ROYAL POINCIANA WAY PALM BEACH, FLORIDA 100% CONSTRUCTION DOCUMENTS / BID PLANS

TREE DISPOSITION, LANDSCAPE, HARDSCAPE, IRRIGATION & ELECTRICAL

INDEX OF DRAWINGS

	IND	EX OF DRAWINGS
SHT#	DWG#	SHEET TITLE
1	1	COVER
2	GN-1	GENERAL NOTES (MEASUREMENT OF PAYMENTS)
3-4	TD-1&2	TREE DISPOSITION/DEMO PLAN
5	TD-3	TREE DISPOSITION CHART
6-7	HP-1&2	HARDSCAPE PLAN
8	HP-3	HARDSCAPE DETAILS
9-10	LP-1&2	LANDSCAPE PLAN
11	LP-3	LANDSCAPE SPECIFICATIONS & PLANT SCHEDULE
12	LP-4	WEST MEDIAN LANDSCAPE LAYOUT PLAN
13	LP-5	EAST MEDIAN LANDSCAPE LAYOUT PLAN
14	LP-6	NOTES & LANDSCAPE DETAILS
15-16	IRR-1&2	IRRIGATION PLAN
17	IRR-3	IRRIGATION SPECIFICATIONS
18	IRR-4	IRRIGATION LEGEND & NOTES
19-21	IRR-5&6	IRRIGATION DETAILS
22	EP-1	ELECTRICAL LAYOUT
23-24	EP-2&3	ELECTRICAL PLANS

AGENCY COMMISSION/COUNCIL

ELECTRICAL DETAILS

Danielle Moore

Bobbie Lindsay

President

Julie Araskog


Council Member

Ted Cooney

Lew Crampton

President Pro Tem

PROJECT
LOCATION

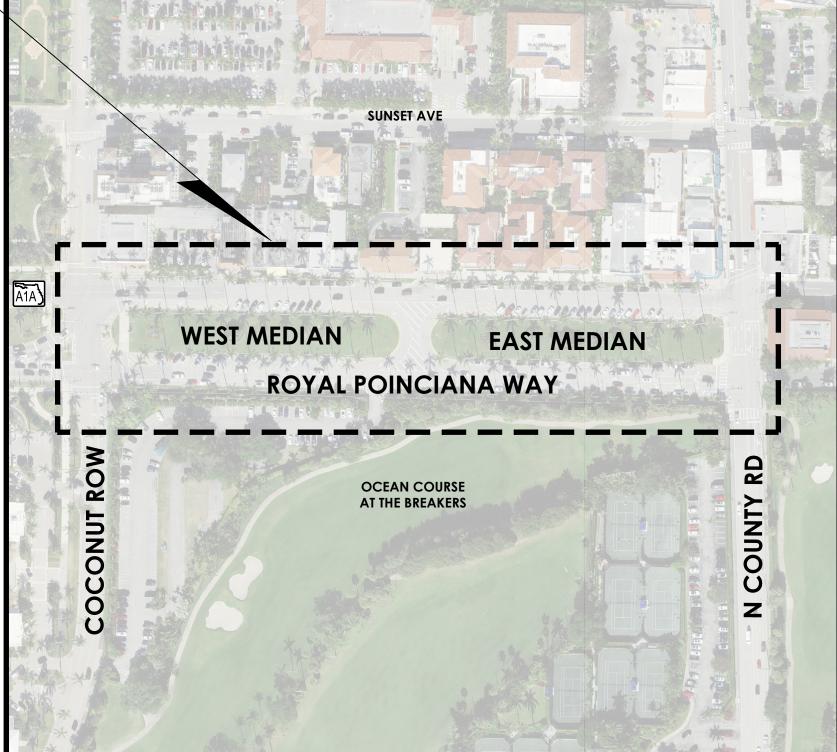

SCALE: NTS

Council Member



TOWN OF PALM BEACH 360 SOUTH COUNTY ROAD PO BOX 2029 Phone: 561-838-5400





500 West Cypress Creek Road, Suite 600 Ft. Lauderdale, FL 33309 954.730.0707 www.chenmoore.com REGISTRATION NO. 6667129
DATE: 1/23/2025

LANDS CA ACTUAL CONTROL OF STATE

OF

ERIC DOUGLAS HARRISON, RLA

REGISTRATION

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PROJECT NUMBER 24-0431.00060

CLIENT PROJECT NUMBER

COVER 1 OF 26

25-26

Bridget Moran

ED-1&2

1 MOBILIZATION (10%) - BID ITEM - GC-1

- A. The quantity to be paid under this Section shall be on a lump sum basis. The Contractor's Lump Sum Unit Price shall include full compensation for all work related to mobilization and demobilization and the work items listed below, and any other related work, except for any work designated to be paid for separately or to be specifically included in the costs of other work under the Contract.
- B. Payment shall be made at the basis of a percentage of the Lump Sum Unit Price whereas the Contractor will receive 50% of the total contract price at the start of the project, 75% after 25% of project completion, and 100% after 50% of project completion.
- C. Payment shall be made at the Contract Lump Sum Unit Price and shall include, but not be limited to, furnishing all materials, labor, and equipment for the preparatory work and operations in mobilizing for beginning work on the project, including those operations necessary for the movement of personnel, equipment, supplies and incidentals to the project site, shop drawing submittal, preparation of pre-construction video, establishment of temporary provisions, controls, and, compliance with permit conditions and adherence to State and local laws and regulations, progress meeting attendance, utility protection and coordination, and locating all existing utilities within the project area in accordance with the project specifications and TOWN Standards.

2. MAINTENANCE OF TRAFFIC - BID ITEM GC-2

- "Traffic Regulation" and all other references to traffic control and maintenance in this document and any regulatory requirements.
- A. Payment for maintenance of traffic will be made at the lump sum price named in the Bid Schedule. Payment for maintenance of traffic will be made in equal monthly amounts during the duration of the contract time.
- B. Payment for maintenance of traffic shall include all materials, plans, and documents the CONTRACTOR is required to prepare for this section. This plan shall include a Maintenance of Traffic (MOT) plan that shall meet all requirements of FDOT and other authorities having jurisdiction. MOT plans shall be signed and sealed by a Professional Engineer registered in the State of Florida.

3. BOND & INSURANCE REQUIREMENTS (3%) - BID ITEM GC-3

- A. Payment for bonds and insurance will be made at the lump sum price named in the Bid Schedule. The CONTRACTOR may request payment for this bid item after the Initial Notice to Proceed has been issued.
- B. Bonds and Insurance are limited to 3% of the Total Bid Price. Any amount in excess of 3% will be moved to Line Item, Mobilization. However, the total bid amount will not change. The 3% ceiling on Bonds and Insurance is not responsiveness, just an instruction on the amount the TOWN will pay for Bonds and Insurance. CONTRACTOR will record the required public construction bond with the Clerk of the Court in the Public Records of Palm Beach County and provide a certified copy of the recorded bond(s). CONTRACTOR shall provide a Certified copy of the bond within 10-days of the award of the contract. Proof of bond shall be provided prior to the commencing of Work and submittal of first invoice. in accordance with Sec. 255.05, Fla. Stat.
- $\frac{\text{4. CLEARING \& GRUBBING/SITE WORK/GRADING (EAST \& WEST MEDIAN) BID ITEM}}{\text{GC-4}}$

Landscape Clearing & Grubbing -

The Contract Unit Price for this item shall constitute full compensation for the furnishing of all labor, materials, supervision, and necessary equipment and services to completely remove and dispose of all timber, brush, stumps, roots, rubbish, debris, and all other obstructions resting on or protruding through the surface of the existing ground and the surface of excavated areas. Remove roots and other debris to a depth of at least 12 inches [300 mm] below the ground surface. Completely remove and dispose of all stumps as indicated on the Contract drawings, as specified herein and as directed by the ENGINEER. The quantity of landscape clearing and grubbing to be paid for under this item shall be included with the actual square footage of landscape clearing and grubbing performed and accepted. Payment will be made at the unit price bid for the actual ACERAGE (AC) of clearing and grubbing performed.

5. STORMWATER POLLUTION PREVENTION/SILT FENCE & TEMPORARY CONSTRUCTION FENCING - BID ITEM GC-5 & GC-7

Fencing - The Contract Unit Price for this item shall constitute full compensation for the furnishing of all labor, materials, supervision, and necessary equipment and services to complete the installation of fencing, as indicated on the Contract drawings, as specified herein and as directed by the ENGINEER. The quantity of fencing to be paid for under this item shall be the actual number of linear feet of fencing installed and accepted. Payment will be made at the unit price bid for the actual Liner Feet (LF) of fencing installed.

6. TREE PRESERVATION FENCING - BID ITEM GC-6

- A. Measurement for payment to furnish and install tree protection fencing will be based upon the number of linear feet of such fencing actually constructed, all in accordance with the requirements of the Contract Documents.
- B. Payment for furnishing and installing tree protection fencing will be made at the unit price per linear foot of fencing named in the Bid Schedule which price shall constitute full compensation for fencing installed.

7. FURNISH AND INSTALL CONCRETE SIDEWALK - BID ITEM C-1 & C-2

- A. Measurement and payment for concrete slabs and related concrete blocks will be based upon the actual number of square yards constructed as shown in the drawings, all in accordance with the requirements of the Contract Documents.
- B. Payment for this item will be made at the unit price per square yard named in the Bid Schedule (Item Response Form) and detailed on the drawings which price shall constitute full compensation for completing said work.
- C. Raised Header Curb The Contract Unit Price for this item shall constitute full compensation for furnishing all materials, labor, equipment and tools for the complete construction of flush header curb as shown on the construction Drawings, specified herein and as directed by the ENGINEER. This item includes, but is not limited to, grading, the installation of curb pad, forming, saw cutting of pavement, cleanup of all areas disturbed by this construction providing temporary sidewalks and walkways interrupted during construction activities, temporary restoration of mailboxes, temporary restoration of driveways, temporary restoration of roads, and temporary restoration of structures. Payment for this item is per Linear Foot (LF) of curb actually constructed as determined by measurement along the centerline of the curb in place.

8. FURNISH AND INSTALL ADA DETACTABLE WARNING - BID ITEM C-3

Furnish and Install ADA Detectable Warning - The Contract Unit Price for this item shall constitute full compensation for furnishing all materials, labor, equipment and tools for the complete installation of approved ADA detectable warning materials as shown on the construction Drawings, specified herein and as directed by the ENGINEER. This item includes, but not limited to all preparation, placement, cleanup, and restoration. Payment for this item will be based upon the actual quantity, at the unit price as (EA), of such detectable warning installed.

9. TREES, SHRUBS & GROUNDCOVER - BID ITEM L-1 TO L-7

Trees, Plants and Groundcover - The Contract Unit Price for this item shall constitute full compensation for the furnishing of all labor, materials, supervision, and necessary equipment and services to complete the installation of all landscape material, as indicated on the Contract drawings, as specified herein and as directed by the ENGINEER. Payment under this item shall be the actual number of plants and/or square footage of sod installed and accepted. Payment will be made at the unit price bid for each (EA) tree, shrub, groundcover or Square Footage (SF) of sod installed. CONTRACTOR shall use all means necessary for preventing dust, debris or other construction refuse from landscape installation operations from being a nuisance to adjacent property of the CITY.

10. IRRIGATION - BID ITEM L-8 TO L-12

Irrigation - The Contract Unit Price for this item shall constitute full compensation for the furnishing of all labor, materials, supervision, and necessary equipment and services to complete the installation of all Irrigation material, as indicated on the Contract drawings, as specified herein and as directed by the ENGINEER. Payment under this item shall be the actual number of installed irrigation heads, valves, controller & rain sensor. Payment will be made at the unit price bid for each (EA) installed. CONTRACTOR shall use all means necessary for preventing dust, debris or other construction refuse from landscape installation operations from being a nuisance to adjacent property of the CITY.

11. TRENCH SAFETY COMPLIANCE AND CONDUIT 630 -2-11 - BID ITEM ELE-4

- The quantity to be paid for under this Section shall be on a lump sum basis. The work specified in this Section consists of furnishing and installing adequate trench and trench safety measures and any special shoring measures for trench safety act compliance. The work also includes the conduit (and all appurtenances necessary for interconnection with the existing conduit system) installation, supply, maintenance and removal of any temporary security fencing required during the course of construction. Measurement is for the straight line HORIZONTAL DISTANCE of the trench or bore, from pull box to pull box, with no allowance for sweeps or vertical distance.
- A. Payment shall be made at the basis of a percentage of the Lump Sum Unit Price. The percent completion of the project shall be based on the percent of the total project actually constructed and not on the percent of the Contract price completed.
- B. The contract Lump Sum Unit Price shall include compensation for required labor, materials, and equipment necessary for complying with the Trench Safety Act and providing any required Special Shoring, as well as the supply, maintenance, and removal of temporary site security fencing during the construction activities in accordance with the Contract Documents.

12. ELECTRICAL REMOVAL, REPAIRS, MODIFICATIONS, AND INSTALLATION OF LOAD CENTER BID ITEM ELE-2 715-7-11 AND BID ITEM ELE-3 715-7-41

- A. The quantity to be paid under this Section shall be on a lump sum basis. The Contractor's Lump Sum Unit Price shall include full compensation for all work related to electrical modifications including but not limited to tie in with the existing conduit system, interconnection with the existing nightmaster, installation, removal and reworking of the existing and proposed load center(s), reworking and installation of the proposed 20A fused disconnect for the police equipment.
- B. The contract Lump Sum Unit Price shall include compensation for required labor, materials, and equipment necessary for any electrical modifications. The Unit price will include but not be limited to the enclosures, transformers, panel boards, breakers, safety switches, H.O.A. switches panel boards, breakers, lightning arrestor, contactors, photo electric switch, grounding, fused disconnect, spare fuses, and the concrete pad (if required). Payment will be made at the unit price bid for the actual equipment installed.

- 13. PULL AND SPLICE BOX 635-2-11 BID ITEM ELE-5
- A. The quantity to be paid under this Section shall be on a lump sum basis. The Contractor's Lump Sum Unit Price shall include full compensation for all work related to the pull boxes including: box covers with lifting slots and a flush-seating lockdown mechanism. Use penta-head lockdown lag bolts. Lockdown bolts and lifting slots are Type 316, 304, or 302 passivated stainless steel or brass. Lockdown bolt assembly is designed to prevent seizing and can be removed without damaging the cover or box body. Lockdown bolt threaded insert/nut assembly is field replaceable.
- B. The contract Lump Sum Unit Price shall include compensation for required labor, materials, and equipment necessary for any pull boxes and ancillary equipment. Payment will be made at the unit price bid for the actual equipment installed.

14. CONDUCTORS, INSULATED, #8 AND OTHERS AS REQUIRED BID ITEM 715-1-12 ELE-1

- A. The quantity to be paid under this Section shall be on a lump sum basis. The Contractor's Lump Sum Unit Price shall include full compensation for all work related to conductors.
- B. The contract Lump Sum Unit Price shall include compensation for required labor, materials, and equipment necessary for any conductors, connections, and ancillary equipment. Payment will be made at the unit price bid for the actual equipment installed.

chen moore and associates
500 West Cypress Creek Road

500 West Cypress Creek Ros Suite 600 Ft. Lauderdale, FL 33309 **954.730.0707** www.chenmoore.com

REGISTRATION

REGISTRATION NO. **6667129**DATE: 1/23/2025



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CLIENT

Town of Palm Beach
Public Works
951 Okeechobee Road, Suite A
West Palm Beach, FL 33401
561.838.5440

Mike Roach, PE

Project Manager:

PROJECT INFORMATION

ROYAL POINCIANA WAY

PROJECT NUMBER 24-0431.00060

CLIENT PROJECT NUMBER
PO 240844

VERIFY SCALES

REVISIONS

DATE OF ISSUE 1/17/25

DESIGNED BY

ESF/EDH DRAWN BY

CHECKED BY

ESF/EDH

GENERAL NC


GENERAL NOTES (MEASUREMENT OF PAYMENT)

ESF/EDH

DRAWING NUMBER

GN-12 OF 26

Check positive response codes before you dig!

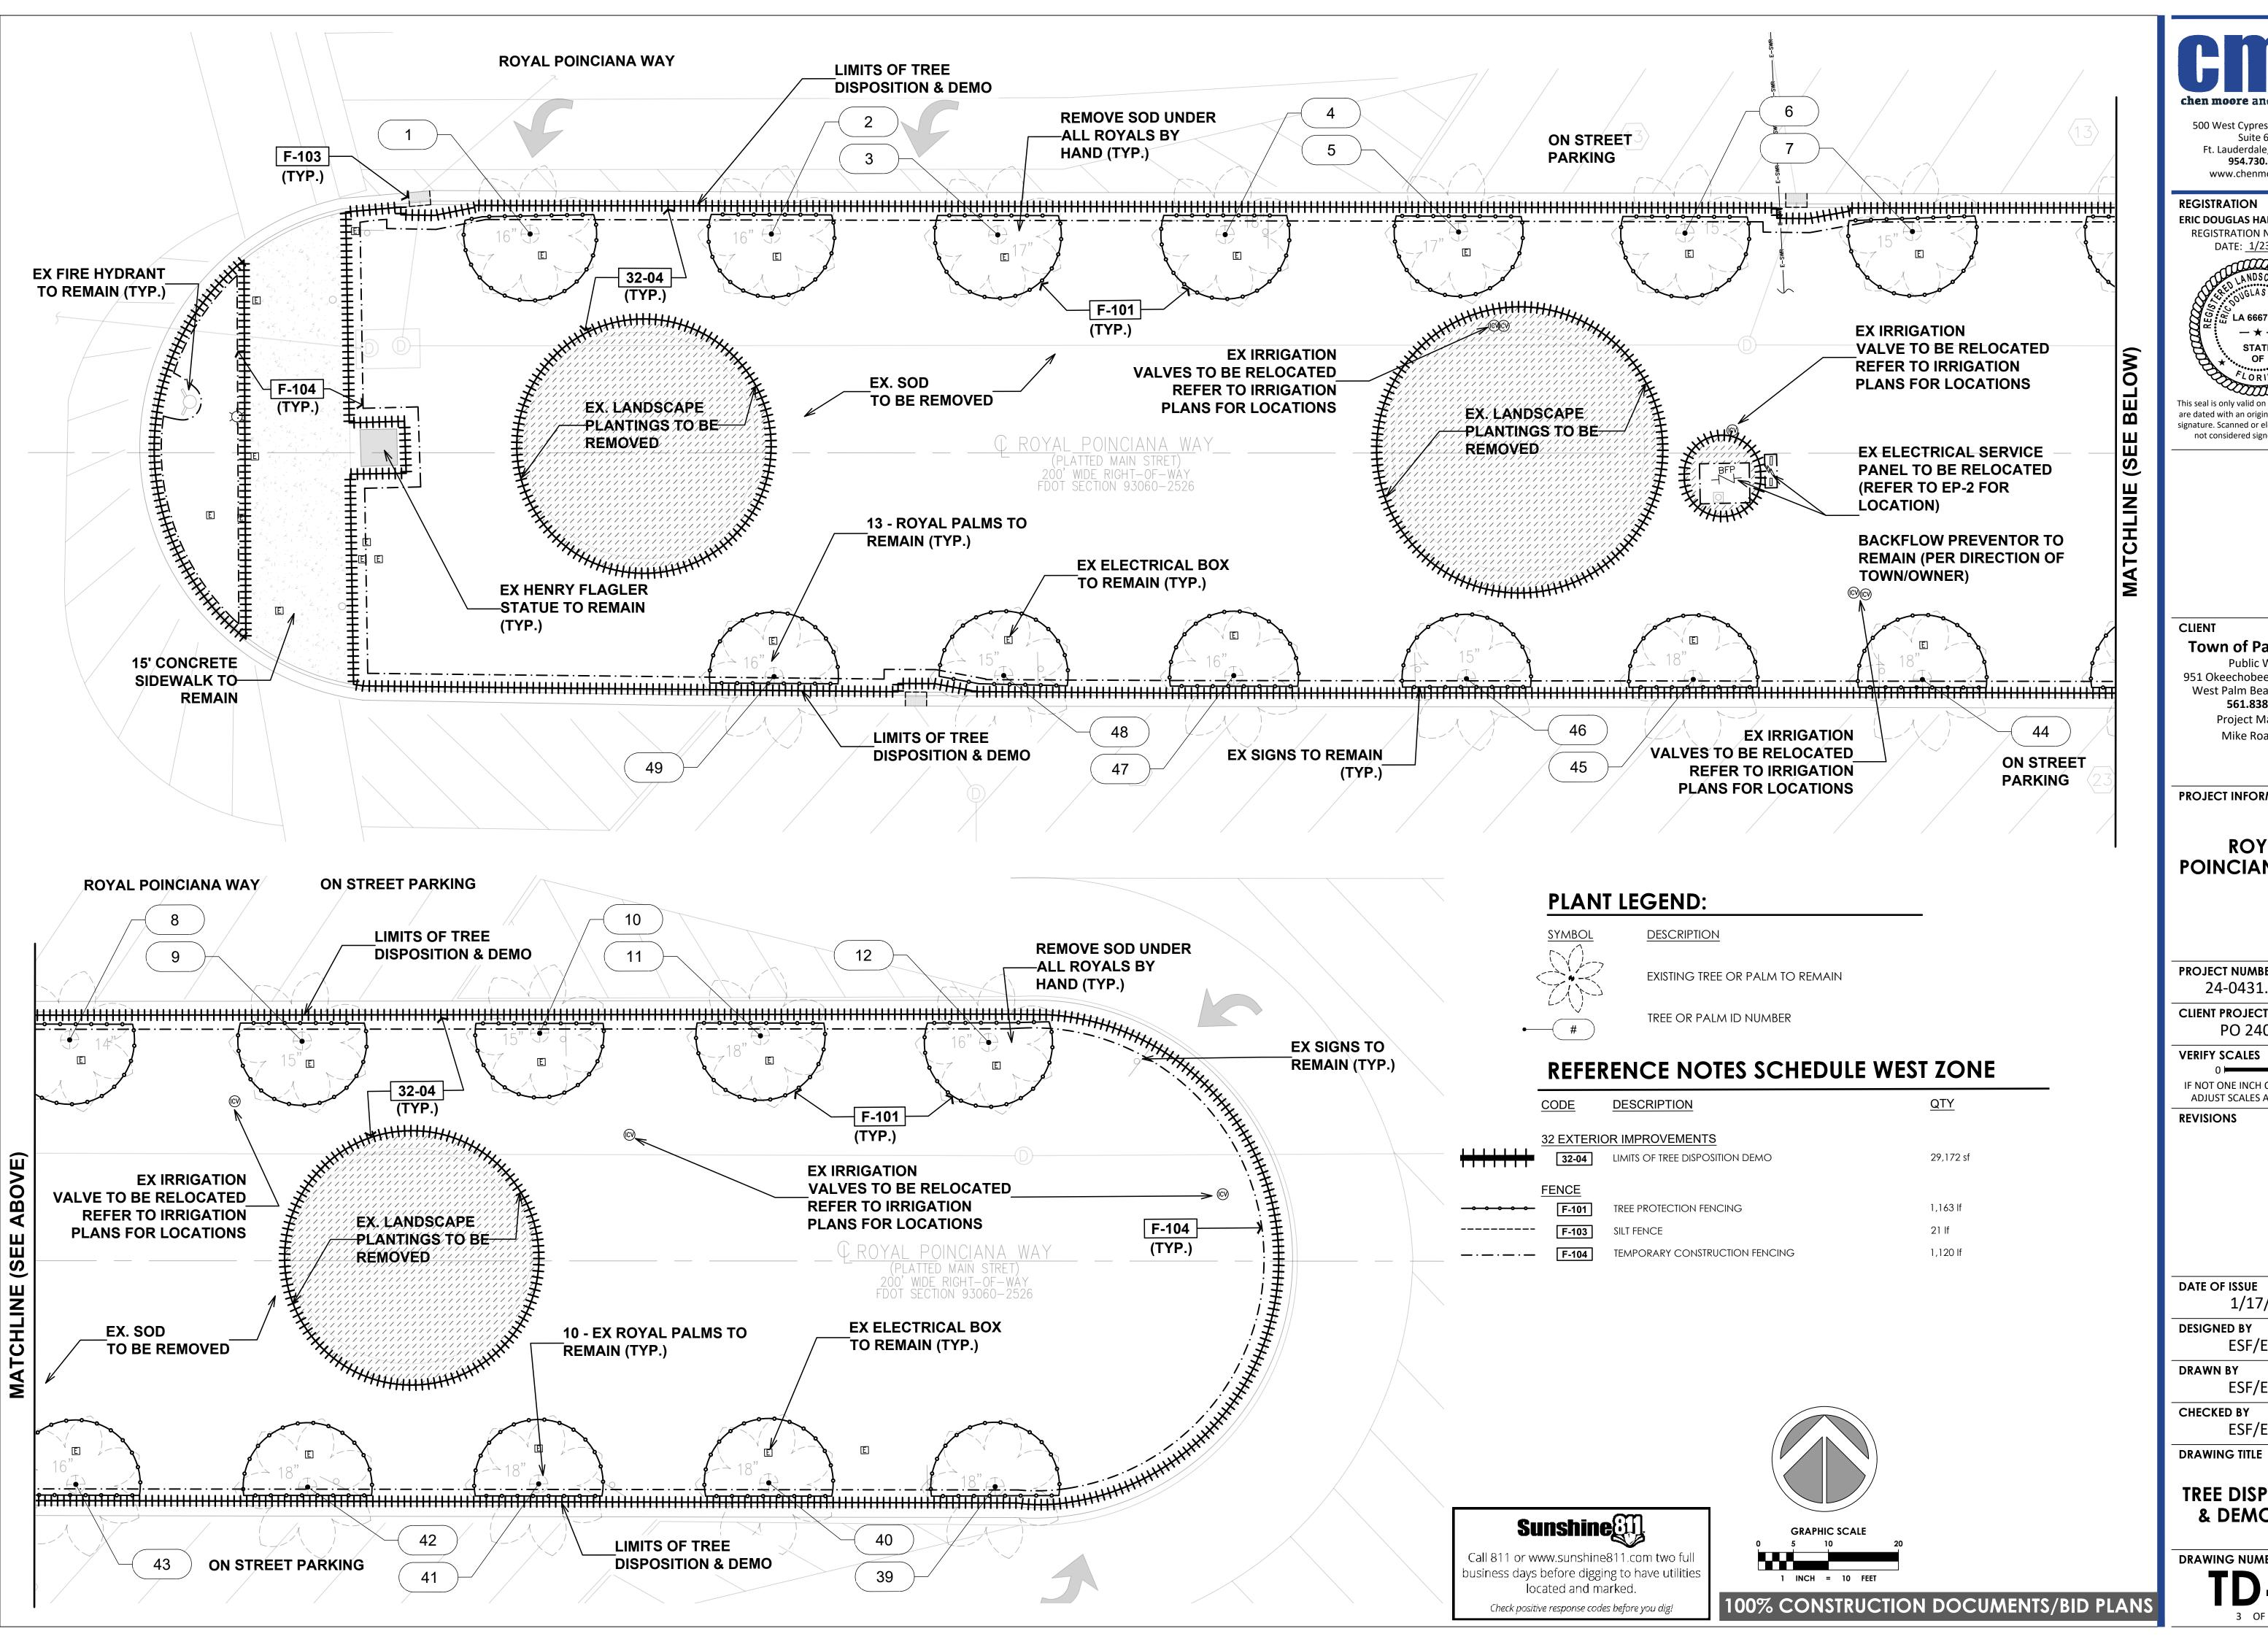

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ERIC DOUGLAS HARRISON, RLA REGISTRATION NO. 6667129 DATE: 1/23/2025



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CLIENT

Town of Palm Beach

Public Works 951 Okeechobee Road, Suite A West Palm Beach, FL 33401 561.838.5440 Project Manager: Mike Roach, PE

PROJECT INFORMATION

ROYAL POINCIANA WAY

PROJECT NUMBER 24-0431.00060

CLIENT PROJECT NUMBER PO 240844

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IF NOT ONE INCH ON THIS SHEET, ADJUST SCALES ACCORDINGLY

DATE OF ISSUE 1/17/25

DESIGNED BY


ESF/EDH **DRAWN BY**

ESF/EDH

CHECKED BY ESF/EDH

TREE DISPOSITION & DEMO PLAN

DRAWING NUMBER

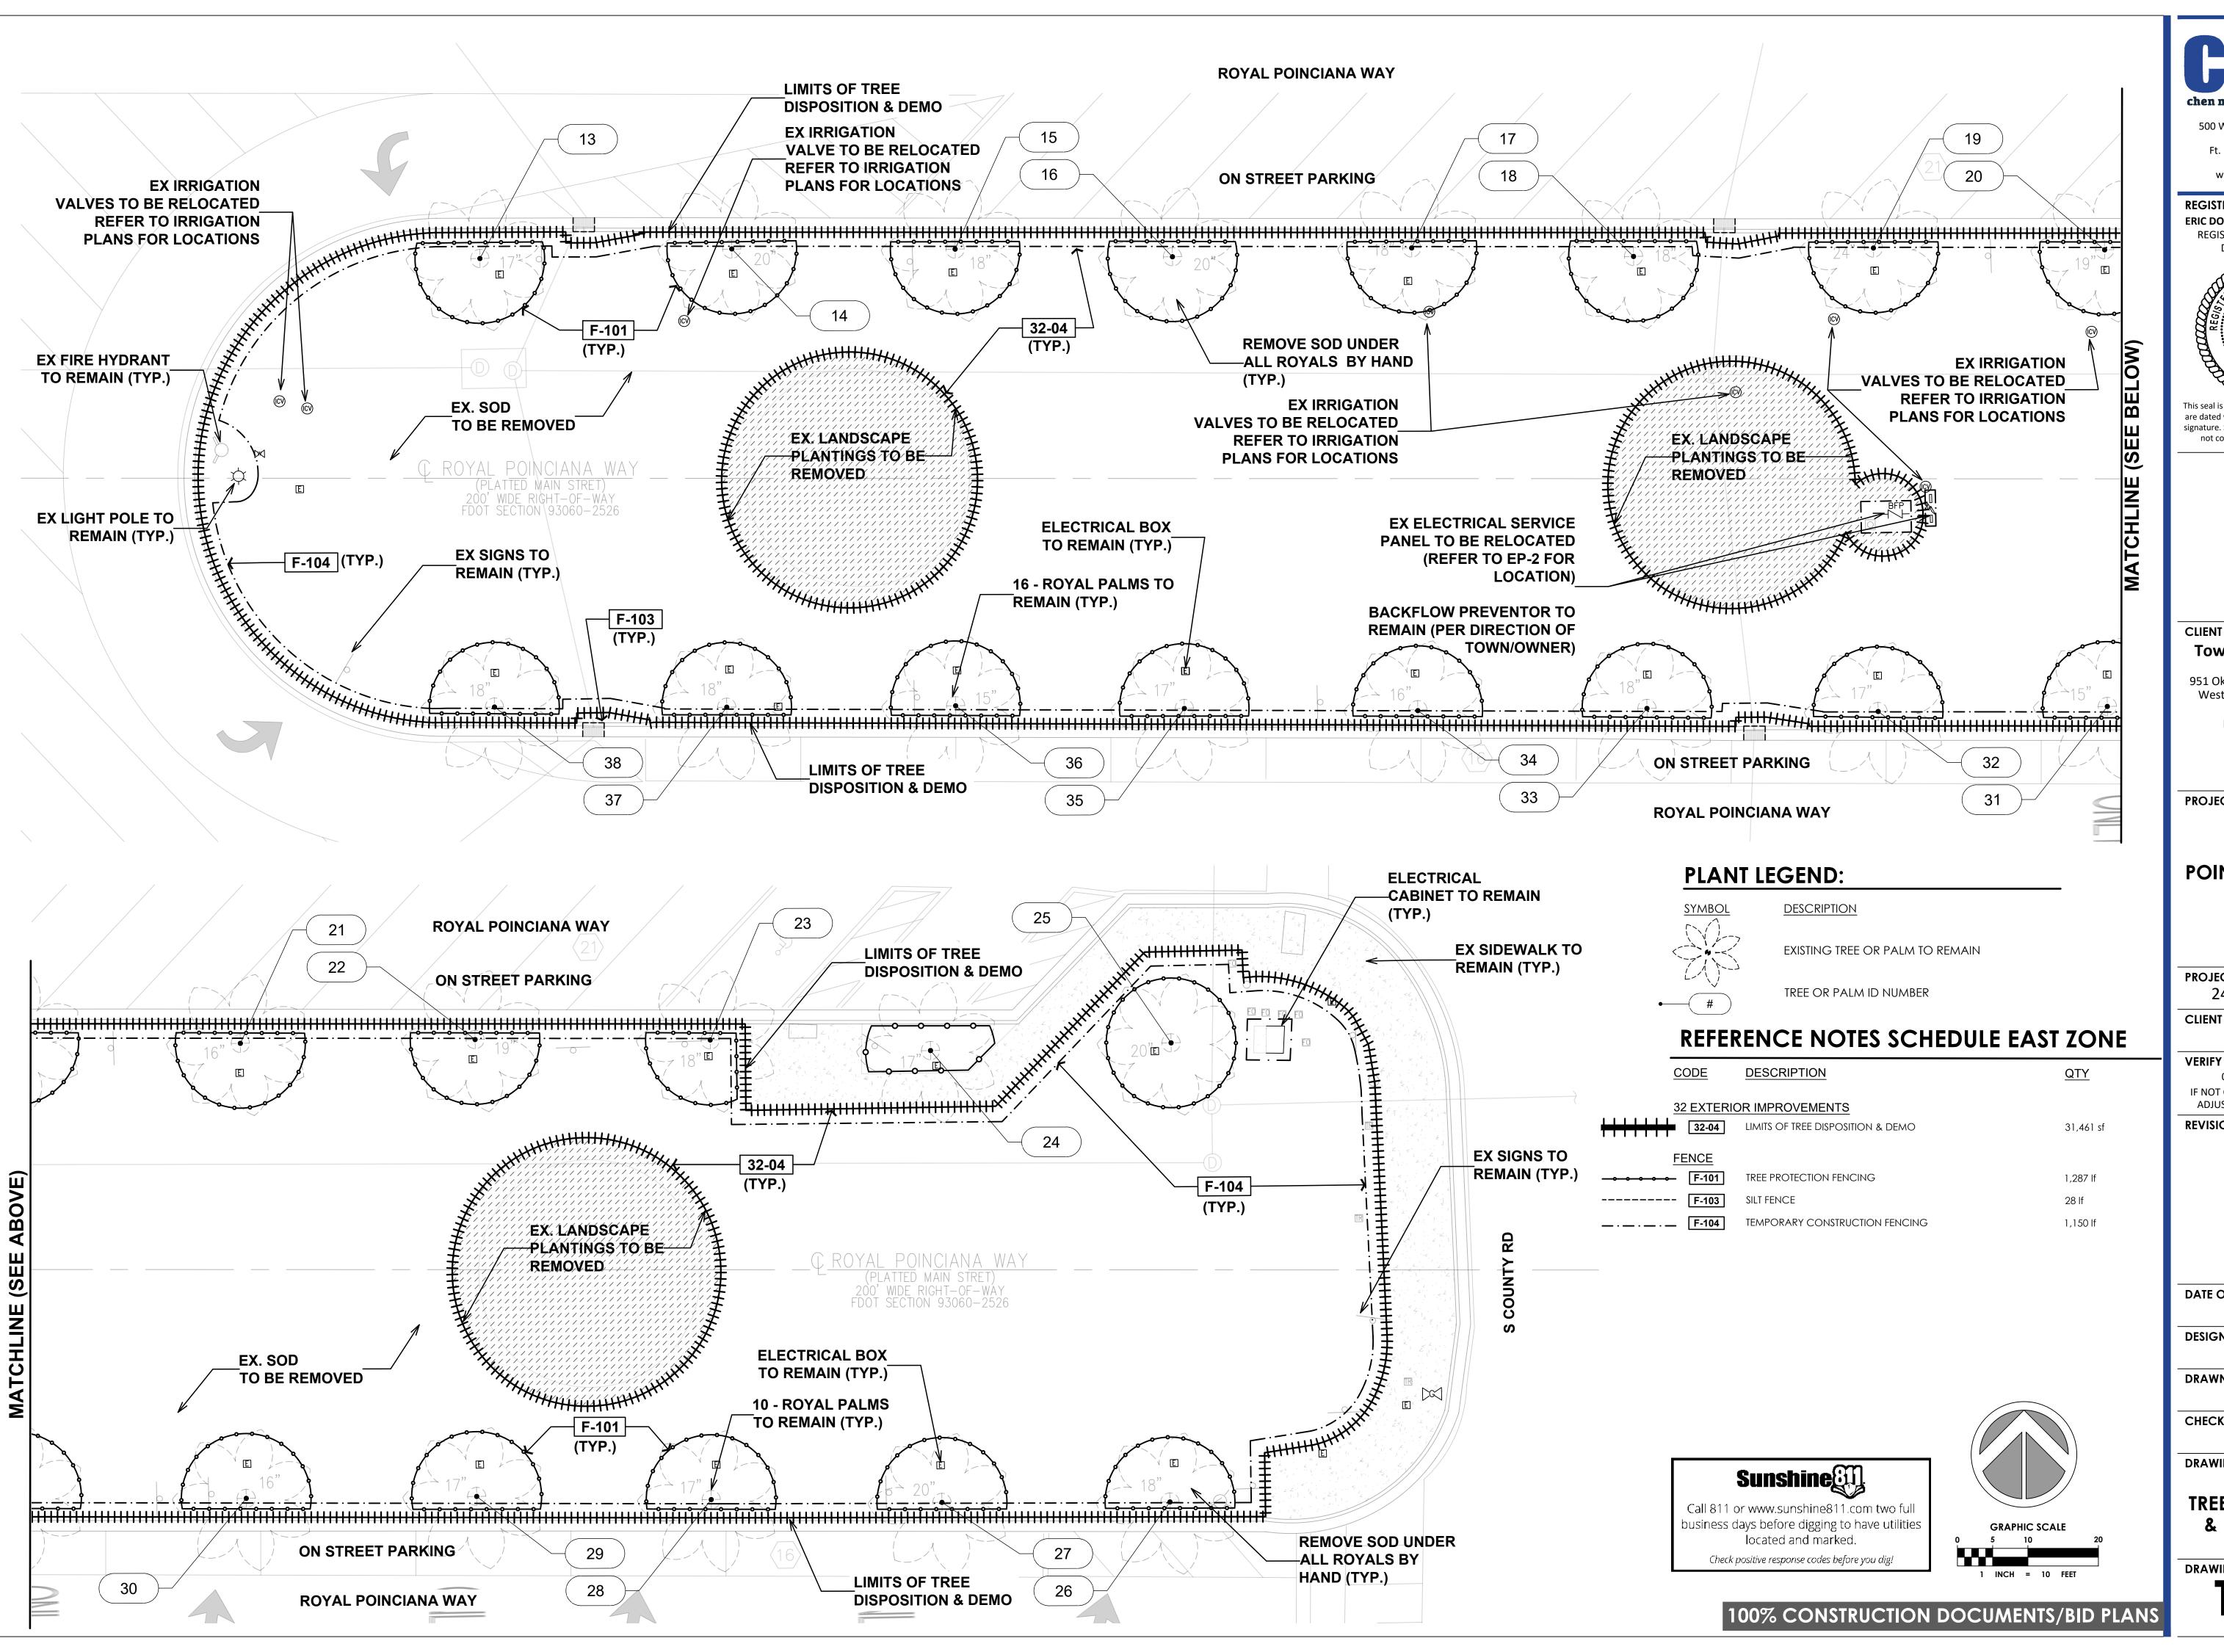

500 West Cypress Creek Road Suite 600 Ft. Lauderdale, FL 33309 954.730.0707 www.chenmoore.com

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PO 240844 **VERIFY SCALES**

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REVISIONS

DATE OF ISSUE 1/17/25

DESIGNED BY

ESF/EDH

DRAWN BY ESF/EDH

CHECKED BY

ESF/EDH

DRAWING TITLE

TREE DISPOSITION & DEMO PLAN

DRAWING NUMBER

TREE DISPOSITION CHART

Tree ID#	Common Name	Scientific Name	DBH (in.)	Canopy Diameter	Disposition	Condition
1	ROYAL PALM	ROYSTONEA REGIA	16	18	Remain	Fair (41% to 60%)
2	ROYAL PALM	ROYSTONEA REGIA	16	17	Remain	Fair (41% to 60%)
3	ROYAL PALM	ROYSTONEA REGIA	17	16	Remain	Fair (41% to 60%)
4	ROYAL PALM	ROYSTONEA REGIA	18	18	Remain	Fair (41% to 60%)
5	ROYAL PALM	ROYSTONEA REGIA	17	17	Remain	Fair (41% to 60%)
6	ROYAL PALM	ROYSTONEA REGIA	15	16	Remain	Fair (41% to 60%)
7	ROYAL PALM	ROYSTONEA REGIA	15	18	Remain	Fair (41% to 60%)
8	ROYAL PALM	ROYSTONEA REGIA	14	19	Remain	Fair (41% to 60%)
9	ROYAL PALM	ROYSTONEA REGIA	15	20	Remain	Fair (41% to 60%)
10	ROYAL PALM	ROYSTONEA REGIA	15	18	Remain	Fair (41% to 60%)
11	ROYAL PALM	ROYSTONEA REGIA	18	19	Remain	Fair (41% to 60%)
12	ROYAL PALM	ROYSTONEA REGIA	16	18	Remain	Fair (41% to 60%)
13	ROYAL PALM	ROYSTONEA REGIA	17	17	Remain	Fair (41% to 60%)
14	ROYAL PALM	ROYSTONEA REGIA	20	18	Remain	Fair (41% to 60%)
15	ROYAL PALM	ROYSTONEA REGIA	18	18	Remain	Fair (41% to 60%)
16	ROYAL PALM	ROYSTONEA REGIA	20	17	Remain	Fair (41% to 60%)
17	ROYAL PALM	ROYSTONEA REGIA	18	20	Remain	Fair (41% to 60%)
18	ROYAL PALM	ROYSTONEA REGIA	18	18	Remain	Fair (41% to 60%)
19	ROYAL PALM	ROYSTONEA REGIA	24	16	Remain	Fair (41% to 60%)
20	ROYAL PALM	ROYSTONEA REGIA	 19	17	Remain	Fair (41% to 60%)
21	ROYAL PALM	ROYSTONEA REGIA	16	18	Remain	Fair (41% to 60%)
22	ROYAL PALM	ROYSTONEA REGIA	19	18	Remain	Fair (41% to 60%)
23	ROYAL PALM	ROYSTONEA REGIA	18	19	Remain	Fair (41% to 60%)
24	ROYAL PALM	ROYSTONEA REGIA	17	18	Remain	Fair (41% to 60%)
25	ROYAL PALM	ROYSTONEA REGIA	20	18	Remain	Fair (41% to 60%)
26	ROYAL PALM	ROYSTONEA REGIA	18	17	Remain	Fair (41% to 60%)
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44	ROYAL PALM	ROYSTONEA REGIA	18	17	Remain	Fair (41% to 60%)
45	ROYAL PALM	ROYSTONEA REGIA	18	16	Remain	Fair (41% to 60%)
46	ROYAL PALM	ROYSTONEA REGIA	15	18	Remain	Fair (41% to 60%)
47	ROYAL PALM	ROYSTONEA REGIA	16	19	Remain	Fair (41% to 60%)
48	ROYAL PALM	ROYSTONEA REGIA	15	16	Remain	Fair (41% to 60%)
49	ROYAL PALM	ROYSTONEA REGIA	16	17	Remain	Fair (41% to 60%)
	TOTAL NUMBER OF PALMS TO					
	REMA	AIN TO THE PROPERTY OF THE PRO				

GENERAL DEMOLITION NOTES:

- 1. DO NOT START DEMOLITION WORK UNTIL UTILITY DISCONNECTING AND SEALING HAVE BEEN COMPLETED AND VERIFIED IN WRITING.
- 2. CONDUCT DEMOLITION OPERATIONS AND REMOVE DEBRIS TO ENSURE MINIMUM INTERFERENCE WITH ROADS, STREETS, WALKS, AND OTHER ADJACENT OCCUPIED AND USED FACILITIES.
- 3. DO NOT CLOSE OR OBSTRUCT STREETS, WALKWAYS, OR OTHER ADJACENT OCCUPIED OR IN-USE FACILITIES WITHOUT PERMISSION FROM OWNER, THE TOWN OF PALM BEACH AND AUTHORITIES HAVING JURISDICTION. PROVIDE ALTERNATE ROUTES AROUND CLOSED OR OBSTRUCTED TRAFFIC WAYS AS REQUIRED BY GOVERNING REGULATIONS.
- 4. CONDUCT DEMOLITION OPERATIONS TO PREVENT INJURY TO PEOPLE AND DAMAGE TO ADJACENT BUILDINGS AND FACILITIES TO REMAIN. ENSURE SAFE PASSAGE OF PEOPLE AROUND DEMOLITION AREA.
- 5. ERECT TEMPORARY PROTECTION, SUCH AS WALKWAYS, FENCES, BARRIERS, RAILINGS, ETC. WHERE REQUIRED BY AUTHORITIES HAVING JURISDICTION.
- 6. PROTECT EXISTING SITE IMPROVEMENTS, APPURTENANCES, AND LANDSCAPING TO REMAIN.
- 7. ADJACENT IMPROVEMENTS SHALL BE CLEANED OF DUST, DIRT, AND DEBRIS CAUSED BY DEMOLITION OPERATIONS. RETURN ADJACENT AREAS TO CONDITION EXISTING BEFORE START OF DEMOLITION.
- 8. FOR SELECTIVE DEMOLITION, USE CUTTING METHODS LEAST LIKELY TO DAMAGE CONSTRUCTION TO REMAIN OR ADJOINING CONSTRUCTION. TO MINIMIZE DISTURBANCE OF ADJACENT SURFACES. USE HAND OR SMALL POWER TOOLS DESIGNED FOR SAWING OR GRINDING, NOT HAMMERING OR CHOPPING, TEMPORARILY COVER OPENINGS TO REMAIN.
- 9. INFORMATION SHOWN ON THE DRAWINGS AS TO THE LOCATION OF EXISTING UTILITIES HAS BEEN PREPARED FROM THE MOST RELIABLE DATA AVAILABLE; HOWEVER, THIS INFORMATION IS NOT GUARANTEED. TAKE RESPONSIBILITY TO DETERMINE THE LOCATION, CHARACTER, AND DEPTH OF ALL EXISTING UTILITIES. ASSIST THE UTILITY COMPANIES, BY EVERY MEANS POSSIBLE, TO DETERMINE SAID LOCATIONS AND THE LOCATIONS OF RECENT ADDITIONS TO THE SYSTEMS NOT SHOWN.
- 10. REMOVAL, DEMOLITION, HAULING, AND DISPOSAL SHALL COMPLY WITH REGULATIONS BY F.D.E.P., E.P.A., AND ANY OTHER AUTHORITY HAVING JURISDICTION.
- 11. ALL EXISTING PATHWAY AND STREET LIGHTING WILL REMAIN IN PLACE AND REMAIN IN SERVICE DURING CONSTRUCTION OPERATIONS.
- 12. REFER TO ELECTRICAL PLANS FOR ALL DEMOLITION AND RELOCATIONS.

4' HIGH DENSITY ORANGE

POLYETHELENE SAFETY FENCE

STAKES: 6' T-POST

WIRE OR ZIP TIES

FENCE TO POST

- FINISHED GRADE

TO SECURE SAFETY

DRIVEN 1'-8" MIN

BELOW GRADE

IRRIGATION DEMOLITION NOTES:

1. TAKE RESPONSIBILITY TO IDENTIFY AND INVENTORY ALL EXISTING IRRIGATION EQUIPMENT WITHIN LIMITS OF CLEARING & GRUBBING WHICH INCLUDES ALL VALVE BOXES, VALVES, IRRIGATION HEADS, QUICK COUPLERS, GATE VALVES, IRRIGATION CONTROLLER, JUNCTION BOXES AND DECODERS. IDENTIFY WHAT CAN BE SALVAGED AND RE-USED IF NOT DAMAGED PER RE-DESIGN (SEE PLANS). CUT AND CAP AT LOCATIONS SHOWN ON PLANS, REDIRECTION OF MAINLINE AND ELECTRICAL WIRE ARE LABELED AS PROPOSED. ALL IRRIGATION ZONES OUTSIDE LIMITS OF PLANS ARE TO BE OPERATIONAL AND RUNNING AT TIME OF CONSTRUCTION. DURING TIME OF CONSTRUCTION ALL EXISTING MATERIAL SHALL BE STORED BY TOWN OF PALM BEACH PUBLIC WORKS DEPARTMENT UNTIL FURTHER NOTICE.

OPTIONAL POST POSITIONS PRINCIPAL POST POSITION (CANTED 20° TOWARD FLOW) FILTER FABRIC SILT FLOW 2"x2" WOOD POST SILT FENCE FABRIC GRADE LINE AT — SOIL BACKFILL SILT FENCE

MAINTENANCE OF TRAFFIC

- MAINTENANCE OF TRAFFIC SHALL BE IN ACCORDANCE WITH FLORIDA DEPARTMENT OF TRANSPORTATION (FDOT) DESIGN STANDARDS INDEX, 600 SERIES, 2020-21 EDITION OF THE STANDARD PLANS.
- NO EXCAVATIONS WILL BE CONDUCTED WITHIN THE ROADWAY OF ROYAL POINCIANA WAY. MOVEMENTS OF CONSTRUCTION VEHICLES AND STAGING OF EQUIPMENT SHALL BE FOR NO LONGER THAN 60 MINUTES. OPERATIONS SHALL BE CONDUCTED IN ACCORDANCE WITH FDOT DESIGN STANDARD INDEX 602.
- TAKE RESPONSIBILITY FOR ACQUIRING FDOT AND TOWN OF PALM BEACH RIGHT OF WAY PERMITS. AS A CONDITION OF THE TOWN ROW PERMIT REQUIREMENTS, TAKE RESPONSIBILITY FOR SUBMITTING WEEKLY TRAFFIC UPDATES TO THE TOWN FOR THE DURATION OF THE PROJECT.

Sunshine

Call 811 or www.sunshine811.com two full business days before digging to have utilities located and marked.

ORANGE CONSTRUCTION FENCE DETAIL

Check positive response codes before you dig!

100% CONSTRUCTION DOCUMENTS/BID PLANS

500 West Cypress Creek Road

Ft. Lauderdale, FL 33309 954.730.0707

www.chenmoore.com **REGISTRATION**

ERIC DOUGLAS HARRISON, RLA REGISTRATION NO. 6667129

DATE: 1/23/2025 LA 6667129 STATE FLORIDA

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CLIENT

Town of Palm Beach

Public Works 951 Okeechobee Road, Suite A West Palm Beach, FL 33401 561.838.5440 Project Manager: Mike Roach, PE

PROJECT INFORMATION

ROYAL **POINCIANA WAY**

PROJECT NUMBER 24-0431.00060

CLIENT PROJECT NUMBER PO 240844

VERIFY SCALES

IF NOT ONE INCH ON THIS SHEET, ADJUST SCALES ACCORDINGLY

REVISIONS

DATE OF ISSUE 1/17/25

DESIGNED BY

ESF/EDH **DRAWN BY**

ESF/EDH CHECKED BY

ESF/EDH

DRAWING TITLE

TREE DISPOSITION **CHART**

5 OF 26

DRAWING NUMBER

BARRICADES BETWEEN TREES AND CONSTRUCTION ACTIVITY. BE LOCATED TO PROTECT A MINIMUM OF 75% OF THE CRITICAL PROTECTION ZONE ADJUST AS NECESSARY TO ACCOMMODATE PROPOSED SITE IMPROVEMENTS; REFER TO TREE DISPOSITION NOTES. SECURELY AFFIX FENCE TO 8' MAXIMUM STRINGER WITH NAILS OR O C SPACING NO ENTRY OR STORAGE STAPLES (TYP.) NO DRIP LINE — 2"X4" STRINGER/TOP RAIL ENCROACHMENT - 4' HT. BARRICADE FENCE OF ORANGE "TENSOR" HIGH VISIBILITY MESH - 2"X4" MIN. WOOD POST - EXISTING UNDISTURBED SOIL

2' MIN

TREE PRESERVATION FENCING

329343-24

DIMENSION VARIES PER CRITICAL

PROTECTION ZONE

CRITICAL PROTECTION ZONE: THE AREA SURROUNDING A TREE WITHIN A CIRCLE

DESCRIBED BY A RADIUS OF ONE FOOT

FOR EACH INCH OF THE TREE TRUNK DIAMETER AT 54" ABOVE FINISHED GRADE

FOR GROUPS OF TREES, PLACE

IN ANCHOR TRENCH

SILT FENCE BARRIER DETAIL


FILTER FABRIC (IN —

CONFORMANCE WITH

SECT 985 FDOT SPEC)

312553-02

312553-03

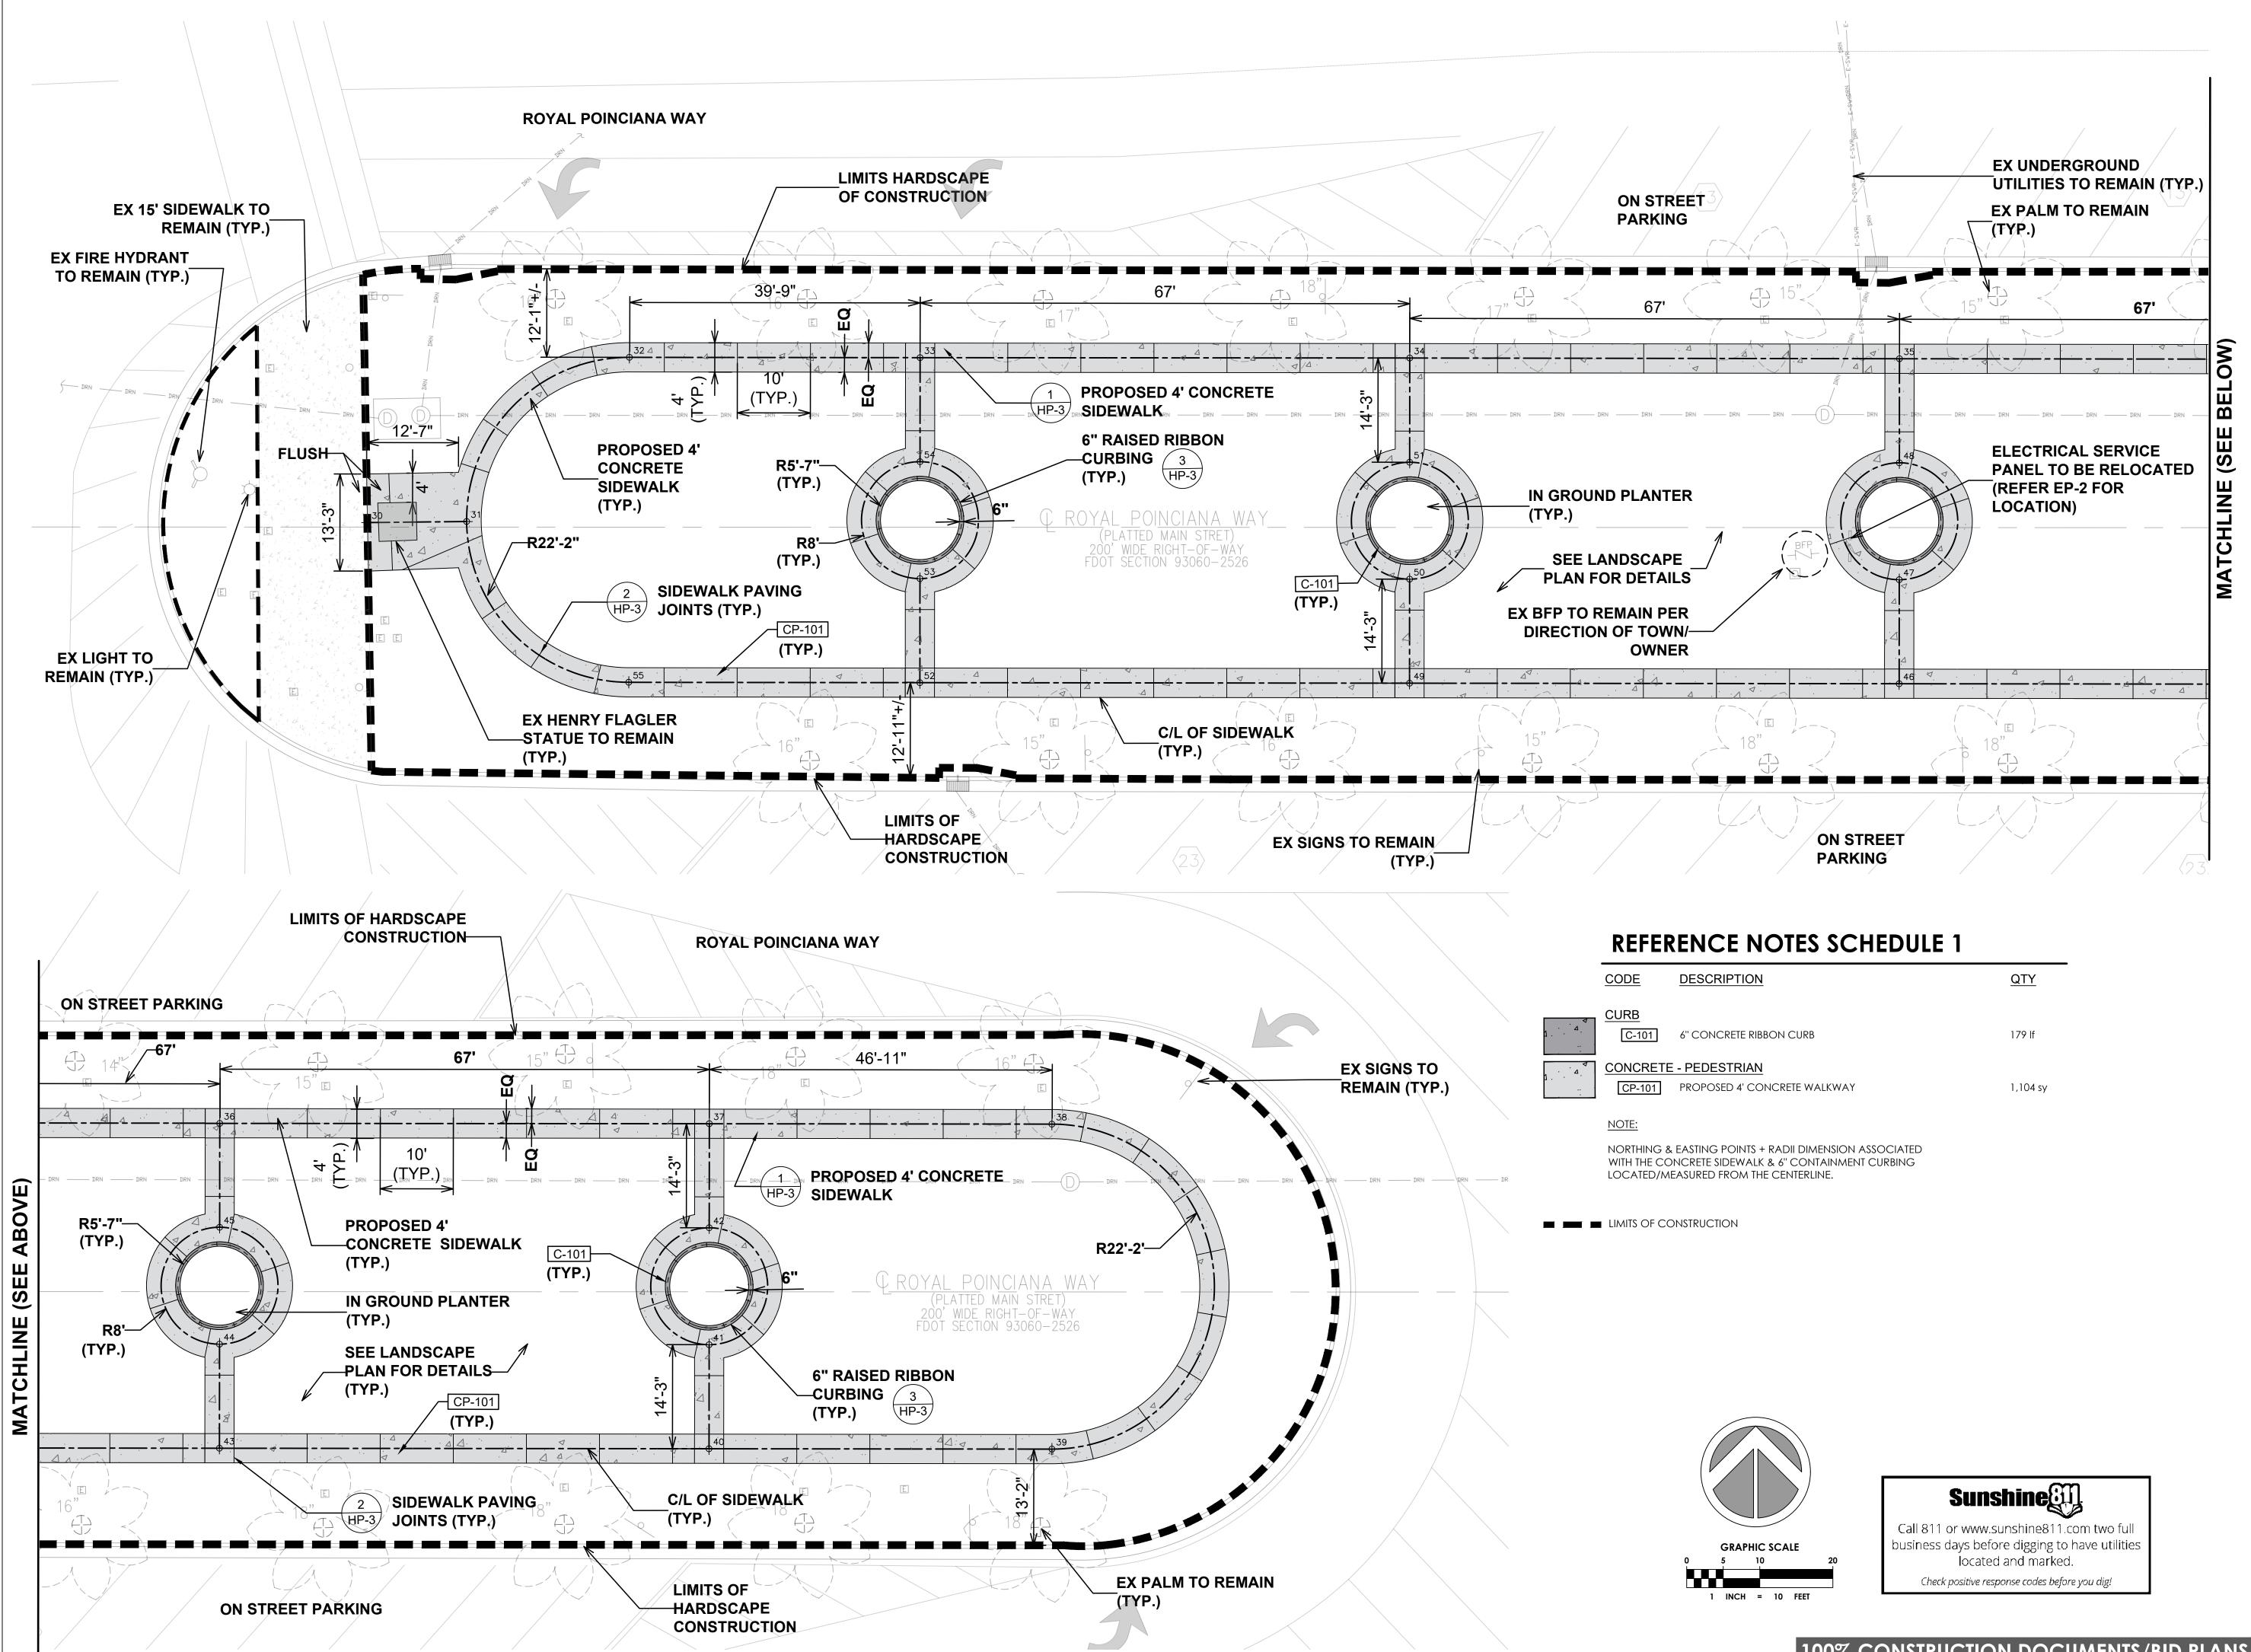



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REGISTRATION

ERIC DOUGLAS HARRISON, RLA REGISTRATION NO. 6667129



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CLIENT

Town of Palm Beach

Public Works 951 Okeechobee Road, Suite A West Palm Beach, FL 33401 561.838.5440 Project Manager: Mike Roach, PE

PROJECT INFORMATION

ROYAL POINCIANA WAY

PROJECT NUMBER 24-0431.00060

CLIENT PROJECT NUMBER PO 240844

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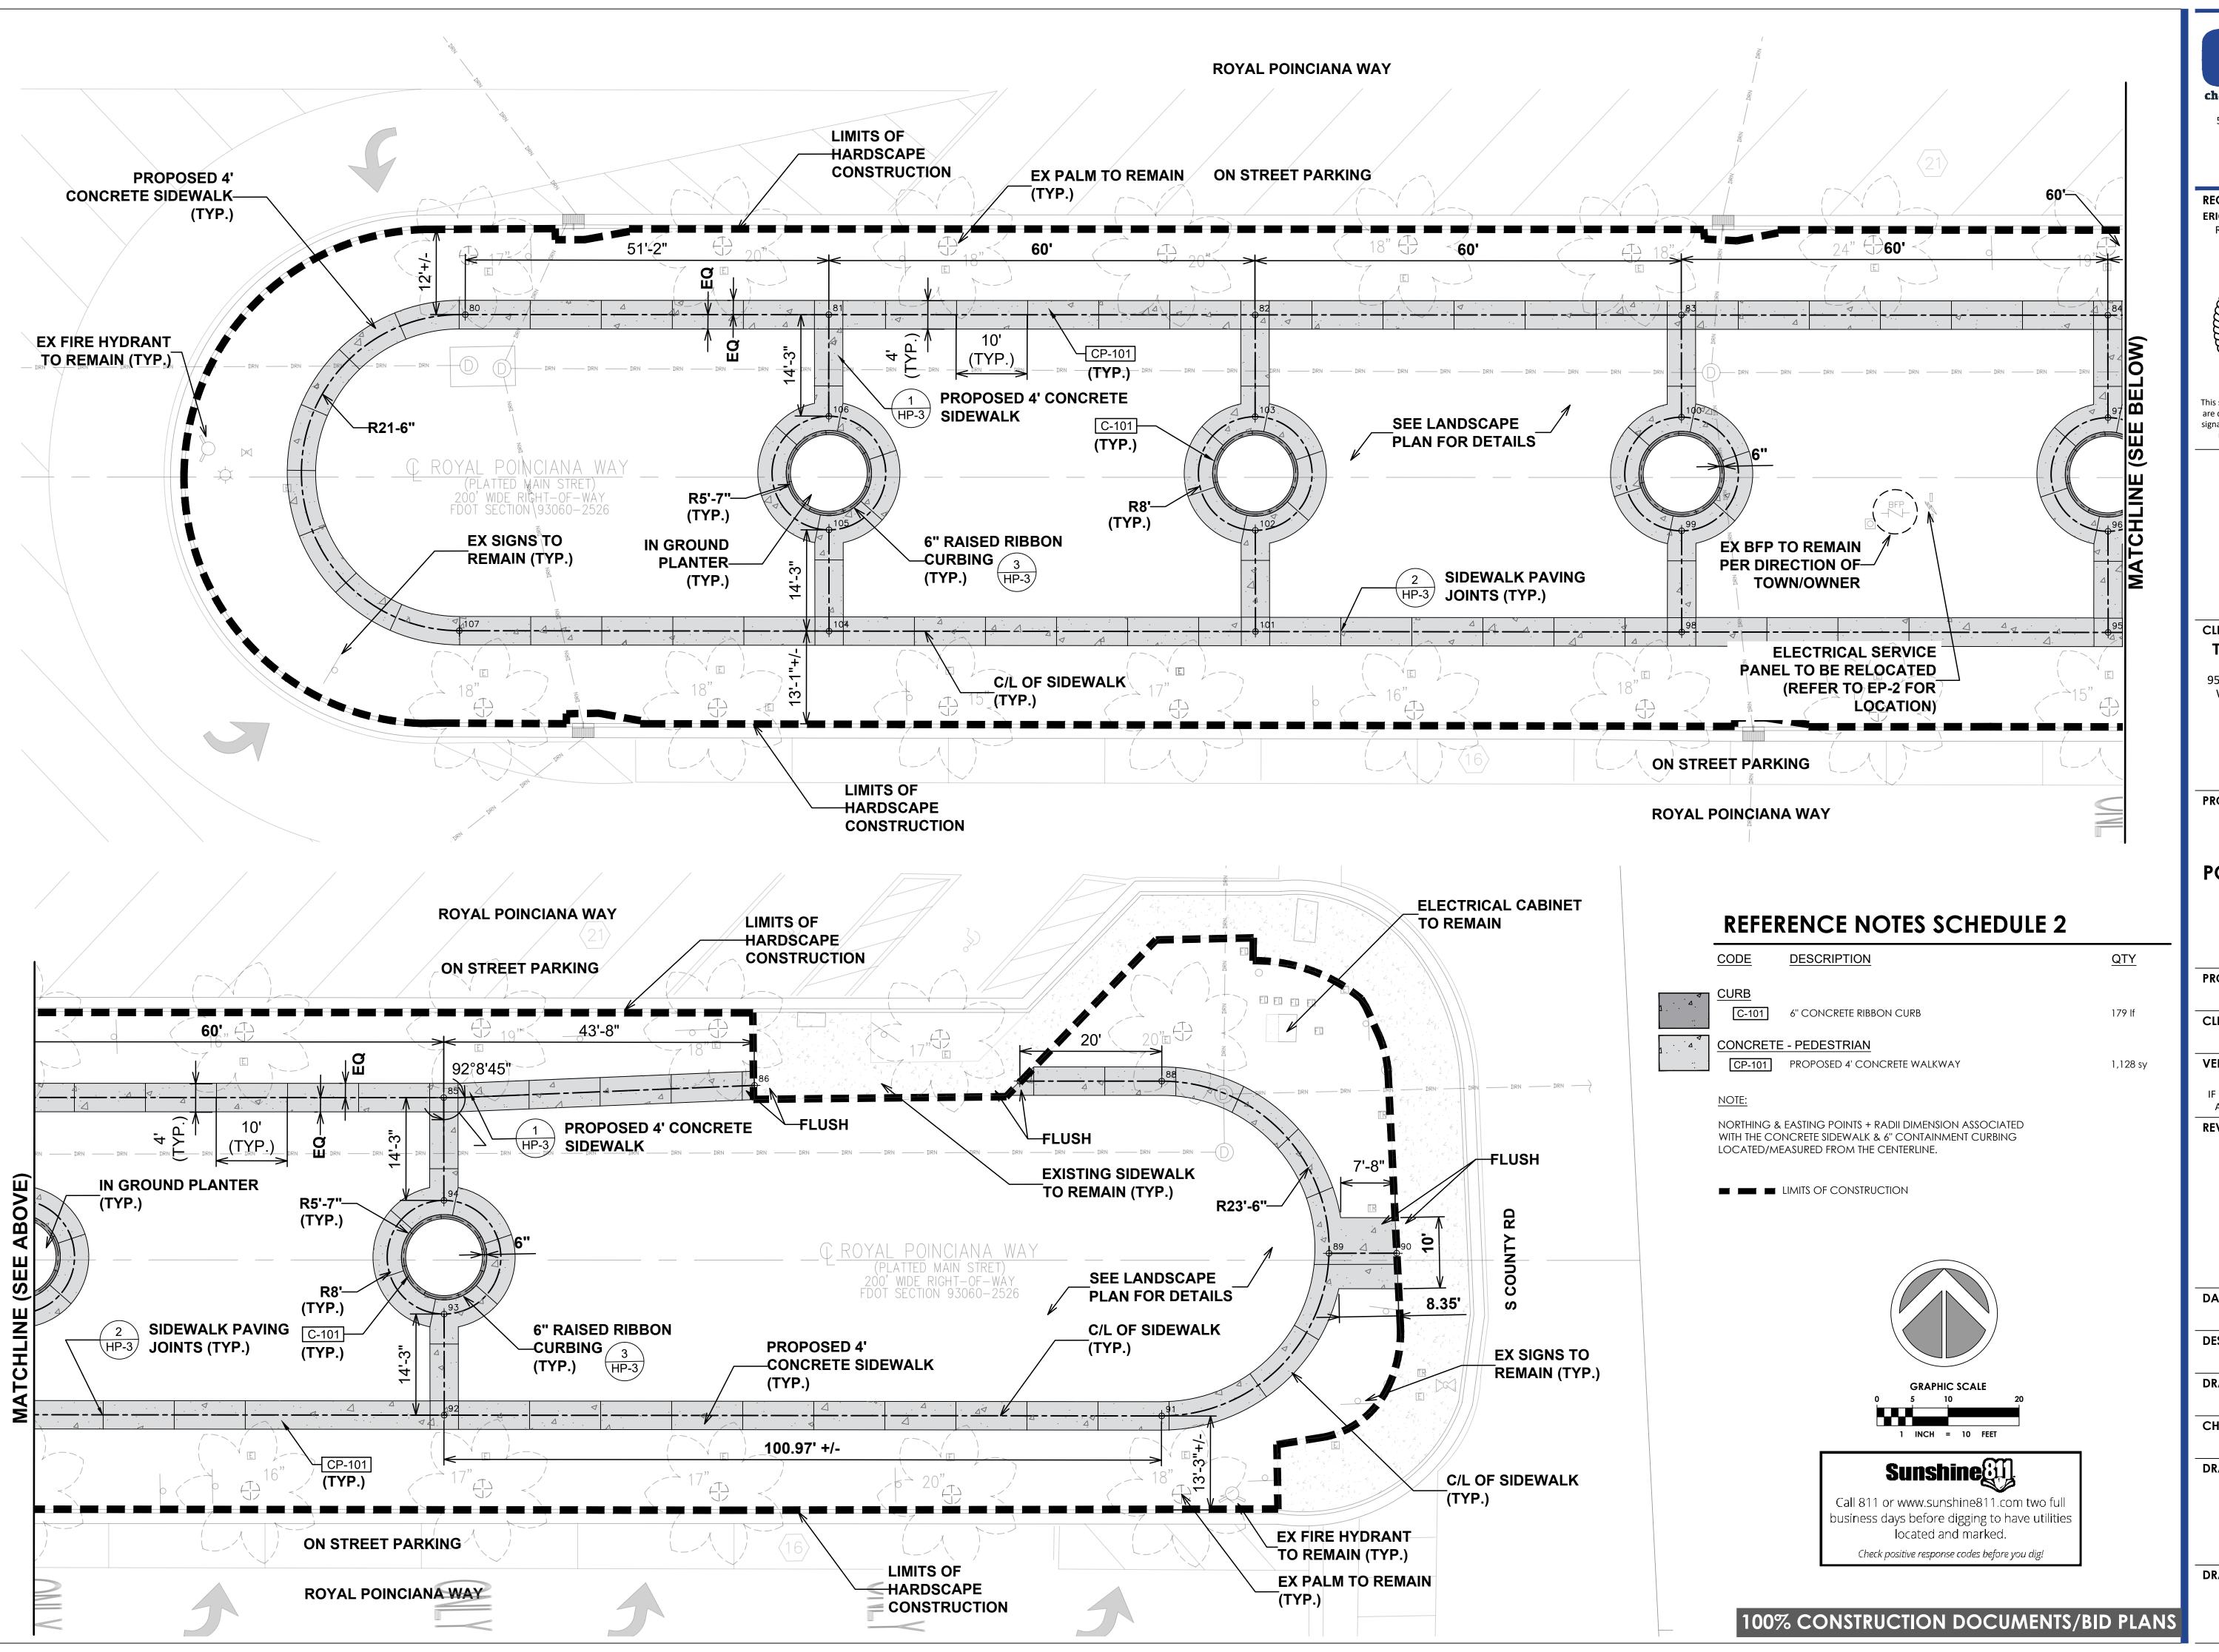
DRAWING TITLE

HARDSCAPE PLAN

DRAWING NUMBER

6 OF 26

100% CONSTRUCTION DOCUMENTS/BID PLANS





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REGISTRATION NO. **6667129**DATE: <u>1/23/2025</u>



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HARDSCAPE PLAN

DRAWING NUMBER

HP_

NORTHERN/EASTERN POINT SCHEDULE:


	POINT	NORTHING	EASTING
	30	N 867934.3398	E 969277.653
	31	N 867934.2237	E 969291.213
	32	N 867956.2620	E 969313.914
	33	N 867955.4616	E 969353.679
	34	N 867954.1393	E 969420.666
	35	N 867952.7648	E 969487.662
	36	N 867951.3900	E 969554.651
	37	N 867950.0686	E 969621.631
	38	N 867949.1253	E 969668.496
	39	N 867904.6658	E 969667.653
	40	N 867905.6099	E 969620.743
	41	N 867919.8407	E 969621.030
	42	N 867935.8376	E 969621.345
	43	N 867906.9522	E 969553.762
	44	N 867921.1889	E 969554.046
	45	N 867937.1858	E 969554.365
	46	N 867908.3066	E 969486.773
	47	N 867922.5373	E 969487.060
	48	N 867938.5341	E 969487.379
	49	N 867909.6548	E 969419.790
	50	N 867923.8857	E 969420.070
	51	N 867939.8825	E 969420.385
	52	N 867911.0031	E 969352.803
	53	N 867925.2339	E 969353.083
1	54	N 867941.2308	E 969353.399
WEST MEDIAN	55	N 867911.8047	E 969312.979
EAST MEDIAN >	80	N 867946.5583	E 969796.514
•	81	N 867945.5785	E 969847.662
	82	N 867944.3996	E 969907.657
	83	N 867943.2515	E 969967.618
	84	N 867942.0875	E 970027.624
	85	N 867940.9242	E 970087.595
	86	N 867941.8142	E 970131.357
	87	N 867941.7049	E 970168.700
	88	N 867941.3185	E 970188.670
	89	N 867916.6435	E 970211.745
	90	N 867916.4783	E 970221.258
	91	N 867894.2139	E 970187.761
	92	N 867896.2396	E 970086.812
	93	N 867910.4670	E 970087.062
	94	N 867926.4646	E 970087.342
	95	N 867897.4433	E 970026.826
	96	N 867911.6745	E 970027.074
	97	N 867927.6717	E 970027.373
	98	N 867898.6473	E 969966.827
	99	N 867912.8819	E 969967.084
	100	N 867928.8794	E 969967.368
	101	N 867899.8509	E 969906.849
	102	N 867914.0893	E 969907.099
	103	N 867930.0869	E 969907.381
	104	N 867901.0549	E 969846.850
	105	N 867915.2968	E 969847.110
	106	N 867931.2944	E 969847.389

N 867902.0989

E 969794.8222

HARDSCAPE DETAILS:


- 1 PROPOSED 4' CONCRETE SIDEWALK TROWELED 5 COMPACTED SUB-BASE (98% AASHTO, 12" MIN.)
- 2) 10G 6x6 W1.4xW1.4 WIRE MESH AS DIRECTED BY ENGINEER PLACE MESH AT BOTTOM THIRD OF SIDEWALK
- (6) CURB, WALL OR OTHER VERTICAL HARDSCAPE SURFACE.
- (4) CONSTRUCTION JOINT

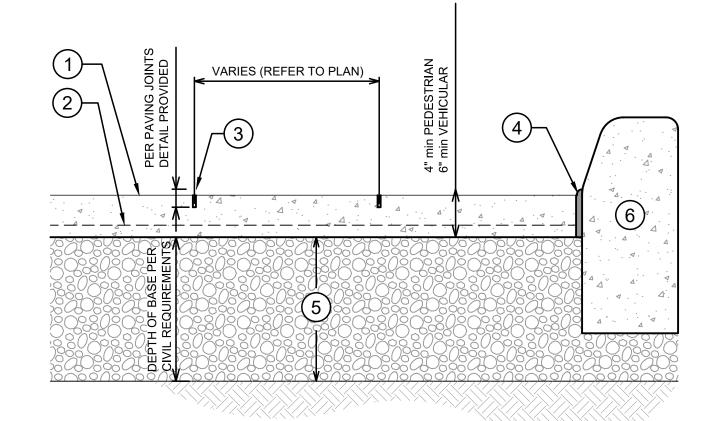

P-TH-07

P-CU-34


PROPOSED 4' CONCRETE SIDEWALK

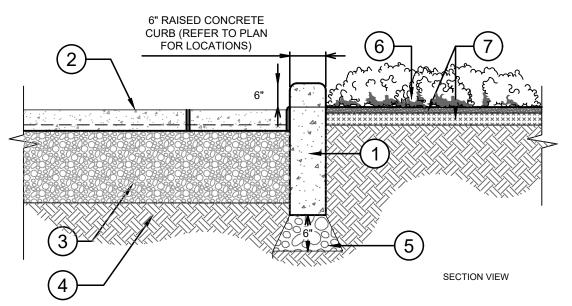


- 1 18" DEPTH, 3500 PSI FIBERMESH® REINF. CONC. CURB. SAW CUT JOINT REQUIRED
- EVERY ±15 INTERVAL.

 (2) EXPOSED CONCRETE TROWELED FINISH
- (3) COMPACTED SUB-BASE (98% AASHTO, 12" MIN)
- (4) EXISTING SUBGRADE
- (5) 6" MIN. COMPACTED CHRUSHED LIMEROCK BASE (95% MODIFIED PROCTOR)
- 6 PLANTER (SEE PLAN FOR LOCATIONS)
- 7 FINISH BED WITH EXISTING TOPSOIL


RAISED CONCRETE CONTAINMENT CURBING 3/4" = 1'-0"

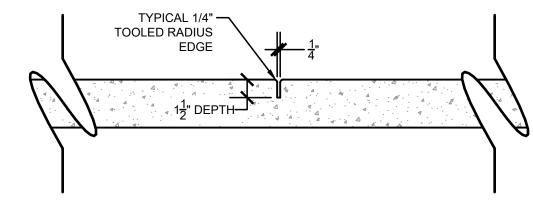


TOOLED CONTROL JOINT

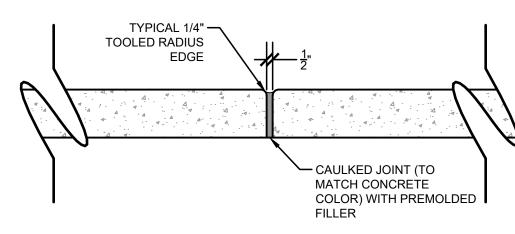

CONSTRUCTION JOINT

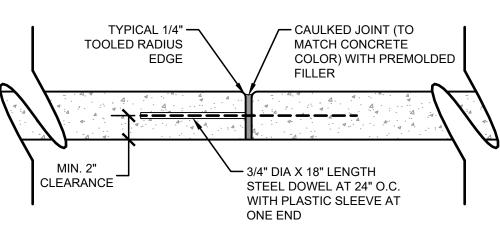

DOWELED CONSTRUCTION JOINT

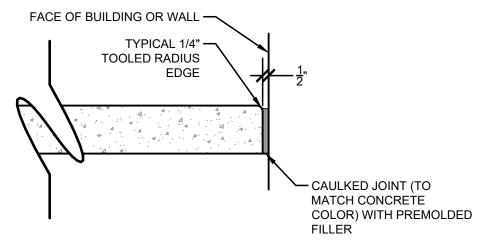

CONSTRUCTION JOINT AT BUILDING OR WALL

TYPICAL CONCRETE PAVING JOINTS 1 1/2" = 1'-0"

321313-20

GENERAL NOTES

- 1. ALL WALKWAYS SHALL BE ACCESSIBLE ROUTES WITH RUNNING SLOPES NOT TO EXCEED 1:20 AND CROSS SLOPES SHALL NOT EXCEED 1:50 AS PER 402.2 FBC.
- 2. ELEVATION CHANGES IN ACCESSIBLE ROUTE SHALL COMPLY WITH 303 FBC. SPECIAL ATTENTION TO BE PAID AT POINTS WHERE NEW WALKS
- 3. CONTRACTOR TO PROVIDE AN EXPANSION JOINT WHERE PROPOSED CONCRETE MEETS EXISTING CONCRETE.
- 4. PROVIDED QUANTITIES ARE ESTIMATES. ACTUAL QUANTITIES WILL VARY AND SHALL BE VERIFIED BY GENERAL CONTRACTOR.
- 5. BOUNDARY OF TREE PRESERVATION SHOWN FOR INFORMATIONAL PURPOSES ONLY. ACTUAL LOCATION, BOUNDARY AND QUANTITY OF TREE PRESERVATION FENCING TO BE QUANTIFIED BY GENERAL CONTRACTOR. ANY TREES WITHIN AN AREA OF IMPACT BY CONSTRUCTION RELATED ACTIVITY SHALL BE PROTECTED PER DETAIL PROVIDED ON TD-3.

EXISTING CONDITIONS/SURVEY NOTES

1. THE SURVEY DEPICTED HEREON IS CLASSIFIED AS A TOPOGRAPHIC AND TREE SURVEY AND IS IN COMPLIANCE WITH CHAPTER 5J-17 FLORIDA ADMINISTRATIVE CODE.

2. ENGENUITY GROUP, INC. AND THE CERTIFYING SURVEYOR ACCEPT NO RESPONSIBILITY FOR RIGHT-OF-WAYS, EASEMENTS RESTRICTIONS OR OTHER MATTERS AFFECTING TITLE TO THE LANDS SURVEYED OTHER THAN THOSE RECITED IN THE CURRENT DEED AND/OR OTHER INSTRUMENT OF RECORD FURNISHED BY THE CLIENT.

3. UNDERGROUND UTILITIES WERE NOT SEARCHED FOR OR LOCATED BY ENGENUITY GROUP, INC.

4. THE SURVEY IS NOT VALID WITHOUT THE ORIGINAL SIGNATURE AND RAISED SEAL OR ELECTRONIC SIGNATURE OF A FLORIDA LICENSED SURVEYOR AND MAPPER. OTHERWISE THIS MAP IS FOR INFORMATIONAL PURPOSES ONLY.

5. LAST DATE OF FIELD SURVEY: JULY 25, 2024

6. ALL DISTANCES SHOWN HEREON ARE IN U.S. FEET AND DECIMAL PARTS THEREOF UNLESS OTHERWISE NOTED.

7. ADDITIONS OR DELETIONS TO THE SURVEY MAP BY OTHER THAN THE SIGNING PARTY OR PARTIES IS PROHIBITED WITHOUT WRITTEN CONSENT OF THE SIGNING PARTY OR PARTIES.

8. ACCURACY STATEMENT: A FIELD SURVEY WAS PERFORMED IN ACCORDANCE WITH CHAPTER 5J-17, FLORIDA ADMINISTRATIVE CODE PURSUANT TO SECTION 472.027 FLORIDA STATE STATUTES FOR TOPOGRAPHIC SURVEYS. THE ACCURACY OF CONTROL DATA WAS VERIFIED BY REDUNDANT MEASUREMENTS OF TRAVERSE CLOSURES AND EXCEEDS COMMERCIAL/HIGH RISK: LINEAR: 1 FOOT IN 10,000 FEET.

9. THIS SURVEY WAS PREPARED WITHOUT THE BENEFIT OF A TITLE REPORT.

10. ALL DIMENSIONS SHOWN HEREON ARE MEASURED UNLESS OTHERWISE NOTED.

11. ELEVATIONS SHOWN HEREON ARE BASED ON THE NORTH AMERICAN VERTICAL DATUM OF 1988 (NAVD 1988) AND REFERENCE THE FOLLOWING BENCHMARK: TR 10 RM 1 ELEVATION=15.910 (NAVD 1988) AT PALM BEACH, 0.2 MILE EAST ALONG A PRIVATE DRIVEWAY FROM THE JUNCTION OF NORTH COUNTY ROAD, ABOUT 0.5 MILE NORTH OF THE INTERSCTION OF ROYAL PALM WAY, SET IN THE TOP OF THE WEST END OF THE CONCRETE SEAWALL WHICH IS ALONG THE NORTH SIDE OF THE BREAKERS HOTEL, 18 FEET NORTH OF THE NORTHWEST CORNER OF THE NORTHEAST WING OF THE HOTEL, 1.9 FEET EAST OF THE WEST END OF THE SEAWALL AND 3.3 FEET ABOVE THE LEVEL OF THE SIDEWALK.

12. THE FOLLOWING CONVERSION MAY BE USED TO CONVERT FROM THE NATIONAL GEODETIC VERTICAL DATUM OF 1929 (NGVD 29) TO THE NORTH AMERICAN VERTICAL DATUM OF 1988 (NAVD 88) (PER U.S ARMY CORPS OF ENGINEERS CORPSCON VERSION 6.0.1).

NGVD 29 - 1.574 = NAVD 88.

13. THIS SURVEY IS BASED ON THE FLORIDA STATE PLANE COORDINATE SYSTEM TRANSVERSE MERCATOR, FLORIDA EAST ZONE 901, NORTH AMERICAN DATUM OF 1983 (1990 ADJUSTMENT).

PAVING AND GRADING NOTES

- 1. ALL SIDEWALKS SHALL MEET ALL A.D.A. REQUIREMENTS (5% MAX. LONGITUDINAL SLOPE AND 2% MAX. TRANSVERSE SLOPE).
- 2. ALL NON-DIRECTIONAL WALKING SURFACES (OPEN AREAS/PLAZAS) SHALL BE CONSTRUCTED WITH 2% MAXIMUM SLOPE IN ANY GIVEN DIRECTION.
- 3. ALL CONNECTIONS TO EXISTING SIDEWALK SHALL BE MATCHED IN ELEVATION AND SAWCUT WITH A CLEAN JOINT.
- 4. BACKFILL MATERIAL UNDER PAVED AREAS SHALL BE COMPACTED TO 98% OF THE MAXIMUM DENSITY AS DETERMINED BY AASHTO T-180.
- 5. INSTALL DETECTABLE WARNING IN ACCORDANCE WITH FDOT SPECIFICATION 527
- 6. PLACE DETECTABLE WARNING ACROSS THE FULL WIDTH OF THE WALKWAY TO A MINIMUM OF TWO (2) FEET MEASURE PERPENDICULAR TO THE CURB LINE AND NO GREATER THAN FIVE (5) FEET FROM THE BACK OF THE CURB OR EDGE OF PAVEMENT

cma

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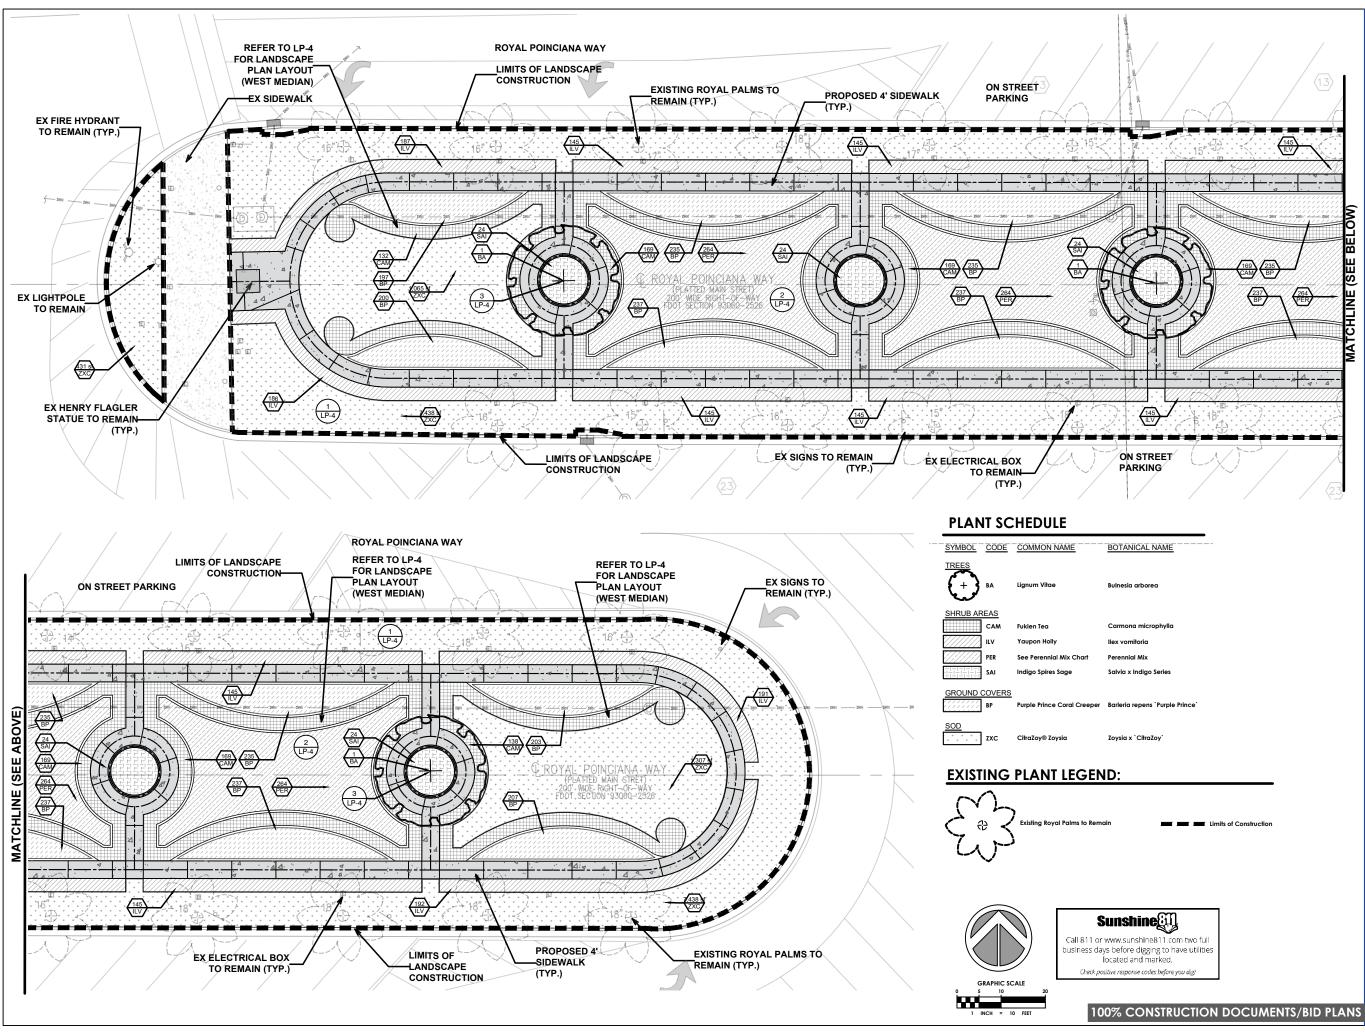
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HARDSCAPE DETAILS

8 OF 26



GM3

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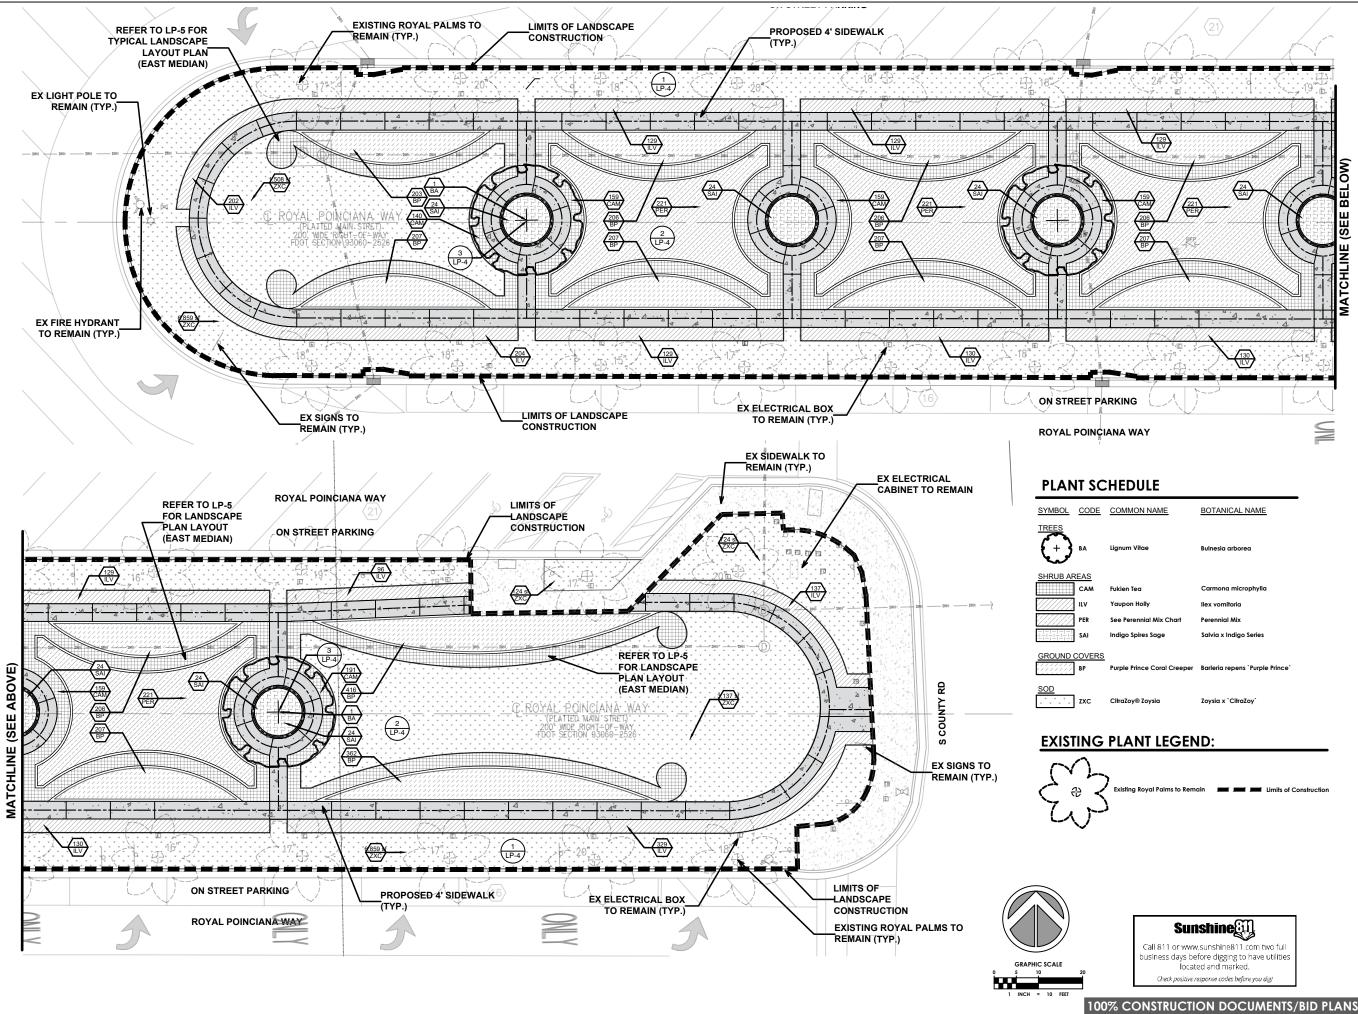
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DRAWING TITLE

LANDSCAPE PLAN

DRAWING NUMBER

LP-1



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LANDSCAPE PLAN

- 1.1.1. THESE GENERAL NOTES, CONSTRUCTION DOCUMENTS AND SPECIFICATIONS.
- ALL APPLICABLE LOCAL, STATE AND FEDERAL CODES, ORDINANCES AND REGULATIONS. 1.2. SOURCE OF BASE INFORMATION PROVIDED IS ASSUMED TO BE CORRECT. IF SITE DISCREPANCIES ARE PRESENT, CONTRACTOR SHALL NOTIFY OWNER'S REPRESENTATIVE IMMEDIATELY. IF CONTRACTOR CONTINUES WORK WITHOUT THE
- PROPER NOTIFICATION, CONTRACTOR DOES SO AT HIS OWN RISK. 1.3. THE CONTRACTOR SHALL FURNISH ALL MATERIALS, LABOR, SUPERVISION, AND EQUIPMENT REQUIRED FOR THE WORK AS SHOWN ON THE CONSTRUCTION DOCUMENTS DESCRIBED HEREIN.
- 1.4. CONTRACTOR SHALL BE RESPONSIBLE FOR ANY COORDINATION WITH SUB-CONTRACTORS AS REQUIRED TO COMPLETE THE WORK OF THIS PROJECT.
- 1.5. CONTRACTOR SHALL VERIFY LOCATIONS OF PERTINENT SITE IMPROVEMENTS INSTALLED UNDER OTHER CONTRACTS. IF ANY PART OF THIS PLAN CANNOT BE FOLLOWED DUE TO SITE CONDITIONS, CONTACT OWNER'S REPRESENTATIVE FOR INSTRUCTIONS PRIOR TO COMMENCING WORK.
- 1.6. CONTRACTOR TO NOTIFY "SUNSHINE STATE ONE CALL OF FLORIDA, INC." AT 1-800-432-4770 TWO FULL BUSINESS DAYS 6.2. THE PLANTING PLAN SHALL BE INSTALLED IN COMPLIANCE WITH ALL EXISTING CODES AND APPLICABLE DEED PRIOR TO DIGGING FOR UNDERGROUND UTILITY LOCATIONS.
- 1.7. CONTRACTOR IS RESPONSIBLE FOR DETERMINING ALL UTILITY LOCATIONS AND INSTALLING FACILITIES SO AS TO NOT CONFLICT. THE LOCATION OF EXISTING UTILITIES OR SITE FEATURES AS SHOWN ON THE PLANS MAY VARY IN RELATION TO ACTUAL EXISTING CONDITIONS. ANY DIFFERING SITE CONDITIONS FROM THAT WHICH IS REPRESENTED HEREON, WHETHER ABOVE, ON OR BELOW THE SURFACE OF THE GROUND, SHOULD BE BROUGHT TO THE IMMEDIATE ATTENTION OF THE LANDSCAPE ARCHITECT AND THE OWNER IN WRITING. NO CLAIM FOR EXPENSES INCURRED BY THE CONTRACTOR DUE TO DIFFERING SITE CONDITIONS WILL BE ALLOWED IF THE CONTRACTOR FAILS TO PROVIDE THE REQUIRED WRITTEN NOTIFICATION OF SUCH CONDITIONS FOR REVIEW BY THE LANDSCAPE ARCHITECT AND THE OWNER.
- 1.8. CONTRACTOR SHALL NOTIFY ALL APPROPRIATE UTILITY COMPANIES OF PROPOSED START OF WORK IN ACCORDANCE WITH THEIR STANDARD REQUIREMENTS, INCLUDING BUT NOT LIMITED TO, WATER, SANITARY SEWER, POWER, NATURAL GAS, TELEPHONE AND CABLE TV COMPANIES
- 1.9. IT SHALL BE THE CONTRACTOR'S SOLE RESPONSIBILITY TO TAKE THE NECESSARY PRECAUTIONS TO ENSURE PROPER SAFETY 6.8. AND WORKMANSHIP WHEN WORKING IN THE VICINITY OF EXISTING UTILITY LINES.
- 1.10. PERFORM EXCAVATION IN THE VICINITY OF UNDERGROUND UTILITIES WITH CARE AND BY HAND, IF NECESSARY. THE CONTRACTOR BEARS FULL RESPONSIBILITY FOR THIS WORK AND DISRUPTION OF DAMAGE TO UTILITIES SHALL BE REPAIRED IMMEDIATELY AND AT NO EXPENSE TO THE OWNER
- 1.11. THE SUCCESSFUL BIDDER SHALL FURNISH TO THE OWNER A UNIT PRICE BREAKDOWN FOR ALL MATERIALS. THE OWNER MAY, AT ITS DISCRETION, ADD OR DELETE FROM THE MATERIALS UTILIZING THE UNIT PRICE BREAKDOWN SUBMITTED.
- 1.12. IT IS THE RESPONSIBILITY OF THE CONTRACTOR TO ENSURE THAT ALL REQUIRED PERMITS ARE OBTAINED AND ARE IN HAND AT THE JOB SITE PRIOR TO THE COMMENCEMENT OF CONSTRUCTION. CONTRACTOR SHALL ABIDE BY ALL PERMIT CONDITIONS.

2. PRE-CONSTRUCTION RESPONSIBILITY

- 2.1. UPON RECEIPT OF NOTICE OF AWARD, THE CONTRACTOR SHALL ARRANGE A PRE-CONSTRUCTION CONFERENCE TO 6.13. ALL PLANTING BEDS IN MEDIANS, HARDSCAPE AREAS OR AREAS ENCOMPASSED BY IMPERVIOUS MATERIAL SHALL BE INCLUDE ALL INVOLVED GOVERNMENTAL AGENCIES, ALL AFFECTED UTILITY OWNERS, THE OWNER, THE LANDSCAPE ARCHITECT, ANY OTHER PERTINENT PARTIES AND HIMSELF.
- 2.2. CONTRACTOR SHALL PROVIDE TEMPORARY SANITARY FACILITIES ONSITE. LOCATION TO BE DETERMINED BY THE OWNER. JANITORIAL SERVICES SHALL BE PROVIDED BY CONTRACTOR THROUGHOUT THE DURATION OF PROJECT.
- 2.3. PRIOR TO BEGINNING CONSTRUCTION, THE CONTRACTOR SHALL PREPARE AN EXISTING CONDITIONS VIDEO RECORDING AND VERIFY THE SIZE, LOCATION, ELEVATION, AND MATERIAL OF ALL EXISTING UTILITIES WITHIN THE AREA OF CONSTRUCTION.
- 2.4. IF UPON EXCAVATION, AN EXISTING UTILITY IS FOUND TO BE IN CONFLICT WITH THE PROPOSED CONSTRUCTION OR TO BE OF A SIZE OR MATERIAL DIFFERENT FROM THAT SHOWN ON THE PLANS; THE CONTRACTOR SHALL IMMEDIATELY NOTIFY THE LANDSCAPE ARCHITECT.
- 2.5. IT SHALL BE THE CONTRACTOR'S RESPONSIBILITY TO MAKE ARRANGEMENTS FOR THE FIELD LOCATIONS AND FOR ANY TREES PROPOSED FOR RELOCATION. THIS SHALL BE DONE IN A TIMELY MANNER TO MINIMIZE IMPACT ON CONSTRUCTION SCHEDULE. ANY DELAY CAUSED BY THE CONTRACTOR BY THE RELOCATION OF TREES SHALL BE INCIDENTAL TO THE CONTRACT AND NO EXTRA COMPENSATION WILL BE ALLOWED.
- 2.6. CONTRACTOR SHALL VERIFY LIMITS OF CONSTRUCTION AS NOTED ON THE PLANS. ANY WORK PERFORMED OUTSIDE OF 6.19. ALL TREES SPECIFIED AS FIELD GROWN OR B&B TREES SHALL BE ROOT-PRUNED AT THE NURSERY A MINIMUM OF (8) WEEKS THE AGREED UPON LIMITS OF CONSTRUCTION SHALL BE DONE AT THE EXPENSE OF THE CONTRACTOR.

3. SITE DEMOLITION 3.1. ITEMS SHALL REMAIN UNLESS OTHERWISE NOTED ON THE PLAN(S), REMOVE DESIGNATED ITEMS SHOWN ON THE PLAN TO

- THE FULL DEPTH OF THEIR CONSTRUCTION UNLESS OTHERWISE NOTED. 3.2. ALL HARDSCAPE DESIGNATED FOR REMOVAL SHALL BE SAW CUT, LEAVING UNIFORM EDGES TO THE GREATEST EXTENT
- POSSIBLE. MATERIAL EDGES TO REMAIN SHALL BE SHORED UP AND PROTECTED DURING CONSTRUCTION TO PRESERVE EDGE INTACT. REPAIRS TO DAMAGED EDGES SHALL BE REPAIRED BY CONTRACTOR AT NO ADDITIONAL COST TO THE
- 3.3. NO EXISTING MATERIAL SHALL BE USED IN NEW CONSTRUCTION UNLESS NOTED ON THE PLANS OR APPROVED DURING THE SHOP DRAWING APPROVAL PROCESS.
- 3.4. SALVAGE EXISTING MATERIALS AS INDICATED ON THE PLANS. SALVAGED MATERIALS SHALL BE HANDLED WITH CARE AND STORED ON-SITE OR AS DIRECTED BY OWNER. CLEAN ALL DEBRIS AND CONSTRUCTION MATERIAL FROM SALVAGED ITEMS; REUSE AS DIRECTED BY OWNER'S REPRESENTATIVE
- 3.5. REMOVE DEMOLISHED MATERIALS FROM SITE AND DISPOSE OF AS REQUIRED BY LOCAL, STATE OR FEDERAL LAWS.
- 3.6. CONTRACTOR SHALL PROTECT ADJACENT WATER BODIES, COASTAL DUNE SYSTEMS AND PROPERTIES FROM DAMAGE BY
 6.27. TREES THAT CANNOT STAND WITHOUT THE SUPPORT OF STAKES AND/OR GUYS SHALL BE REJECTED. SEDIMENTATION OR OTHER POTENTIAL CONSTRUCTION RELATED CAUSES.
- 3.7. ALL IRRIGATION IN DEMOLITION AREA TO BE CAPPED AND ADJUSTED AS NECESSARY TO ENSURE OVERALL SYSTEM IS NOT 7.1. ALL AREAS NOT USED FOR BUILDINGS, VEHICULAR USE AREAS, WALKWAYS OR PLANTING BEDS SHALL BE GRASSED.

4. TREE PRESERVATION

- 4.1. ALL TREES TO BE PRESERVED AS INDICATED ON THE TREE DISPOSITION PLAN SHALL BE PROTECTED BY A TREE PROTECTION 8. MULCH & FERTILIZER BARRICADE, UNLESS OTHERWISE NOTED ON PLAN.
- 4.2. TREE PROTECTION BARRICADES SHALL BE PROVIDED BY LANDSCAPE CONTRACTOR AROUND THE DRIP LINE OF EXISTING TREES TO BE PRESERVED IN PLACE, AS SHOWN ON PLAN. PRESERVATION BARRICADES SHALL BE LEFT IN PLACE THROUGHOUT DURING ALL PHASES OF CONSTRUCTION.
- 4.3. PRIOR TO ANY CONSTRUCTION A TREE PROTECTION BARRICADE INSPECTION SHALL BE CONDUCTED BY THE LANDSCAPE ARCHITECT, OWNER OR GOVERNING MUNICIPALITY. REFER TO PLANS FOR TREE PRESERVATION BARRICADE FENCING
- 4.4. IF EXCAVATION IN THE VICINITY OF A PROTECTED TREE IS REQUIRED, CONTRACTOR SHALL ROOT PRUNE TREES, UNDER THE SUPERVISION OF A CERTIFIED ARBORIST IN ACCORDANCE TO THE FOLLOWING CONDITIONS:
- 4.4.1. ROOT PRUNE TREES A MINIMUM OF EIGHT (8) WEEKS PRIOR TO CONSTRUCTION. PRIOR TO ROOT PRUNING, THOROUGHLY WATER THE ROOT ZONE WITH AT LEAST 2 TO 3 INCHES OF WATER FOR 2 TO 3 DAYS PRIOR TO ROOT PRUNING. SEE BELOW FOR RELOCATION TIMELINE
 - 1. PROVIDE TEMPORARY IRRIGATION FOR EACH TREE THROUGHOUT THE DURATION OF CONSTRUCTION.
 - 2. ROOT PRUNE TREES, SHOWN ON PLAN IN AREAS WHERE ROOTS WILL CONFLICT WITH CONSTRUCTION ACTIVITY. PRUNING OF ROOTS SHOULD BE DONE IN A MANNER TO PRESERVE THE GREATEST AMOUNT OF THE ROOT BASE AS POSSIBLE.
 - 3. BACKFILL TRENCH WITH PLANTING SOIL.
- 4. FERTILIZE WITHIN THE ROOT ZONE (SEE BELOW).
- 4.4.2. ROOT PRUNING SHALL BE ACCOMPLISHED BY DIGGING A TRENCH AROUND THE TREE IN AREAS WHERE PROPOSED SITE WORK WILL BE PERFORMED. TRENCHING SHALL BE AT A MINIMUM OF 24" DEEP. ROOT PRUNE ONLY WITH A MECHANICAL ROOT-PRUNING SAW OR A TRENCHER WITH A MAXIMUM TRENCH WIDTH OF 8".
- 4.4.3. ALL EXPOSED ROOTS SHALL BE CUT OFF SMOOTHLY, WITH SHARP INSTRUMENTS. BACKFILL TRENCHES WITH SOIL CONSISTING OF 30% SILICA SAND AND 70% MUCK. WATER THOROUGHLY AFTER ROOT PRUNING, AND ONCE WEEKLY DURING THE ROOT REGENERATION PERIOD, WITH A SOLUBLE FERTILIZER THAT HAS A 20.20.20 ANALYSIS AT MANUFACTURER'S RECOMMENDED RATE.
- 4.5. THE CONTRACTOR SHALL FIELD STAKE THE LIMIT OF ROOT PRUNING. LIMITS OF ROOT PRUNING SHALL BE APPROVED BY

- THE LANDSCAPE ARCHITECT PRIOR TO ANY EXCAVATION. DO NOT ROOT PRUNE FOR IRRIGATION OR ELECTRICAL LINES WITHIN DRIP LINES OF EXISTING TREES. COORDINATE ALL TRENCHING REQUIRED FOR UTILITY WORK WITH THE LANDSCAPE
- 4.6. ROOT PRUNING SHALL OCCUR IN ACCORDANCE WITH TREE RELOCATION NOTES AS NOTED ON PLANS.

- 5.1. ALL TREES SHALL BE PLANTED WITH A MINIMUM OF 12" TOPSOIL AROUND AND BENEATH THE ROOTBALL.
- 5.2. ALL TREES AND SHRUBS SHALL BE PLANTED WITH A MINIMUM OF 6" TOPSOIL AROUND AND BENEATH THE ROOTBALL.
- 5.3. MINIMUM TOPSOIL SHALL BE 2" FOR SODDED GRASS AREAS. 5.4. PLANTING SOIL MIX SHALL BE A WEED FREE MIX AS FOLLOWS:
- TREES: 60% SAND, 40% MUCK
- 5.4.2. PALMS: 80% SAND & 20% MUCK

5.4.3. TURF: 80% SAND, 20% MUCK

- 6.1. THIS PLAN HAS BEEN DESIGNED TO MEET OR EXCEED ALL APPLICABLE CODES
- PLANT MATERIAL: ALL PLANT MATERIAL SHALL BE FLORIDA #1 OR BETTER AS ESTABLISHED BY "GRADES AND STANDARDS FOR NURSERY PLANTS" OF THE STATE OF FLORIDA, DEPARTMENT OF AGRICULTURE.
- ALL PLANT MATERIAL SHALL BE TRUE TO THE BOTANICAL NAME, GENUS, SPECIES AND/OR HYBRID DESIGNATION
- ALL TREES, SHRUBS AND GROUNDCOVERS SHALL BE OF THE SIZES (HEIGHT & SPREAD) AS SPECIFIED IN THE PLANT LIST. CONTAINER SIZE IS FOR REFERENCE PURPOSES ONLY. ALL PLANT MATERIAL SHALL MEET OR EXCEED THE MINIMUM SIZES AT INSTALLATION, AS SPECIFIED IN THE PLANT LIST.
- 6.6. QUANTITIES LISTED ON THE PLANT LIST ARE FOR ESTIMATING PURPOSES. CONTRACTOR SHALL VERIFY ALL QUANTITIES. MULCH, TOPSOIL, FERTILIZER, ETC. SHALL BE INCLUDED IN THE UNIT COST OF THE PLANTS.
- WHERE THERE IS A DISCREPANCY EITHER IN QUANTITIES, PLANT NAMES, SIZES OR SPECIFICATIONS BETWEEN THE PLAN OR PLANT LIST, THE PLAN TAKES PRECEDENCE.
- ALL SUBSTITUTIONS AND CHANGES SHALL BE APPROVED IN WRITING PRIOR TO INSTALLATION. ANY DISCREPANCIES BETWEEN PLANS, SITE AND SPECIFICATIONS SHALL BE BROUGHT TO THE IMMEDIATE ATTENTION OF THE LANDSCAPE ARCHITECT, THE OWNER AND/OR GOVERNING MUNICIPALITY.
- CONTRACTOR SHALL BE RESPONSIBLE FOR PROVIDING FINAL GRADING OF ALL ASSOCIATED PLANTING AREAS. 6.10. AFTER FINAL GRADE, LANDSCAPE AREAS ARE TO BE RAKED TO A DEPTH OF 6". ALL ROCK AND FOREIGN INORGANIC
- MATERIALS SHALL BE REMOVED AND DISPOSED OF PROPERLY OFF-SITE.
- 6.11. ALL PLANTING HOLES TO BE HAND DUG EXCEPT WHERE MACHINE DUG HOLES WILL NOT ADVERSELY AFFECT EXISTING TREES, DAMAGE UTILITIES OR OTHER IMPROVEMENTS.
- 6.12. ALL PLANTING BEDS IN OPEN AREAS AND AROUND BUILDING FOUNDATIONS SHALL BE EXCAVATED TO A DEPTH OF TWENTY-FOUR INCHES (24") AND BACK FILLED WITH SOIL MIX AS SPECIFIED IN SECTION 5.00. PLANTING BED SHALL BE FREE FROM ROCK, CONSTRUCTION DEBRIS OR OTHER EXTRANEOUS MATERIAL.
- EXCAVATED TO A DEPTH OF THIRTY-SIX INCHES (36") OR UNTIL NATIVE SOILS ENCOUNTERED TO ENSURE DRAINAGE. BACK FILL WITH SOIL MIX AS SPECIFIED IN SECTION 5.00. PLANTING BED SHALL BE FREE FROM ROCK, CONSTRUCTION **DEBRIS OR OTHER EXTRANEOUS MATERIAL**
- 6.14. EXCAVATE PLANTING PITS TO A DEPTH SO THAT THE TRUNK FLARE AND FIRST ORDER LATERAL ROOT(S) WILL BE PLANTED AT FINISH GRADE OR SLIGHTLY HIGHER. ADVENTITIOUS ROOTS ARE NOT CONSIDERED FIRST ORDER ROOTS.
- BURLAP, SYNTHETIC STRING, CORDS AND/OR LIFTING ROPES SHALL BE REMOVED FROM THE ROOTBALLS BEFORE ANY TREES ARE PLANTED. THE TOP 1/3RD OF BURLAP MUST BE REMOVED FROM HE TOP OF THE ROOTBALLS. THE TOP 1/3RD OF WIRE BASKETS SHALL BE COMPLETELY REMOVED AND THE BOTTOM 2/3RDS SHALL BE CUT BEFORE THE TREES ARE
- 6.16. NO PLUNGING OF ANY TREE OR PALM WILL BE ACCEPTED.
- 6.17. NO PLANT MATERIAL WILL BE ACCEPTED SHOWING EVIDENCE OF CABLE, CHAIN MARKS, EQUIPMENT SCARS, OR
- 6.18. PLANT MATERIAL WILL NOT BE ACCEPTED WHEN THE BALL OF EARTH SURROUNDING ITS ROOTS HAS BEEN CRACKED, BROKEN OR OTHERWISE DAMAGED.
- 6.20. ALL PLANT MATERIAL PLANTED WITHIN THE SIGHT DISTANCE TRIANGLE AREAS SHALL BE MAINTAINED TO PROVIDE UNOBSTRUCTED CROSS-VISIBILITY AT A HORIZONTAL LEVEL BETWEEN 30 INCHES AND 8 FEET ABOVE ADJACENT STREET
- 6.21. NO CANOPY TREES SHALL BE PLANTED WITHIN 12 FEET OF A LIGHT POLE. NO PALM SPECIES SHALL BE PLANTED WITHIN 6
- 6.22. GROUND COVER PLANTINGS SHALL PROVIDE NOT LESS THAN 50 PERCENT COVERAGE IMMEDIATELY UPON PLANTING
- AND 100 PERCENT COVERAGE WITHIN 6 MONTHS AFTER PLANTING. 6.23. TREES AND PALMS SHALL BE MAINTAINED TO ALLOW FOR CLEAR PASSAGE 8' IN ALL PEDESTRIAN AREAS.
- 6.24. ALL LANDSCAPE MATERIAL SHALL BE SETBACK A MINIMUM OF 10' FROM ANY FIRE HYDRANT. 6.25. CONTRACTOR SHALL REMOVE ALL NURSERY STAKES, CONDUIT, FLAGGING AND NURSERY TAPE PRIOR TO STAKING.
- 6.26. CONTRACTOR SHALL STAKE & GUY ALL TREES AND PALMS AT TIME OF PLANTING AS PER THE APPROPRIATE DETAIL. CONTRACTOR IS RESPONSIBLE FOR THE MAINTENANCE AND/OR REPAIR OF ALL STAKING AND GUYING DURING WARRANTY PERIOD AND REMOVAL & DISPOSAL OF STAKING AFTER ESTABLISHMENT/WARRANTY PERIOD.

7. TURF GRASSES

GRASSING SHALL EXTEND TO ANY ABUTTING STREET PAVEMENT EDGE AND TO THE MEAN WATERLINE OF ANY ABUTTING CANAL, LAKE OR WATERWAY. REFER TO PLANTING SCHEDULE FOR ESTIMATED QUANTITY AND SPECIES.

- 8.1. ALL PLANTING BEDS AND WATER BASINS FOR TREES SHALL BE COVERED WITH MULCH SHALL BE SHREDDED GRADE "A" EUCALYPTUS OR MELALEUCA MULCH, MANUFACTURED BY ACTION NURSERY PRODUCTS, INC., FORT MYERS, FL 33911, OR APPROVED EQUAL
- 8.2. INDIVIDUAL TREES PLANTED IN LAWN AREAS SHALL BE MULCHED WITH A MINIMUM 3' DIAMETER MULCH RING.
- MULCH SHALL NOT BE INSTALLED WITHIN 3" OF TREE TRUNKS.

8.4. FERTILIZER SHALL CONFORM AS FOLLOWS:

FERTILIZER CONTENT SHALL CONFORM TO THE FOLLOWING

CONSTITUENT PRESENT BY WEIGHT (50PERCENT IN SLOW RELEASE FORM) NITROGEN (N) PHOSPHORUS (P) POTASSIUM (K) (50 PERCENT IN SLOW RELEASE FORM

(A) 50 PERCENT OF NITROGEN SHALL BE DERIVED FROM NATURAL ORGANIC SOURCE OF UREAFORM. 50 PERCENT OF NITROGEN SHALL BE DERIVED FROM SLOW RELEASE

NITROGEN. (B) AVAILABLE PHOSPHORUS SHALL BE DERIVED FROM SUPERPHOSPHATE, BONE

- MEAL, OR TANKAGE. (C) POTASSIUM SHALL BE DERIVED FROM SULFUR-COATED POTASSIUM. 50 PERCENT OF
- POTASSIUM SHALL BE DERIVED FROM SLOW RELEASE POTASSIUM. FERTILIZER SHALL BE DELIVERED IN MANUFACTURER'S STANDARD CONTAINER PRINTED WITH MANUFACTURER'S NAME, MATERIAL WEIGHT AND GUARANTEED ANALYSIS.
- CONTROLLED-RELEASE FERTILIZER SHALL BE EQUAL TO THE FOLLOWING:

MANUFACTURER PALM MIX AND GENERAL FERTILIZER

ATLANTIC F.E.C.- 18375 S.W. 260 STREET HOMESTEAD, FL 33031

AGRIFORM 20-10-5 PLANTING TABLES SIERRA CHEMICAL CO., MILPITAS, CA 95035

- 1.1. ALL LANDSCAPED AREAS WILL BE IRRIGATED BY AN UNDERGROUND, AUTOMATIC, RUST-FREE IRRIGATION SYSTEM PROVIDING 100% COVERAGE AND 50% SPRAY OVERLAP. THE SYSTEM SHALL BE MAINTAINED IN GOOD WORKING ORDER AND DESIGNED TO MINIMIZE WATER ON IMPERVIOUS SERVICES AND NOT OVERSPRAY WALKWAYS. A RAIN SENSOR DEVICE SHALL BE INSTALLED TO OVERRIDE THE IRRIGATION CYCLE OF THE SYSTEM WHEN ADEQUATE RAINFALL HAS OCCURRED.
- 1.2. ALL PLANT MATERIAL SHALL BE WATERED AT TIME OF PLANTING IN ACCORDANCE WITH STANDARD NURSERY PRACTICES. IN ADDITION, CONTRACTOR WILL CONTINUE THE WATERING OF PLANT MATERIAL UNTIL SUBSTANTIAL COMPLETION AND THE LANDSCAPE IS TURNED OVER TO THE OWNER.

2. PROJECT CLOSEOUT

- 2.1. DURING CONSTRUCTION, THE PROJECT SITE AND ALL ADJACENT AREAS SHALL BE MAINTAINED IN A NEAT AND CLEAN MANNER. UPON FINAL CLEAN UP, THE PROJECT SITE SHALL BE LEFT CLEAR OF ALL SURPLUS MATERIAL OR TRASH. THE PAVED AREAS SHALL BE SWEPT BROOM CLEAN.
- 2.2. THE CONTRACTOR SHALL RESTORE, REPLACE OR AS DIRECTED BY THE LANDSCAPE ARCHITECT, ANY PUBLIC OR PRIVATE PROPERTY DAMAGED BY THE WORK OF THE CONTRACTOR, HIS EQUIPMENT, EMPLOYEES OR THOSE OF HIS SUB-CONTRACTORS. THIS WORK SHALL BE RESTORED TO A CONDITION EQUAL TO OR BETTER THAN THAT OF THE EXISTING ADJACENT AREAS. THE RESTORATION WORK SHALL BE AT THE CONTRACTOR'S EXPENSE. SUITABLE MATERIALS AND METHODS SHALL BE USED FOR SUCH RESTORATION.
- 2.3. WHERE MATERIAL OR DEBRIS HAS WASHED OR FLOWED INTO OR BEEN PLACED IN WATER COURSES, DITCHES, DRAINS, CATCH BASINS, OR ELSEWHERE AS A RESULT OF THE CONTRACTOR'S OPERATIONS, SUCH MATERIAL OR DEBRIS SHALL BE REMOVED AND SATISFACTORILY DISPOSED OF DURING PROGRESS OF THE WORK. THESE AREAS SHALL BE KEPT IN A CLEAN AND NEAT CONDITION.
- 2.4. THE CONTRACTOR SHALL MAINTAIN ACCURATE AND COMPLETE RECORDS OF WORK ITEMS COMPLETED.
- 2.5. UPON COMPLETION OF CONSTRUCTION, THE CONTRACTOR SHALL SUBMIT TO THE LANDSCAPE ARCHITECT OF RECORD COMPLETE SETS OF "AS-BUILT" CONSTRUCTION DRAWINGS. THESE DRAWINGS SHALL BE MARKED TO SHOW "AS-BUILT" CONSTRUCTION CHANGES AND DIMENSIONED LOCATIONS AND ELEVATIONS OF ALL IMPROVEMENTS INCLUDING PRODUCT/EQUIPMENT AS SPECIFIED OR REVISED DURING THE SHOP DRAWING SUBMITTAL PROCESS. AS-BUILT DRAWINGS SHALL BE SIGNED AND SEALED BY A FLORIDA REGISTERED LAND SURVEYOR.

3. GUARANTEE

- 3.1. ALL NEW PLANT MATERIAL SHALL BE GUARANTEED FOR 1 YEAR FROM TIME OF FINAL ACCEPTANCE OF PROJECT. ANY PLANT MATERIAL NOT IN A HEALTHY GROWING CONDITION WILL BE REPLACED IN KIND BY THE CONTRACTOR AT NO ADDITIONAL COST TO THE OWNER WITHIN 10 DAYS OF NOTIFICATION.
- 3.2. FOR ALL REPLACEMENT PLANT MATERIAL, THE WARRANTY PERIOD SHALL BE EXTENDED AN ADDITIONAL 90 DAYS BEYOND THE ORIGINAL WARRANTY PERIOD. REPLACEMENT MATERIAL SHALL BE REPLACED IN KIND AS IT RELATES TO SPECIES, **QUANTITY AND SIZE.**
- 3.3. ALL TREES THAT LEAN OR ARE BLOWN OVER, CAUSED BY WINDS LESS THAN 74 MPH AS DETERMINED BY THE NATIONAL HURRICANE CENTER, WILL BE RE-SET AND BRACED BY THE CONTRACTOR AT NO ADDITIONAL COST TO THE OWNER

22,604 sf CitraZoy® Zoysia

PLANT SCHEDULE


SYMBOL CODE	QTY	COMMON NAME	BOTANICAL NAME	CONT	SIZE	NATIVE		REMARKS
TREES + BA	6	Lignum Vitae	Bulnesia arborea	FG	14` - 16` HT, 4" CAL	Yes		
SYMBOL CODE	QTY	COMMON NAME	BOTANICAL NAME	CONT	SIZE	NATIVE	SPACING	REMARKS
SHRUB AREAS								
CAM	1,912	Fukien Tea	Carmona microphylla	7 gal		No	24" o.c.	DENSLEY FOLIATED
ILV	3,919	Yaupon Holly	llex vomitoria	3 gal		Yes	14" o.c.	DENSLEY FOLIATED
PER	1,940	See Perennial Mix Chart	Perennial Mix	3 gal		No	24" o.c. ——	PHILLIPE VIOLET AFRICAN IRIS SCARLET SAGE WILD ALAMANDA WHITE GRAFFITI ASIAN SNOW JASMINE
SAI	240	Indigo Spires Sage	Salvia x Indigo Series	3 gal		No	24" o.c.	
SYMBOL CODE	QTY	COMMON NAME	BOTANICAL NAME	CONT	SIZE	NATIVE		REMARKS
GROUND COVERS	5,541	Purple Prince Coral Creeper	Barleria repens `Purple Prince`	1 gal	3"-4" HT	No		
SOD								

Zoysia x `CitraZoy`

500 West Cypress Creek Road Ft. Lauderdale, FL 33309 954.730.0707 www.chenmoore.com

REGISTRATION

ERIC DOUGLAS HARRISON, RLA REGISTRATION NO. 6667129

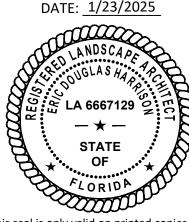

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CLIENT

Town of Palm Beach Public Works 951 Okeechobee Road, Suite A West Palm Beach, FL 33401 561.838.5440 Project Manager:

Mike Roach, PE

PROJECT INFORMATION

ROYAL **POINCIANA WAY**

PROJECT NUMBER 24-0431.00060

CLIENT PROJECT NUMBER PO 240844

VERIFY SCALES

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REVISIONS

DATE OF ISSUE 1/17/25

DESIGNED BY


ESF/EDH DRAWN BY

CHECKED BY ESF/EDH

ESF/EDH

DRAWING TITLE LANDSCAPE **SPECIFICATIONS**

SCHEDULE DRAWING NUMBER

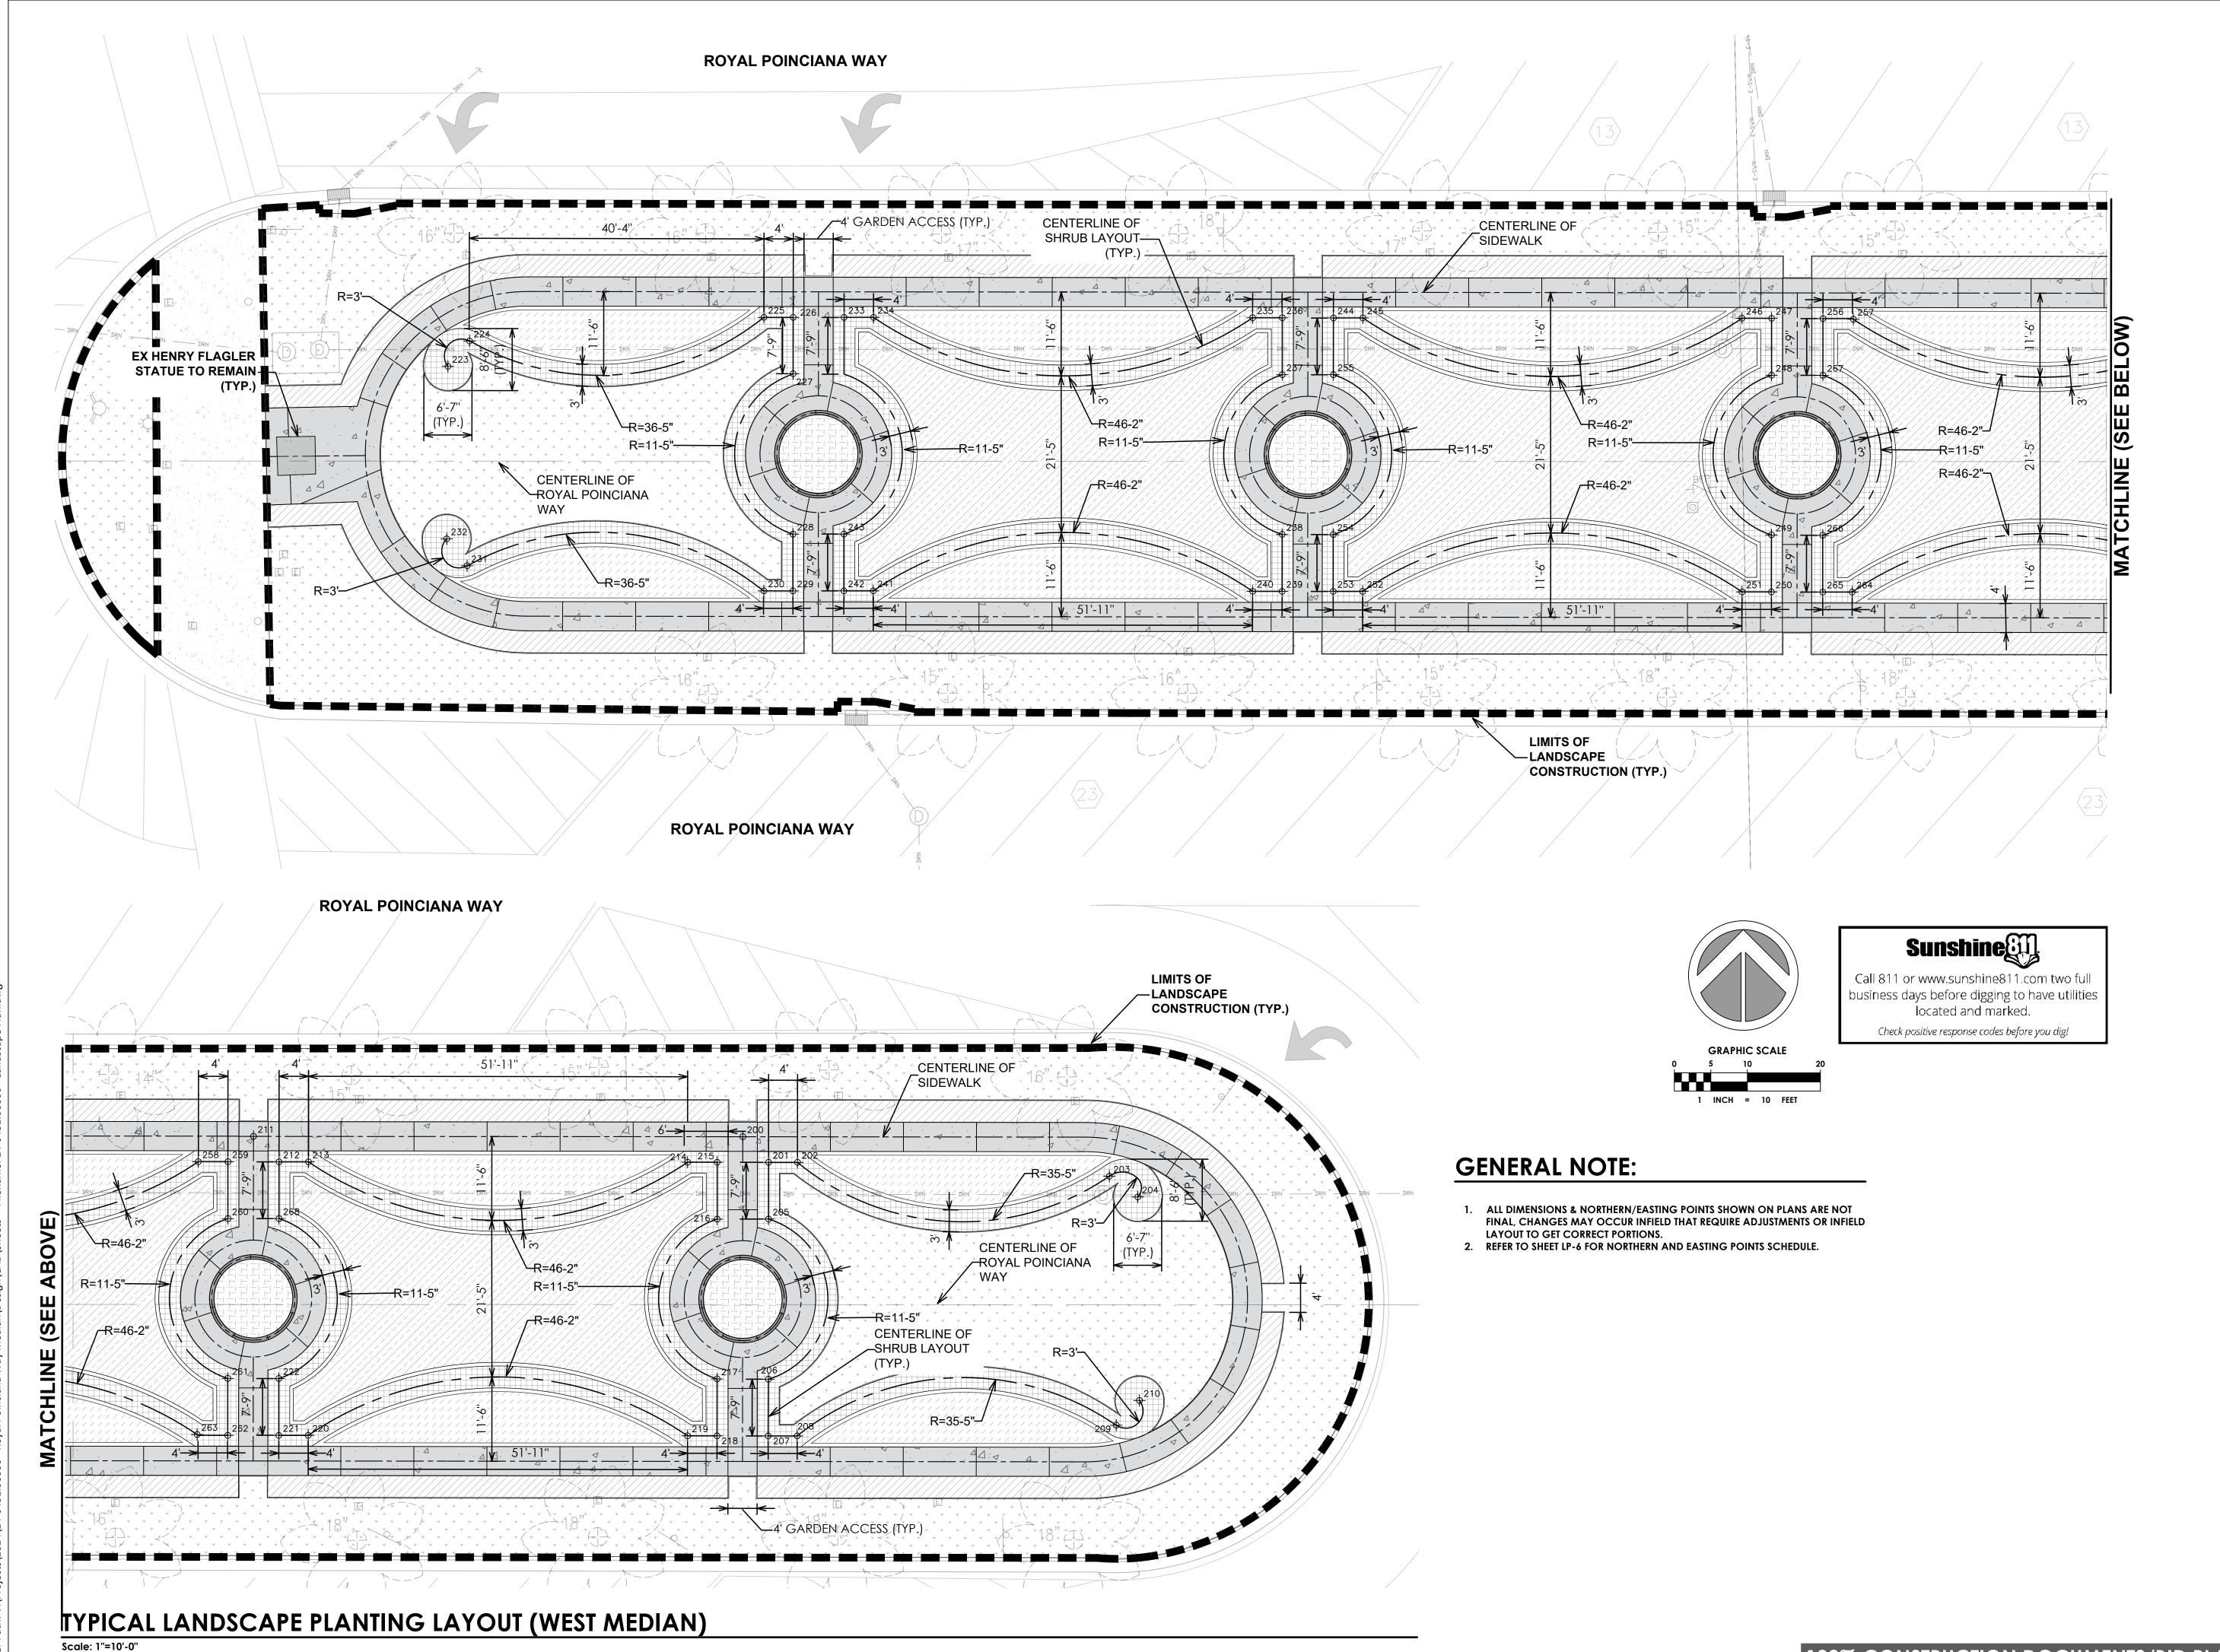

cma

500 West Cypress Creek Road Suite 600 Ft. Lauderdale, FL 33309 **954.730.0707** www.chenmoore.com

REGISTRATION

REGISTRATION NO. **6667129**DATE: 1/23/2025



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CLIENT

Town of Palm Beach

Public Works
951 Okeechobee Road, Suite A
West Palm Beach, FL 33401
561.838.5440
Project Manager:
Mike Roach, PE

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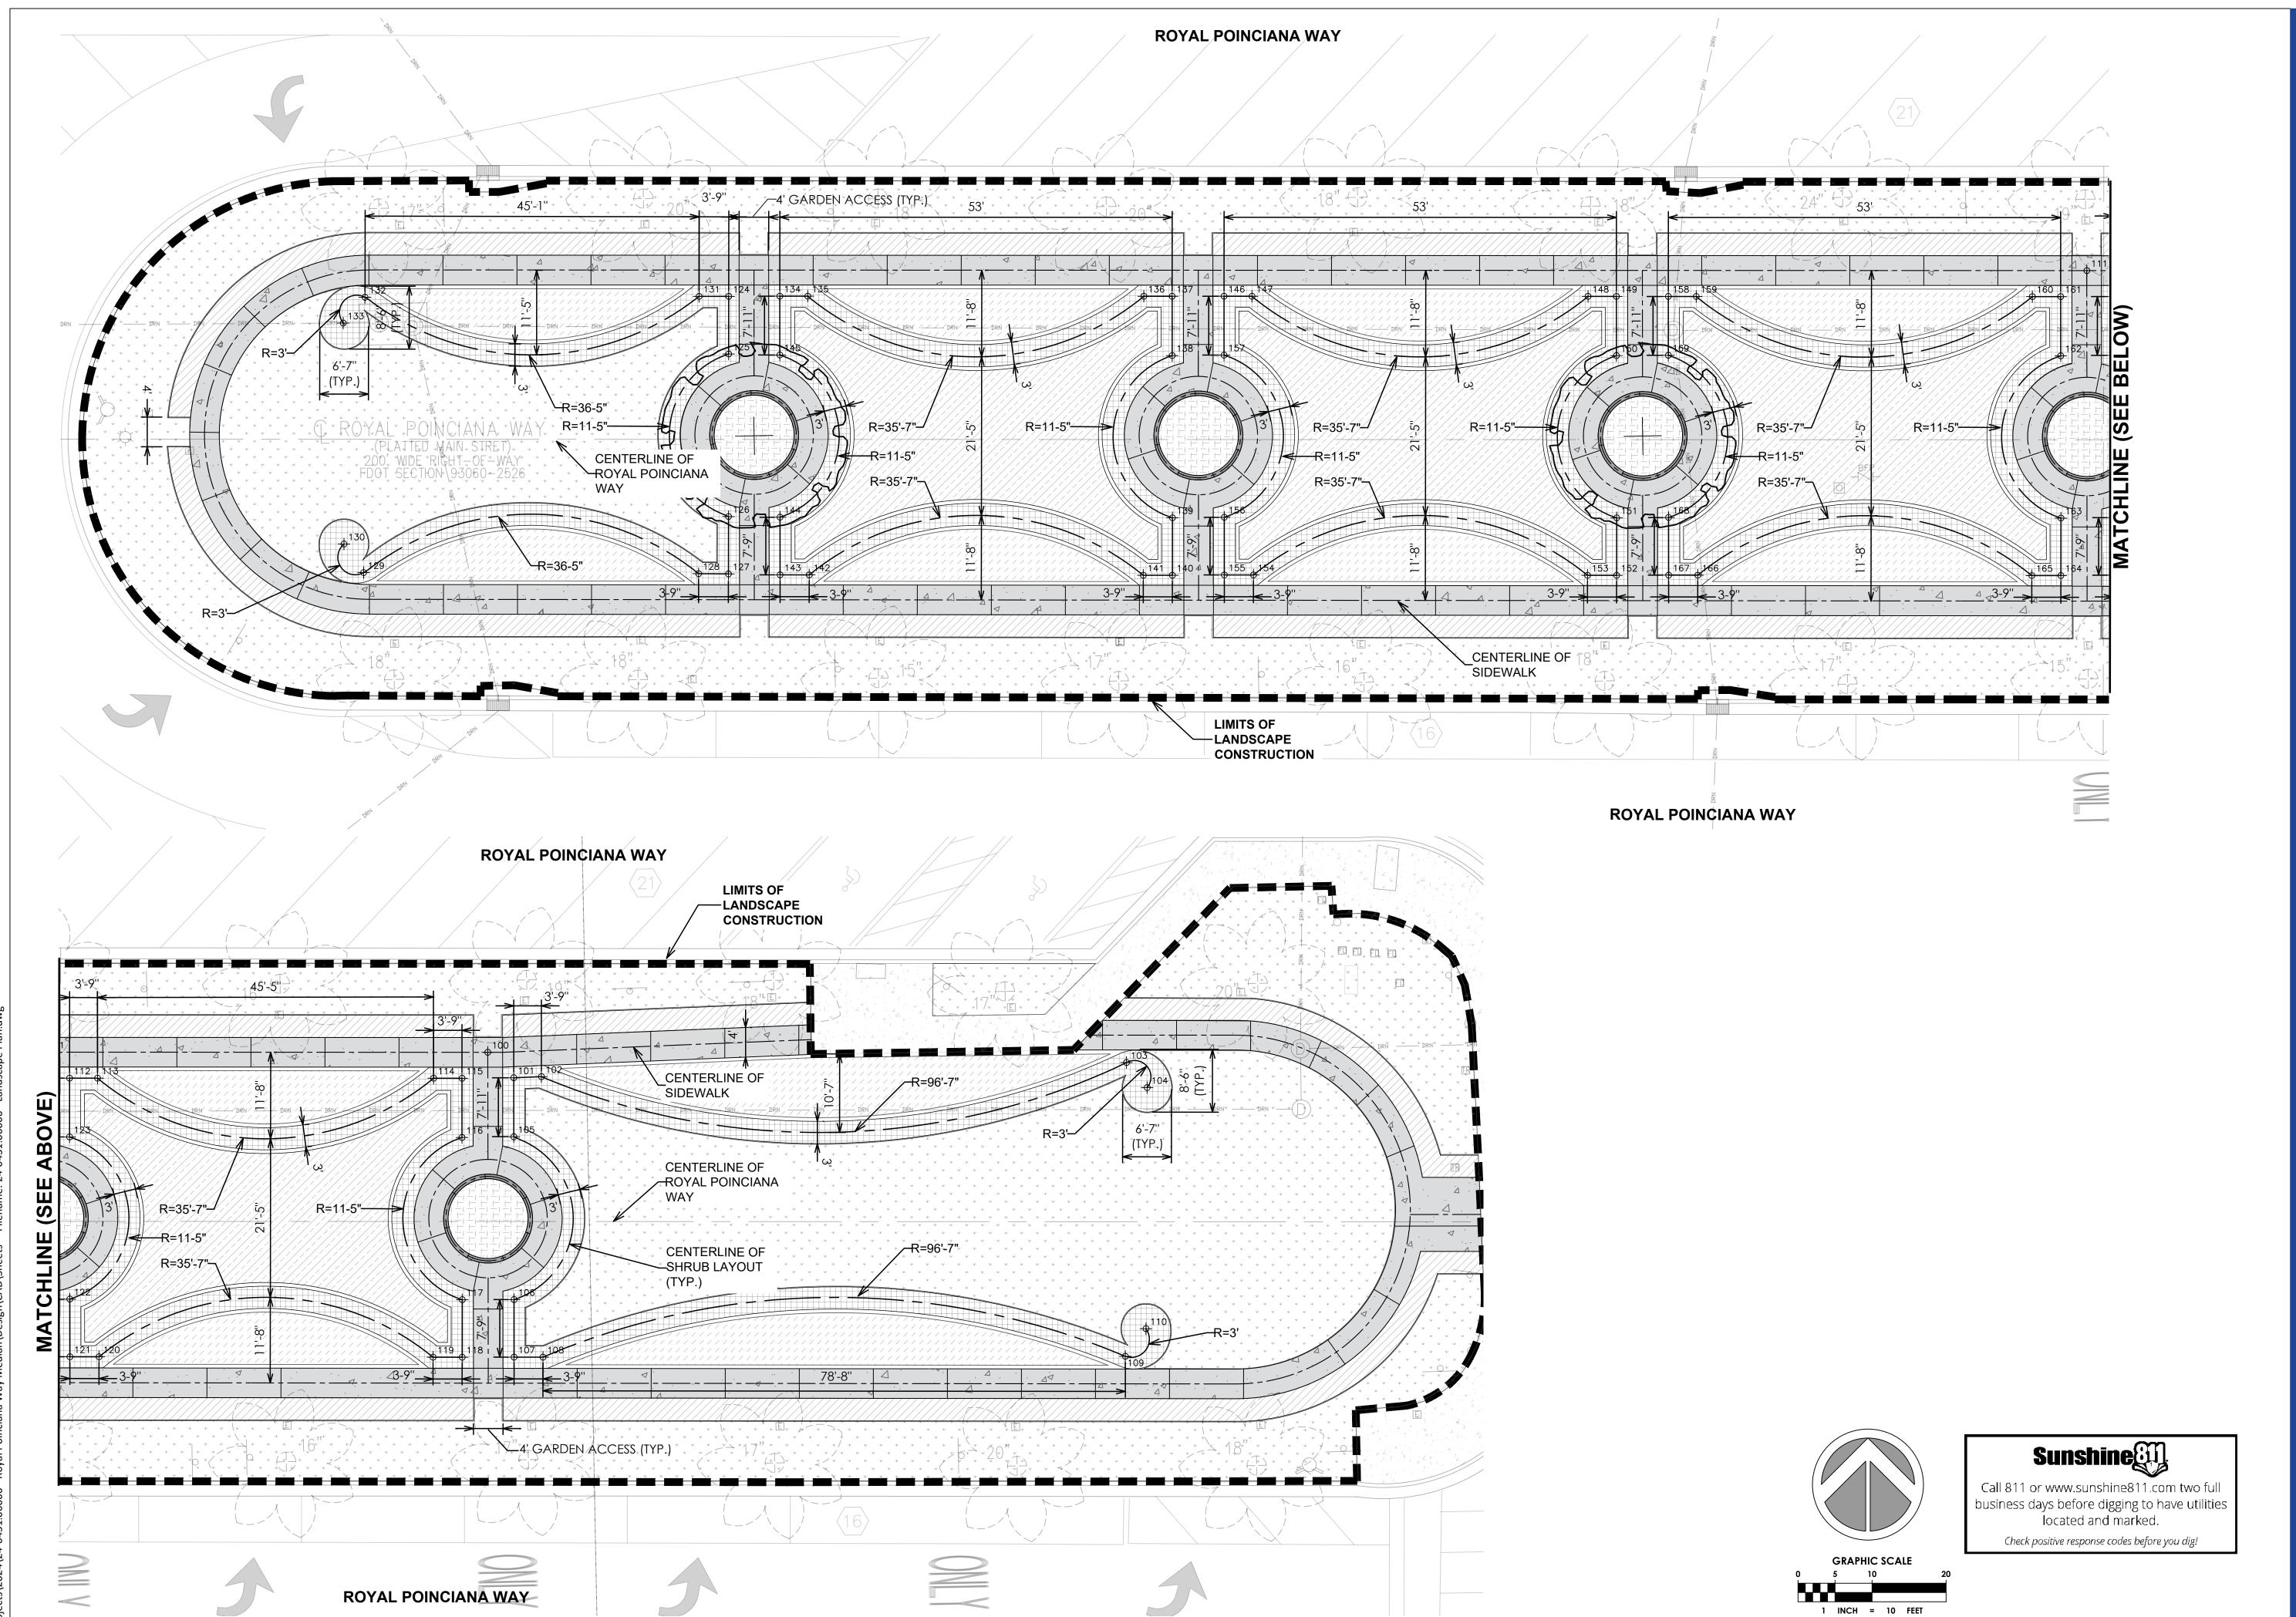
ESF/EDH

DRAWING TITLE

WEST MEDIAN LANDSCAPE LAYOUT PLAN

DRAWING NUMBER

LP-4



TYPICAL LANDSCAPE PLANTING LAYOUT (EAST MEDIAN)

Scale: 1"=10'-0"



500 West Cypress Creek Road Suite 600 Ft. Lauderdale, FL 33309 **954.730.0707** www.chenmoore.com

REGISTRATION

ERIC DOUGLAS HARRISON, RLA
REGISTRATION NO. 6667129
DATE: 1/23/2025



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CLIENT

Town of Palm Beach
Public Works

951 Okeechobee Road, Suite A
West Palm Beach, FL 33401
561.838.5440
Project Manager:
Mike Roach, PE

PROJECT INFORMATION

ROYAL POINCIANA WAY

PROJECT NUMBER 24-0431.00060

CLIENT PROJECT NUMBER PO 240844

VERIFY SCALES

0 ► 1"

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REVISIONS

DATE OF ISSUE 1/17/25

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ESF/EDH

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ESF/EDH CHECKED BY

ESF/EDH

DRAWING TITLE

EAST MEDIAN LANDSCAPE LAYOUT PLAN

DRAWING NUMBER

100% CONSTRUCTION DOCUMENTS/BID PLANS

LP-5
13 OF 26

NORTHING/EASTING POINT SCHEDULE LANDSCAPE DETAILS: **EASTING** DESCRIPTION NORTHING DESCRIPTION NORTHING **EASTING** (1) SOD (AS SPECIFIED) (1) DO NOT PRUNE CENTRAL LEADER CALIPER MEASUREMENT IS 6" FROM TOP OF ROOT BALL FOR TREES WITH 6" CALIPER OR LESS. (2) PRUNE DAMAGED OR DEAD WOOD (2) PLANTING MIX: **West Median** N 867908.9631 E 969628.2933 2. CALIPER MEASUREMENT IS 12" FROM TOP OF ROOT BALL FOR IMMEDIATELY PRIOR TO PLANTING USING 80% SILICA SAND, 20% ORGANIC **East Median** N 867940.9242 E 970087.5957 TREES WITH 6" CALIPER GREATER. ACCEPTABLE NURSERY PRACTICES OR AS N 867909.5966 E 969672.0042 (3) SIDEWALK OR CURB DIRECTED BY THE LANDSCAPE ARCHITECT N 867937.4153 E 970091.0331 REFER TO PLANT SCHEDULE FOR INDIVIDUAL SIZES. N 867912.9242 E 969675.2438 (4) SUB-BASE (3) PROTECT TRUNK WITH 3 LAYERS OF BURLAP N 867937.4985 E 970094.7682 N 867951.3900 E 969554.6512 (5) NATIVE SOIL E 970173.8129 N 867937.9049 1" WIDE MIN. NYLON STRAPPING AT EQUAL N 867947.8313 E 969558.0779 SPACING (3 PER TREE) GUY WIRES SHALL E 970176.5376 N 867934.4651 NOT TO BE USED N 867947.7615 E 969562.1105 (5) FLUORESCENT MARKING FLAG N 867929.4534 E 970090.8952 N 867946.7211 E 969614.0017 (6) FINISH GRADE N 867907.4577 E 970090.5097 E 969618.0578 N 867946.6395 (7) 3" LAYER OF SPECIFIED MULCH: DO NOT N 867899.6849 E 970090.3679 N 867938.8458 E 969617.9084 INSTALL WITHIN 3" OF TREE TRUNK N 867899.6079 E 970094.5885 (8) FERTILIZER TABLET IF APPLICABLE N 867916.9724 E 969617.4779 XETANGAR YAYARAHA XIAXXETANGAR YARAHA XIAXZETANGAR YERKANIA YERKANIA KARANIA KARANIA YARANI YARANI YARANI YAY E 970172.9122 N 867898.2234 (9) CONSTRUCT TEMPORARY 3" WATERING N 867909.1783 E 969617.3217 E 970175.7595 N 867901.9009 N 867909.2557 E 969613.2922 (10) 2"X4"X8" STAKE: SET 2" BELOW FINISH GRADE 111 N 867942.0803 E 970027.6382 N 867910.3104 E 969561.3668 (11) SPECIFIED SOIL MIX 112 N 867938.5134 E 970031.0617 N 867910.3844 E 969557.3316 (12) EXISTING SOIL 113 N 867938.4406 E 970034.8303 N 867918.1667 E 969557.4871 (13) 2X DIAMETER OF THE ROOTBALL 114 E 970080.2150 N 867937.5630 N 867946.2185 E 969302.7546 **14)** SET CROWN OF ROOT BALL SLIGHTLY N 867937.4876 E 970084.0410 ABOVE SURROUNDING FINISH GRADE. N 867949.6310 E 969305.7803 REMOVE TOP 2/3 OF BURLAP FROM 116 E 970083.8955 N 867929.4843 N 867952.1091 E 969346.1341 ROOTBALL. TRUNK TAPER SHALL BE VISIBLE AT TIME OF INSTALLATION N 867907.5709 E 970083.5086 N 867952.0294 E 969350.1436 (15) SET ROOTBALL ON UNDISTURBED SOIL N 867899.8100 E 970083.3528 N 867944.3138 E 969349.9898 (16) REMOVE TOP 2/3 OF BURLAP/WIRE BASKET 119 N 867899.8860 E 970079.4234 FROM ROOTBALL N 867922.3490 E 969349.5545 N 867900.7959 E 970034.3161 (17) CLEAR TRUNK: REFER TO PLANT SCHEDULE N 867914.5715 E 969349.4004 N 867900.8747 E 970030.3882 N 867914.6549 E 969345.4088 **SOD PLANTING** LARGE TREE PLANTING: 2" CALIPER AND GREATER N 867908.6618 E 970030.5232 N 867918.8669 E 969304.8550 N 867930.5715 E 970030.9082 N 867922.6053 E 969302.1405 (1) PLANT MATERIAL SHALL NOT BE PRUNED N 867942.0882 E 969844.1766 N 867951.8922 E 969357.1097 ROOTBALL (TYP.) PRIOR TO INSTALLATION: AFTER PLANTS N 867934.3078 E 969844.0224 HAVE BEEN INSTALLED, EACH PLANT N 867951.8224 E 969361.1424 CANOPY (TYP.) SHALL BE PRUNED FOR UNIFORMITY N 867912.3517 E 969843.5882 N 867950.7821 E 969413.0335 (2) SET CROWN OF ROOT SLIGHTLY ABOVE N 867904.6048 E 969843.4280 SURROUNDING FINISH GRADE: TRUNK N 867950.7004 E 969417.0897 TAPER SHALL BE VISIBLE AT TIME OF N 867904.7181 E 969839.4005 INSTALLATION N 867942.9067 E 969416.9403 MULCH BED (TYP.) (3) 3" LAYER OF SPECIFIED MULCH: DO NOT N 867905.7167 E 969794.1698 N 867921.0334 E 969416.5097 NSTALL WITHIN 3" OF TREE TRUNK E 969791.5855 ON CENTER SPACING (TYP.) N 867909.6237 (4) CONSTRUCT TEMPORARY 3" WATERING N 867913.2392 E 969416.3535 REFER TO PLANT SCHEDULE 131 N 867942.1676 E 969840.1718 N 867913.3166 E 969412.3241 (5) FINISH GRADE N 867942.8981 E 969795.0612 N 867914.3714 E 969360.3986 (6) FERTILIZER TABLET IF APPLICABLE. N 867939.4722 E 969792.0537 N 867914.4453 E 969356.3634 7) BACKFILL WITH SPECIFIED SOIL MIX N 867941.9845 E 969851.0774 N 867922.2276 E 969356.5189 (8) EXISTING SOIL SHRUB SPACING DETAIL PLAN N 867941.9117 E 969854.8460 N 867950.5441 E 969424.0953 (9) 2X DIAMETER OF THE ROOTBALL N 867941.0341 E 969900.2307 N 867950.4743 E 969428.1280 137 N 867940.9587 E 969904.0567 N 867949.4339 E 969480.0191 N 867932.9554 E 969903.9111 N 867949.3523 E 969484.0753 N 867911.0420 E 969903.5243 N 867941.5586 E 969483.9259 N 867903.2811 E 969903.3685 N 867919.6852 E 969483.4954 141 N 867903.3571 E 969899.4391 N 867911.8910 E 969483.3391 142 N 867904.2670 E 969854.3318 N 867911.9685 E 969479.3097 E 969850.4038 N 867904.3458 143 N 867913.0232 E 969427.3843 E 969850.5389 N 867912.1329 N 867913.0972 E 969423.3491 N 867934.0426 E 969850.9239 N 867920.8795 E 969423.5045 N 867940.8331 E 969911.0648 N 867942.7784 E 969423.9390 E 969914.8334 N 867940.7602 N 867949.1769 SHRUB/GROUND COVER PLANTING & SPACING E 969491.1017 N 867939.8827 E 969960.2181 E 969495.2633 N 867949.0150 N 867939.8072 E 969964.0441 149 N 867948.0668 E 969547.0255 E 969963.8985 N 867931.8039 N 867947.9851 E 969551.0817 E 969963.5117 N 867909.8906

N 867940.1915

N 867918.3181

N 867910.5239

N 867910.7176

N 867911.6561

N 867911.7301

N 867919.5124

N 867941.4113

N 867940.0656

N 867902.1297

N 867902.2056

N 867903.1155

N 867903.1944

N 867910.9814

N 867932.8912

N 867939.6643

N 867939.5914

N 867938.7139

N 867938.6384

N 867930.6351

N 867908.7218

N 867900.9609

N 867901.0368

N 867901.9467

N 867902.0256

N 867909.8126

N 867931.7224

N 867950.0686

N 867946.4975

N 867946.4166

N 867943.7181

N 867940.7941

N 867938.7276

N 867916.7988

N 867909.0411

West Median

152

153

159

165

200

206

207

E 969963.3558

E 969959.4265

E 969914.3192

E 969910.3912

E 969910.5263

E 969910.9112

E 969971.0589

E 969974.8275

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CLIENT

Town of Palm Beach Public Works

951 Okeechobee Road, Suite A

West Palm Beach, FL 33401 561.838.5440 Project Manager: Mike Roach, PE

PROJECT INFORMATION

ROYAL POINCIANA WAY

PROJECT NUMBER 24-0431.00060

CLIENT PROJECT NUMBER PO 240844

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DATE OF ISSUE 1/17/25

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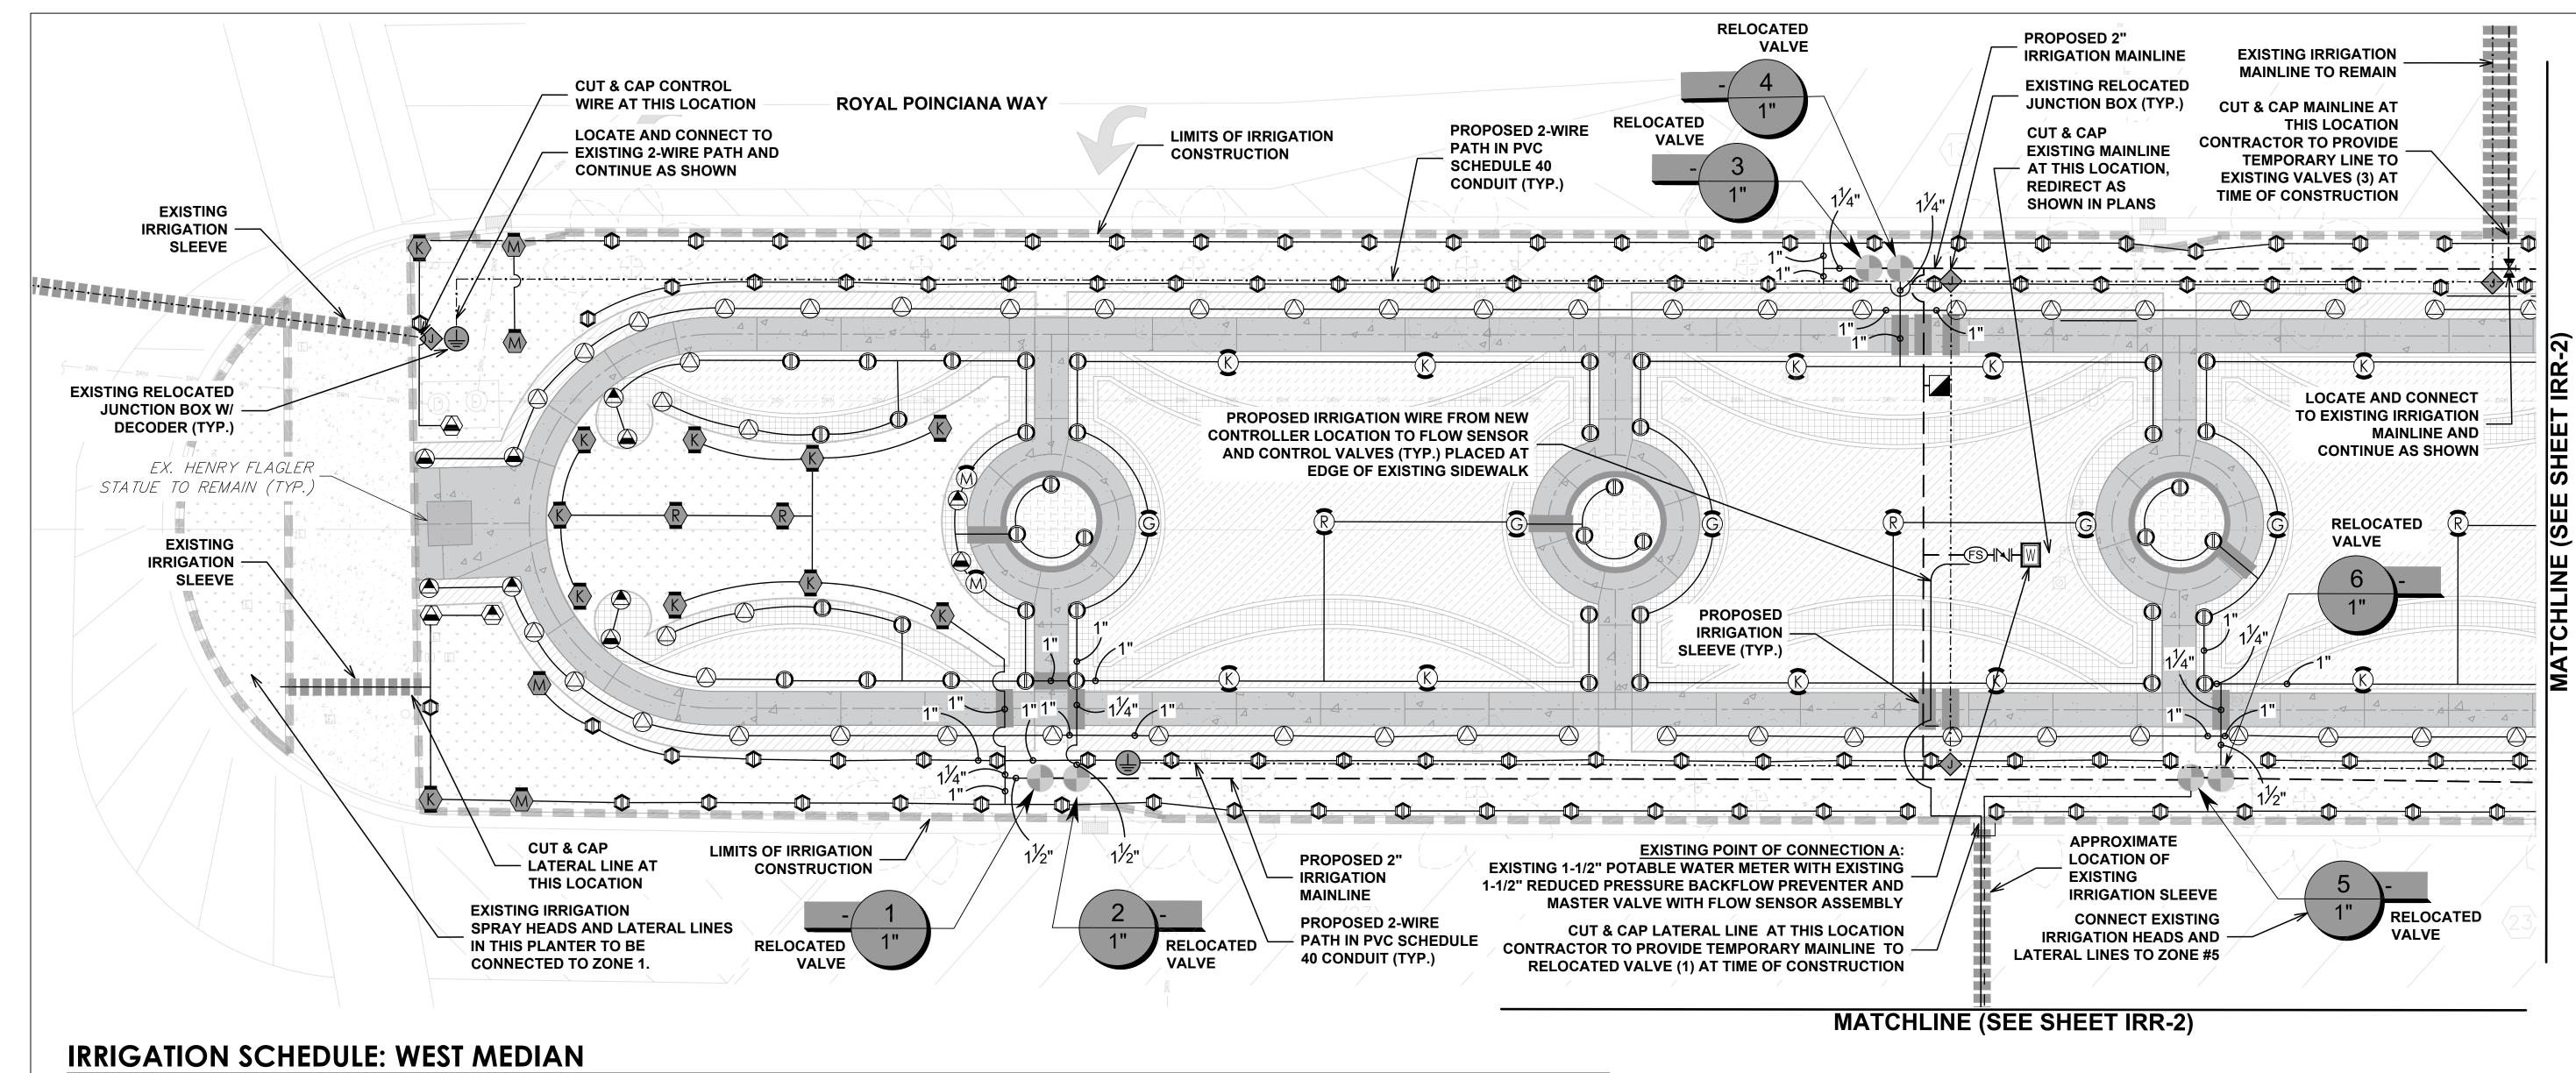
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NOTES & **LANDSCAPE DETAILS**

DRAWING NUMBER



SYMBOL MANUFACTURER/MODEL/DESCRIPTION Hunter MP Strip PROS-06-PRS40-CV LST Turf Rotator, 6" (15.24 cm) pop-up with factory installed check valve, pressure regulated to 40 psi (2.76 bar), MP Rotator nozzle on PRS40 body. LST=Ivory left strip, SST=Brown side strip, RST=Copper right strip. Hunter MP Strip PROS-06-PRS40-CV RST Turf Rotator, 6" (15.24 cm) pop-up with factory installed check valve, pressure regulated to 40 psi (2.76 bar), MP Rotator nozzle on PRS40 body. LST=Ivory left strip, SST=Brown side strip, RST=Copper right strip. Hunter MP1000 PROS-06-PRS40-CV M Turf Rotator, 6" (15.24 cm) pop-up with check valve, pressure regulated to 40 psi (2.76 bar), MP Rotator nozzle on PRS40 body. M=Maroon adj arc 90 to 210, L=Light Blue 210 to 270 arc, O=Olive 360 arc. Hunter MP2000 PROS-06-PRS40-CV K Turf Rotator, 6" (15.24 cm) pop-up with factory installed check valve, pressure regulated to 40 psi (2.76 bar), MP Rotator nozzle on PRS40 body. K=Black adj arc 90-210, G=Green adj arc 210-270, R=Red 360 arc. Hunter MP2000 PROS-06-PRS40-CV R Turf Rotator, 6" (15.24 cm) pop-up with factory installed check valve, pressure regulated to 40 psi (2.76 bar), MP Rotator nozzle on PRS40 body. K=Black adj arc 90-210, G=Green adj arc 210-270, R=Red 360 arc. Hunter MP800SR PROS-06-PRS40-CV ADJ Turf Rotator, 6.0" pop-up with check valve, pressure • regulated to 40 psi (2.76 bar), MP Rotator nozzle on PRS40 body. ADJ=Orange and Gray (arc 90-210), 360=Lime Green and Gray (arc 360) Hunter MP Strip PROS-12-PRS40-CV LST Shrub Rotator, 12" (30.48 cm) pop-up with factory installed

check valve, pressure regulated to 40 psi (2.76 bar), MP Rotator nozzle. LST=Ivory left strip, SST=Brown side strip, RST=Copper right strip, on PRS40 body.

Hunter MP Strip PROS-12-PRS40-CV RST Shrub Rotator, 12" (30.48 cm) pop-up with factory installed check valve, pressure regulated to 40 psi (2.76 bar), MP Rotator nozzle. LST=Ivory left strip, SST=Brown side strip, RST=Copper right strip, on PRS40 body.

Hunter MP Strip PROS-12-PRS40-CV SST Shrub Rotator, 12" (30.48 cm) pop-up with factory installed check valve, pressure regulated to 40 psi (2.76 bar), MP Rotator nozzle. LST=Ivory left strip, SST=Brown side strip, RST=Copper right strip, on PRS40 body.

> Hunter MP1000 PROS-12-PRS40-CV M Shrub Rotator, 12" (30.48 cm) pop-up with check valve, pressure regulated to 40 psi (2.76 bar), MP Rotator nozzle. M=Maroon adj arc 90 to 210, L=Light Blue 210 to 270 arc, O=Olive 360 arc on PRS40 body.

Hunter MP2000 PROS-12-PRS40-CV G Shrub Rotator, 12" (30.48 cm) pop-up with check valve, pressure regulated to 40 psi (2.76 bar), MP Rotator nozzle. K=Black adj arc 90-210, G=Green adj arc 210-270, R=Red 360 arc on PRS40 body.

Hunter MP2000 PROS-12-PRS40-CV K Shrub Rotator, 12" (30.48 cm) pop-up with check valve, pressure regulated to 40 psi (2.76 bar), MP Rotator nozzle. K=Black adj arc 90-210, G=Green adj arc 210-270, R=Red 360 arc on PRS40 body.

Hunter MP2000 PROS-12-PRS40-CV R Shrub Rotator, 12" (30.48 cm) pop-up with check valve, pressure regulated to 40 psi (2.76 bar), MP Rotator nozzle. K=Black adj arc 90-210, G=Green adj arc 210-270, R=Red 360 arc on PRS40 body.

Hunter MP800SR PROS-12-PRS40-CV ADJ Shrub Rotator, 12.0" pop-up with check valve, pressure regulated to 40 psi (2.76 bar), MP Rotator nozzle on PRS40 body. OR = Orange adj arc 90 to 210.

MANUFACTURER/MODEL/DESCRIPTION SYMBOL

Existing Remote Control Valve

Existing remote control valve to remain. Hunter ICV-G-FS with ICD-100 Existing remote control valve, glass-filled nylon construction, globe configuration, NPT threaded inlet/outlet, with single

Hunter HQ-33DRC Existing Quick coupler valve, yellow rubber cover, red brass and stainless steel, with 3/4" NPT inlet, 2-piece body.

Existing Leemco LGT22SS304X Stainless steel gate valve.

station decoder.

Existing Zurn 950XL Double Check Valve Assembly Relocated Existing Hunter A2C-75D-M

PED-SS stainless pedestal. Existing Junction Box Standard size valve box with wire splice.

Existing Junction Box with Decoder Grounding 10" round valve box with 5/8" x 8' copper grounding rod, 10 ohms resistance or less. Install minimum of 8' from irrigation mainline, decoders, or remote control valves. **Hunter RAIN-CLIK**

2-Wire Decoder Controller with 75 station capacity, with

Rain Sensor, with conduit installation, mount as noted. Normally closed switch. Existing Hunter ICV-G w FS-100-B, ICD-100, ICD-SEN


1" remote control master valve, glass-filled nylon construction, globe configuration, NPT threaded inlet/outlet, with 1" brass flow sensor and sensor decoder.

Water Meter 1-1/2" Existing Water Meter per City Irrigation Lateral Line: PVC Schedule 40 — — Irrigation Mainline: PVC Schedule 40

> Pipe Sleeve: HDPE PE4710 DR 11 4" pipe sleeve for irrigation mainline, lateral lines, and wire

Pipe Sleeve: PVC Schedule 40 -----2-wire path, 12 gauge, twisted pair. Color coded per valve

> Valve Callout — Valve Number — Valve Flow - Valve Size

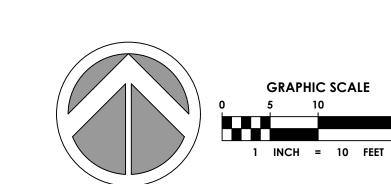

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Suite 600

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951 Okeechobee Road, Suite A West Palm Beach, FL 33401 561.838.5440 Project Manager Mike Roach, PE

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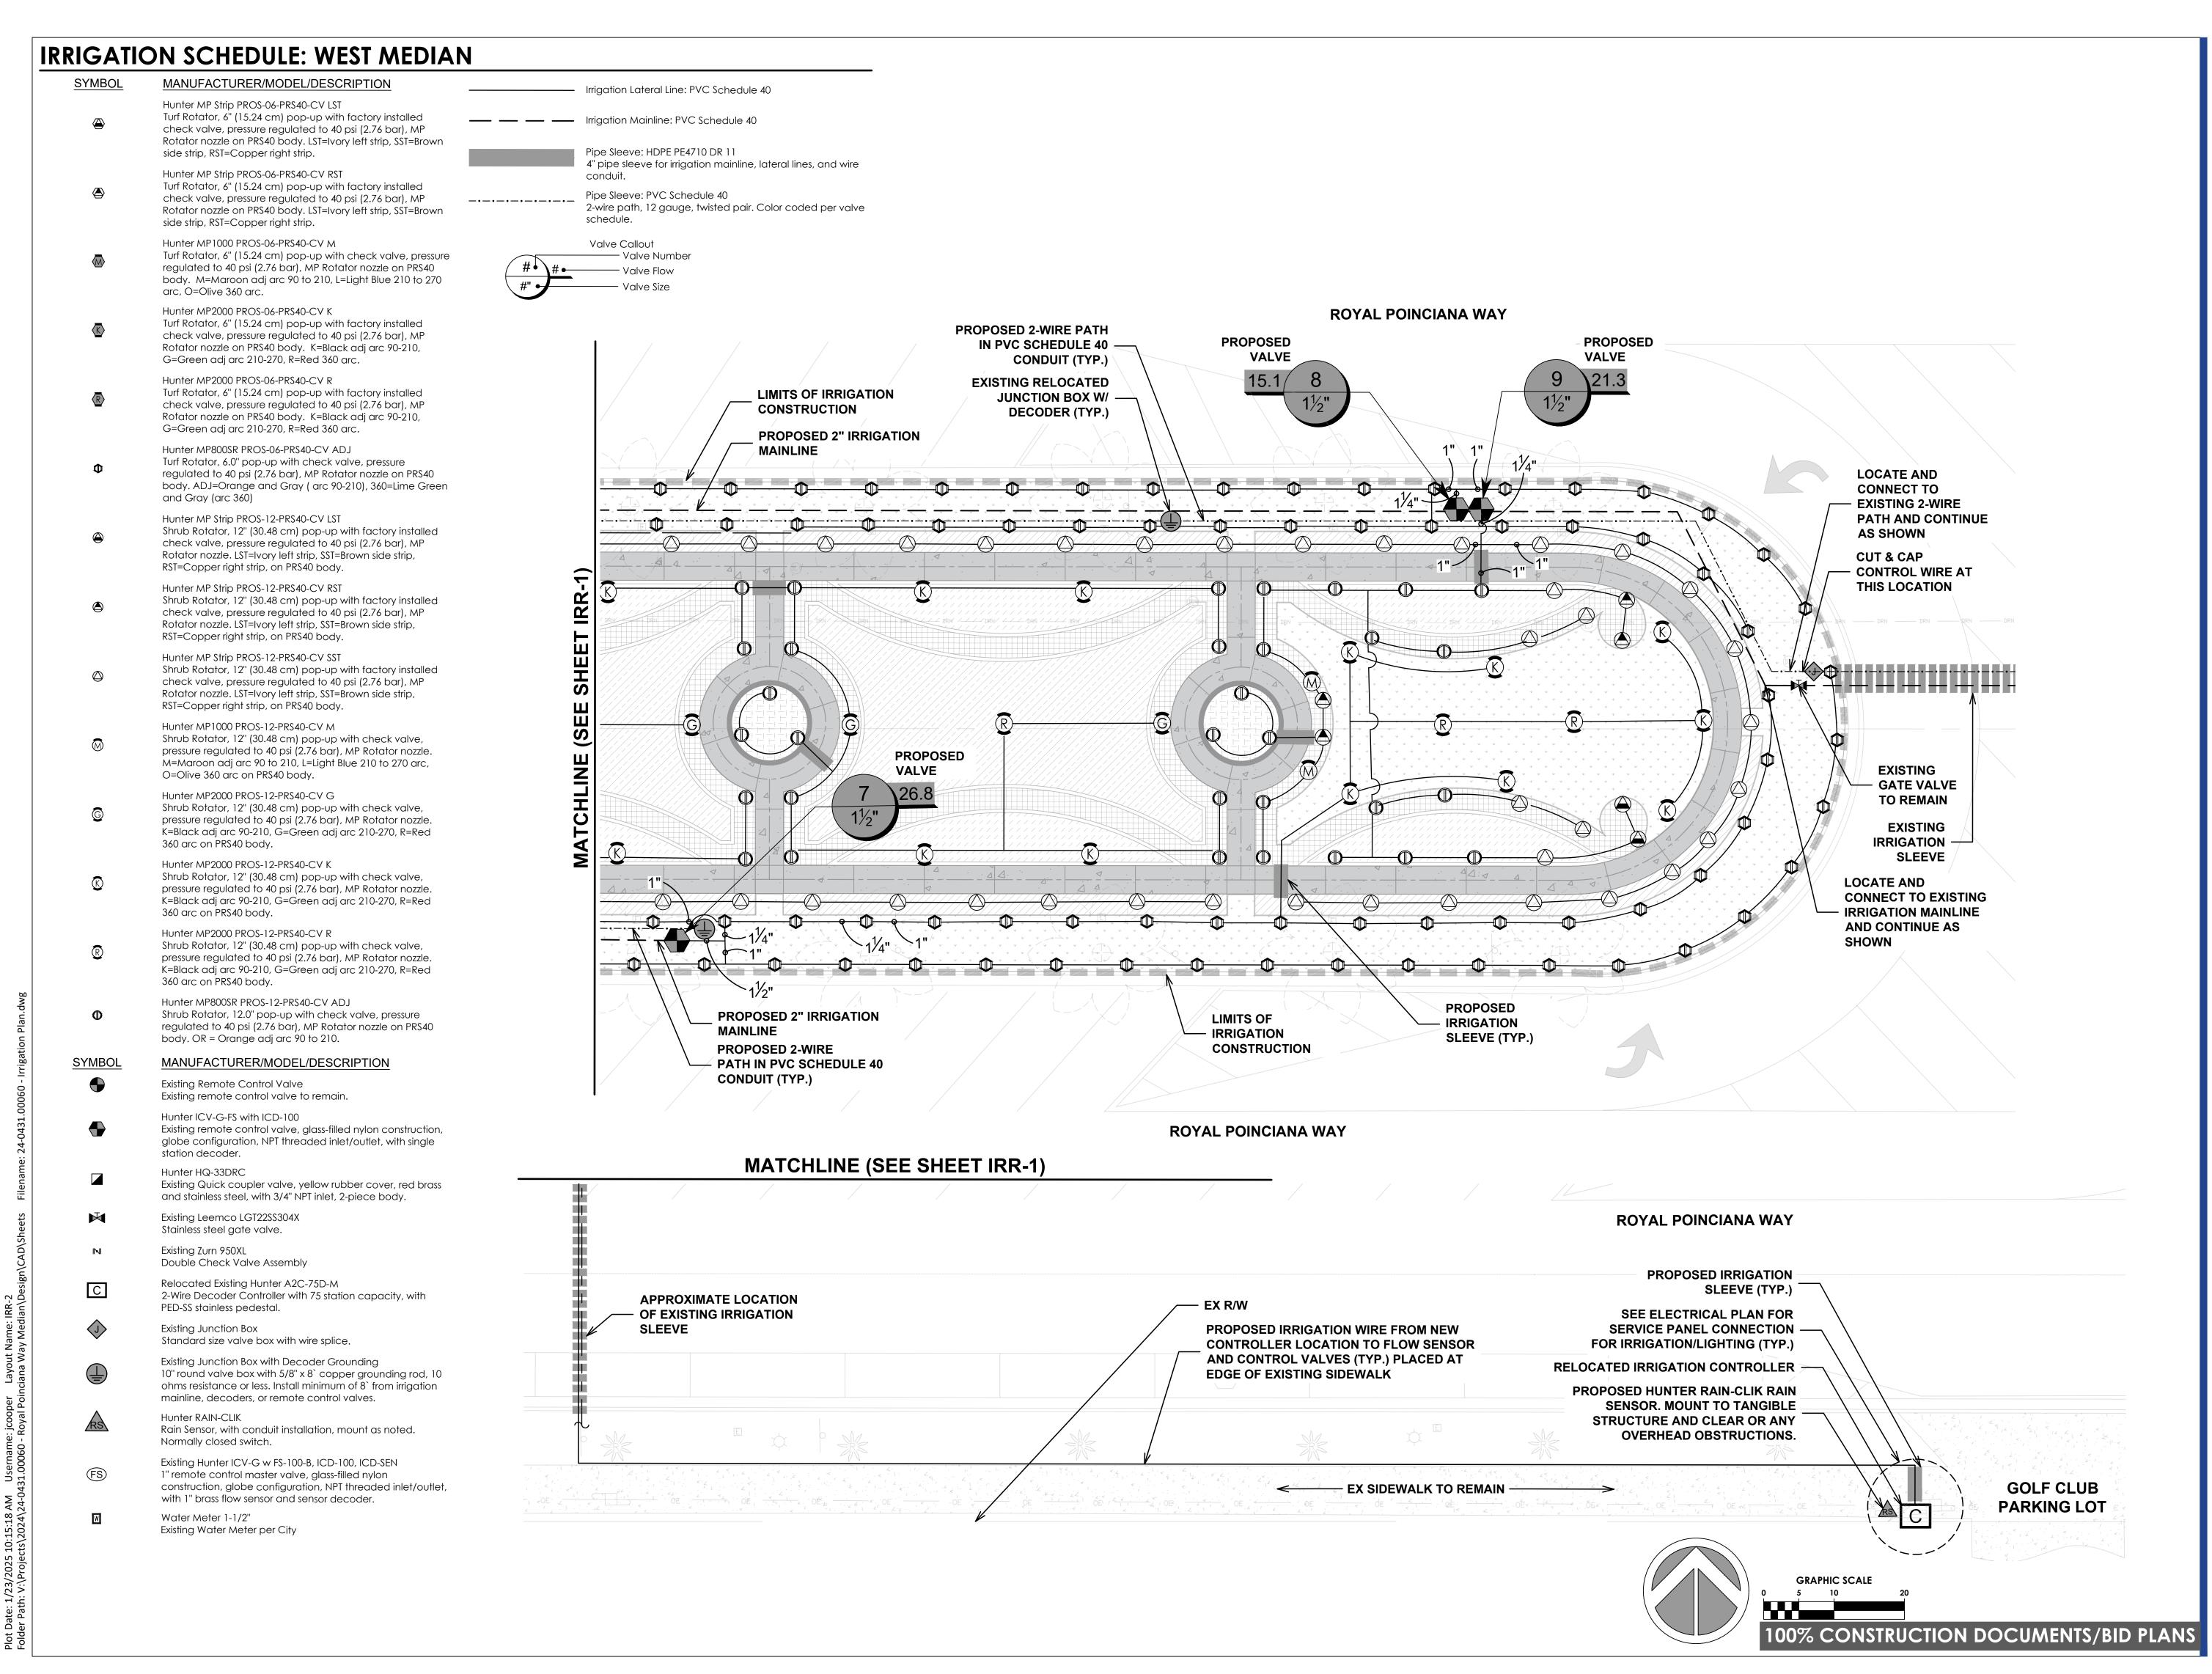
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IRRIGATION PLAN




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Public Works 951 Okeechobee Road, Suite A West Palm Beach, FL 33401 **561.838.5440**

Mike Roach, PE

Project Manager:

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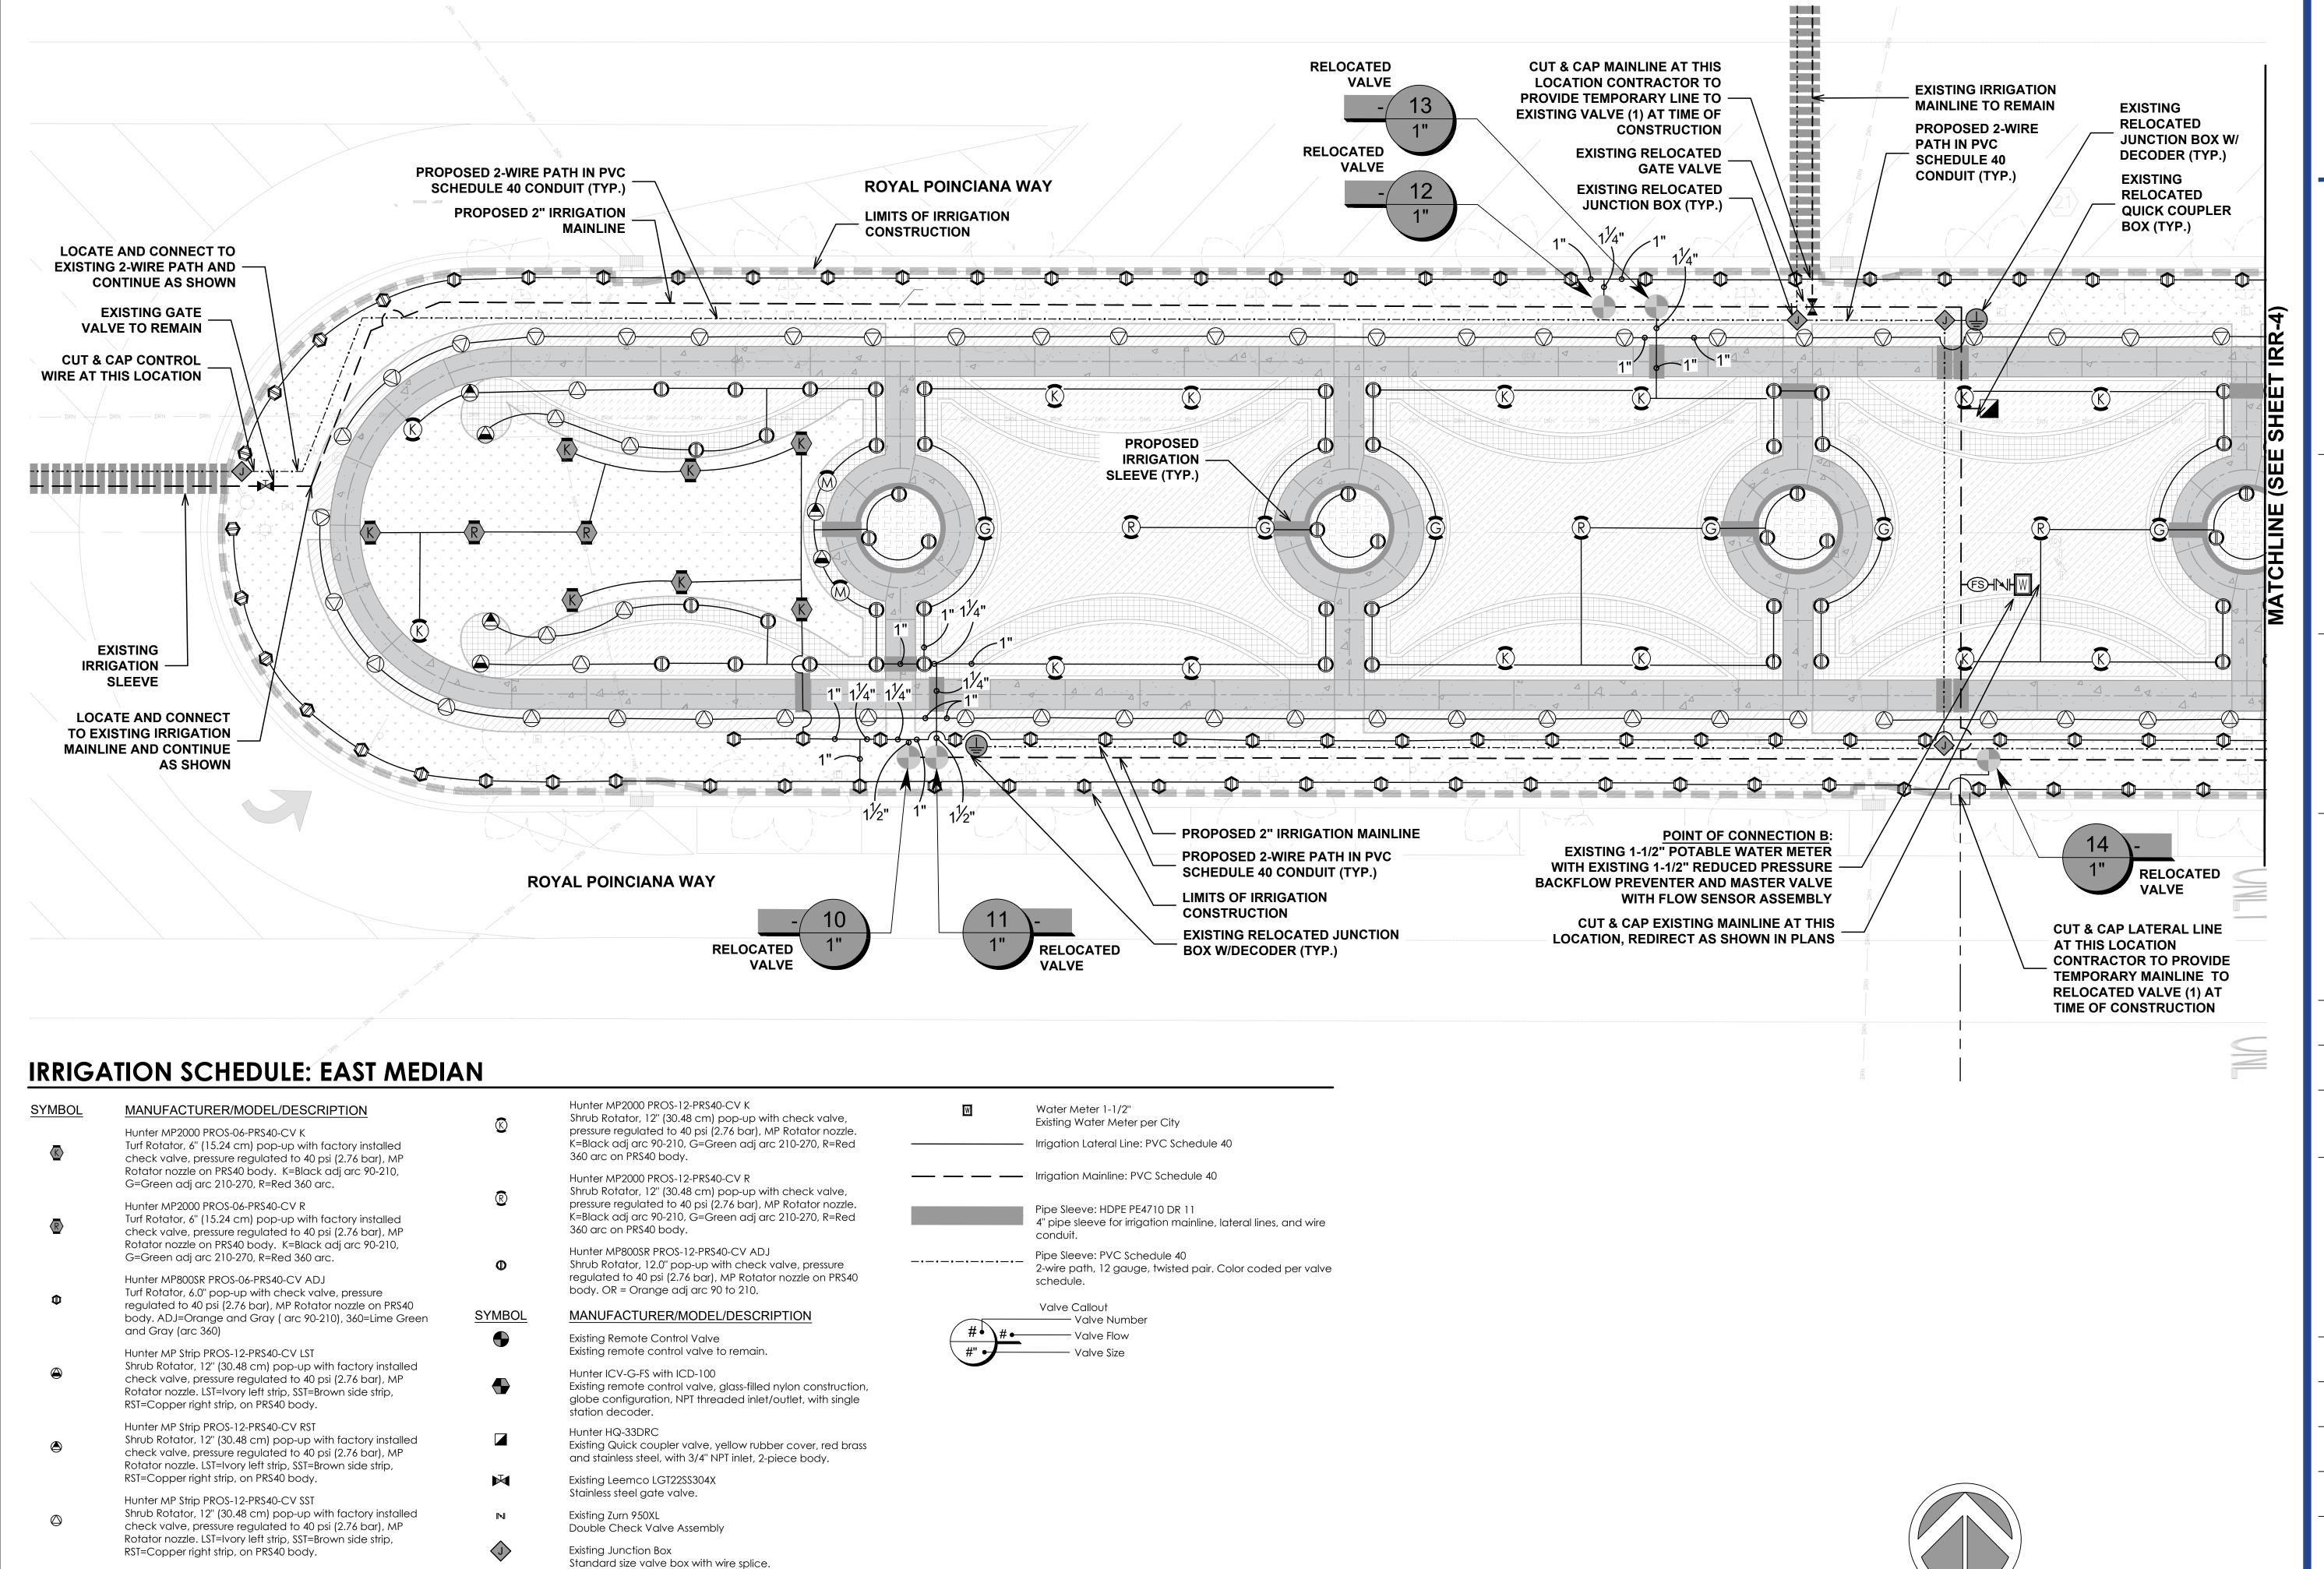
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Hunter MP1000 PROS-12-PRS40-CV M

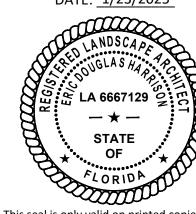Hunter MP2000 PROS-12-PRS40-CV G

O=Olive 360 arc on PRS40 body.

360 arc on PRS40 body.

Shrub Rotator, 12" (30.48 cm) pop-up with check valve,

pressure regulated to 40 psi (2.76 bar), MP Rotator nozzle.

M=Maroon adj arc 90 to 210, L=Light Blue 210 to 270 arc,

Shrub Rotator, 12" (30.48 cm) pop-up with check valve, pressure regulated to 40 psi (2.76 bar), MP Rotator nozzle.

K=Black adj arc 90-210, G=Green adj arc 210-270, R=Red

Existing Hunter ICV-G w FS-100-B, ICD-100, ICD-SEN

construction, globe configuration, NPT threaded inlet/outlet,

1" remote control master valve, glass-filled nylon

with 1" brass flow sensor and sensor decoder.

Chen moore and associates

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REGISTRATION ERIC DOUGLAS HARRISON, RLA



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Mike Roach, PE

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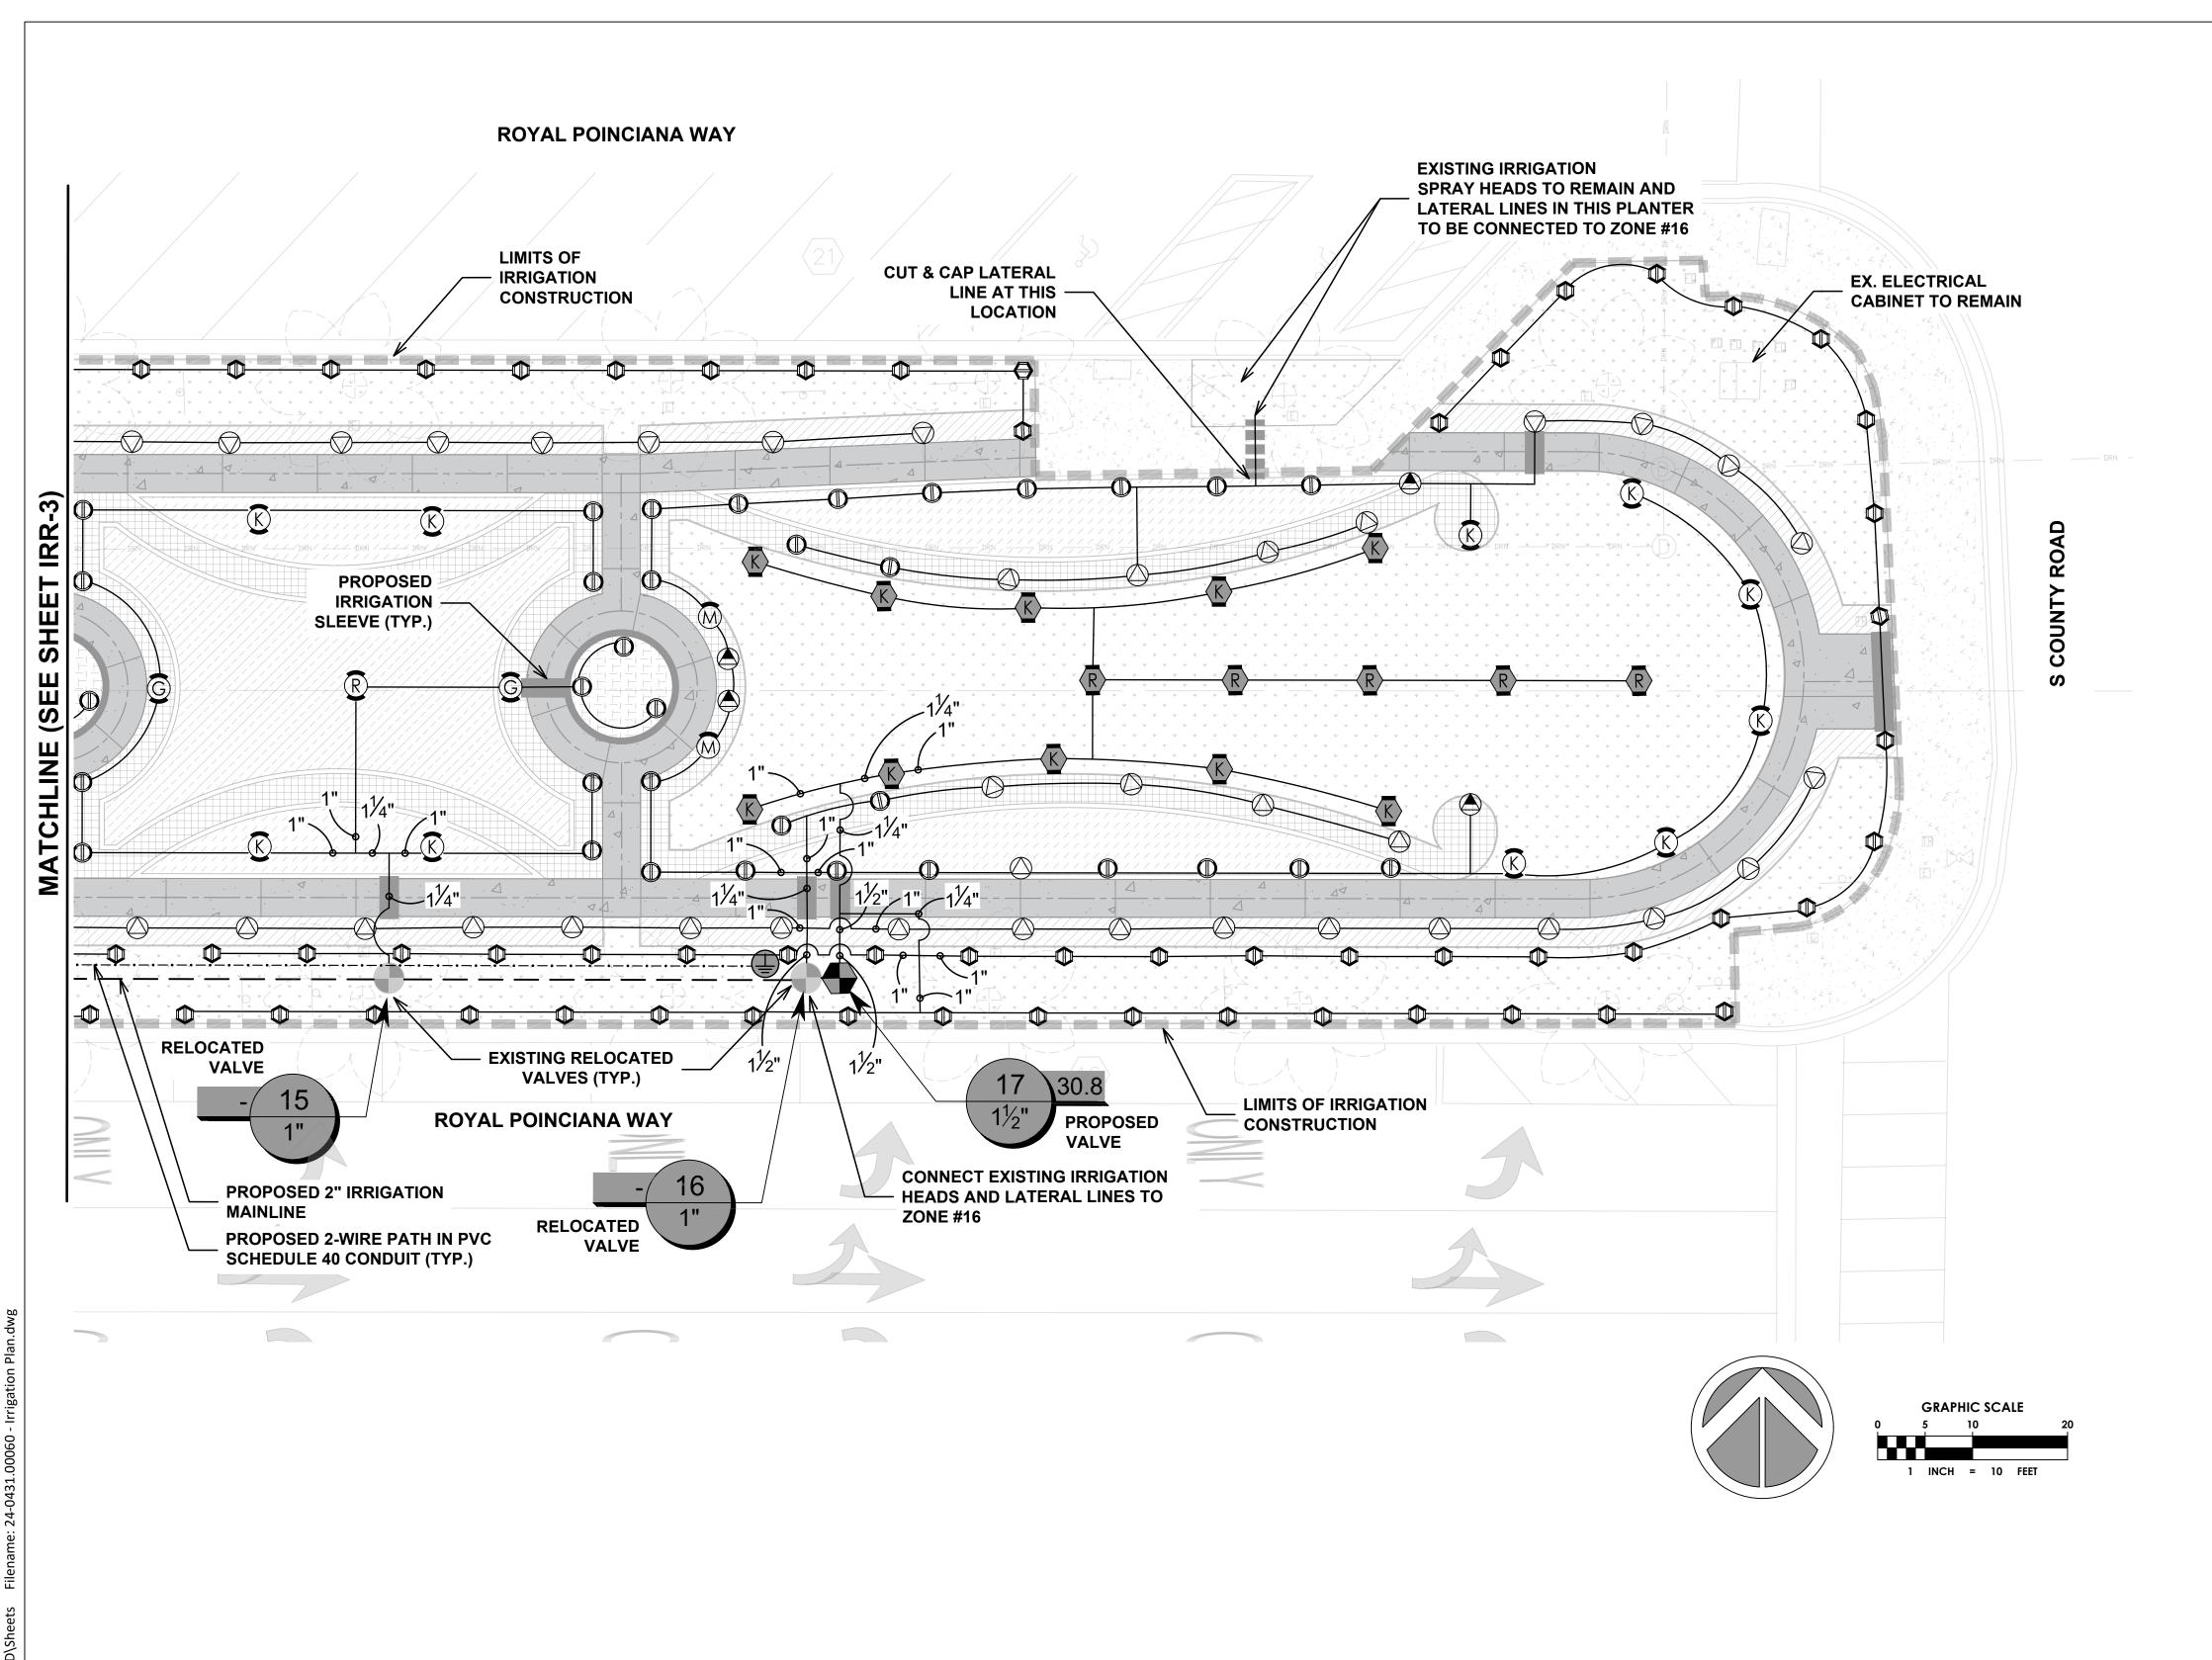
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DRAWING NUMBER

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IRR-3



IRRIGATION SCHEDULE: EAST MEDIAN

AUFACTURER/MODEL/DESCRIPTION Inter MP2000 PROS-06-PRS40-CV K Rotator, 6" (15.24 cm) pop-up with factory installed tack valve, pressure regulated to 40 psi (2.76 bar), MP action nozzle on PRS40 body. K=Black adj arc 90-210, Green adj arc 210-270, R=Red 360 arc. Inter MP2000 PROS-06-PRS40-CV R Rotator, 6" (15.24 cm) pop-up with factory installed tack valve, pressure regulated to 40 psi (2.76 bar), MP action nozzle on PRS40 body. K=Black adj arc 90-210, Green adj arc 210-270, R=Red 360 arc. Inter MP800SR PROS-06-PRS40-CV ADJ Rotator, 6.0" pop-up with check valve, pressure ulated to 40 psi (2.76 bar), MP Rotator nozzle on PRS40 by. ADJ=Orange and Gray (arc 90-210), 360=Lime Green atj Gray (arc 360) Inter MP Strip PROS-12-PRS40-CV LST Inter MP Strip PROS-12-PRS40-CV LST Inter MP Strip PROS-12-PRS40-CV RST Inter MP Strip PROS-12-PRS40-CV SST Inter MP Strip PROS-12-PRS40-CV M Inter MP Strip PROS-12-PRS40-CV G Inter
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Rotator, 6" (15.24 cm) pop-up with factory installed ack valve, pressure regulated to 40 psi (2.76 bar), MP ator nozzle on PRS40 body. K=Black adj arc 90-210, Green adj arc 210-270, R=Red 360 arc. Ater MP800SR PROS-06-PRS40-CV ADJ. Rotator, 6.0" pop-up with check valve, pressure ulated to 40 psi (2.76 bar), MP Rotator nozzle on PRS40 dy. ADJ=Orange and Gray (arc 90-210), 360=Lime Green d Gray (arc 360) Ater MP Strip PROS-12-PRS40-CV LST ab Rotator, 12" (30.48 cm) pop-up with factory installed ack valve, pressure regulated to 40 psi (2.76 bar), MP ator nozzle. LST=lvory left strip, SST=Brown side strip, e-Copper right strip, on PRS40 body. Atter MP Strip PROS-12-PRS40-CV RST ab Rotator, 12" (30.48 cm) pop-up with factory installed ack valve, pressure regulated to 40 psi (2.76 bar), MP ator nozzle. LST=lvory left strip, SST=Brown side strip, e-Copper right strip, on PRS40 body. Atter MP Strip PROS-12-PRS40-CV RST ab Rotator, 12" (30.48 cm) pop-up with factory installed ack valve, pressure regulated to 40 psi (2.76 bar), MP ator nozzle. LST=lvory left strip, SST=Brown side strip, e-Copper right strip, on PRS40 body. Atter MP Strip PROS-12-PRS40-CV SST ab Rotator, 12" (30.48 cm) pop-up with factory installed ack valve, pressure regulated to 40 psi (2.76 bar), MP ator nozzle. LST=lvory left strip, SST=Brown side strip, e-Copper right strip, on PRS40 body. Atter MP1000 PROS-12-PRS40-CV M Ab Rotator, 12" (30.48 cm) pop-up with check valve, soure regulated to 40 psi (2.76 bar), MP Rotator nozzle. Maroon adj arc 90 to 210, L=Light Blue 210 to 270 arc, Dlive 360 arc on PRS40 body. Atter MP2000 PROS-12-PRS40-CV G Ab Rotator, 12" (30.48 cm) pop-up with check valve, soure regulated to 40 psi (2.76 bar), MP Rotator nozzle. Alack adj arc 90-210, G=Green adj arc 210-270, R=Red arc on PRS40 body. Atter MP2000 PROS-12-PRS40-CV K
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NUFACTURER/MODEL/DESCRIPTION ing Remote Control Valve ing remote control valve to remain.
ter ICV-G-FS with ICD-100 ing remote control valve, glass-filled nylon construction, be configuration, NPT threaded inlet/outlet, with single ion decoder.
ter HQ-33DRC ing Quick coupler valve, yellow rubber cover, red brass I stainless steel, with 3/4" NPT inlet, 2-piece body.
ing Leemco LGT22SS304X nless steel gate valve.
ing Zurn 950XL Ible Check Valve Assembly
ing Junction Box ndard size valve box with wire splice.
ing Hunter ICV-G w FS-100-B, ICD-100, ICD-SEN emote control master valve, glass-filled nylon struction, globe configuration, NPT threaded inlet/outlet,
1" brass flow sensor and sensor decoder. Ter Meter 1-1/2" Ting Water Meter per City
ation Lateral Line: PVC Schedule 40
ation Mainline: PVC Schedule 40
e Sleeve: HDPE PE4710 DR 11 ipe sleeve for irrigation mainline, lateral lines, and wire
(11 111
duit. Sleeve: PVC Schedule 40 fre path, 12 gauge, twisted pair. Color coded per valve edule.
e Sleeve: PVC Schedule 40 re path, 12 gauge, twisted pair. Color coded per valve
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DRAWING TITLE

IRRIGATION PLAN

GENERAL

- 1.1. THE SYSTEM HAS BEEN DESIGNED TO CONFORM WITH THE REQUIREMENTS OF ALL APPLICABLE CODES. SHOULD ANY CONFLICT EXIST, THE REQUIREMENTS OF THE CODES SHALL PREVAIL. IT IS THE RESPONSIBILITY OF THE OWNER/INSTALLATION CONTRACTOR TO INSURE THE ENTIRE SYSTEM IS INSTALLED ACCORDING TO ALL APPLICABLE LAWS, RULES, REGULATIONS AND CONVENTIONS. IRRIGATION CONTRACTOR IS RESPONSIBLE FOR OBTAINING ALL REQUIRED PERMITS ACCORDING TO FEDERAL, STATE AND LOCAL LAWS.
- 1.2. CONTRACTOR TO VERIFY LOCATION OF ALL EXISTING UTILITIES.
- 1.3. IT SHALL BE THE CONTRACTOR'S SOLE RESPONSIBILITY TO TAKE THE NECESSARY PRECAUTIONS TO ENSURE PROPER SAFETY AND WORKMANSHIP WHEN WORKING IN THE VICINITY OF EXISTING UTILITY LINES.
- 1.4. CONTRACTOR SHALL BE RESPONSIBLE TO COORDINATE AND VERIFY PROPER CLEARANCE WITH FPL ON ANY WORK IN THE VICINITY OF OVERHEAD OR UNDERGROUND POWER LINES.
- 1.5. THE CONTRACTOR MUST SUBMIT FOR APPROVAL, PRIOR TO INSTALLATION, COPIES OF THE MANUFACTURER'S CUT SHEETS/SPECIFICATIONS FOR ALL COMPONENTS TO BE USED IN THE IRRIGATION SYSTEM.
- 1.6. THE IRRIGATION CONTRACTOR SHALL BE CERTIFIED AS A CERTIFIED IRRIGATION CONTRACTOR BY THE IRRIGATION ASSOCIATION. THE CERTIFICATION SHALL BE CURRENT AND IN GOOD STANDING.

2. SCOPE OF WORK

- 2.1. THE WORK SPECIFIED IN THIS SECTION CONSISTS OF FURNISHING ALL COMPONENTS NECESSARY FOR THE INSTALLATION, TESTING, AND DELIVERY OF A COMPLETE, FULLY FUNCTIONAL AUTOMATIC LANDSCAPE IRRIGATION SYSTEM THAT COMPLETELY COMPLIES WITH THE 100% IRRIGATION PLANS, SPECIFICATIONS, NOTES, DETAILS AND ALL APPLICABLE LAWS, REGULATIONS, CODES AND ORDINANCES. THIS WORK SHALL INCLUDE, BUT NOT BE LIMITED TO, THE PROVIDING OF ALL REQUIRED MATERIAL (PIPE, VALVES, 6. FITTINGS, CONTROLLERS, WIRE, PRIMER, GLUE, ETC.), LAYOUT, PROTECTION OF THE PUBLIC, EXCAVATION, 6.1. ASSEMBLY, INSTALLATION, BACK FILLING, COMPACTING, REPAIR OF ROAD SURFACES, CONTROLLER AND LOW VOLTAGE FEEDS TO VALVES, CLEANUP, MAINTENANCE, GUARANTEE AND AS-BUILT PLANS.
- 2.2. ALL IRRIGATED AREAS SHALL PROVIDE 100% HEAD-TO-HEAD COVERAGE FROM A FULLY AUTOMATIC IRRIGATION SYSTEM WITH A RAIN SENSOR AS SHOWN. THE RAIN SENSOR SHALL BE INSTALLED TO PREVENT ITS ACTIVATION BY ADJACENT HEADS. ALL WATERING PROCEDURES SHALL CONFORM TO LOCAL CODES, AS WELL AS THIS PROJECT'S REGIONAL WATER MANAGEMENT DISTRICT RESTRICTIONS AND REGULATIONS. ZONES ARE PRIORITIZED FIRST BY PUBLIC SAFETY AND THEN BY HYDRAULIC CONCERNS. 7. THIS SEQUENCING WILL BE A MANDATORY PUNCH LIST ITEM. THESE PLANS HAVE BEEN DESIGNED TO 7.1. SATISFY/EXCEED THE FLORIDA BUILDING CODE (FBC) APPENDIX F AND THE FLORIDA IRRIGATION SOCIETY STANDARDS AND SPECIFICATIONS FOR TURF AND LANDSCAPE IRRIGATION SYSTEMS, FOURTH EDITION.
- 2.3. CONTRACTOR SHALL VERIFY THE LOCATION OF ALL UNDERGROUND UTILITIES 72 HOURS PRIOR TO COMMENCEMENT OF WORK.
- 2.4. IT IS THE RESPONSIBILITY OF THE IRRIGATION CONTRACTOR TO FAMILIARIZE THEMSELVES WITH ALL GRADE DIFFERENCES, LOCATION OF WALLS, RETAINING WALLS, STRUCTURES AND UTILITIES. DO NOT WILLFULLY INSTALL THE SPRINKLER SYSTEM AS SHOWN ON THE DRAWINGS WHEN IT IS OBVIOUS IN THE FIELD THAT UNKNOWN OBSTRUCTION, GRADE DIFFERENCES OR DIFFERENCES IN THE AREA DIMENSIONS EXIST THAT MIGHT NOT HAVE BEEN CONSIDERED IN THE DESIGN. SUCH OBSTRUCTIONS, OR DIFFERENCES, SHOULD BE BROUGHT TO THE ATTENTION OF THE OWNER' AUTHORIZED REPRESENTATIVE. IN THE EVENT THIS 8. NOTIFICATION IS NOT PERFORMED, THE IRRIGATION CONTRACTOR SHALL ASSUME FULL RESPONSIBILITY FOR ANY REVISIONS NECESSARY.
- 2.5. IRRIGATION CONTRACTOR SHALL REPAIR OR REPLACE ALL EXISTING SITE ITEMS DAMAGED BY THEIR 8.3. THREADED PIPE: PVC SCHEDULE 80. THE LOCATION AND INSTALLATION OF PIPE SLEEVES AND LATERALS THROUGH WALLS, UNDER ROADWAYS AND PAVING, ETC.
- 2.6. THE CONTRACTOR SHALL TAKE IMMEDIATE STEPS TO REPAIR, REPLACE, OR RESTORE ALL SERVICES TO ANY UTILITIES WHICH ARE DISRUPTED DUE TO THEIR OPERATIONS. ALL COSTS INVOLVED IN DISRUPTION OF SERVICE AND REPAIRS DUE TO NEGLIGENCE ON THE PART OF THE CONTRACTOR SHALL BE THE CONTRACTOR'S RESPONSIBILITY.

3. <u>SUBMITTALS</u>

- 3.1. THE CONTRACTOR SHALL PROVIDE FOR APPROVAL PRIOR TO INSTALLATION, MANUFACTURER'S PRODUCT DESCRIPTION SHEETS/SPECIFICATIONS FOR ALL MAJOR COMPONENTS OF THE IRRIGATION SYSTEM. MODEL NUMBERS SHALL BE HIGHLIGHTED OR CIRCLED.
- 3.2. NO SUBSTITUTIONS OR DEVIATIONS FROM THE SPECIFIED BRANDS, MODELS, OR SIZES SHALL BE PERMITTED, EXCEPT WITH WRITTEN APPROVAL FROM THE LANDSCAPE ARCHITECT OF RECORD.
- 3.3. ANY MAJOR DESIGN CHANGES SHALL BE BROUGHT TO THE ATTENTION OF THE LANDSCAPE ARCHITECT 8.7. OF RECORD PRIOR TO CONSTRUCTION; CONTRACTOR PROCEEDS WITH CHANGES AT OWN RISK. DESIGN CHANGES, SUBSTITUTIONS, OR DEVIATIONS NOT APPROVED BY THE LANDSCAPE ARCHITECT OF RECORD WILL RESULT IN REJECTION AND REPLACEMENT OF MATERIALS AT NO ADDITIONAL COST TO THE OWNER.

4. POST CONSTRUCTION DOCUMENTATION

4.1. DOCUMENTATION:

- PROVIDE THE MANUFACTURERS' RECOMMENDED OPERATING INSTRUCTIONS FOR ALL MAJOR COMPONENTS INCORPORATED INTO THE IRRIGATION SYSTEM.
- PROVIDE SYSTEM OPERATION MANUALS, MAINTENANCE SCHEDULES, RECOMMENDED SCHEDULE OF OPERATION INCLUDED AVERAGE APPLICATION RATES WITH SEASONAL ADJUSTMENTS FOR EACH
- PROVIDE ALL REQUIRED TESTING AND INSPECTION CERTIFICATES TO THE OWNER OR OWNER'S

- 4.2. AS-BUILT DRAWINGS: PROVIDE RECORD DRAWINGS AND PLANS SHOWING ALL CHANGES IN THE DESIGN 9. LAYOUT
 - TO INDICATE THE ACTUAL INSTALLATION AND LOCATION OF ALL EQUIPMENT AND MATERIALS. THE 9.1. LAY OUT IRRIGATION SYSTEM MAINLINES AND LATERAL LINES. MAKE THE NECESSARY ADJUSTMENTS AS 15.1. EXCAVATE STRAIGHT AND VERTICAL TRENCHES WITH SMOOTH, FLAT OR SLOPING BOTTOMS. TRENCH FOLLOWING SPECIFIC ITEMS MUST BE INCLUDED:
 - LOCATION AND SIZE OF MAINLINE PIPING, LATERAL PIPING, AND PIPE SLEEVING.
- ISOLATION VALVES
- REMOTE CONTROL VALVE LOCATIONS, SIZES, NUMBER, AND AREA OF COVERAGE SHOWN USING DIFFERENT COLORS.
- SPLICE BOXES AND LOW VOLTAGE WIRING PATH.
- CONTROLLER AND RAIN SHUTOFF DEVICES.
- POINT OF CONNECTION INCLUDING THE TYPE OF WATER SOURCE, SIZE, FLOW RATE, AND OPERATING PRESSURE. DATE AND SCALE.
- CONTRACTOR'S NAME, ADDRESS, AND TELEPHONE NUMBER.
- THE AS-BUILT DRAWINGS SHALL BE SIGNED BY A FLORIDA REGISTERED LANDSCAPE ARCHITECT OR PROFESSIONAL ENGINEER.
- CONTRACTOR SHALL FURNISH FIVE EXTRA UNITS OF EACH TYPE OF POPUP SPRAY AND EMITTER THAT MATCH PRODUCTS INSTALLED AND THAT ARE PACKAGED WITH PROTECTIVE COVERING FOR STORAGE AND IDENTIFIED WITH LABELS DESCRIBING CONTENTS. INCLUDE TOOLS TO SERVICE THESE PRODUCTS. 5. FINAL ACCEPTANCE

FINAL ACCEPTANCE OF THE IRRIGATION SYSTEM WILL BE GIVEN AFTER THE FOLLOWING DOCUMENTS

- AND CONDITIONS HAVE BEEN COMPLETED AND APPROVED. FINAL PAYMENT WILL NOT BE RELEASED UNTIL THESE CONDITIONS ARE SATISFIED.
- FINAL WALK-THRU AND CORRECTION OF ALL PUNCH LIST ITEMS.
- COMPLETION AND ACCEPTANCE OF AS-BUILT RECORD DRAWINGS.

TURNOVER OF ALL REQUIRED PARTS AND TOOLS AS OUTLINED IN THE PROJECT SPECIFICATIONS.

- FULLY WARRANT THE LANDSCAPE IRRIGATION SYSTEM FOR A PERIOD OF ONE (1) YEAR AFTER THE
- DURING THE WARRANTY PERIOD, ENFORCE MANUFACTURER'S AND SUPPLIER'S WARRANTIES MALFUNCTIONS, DEFICIENCIES, BREAKS, DAMAGES, DISREPAIR OR OTHER DISORDERS DUE TO MATERIALS WORKMANSHIP, OR INSTALLATION BY THE CONTRACTOR AND HIS SUPPLIERS SHALL BE IMMEDIATELY AND 11. CONTROL WIRING PROPERLY CORRECTED.
- REPAIR DAMAGES PROMPTLY WHICH ARE CAUSED BY SYSTEM MALFUNCTION.

- THE POC'S ARE EXISTING 1-1/2" WATER METERS, UTILIZING AN EXISTING MUNICIPAL POTABLE WATER MAIN THE POC SHALL BE CAPABLE OF SUPPLYING A MINIMUM OF 60 GPM AT 60 PSI. CONTRACTOR SHALL VERIFY THESE MINIMUM CONDITIONS CAN BE MET PRIOR TO BEGINNING IRRIGATION SYSTEM 11.2. INSTALLATION.
- 7.2. ALL EXISTING WATER METERS ARE MAINTAINED BY THE CITY OF WEST PALM BEACH UTILITIES. CONTRACTOR 11.3. TAPE AND BUNDLE CONTROL WIRES EVERY 10' AND RUN ADJACENT TO THE MAINLINE. AT ALL TURNS IN TO PROVIDE COORDINATION AND ANY NECESSARY PERMITTING FOR WORK RELATED TO WATER METERS.
- IF THE CONDITIONS CAN NOT BE MET, THE CONTRACTOR MUST NOTIFY THE DESIGNER PRIOR TO PROCEEDING WITH THE WORK. IF THE CONTRACTOR DOES NOT DO SO, THE CONTRACTOR PROCEEDS AT THEIR OWN RISK AND BECOMES RESPONSIBLE FOR ANY FUTURE WORK REQUIRED TO MAKE THE SYSTEM 11.4. PERFORM AS REQUIRED.

- MAINLINE PIPE: PVC SCHEDULE 40, NON-GASKETED, SOLVENT WELD, WITH PVC SCHEDULE 40 FITTINGS
- 8.2. LATERAL PIPE: PVC SCHEDULE 40, NON-GASKETED, SOLVENT WELD, WITH PVC SCHEDULE 40 FITTINGS.
- WORK. IRRIGATION CONTRACTOR SHALL COORDINATE THEIR WORK WITH OTHER CONTRACTORS FOR 8.4. PIPE LOCATIONS SHOWN ON THE PLAN ARE SCHEMATIC AND SHALL BE ADJUSTED IN THE FIELD. WHEN 12. GROUNDING LAYING OUT MAINLINES PLACE A MAXIMUM OF 12" AWAY FROM EITHER THE BACK OF CURB, FRONT OF 12.1. WALK, BACK OF WALK, OR OTHER HARDSCAPE TO ALLOW FOR EASE IN LOCATING AND PROTECTION FROM PHYSICAL DAMAGE. INSTALL ALL LATERAL PIPE NEAR EDGES OF PAVEMENT OR AGAINST BUILDINGS WHENEVER POSSIBLE TO ALLOW SPACE FOR PLANT ROOT BALLS. ALWAYS INSTALL PIPING INSIDE PROJECT PROPERTY BOUNDARY.
 - 8.5. PIPES SHALL ALWAYS BE PLACED IN PLANTING BEDS. IF IT IS NECESSARY TO HAVE PIPING UNDER HARDSCAPES, SUCH AS ROADS, WALKS, AND PATIOS, THE PIPES MUST BE SLEEVED USING SCH 40 PVC WITH THE SLEEVE DIAMETER BEING TWICE THE SIZE OF THE PIPE IT IS CARRYING WITH A MINIMUM SLEEVE 12.2. GROUNDING FOR DECODERS AND 2-WIRE PATH SHALL BE PROVIDED FOR EVERY 400 LINEAR FEET. SIZE OF 2".
 - 8.6. PIPE SIZES SHALL CONFORM TO THOSE SHOWN ON THE DRAWINGS. NO SUBSTITUTIONS OF SMALLER PIPE SIZES SHALL BE PERMITTED, BUT SUBSTITUTIONS OF LARGER SIZES MAY BE APPROVED. ALL DAMAGED AND 13. VALVES REJECTED PIPE SHALL BE REMOVED FROM THE SITE AT THE TIME OF SAID REJECTION.
 - CONTRACTOR TO ENSURE ALL MAINLINE PIPING IS PROPERLY RESTRAINED USING MECHANICAL JOINT FITTINGS, RESTRAINING COLLARS, THREADED RODS, THRUST BLOCKS, ETC., AS AND WHERE REQUIRED CONTRACTOR SHALL REFER TO PIPE MANUFACTURER'S RECOMMENDED INSTALLATION PRACTICES FOR 13.2. ADJUST THE FLOW CONTROL ON EACH RCV TO ENSURE SHUT OFF IN 10 SECONDS AFTER DEACTIVATION
 - 8.8. PVC PIPE JOINT COMPOUND AND PRIMER: SLOW-DRYING, HEAVY DUTY CEMENT AND TINTED (PURPLE) 13.3. USING 3" HIGH NUMBER STENCILS, PAINT THE VALVE NUMBER IN WHITE ON THE LID OF EACH VALVE BOX. PRIMER THAT IS COMPATIBLE WITH THE CEMENT. THE PVC CEMENT SHALL BE WELD-ON 2711 GREY AND 14. EQUIPMENT THE PRIMER SHALL BE WELD-ON P70 PURPLE PRIMER, OR APPROVED EQUALS.
 - 8.9. MAIN LINE PIPE DEPTH MEASURED TO THE TOP OF PIPE SHALL BE 18" MINIMUM, 36" MINIMUM AT VEHICULAR CROSSINGS.
 - 8.10. LATERAL LINE DEPTHS MEASURED TO TOP OF PIPE SHALL BE 12" MINIMUM, 30" MINIMUM AT VEHICULAR CROSSINGS.

- REQUIRED TO TAKE INTO ACCOUNT ALL SITE OBSTRUCTIONS AND LIMITATIONS PRIOR TO EXCAVATING
- STAKE ALL SPRINKLER HEAD LOCATIONS. ADJUST LOCATION AND MAKE THE NECESSARY MODIFICATIONS TO NOZZLE TYPES, ETC., REQUIRED TO INSURE 100% HEAD TO HEAD COVERAGE, REFER TO THE EDGE OF PAVEMENT DETAIL ON THE IRRIGATION DETAIL SHEET.
- 9.3. SPRAY HEADS SHALL BE INSTALLED 4" FROM SIDEWALKS OR CURBED ROADWAYS AND 12" FROM UNCURBED ROADWAYS.
- 9.4. Shrub heads shall be installed on 3/4" sch 40 pvc risers. The risers shall be set at a minimum 16. <u>Installation</u> OF 18" OFF SIDEWALKS, ROADWAY CURBING, BUILDING FOUNDATIONS, AND/OR ANY OTHER HARDSCAPED AREAS. SHRUB HEADS SHALL BE INSTALLED TO A STANDARD HEIGHT OF 4" BELOW MAINTAINED HEIGHT OF PLANTS AND SHALL BE INSTALLED WITHIN PLANTED MASSES TO BE LESS VISIBLE AND OFFER PROTECTION. PAINT ALL SHRUB RISERS WITH FLAT BLACK OR FOREST GREEN PAINT, UNLESS IRRIGATION SYSTEM WILL BE INSTALLED FROM A REUSE WATER SYSTEM WITH PURPLE PVC RISERS
- LOCATE VALVES PRIOR TO EXCAVATION. INSURE THAT THEIR LOCATION PROVIDES FOR EASY ACCESS AND THAT THERE IS NO INTERFERENCE WITH PHYSICAL STRUCTURES, PLANTS, TREES, POLES, ETC. VALVE BOXES MUST BE PLACED A MINIMUM OF 12" AND A MAXIMUM OF 15" FROM THE EDGE OF PAVEMENT, CURBS, ETC., AND THE TOP OF THE BOX MUST BE 2" ABOVE FINISH GRADE. NO VALVE BOXES SHALL BE INSTALLED IN TURF AREAS WITHOUT APPROVAL BY THE IRRIGATION DESIGNER; ONLY IN SHRUB BEDS NEVER INSTALL VALVE BOXES WITHIN A SPORTS FIELD OR DESIGNATED PLAY AREA

10. ELECTRICAL POWER SUPPLY

- CONTROLLER AND TURN OVER ALL EXISTING EQUIPMENT TO THE TOWN OF PALM BEACH
- 10.2. ALL ELECTRICAL INSTALLATION TO COMPLY WITH THE NATIONAL ELECTRICAL CODE AND ANY AND ALL OTHER APPLICABLE ELECTRICAL CODES, LAWS AND REGULATIONS. A LICENSED ELECTRICIAN SHALL PERFORM ALL ELECTRICAL HOOK-UPS. POWER FOR THE CONTROLLER SHALL BE 120 VOLT, 20 AMP.

- 11.1. IRRIGATION CONTROL WIRE PATH SHALL BE TWISTED PAIR, SOLID-CORE, COLOR-CODED RED/BLUE PAIRS, 18. TESTING & FLUSHING ENCLOSED IN A COLOR-CODED PE SLEEVE SUITABLE FOR DIRECT BURIAL AND CONTINUOUS OPERATION 18.1. LEAKAGE TESTING AT RATED VOLTAGES. WIRING FROM DECODERS TO SOLENOIDS SHALL BE THERMOPLASTIC SOLID 18.1.1. COPPER, SINGLE CONDUCTOR, LOW VOLTAGE IRRIGATION CONTROLLER WIRE SUITABLE FOR DIRECT BURIAL AND CONTINUOUS OPERATION AT RATED VOLTAGES.
- ALL CONTROL WIRING SHALL BE PLACED IN 1" PVC SCHEDULE 40 GRAY ELECTRICAL CONDUIT. AT TURNS 18.1.2. IN DIRECTION UTILIZE JUNCTION BOXES. VALVE AND JUNCTION BOX LOCATIONS MAY BE COMBINED.
- DIRECTION MAKE A 2' COIL OF WIRE. AT ALL VALVE BOXES COIL WIRE AROUND A 3/4" PIECE OF PVC PIPE TO MAKE A COIL USING 32 LINEAR INCHES OF WIRE. MAKE ELECTRICAL CONNECTIONS WITH 3M DBY/R CONNECTORS.
- NUMBER ALL WIRES USING AN ELECTRICAL BOOK OF NUMBERS ACCORDING TO THE PLANS. NUMBER WIRES IN ALL VALVE BOXES, JUNCTION BOXES AND AT THE CONTROLLER.
- 11.5. WIRE SIZED, NUMBERED AND COLORED AS FOLLOWS:
 - #12 TWISTED PAIR: RED/BLUE
 - #12 COMMON, DECODER TO VALVE: BLACK

#12 CONTROL, DECODER TO VALVE: RED

- CONTRACTOR TO UTILIZE 4" X 96" X 0.06" COPPER GROUNDING PLATES, 5/8" X 10' COPPER CLAD GROUNDING RODS, 'ONE STRIKE' CAD WELLS AT ALL CONNECTION POINTS, #6 BARE COPPER WIRE, AND EARTH CONTACT MATERIAL. INSTALL THESE AND OTHER REQUIRED COMPONENTS AS OUTLINED IN THE DETAIL. CONTRACTOR TO VERIFY THAT THE EARTH TO GROUND RESISTANCE DOES NOT EXCEED 10 OHMS. CONTRACTOR SHALL PROVIDE A WRITTEN CERTIFICATION ON A LICENSED ELECTRICAL CONTRACTORS LETTER HEAD SHOWING THE DATE OF THE TEST, CONTROLLER LOCATION, AND TEST RESULTS. EACH CONTROLLER SHALL BE SO GROUNDED AND TESTED.
- DECODER GROUNDING SHALL INCLUDE A LINE SURGE PROTECTOR DECODER AND GROUNDING AS DESCRIBED IN 12.1, ABOVE TO ACHIEVE 10 OHMS OR LESS.

- 13.1. SEQUENCE ALL VALVES SO THAT THE FARTHEST VALVE FROM THE P.O.C. OPERATES FIRST AND THE CLOSEST TO THE P.O.C. OPERATES LAST. THE CLOSEST VALVE TO THE P.O.C. SHOULD BE THE LAST VALVE IN THE PROGRAMMED SEQUENCE.
- BY THE IRRIGATION CONTROLLER
- 14.1. BUBBLERS SHALL BE INSTALLED USING SCH 80 NIPPLES AND SHALL BE PLACED AT THE BASE OF TREES FOR
- 14.2. ALL POP-UP HEADS AND SHRUB RISERS SHALL BE PRESSURE COMPENSATING. ALL POP-UP HEADS SHALL BE MOUNTED ON FLEX-TYPE SWING JOINTS.
- 14.3. ALL SPRINKLER EQUIPMENT NOT OTHERWISE DETAILED OR SPECIFIED SHALL BE INSTALLED AS PER MANUFACTURER'S RECOMMENDATIONS AND SPECIFICATIONS, AND IN ACCORDANCE WITH LOCAL AND STATE LAWS.

15. TRENCHING

- WIDTH AND DEPTH SHOULD BE SUFFICIENT TO ALLOW FOR THE PROPER VERTICAL AND HORIZONTAL SEPARATION BETWEEN PIPING AS SHOWN IN THE PIPE INSTALLATION DETAIL ON THE DETAIL SHEET.
- 15.2. PROTECT EXISTING LANDSCAPED AREAS. REMOVE AND REPLANT ANY DAMAGED PLANT MATERIAL UPON JOB COMPLETION. THE REPLACEMENT MATERIAL SHALL BE THE SAME GENUS, SPECIES, AND SIZE OF THE MATERIAL IT IS REPLACING. THE FINAL DETERMINATION AS TO WHAT NEEDS TO BE REPLACED AND THE ACCEPTABILITY OF THE REPLACEMENT MATERIAL SHALL BE SOLELY DETERMINED BY THE OWNER OR OWNER'S REPRESENTATIVE.

- CUT ALL PIPE SQUARE AND DEBURR. CLEAN PIPE AND FITTINGS OF FOREIGN MATERIAL. THEN APPLY A SMALL AMOUNT OF PRIMER WHILE ENSURING THAT ANY EXCESS IS WIPED OFF IMMEDIATELY. PRIMER SHOULD NOT PUDDLE OR DRIP FROM PIPE OR FITTINGS. NEXT APPLY A THIN COAT OF PVC CEMENT. FIRST APPLY A THIN LAYER TO THE PIPE, THEN A THIN LAYER INSIDE THE FITTING, AND FINALLY ANOTHER VERY THIN LAYER ON THE PIPE. INSERT THE PIPE INTO THE FITTING. INSURE THAT THE PIPE IS INSERTED TO THE BOTTOM OF THE FITTING, THEN TURN THE PIPE A 1/4 TURN AND HOLD FOR 10 SECONDS. MAKE SURE THAT THE PIPE DOESN'T RECEDE FROM THE FITTING. IF THE PIPE ISN'T AT THE BOTTOM OF THE FITTING UPON COMPLETION, THE GLUE JOINT IS UNACCEPTABLE AND MUST BE DISCARDED
- PIPES MUST CURE A MINIMUM OF 30 MINUTES PRIOR TO HANDLING AND PLACING INTO TRENCHES. A LONGER CURING TIME MAY BE REQUIRED; REFER TO THE MANUFACTURER'S SPECIFICATIONS. THE PIPE MUST CURE A MINIMUM OF 24 HOURS PRIOR TO FILLING WITH WATER

17. BACKFILLING

- 10.1. ELECTRICAL SUPPLY FOR PROPOSED CONTROLLER IS EXISTING. CONTRACTOR TO REMOVE EXISTING 17.1. THE BACKFILL 6" BELOW AND 6" ABOVE ALL PIPING SHALL BE CLEAN SAND. ALL OTHER TRCNCH BACKFILL CAN BE NATIVE MATERIAL BUT SHALL NOT CONTAIN ANYTHING LARGER THAN 2" IN DIAMETER.
 - CONTRACTOR SHALL BACKFILL ALL PIPING, BOTH MAINLINE AND LATERALS, PRIOR TO PERFORMING ANY PRESSURE TESTS. THE PIPE SHALL BE BACKFILLED WITH THE EXCEPTION OF 2' ON EACH SIDE OF EVERY JOINT (BELL FITTINGS, 90'S, TEES, 45'S, ETC.). THESE JOINTS SHALL NOT BE BACKFILLED UNTIL ALL PIPING HAS SATISFACTORILY PASSED ITS APPROPRIATE PRESSURE TEST AS OUTLINED BELOW

- REMOVE ALL REMOTE CONTROL VALVES AND CAP USING A THREADED CAP. FILL MAINLINE WITH WATER AND PRESSURIZE THE SYSTEM TO 125 PSI. MONITOR THE SYSTEM PRESSURE AT TWO GAUGE LOCATIONS; THE GAUGE LOCATIONS MUST BE AT OPPOSITE ENDS OF THE MAINLINE. WITH THE SAME RESPECTIVE PRESSURES, MONITOR THE GAUGES FOR TWO HOURS.
- PVC SOLVENT-WELD PIPE CONNECTIONS SHALL HAVE NO LEAKAGE. GASKETED PIPING SHALL LOSE NO MORE WATER THAN ALLOWED PER THE FLORIDA STATE BUILDING CODE, VOLUME II PLUMBING, PART VI, APPENDIX 'F'. REFER TO THIS SECTION FOR THE FORMULA TO BE USED TO CALCULATE THE MAXIMUM ALLOWABLE WATER LOSS DURING THE TESTING TIME.
- REPAIR ALL LEAKS AND RETEST MAINLINE PIPING UNTIL THE TEST IS SUCCESSFUL 18.1.4.
- LATERAL PIPE MUST BE FILLED AND VISUALLY CHECKED FOR LEAKS. ANY LEAKS DETECTED MUST BE REPAIRED. NO PRESSURE TEST OF THE LATERAL LINES IS REQUIRED.

18.2. FLUSHING:

- 18.2.1. PRIOR TO THE PLACEMENT OF HEADS, FLUSH ALL LINES FOR A MINIMUM OF 10 MINUTES OR UNTIL LINES ARE COMPLETELY CLEAN OF DEBRIS, WHICHEVER IS LONGER.
- USE SCREENS IN HEADS AND ADJUST HEADS FOR PROPER COVERAGE AVOIDING EXCESS WATER ON WALLS, WALKS AND PAVING.

18.3. OPERATIONAL TESTING:

- 18.3.1. UPON COMPLETION OF BACKFILLING, FINISH GRADING AND CONTOURING, TEST THE ENTIRE SYSTEM FOR PROPER OPERATION, INCLUDING ELECTRICALLY ACTUATING THE REMOTE CONTROL VALVES. RUN EACH ZONE UNTIL WATER BEGINS TO PUDDLE OR RUN OFF. THIS WILL ALLOW DETERMINATION OF THE NUMBER OF IRRIGATION START TIMES NECESSARY TO MEET THE WEEKLY EVAPOTRANSPIRATION REQUIREMENTS OF THE PLANTING MATERIAL IN EACH ZONE. IN SANDY SOILS NO PUDDLING WILL OCCUR. IN THESE CASES, CALCULATE THE REQUIRED RUN TIMES.
- ONCE THE MAINLINE AND LATERAL LINES HAVE PASSED THEIR RESPECTIVE TESTS AND THE SYSTEM IS COMPLETELY OPERATIONAL, A COVERAGE TEST AND DEMONSTRATION OF THE SYSTEM IS REQUIRED. THE IRRIGATION CONTRACTOR MUST DEMONSTRATE TO THE OWNER OR HIS/HER REPRESENTATIVE THAT PROPER COVERAGE IS OBTAINED AND THAT THE SYSTEM WORKS AUTOMATICALLY FROM THE CONTROLLER. THIS DEMONSTRATION REQUIRES THAT EACH ZONE BE TURNED ON IN THE PROPER SEQUENCE AS SHOWN ON THE PLANS FROM THE CONTROLLER. EACH ZONE WILL BE INSPECTED FOR PROPER COVERAGE AND FUNCTION. THE DETERMINATION OF PROPER COVERAGE AND FUNCTION WILL BE SOLELY DETERMINED BY THE OWNER OR OWNER'S REPRESENTATIVE.

500 West Cypress Creek Road Suite 600 Ft. Lauderdale, FL 33309 954.730.0707 www.chenmoore.com

REGISTRATION **ERIC DOUGLAS HARRISON, RLA**

REGISTRATION NO. 6667129



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CLIENT

Town of Palm Beach Public Works 951 Okeechobee Road, Suite A West Palm Beach, FL 33401 561.838.5440

Project Manager: Mike Roach, PE

PROJECT INFORMATION

ROYAL **POINCIANA WAY**

PROJECT NUMBER 24-0431.00060

CLIENT PROJECT NUMBER

VERIFY SCALES

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IRRIGATION **SPECIFICATIONS**

SYMBOL	MANUFACTURER/MODEL	QTY	ARC	PSI	GPM	RADIUS
	Hunter MP Strip PROS-06-PRS40-CV LST	2	LCS	40	0.22	5'x15'
	Hunter MP Strip PROS-06-PRS40-CV RST	1	RCS	40	0.22	5'x15'
$\langle \overline{M} \rangle$	Hunter MP1000 PROS-06-PRS40-CV M	4	90-210	40		14'
K	Hunter MP2000 PROS-06-PRS40-CV K	28	90-210	40		19'
R	Hunter MP2000 PROS-06-PRS40-CV R	9	360	40	1.48	19'
•	Hunter MP800SR PROS-06-PRS40-CV ADJ	311	Adj	40		10'
	Hunter MP Strip PROS-12-PRS40-CV LST	10	LCS	40	0.22	5'x15'
	Hunter MP Strip PROS-12-PRS40-CV RST	16	RCS	40	0.22	5'x15'
	Hunter MP Strip PROS-12-PRS40-CV SST	182	SST	40	0.44	5'x30'
$\overline{\mathbb{M}}$	Hunter MP1000 PROS-12-PRS40-CV M	8	90-210	40		14'
<u>©</u>	Hunter MP2000 PROS-12-PRS40-CV G	16	210-270	40		19'
K	Hunter MP2000 PROS-12-PRS40-CV K	47	90-210	40		19'
$\overline{\mathbb{R}}$	Hunter MP2000 PROS-12-PRS40-CV R	10	360	40	1.48	19'
•	Hunter MP800SR PROS-12-PRS40-CV ADJ	158	Adj	40		10'
SYMBOL	MANUFACTURER/MODEL/DESCRIPTION	QTY				
	Existing Remote Control Valve Existing remote control valve to remain.	13				
	Hunter ICV-G-FS with ICD-100 Existing remote control valve, glass-filled nylon construction, globe configuration, NPT threaded inlet/outlet, with single station decoder.	4				
	Hunter HQ-33DRC Existing Quick coupler valve, yellow rubber cover, red brass and stainless steel, with 3/4" NPT inlet, 2-piece body.	2				
	Existing Leemco LGT22SS304X Stainless steel gate valve.	4				
N	Existing Zurn 950XL Double Check Valve Assembly	2				
С	Relocated Existing Hunter A2C-75D-M 2-Wire Decoder Controller with 75 station capacity, with PED-SS stainless pedestal.	1				
\Diamond	Existing Junction Box Standard size valve box with wire splice.	9				
	Existing Junction Box with Decoder Grounding 10" round valve box with 5/8" x 8' copper grounding rod, 10	2				

	ohms resistance or less. Install minimum of 8° from irrigation mainline, decoders, or remote control valves.	2
	Hunter RAIN-CLIK Rain Sensor, with conduit installation, mount as noted. Normally closed switch.	1
	Existing Hunter ICV-G w FS-100-B, ICD-100, ICD-SEN 1" remote control master valve, glass-filled nylon construction, globe configuration, NPT threaded inlet/outlet, with 1" brass flow sensor and sensor decoder.	2
	Water Meter 1-1/2" Existing Water Meter per City	2
-	Irrigation Lateral Line: PVC Schedule 40	9,181 l.f.

4" pipe sleeve for irrigation mainline, lateral lines, and wire

2-wire path, 12 gauge, twisted pair. Color coded per valve 262.0 l.f.


1,282 l.f.

547.8 l.f.

Irrigation Mainline: PVC Schedule 40

Pipe Sleeve: HDPE PE4710 DR 11

Pipe Sleeve: PVC Schedule 40

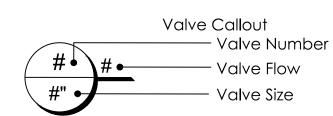

GENERAL NOTES

- PROVIDED BY UTILITY COMPANIES.
- 2. CONTRACTOR TO VERIFY LOCATION OF ALL EXISTING SITE FEATURES AND UTILITIES.
- 3. IT SHALL BE THE CONTRACTOR'S SOLE RESPONSIBILITY TO TAKE THE NECESSARY PRECAUTIONS TO ENSURE
- OR UNDERGROUND POWER LINES.
- 5. CONTRACTOR SHALL VERIFY PROPER CLEARANCE BELOW EXISTING OVERHEAD POWER LINES PRIOR TO
- 6. MAINLINE LOCATION, WHERE SHOWN, IS FOR GRAPHIC CLARITY PURPOSES ONLY. INSTALL AT THE BACK OF CURB, FRONT OF WALK, BACK OF WALK, OR ADJACENT TO OTHER HARDSCAPES TO FACILITATE FUTURE LOCATION AND TO PROTECT FROM DAMAGE. ENSURE MAINLINE IS INSTALLED ACCORDING TO THE IRRIGATION
- SPECIFICATIONS AND DETAILS. 7. IF IT IS NECESSARY TO HAVE PIPING UNDER HARDSCAPE ITEMS, SUCH AS ROADS, WALKS AND PATIOS, THE PIPES MUST BE SLEEVED WITH THE SLEEVE DIAMETER BEING AT LEAST TWICE THE SIZE OF THE PIPE IT IS CARRYING.
- 8. ANY MAJOR DESIGN CHANGES SHALL BE BROUGHT TO THE ATTENTION OF THE LANDSCAPE ARCHITECT OF RECORD PRIOR TO CONSTRUCTION; CONTRACTOR PROCEEDS WITH CHANGES AT OWN RISK.
- 9. NO SUBSTITUTIONS SHALL BE PERMITTED, EXCEPT WITH WRITTEN APPROVAL FROM THE LANDSCAPE ARCHITECT
- OF RECORD. 10. CONTRACTOR TO REPLACE ALL TURF AND SHRUBS DAMAGED FROM THE REMOVAL OF EXISTING IRRIGATION SYSTEM AND THE INSTALLATION OF PROPOSED IRRIGATION SYSTEM.
- 11. CONTRACTOR TO PHASE THE DEMOLITION OF EXISTING IRRIGATION SYSTEM AND THE INSTALLATION OF PROPOSED IRRIGATION SYSTEM BY MEDIAN IN ORDER TO LIMIT CONSTRUCTION ACTIVITY AND IMPACTS TO THE VISUAL APPEARANCE OF TURF AREAS ALONG ROYAL PALM WAY. CONTRACTOR TO SUBMIT PHASING PLAN TO TOWN OF PALM BEACH FOR APPROVAL.
- 12. THE CONTRACTOR TO PROVIDE PROTECTIVE MEASURES FOR ALL DECORATIVE POTS AND STATUE WITHIN THE LIMITS OF CONSTRUCTION FOR THE DURATION OF THE PROJECT. ANY DAMAGE TO THESE ITEMS AS A RESULT OF THE CONSTRUCTION ACTIVITIES WILL BE THE RESPONSIBILITY OF THE CONTRACTOR FOR REPLACEMENT IN KIND.

MAINTENANCE OF TRAFFIC

- 1. MAINTENANCE OF TRAFFIC SHALL BE IN ACCORDANCE WITH FLORIDA DEPARTMENT OF TRANSPORTATION (FDOT) DESIGN STANDARDS INDEX, 600 SERIES, 2020-21 EDITION OF THE STANDARD PLANS.
- 2. NO EXCAVATIONS WILL BE CONDUCTED WITHIN THE ROADWAY OF ROYAL POINCIANA WAY. MOVEMENTS OF CONSTRUCTION VEHICLES AND STAGING OF EQUIPMENT SHALL BE FOR NO LONGER THAN 60 MINUTES. OPERATIONS SHALL BE CONDUCTED IN ACCORDANCE WITH FDOT DESIGN STANDARD INDEX 602.
- 3. CONTRACTOR RESPONSIBLE FOR ACQUIRING FDOT AND TOWN OF PALM BEACH RIGHT OF WAY PERMITS. AS A CONDITION OF THE TOWN ROW PERMIT REQUIREMENTS, THE CONTRACTOR IS RESPONSIBLE FOR SUBMITTING WEEKLY TRAFFIC UPDATES TO THE TOWN FOR THE DURATION OF THE PROJECT.

VALVE SCHEDULE

	<u>NUMBER</u>	MODEL	SIZE	TYPE	<u>GPM</u>	<u>PSI</u>
existing	1	Hunter ICV-G-FS with ICD-100	1-1/2"	Turf Rotary	24.49	42.6
	2	Hunter ICV-G-FS with ICD-100	1-1/2"	Shrub Rotary	24.2	42.3
	3	Hunter ICV-G-FS with ICD-100	1-1/2"	Turf Rotary	19.02	42.9
	4	Hunter ICV-G-FS with ICD-100	1-1/2"	Shrub Rotary	17.91	42.8
	5	Hunter ICV-G-FS with ICD-100	1-1/2"	,		1.5
	6	Hunter ICV-G-FS with ICD-100	1-1/2"	Shrub Rotary	25.57	46.4
	7	Hunter ICV-G-FS with ICD-100	1-1/2"	Turf Rotary	26.79	45.0
	8	Hunter ICV-G-FS with ICD-100	1-1/2"	Turf Rotary	15.14	42.2
	9	Hunter ICV-G-FS with ICD-100	1-1/2"	Shrub Rotary	21.26	42.3
	10	Hunter ICV-G-FS with ICD-100	1-1/2"	Turf Rotary	28.48	43.2
,	11	Hunter ICV-G-FS with ICD-100	1-1/2"	Shrub Rotary	27.81	42.8
EXISTING	12	Hunter ICV-G-FS with ICD-100	1-1/2"	Turf Rotary	15.13	42.8
PROPOSED	13	Hunter ICV-G-FS with ICD-100	1-1/2"	Shrub Rotary	19.51	43.3
	14	Hunter ICV-G-FS with ICD-100	1-1/2"	,		1.5
	15	Hunter ICV-G-FS with ICD-100	1-1/2"	Shrub Rotary	15.76	44.5
7	16	Hunter ICV-G-FS with ICD-100	1-1/2"	Shrub Rotary	28.29	44.4
PROPOSED	17	Hunter ICV-G-FS with ICD-100	1-1/2"	Turf Rotary	30.85	43.6
			•	,		

AREAS AND QUANTITIES HAVE BEEN PROVIDED FOR CONVENIENC ONLY. CONTRACTOR TO PROVIDE TOTAL QUANTITIES REQUIRE FOR COMPLETE IRRIGATION SYSTEM AND SITE RESTORATION. TOWN OF PALM BEACH MAY MODIFY QUANTITIES AS NECESSARY

FDOT GENERAL NOTES

- GOVERNING STANDARD PLANS:
- FLORIDA DEPARTMENT OF TRANSPORTATION, FY 2024-25 STANDARD PLANS FOR ROAD AND BRIDGE CONSTRUCTION AND APPLICABLE INTERIM REVISIONS (IRS).
- WEBSITE: https://www.fdot.gov/design/standardplans GOVERNING STANDARD SPECTIFICATIONS:
- FLORIDA DEPARTMENT OF TRANSPORTATION, JULY 2024 STANDARD SPECIFICATIONS FOR ROAD AND BRIDGE CONSTRUCTION.
- WEBSITE: https://www.fdot.gov/programmanagement/implemented/specbooks 3. CONTRACTOR SHALL REPAIR ALL DAMAGE DONE TO FDOT PROPERTY DURING DEMOLITION, RELOCATION
- &/OR INSTALLATION ACTIVITIES AT HIS SOLE EXPENSE. 4. ANY PLANT MATERIAL SUBSTITUTION WITHIN OR IMPACTING THE FDOT RIGHT OF WAY WHETHER REQUESTED BY THE CONTRACTOR, OWNER, LANDSCAPE ARCHITECT OR OTHER WILL NEED TO GET APPROVAL FROM THE FDOT
- OWNERSHIP OF ALL SUITABLE EXCAVATED MATERIALS, AS DETERMINED BY THE DEPARTMENT, SHALL REMAIN IN THE DEPARTMENT UNTIL A FINAL ACCEPTANCE OF THE PERMITTED PROJECT IS FULFILLED. EXCAVATED MATERIALS SHALL BE HAULED BY THE PERMITTEE, AT THEIR COST & EXPENSE FROM THE SITE TO THE PALM BEACH OPERATIONS CENTER OR STOCKPILED IN THOSE AREAS AS DIRECTED BY THE DEPARTMENT, INCLUDING ASPHALT

FDOT IRRIGATION NOTES

- THE IRRIGATION SYSTEM SHALL USE THE LOWEST QUALITY WATER AVAILABLE WHICH ADEQUATELY AND SAFELY MEETS THE WATER NEEDS OF THE SYSTEM. STORM WATER, RECLAIM WATER, OR GREY WATER IRRIGATION SHALL BE USED WHENEVER POSSIBLE.
- 2. FDOT REQUIRES 24-HOUR EMERGENCY ACCESS TO WATER SOURCE.
- 3. CONTRACTOR SHALL PROVIDE FDOT DISTRICT OPERATIONS MANAGER WITH A SET OF "AS-BUILT" IRRIGATION
- 4. SLEEVING MUST BE 36" BELOW THE ROADWAY. VERIFY WITH FDOT MAINTENANCE THAT SLEEVING/DIRECTIONAL BORE IS PERMITTED AT THIS TIME. A NEWLY RESURFACED ROAD CANNOT BE DISTURBED FOR 5 YEARS.
- 5. PERMITTEE'S REPRESENTATIVE & AN FDOT INSPECTOR MUST BE ON SITE DURING ALL BORING ACTIVITIES. UPON COMPLETION OF THE BORING ACTIVITIES, PERMITTEE SHALL PROVIDE ALL DOCUMENTATION TO BE IN

ACCORDANCE WITH FDOT STANDARD SPECIFICATIONS, SECTION 555 OR 556, WHICHEVER IS APPLICABLE.

- PERMITTEE'S CONTRACTORS THAT ARE PERFORMING DIRECTIONAL DRILLING AND/OR JACK AND BORE ACTIVITIES SHALL PROVIDE THE DEPARTMENT (PERMITS OFFICE) PROOF OF A PROPER STATE CONTRACTOR'S LICENSE AND CERTIFICATE OF LIABILITY INSURANCE PRIOR TO ANY COMMENCEMENT OF PERMITTED WORK.
- PERMITTEE WILL ENSURE THAT ALL LOCATES HAVE BEEN PERFORMED PRIOR TO SCHEDULING OF ANY BORING ACTIVITIES. THIS SHALL INCLUDE SOFT DIGS TO VERIFY VERTICAL & HORIZONTAL ALIGNMENT.
- 8. SHOULD THE IRRIGATION SYSTEM NOT BE FUNCTIONAL FOR A PERIOD OF TIME DURING CONSTRUCTION, ENSURE THAT MEASURES ARE TAKEN TO WATER THE EXISTING PLANT MATERIAL AND SOD. THIS MAY INCLUDE PORTIONS OF THE MEDIAN OUTSIDE THE RENOVATION AREA DEPENDING ON HOW THE SYSTEM IS ZONED.

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REGISTRATION

ERIC DOUGLAS HARRISON, RLA REGISTRATION NO. 6667129



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CLIENT

Town of Palm Beach Public Works

951 Okeechobee Road, Suite A West Palm Beach, FL 33401 561.838.5440

Project Manager

Mike Roach, PE

PROJECT INFORMATION

ROYAL POINCIANA WAY

PROJECT NUMBER 24-0431.00060

CLIENT PROJECT NUMBER

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REVISIONS

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DATE OF ISSUE

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DRAWING TITLE


IRRIGATION SCHEDULE


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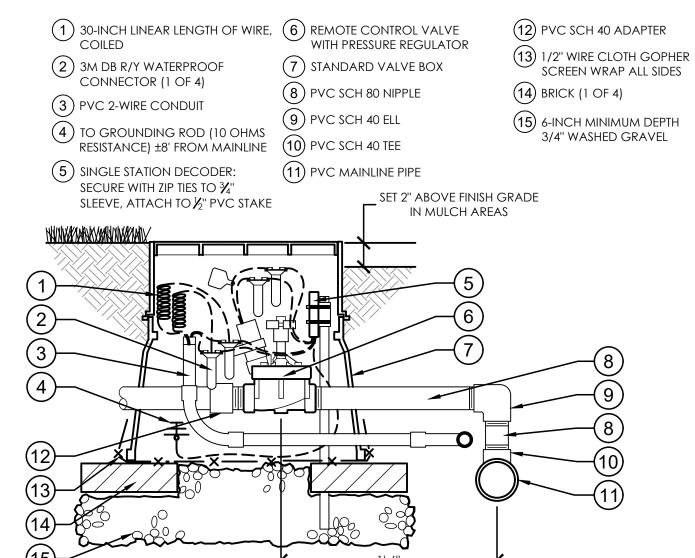
100% CONSTRUCTION DOCUMENTS/BID PLANS

MILLINGS.

DISTRICT LANDSCAPE ARCHITECT.



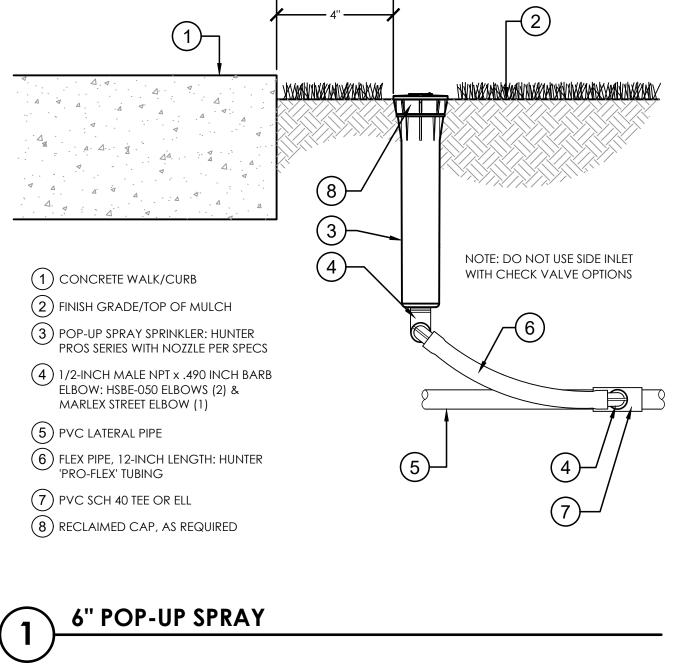


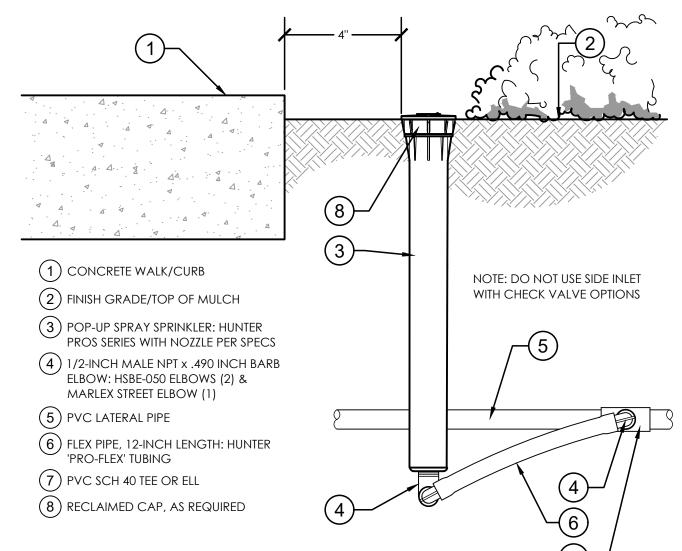


(1) TO DECODER/REMOTE CONTROL VALVE BOX (±8') (2) IRRIGATION MAINLINE SCREEN WRAP ALL SIDES

(3) 5/8" X 8' COPPER GROUNDING ROD (10 OHMS RESISTANCE) (4) 10" ROUND VALVE BOX

(5) BRICK (1 OF 3)

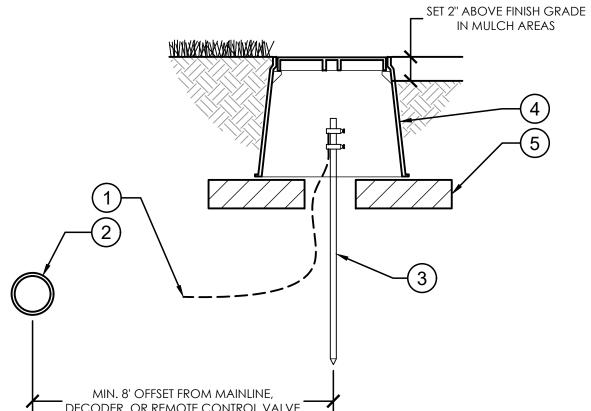

- 1) 30-INCH LINEAR LENGTH OF WIRE, (5) GROUNDING ROD (10 OHMS RESISTANCE OR LESS)
- (2) 3M DB R/Y WATERPROOF (6) STANDARD VALVE BOX CONNECTOR (1 OF 2) (7) 1/2" WIRE CLOTH GOPHER
- (3) PVC 2-WIRE CONDUIT SCREEN WRAP ALL SIDES (4) LINE SURGE DECODER: (8) BRICK (1 OF 4) SECURE WITH ZIP TIES TO 3/4" SLEEVE, ATTACH TO 1/2" PVC STAKE 9 6-INCH MINIMUM DEPTH

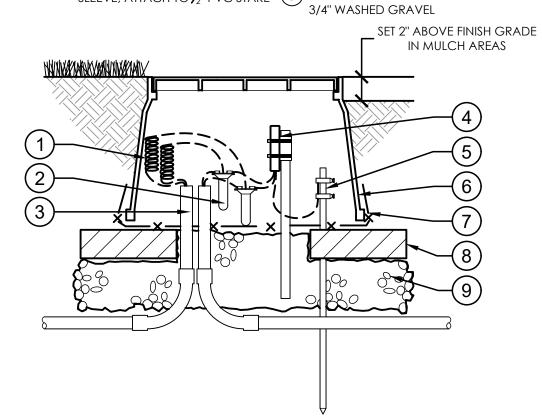

DECODER GROUNDING AND JUNCTION BOX

MAINLINE AND LATERAL PIPING

328409.79-26

12" POP-UP SPRAY


← 12" MAX. CLEARANCE (1) FINISH GRADE


HARDSCAPE SURFACE FIELD ADJUST PIPING AS NECESSARY TO AVOID CONFLICT (3) BACKFILL PER IRRIGATION WITH DRAINAGE STRUCTURES, UTILITIES, AND PLANTINGS. SPECIFICATIONS REFER TO FLORIDA BUILDING CODE APPENDIX F FOR MINIMUM PIPE DEPTH OF COVER. WHERE MINIMUM PIPE DEPTH OF COVER IS NOT POSSIBLE,

PIPE SLEEVING SHALL BE NECESSARY TO PROTECT PIPE IN 6 IRRIGATION CONTROL WIRE IN CONDUIT SHALLOW AREAS. (SIZE AS REQUIRED)

(2) CURB, EDGE OF ROADWAY, OR (4) IRRIGATION LATERAL PIPE 12" DEPTH (5) IRRIGATION MAINLINE PIPE 18" DEPTH **REMOTE CONTROL VALVE WITH DECODER**

PIPE SLEEVING

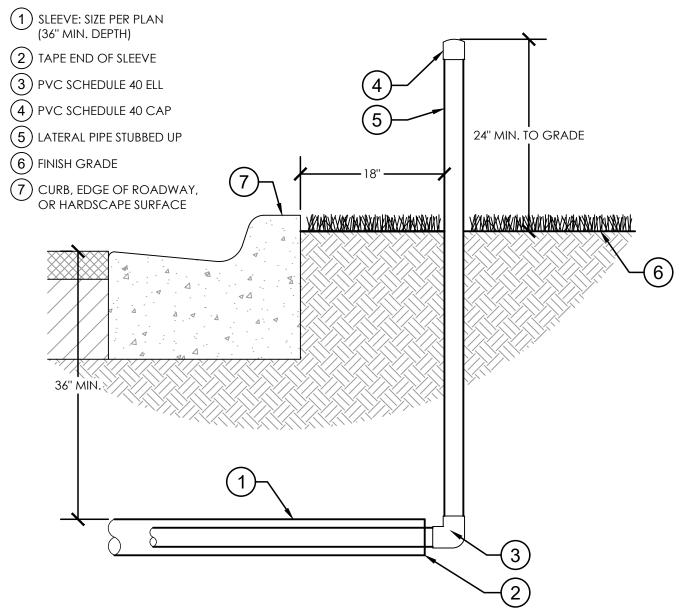

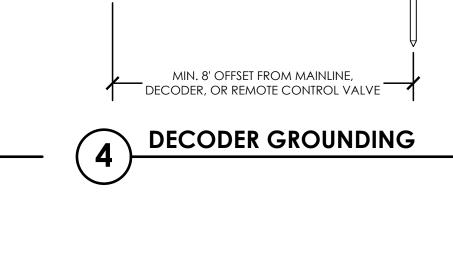

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REGISTRATION NO. **6667129**

REGISTRATION ERIC DOUGLAS HARRISON, RLA



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Town of Palm Beach Public Works

951 Okeechobee Road, Suite A West Palm Beach, FL 33401 561.838.5440

> Project Manager: Mike Roach, PE

PROJECT INFORMATION

ROYAL POINCIANA WAY

PROJECT NUMBER 24-0431.00060

CLIENT PROJECT NUMBER

VERIFY SCALES

REVISIONS

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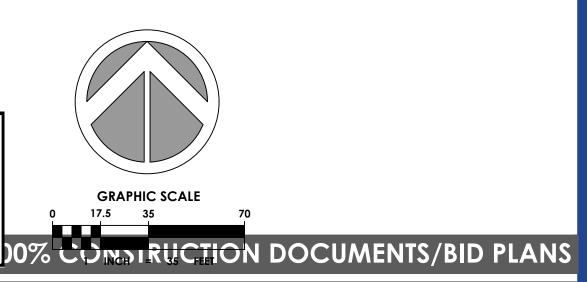
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IRRIGATION DETAILS



Call 811 or www.sunshine811.com two full business days before digging to have utilities located and marked.

Check positive response codes before you dig!






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REGISTRATION

DANIEL DIEZ, PE LICENSE NO. 92828 DATE: 1/23/2025

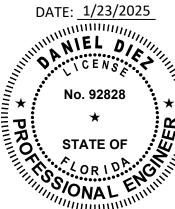

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TOWN OF PALM BEACH

PROJECT INFORMATION

ROYAL POINCIANA WAY

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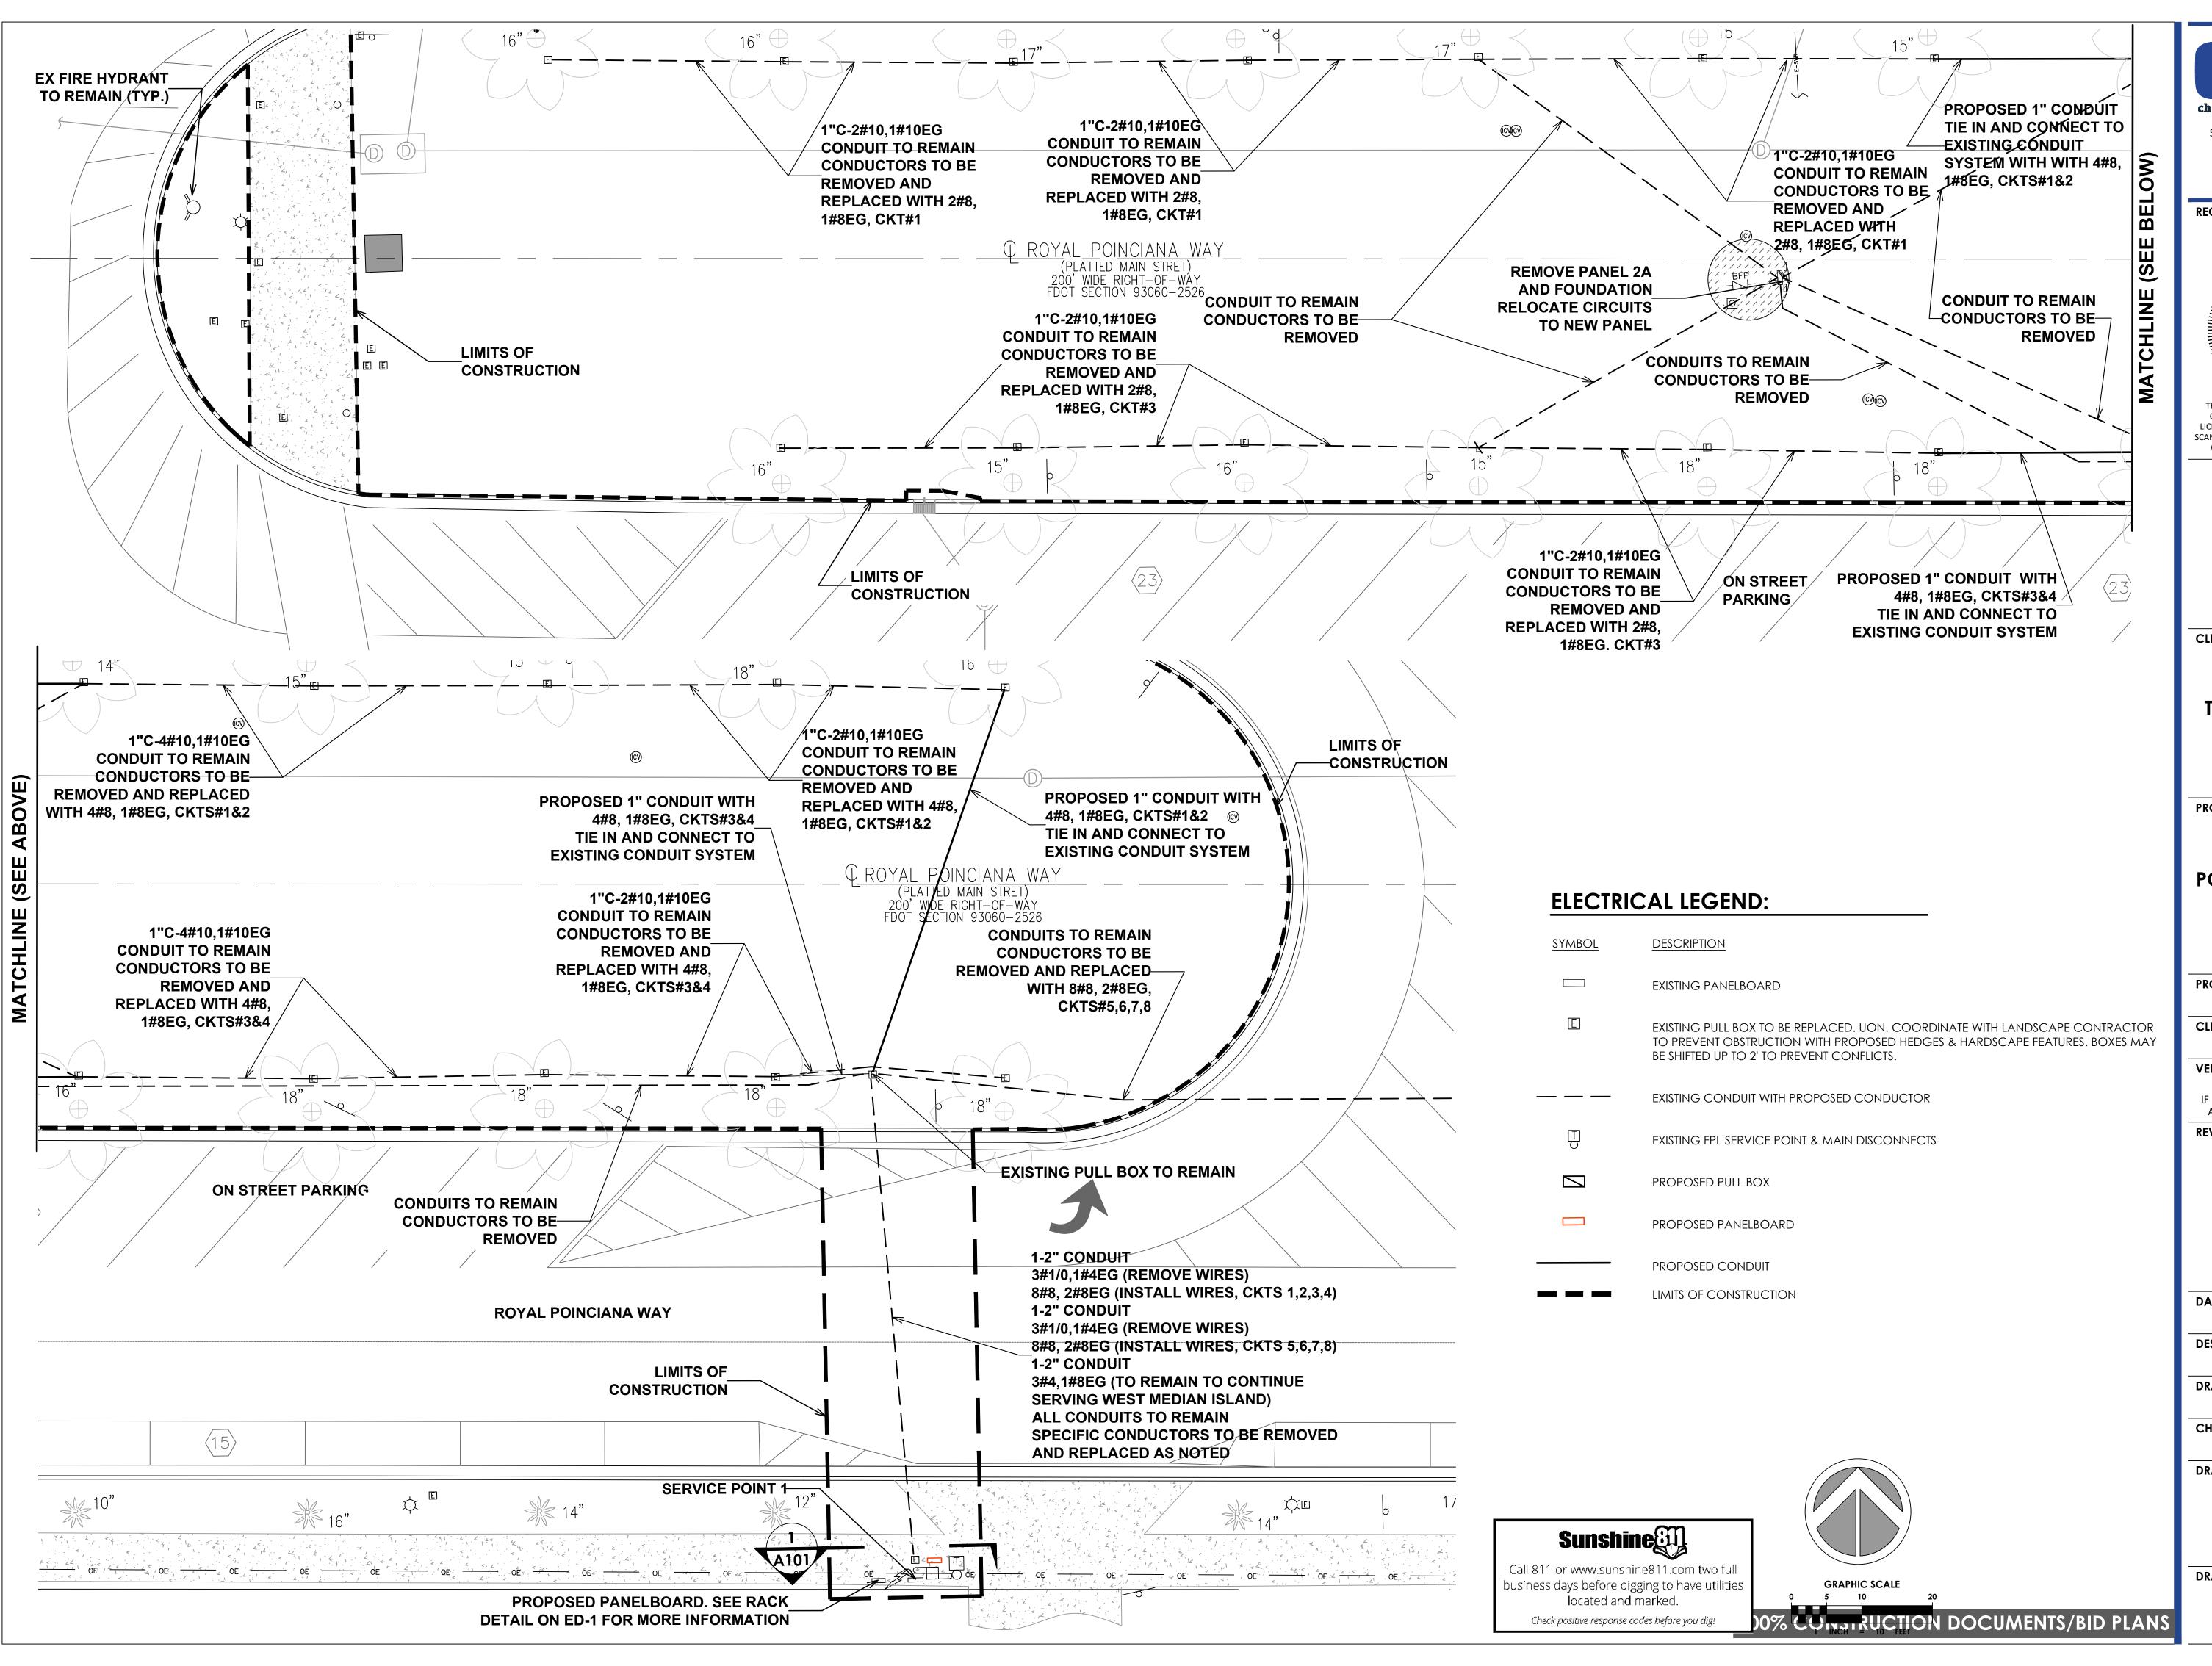
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ELECTRICAL PLAN

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EP-122 OF 5

Plot Date: 1/23/2025 9:39:38 AM Username: ddiez Layout Name: EP-1



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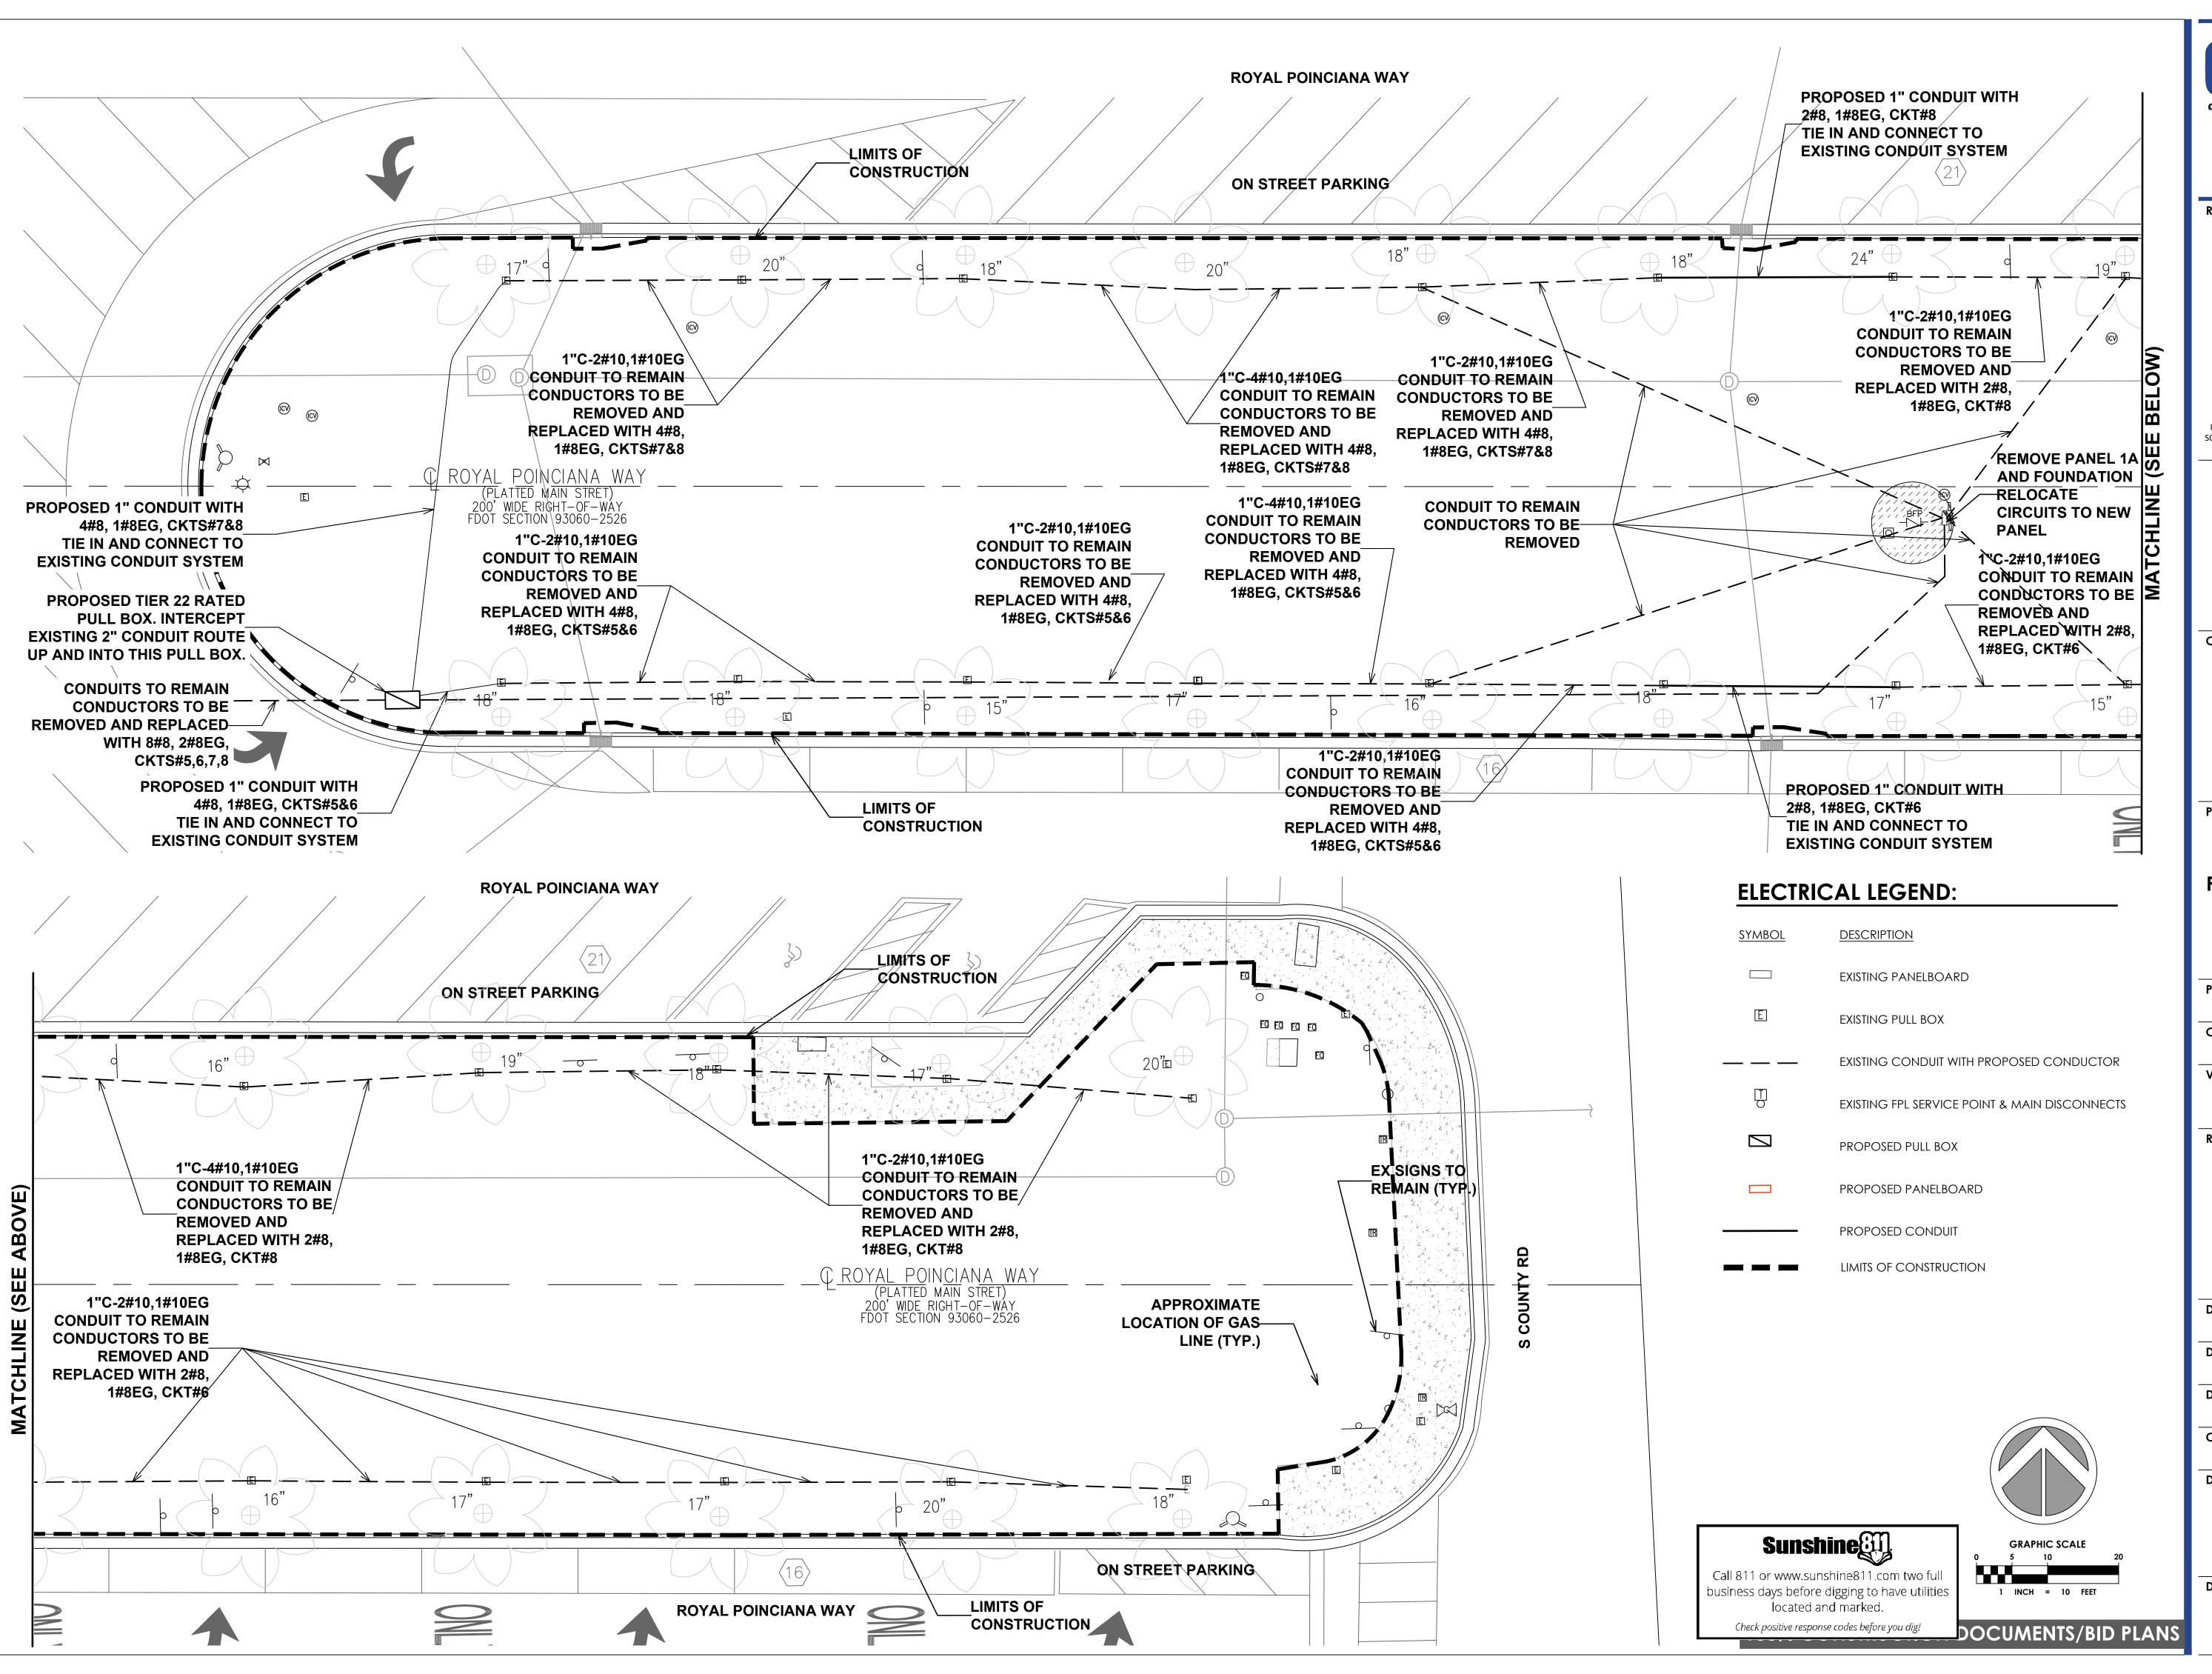
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Chen moore and associates

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LICENSE NO. 92828

DATE: 1/23/2025

No. 92828

No. 92828

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ELECTRICAL PLAN

DRAWING NUMBER

EP-3

120/240V, 1ø, 3W 25 KAIC MIN. WITH GROUND BAR				PANEL SCH	EDULE						125A BUS SURFACE MOUNTED NEMA TYPE1		
POLE NO.	KVA	BKR TRIP	BKR POLE	VOLT	LOAD DESCRIPTION	TYPE	POLE NO.	KVA	BKR TRIP	BKR POLE	VOLT	LOAD DESCRIPTION	TYPE
1	0.800	20	1	120	CHRISTMAS LTG		2	0.800	20	1	120	CHRISTMAS LTG	
3	0.800	20	1	120	CHRISTMAS LTG		4	0.800	20	1	120	CHRISTMAS LTG	
5	0.800	20	1	120	CHRISTMAS LTG		6	0.800	20	1	120	CHRISTMAS LTG	
7	0.800	20	1	120	CHRISTMAS LTG		8	0.800	20	1	120	CHRISTMAS LTG	
9		20	1	120	SPACE		10		30	2	240	SPD	
1 1		20	1	120	SPACE		12		30	2	240	370	
TOT 44 COM		_	· -	C 4 10 1 4	·	·	-		·			· · · · · · · · · · · · · · · · · · ·	

6.4 KVA TOTAL CONNECTED LOAD 6.4 KVA TOTAL DEMAND LOAD 53 AMPS TOTAL DEMAND LOAD

PANEL INFORMATION:

- 12 SPACE MINIMUM. BREAKERS TO BE 22kAIC RATED MINIMUM. BRANCH CIRCUITS TO BE GFCI TYPE.
- NEMA 4X

20A FUSED DISCONNECT (FOR POLICE EQUIPMENT) INFORMATION:


- DISCONNECT SHALL BE ABLE TO BE LOCKED IN BOTH THE ON AND OFF POSITIONS.
- FUSE TO BE 30KAIC RATED MINIMUM, SLOW-BLOW TYPE.
- **NEMA 4X**

Sunshine

Call 811 or www.sunshine811.com two full

business days before digging to have utilities located and marked.

Check positive response codes before you dig!

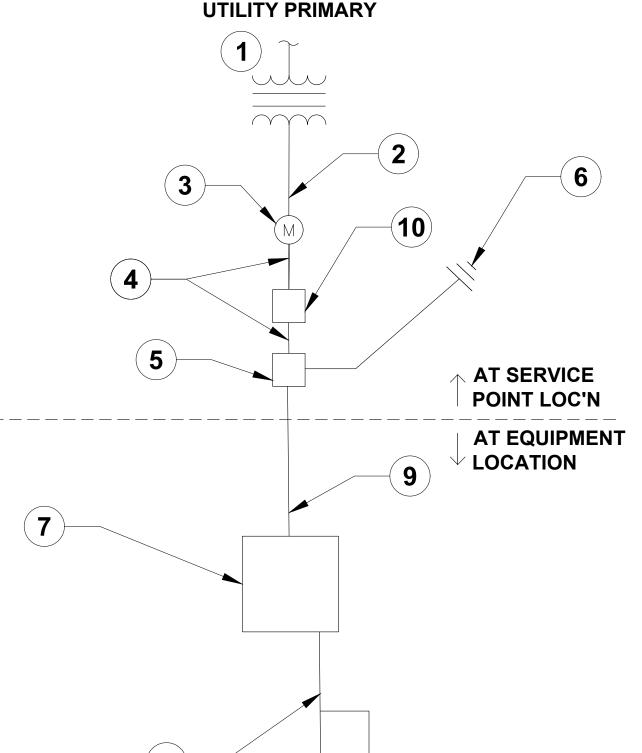

ONE LINE DIAGRAM FOR REPLACEMENT PANELBOARD

NOT TO SCALE

GENERAL NOTES

- **ELECTRICAL INSTALLATIONS SHALL COMPLY WITH THE LATEST ADOPTED** REQUIREMENTS/ADDITIONS OF THE FDOT, THE NATIONAL ELECTRIC CODE (NFPA 70). THE NATIONAL ELECTRICAL SAFETY CODE (ANSI C2) AND ALL STATE AND LOCAL LAWS, CODES, AND STANDARDS CURRENTLY ADOPTED AND ENFORCED BY **ALL AUTHORITIES HAVING JURISDICTIONS.**
- ASCERTAIN THAT ALL ELECTRICAL SYSTEM COMPONENTS FURNISHED BY CONTRACTOR ARE COMPATIBLE IN ALL RESPECTS WITH FDOT STANDARDS AND SPECIFICATION, AND MEET ALL FDOT REQUIREMENTS.
- COLOR CODE ALL PHASE WIRING BY THE USE OF COLORED WIRE INSULATION AND/OR COLORED TAPE, WHERE TAPE IS USED, THE WIRE INSULATION SHALL BE BLACK. PHASE CONDUCTORS SHALL BE USED FOR SINGLE-PHASE, THREE WIRE SYSTEMS, NEUTRAL CONDUCTORS SHALL BE WHITE OR NEUTRAL GRAY.
- ALL BRANCH CIRCUIT CONDUCTORS CONNECTED TO A PARTICULAR PHASE SHALL BE IDENTIFIED WITH THE SAME COLOR. THE COLOR CODING SHALL BE CONTINUOUS AND EXTEND TO THE POINT OF UTILIZATION.
- ALL POWER AND CONTROL CIRCUIT CONDUCTORS SHALL BE COPPER; ALUMINUM WILL NOT BE ACCEPTED. THIS INCLUDES WIRE, CABLE, BUSSES, TERMINALS, SWITCH/PANEL COMPONENTS ETC.
- EQUIPMENT CABINETS SHALL NOT BE USED AS PULL/JUNCTION BOXES. ONLY WIRING TERMINATIONS AT THE EQUIPMENT SHALL BE BROUGHT INTO THESE **ENCLOSURES.**
- SPLICES AND JUNCTION POINTS SHALL BE PERMITTED ONLY IN JUNCTION BOXES EQUIPPED WITH REMOVABLE COVERS. AND AT EASILY ACCESSIBLE LOCATIONS.
- ALL EXPOSED CONDUITS SHALL BE RIGID STEEL PVC COATED.
- PROVIDE ALL ELECTRICAL MATERIALS, TOOLS, AND TRANSPORTATION, AND PERFORM ALL SERVICES AND LABOR REQUIRED TO INSTALL A COMPLETE AND **OPERABLE ITEM OR SYSTEM AS INDICATED.**
- 10. ELECTRICAL MATERIALS SHALL BE NEW AND SHALL BE ETL OR UL LISTED AND LABELED. INSTALL ELECTRICAL MATERIALS IN ACCORDANCE WITH THE MANUFACTURER'S RECOMMENDATIONS.
- 11. INVESTIGATE THE EXISTING UTILITIES IN THE PROJECT AREA BEFORE ANY **EXCAVATION OR BORING AND BE RESPONSIBLE FOR RESEARCHING AND** INVESTIGATING THE EXISTING UTILITIES IN THE WORK AREA. THE UTILITIES SHOWN IN THE PLANS ARE THE BEST INFORMATION AVAILABLE TO THE ENGINEER AND DRAWN FOR THE CONTRACTORS INFORMATION. FIELD VERIFY THE UTILITES BEFORE ANY DIGGING, EXCAVATION, OR BORINGS.
- 12. ALL STEEL CONDUITS FITTINGS, NUTS, BOLTS, ETC. SHALL BE GALVANIZED.
- 13. BOTH ENDS OF ALL CONTROL CONDUCTORS SHALL BE IDENTIFIED AS TO THE CIRCUIT, TERMINAL BLOCK, AND TERMINAL NUMBER.
- 14. UNDERGROUND CONDUIT SHALL BE PVC SCH. 40 UNLESS OTHERWISE NOTED. UNDERGROUND CONDUIT SHALL TRANSITION TO PVC-COATED RGS CONDUIT WITH PVC TO RGS CONDUIT FITTINGS. CONDUIT SHALL BE PVC-COATED RGS ABOVE GRADE THROUGH AND INCLUDING THE FIRST 90 DEGREE FITTING UNDERGROUND **UNLESS OTHERWISE NOTED.**
- 15. UNDERGROUND CONDUITS SHALL BE INSTALLED A MINIMUM OF 36" BELOW FINISHED GRADE UNLESS OTHERWISE NOTED.
- 16. ALL LIQUID-TIGHT, FLEXIBLE CONDUIT SHALL BE METALLIC.
- 17. EXISTING SERVICE CONNECTION POINT: COORDINATE WITH FPL TO DE-ENERGIZE **EQUIPMENT RACK PRIOR TO BEGINNING WORK.**
- 18. PROVIDE NEW LABEL AT ALL MAIN SERVICE DISCONNECTS INDICATING "MAIN SERVICE DISCONNECT."
- 19. REPLACE ANY SUBSTANDARD OR RUSTING COMPONENTS ON EXISTING RACK.
- 20. THE CONTRACT LUMP SUM PRICE SHALL INCLUDE BUT NOT BE LIMITED TO: DEMOLITION OF EXISTING, GROUNDING, CONDUIT/WIRING, PULL BOXES. INTEGRATION OF PROPOSED EQUIPMENT WITH EXISTING EQUIPMENT, FIELD ADJUSTMENTS AND ANY ADDITIONAL APPURTENANCES REQUIRED FOR A COMPLETE, FUNCTIONING, AND COMPLIANT INSTALLATION.

SPECIFIC NOTES

- EXISTING FPL 120/240V, 50kVA, TRANSFORMER.
- EXISTING SERVICE FROM FPL DISTRIBUTION TO SERVICE EQUIPMENT RACK.
- EXISTING 320A FEED-THROUGH METER BASE AS PER FPL STANDARDS AND REQUIREMENTS. VERIFY GROUNDING FOR THE METER BASE PER POWER COMPANY REQUIREMENTS.
- EXISTING FEEDER CONDUCTORS TO REMAIN, REROUTE AND ADJUST AS NECESSARY.
- PROPOSED 12-SPACE MINIMUM PANELBOARD WITH 100A MAIN SERVICE ENTRANCE RATED CIRCUIT BREAKER. FEED FROM EXISTING 100A NIGHTMASTER.
- VERIFY GROUNDING AND SUPPLEMENT WITH ADDITIONAL GROUND RODS. IF GROUND RESISTANCE TEST REVEALS A FAILING CONDITION, AT EXISTING RACK.
- RECONNECT EXISTING RECEPTACLE(S) TO THE NEW CIRCUIT CONDUCTORS AT EACH TREE. INSIDE THE EXISTING PULL BOX.
- CONNECT EACH RECEPTACLE EQUIPMENT GROUND TERMINAL TO THE GROUNDED CONDUCTOR.
- PROPOSED CONDUCTORS FROM PANELBOARD TO CHRISTMAS LIGHT RECEPTACLES.
- EXISTING 100A NIGHTMASTER TO REMAIN. REROUTE OUTGOING FEEDER TO SUPPLY POWER TO THE NEW 12-SPACE PANELBOARD.

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DANIEL DIEZ, PE

REGISTRATION

LICENSE NO. 92828 DATE: 1/23/2025 No. 92828 STATE OF

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CLIENT

TOWN OF PALM BEACH

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PROJECT NUMBER 24-0431.00060

CLIENT PROJECT NUMBER

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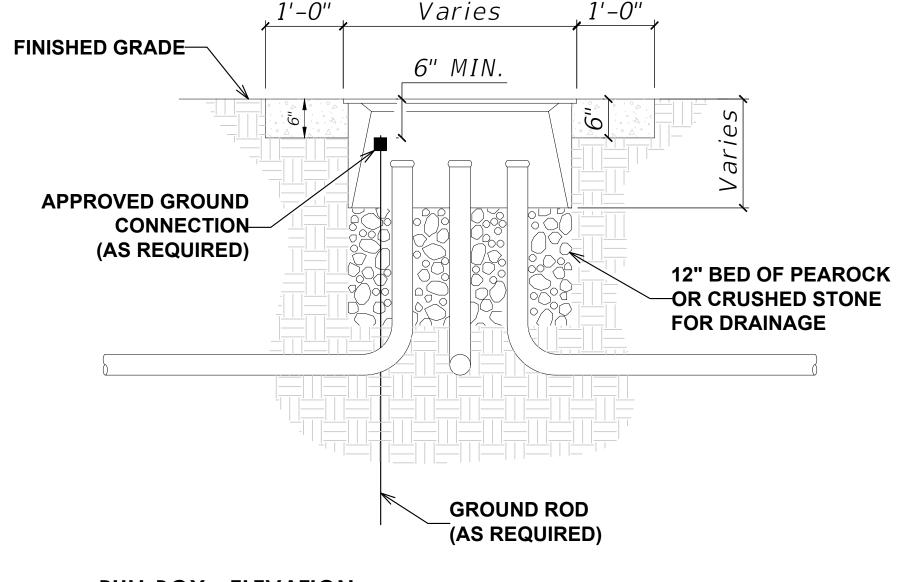
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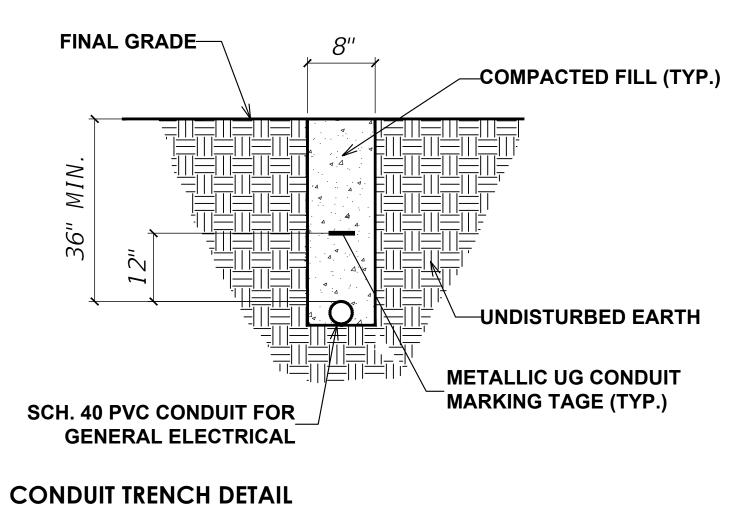
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NOTES

- DE-ENERGIZE ENTIRE SYSTEM BEFORE WORK BEGINS, COORDINATE WITH FPL TO DE-ENERGIZE EQUIPMENT RACK AS NEEDED. COORDINATE WITH POLICE DEPARTMENT REGARDING LENGTH OF OUTAGE OF THE EXISTING POLICE **EQUIPMENT LOCATED AT THE EQUIPMENT RACK.**
- 2. INSTALL A 1'-0" WIDE (MIN.) CONCRETE APRON AROUND ALL BOXES USING CLASS NS CONCRETE. SLOPE THE APRON AWAY FROM THE BOX.
- WHERE MULTIPLE PULL BOXES ARE PLACED SIDE BY SIDE, MAINTAIN AT LEAST 8" BETWEEN THE PULL BOXES.
- RECTANGULAR BOXES SHOWN, OTHERS SIMILAR.
- **DETAILS NOT TO SCALE.**

183 in

ARC FLASH SAMPLE LABELS

WARNING Arc Flash and Electric Shock Risk Appropriate PPE Required

Arc Flash Boundary 181 in 47.8 cal/cm^2 Incident Energy at 18 in Arc-rated shirt & pants or arc-rated coverall or arc-rated arc flash suit 240 VAC Electric Shock Risk when cover is removed Glove Class 42 in Limited Approach

12 in Restricted Approach Location: BUS-20A FUSED DISCONNECT



SKM Systems Analysis, Inc. 1 Pearl St.

Redondo Beach, CA 90277 (310) 698-4700

| Job#: | 232874 | Prepared on: | 01/22/25 | By: | Engineer Warning: Changes in equipment settings or system configuration will in∨alidate the calculated ∨alues and PPE requirements

WARNING

Arc Flash and Electric Shock Risk **Arc Flash and Electric Shock Risk Appropriate PPE Required**

48.9 cal/cm^2 Incident Energy at 18 in Arc-rated shirt & pants or arc-rated coverall or arc-rated arc flash suit 240 VAC Electric Shock Risk when cover is removed

Job#: | 232874 | Prepared on: | 01/22/25 | By: | Engineer

Warning: Changes in equipment settings or system

configuration will invalidate the calculated values and

Arc Flash Boundary

Glove Class 42 in Limited Approach 12 in Restricted Approach

Location: **BUS-METER**

Systems Analysis, Inc.

PPE requirements

SKM Systems Analysis, Inc. 1 Pearl St. Redondo Beach, CA 90277 (310) 698-4700

Systems Analysis, Inc.

182 in

240 VAC

42 in

12 in

48.4 cal/cm^2

Location:

Job#: | 232874 | Prepared on: | 01/22/25 | By: | Engineer Warning: Changes in equipment settings or system configuration will invalidate the calculated values and PPE requirements

WARNING

Appropriate PPE Required

Incident Energy at 18 in

Arc-rated shirt & pants or arc-rated

coverall or arc-rated arc flash suit

Electric Shock Risk when cover is

NIGHTMASTER 100A DISCON

SKM Systems Analysis, Inc.

1 Pearl St.

Redondo Beach, CA 90277

(310) 698-4700

Arc Flash Boundary

removed

Glove Class

Limited Approach

Restricted Approach

WARNING

Arc Flash and Electric Shock Risk

Appropriate PPE Required

Arc Flash Boundary 47.8 cal/cm^2 Incident Energy at 18 in Arc-rated shirt & pants or arc-rated coverall or arc-rated arc flash suit 240 VAC Electric Shock Risk when cover is removed Glove Class 42 in Limited Approach

12 in Restricted Approach Location: PANELBOARD-MAIN

Systems Analysis, Inc.

SKM Systems Analysis, Inc. 1 Pearl St. Redondo Beach, CA 90277 (310) 698-4700

|Job#: | 232874 | Prepared on: | 01/22/25 | By: | Engineer Warning: Changes in equipment settings or system configuration will invalidate the calculated values and PPE requirements

WARNING

Arc Flash and Electric Shock Risk

Appropriate PPE Required

Arc Flash Boundary 0.15 cal/cm^2 Incident Energy at 18 in No Arc-rated PPE Required 240 VAC

Electric Shock Risk when cover is removed Glove Class Limited Approach

Restricted Approach TREE LIGHTING PULLBOXES Location:

Systems Analysis, Inc.

SKM Systems Analysis, Inc. 1 Pearl St.

Redondo Beach, CA 90277 (310) 698-4700

|Job#: | 232874 | Prepared on: | 01/22/25 | By: | Engineer Warning: Changes in equipment settings or system configuration will in∨alidate the calculated ∨alues and PPE requirements

ARC FLASH CALCULATION EQUIPMENT SETTINGS BASIS:

LIGHTING PANELBOARD MAIN PROTECTIVE EQUIPMENT: 100A MAIN BREAKER - SQUARE D QO-VH 2-POLE 100A

POLICE MAIN PROTECTIVE EQUIPMENT: FUSED DISCONNECT - USING 20A BUSSMAN STD, HRC FUSE



Call 811 or www.sunshine811.com two full business days before digging to have utilities located and marked.

Check positive response codes before you dig!

100% CONSTRUCTION DOCUMENTS/BID PLANS



500 West Cypress Creek Road Ft. Lauderdale, FL 33309 954.730.0707 www.chenmoore.com

REGISTRATION

DANIEL DIEZ, PE LICENSE NO. 92828 DATE: 1/23/2025

THIS SEAL IS ONLY VALID ON PRINTED COPIES THAT ARE DATED WITH THE LICENSEE'S ORIGINAL HAND SIGNATURE SCANNED OR ELECTRONIC COPIES ARE NOT CONSIDERED SIGNED AND SEALED

CLIENT

TOWN OF PALM BEACH

PROJECT INFORMATION

ROYAL POINCIANA WAY

####

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