DOC PALM BEACH PLLC

1 7 5 B R A D L E Y P L A C E P A L M B E A C H , F L O R I D A

MAJOR PROJECT WITH NOTICE


(COMBO PROJECT WITH SPECIAL EXCEPTIONS, SITE PLAN REVIEW AND VARIANCES REQUESTS)

DRC FINAL SUBMITTAL

JANUARY 27, 2025


TOWN COUNCIL MEETING DATE: MARCH 12, 2025 ARCOM MEETING DATE: MARCH 26, 2025



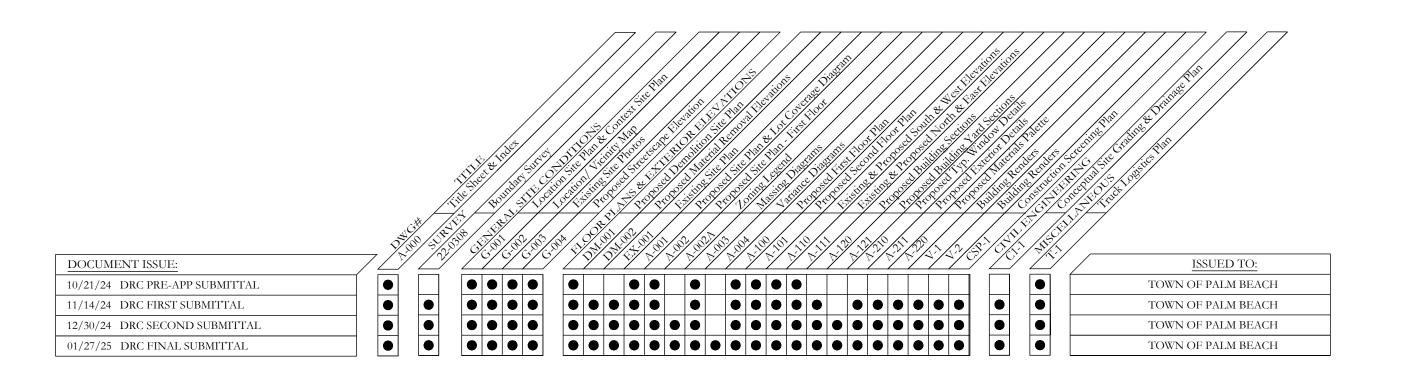

TRAFFIC & CIVIL ENGINEERING SIMMONS & WHITE **CIVIL & TRAFFIC ENGINEERING** 2581 METROCENTRE BLVD WEST, STE 3 WEST PALM BEACH, FL 33407

ARCHITECT FAIRFAX & SAMMONS ARCHITECTS 214 BRAZILIAN AVENUE, SUITE 100 PALM BEACH, FL 33480 561-805-8591

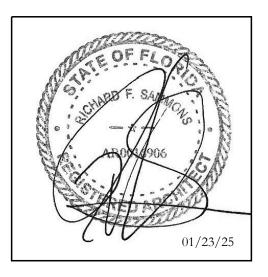

DRC FINAL SUBMITTAL	01/27/2024
DRC SECOND SUBMITTAL	12/30/2024
DRC FIRST SUBMITTAL	11/14/2024
DRC PRE-APPLICATION	10/21/2024

ZONING CASE NUMBER:

ZON-24-0067

FILE NUMBER: ARC-24-0111

175 BRADLEY PLACE

PALM BEACH, FLORIDA 33480

SHEET TITLE

SCOPE OF WORK:

2023 FLORIDA BUILDING CODE.

MUNICIPALITY: PALM BEACH

COUNTY, FLORIDA.

LEGAL DESCRIPTION:

RENOVATIONS AND ADDITION TO COMMERCIAL

CODES AND STANDARDS:

PROPERTY AT 175 BRADLEY PLACE, PALM BEACH, FLORIDA.

THIS PROJECT WAS DESIGNED IN ACCORDANCE WITH THE

LOT 19 OF BUNGALOW PARK ADDITION, ACCORDING TO THE PLAT THEREOF ON

FILE IN THE OFFICE OF THE CLERK OF THE COURT IN AND FOR PALM BEACH

LOCATION ADDRESS: 175 BRADLEY PLACE, PALM BEACH, FLORIDA.

PARCEL CONTROL NUMBER: 50-43-43-15-08-000-0190

COVER SHEET

11/14/2024 SCALE AS NOTED MC, MRM

SHEET NO



FAIRFAX, SAMMONS ♣ PARTNERS, LLC. 214 BRAZILIAN AVENUE, PALM BEACH 33480 TELEPHONE (561) 805-8591

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LICENSE NO. AA26000846

INVOICE NO.:72740

DATE:	DESCRIPTION:	
12-02-2024	BOUNDARY SURVEY	

ABBREVIATIONS / SYMBOLS:

A/C	= AIR CONDITIONING UNIT
ADJ	= ADJACENT
BCR	= BROWARD COUNTY RECORDS

= BENCHMARK = CALCULATED

= CENTERLINE = CONCRETE BLOCK WALL = CHATTAHOOCHEE

= CONCRETE = CONCRETE MONUMENT

= COLUMN

= DRAINAGE STRUCTURE

= ELEVATION = EDGE OF WATER = FINISHED FLOOR = IDENTIFICATION

= INVERT = IRON PIPE

= LENGTH = LIMITED ACCESS EASEMENT = LAKE MAINTENANCE EASEMENT

= MEASURED = NAIL AND DISC = NATURAL GROUND = NON RADIAL

= LIGHT POLE

= NOT TO SCALE

= PLAT = PLAT BOOK

= PALM BEACH COUNTY RECORDS = POINT OF CURVATURE

= POINT OF COMPOUND CURVATURE = PERMANENT CONTROL POINT

= POINT OF INTERSECTION

= POINT OF BEGINNING = POINT OF COMMENCEMENT = POINT OF REVERSE CURVATURE

= PERMANENT REFERENCE MONUMENT

= POINT OF TANGENCY

= RADIUS = RANGE

= ROOF OVERHANG EASEMENT

= RIGHT OF WAY = SECTION = SIDEWALK

= TOP OF BANK TYP = TYPICAL = UTILITY EASEMENT

WF = WOOD FENCE = WOOD POWER POLE (UTILITY POLE)

		CONVERSION
	OVERHEAD CABLES	INCHES TO
	METAL FENCE X — X — X — WOOD FENCE -// — // — // —	DECIMAL 1" = 0.08' 2" = 0.17' 3" = 0.25'
-(PLASTIC FENCE EASEMENT LINES	4" = 0.33' 5" = 0.42' 6" = 0.50'
	CENTERLINE (C/L)	7" = 0.58' 8" = 0.67'
	PLATTED LOT LINE	9" = 0.75'
	BOUNDARY LINE	10" = 0.83' 11" = 0.92'
	X vv vvi	12" = 1.0'

XX.XX' INDICATES N.A.V.D. 88

ELEVATION

SCALE: 1"=20'

PROPERTY ADDRESS:

175 BRADLEY PLACE, PALM BEACH, FLORIDA 33480

LEGAL DESCRIPTION:

LOT 19 OF BUNGALOW PARK, AN ADDITION TO THE TOWN OF PALM BEACH, ACCORDING TO THE PLAT THEREOF AS RECORDED IN PLAT BOOK 7, PAGE(S) 26, OF THE PUBLIC RECORDS OF PALM BEACH COUNTY, FLORIDA

CERTIFICATIONS:

- ROWE PLASTIC SURGERY


FLOOD DATA:

FLOOD ZONE: AE

COMMUNITY NUMBER: 120220

COMMUNITY NAME: TOWN OF PALM BEACH

PANEL NUMBER: 12099C0581F

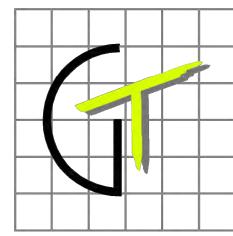


GT SURVEYOR SERVICES INC.

1660 SOUTHERN BLVD. UNIT K WEST PALM BEACH FLORIDA 33406-1747 OFFICE: 561-753-0353 E-MAIL gtsurveying@gmail.com

I HEREBY CERTIEY: THAT THIS MAP OF BOUNDARY SURVEY WAS PREPARED UNDER MY DIRECTION AND IS TRUE AND CORRECT TO THE BEST OF MY KNOWLEDGE AND BELIEF. FURTHERMORE THIS SURVEY SKETCH MEETS THE INTENT OF THE STANDARDS OF PRACTICE FOR LAND SURVEYING IN THE STATE OF FLORIDA, PURSUANT TO RULE 5J-17 OF THE FLORIDA ADMINISTRATIVE CODE AND ITS IMPLEMENTING RULE, CHAPTER 472.027 OF THE FLORIDA


GINO BUKLANO SURVEYOR AND MAPPER FLORIDA LICENSE NO.: 5044

NOT VALID WITHOUT THE SIGNATURE AND THE ORIGINAL RAISED SEAL OF THE FLORIDA LICENSED SURVEYOR MAPPER NAMED ABOVE.

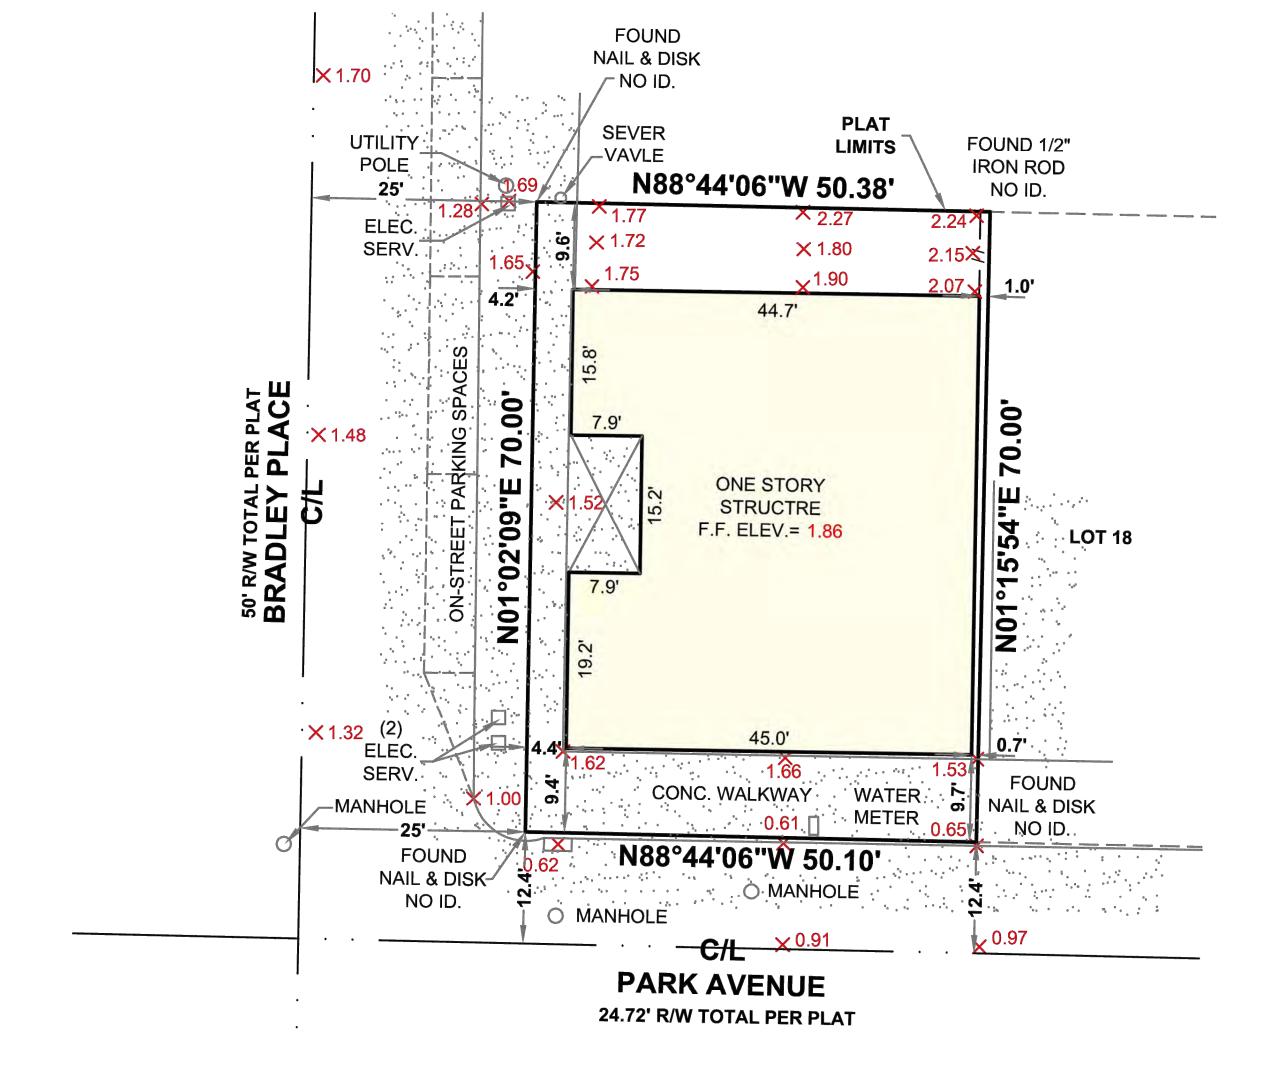

GENERAL NOTES:

- BEARING BASIS PER G.P.S COORDINATE SYSTEM NAD 83, 1990 ADJUSMENT (UNLESS OTHERWISE NOTED)
- THIS SURVEY IS BASED UPON RECORDED INFORMATION AS PROVIDED BY CLIENT. NO SPECIFIC SEARCH OF THE PUBLIC RECORD HAS BEEN MADE BY THIS OFFICE.
- UNDERGROUND IMPROVEMENTS HAVE NOT BEEN LOCATED.
- ELEVATION ARE BASED UPON NORTH AMERICAN VERTICAL DATUM 1988 (N.A.V.D. 1988) UNLESS OTHERWISE NOTED.
- IN SOME CASES, GRAPHIC REPRESENTATIONS HAVE BEEN EXAGGERATED FOR CLEARER ILLUSTRATION. MEASURED RELATIONSHIP SHALL HAVE PRECEDENCE OVER SCALE POSITIONS.
- ALL DIMENSIONS SHOWN ARE FIELD MEASURED AND CORRESPOND TO RECORD INFORMATION UNLESS SPECIFICALLY NOTED OTHERWISE.
- WELL-IDENTIFIED FEATURES IN THIS SURVEY AND MAP HAVE BEEN MEASURED TO AN ESTIMATED HORIZONTAL POSITIONAL ACCURACY OF 0.10 (FT)
- "ADDITIONS OR DELETIONS TO THIS SURVEY MAP BY OTHER THAN THE SIGNING PARTY OR PARTIES IS PROHIBITED WITHOUT THE WRITTEN CONSENT OF THE SIGNING PARTY OR PARTIES." (CHAPTER 61G17-6.003 OF THE FLORIDA ADMINISTRATIVE CODE PURSUANT TO SECTION 472.027 OF THE FLORIDA STATUTES)
- ** "5J-17.052 STANDARDS OF PRACTICE: SPECIFIC SURVEY, MAP, AND REPORT REQUIREMENTS. (2) BOUNDARY MONUMNETS- (b6) WHEN A CORNER FALLS IN A HARD SURFACE SUCH AS ASPHALT OR CONCRETE, ALTERNATE MONUMENTATION MAY BE USED THAT IS DURABLE AND IDENTIFIABLE ." (EXAMPLES: FENCE POST, BLDG. CORNERS, ETC.)

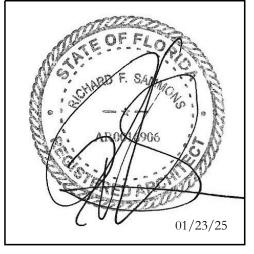

STATE OF FLORIDA

DRC FINAL SUBMITTAL 01/27/2024 DRC SECOND SUBMITTAL 12/30/2024 DRC FIRST SUBMITTAL 11/14/2024 DRC PRE-APPLICATION 10/21/2024

ZON-24-0067

ZONING CASE NUMBER:

FILE NUMBER: ARC-24-0111

175 BRADLEY PLACE PALM BEACH, FLORIDA 33480

BOUNDARY SURVEY

FAIRFAX & SAMMONS FAIRFAX, SAMMONS ❖ PARTNERS, LLC. 214 BRAZILIAN AVENUE, PALM BEACH 3348 TELEPHONE (561) 805-8591


LICENSE NO. AA2600084

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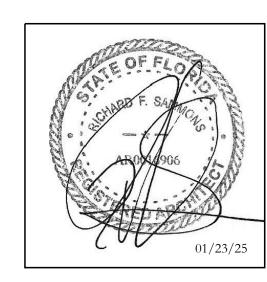
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—— 1000' RADIUS

—— SUBJECT SITE: 175 BRADLEY PLACE





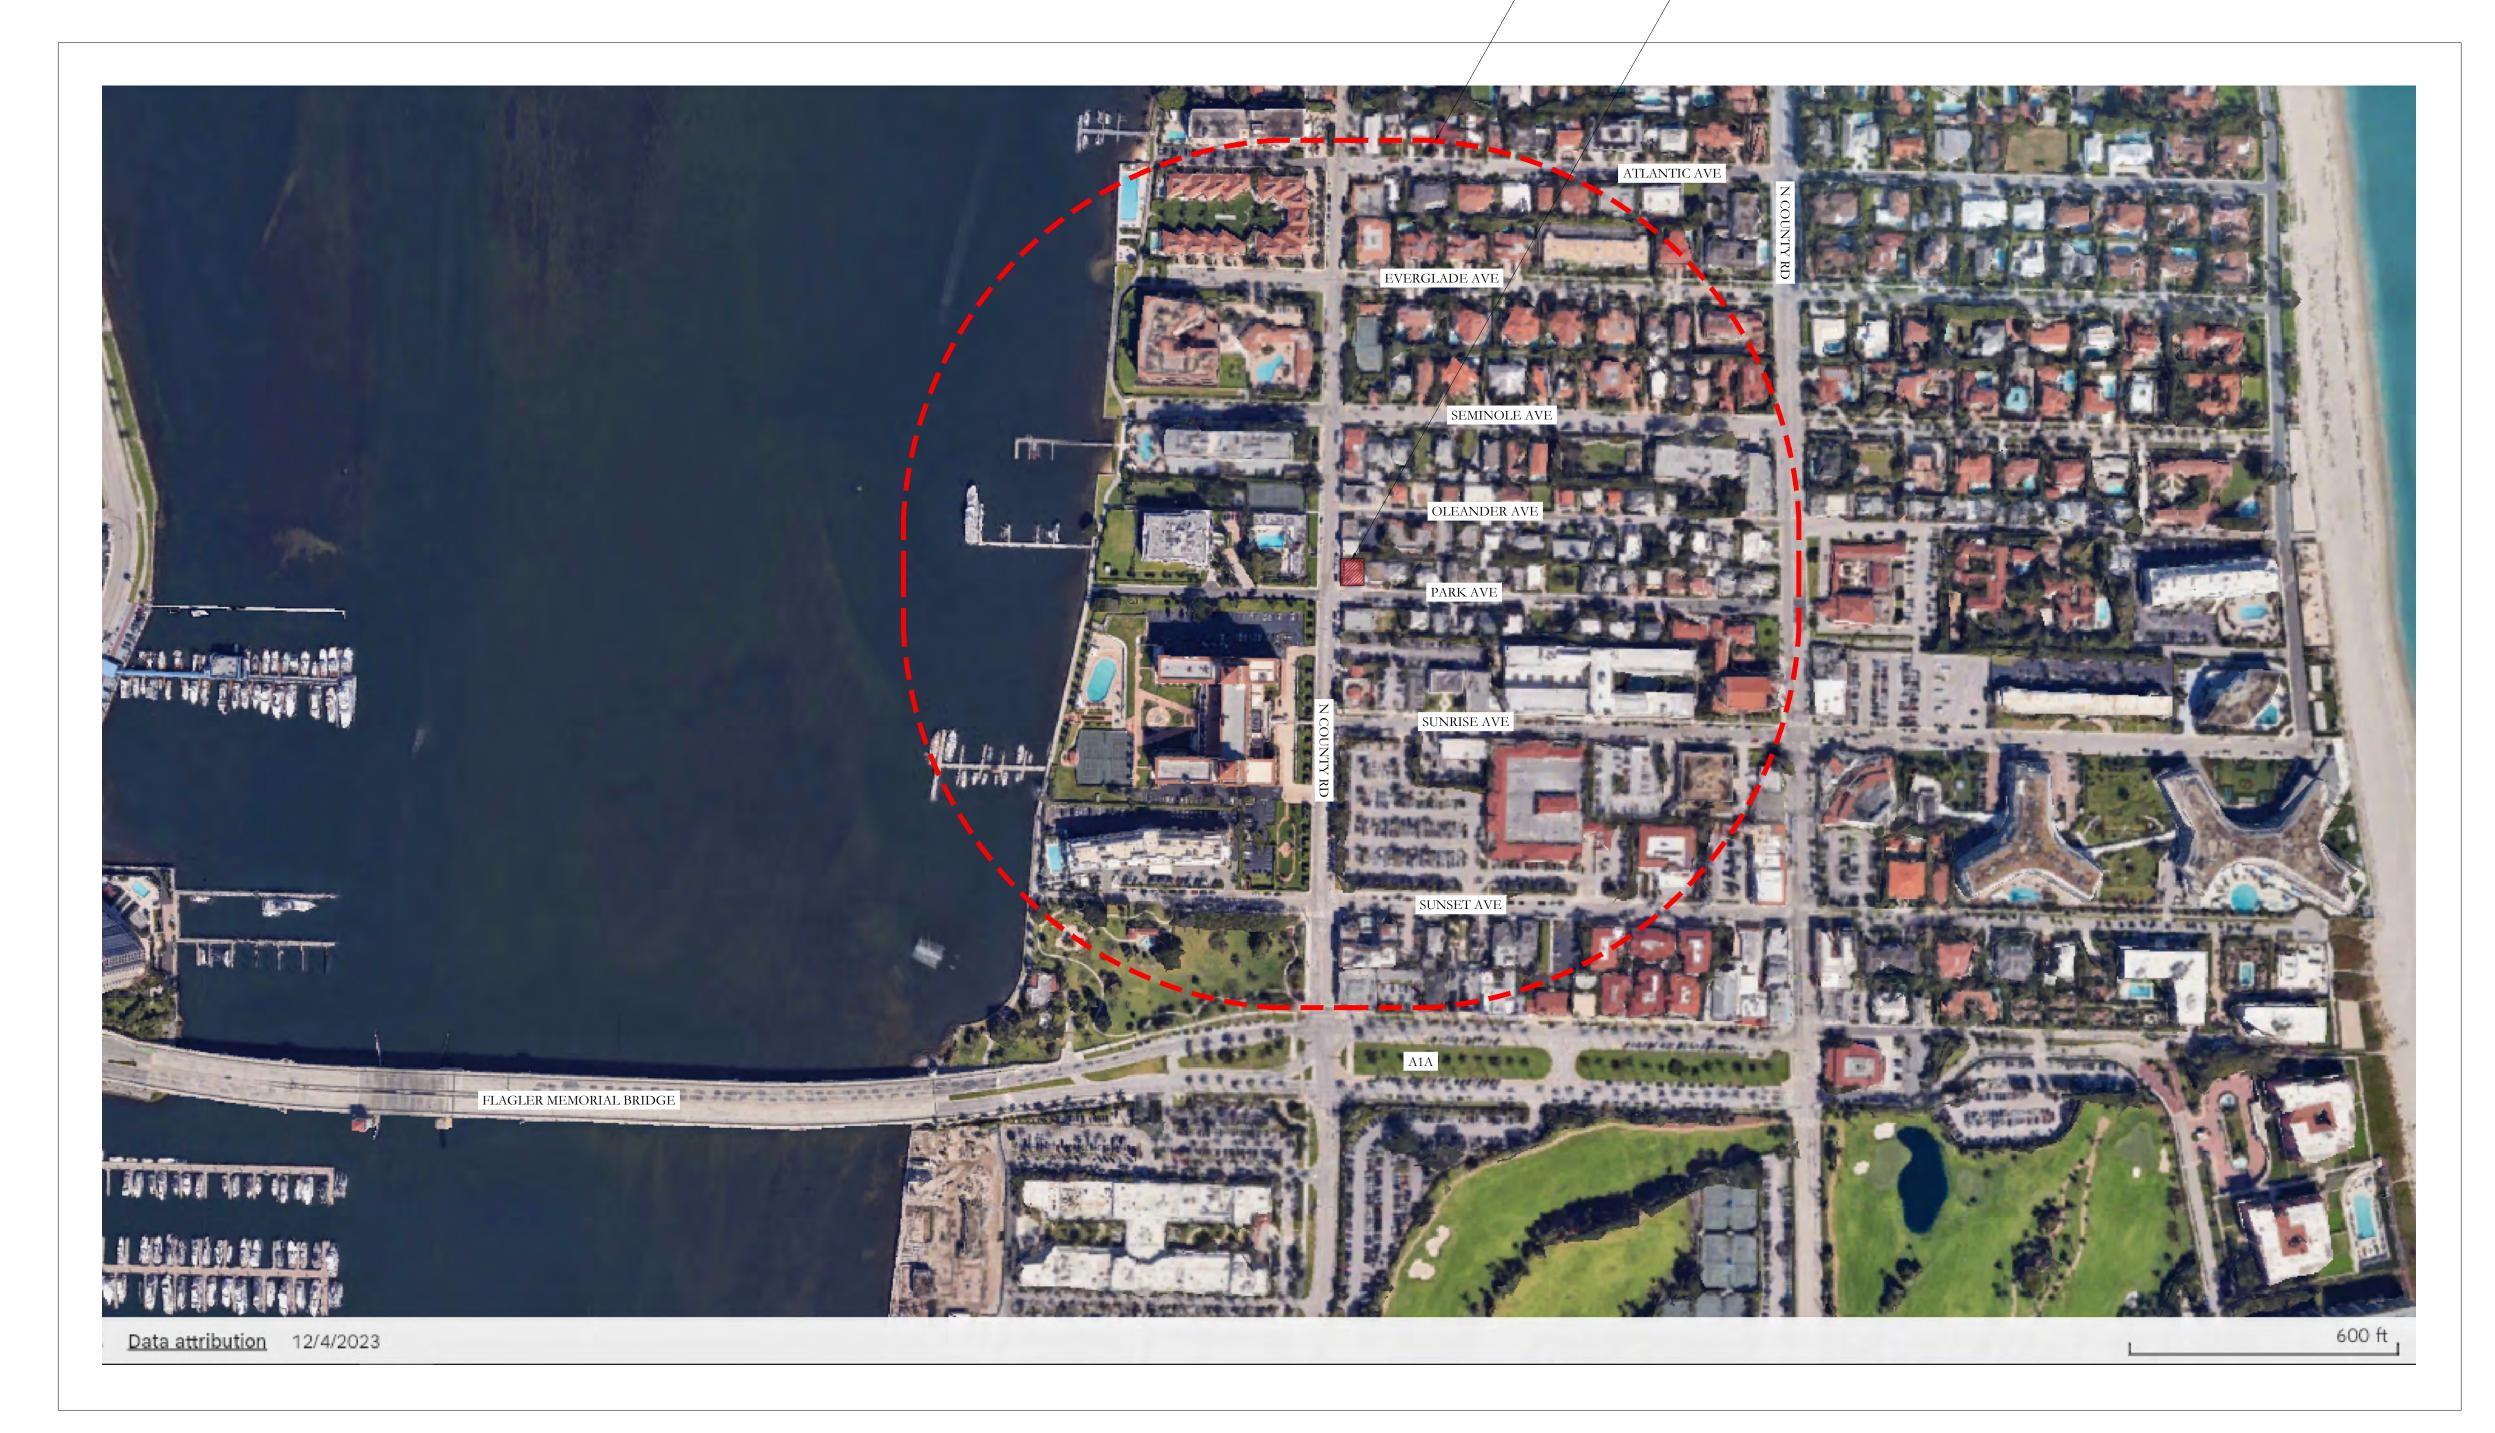

RICHARD F. SAMMONS STATE OF FLORIDA ARCHITECT REGISTRATION NO. AR0016906

DRC FINAL SUBMITTAL	01/27/2024
DRC SECOND SUBMITTAL	12/30/2024
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DRC PRE-APPLICATION	10/21/2024

ZONING CASE NUMBER:

ZON-24-0067

FILE NUMBER:

ARC-24-0111

175 BRADLEY PLACE

PALM BEACH, FLORIDA 33480

SHEET NO

LOCATION SITE PLAN 1000 FT RADIUS

DATE 10/9/2024 SCALE

SHEET TITLE

SCALE
AS NOTED





FAIRFAX, SAMMONS & PARTNERS, LLC.

214 BRAZILIAN AVENUE, PALM BEACH 33480


TELEPHONE (561) 805-8591


FAIRFAXANDSAMMONS.COM

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01/27/2024 12/30/2024 11/14/2024


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1 EXISTING SITE CONDITION

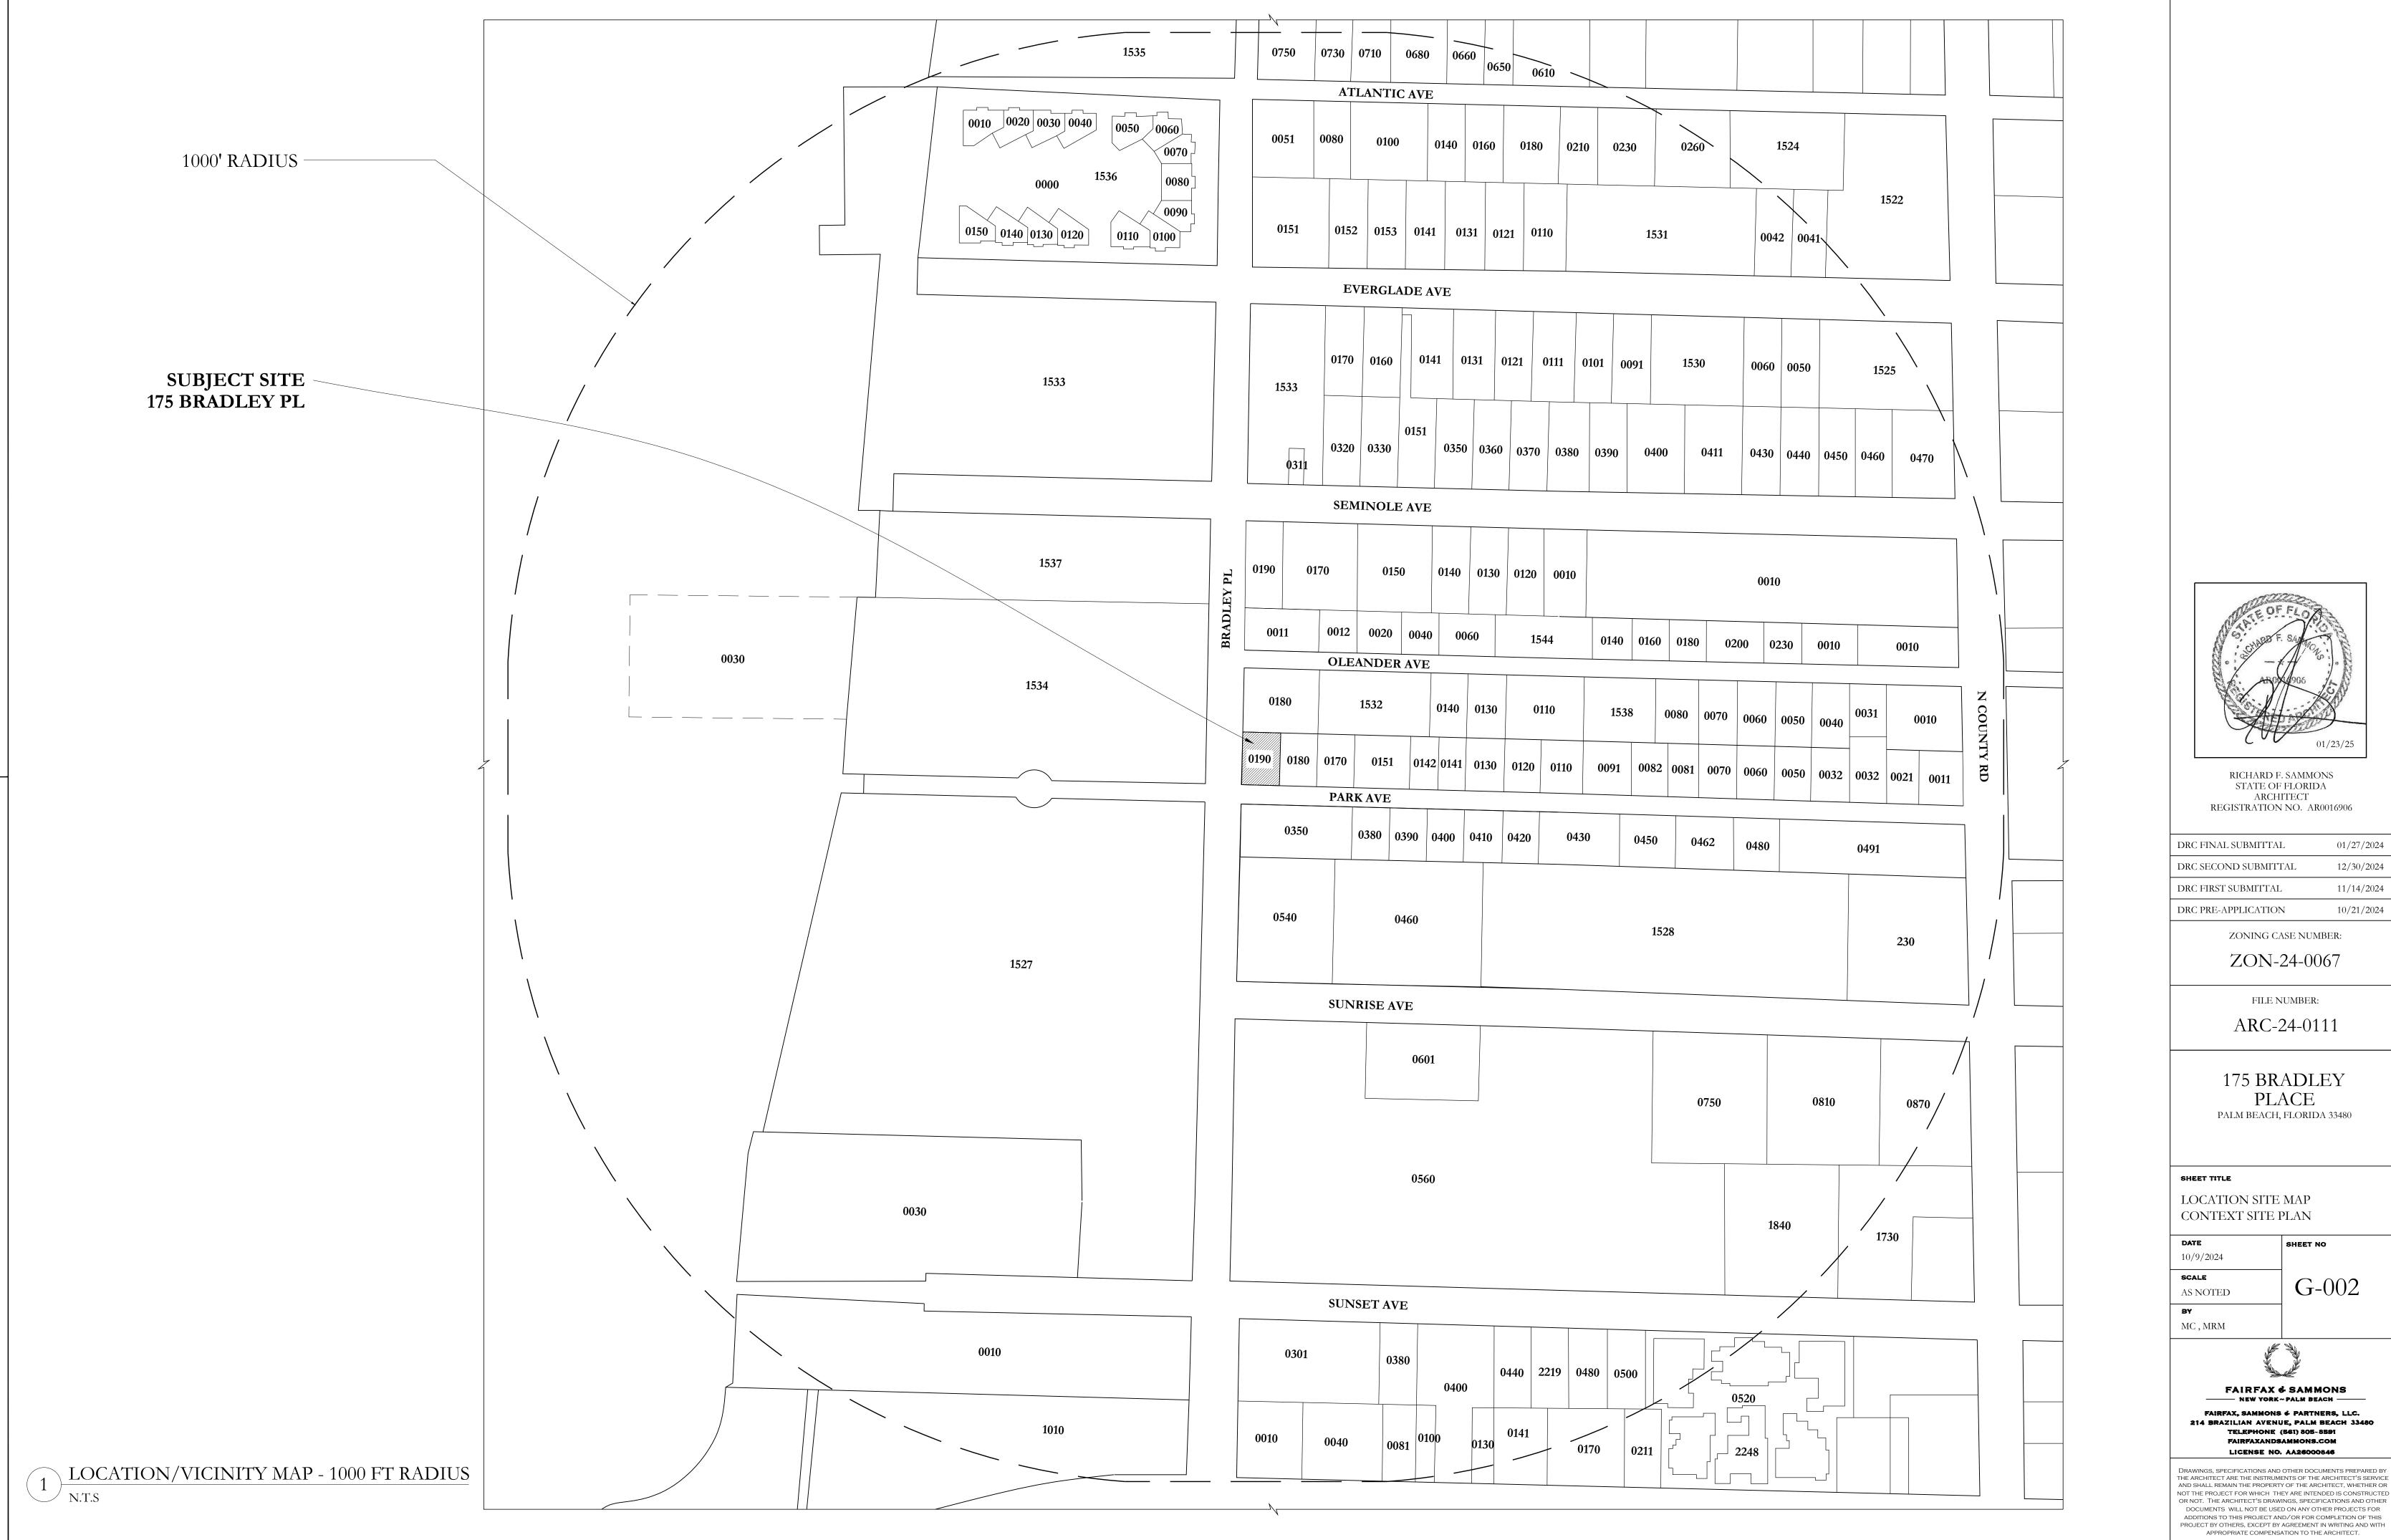


2 EXISTING SITE CONDITION

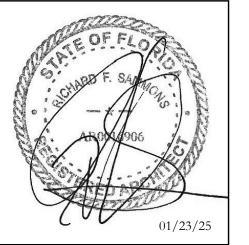

3 KEY PLAN: EXISTING CONDITION
1/16" = 1'- 0"

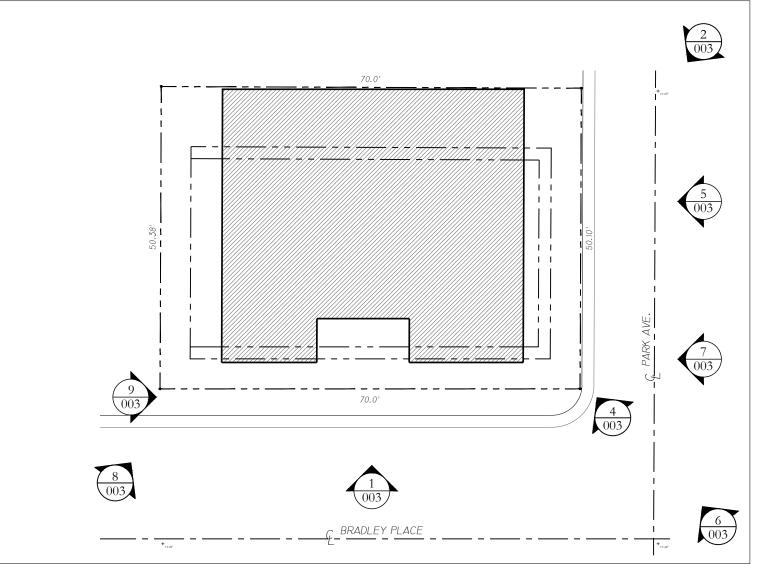

4 EXISTING SITE CONDITION

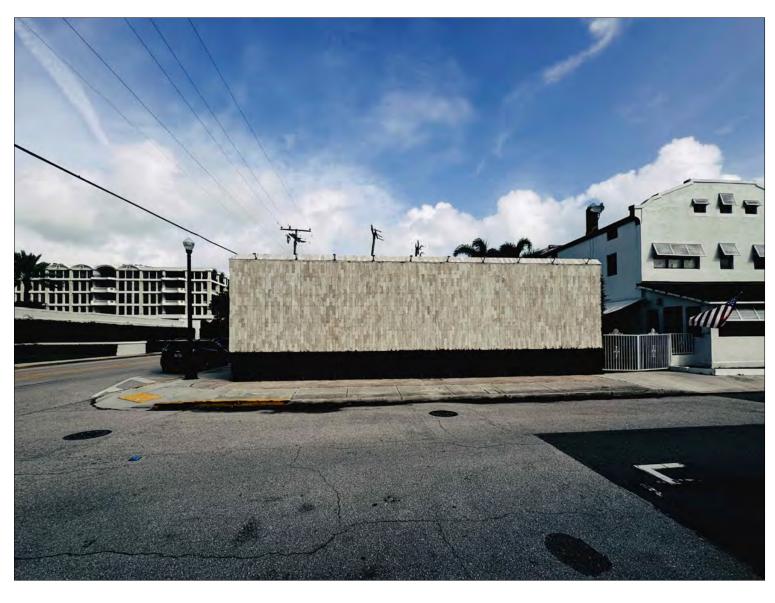

5 EXISTING SITE CONDITION




6 EXISTING SITE CONDITION




7 EXISTING SITE CONDITION



8 EXISTING SITE CONDITION

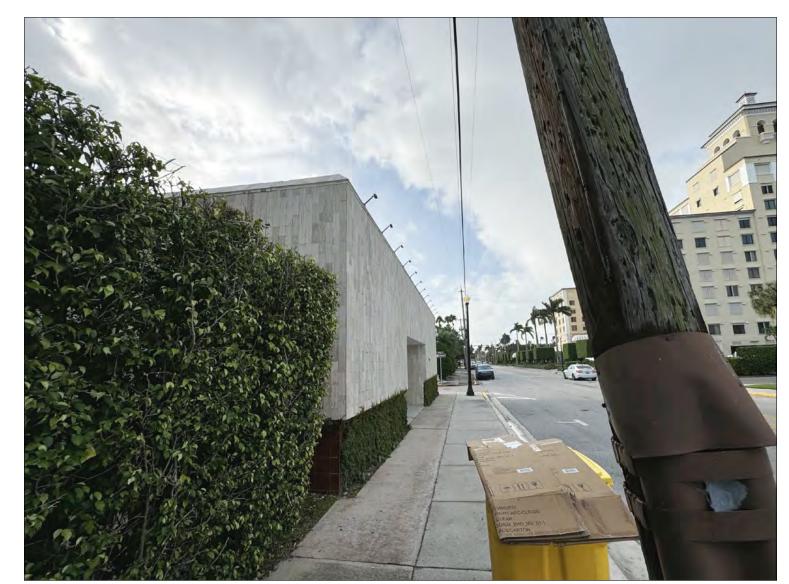

9 EXISTING SITE CONDITION

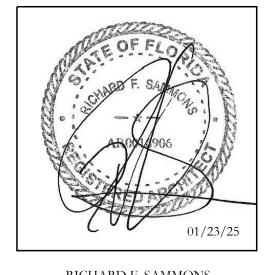

RICHARD F. SAMMONS STATE OF FLORIDA ARCHITECT REGISTRATION NO. AR0016906

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ZON-24-0067

FILE NUMBER:

ARC-24-0111

175 BRADLEY
PLACE
PALM BEACH, FLORIDA 33480

SHEET TITLE

EXTISTING CONDITION SITE PHOTOS

DATE
10/9/2024

SCALE
AS NOTED


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G-003


BY MC, MRM

FAIRFAX & SAMMON

FAIRFAX, SAMMONS & PARTNERS, LLC.
214 BRAZILIAN AVENUE, PALM BEACH 33480
TELEPHONE (561) 805-8591
FAIRFAXANDSAMMONS.COM
LICENSE NO. AA26000846

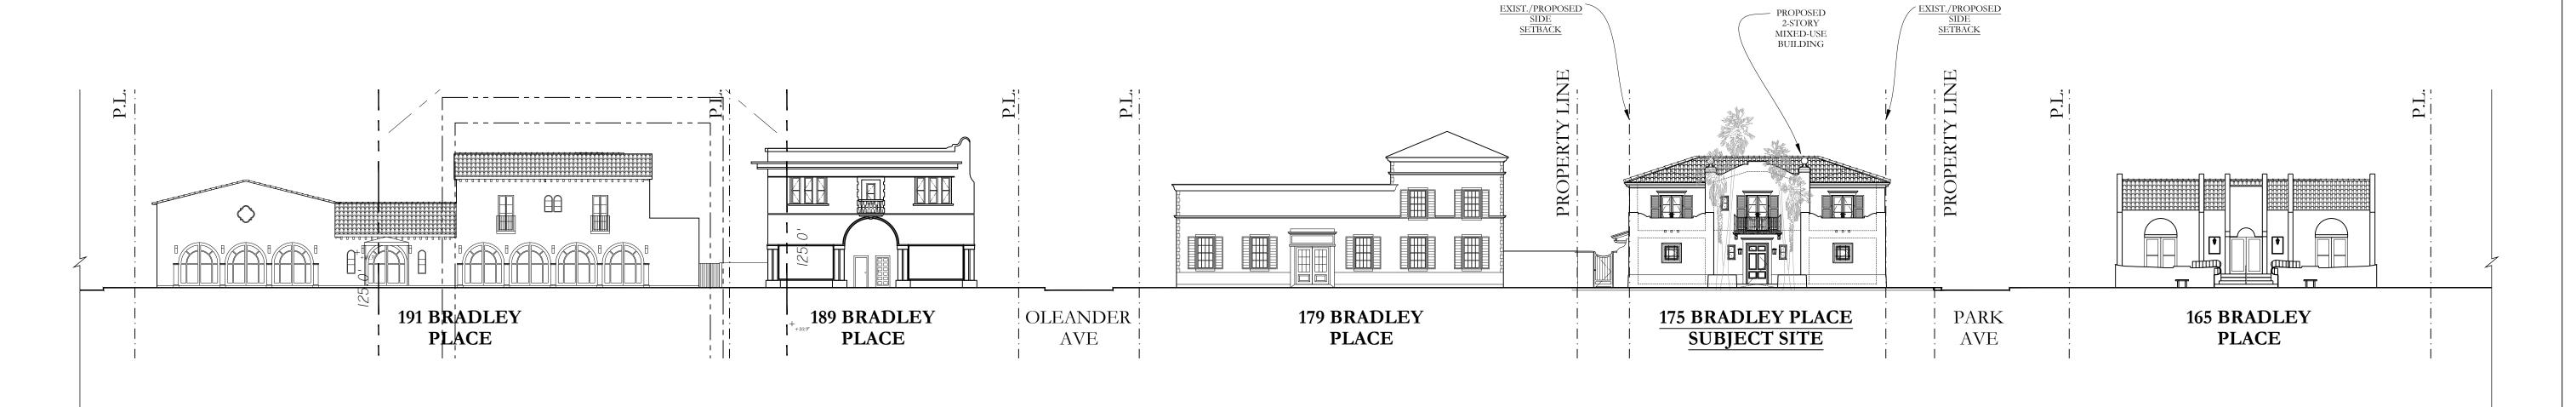


PROPOSED BRADLEY PLACE STREETSCAPE ELEVATION, FACING WEST

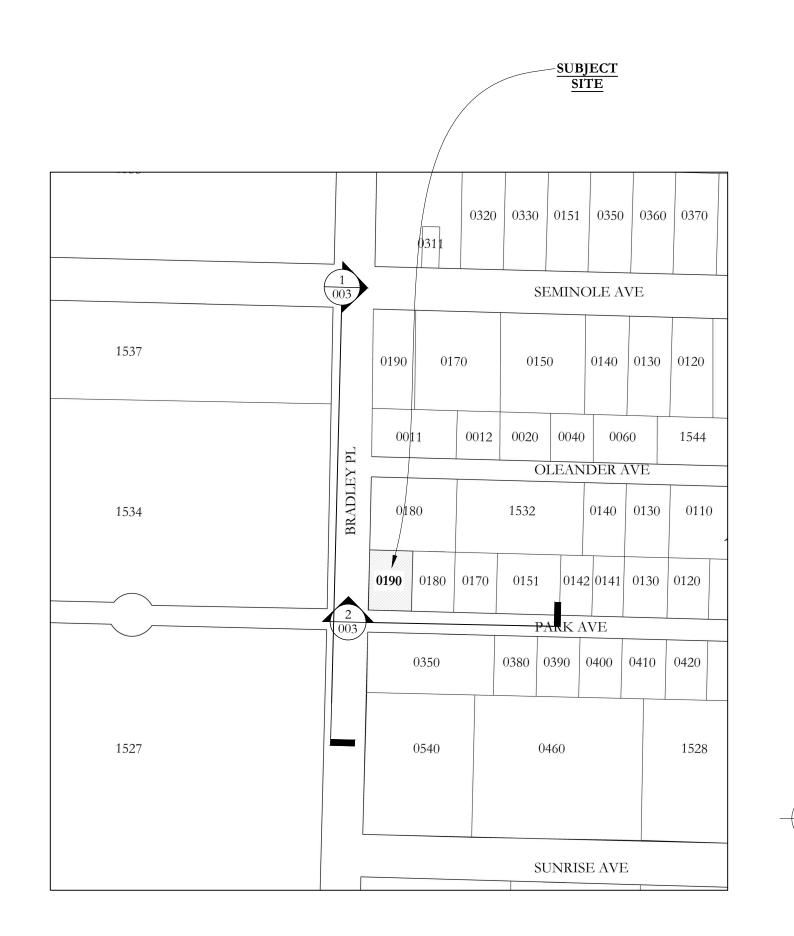



PROPOSED PARK AVE. STREETSCAPE ELEVATION, FACING SOUTH

1/16"=1'-0"

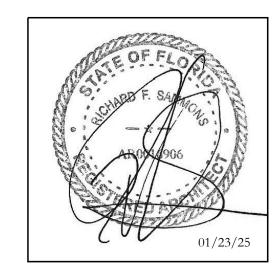

RICHARD F. SAMMONS STATE OF FLORIDA ARCHITECT REGISTRATION NO. AR0016906

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ZONING CASE NUMBER:

ZON-24-0067

FILE NUMBER:

ARC-24-0111

175 BRADLEY PLACE

PALM BEACH, FLORIDA 33480

SHEET TITLE

MC, MRM

PROPOSED
STREESCAPE ELEVATIONS

DATE	SHEET NO
10/9/2024	
SCALE	
AS NOTED	J-0
BY	

FAIRFAX, SAMMONS & PARTNERS, LLC.

214 BRAZILIAN AVENUE, PALM BEACH 33480

TELEPHONE (561) 805-8691

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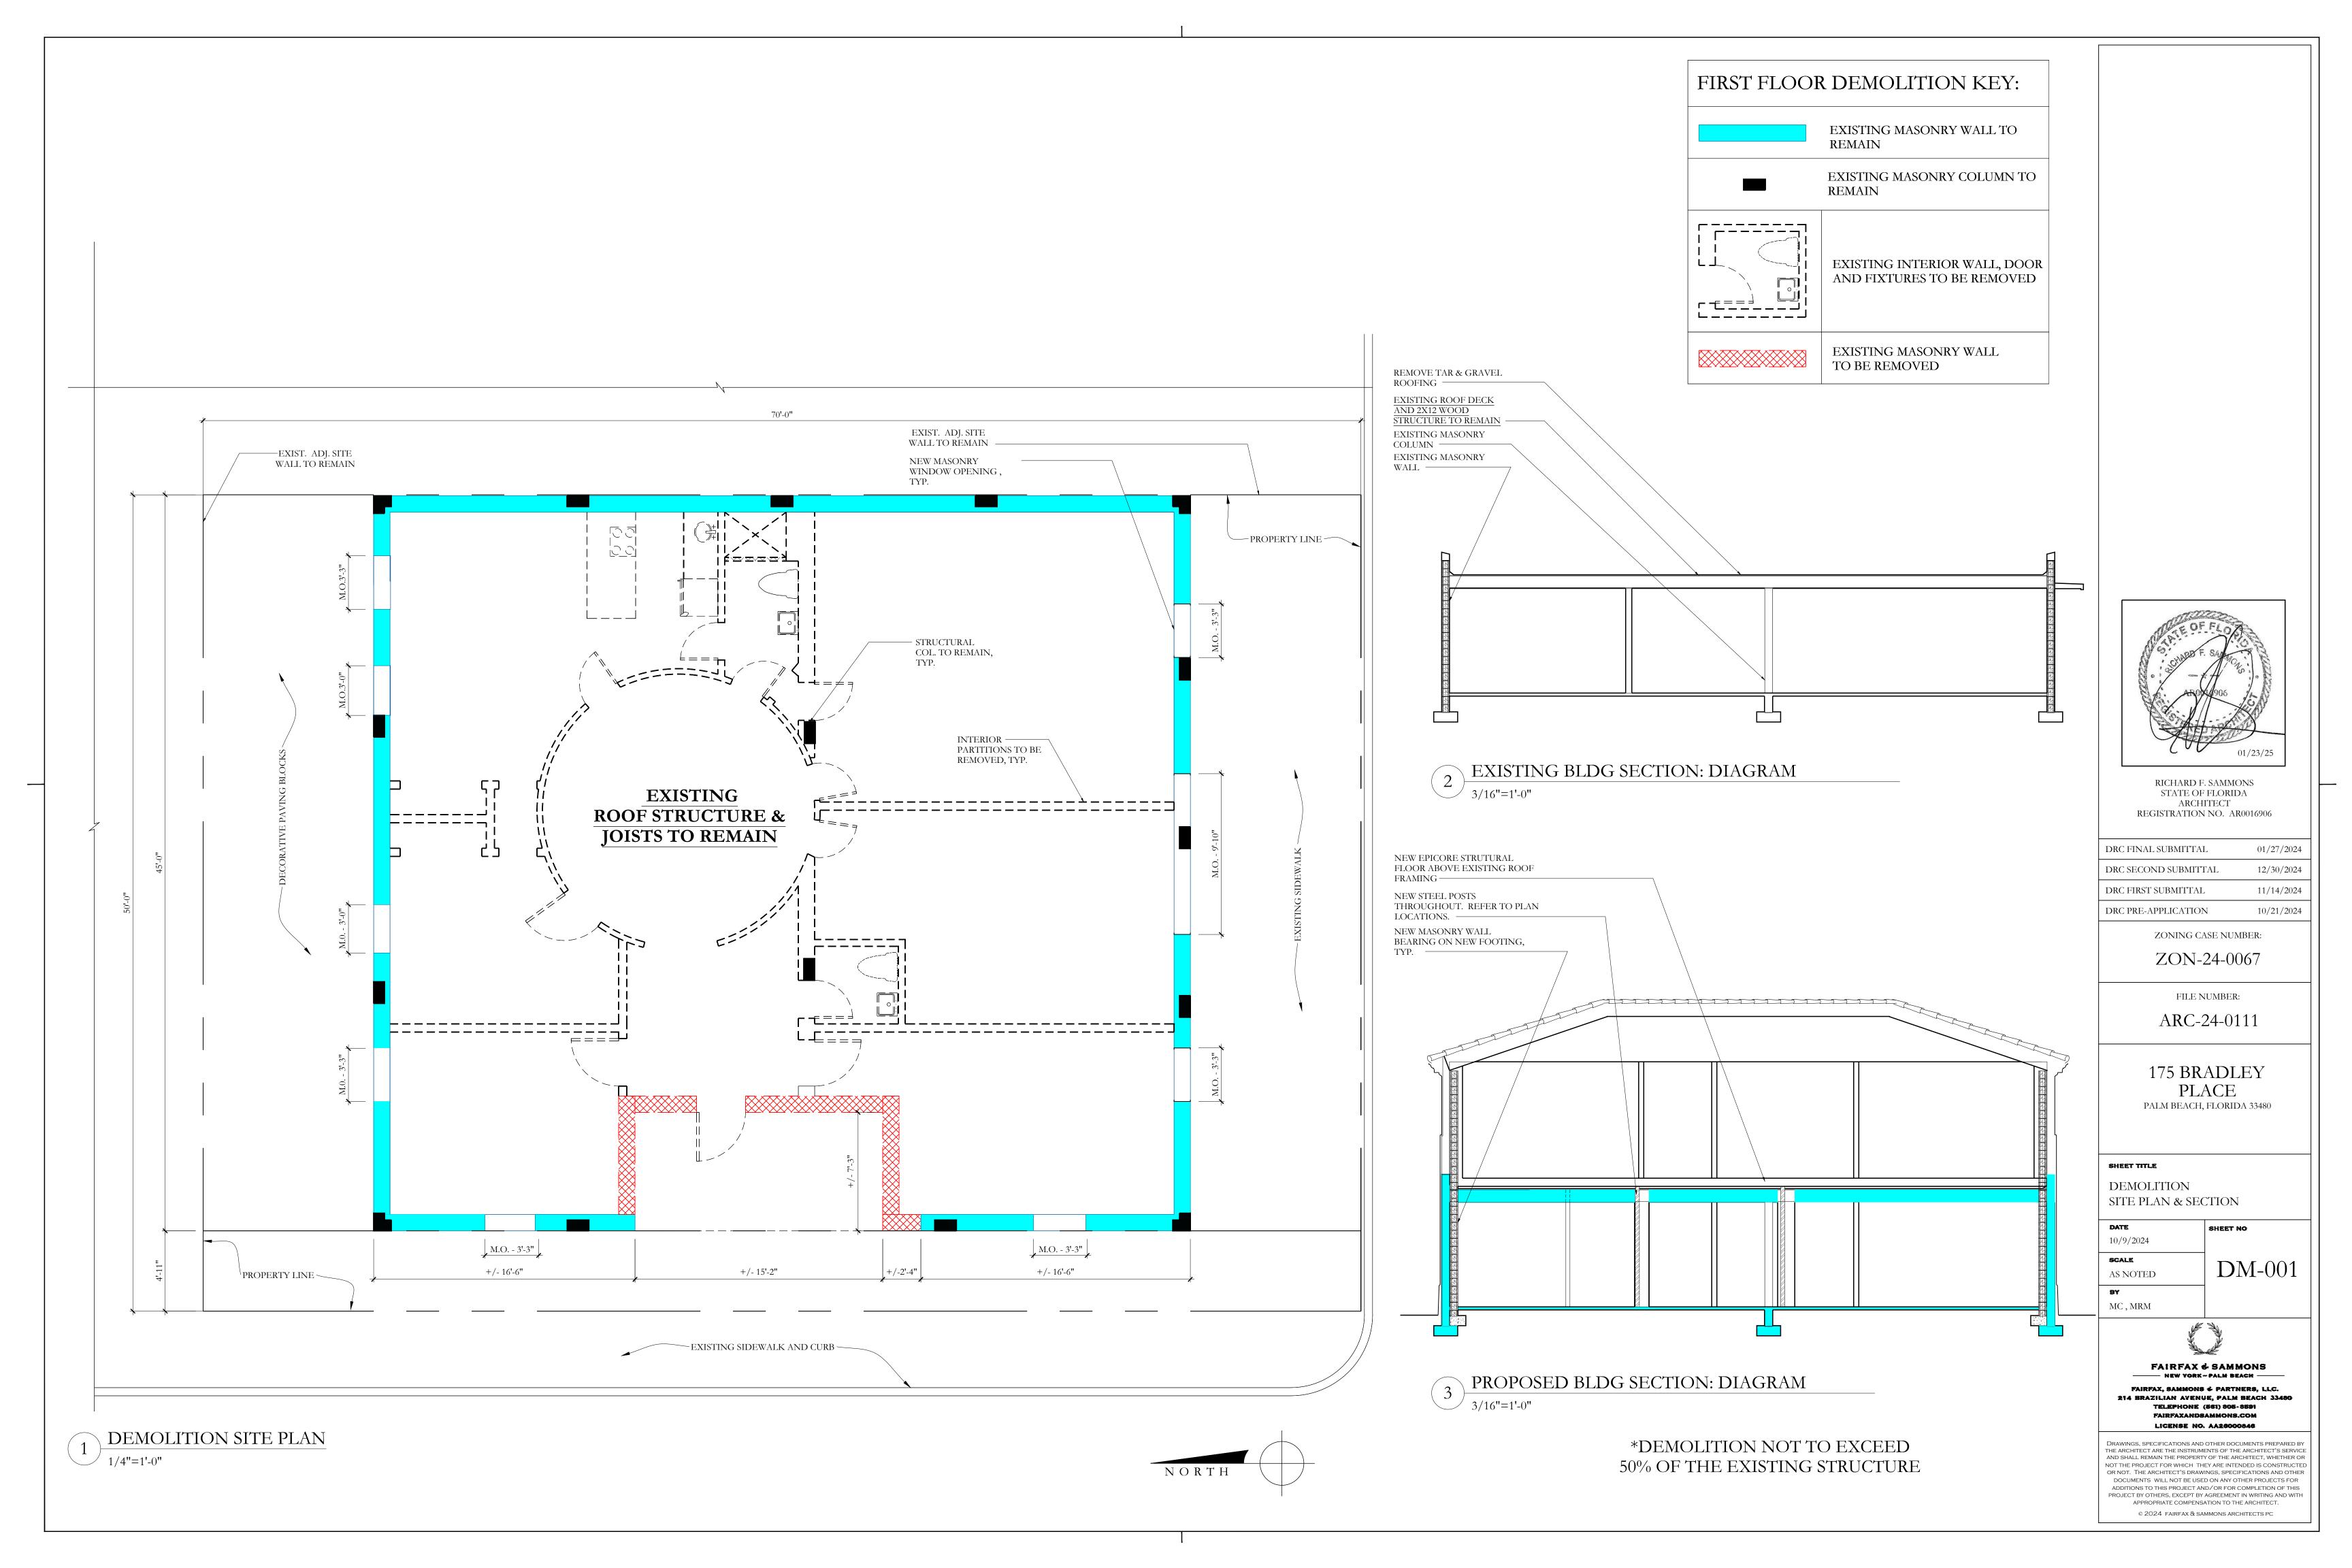
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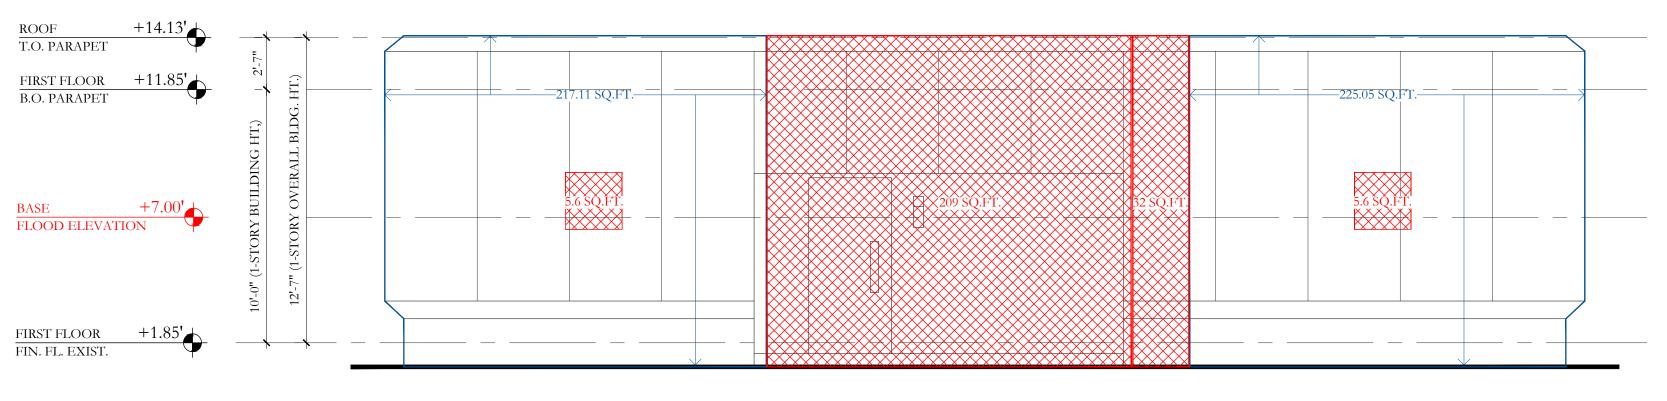
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LICENSE NO. AA26000846


3 KEY PLAN

N.T.S







1 PROPOSED REMOVAL: WEST ELEVATION

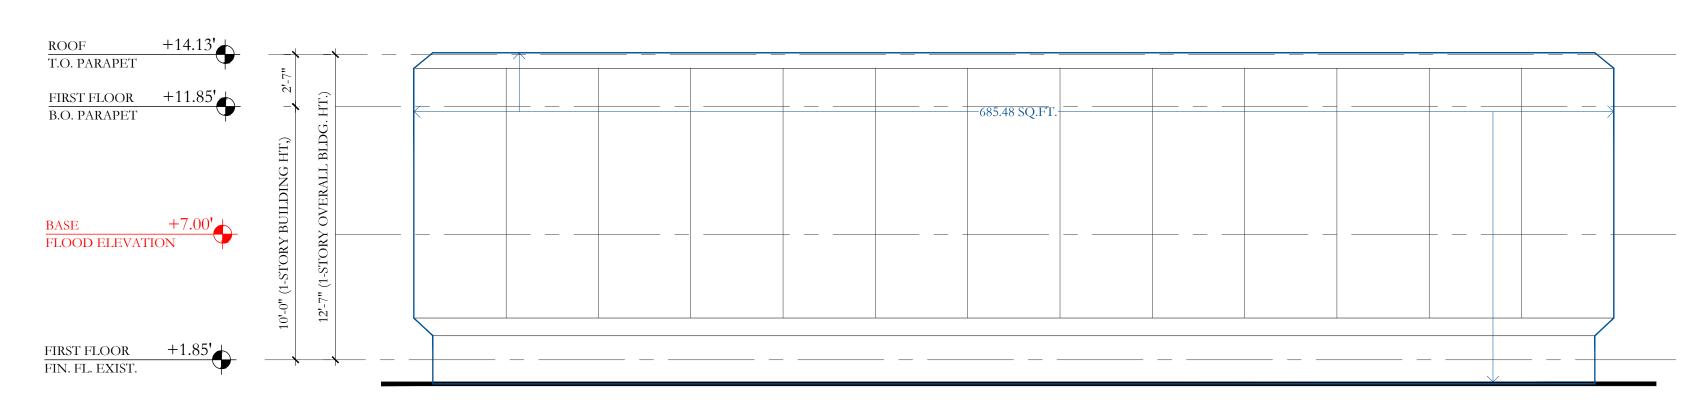

PROPOSED REMOVAL: EAST ELEVATION 1/4"-1' 0"

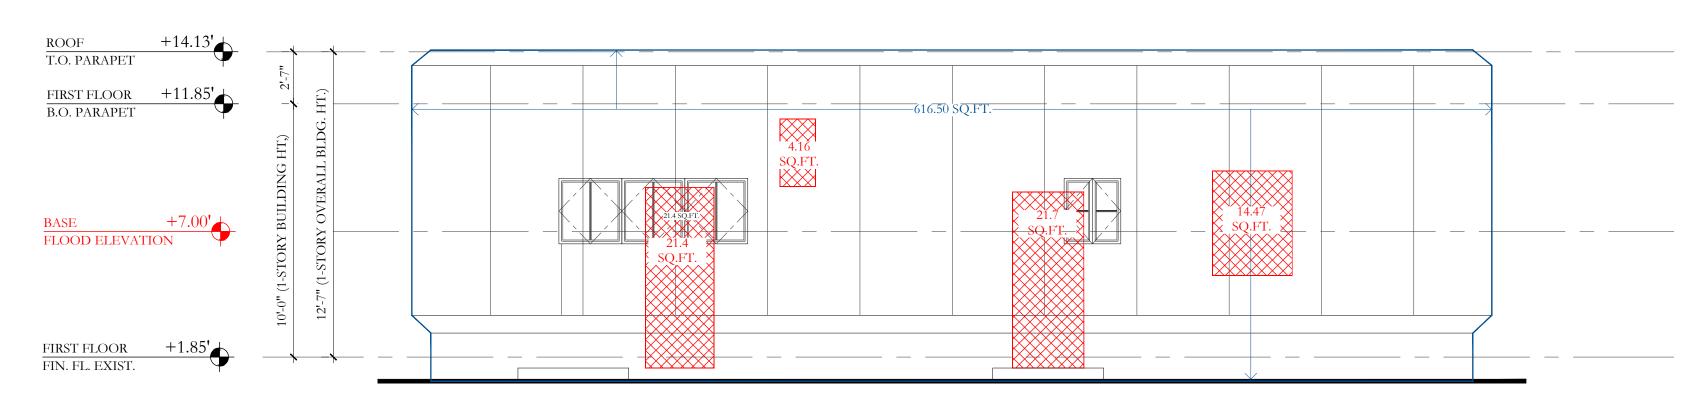

PROPOSED REMOVAL: NORTH ELEVATION

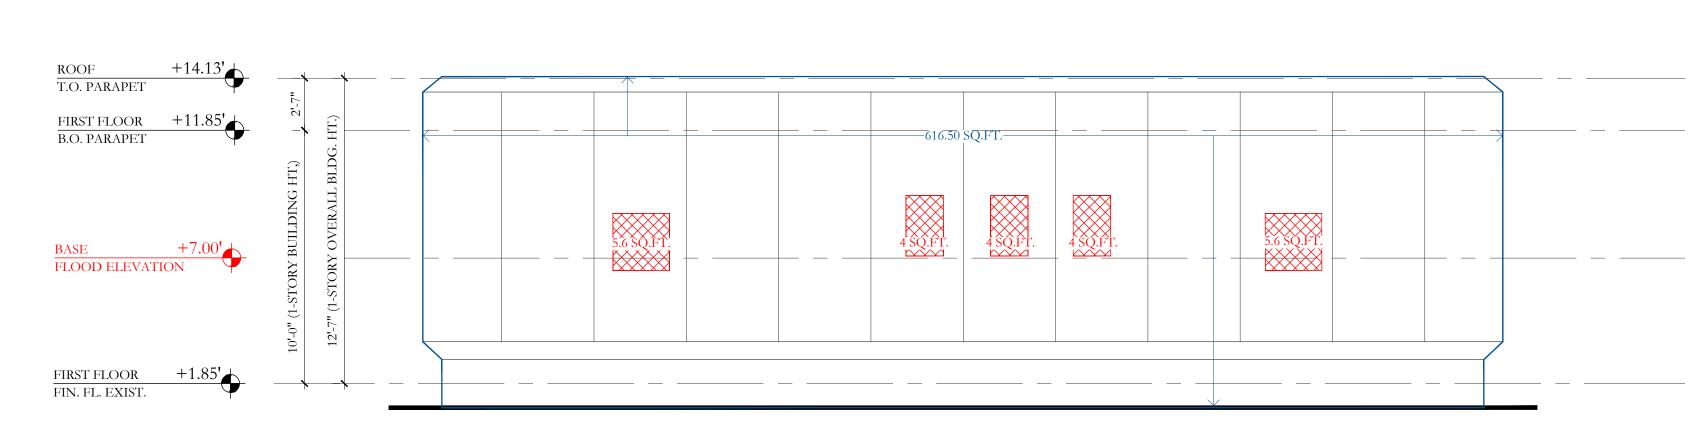

4 PROPOSED REMOVAL: SOUTH ELEVATION

1/4"=1'-0"

WEST ELEVATION CALCULATIONS:

EXTERIOR WALL AREA TO REMAIN:	430.96 SQ. FT.
EXISTING WALL AREA TO BE DEMOLISHED:	252.20 SQ. FT.
EXISTING WALL AREA:	685.48 SQ. FT.
PERCENTAGE OF EXISTING WALL AREA TO BE DEMOLISHED:	36.79 %

EAST ELEVATION CALCULATIONS:

EXTERIOR WALL AREA TO REMAIN:	685.48 SQ. FT.
EXISTING WALL AREA TO BE DEMOLISHED:	0 SQ. FT.
EXISTING WALL AREA:	685.48 SQ. FT.
PERCENTAGE OF EXISTING WALL AREA TO BE DEMOLISHED:	0 %

NORTH ELEVATION CALCULATIONS:

EXTERIOR WALL AREA TO REMAIN:	562.2 SQ. FT.
EXISTING WALL AREA TO BE DEMOLISHED:	61.87 SQ. FT.
EXISTING WALL AREA:	616.50 SQ. FT.
PERCENTAGE OF EXISTING WALL AREA TO BE DEMOLISHED:	10 %


SOUTH ELEVATION CALCULATIONS:

EXTERIOR WALL AREA TO REMAIN:	598.90 SQ. FT.
EXISTING WALL AREA TO BE DEMOLISHED:	17.60 SQ. FT.
EXISTING WALL AREA:	616.50 SQ. FT.
PERCENTAGE OF EXISTING WALL AREA TO BE DEMOLISHED:	2.80 %

TOTAL DEMOLITION FOR NEW MASONRY OPENINGS:

TOTAL EXTERIOR WALL AREA TO REMAIN:	2,277.54 SQ. FT.
TOTAL EXISTING WALL AREA TO BE DEMOLISHED:	331.67 SQ. FT.
TOTAL EXISTING WALL AREA:	2,603.96 SQ. FT.
PERCENTAGE OF EXISTING WALL AREA TO BE DEMOLISHED:	12.73 %

PERCENTAGE OF EXISTING WALL AREA TO BE DEMOLISHED WILL BE LESS THAN 50%

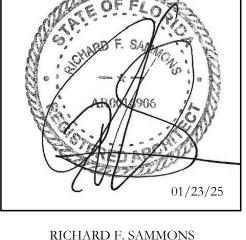

RICHARD F. SAMMONS STATE OF FLORIDA ARCHITECT REGISTRATION NO. AR001690

DRC FINAL SUBMITTAL	01/27/2024
DRC SECOND SUBMITTAL	12/30/2024
DRC FIRST SUBMITTAL	11/14/2024
DRC PRE-APPLICATION	10/21/2024

ZONING CASE NUMBER:

ZON-24-0067

FILE NUMBER:

ARC-24-0111

175 BRADLEY PLACE

PALM BEACH, FLORIDA 33480

SHEET TITLE

MATERIAL REMOVAL ELEVATIONS

DATE 10/9/2024 SCALE AS NOTED

BY MC, MRM

DEMOLITION KEY:

EXISTING EXTERIOR WALL TO REMAIN

NEW MASONRY OPENING

SHEET NO


DM-002


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TELEPHONE (561) 806-8591

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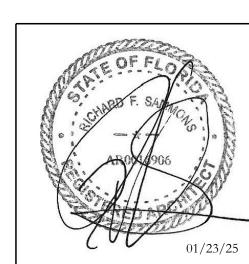
NOTE: ELEVATIONS REFERENCED TO NAVD SURVEY ELEVATIONS

LEGEND:

+_{+5.50'} EXISTING SPOT ELEVATION

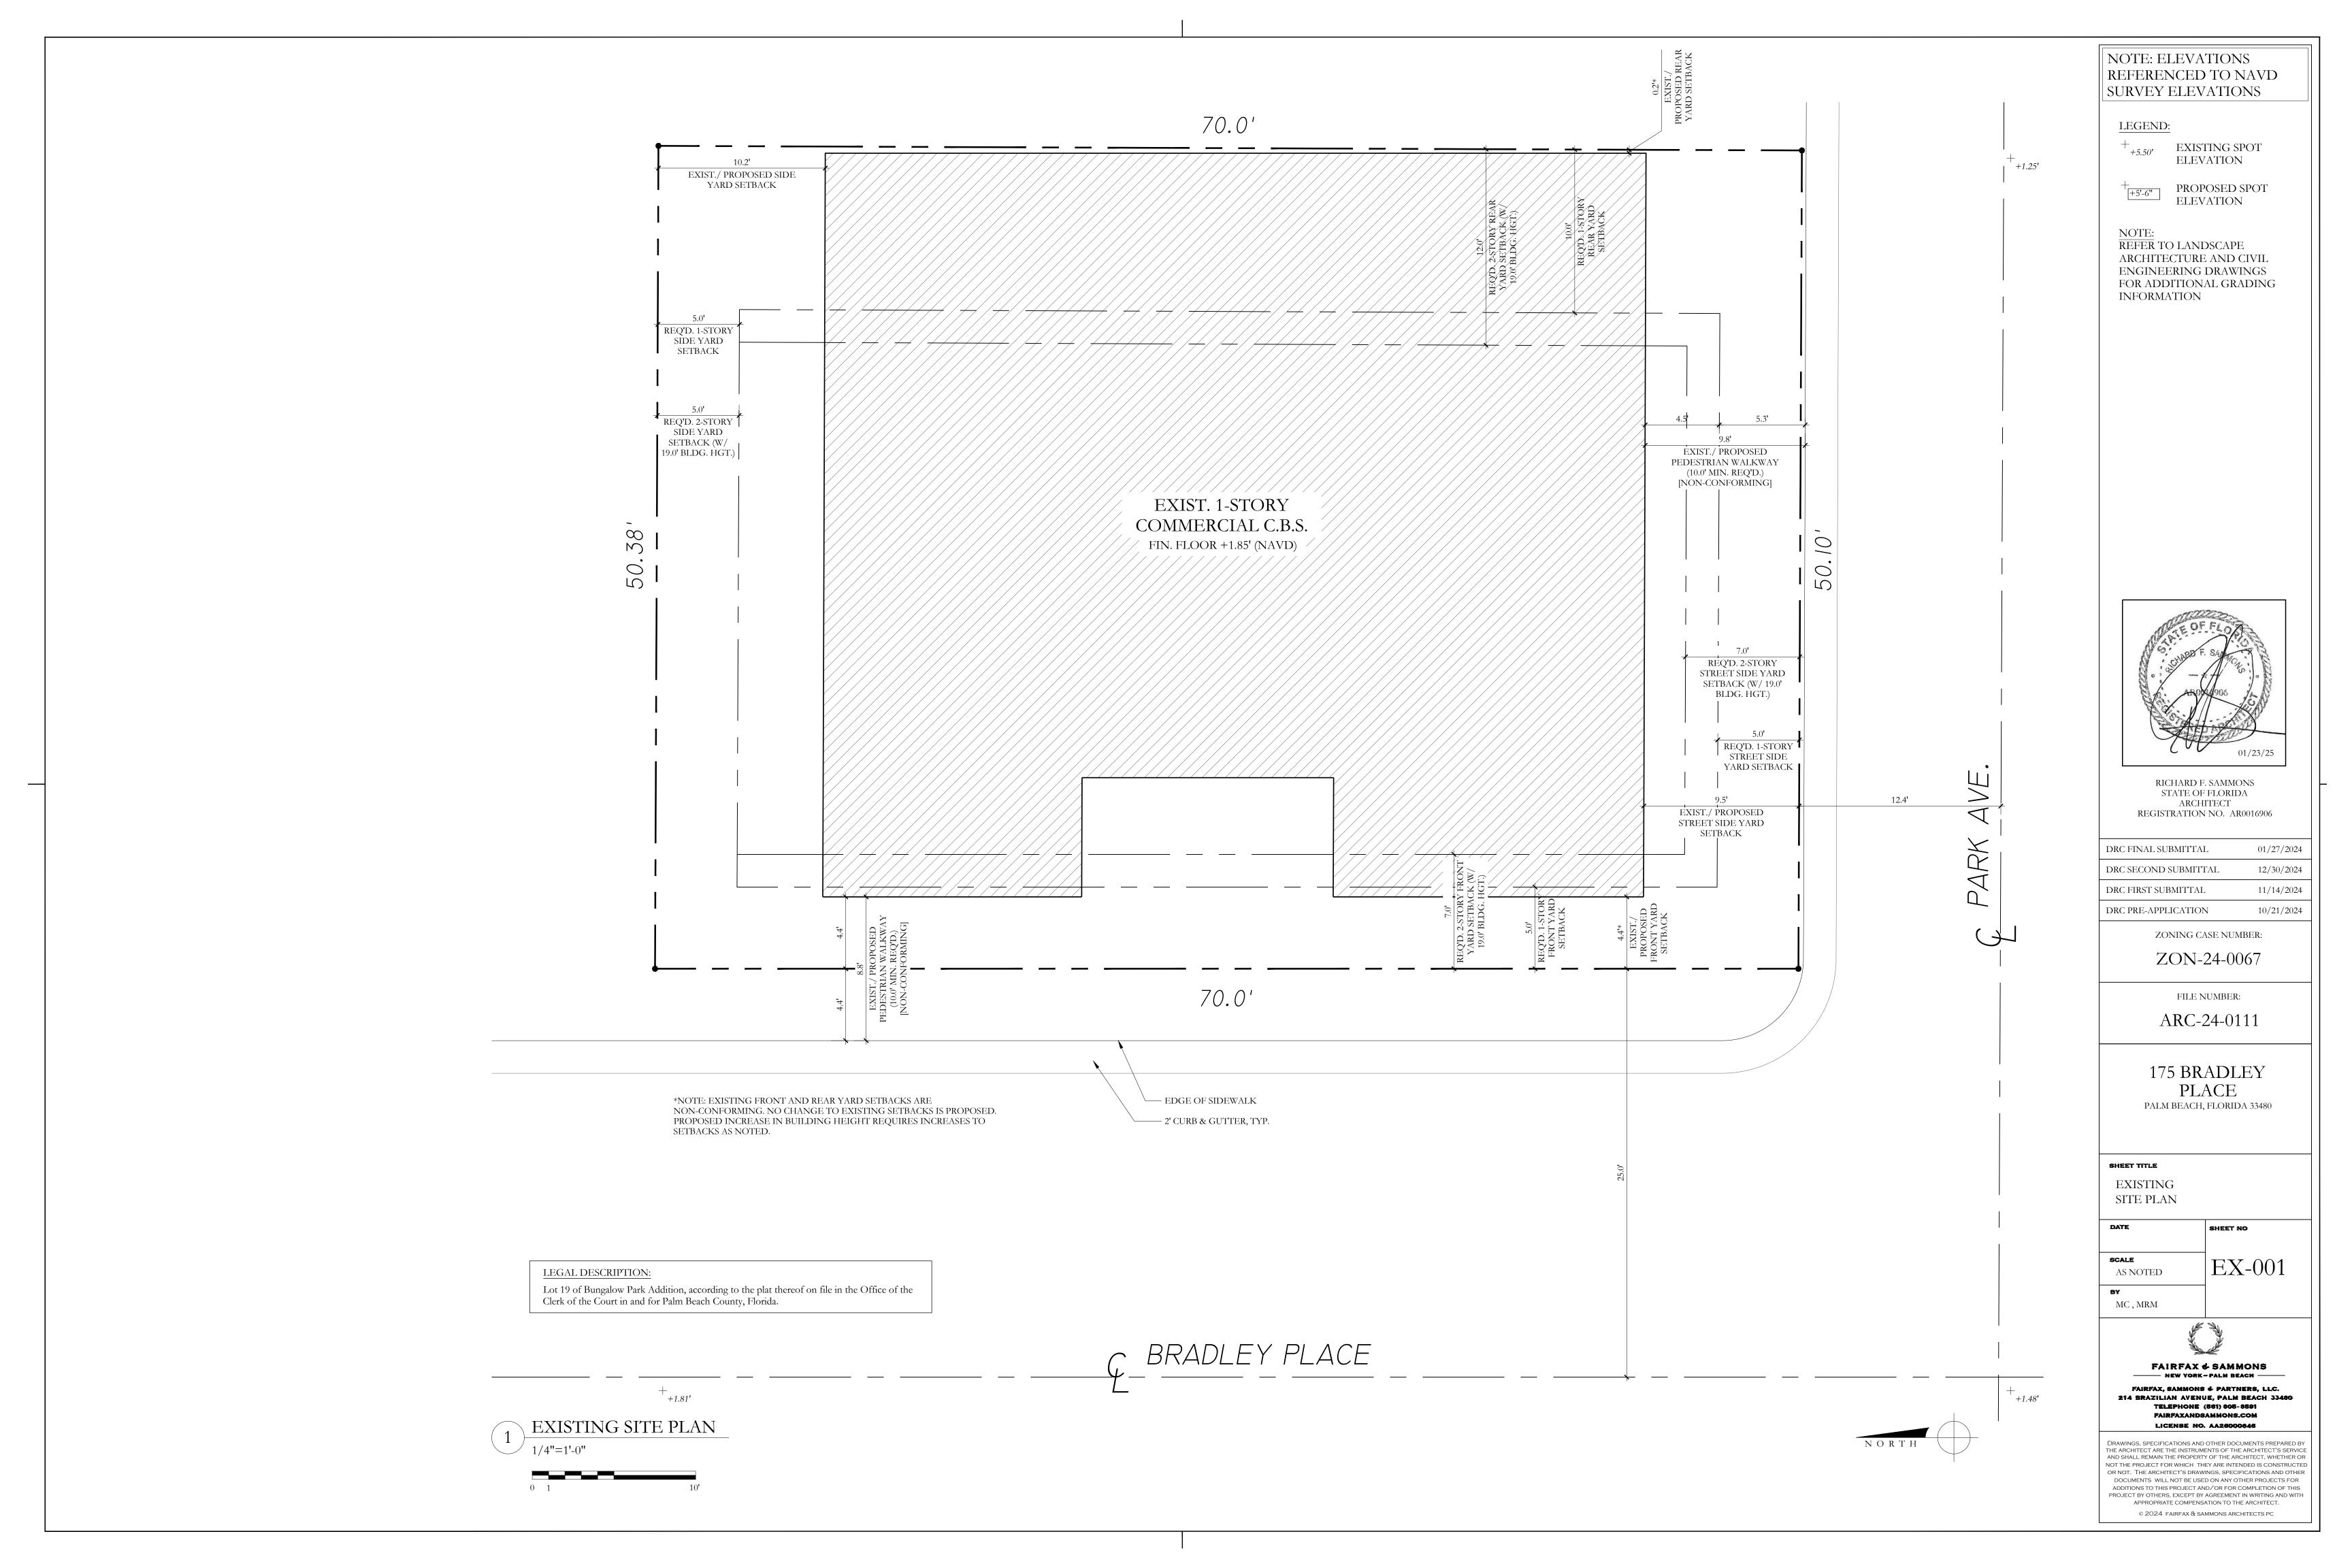+ PROPOSED SPOT ELEVATION

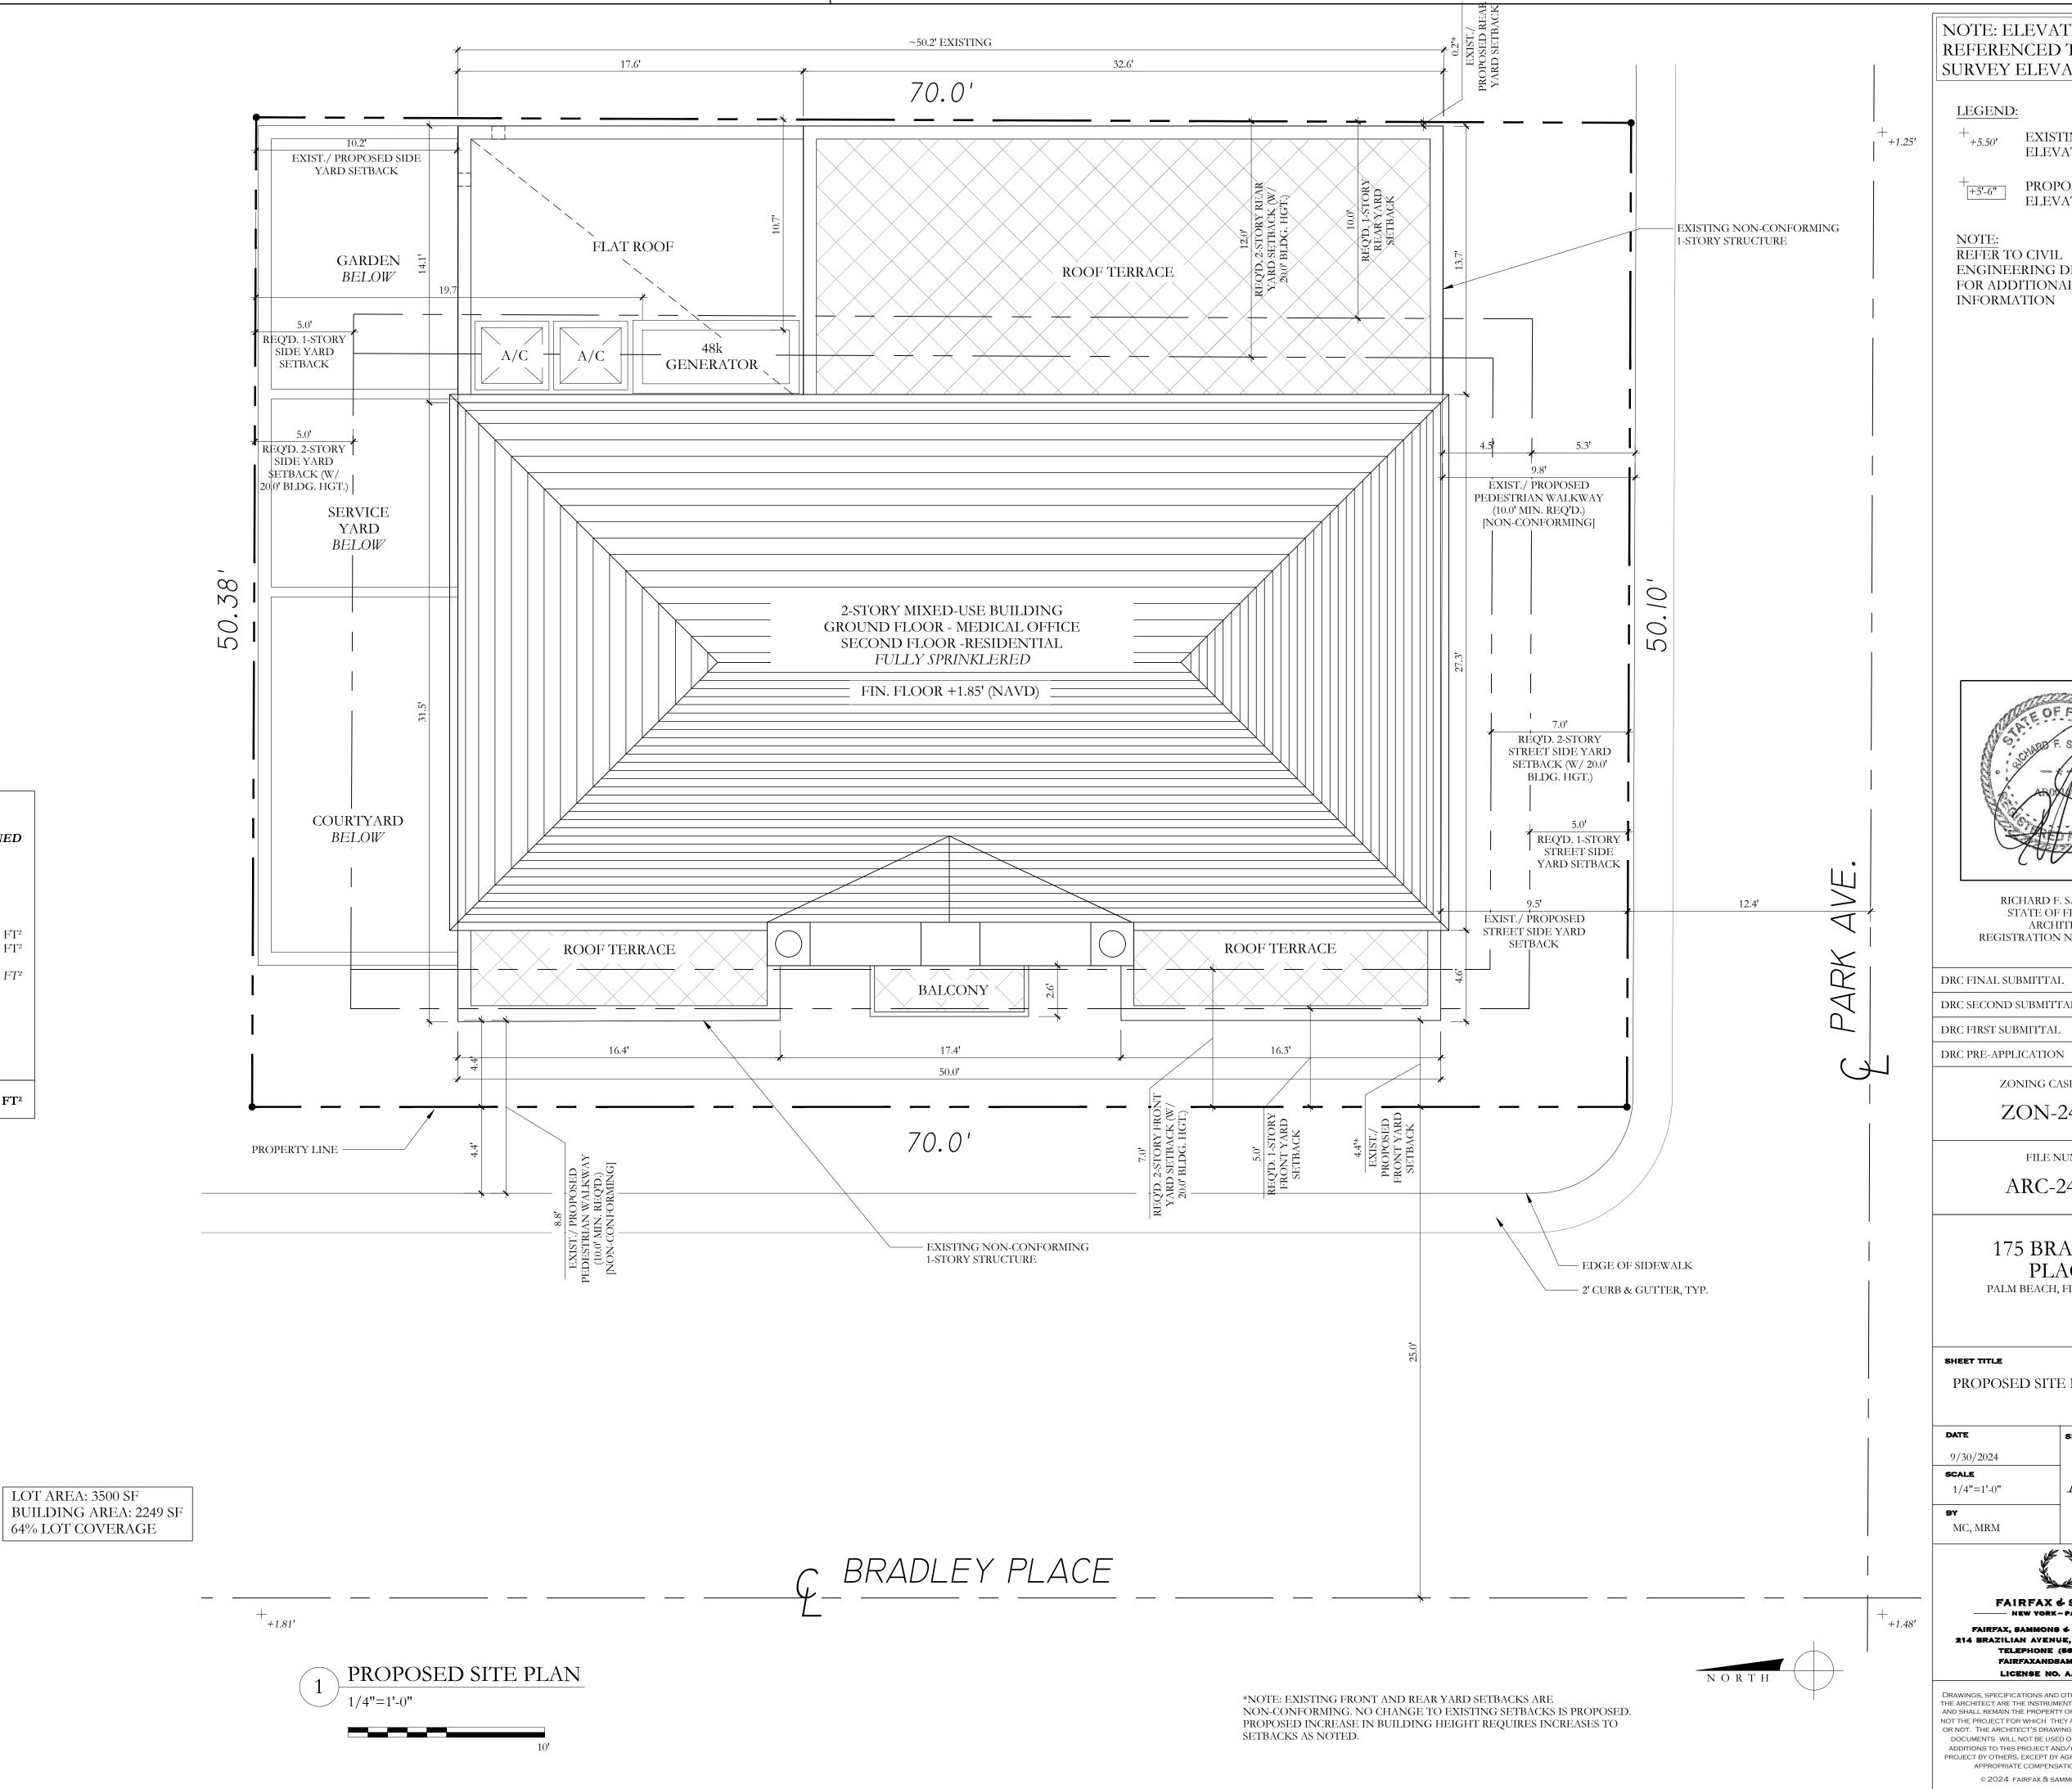REFER TO CIVIL ENGINEERING DRAWINGS FOR ADDITIONAL GRADING INFORMATION



RICHARD F. SAMMONS STATE OF FLORIDA ARCHITECT REGISTRATION NO. AR0016906

DRC FINAL SUBMITTAL 01/27/2024 DRC SECOND SUBMITTAL 12/30/2024 DRC FIRST SUBMITTAL 11/14/2024

ZONING CASE NUMBER:

10/21/2024

ZON-24-0067

FILE NUMBER: ARC-24-0111

175 BRADLEY PLACE

PALM BEACH, FLORIDA 33480

PROPOSED SITE PLAN

SHEET NO 9/30/2024 SCALE A-001 1/4"=1'-0" MC, MRM

> FAIRFAX & SAMMONS FAIRFAX, SAMMONS & PARTNERS, LLC. 214 BRAZILIAN AVENUE, PALM BEACH 33480 TELEPHONE (561) 805-8591

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LICENSE NO. AA26000846

2 LOT COVERAGE DIAGRAM

1/16"=1'-0"

BRADLEY PL

AREA CALCULATIONS:

INTERIOR

INTERIOR

TERRACES

BALCONY

TOTAL AREA:

SUBTOTAL

FIRST FLOOR - MED. OFFICE.

SECOND FLOOR - RESIDENTIAL

CONDITIONED UNCONDITIONED

426 FT²

 $18 \, \mathrm{FT^2}$

444 FT²

3,743 FT²

LOT AREA: 3500 SF

2,049 FT²

1,250 FT²

3,299 FT²

APPROX.


GENERAL NOTES:

- 1. THE ENTIRE AREA OF THE LEVEL OF EXIT DISCHARGE (VESTIBULE) SHALL BE SEPARATED FROM THE OFFICE AREA BELOW BY CONSTRUCTION CONFORMING TO THE FIRE-RESISTANCE RATING OF THE INTERIOR EXIT STAIRWAY. 2023 FBC. SEC.1023 & SEC.1026.2.
- 2. AN NFPA 72 COMPLIANT FIRE ALARM SHALL BE INSTALLED WITH NOTIFICATION TO THE RESIDENCE FOR ALL ALARMS. THE FDC SHALL COMPLY WITH NFPA 14 FOR INSTALLATION AND LOCATION FROM A FIRE HYDRANT.
- 3. NFPA 14 CHAPTER 6, 6.4.5.4 * FIRE DEPARTMENT CONNECTIONS SHALL BE LOCATED NOT MORE THAN 100 FT (30.5 M) FROM THE NEAREST FIRE HYDRANT CONNECTED TO AN APPROVED WATER SUPPLY.
- 4. 6.4.6 FIRE DEPARTMENT CONNECTIONS SHALL BE LOCATED NOT LESS THAN 18 IN. (457 MM) NOR MORE THAN 48 IN. (1219 MM) ABOVE THE LEVEL OF THE ADJOINING GROUND, SIDEWALK, OR GRADE SURFACE.
- 5. ALL PROVISIONS OF NFPA 241 SHALL BE COMPLIED WITH DURING THE CONSTRUCTION OF THE PROJECT.

FLOOD PROOFING:

BUILDING PLANS ARE DESIGNED IN ACCORDANCE WITH 2023 FBC, SEC. 1612 FLOOD HAZARD DOCUMENTATION, REFER TO BUILDING ELEVATIONS FOR THE DRY FLOOD-PROOFED ELEVATION (BFE +1). DRY FLOODPROOFING IS DESIGNED IN ACCORDANCE WITH ASCE 24, REFER TO THE PROJECT'S FLOOD EMERGENCY

TFB = INDICATES LOCATION OF TEMPORARY FLOOD BARRIER TO BE INSTALLED AS PER FLOOD MANAGEMENT PLANS

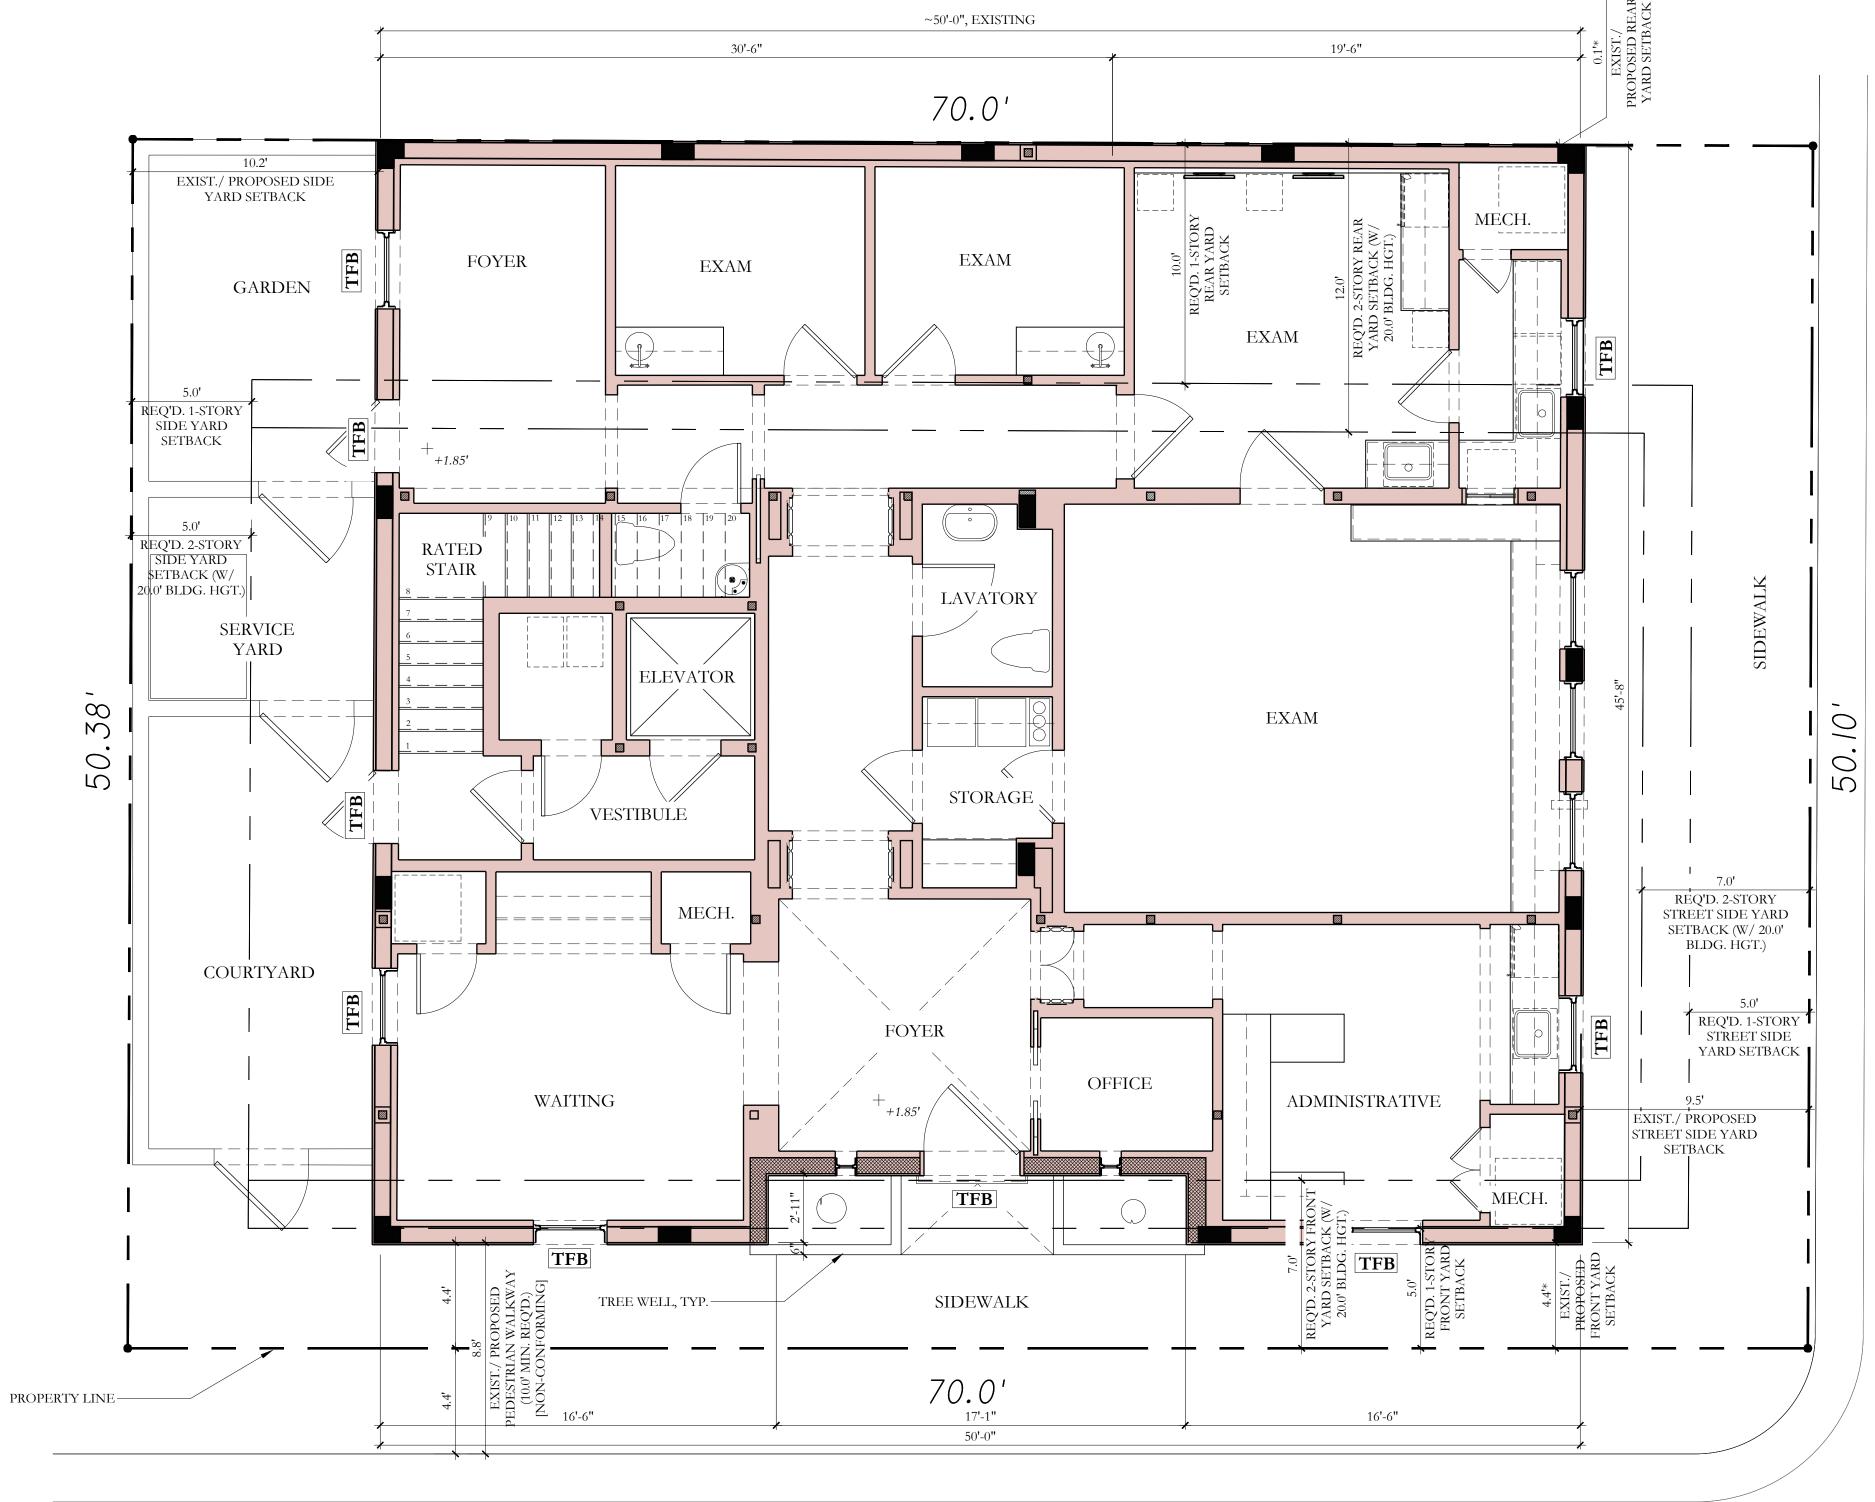

BRADLEY PLACE

PROPOSED SITE PLAN W/ FIRST FLOOR PLAN



SHEET TITLE

10/9/2024

AS NOTED

MC, MRM

SCALE


PROPOSED

SITE FLOORPLAN

FAIRFAX & SAMMONS ----- NEW YORK-PALM BEACH ---FAIRFAX, SAMMONS & PARTNERS, LLC.

214 BRAZILIAN AVENUE, PALM BEACH 33480 TELEPHONE (561) 805-8591 LICENSE NO. AA26000846

Drawings, specifications and other documents prepared b THE ARCHITECT ARE THE INSTRUMENTS OF THE ARCHITECT'S SERVICE AND SHALL REMAIN THE PROPERTY OF THE ARCHITECT, WHETHER OR NOT THE PROJECT FOR WHICH THEY ARE INTENDED IS CONSTRUCTED OR NOT. THE ARCHITECT'S DRAWINGS, SPECIFICATIONS AND OTHER DOCUMENTS WILL NOT BE USED ON ANY OTHER PROJECTS FOR ADDITIONS TO THIS PROJECT AND/OR FOR COMPLETION OF THIS PROJECT BY OTHERS, EXCEPT BY AGREEMENT IN WRITING AND WITH APPROPRIATE COMPENSATION TO THE ARCHITECT. © 2024 FAIRFAX & SAMMONS ARCHITECTS PC

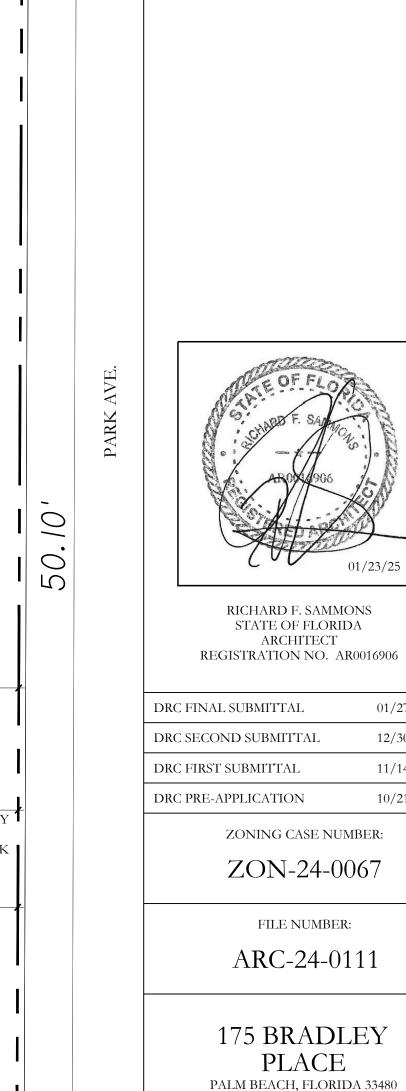

NOTE: ELEVATIONS

SURVEY ELEVATIONS

LEGEND:

NOTE:

REFER TO CIVIL

INFORMATION

REFERENCED TO NAVD

+_{+5.50'} EXISTING SPOT

PROPOSED SPOT

ENGINEERING DRAWINGS

FOR ADDITIONAL GRADING

STATE OF FLORIDA ARCHITECT

FILE NUMBER:

PLACE

SHEET NO

01/27/2024

12/30/2024

11/14/2024

10/21/2024

ELEVATION

ELEVATION



Town of Palm Beach Planning Zoning and Building 360 S County Rd Palm Beach, FL 33480 www.townofpalmbeach.com

Line #		Zoning Legend					
1	Property Address:	175 BRADLEY PLACE					
2		C-TS (COMMERCIAL TOWN SERVING)					
3	Lot Area (sq. ft.):	3,500 S.F.					
4	Lot Width (W) & Depth (D) (ft.):						
5	Structure Type: (Single-Family, Multi-Family, Comm., Other)	C.B.S. / COMMERCIAL OFFICE BLDG. (N	B.S. / COMMERCIAL OFFICE BLDG. (NON-MEDICAL) 1 TO 3 STORIES				
6	FEMA Flood Zone Designation:	ZONE AE (EL 6)					
7	Zero Datum for point of meas. (NAVD)	EXISTING FINISH FLOOR (+1.85' NAVD)					
8	Crown of Road (COR) (NAVD)	+1.81' NAVD (BRADLEY PL.)					
9		REQ'D / PERMITTED	EXISTING	NON-CONFORMING	PROPOSED	VARIANCE REQUEST	
10	Lot Area (Sq. Ft.)	4,000 MIN.	3,500	X	[N/C]	*SPECIAL EXCEPTION W/ SITE PLAN REVIEW	
11	Lot Width (Ft.)	30 MIN.	70		[N/C]		
12	Lot Depth (Ft.)	90 MIN.	50.1' - 50.38' [VARIES]	X	[N/C]	*SPECIAL EXCEPTION W/ SITE PLAN REVIEW	
13	Lot Coverage (Sq Ft and %)	2,450 (70%) MAX.	2,288 (65.3%)		[N/C]		
14	Enclosed Square Footage (1st & 2nd Fl., Basement, Accs. Structure, etc)	N/A	2,175		3,570		
15	*Front (West) Yard Setback (1 Story) (Ft.)	5	4.4		N/A		
16	*Front (West) Yard Setback (2 Story) (Ft.)		N/A	X	4.4 [N/C]	X	
17	* Street Side (South) Yard Setback (1 Story) (Ft.)	5	9.5		N/A		
18	* Street Side (South) Yard Setback (2 Story) (Ft.)		N/A	1	9.5 [N/C]		
19	* Side (North) Yard Setback (1 Story) (Ft.)		10.2		N/A		
20	* Side (North) Yard Setback (2 Story) (Ft.)	4 ^ (5 IF PROVIDED)	N/A		10.2 [N/C]		
21	*Rear (East) Yard Setback (1 Story) (Ft.)	10	0.2	_ X	N/A	X	
22	*Rear (East) Yard Setback (2 Story) (Ft.)	12 ^	N/A	A	0.2 [N/C]	A	
23	Building Height (Ft.)	15 FOR 1-STORY 25 FOR 2-STORY	10 (1-STORY)		19 (2-STORY)	*SPECIAL EXCEPTION FOR 2 STORIES	
24	Overall Building Height (Ft.)	20 FOR 1-STORY (FLAT ROOF) 35 FOR 2-STORY (PITCHED ROOF)	12 (1-STORY)		28.5 (2-STORY)	*SPECIAL EXCEPTION FOR 2 STORIES	
25	Building Length (Ft.)	150	50.25		[N/C]		
26	** Max. Fill Added to Site (Ft.)		N/A		N/A		
27	Finished Floor Elev. (FFE)(NAVD)		+1.85		[N/C]		
28	Base Flood Elevation (BFE)(NAVD)		+7.0		[N/C]		
29	Landscape Open Space (LOS) (Sq. Ft. and %)	525 (15%) MIN. (1-STORY)	319 (9.1%) (1-STORY) N/A	X	N/A 319 (9.1%) (1-STORY) [N/C]	X	
30	Front Yard LOS (Sq. Ft. and %)	123 (35%) MIN. (1-STORY) 172 (35%) MIN. (2-STORY)	53 (15%) (1-STORY) N/A	Х	N/A 53 (10.8%) (2-STORY) [N/C]	Х	
31	Maximum Gross Floor Area (Sq. Ft.)	15,000	2,175		3,750		
32	*** Native Plant Species %	Planes refer to TOPP I and served I are not					

^ For buildings in excess of 15 feet in height, increase minimum yard requirements one foot for each two feet of building height, or portion therof, exceeing 15 feet.

* Indicate each yard area with cardinal direction (N,S,E,W)

** Difference of Fin. Floor Elev. (FFE) and highest Crown of Rd (COR) divided by two. (FFE - COR) / 2 = Max. Fill (Sec. 134-1600)

*** Provide Native plant species info per category as requited by Ord. 003-2023 on separate TOPB Landscape Legend Enter N/A if value is not applicable.

Enter N/C if value is not changing.

REV BF 20230626



NOTE: ELEVATIONS
REFERENCED TO NAVD
SURVEY ELEVATIONS


LEGEND:

+_{+5.50'} EXISTING SPOT ELEVATION

+ FROPOSED SPOT ELEVATION

NOTE:
REFER TO LANDSCAPE
ARCHITECTURE AND CIVIL
ENGINEERING DRAWINGS
FOR ADDITIONAL GRADING

INFORMATION

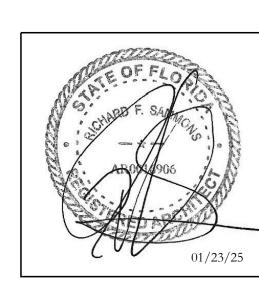

RICHARD F. SAMMONS STATE OF FLORIDA ARCHITECT REGISTRATION NO. AR0016906

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DRC SECOND SUBMITTAL	12/30/2024
DRC FIRST SUBMITTAL	11/14/2024
DRC PRE-APPLICATION	10/21/2024

ZONING CASE NUMBER:

ZON-24-0067

FILE NUMBER:
ARC-24-0111

175 BRADLEY
PLACE
PALM BEACH, FLORIDA 33480

PROPOSED
ZONING LEGEND

DATE 10/9/2024 SCALE

AS NOTED A-002A

BY MC, CG





SHEET NO

FAIRFAX, SAMMONS & PARTNERS, LLC.

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FAIRFAXANDSAMMONS.COM
LICENSE NO. AA26000846


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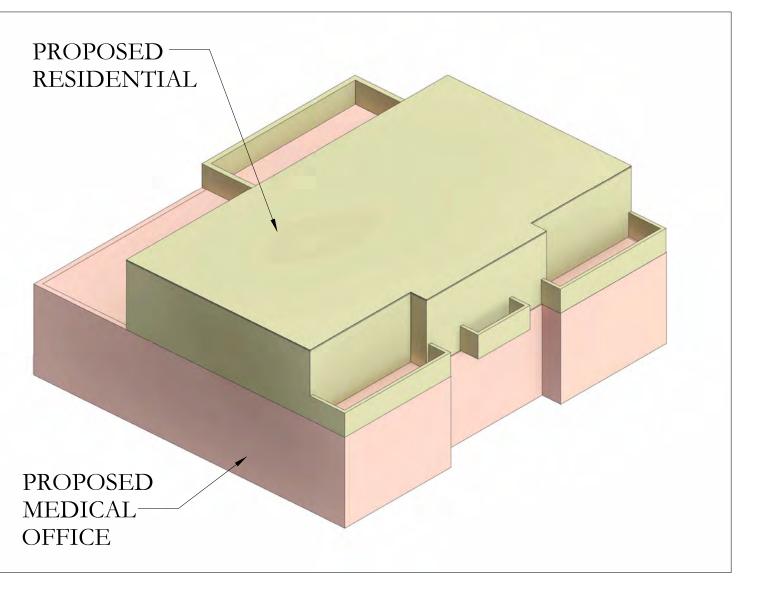


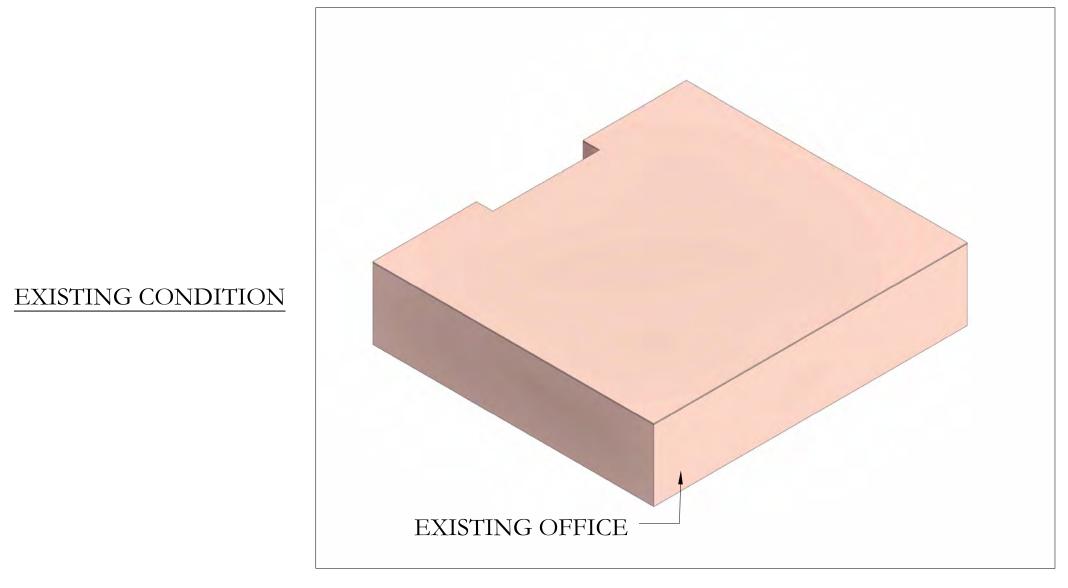
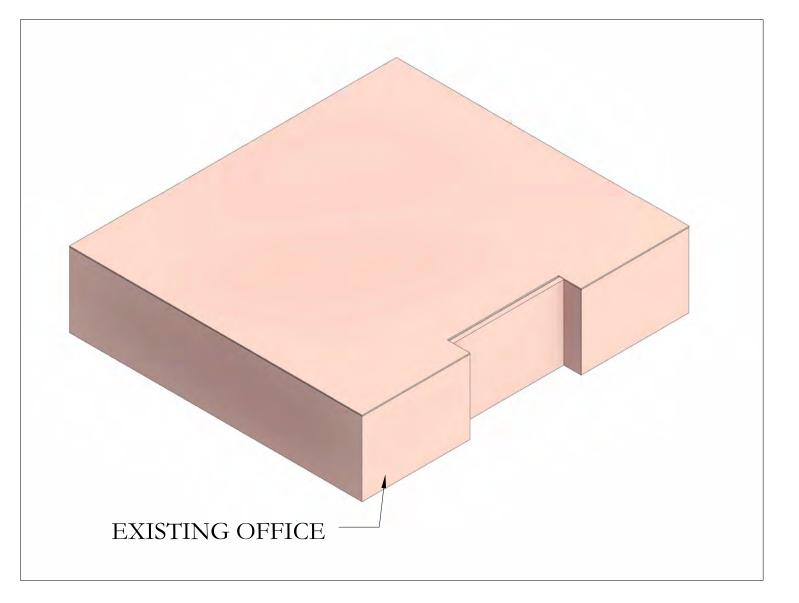
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N.T.S


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N.T.S




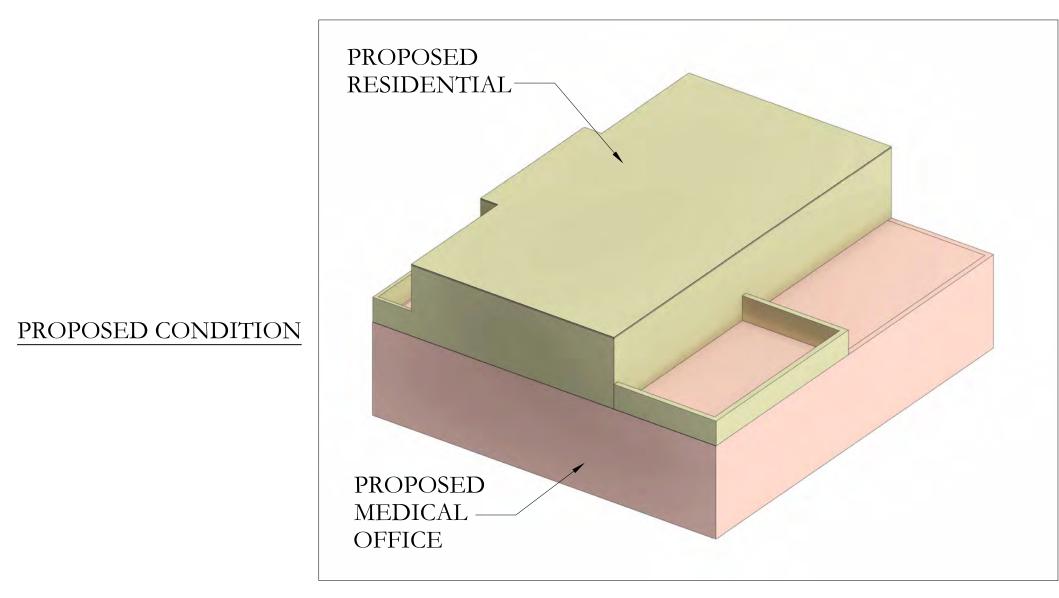

3 MASSING DIAGRAM - FROM EAST
N.T.S

4 MASSING DIAGRAM - FROM WEST
N.T.S

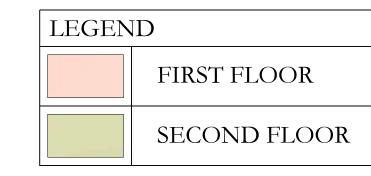

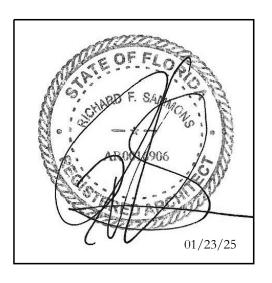

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SHEET T

MASSING DIAGRAMS

DATE	SHEET NO
10/9/2024	
SCALE	
AS NOTED	A-003
BY	
MC, MRM	

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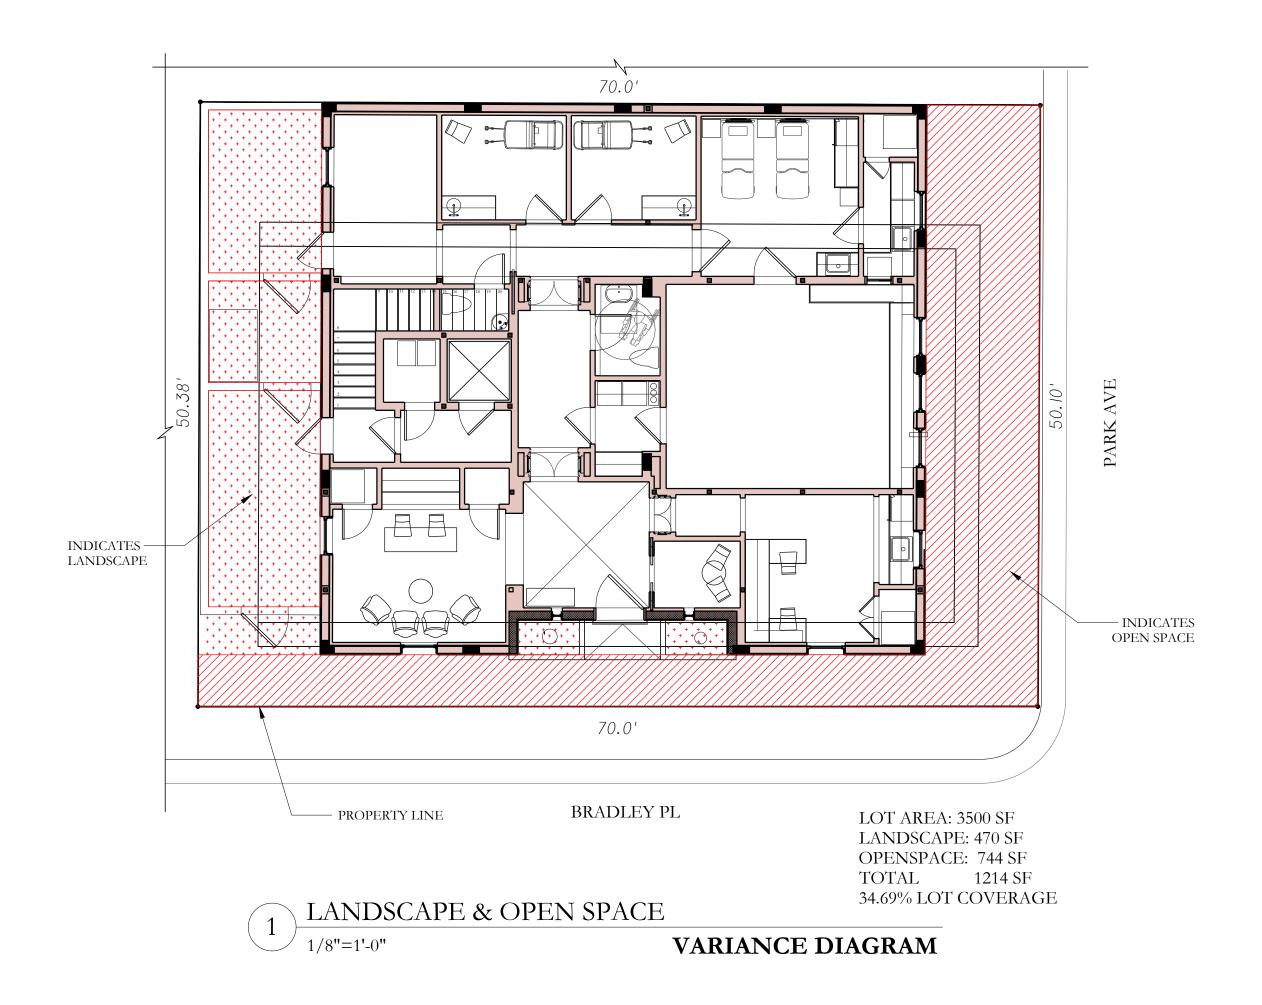
NEW YORK ~ PALM BEACH


FAIRFAX, SAMMONS & PARTNERS, LLC.

214 BRAZILIAN AVENUE, PALM BEACH 33480


TELEPHONE (561) 805-8891
FAIRFAXANDSAMMONS.COM
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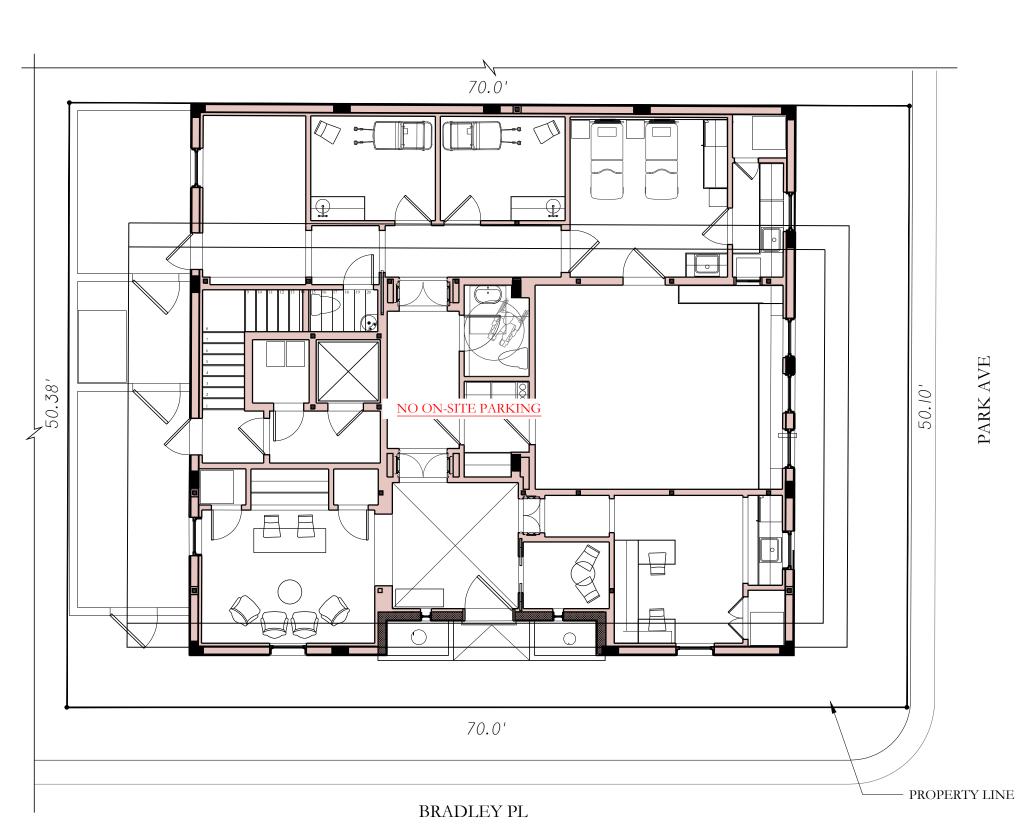




VARIANCE DIAGRAM

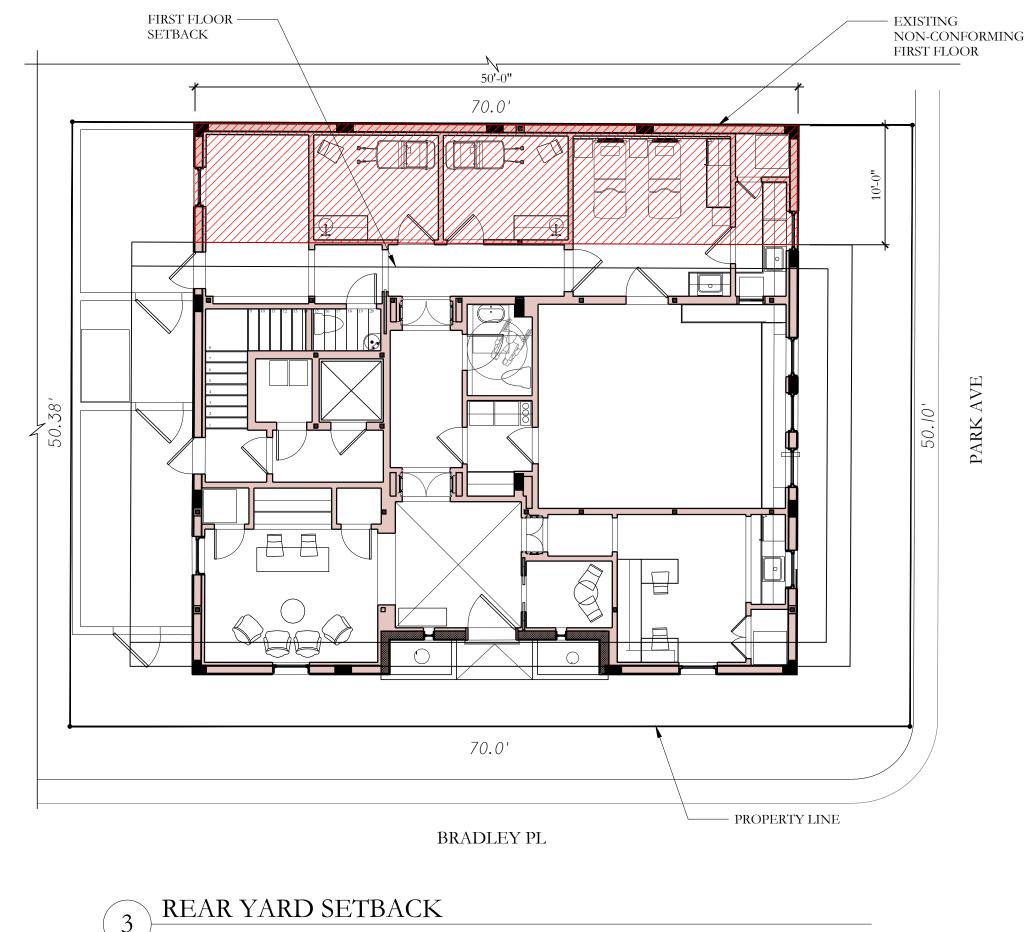

VARIANCE DIAGRAM

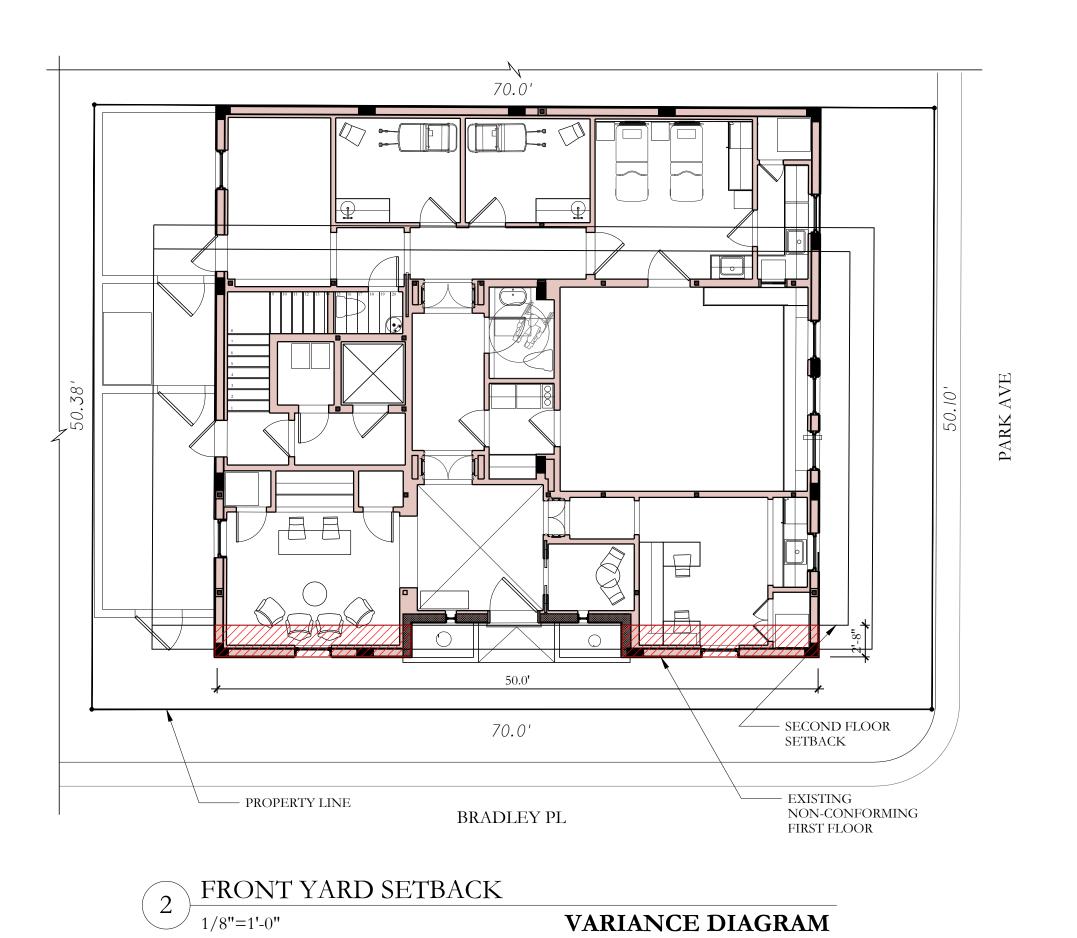


*REFER TO TRAFFIC CONCURRENCE REPORT FOR ADDITIONAL INFORMATION

PARKING DIAGRAM

1/8"=1'-0"

VARIANCE DIAGRAM

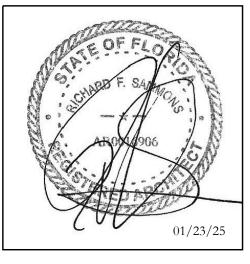

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VARIANCE DIAGRAMS

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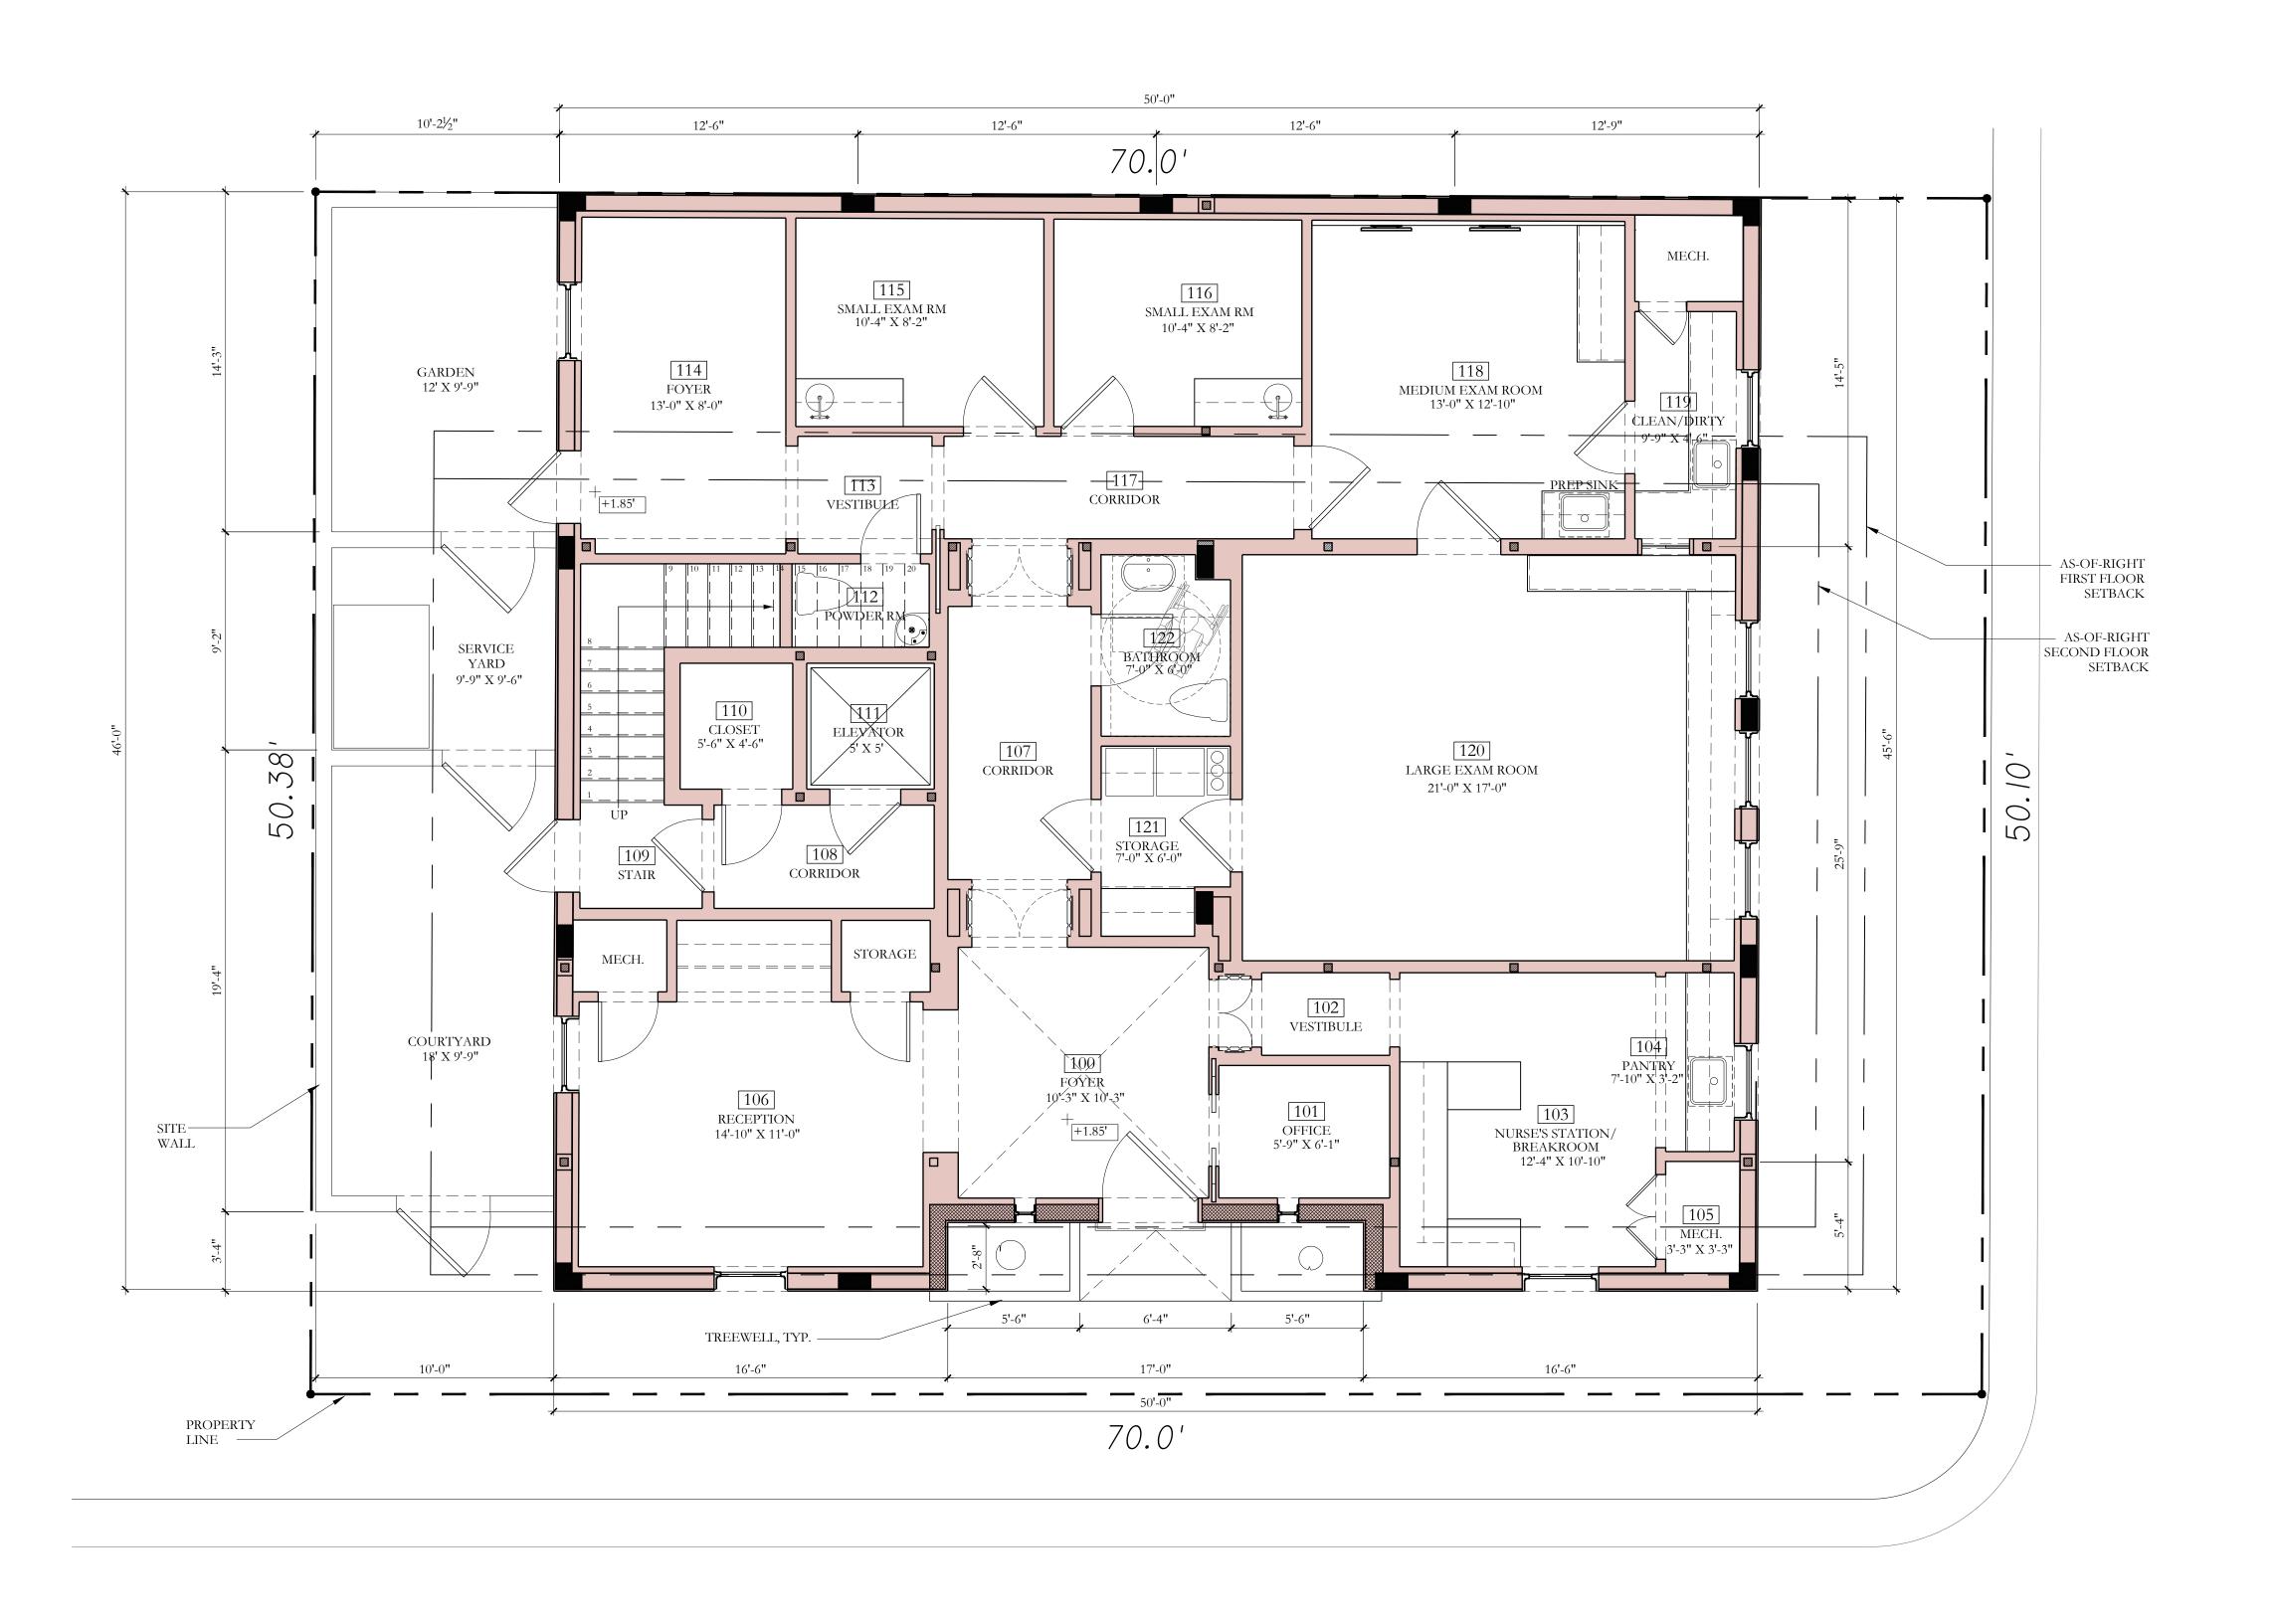
SHEET NO 10/9/2024 SCALE A-004AS NOTED MC, MRM

> FAIRFAX & SAMMONS ----- NEW YORK-PALM BEACH ---

FAIRFAX, SAMMONS ♦ PARTNERS, LLC. 214 BRAZILIAN AVENUE, PALM BEACH 33480 TELEPHONE (561) 805-8591

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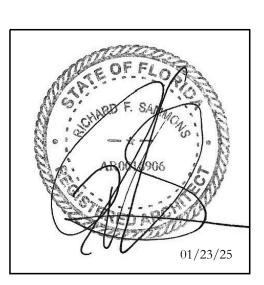
NOTE: ELEVATIONS REFERENCED TO NAVD SURVEY ELEVATIONS

LEGEND:

+_{+5.50'} EXISTING SPOT ELEVATION

+ PROPOSED SPOT ELEVATION ELEVATION

REFER TO LANDSCAPE ARCHITECTURE AND CIVIL ENGINEERING DRAWINGS FOR ADDITIONAL GRADING INFORMATION



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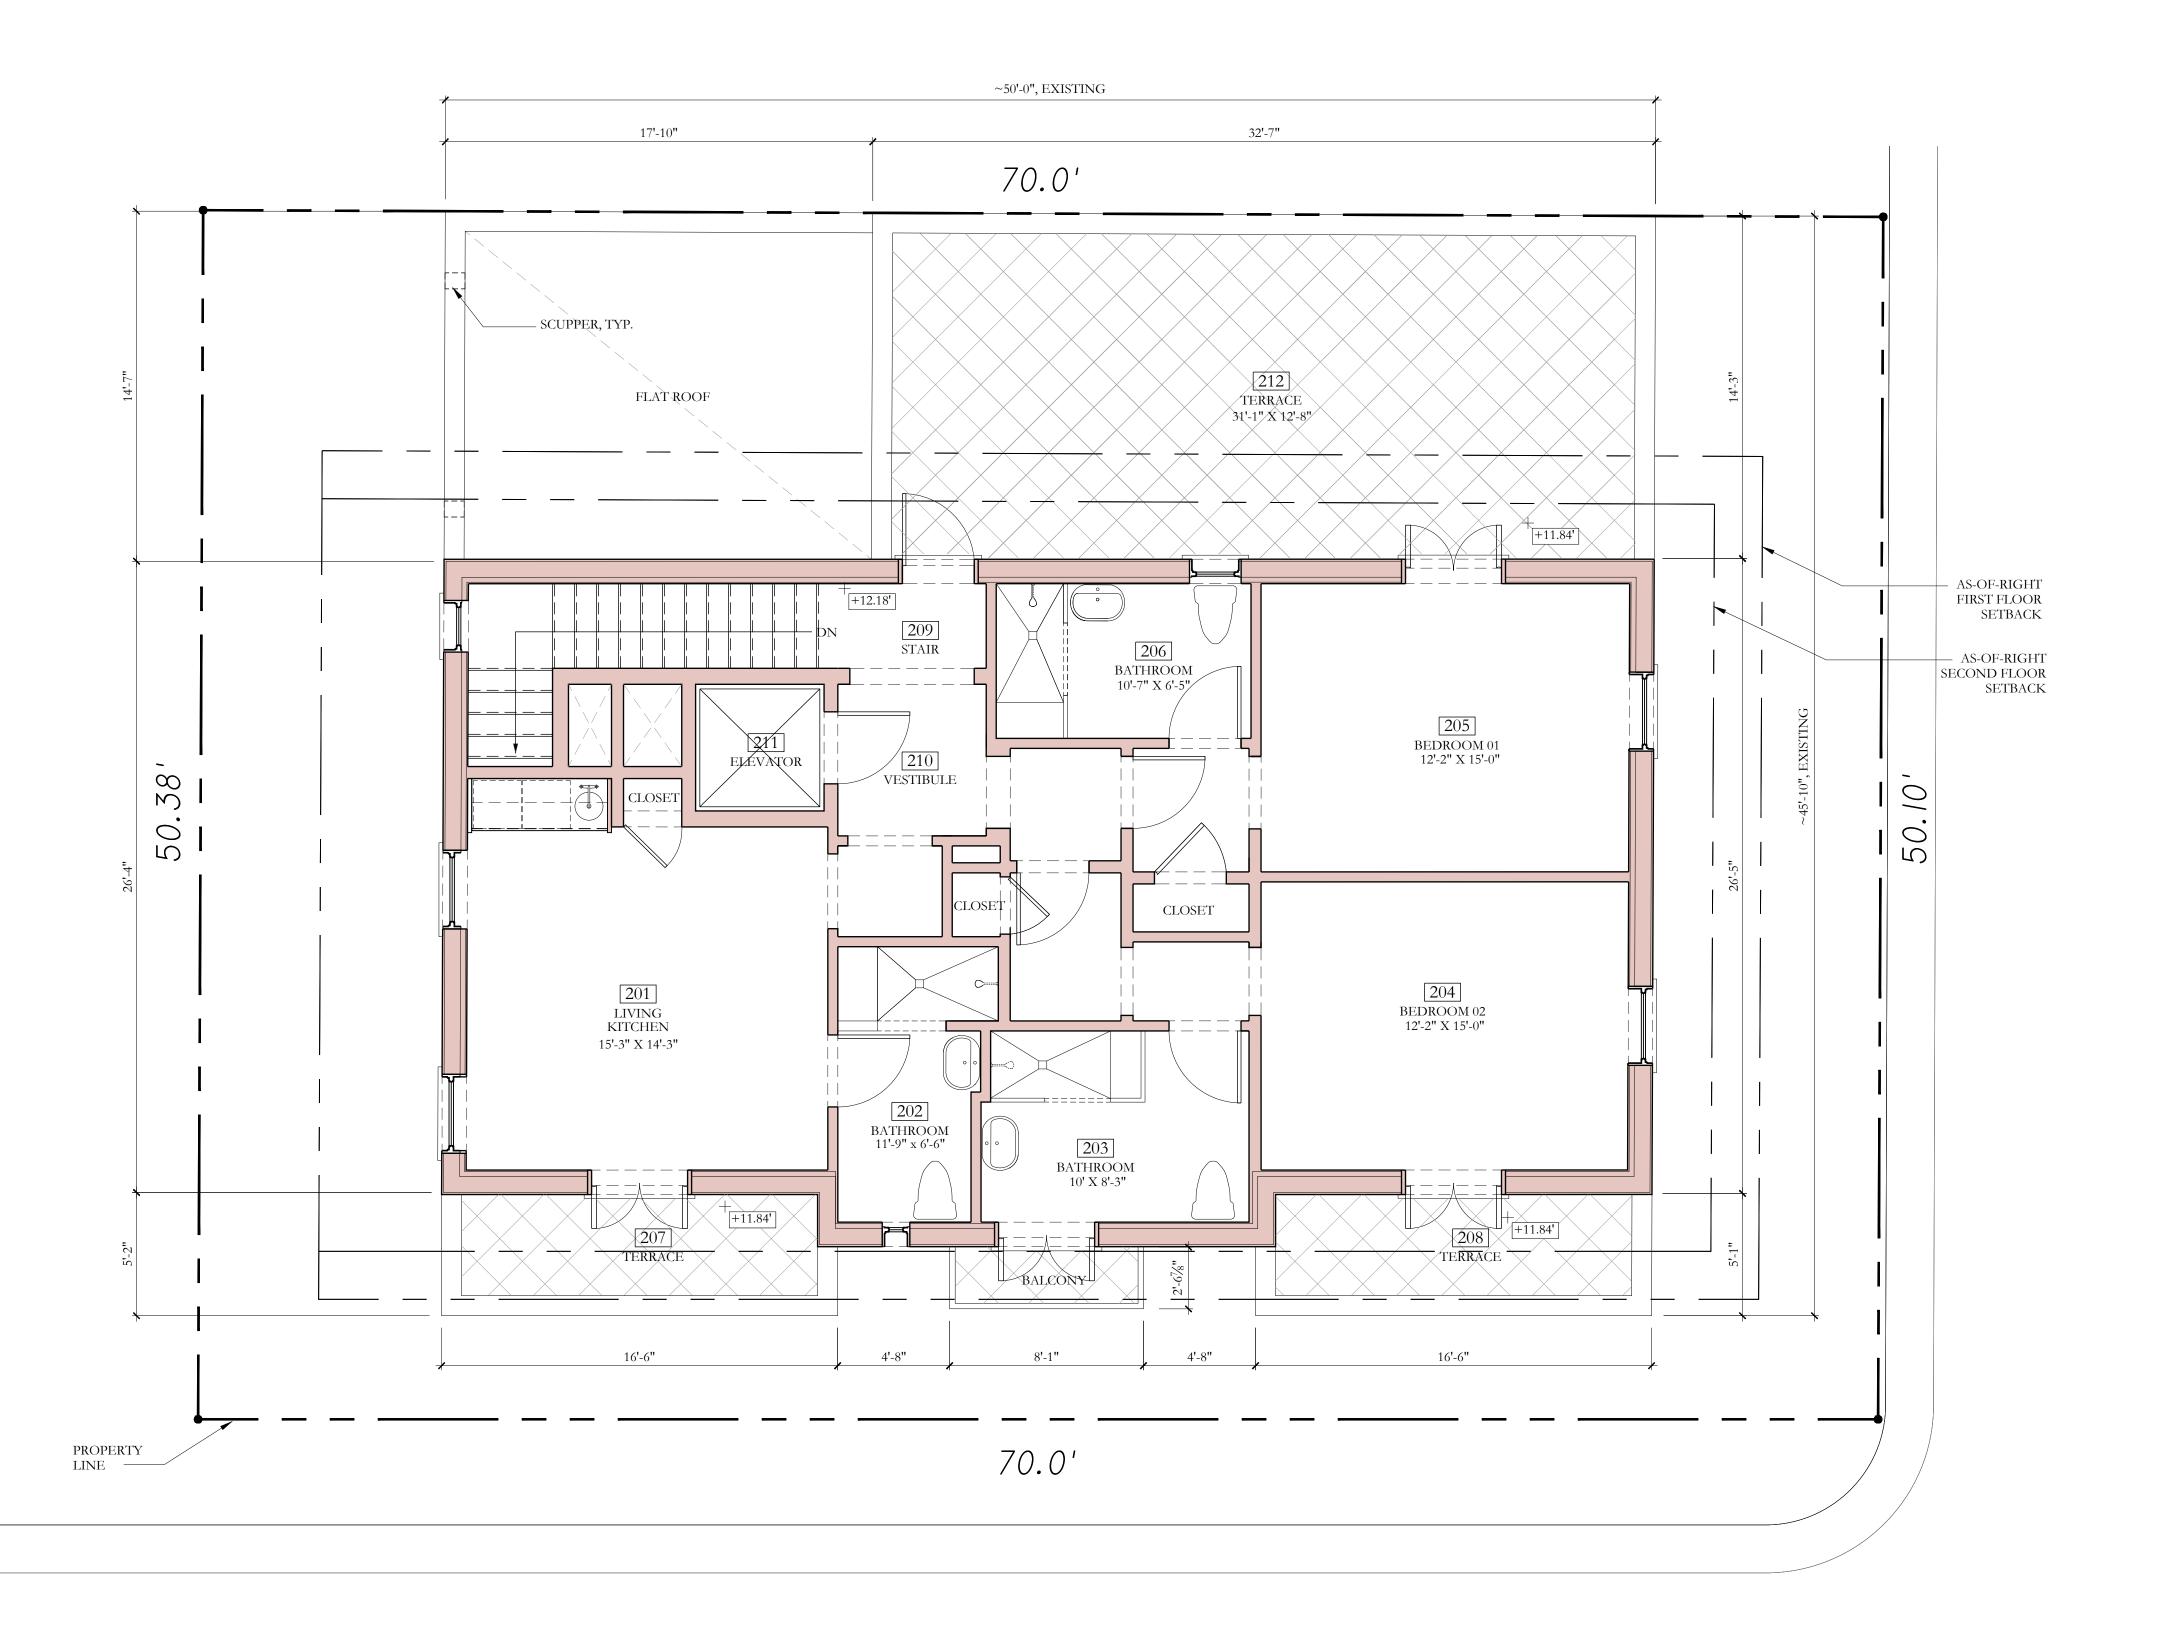
PROPOSED FIRST FLOOR PLAN

SHEET NO 9/30/2024 A-100 1/4"=1'-0" MC, MRM



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PROPOSED SECOND FLOOR PLAN 1/4"=1'-0"




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PROPOSED SPOT ELEVATION

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175 BRADLEY

PLACE PALM BEACH, FLORIDA 33480

SHEET TITLE

PROPOSED SECOND FLOOR PLAN

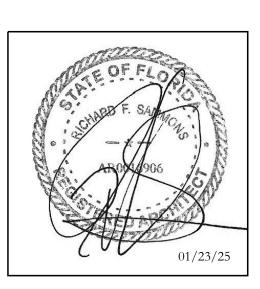DATE 9/30/2024 SCALE 1/4"=1'-0"

A-101 MC, MRM




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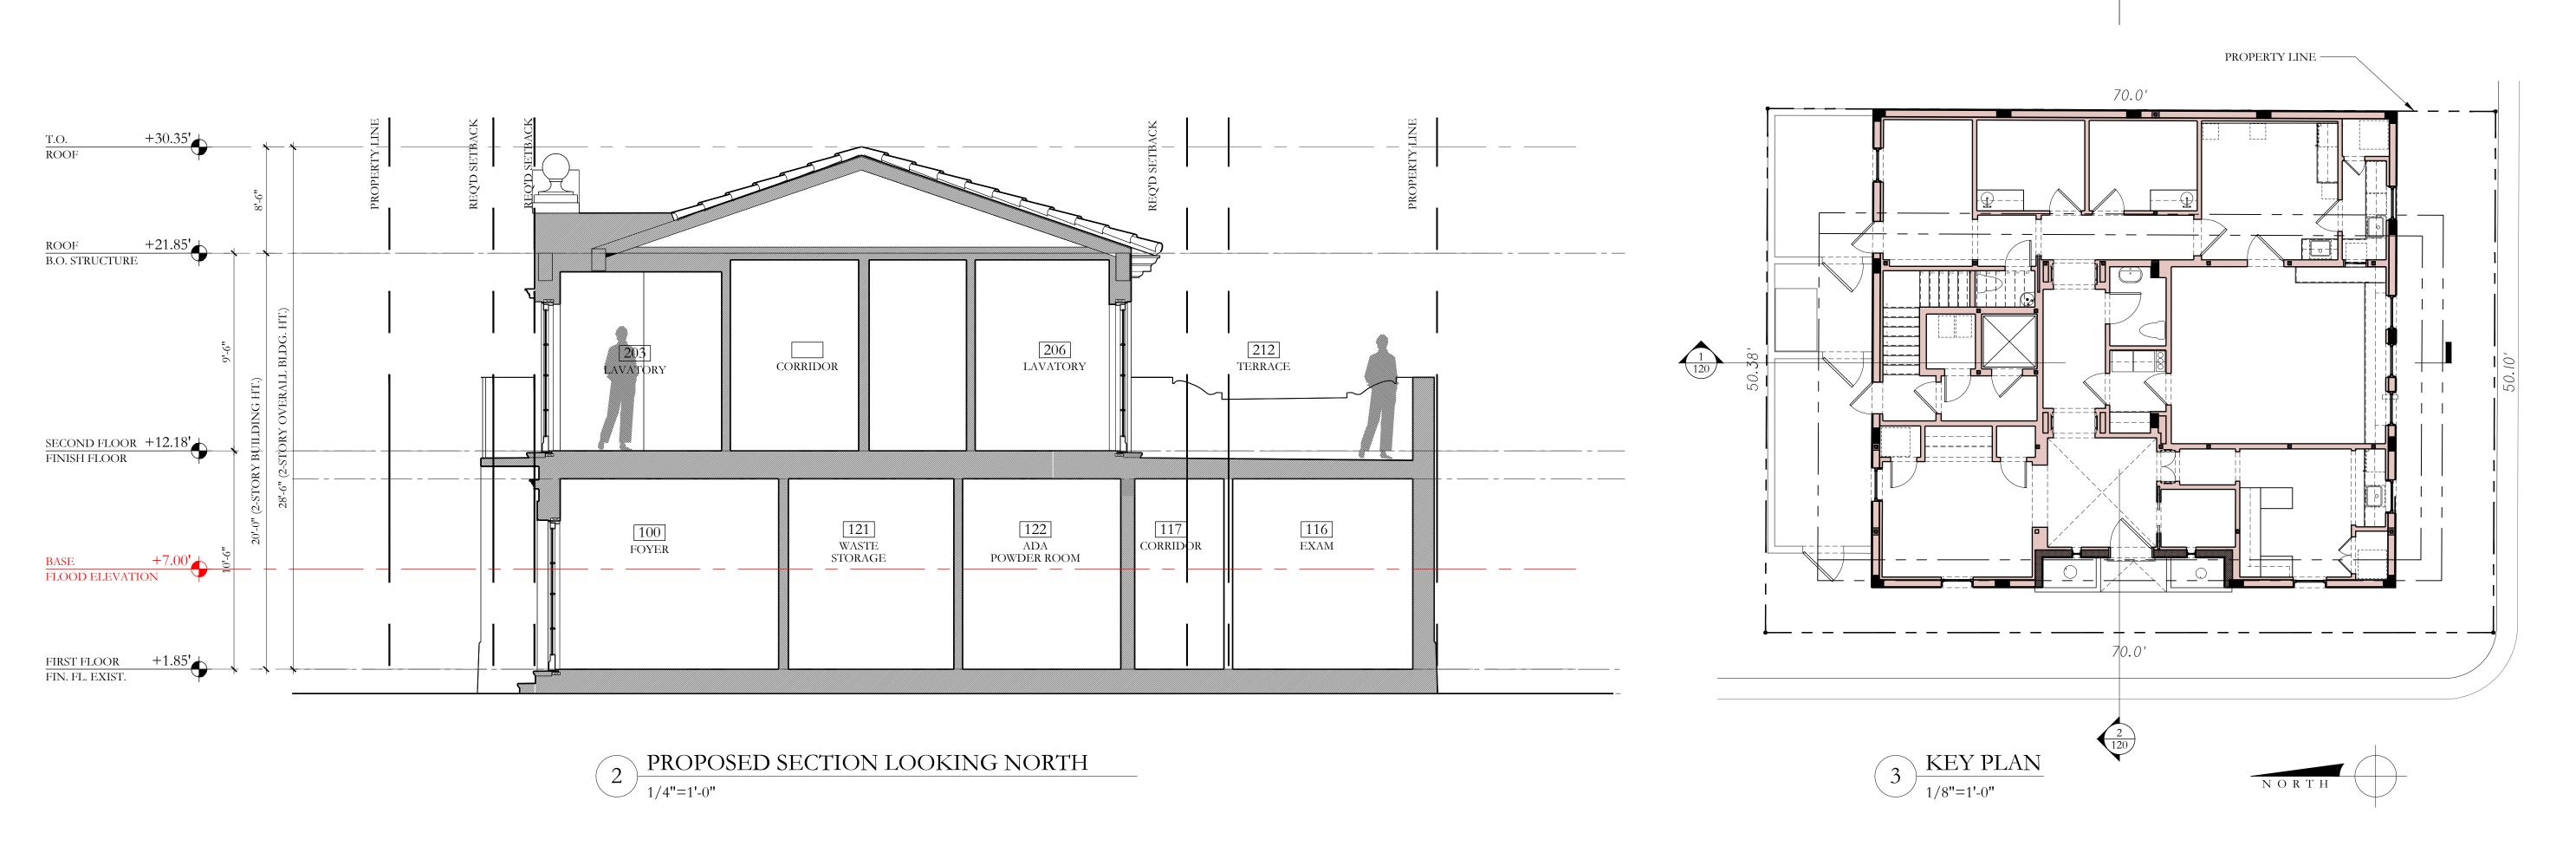







PROPOSED SECTION LOOKING EAST

1/4"=1'-0"

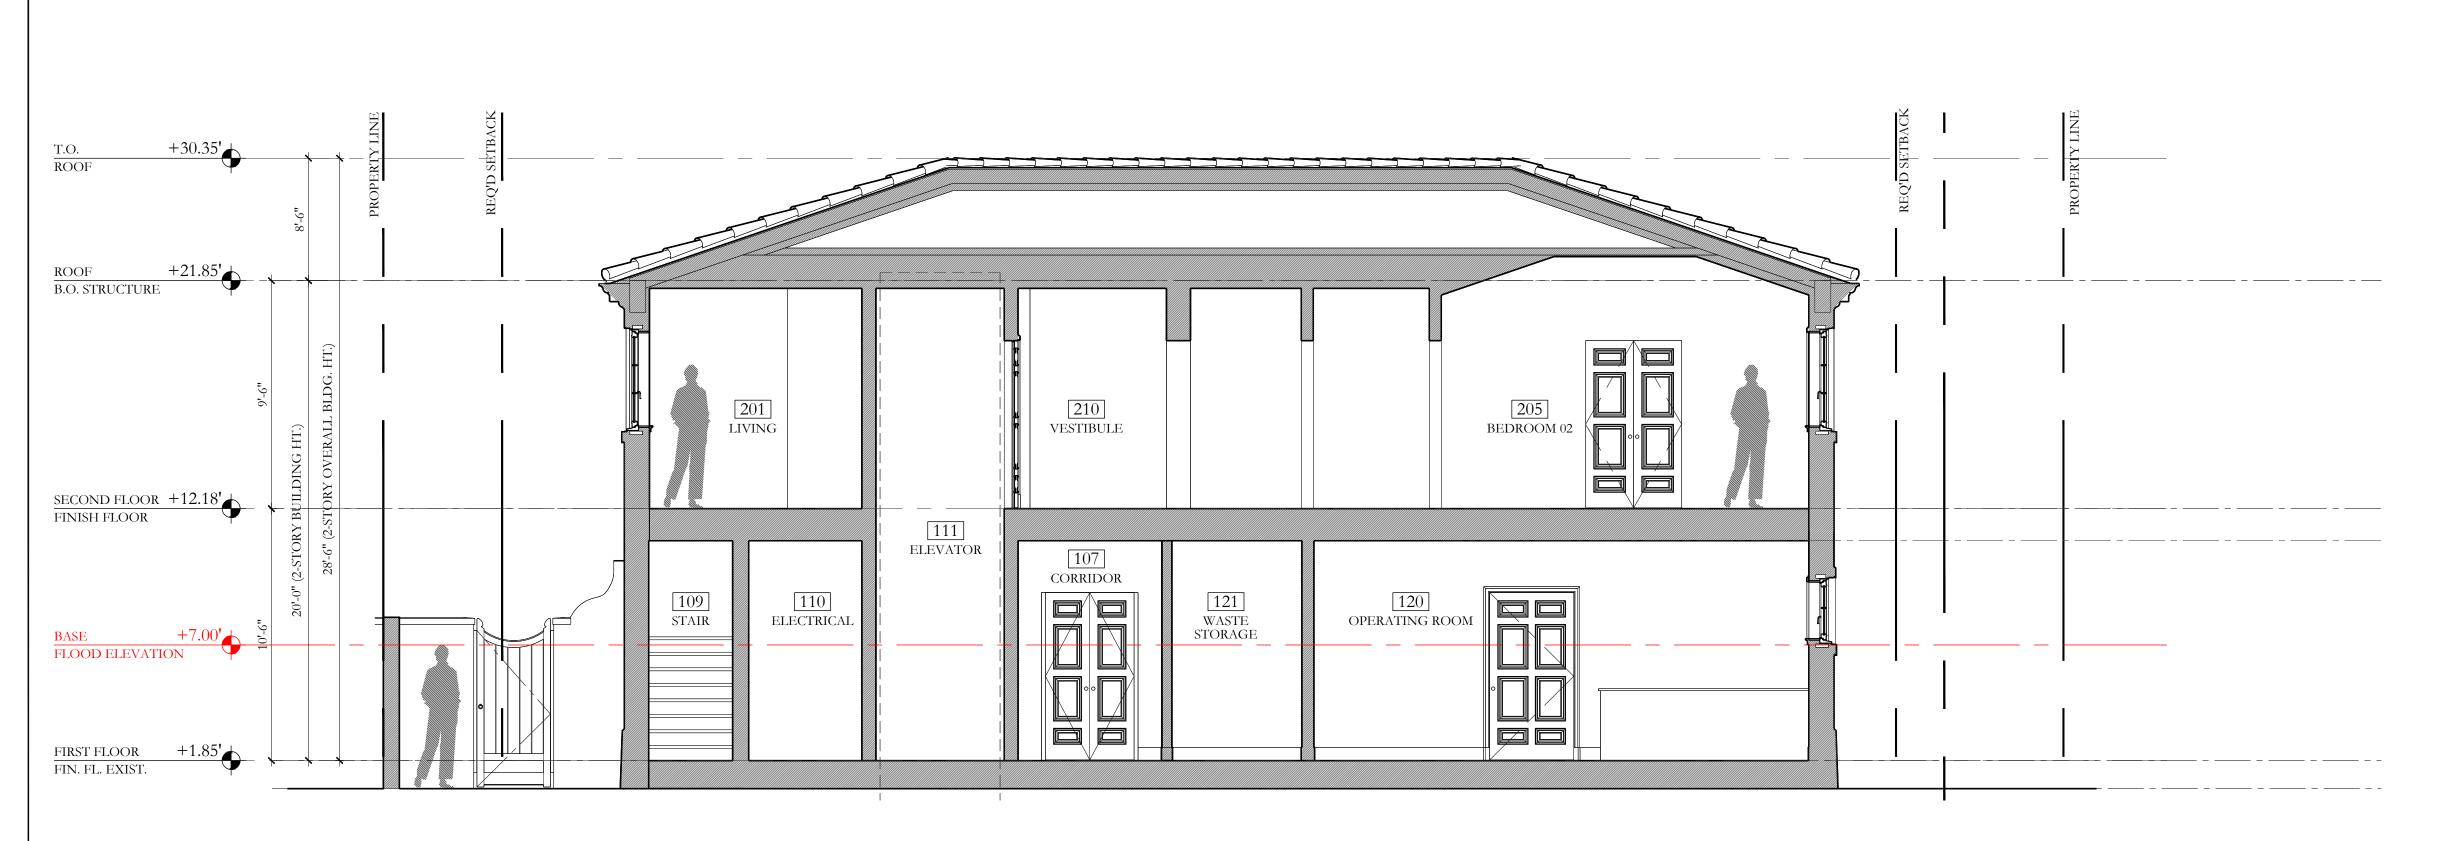

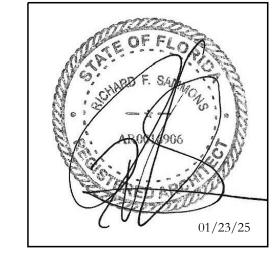

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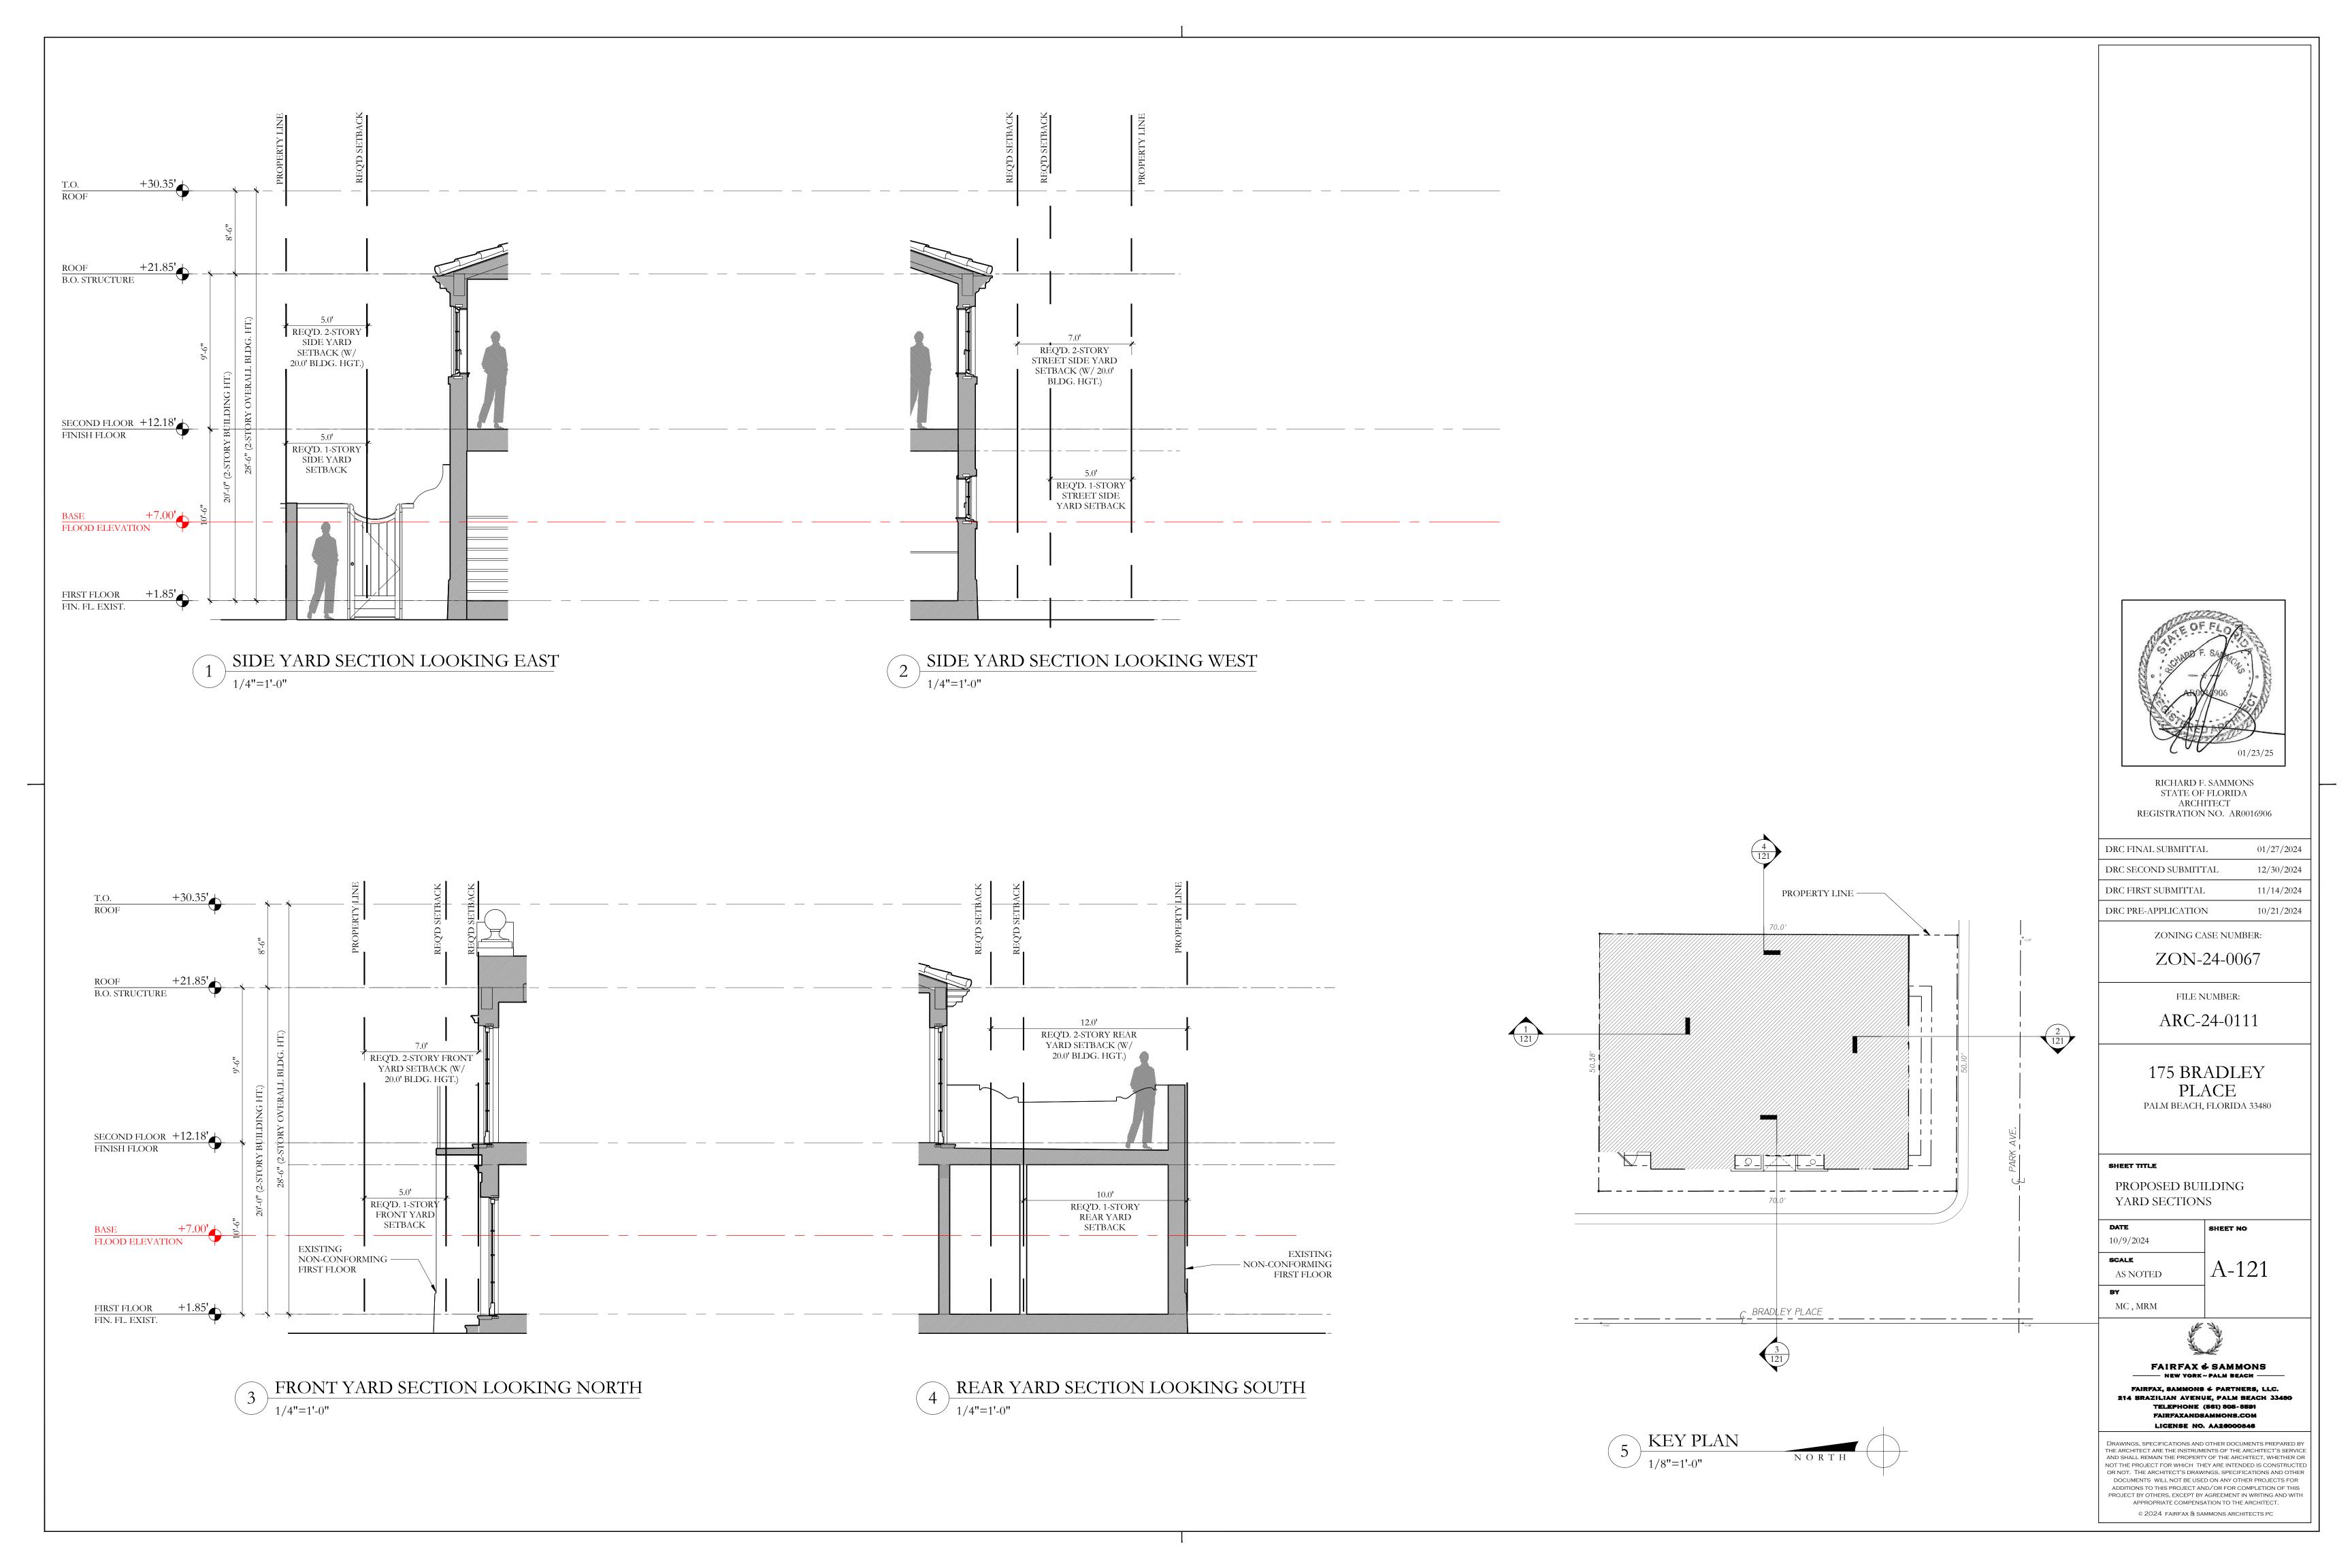
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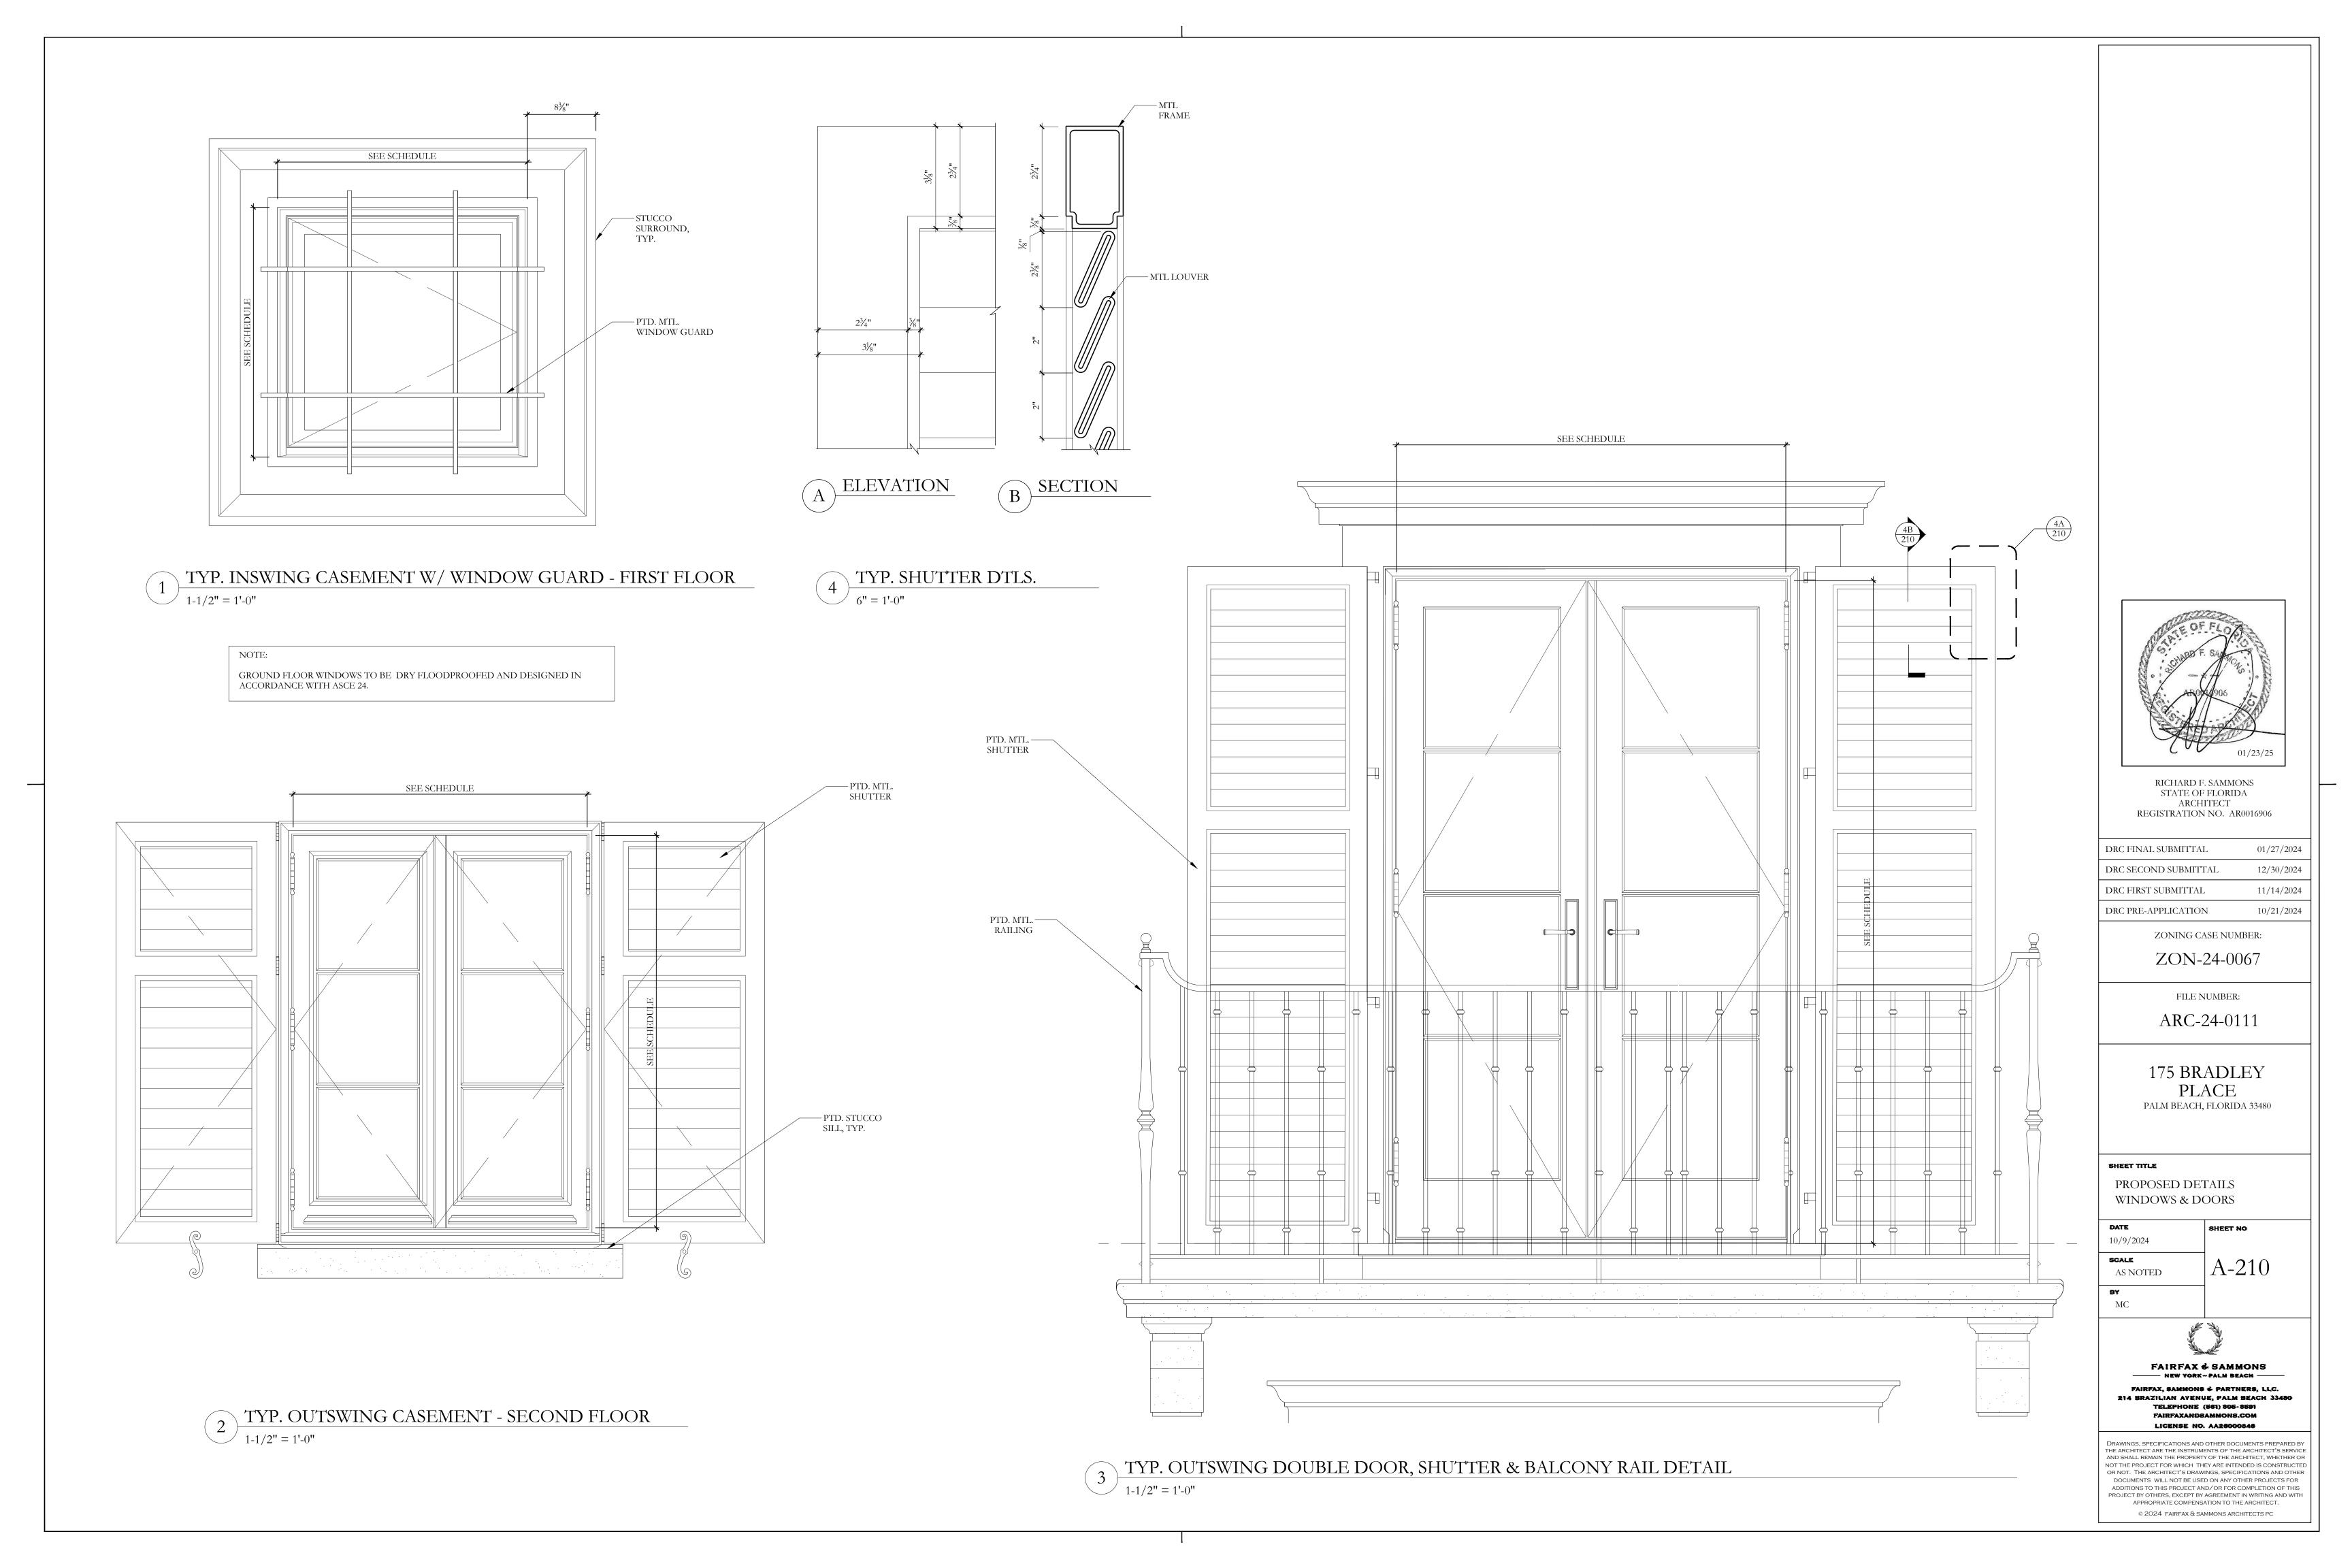
PROPOSED BUILDING SECTIONS & YARD SECTIONS


DATE 10/9/2024	SHEET NO
SCALE	- .
AS NOTED	A-120
BY	
MC , MRM	
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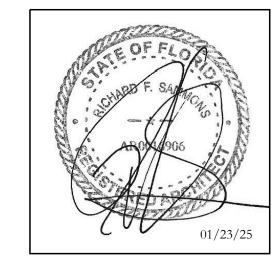
FAIRFAX & SAMMONS NEW YORK-PALM BEACH FAIRFAX, SAMMONS & PARTNERS, LLC.

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175 BRADLEY PLACE

PALM BEACH, FLORIDA 33480

PROPOSED DETAILS SITE WALLS & GATE

SHEET NO 10/9/2024 SCALE A-211 AS NOTED

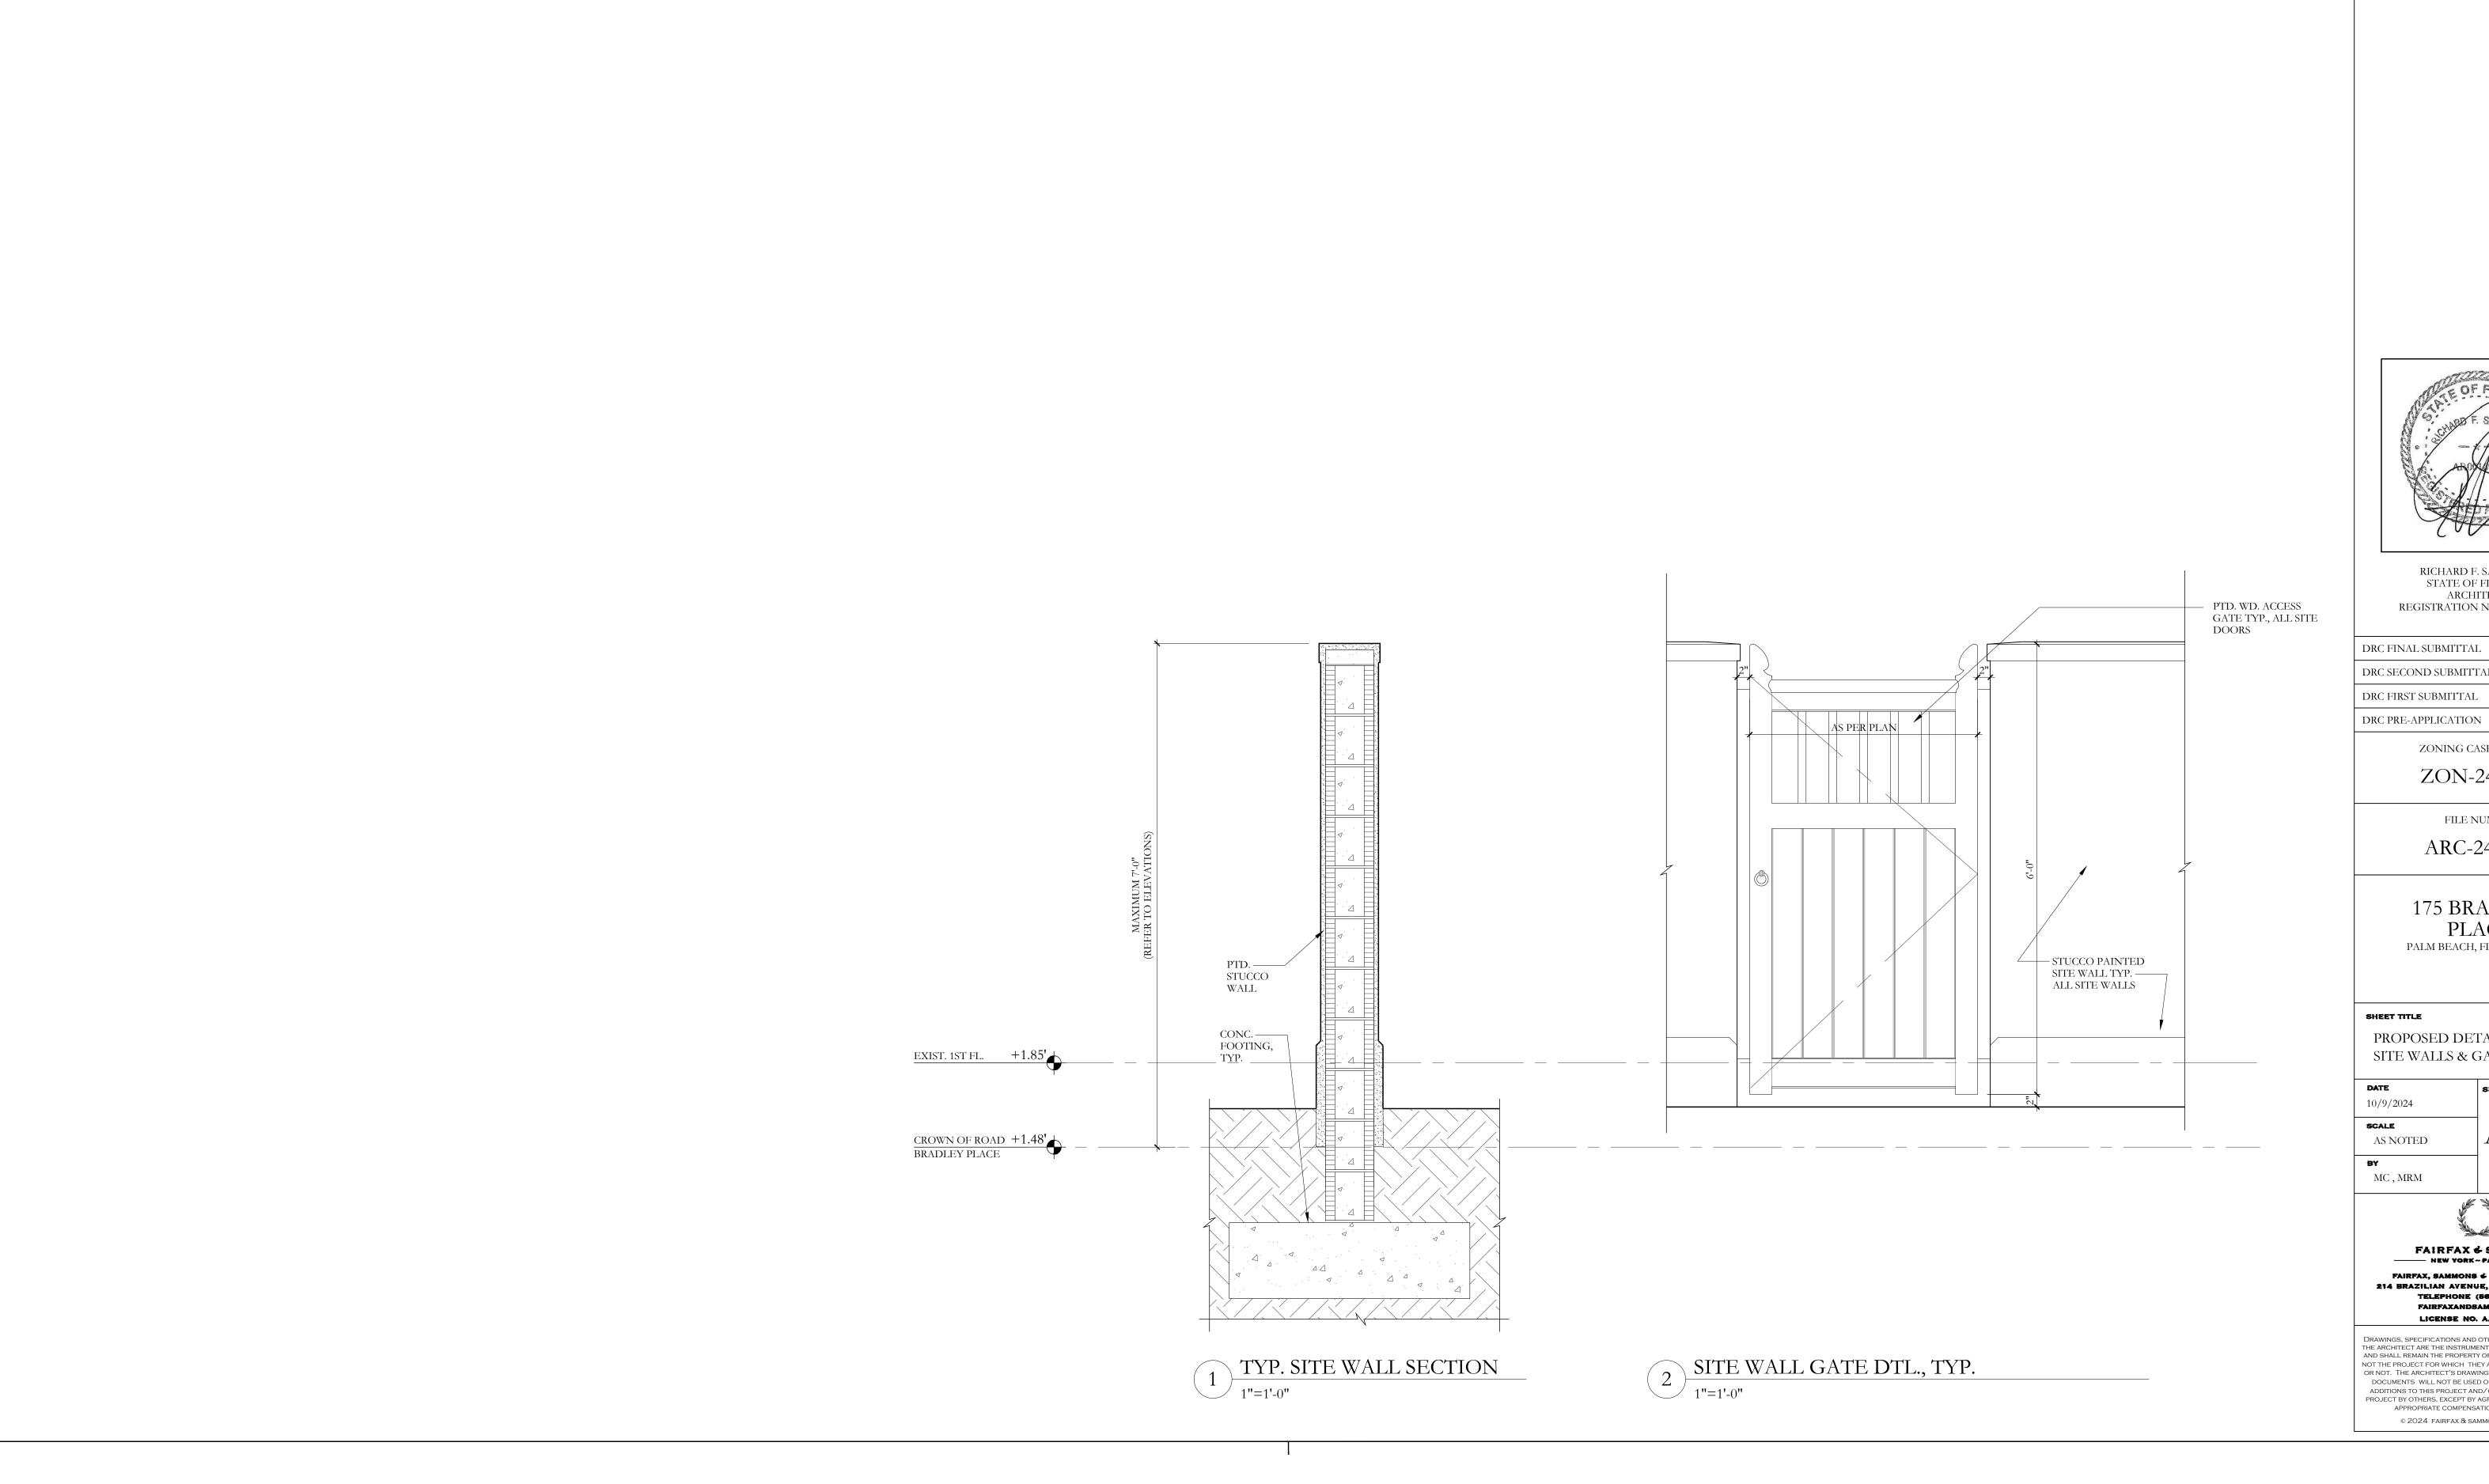MC, MRM

FAIRFAX & SAMMONS

----- NEW YORK-PALM BEACH FAIRFAX, SAMMONS ❖ PARTNERS, LLC.

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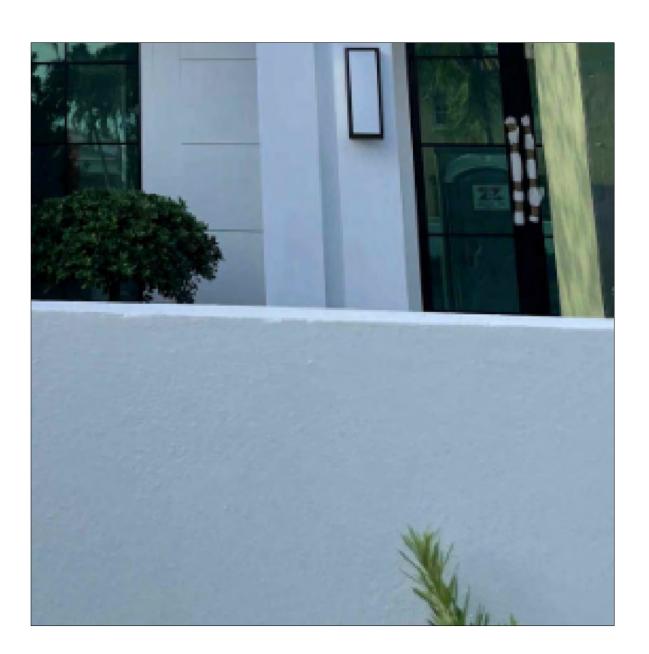


PAINTED STUCCO WALLS
FARROW & BALL - WIMBORNE WHITE 239



DOORS, WINDOWS & SHUTTERS

FARROW & BALL - OFF-BLACK NO. 57 - GLOSS, OR EQUIV.




SITE WALL(S)

PAINTED STUCCO - FARROW & BALL - POINTING



CORAL STONE PAVERS
COURTYARDS

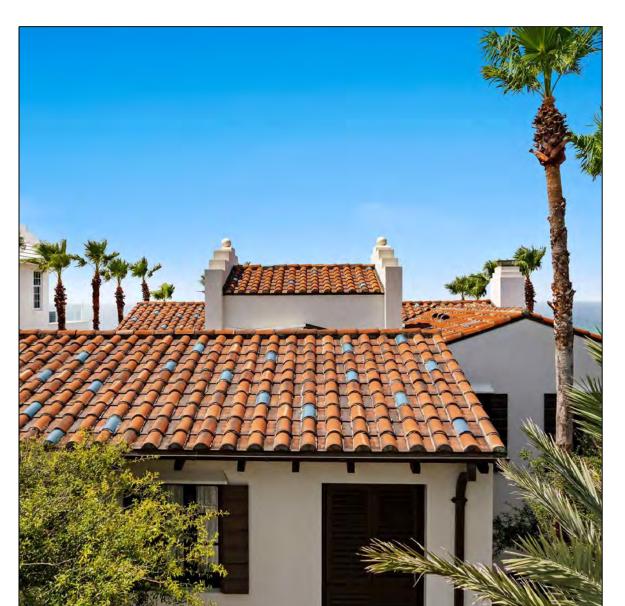

CLAY TILE ROOF
TYPICAL TERRA COTTA



METAL BALCONY RAIL

FARROW & BALL - OFF-BLACK NO. 57 - GLOSS, OR EQUIV.



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175 BRADLEY
PLACE
PALM BEACH, FLORIDA 33480

MATERIALS & COLORS

PALETTE

DATE SHEET NO

AS NOTED

BY

MC

A-220



FAIRFAX & SAMMONS

NEW YORK-PALM BEACH

FAIRFAX, SAMMONS & PARTNERS, LLC.

214 BRAZILIAN AVENUE, PALM BEACH 33480

TELEPHONE (561) 805-8591 FAIRFAXANDSAMMONS.COM LICENSE NO. AA26000846



PROPOSED PERSPECTIVE - NO LANDSCAPE

NTS



PROPOSED PERSPECTIVE - WITH LANDSCAPE

NTS




PROPOSED PERSPECTIVE - NO LANDSCAPE

NTS



4 PROPOSED PERSPECTIVE - WITH LANDSCAPE NTS

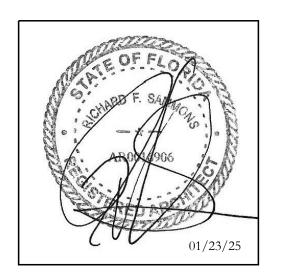

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175 BRADLEY PLACE PALM BEACH, FLORIDA 33480

PROPOSED RENDERS

10/9/2024 AS NOTED

MC, MRM

FAIRFAX & SAMMONS FAIRFAX, SAMMONS ≠ PARTNERS, LLC. 214 BRAZILIAN AVENUE, PALM BEACH 33480


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175 BRADLEY
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PALM BEACH, FLORIDA 33480

SHEET TITLE

PROPOSED RENDERS

DATE
10/9/2024

SCALE
AS NOTED

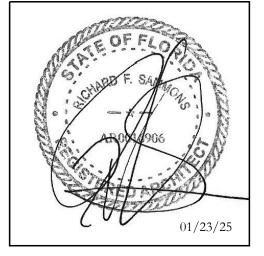
SHEET NO

V-2

BY MC, MRM



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*NOTE: SEE SEPARATE CSP SHEET IN LANDSCAPE DRAWINGS FOR ADDITIONAL INFORMATION

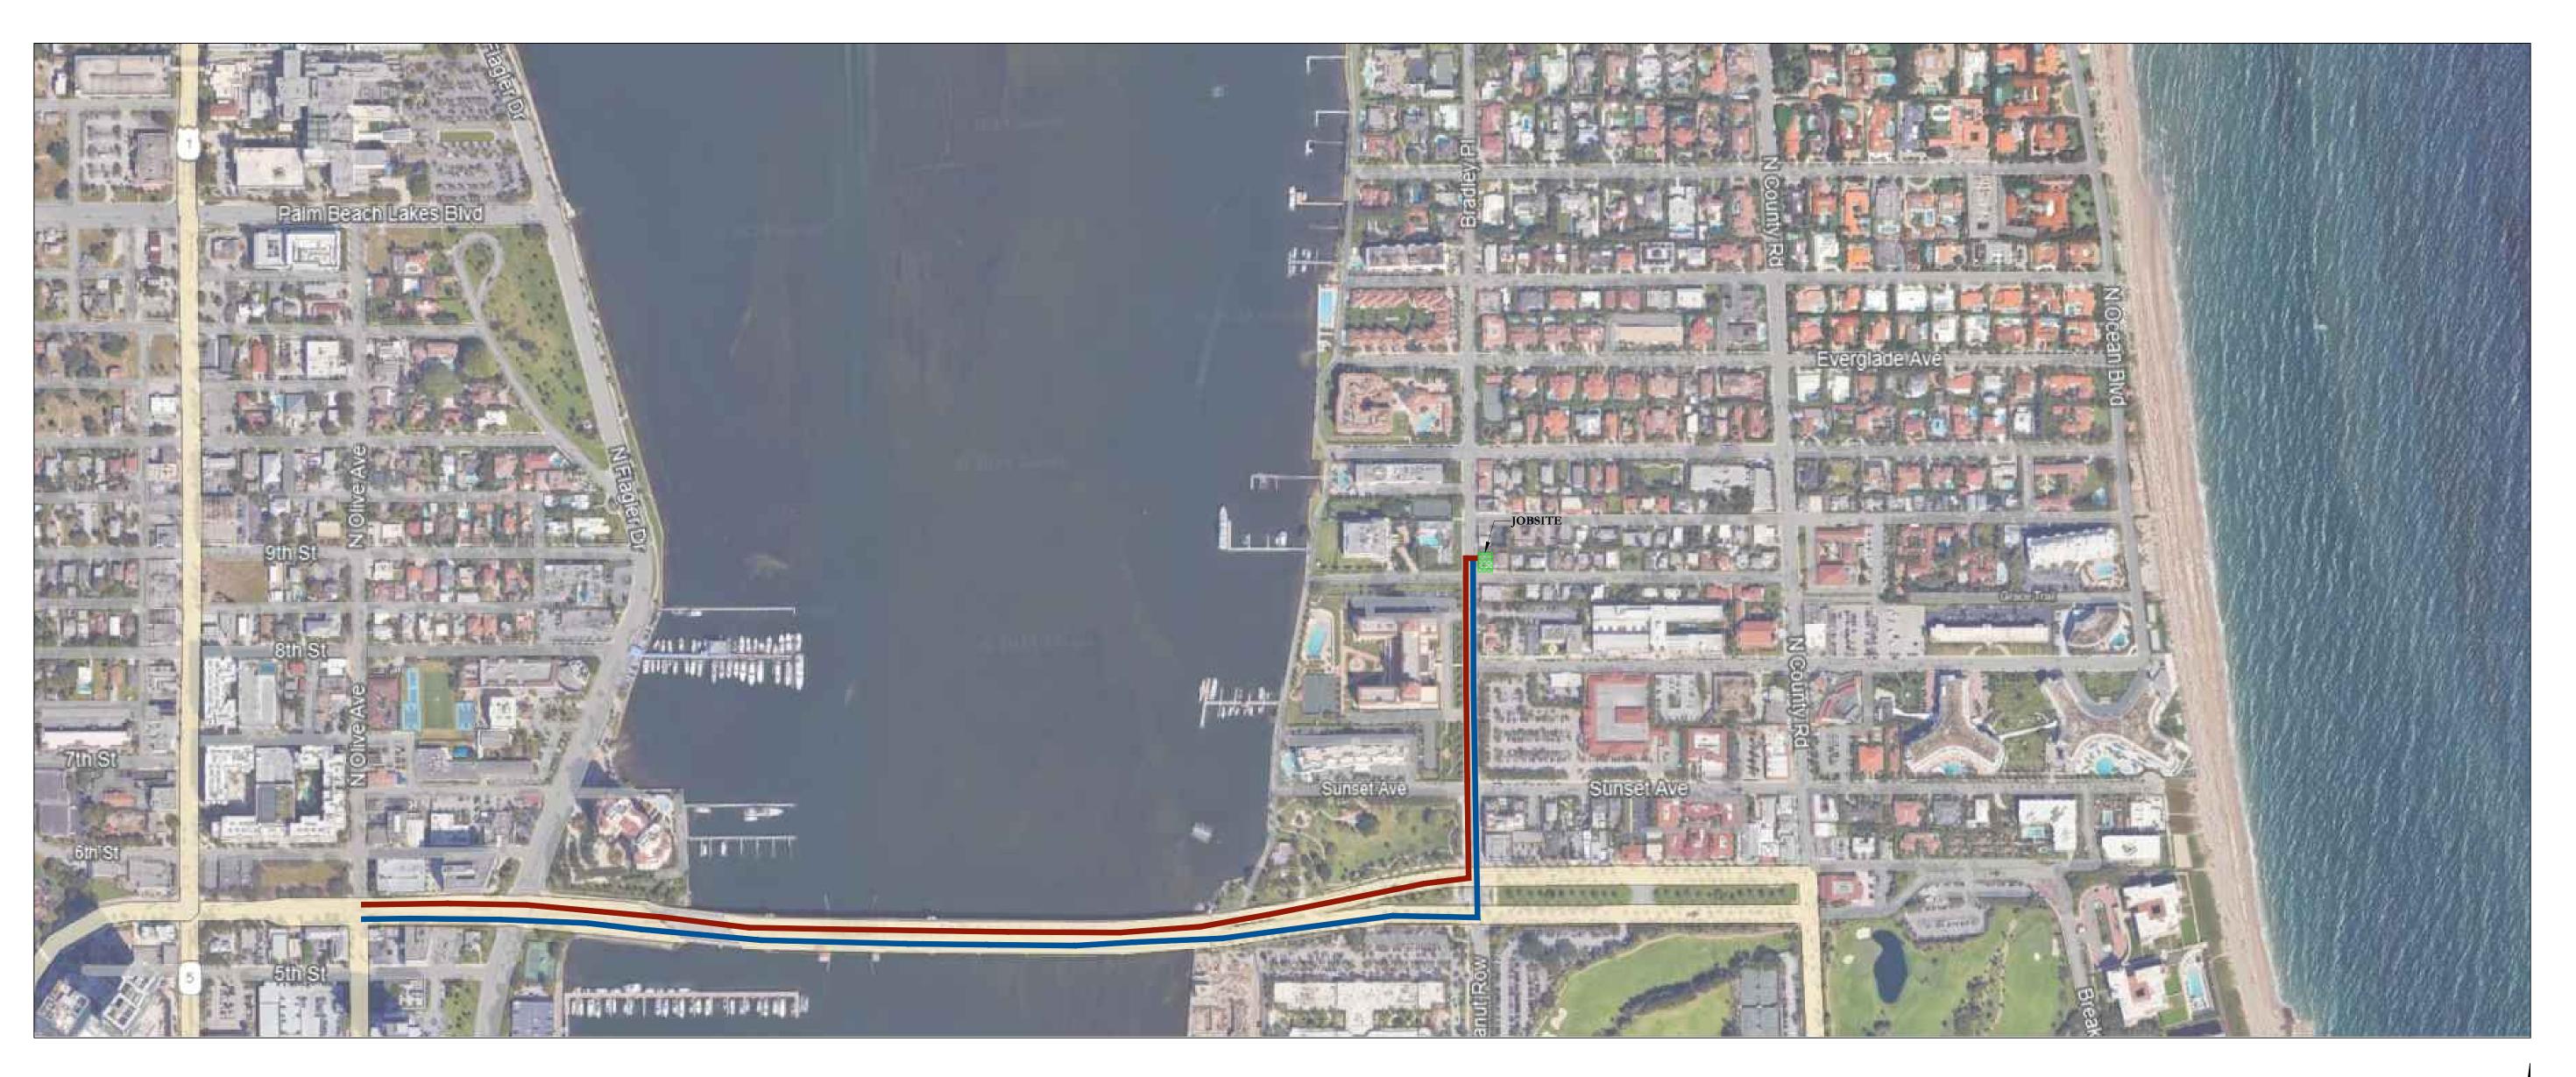CONSTRUCTION SCREENING NOTES:

HEIGHTS OF PERIMETER 90% OPAQUE SCREENING NEEDS TO BE SUFFICIENT TO SHIELD ADJACENT RESIDENTS FROM CONSTRUCTION, INCLUDING ONES ACROSS THE STREET.
(SUGGESTIVE TO ONE'S LINE OF SIGHT AND CANNOT OBSTRUCT SAFE SIGHT TRIANGLE ACCESS.

PROPOSED INGRESS TRUCK ROUTE

PROPOSED EGRESS TRUCK ROUTE

MAXIMUM VEHICLE SIZE ABLE TO BE ACCOMMODATED ON SITE:

FULL SEMI-TRUCK W/53-FOOT TRAILER (I.E. FULL RANGE OF TRUCK SIZES)

ALL DURATIONS ARE APPROXIMATE BASED ON PROJECTS OF SIMILAR SCALE AND SCOPE

REVISED SCHEDULE TO BE PROVIDED IN FINAL SUBMISSION

ESTIMATE OF NUMBER OF TRUCKS VISITING JOBSITE OVER LIFE OF PROJECT:

5 WORKING DAYS/WEEK (AVG.)

x 50 WORK WEEKS/YEAR (AVG.)x 1 YEAR (12-MO.) SCHEDULE (PROPOSED)

= 250 TOTAL WORK DAYS (PROPOSED)

7 TRUCKS/DAY (AVG.)

2 TRIPS/DAY (INGRESS & EGRESS)

14 TRUCK TRIPS/DAY (AVG.)

250 TOTAL WORK DAYS (PROP.)


x 14 TRUCK TRIPS/DAY (AVG.) = 3,500 TOTAL TRUCK TRIPS OVER LIFE OF PROJECT (EST.)

ROUGH SCHEDULE OF CONSTRUCTION W/MAJOR CONSTRUCTION BENCHMARKS:

TASK:	DURATION (IN MONTHS):
SITE PREPARATION:	1
FOUNDATION:	1
BLOCK DELIVERIES & CONCRETE POURS:	2
ROOF TRUSS DELIVERIES & TRUSS SETTING:	1
WINDOW/DOOR DELIVERIES & INSTALLATION:	0.5
DRY-IN:	0.5
INTERIOR FRAMING:	1
ROUGH-IN:	1
DRY WALL:	1
FINISHES:	1
LANDSCAPE/HARDSCAPE INSTALLATION:	1
FINAL INSPECTIONS:	1
TOTAL PROPOSED CONSTRUCTION TIME	

12 mos.

(FOLLOWING ISSUANCE OF BUILDING PERMIT):

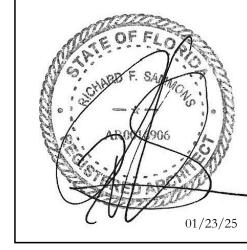

RICHARD F. SAMMONS
STATE OF FLORIDA
ARCHITECT

DRC FINAL SUBMITTAL	01/27/2024
DRC SECOND SUBMITTAL	12/30/2024
DRC FIRST SUBMITTAL	11/14/2024
DRC PRE-APPLICATION	10/21/2024

ZONING CASE NUMBER:

ZON-24-0067

FILE NUMBER:

ARC-24-0111

175 BRADLEY PLACE

PALM BEACH, FLORIDA 33480

SHEET TITLE

TRUCK LOGSTICS PLAN & SCHEDULE OF CONSTRUCTION

DATE	SHEET NO
10/9/2024	
SCALE	
AS NOTED	1-1
BY	
MC, MRM	




FAIRFAX, SAMMONS & PARTNERS, LLC.

214 BRAZILIAN AVENUE, PALM BEACH 33480

TELEPHONE (561) 805-8691

FAIRFAXANDSAMMONS.COM

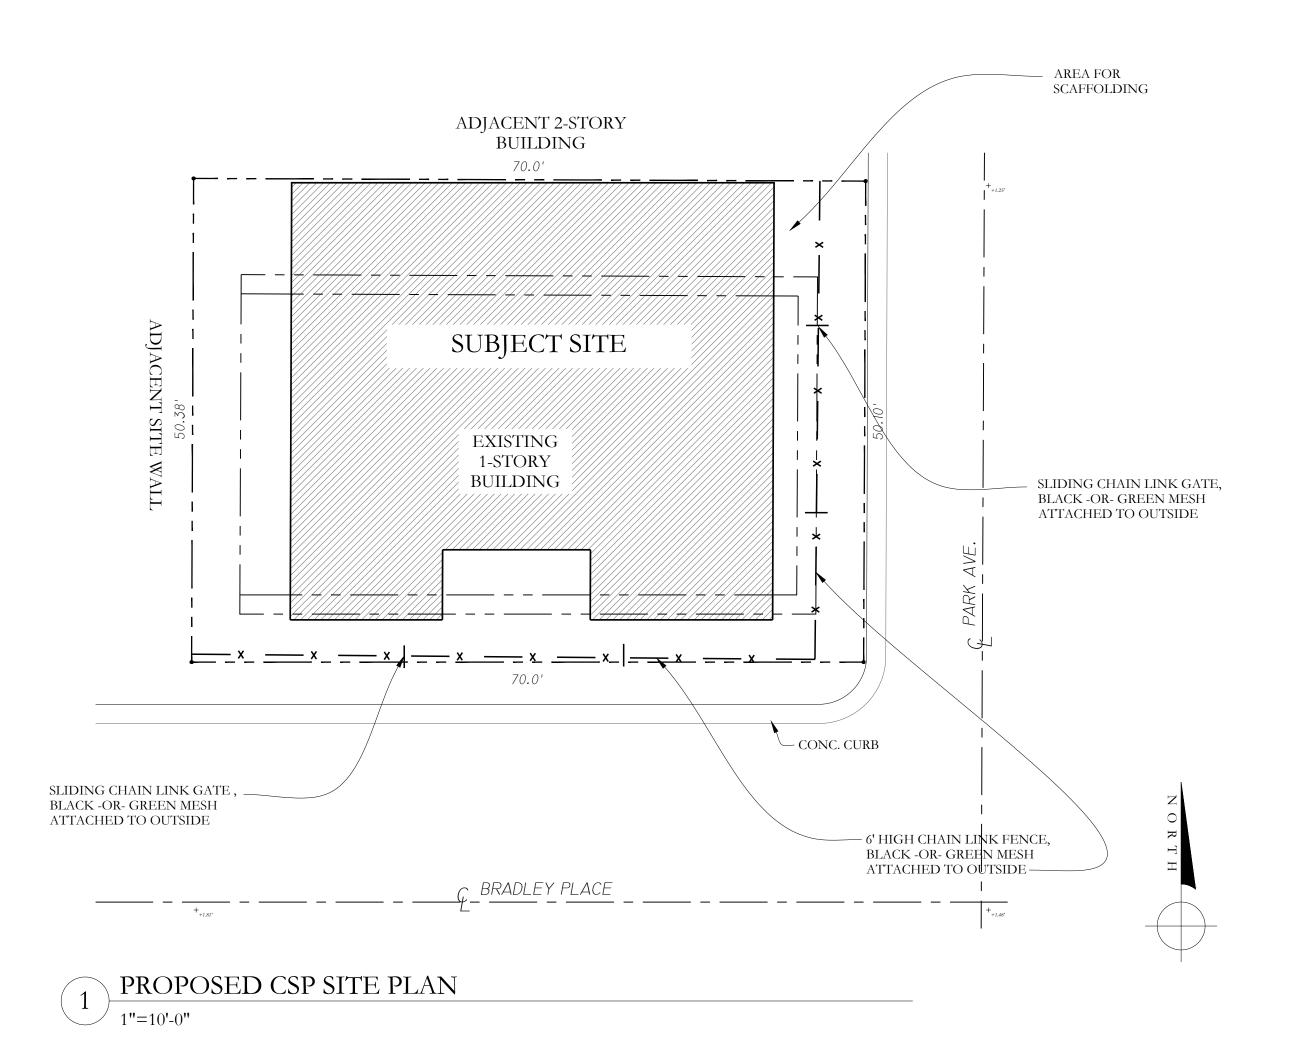



RICHARD F. SAMMONS STATE OF FLORIDA ARCHITECT REGISTRATION NO. AR001690

DRC FINAL SUBMITTAL	01/27/2024
DRC SECOND SUBMITTAL	12/30/2024
DRC FIRST SUBMITTAL	11/14/2024
DRC PRE-APPLICATION	10/21/2024

ZONING CASE NUMBER:

ZON-24-0067

FILE NUMBER:

ARC-24-0111

175 BRADLEY

PLACE PALM BEACH, FLORIDA 33480

SHEET TITLE

CONSTRUCTION SCREENING PLAN

SHEET NO CSP-1 1"=10'-0" MC

FAIRFAX & SAMMONS ----- NEW YORK-PALM BEACH

FAIRFAX, SAMMONS ♦ PARTNERS, LLC. 214 BRAZILIAN AVENUE, PALM BEACH 33480 TELEPHONE (561) 805-8591 FAIRFAXANDSAMMONS.COM LICENSE NO. AA26000846

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NOTES:


1. CONSTRUCTION SCREENING NEEDS TO ACCOMMODATE THE WORK ON THE SECOND FLOOR AND SHIELD ACTIVITY FROM VIEW. THE HEIGHT OF PERIMETER 90% OPAQUE SCREENING NEEDS TO BE SUFFICIENT TO SHIELD ADJACENT RESIDENTS FROM CONSTRUCTION, INCLUDING ONES ACROSS THE STREET.


2. SUGGESTED HEIGHTS 6- TO 8-FOOT FOR ONE-STORY, 16- TO 18-FOOT FOR TWO-STORY

3. HEIGHTS ARE SUBJECTIVE TO ONE'S LINE OF SIGHT AND CANNOT

BE WITHIN A SAFE SIGHT TRIANGLE.

4. CONTRACTORS TO INSTALL SCAFFOLDING TO MEET THIS REQUIREMENT.

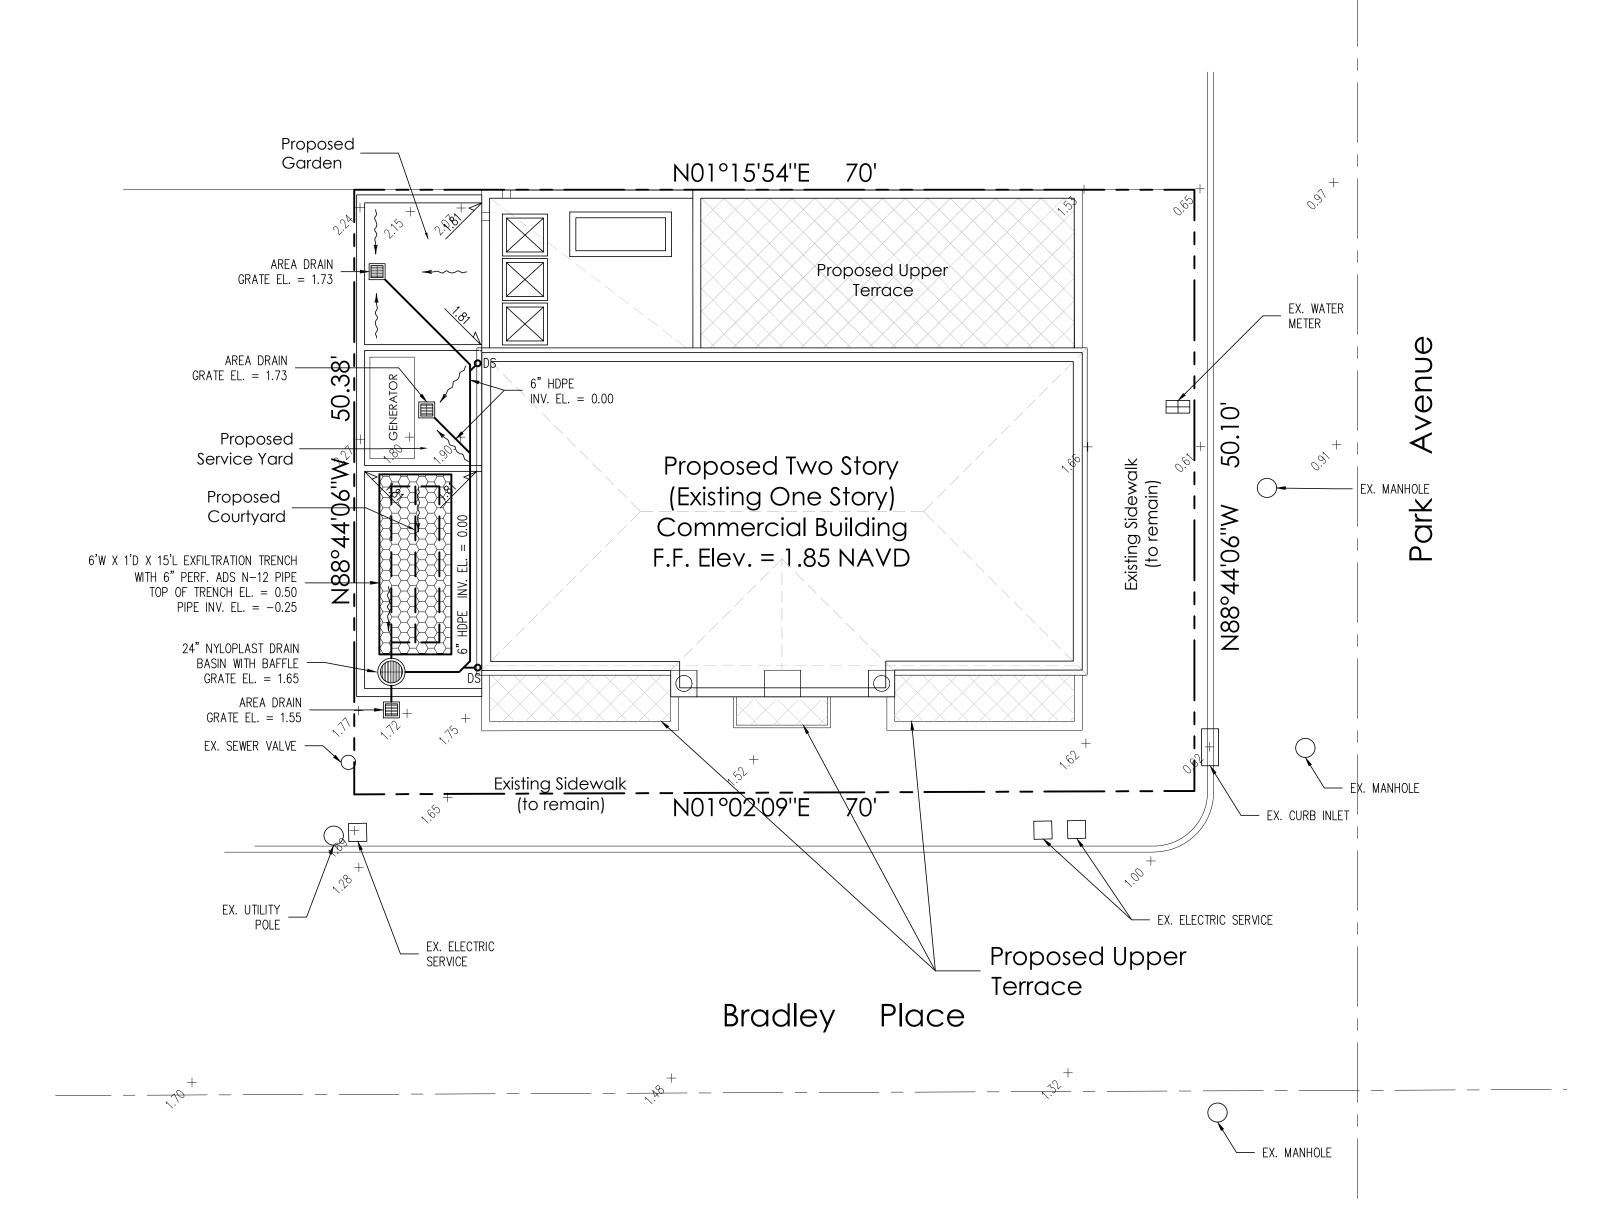

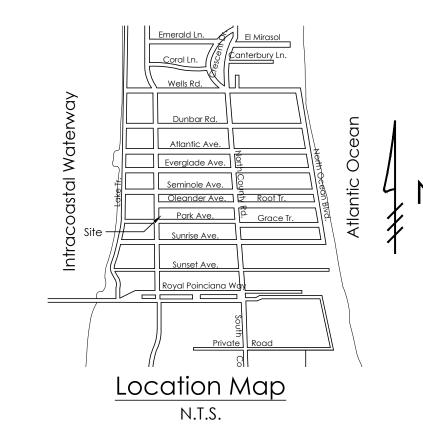

Legend


EXISTING ELEVATION PER GT SURVEYOR SERVICES (NAVD-88)

---7.00--- PROPOSED ELEVATION CONTOUR (NAVD-88)

FLOW DIRECTION

EXFILTRATION TRENCH

24" NYLOPLAST DRAIN BASIN WITH BAFFLE

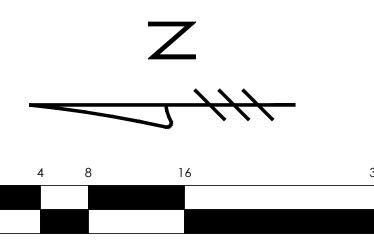

PROPOSED ELEVATION (NAVD-88)

AREA DRAIN

Scale: 1/8" = 1'-0"

STORMWATER RETENTION CALCULATIONS

A. <u>SITE INFORMATION</u>

Total Property Area = 3,534 sq.ft.

Drainage Area Impervious Surface = 3,122 sq.ft.

Drainage Area Pervious Surface = 412 sq.ft.

B. <u>ESTIMATED STORMWATER RETENTION VOLUME</u>

The retention volume is estimated using the Rational Method (Q=CiA)

C = 1.0 (impervious surface) C = 0.2 (pervious surface)

Notes:

1) Exfiltration trenches and storm piping to be protected

2) Roof drain downspouts are to be connected to the

3) Exfiltration trench design uses an assumed value of

4) Contractor shall mill and overlay all roadway cuts a

entire width of each affected lane.

prior to installation of sod.

proposed drainage system. Contractor to provide

engineer with downspout locations prior to installation

hydraulic conductivity. Client may obtain a site specific

test for hydraulic conductivity prior to exfiltration trench

minimum of 50 ft. on either side of the excavation the

5) Contractor is responsible for installing and maintaining

erosion control measures during construction.

6) Video inspection of storm drainage system required

from roots with a root barrier.

of drainage system.

installation.

i = 2 in/hr

Impervious Surface Runoff Volume: $1.0 \times 2 \text{ in/hr} \times 3,122 \text{ sq.ft.} \times 1 \text{ ft./12 in.} = 520 \text{ cu.ft.}$

Pervious Runoff Volume:

 $0.2 \times 2 \text{ in/hr} \times 412 \text{ sq.ft.} \times 1 \text{ ft./}12 \text{ in.} = 14 \text{ cu.ft.}$

Total Volume to be Retained = 534 cu.ft.

C. PROPOSED EXFILTRATION TRENCH SIZING

L = Total Length of Trench Provided = 15 ft W = Trench Width = 6 ft

= 0.00005 cfs/sq.ft./ft. of head K = Hydraulic Conductivity H2 = Depth to Water Table

DU = Un-Saturated Trench Depth = 0.00 ft Saturated Trench Depth = 1.00 ft

= 0.3 cu.ft. V = Volume Treated

GRUBER

6 561.312.2041

Drainage Plan For:

Na

ATION

RENO

SED

OP

_

CONSULTING

ENGINEERS

2475 Mercer Avenue, Suite 305 West Palm Beach, FL 33401

□ office@gruberengineers.com

48 HOURS BEFORE DIGGING, CALL 1-800-432-4770

SUNSHINE STATE ONE CALL OF FLORIDA, INC. Contractor is responsible for obtaining location of existing utilities prior to commencement of construction activities.

Project No. | 2024-0105 Issue Date 01/21/2025 Scale 1/8" = 1'-0"

PROJECT INFORMATION:

REVISIONS:

CHAD M. GRUBER FLORIDA P.E. NO. 57466

This item has been electronically signed and sealed by Chad M. Gruber on the date adjacent to the seal using a SHA authentication code. Printed copies of this document are not considered signed and sealed and the SHA authentication code must be

SHEET NUMBER:

verified on any electronic copies.


Plan Background from Site Plan by

C-1


Fairfax & Sammons Architects P.C. Received 11/11/24 ARC-24-0111

ZON-24-0067

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<u>LEGEND</u>

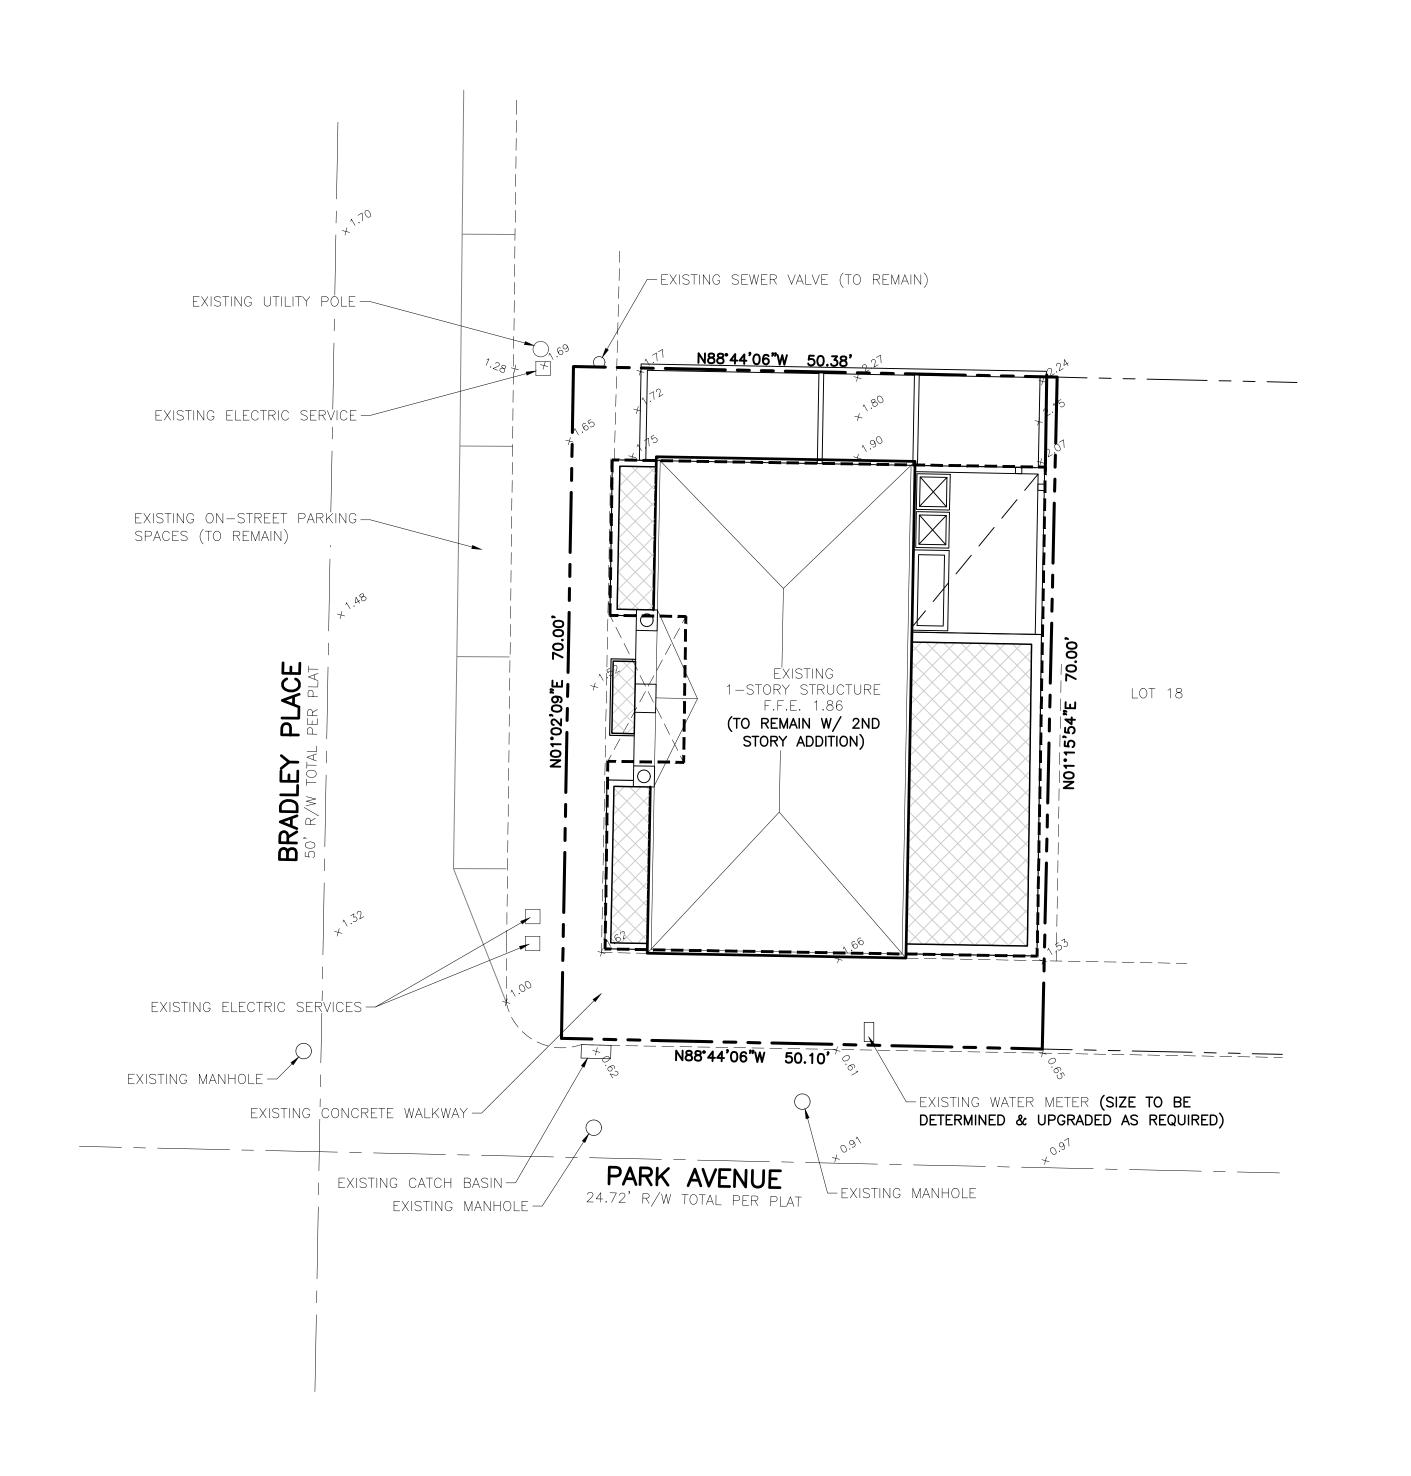

EXISTING GRADE ELEVATION

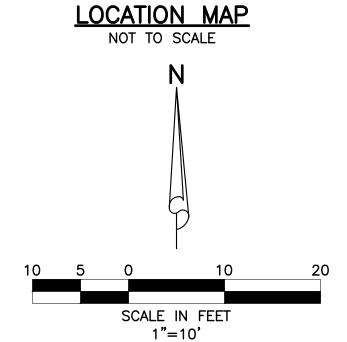PROPOSED PATIO (SEE ARCH.
PLANS FOR DETAILS)

NOTES

1.) THIS DESIGN IS CONCEPTUAL AND SUBJECT TO CHANGE BASED ON FINAL DESIGN.

2.) ALL WATER AND WASTEWATER CONSTRUCTION SHALL BE IN ACCORDANCE WITH THE CITY OF WEST PALM BEACH, THE TOWN OF PALM BEACH AND THE PALM BEACH COUNTY HEALTH DEPARTMENT.

3.) CONTRACTOR SHALL BE RESPONSIBLE FOR REMOVAL OF ALL DEMOLITION MATERIAL IN ACCORDANCE WITH ALL APPLICABLE GOVERNING AGENCY STANDARDS.

4.) LOCATIONS OF WATER AND SANITARY SEWER SERVICES, DRAINAGE STRUCTURES AND PIPES AND OTHER STRUCTURES TO BE COORDINATED WITH LANDSCAPE DESIGN DURING PREPARATION OF FINAL CIVIL ENGINEERING PLANS.


5.) CONSTRUCTION AND DEMOLITION TO COMPLY WITH N.F.P.A. 241.

6.) FIRE DEPARTMENT LOCKING CAPS WILL BE REQUIRED ON THE FIRE DEPARTMENT CONNECTION.

LAND USE AREAS:

BUILDING: 2,296 S.F.
IMPERVIOUS: 707 S.F.
PERVIOUS: 514 S.F.
TOTAL SITE: 3,517 S.F.

NOTE: ALL ELEVATIONS SHOWN HEREON ARE RELATIVE TO THE NORTH AMERICAN VERTICAL DATUM (N.A.V.D.) OF 1988 BASED ON A SURVEY PREPARED BY GT SURVEYOR SERVICES, INC. (561) 753-0353.

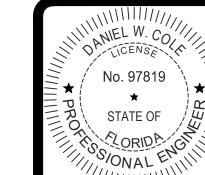

THIS ITEM HAS BEEN DIGITALLY SIGNED AND SEALED BY DANIEL W. COLE, P.E. ON 1/24/2025.


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175 BRADLEY PLACE
SECTION 15, TOWNSHIP 43S., RANGE 43E.
TOWN OF PALM BEACH, FLORIDA
CONCEPTUAL PAVING, DRAINAGE,
WATER AND WASTEWATER PLAN

JOB NO.

24-164



SILT FENCE INSTALLATION DETAIL

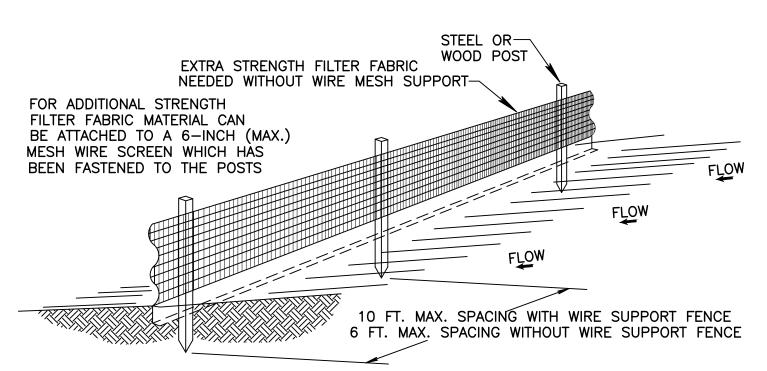
SILT FENCE NOTES:


- 1.) THE HEIGHT OF A SILT FENCE SHALL NOT EXCEED 36 INCHES (90 CM).
- 2.) THE FILTER FABRIC SHALL BE PURCHASED IN A CONTINUOUS ROLL CUT TO THE LENGTH OF THE BARRIER TO AVOID THE USE OF JOINTS.
- 3.) POSTS SHALL BE SPACED A MAXIMUM OF 10 FEET (3 M) APART AT THE BARRIER LOCATION AND DRIVEN SECURELY INTO THE GROUND A MINIMUM OF 12 INCHES (30 CM). WHEN EXTRA STRENGTH FABRIC IS USED WITHOUT THE WIRE SUPPORT FENCE, POST SPACING SHALL NOT EXCEED 6 FEET (1.8 M).
- 4.) A TRENCH SHALL BE EXCAVATED APPROXIMATELY 4 INCHES (10 CM) WIDE AND 4 INCHES (10 CM) DEEP ALONG THE LINE OF POSTS AND UPSLOPE FROM THE BARRIER.
- 5.) WHEN STANDARD STRENGTH FILTER FABRIC IS USED. A WIRE MESH SUPPORT FENCE SHALL BE FASTENED SECURELY TO THE UPSLOPE SIDE OF THE POSTS USING HEAVY DUTY WIRE STAPLES AT LEAST 1 INCH (25 MM) LONG, TIE WIRES, OR HOG RINGS. THE WIRE SHALL EXTEND INTO THE TRENCH A MINIMUM OF 2 INCHES (5 CM) AND SHALL NOT EXTEND MORE THAN 36 INCHES (90 CM) ABOVE THE ORIGINAL GROUND SURFACE.
- 6.) THE STANDARD STRENGTH FILTER FABRIC SHALL BE STAPLED OR WIRED TO THE FENCE, AND 8 INCHES (20 CM) OF THE FABRIC SHALL BE EXTENDED INTO THE TRENCH. THE FABRIC SHALL NOT EXTEND MORE THAN 36 INCHES (90 CM) ABOVE THE ORIGINAL GROUND SURFACE.
- 7.) THE TRENCH SHALL BE BACKFILLED AND THE SOIL COMPACTED OVER THE FILTER FABRIC.
- 8.) PROPOSED SILT FENCE (REQUIRED DURING CONSTRUCTION PER N.P.D.E.S./F.D.E.P. REGULATIONS) TO BE PLACED AS NECESSARY BY CONTRACTOR BASED ON FIELD CONDITIONS AND CONSTRUCTION SEQUENCING.


POLLUTION PREVENTION NOTES:

- 1.) THIS PLAN SHOULD BE USED AS A GUIDE, A COMPLETE STORMWATER POLLUTION PLAN SHOULD BE DEVELOPED BY THE CONTRACTOR TO MEET OR EXCEED F.D.E.P. REQUIREMENTS.
- 2.) CONTRACTOR IS RESPONSIBLE TO ENSURE THAT NO DIRT BE TRACKED OFF-SITE OR LEAVES THE SITE BY WIND, RUNOFF, OR OTHER MEANS.
- 3.) CONTRACTOR SHALL BE RESPONSIBLE FOR ALL N.P.D.E.S. REQUIREMENTS INCLUDING FILING OF N.O.I., MONITORING REPORTS AND N.O.T.
- 4.) POLLUTION PREVENTION MEASURES SHALL CONSIST OF, BUT NOT LIMITED TO, THE FOLLOWING:
- A. CONSTRUCT WASHROCK PAD AT ALL POINTS EGRESS FOR WASHDOWN OF TRUCK TIRES.
- B. CONSTRUCT EROSION CONTROL FENCE AND/OR TURBIDITY SCREENS ALONG PROPERTY LINES AS NEEDED.
- C. NO AREA SHALL BE LEFT BARREN OR SUBJECT TO EROSION DURING CONSTRUCTION. SEEDING AND MULCHING IS REQUIRED FOR ANY AREAS ANTICIPATED TO BE BARREN DURING CONSTRUCTION FOR MORE THAN 15 DAYS.
- D. TURBIDITY BARRIERS TO BE UTILIZED AT PROJECT OUTFALL.
- E. OTHER MEASURES AS DIRECTED BY THE ENGINEER OR THE TOWN OF PALM BEACH.
- 5.) IT IS THE CONTRACTORS RESPONSIBILITY TO COMPLY WITH ALL LOCAL, STATE AND FEDERAL POLLUTION PREVENTION REQUIREMENTS. FOR AFFECTED AREAS GREATER THAN 1 ACRE, COMPLIANCE SHALL INCLUDE (BUT IS NOT LIMITED TO) THE FOLLOWING:
- A. PREPARATION OF A STORMWATER POLLUTION PREVENTION PLAN (S.W.P.P.P.) IN ACCORDANCE WITH THE D.E.P. "GENERIC PERMIT FOR STORMWATER DISCHARGE FROM LARGE AND SMALL CONSTRUCTION ACTIVITIES" (D.E.P. DOCUMENT NO. 62-621.300(4)(A))
- B. SUBMITTAL OF THE NOTICE OF INTENT (N.O.I.) TO THE D.E.P.
- C. MAINTENANCE AND INSPECTION OF THE ELEMENTS OF THE S.W.P.P.P.
- D. MAINTENANCE OF RECORDS (INSPECTION REPORTS, N.O.I, S.W.P.P.P., ETC.)
- E. SUBMITTAL OF THE NOTICE OF TERMINATION TO THE D.E.P. AT THE CONCLUSION OF THE PROJECT.
- 6.) PROPOSED SILT FENCE (REQUIRED DURING CONSTRUCTION PER N.P.D.E.S./F.D.E.P. REGULATIONS) TO BE PLACED AS NECESSARY BY CONTRACTOR BASED ON FIELD CONDITIONS & CONSTRUCTION SEQUENCING.

NOTE: ALL ELEVATIONS SHOWN HEREON ARE RELATIVE TO THE NORTH AMERICAN VERTICAL DATUM (N.A.V.D.) OF 1988 BASED ON A SURVEY PREPARED BY GT SURVEYOR SERVICES, INC. (561) 753-0353.

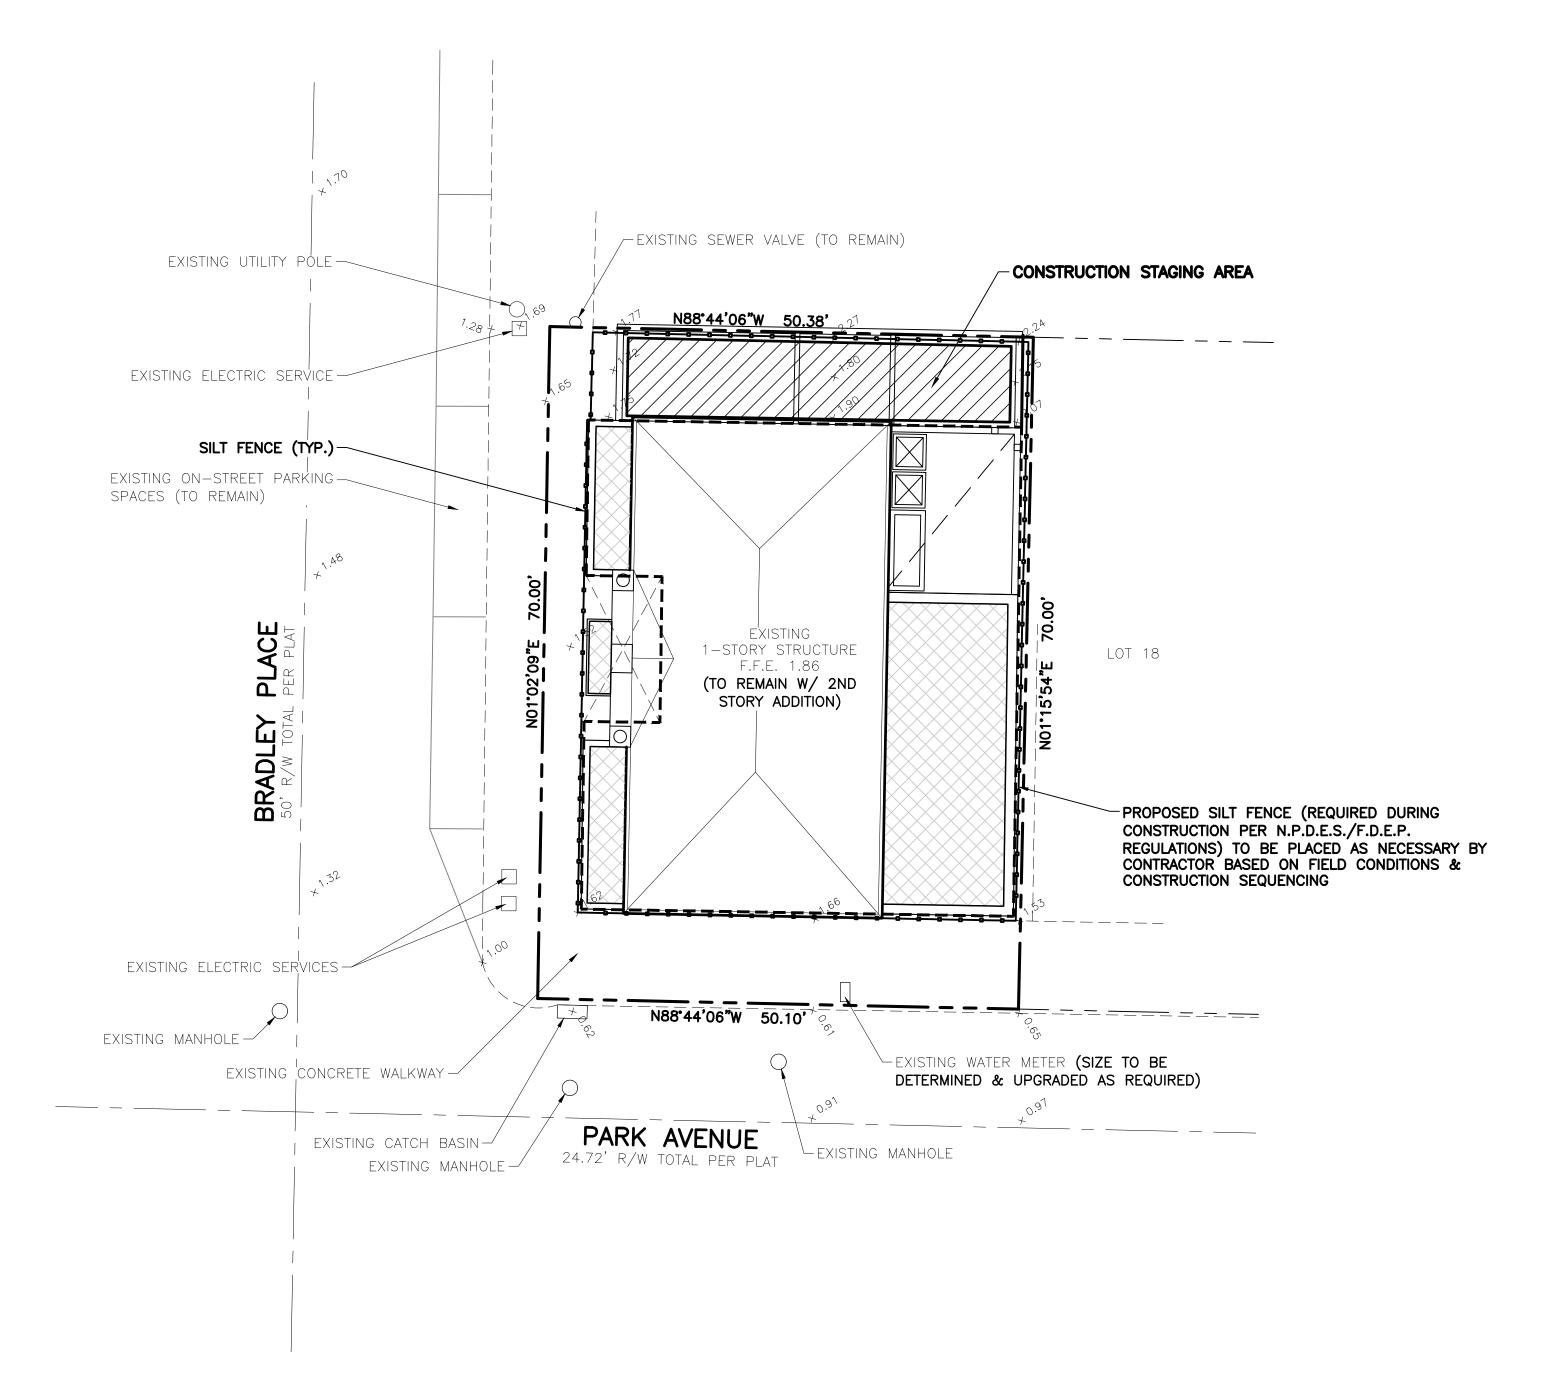

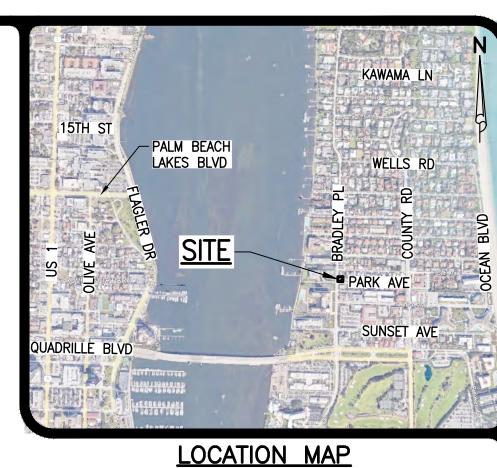

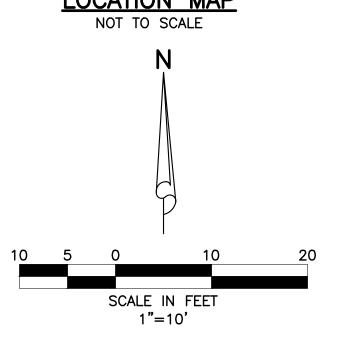


LEGEND

SILT FENCE

CONSTRUCTION STAGING AREA

TON

EXISTING DRIVES AND PARKING AREAS TO BE USED FOR CONSTRUCTION STAGING. UPON FUTURE REMOVAL OF EXISTING DRIVES, WASHROCK CONSTRUCTION ENTRANCE(S) MAY BE REQUIRED.

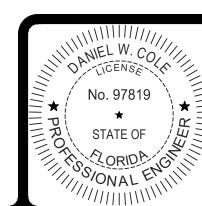

THIS ITEM HAS BEEN DIGITALLY SIGNED AND SEALED BY DANIEL W. COLE, P.E. ON 1/24/2025.

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CHECKED

D.C.

D.B.

REVISIONS

175 BRADLEY PLACE
SECTION 15, TOWNSHIP 43S., RANGE 43E.
TOWN OF PALM BEACH, FLORIDA
CONSTRUCTION STAGING AND
POLLUTION PREVENTION PLAN

APPROVED DATE JOB NO. DRAWING NO. SHEET OF 24-164 24164Z01 1 1