



EXTERIOR FINISHES & MATERIALS: STUCCO, PAINTED BENJAMIN MOORE DECORATOR'S WHITE OC-149.

WINDOW FRAME MATERIAL, COLOR, MUNTIN PROFILE, GLAZING TYPE: PINE, PAINTED, BENJAMIN MOORE DECORATOR'S WHITE OC-149, OGEE 3/4" MUNTIN PROFILE, TRIPLE-PANE HURRICANE IMPACT CLEAR GLASS.
WINDOW SHUTTER COLOR: BENJAMIN MOORE POLO BLUE 2062-10.


ROOF MATERIAL & COLOR: FLAT BUILT-UP GRAVEL & TAR ROOF WITH WHITE COOL ROOF RELECTIVE COATING.

NOTE: ALL WINDOWS AND EXTERIOR DOORS ARE NEW IMPACT-RATED WOOD UNITS, UNLESS OTHERWISE NOTED

PROPOSED SOUTH ELEVATION

SCALE: 1/4" = 1'-0"



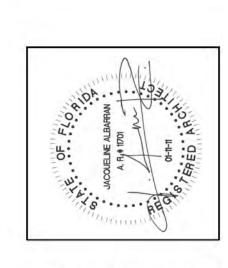

JACQUELINE ALBARRAN, PA REGISTERED ARCHITECT 11701

REVISIONS:

A13.2

DATE:
07-30-2024

JOB #

0496

EXISTING SOUTH ELEVATION

EXISTING NORTH ELEVATION SCALE: 1/4" = 1'-0"

SCALE: 1/4" = 1'-0"

SCALE: 1/4" = 1'-0"

EXISTING WEST ELEVATION

DEMOLITION EAST ELEVATION


SCALE: 1/4" = 1'-0"


DEMOLITION SOUTH ELEVATION


DEMOLITION NORTH ELEVATION DEMOLITION

SCALE: 1/4 = 1-0


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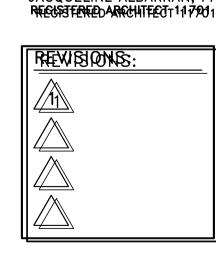


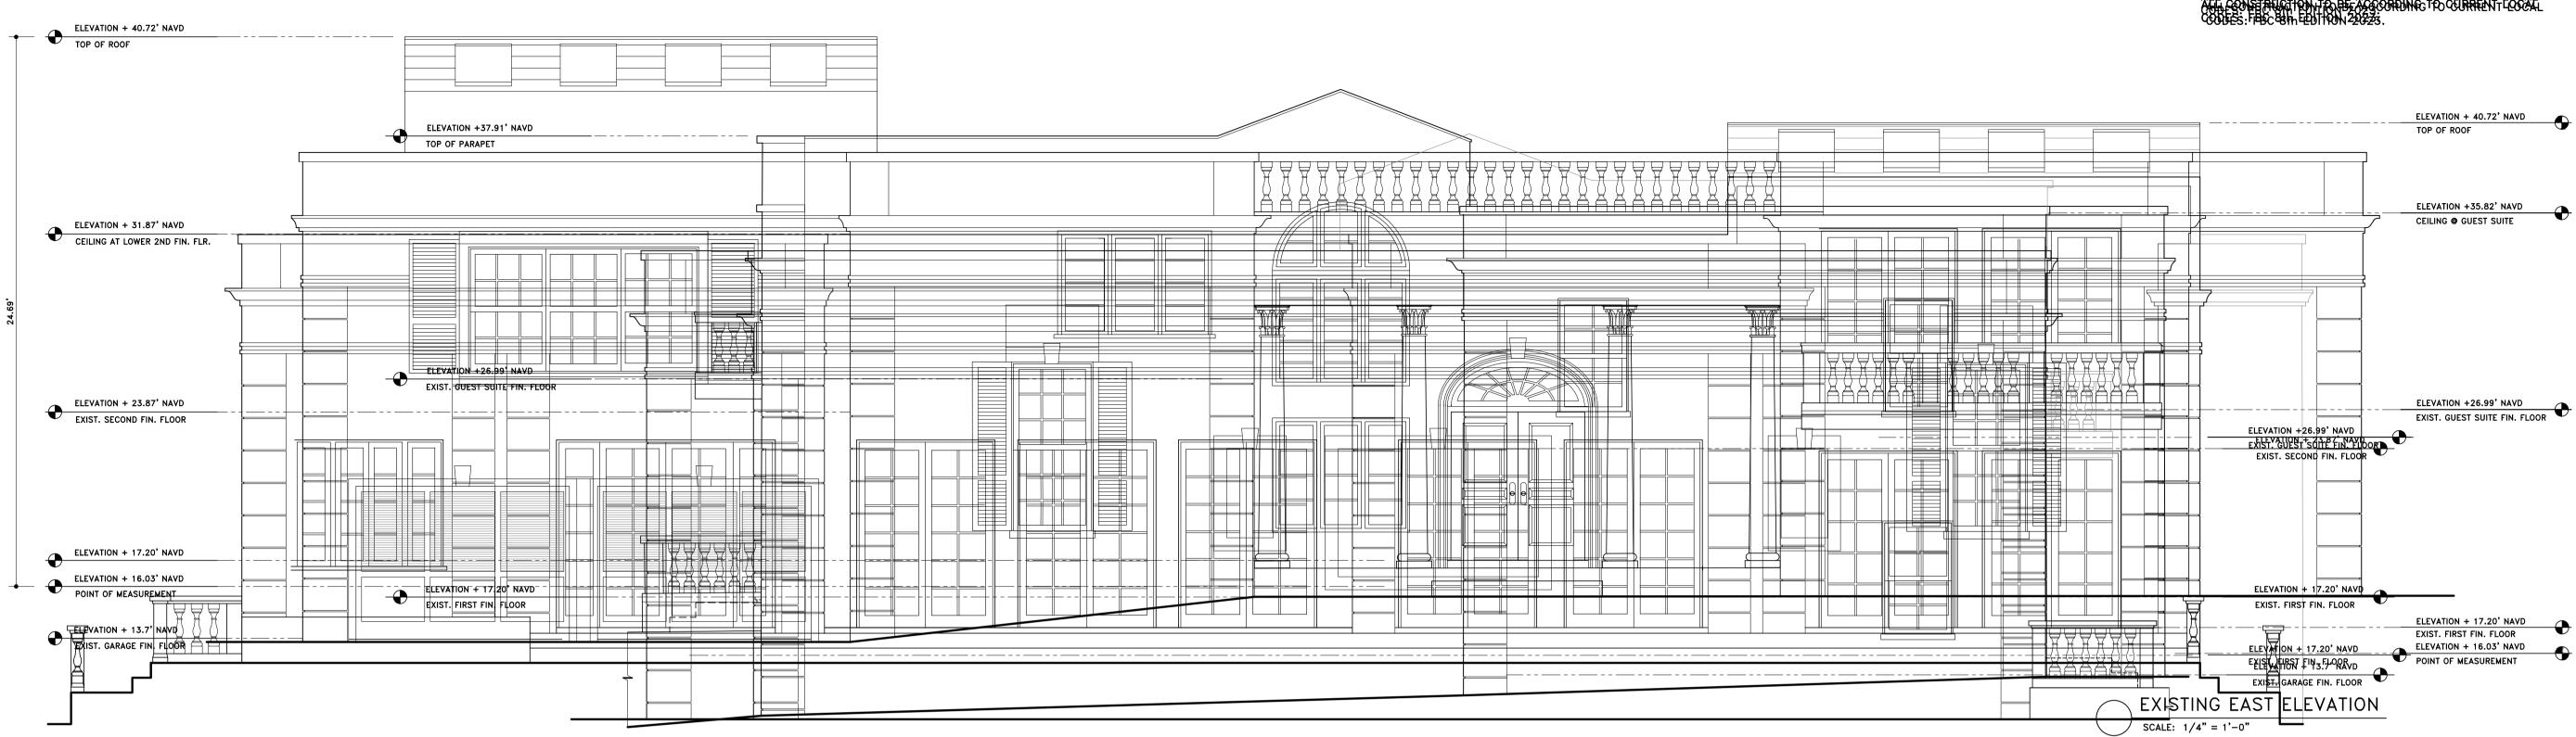

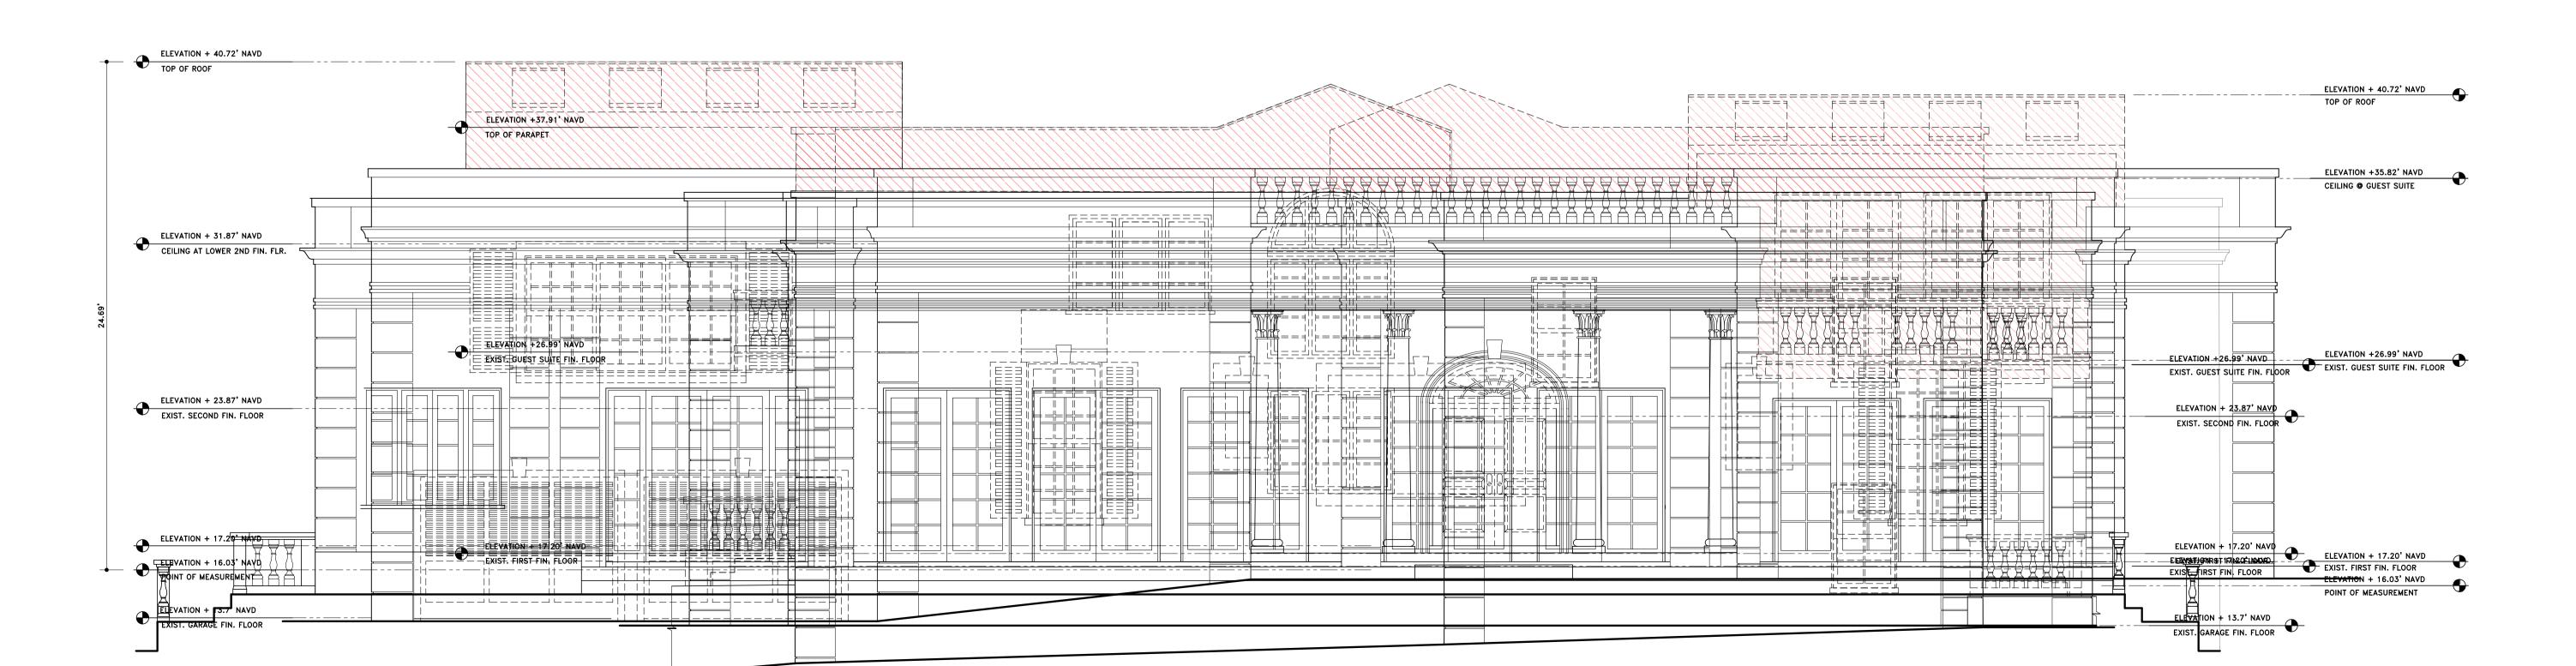
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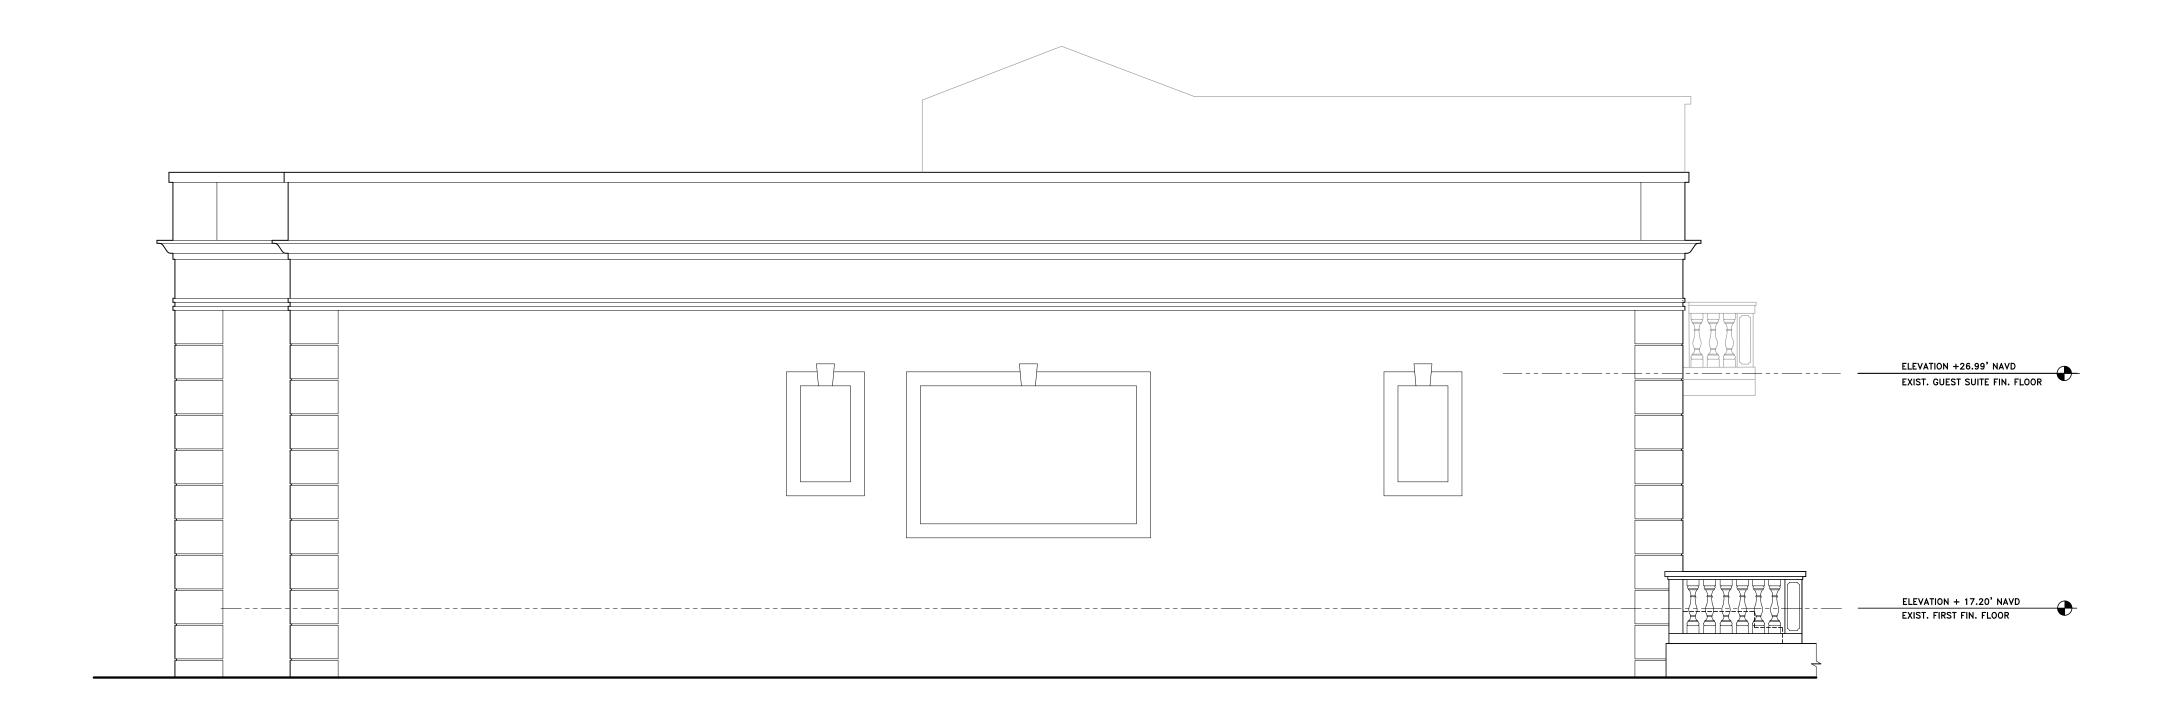


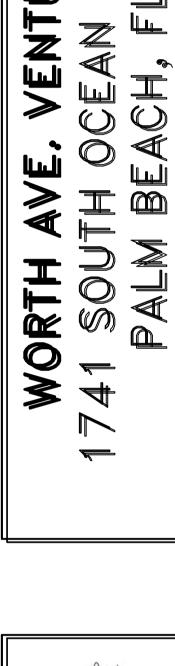

THE GENERAL CONTRACTOR SHALL VERIFY ALL DIMENSIONS, DRAWINGS AND SPECIFICATION REQUIREMENTS WITH EXISTING CONDITIONS IN THE FIELD AND BRING ANY DISCREPANCIES TO THE ARCHITECT'S ATTENTION BEFORE PROCEEDING WITH THE WORK.

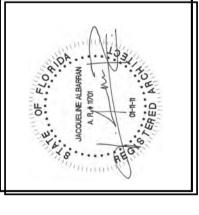DO NOT SCALE DRAWING. ALL DIMENSIONS SUPERSEDE ANY GRAPHIC REPRESENTATION.

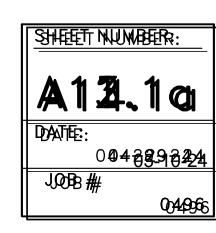
ALL CONSTRUCTION TO BE ACCORDING TO CURRENT LOCAL CODES: FBC 8th EDITION 2023.




EXISTING NORTH ELEVATION

SCALE: 1/4" = 1'-0"



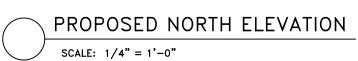

WORTH AVE. VENTURES LLC
1741 SOUTH OCEAN BOULEVAR
PAIM REACH FIORIDA

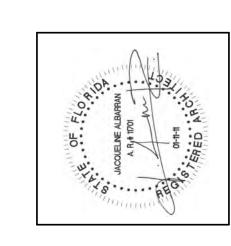

JACQUELINE ALBARRAN, PA REGISTERED ARCHITECT 11701

REVISIONS:

05-24-24

08-05-24

<u>2</u> 08−05−24

SHEET NUMBER:

A 1 4.1 b

DATE:

05-10-24


JOB #

0496





JACQUELINE ALBARRAN, PA REGISTERED ARCHITECT 11701

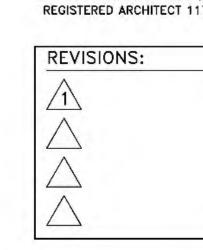

SHEET NUMBER: DATE: 07-30-2024 JOB #

0496

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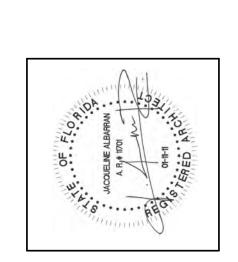
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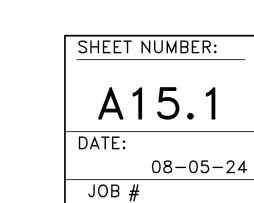
# WORTH



JACQUELINE ALBARRAN, PA REGISTERED ARCHITECT 11701

REVISIONS:

PERSPECTIVE OF EAST ELEVATION




0496




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ALL CONSTRUCTION TO BE ACCORDING TO CURRENT LOCAL CODES: FBC 8th EDITION 2023.



# WORTH

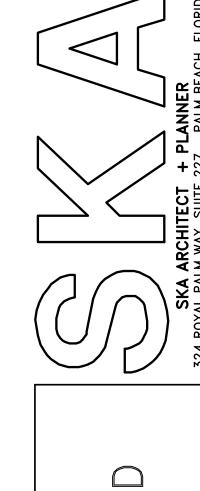

JACQUELINE ALBARRAN, PA REGISTERED ARCHITECT 11701

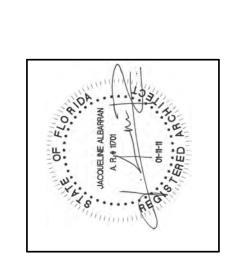
REVISIONS:

PERSPECTIVE OF WEST ELEVATION

SHEET NUMBER: A15.2 DATE: 08-05-24 JOB #


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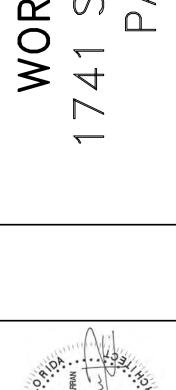





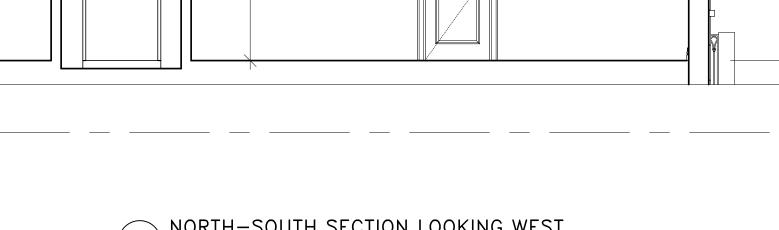








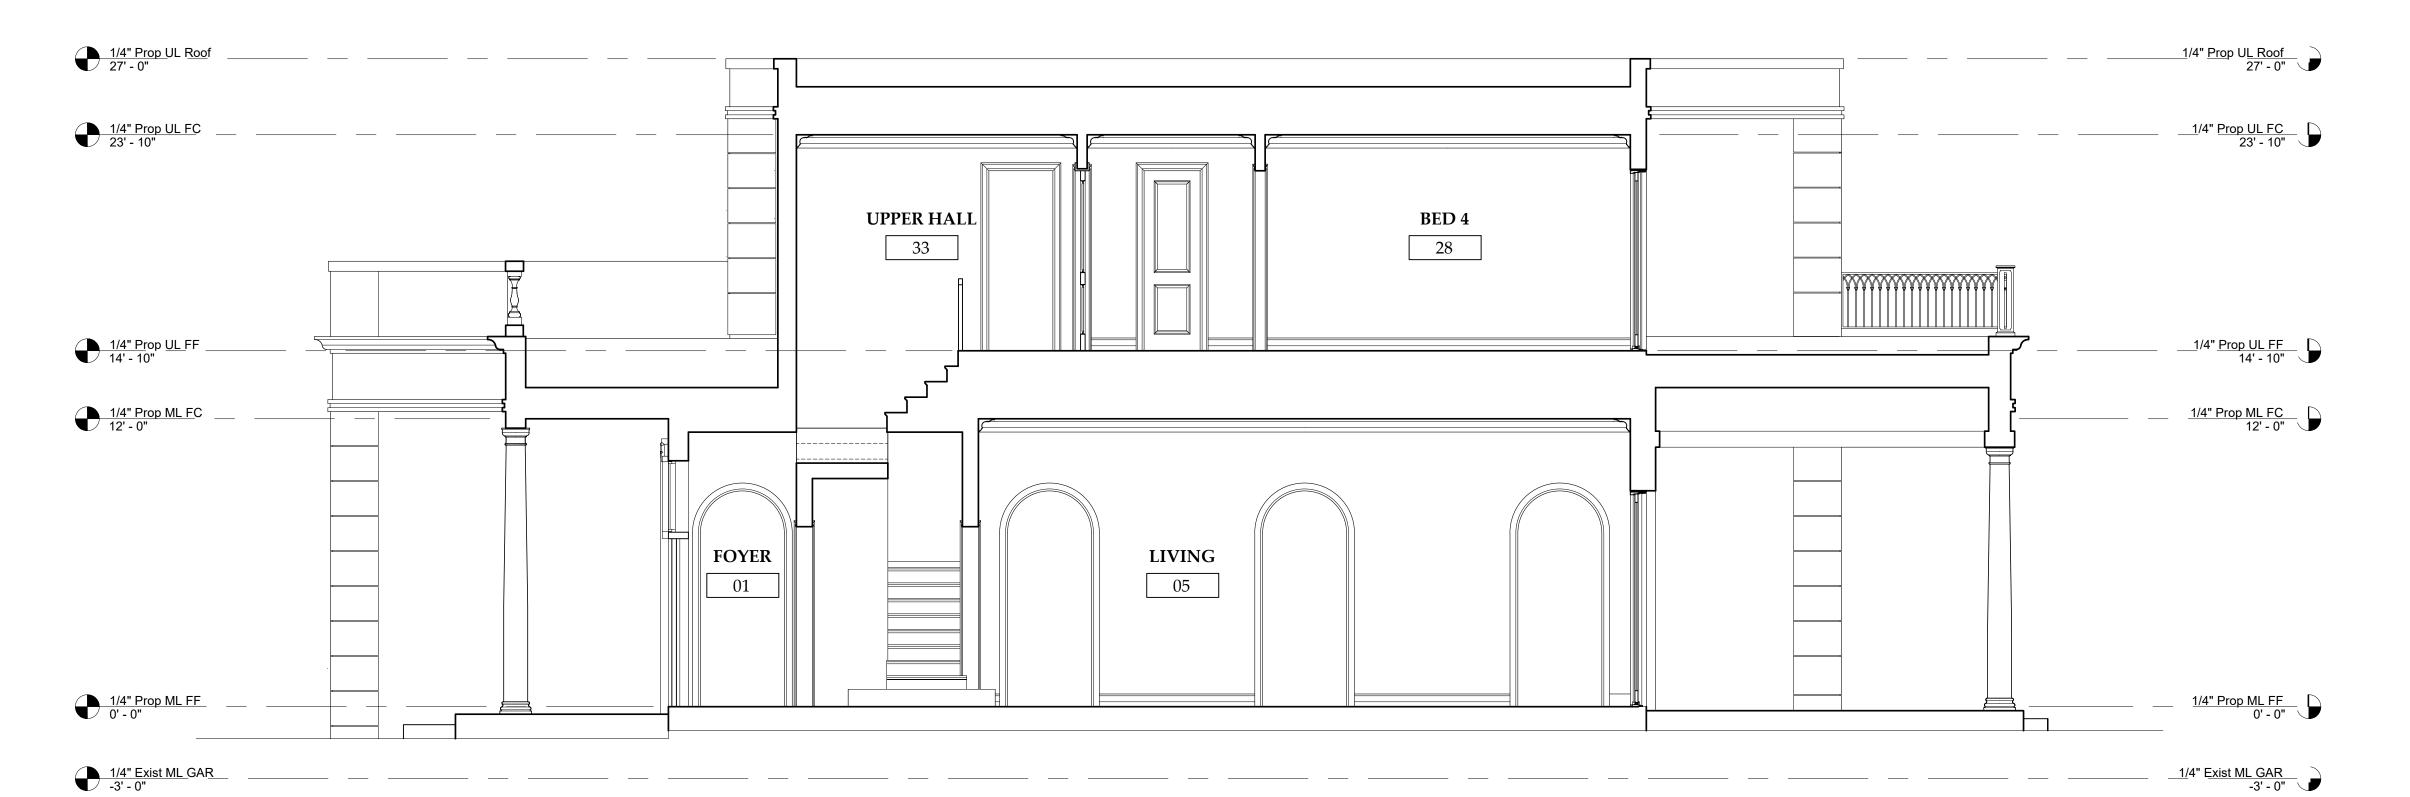


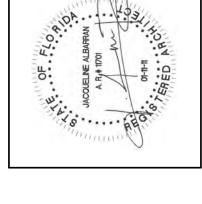

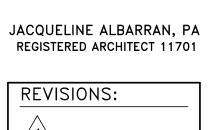

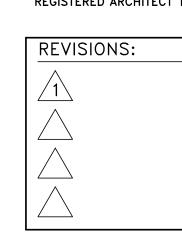

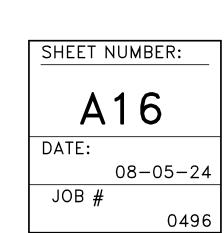


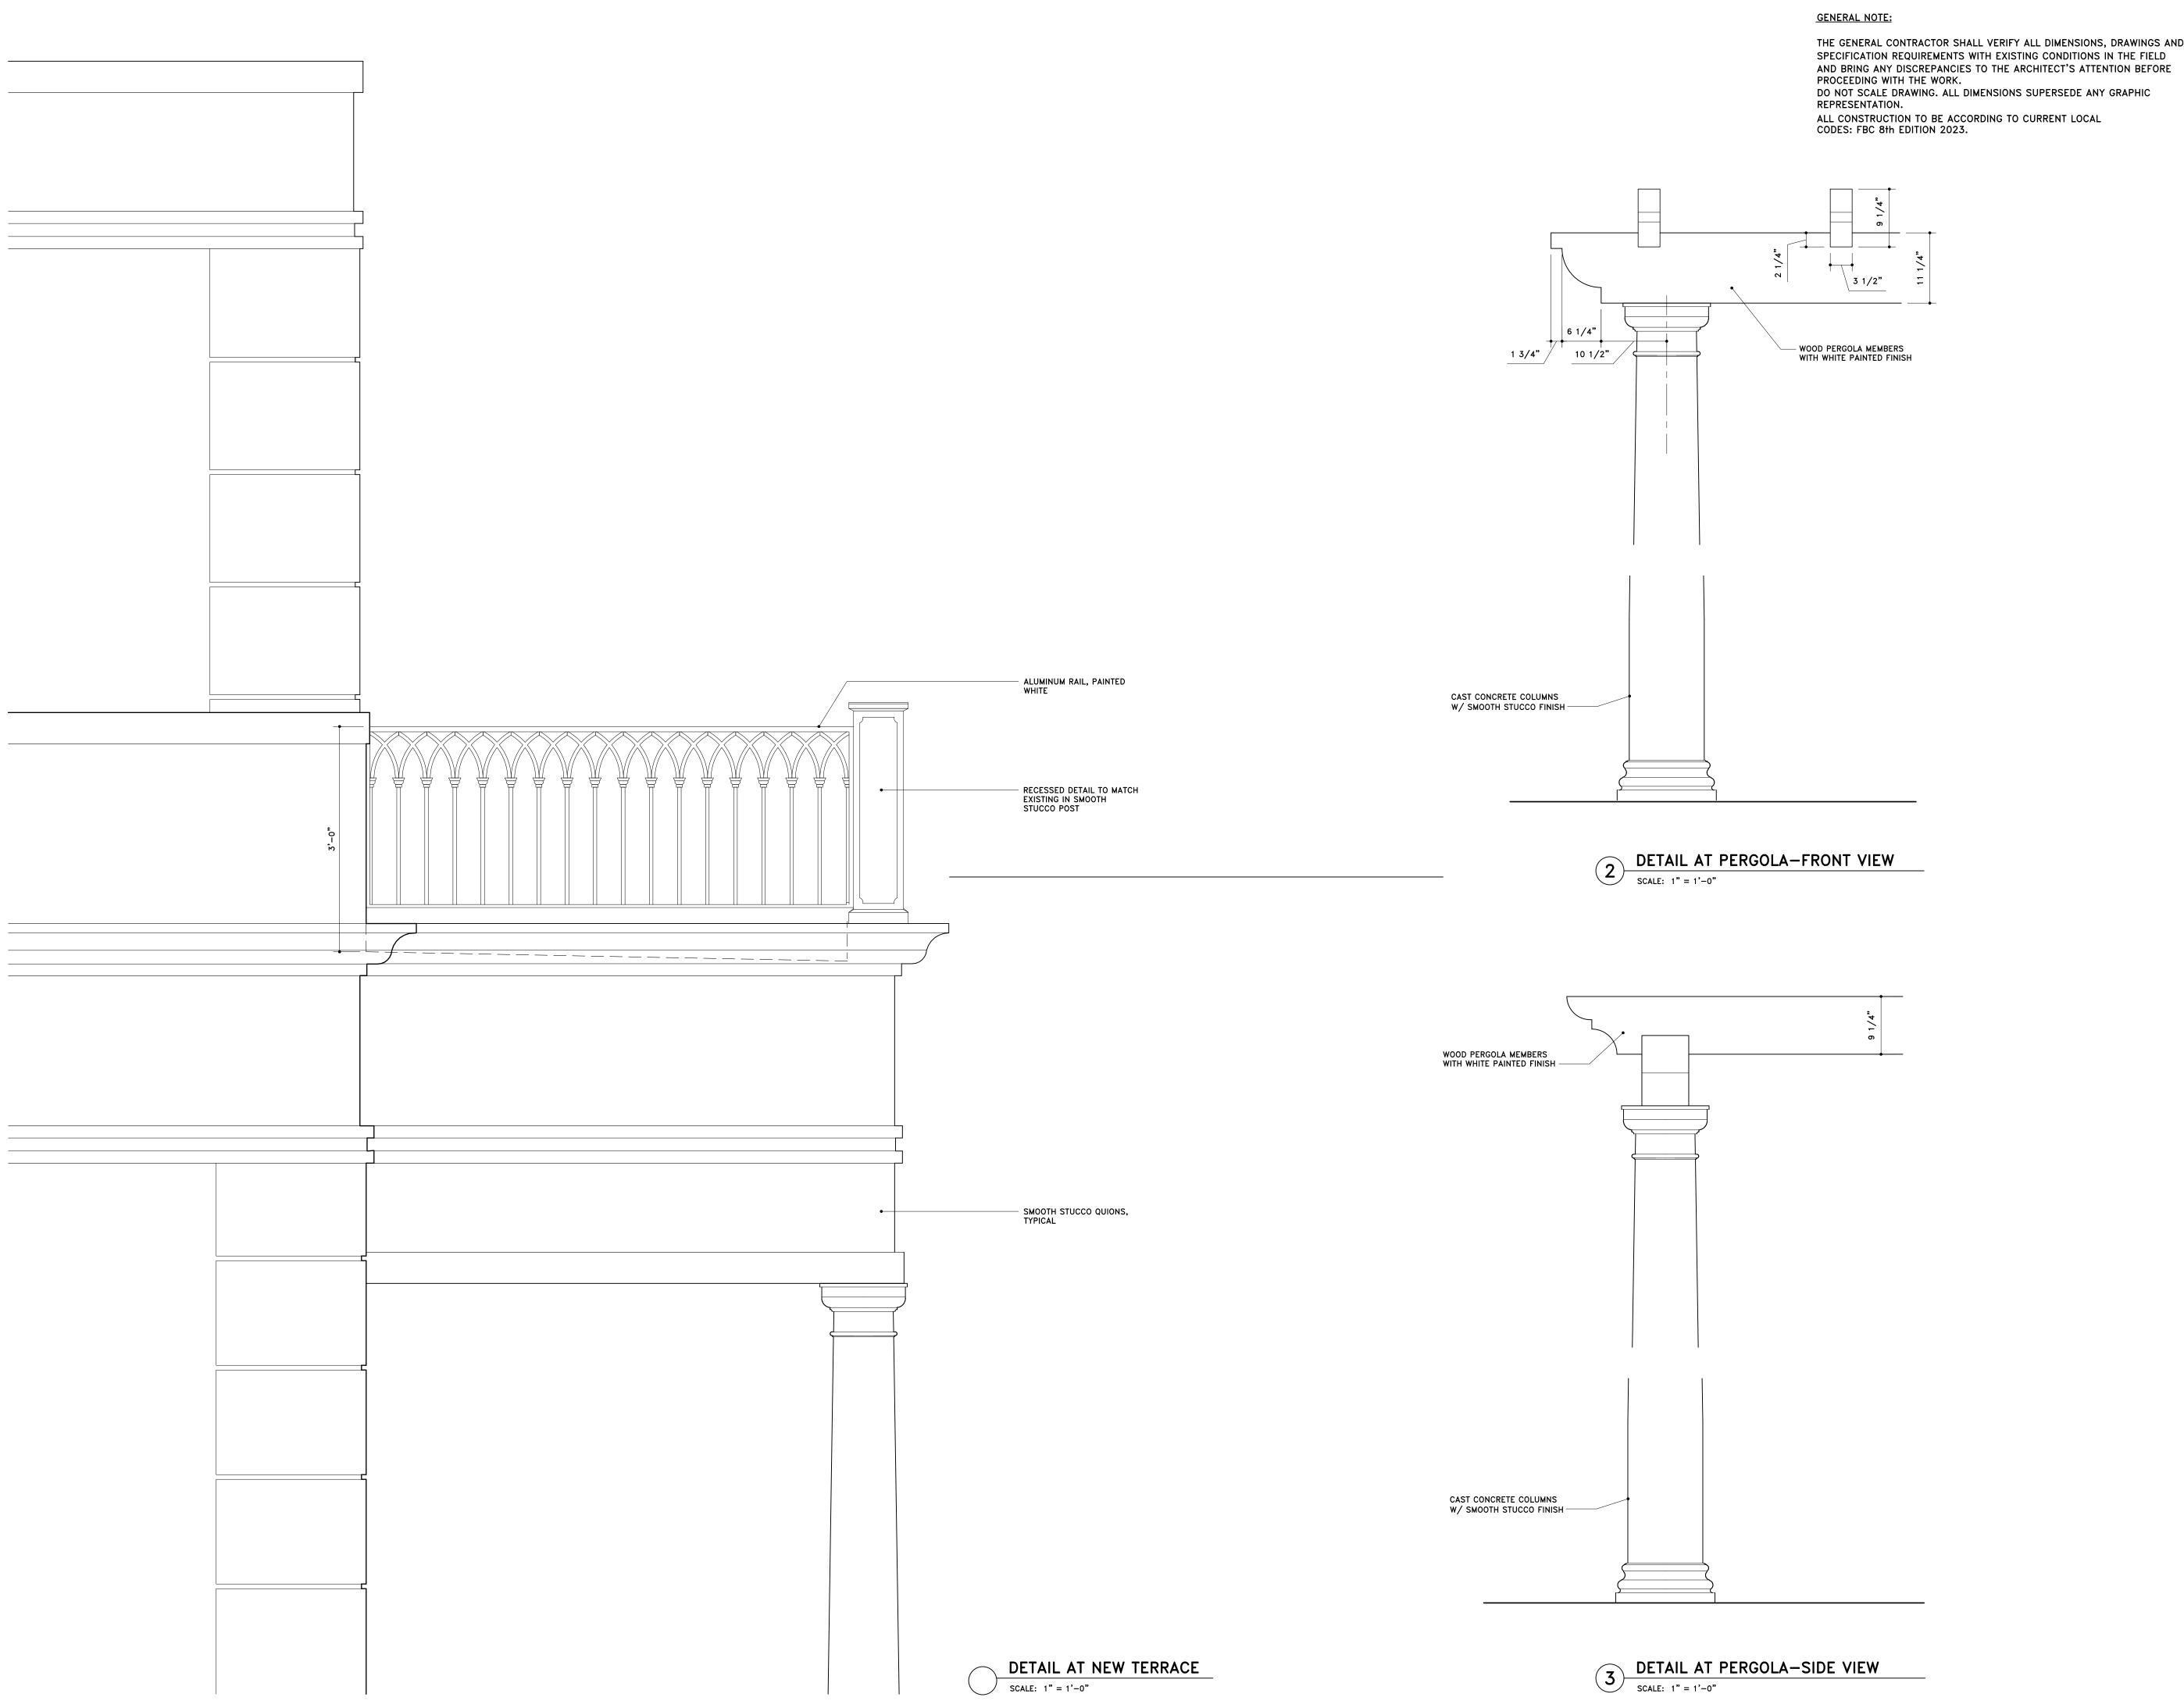

THE GENERAL CONTRACTOR SHALL VERIFY ALL DIMENSIONS, DRAWINGS AND SPECIFICATION REQUIREMENTS WITH EXISTING CONDITIONS IN THE FIELD

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WOW 1

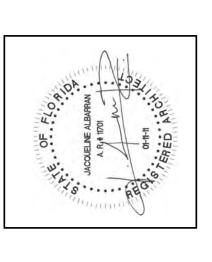

REVISIONS:

1 08-05-24

SHEET NUMBER:

DATE: 08-05-24


JOB # 0496


M1 | M2 | M3 | M4 | M5 | M6 | M7 | M8 | M9 | M10 | M11 | M12 | M13 |


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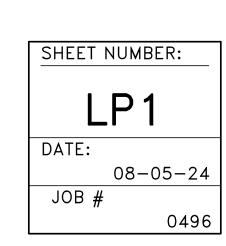
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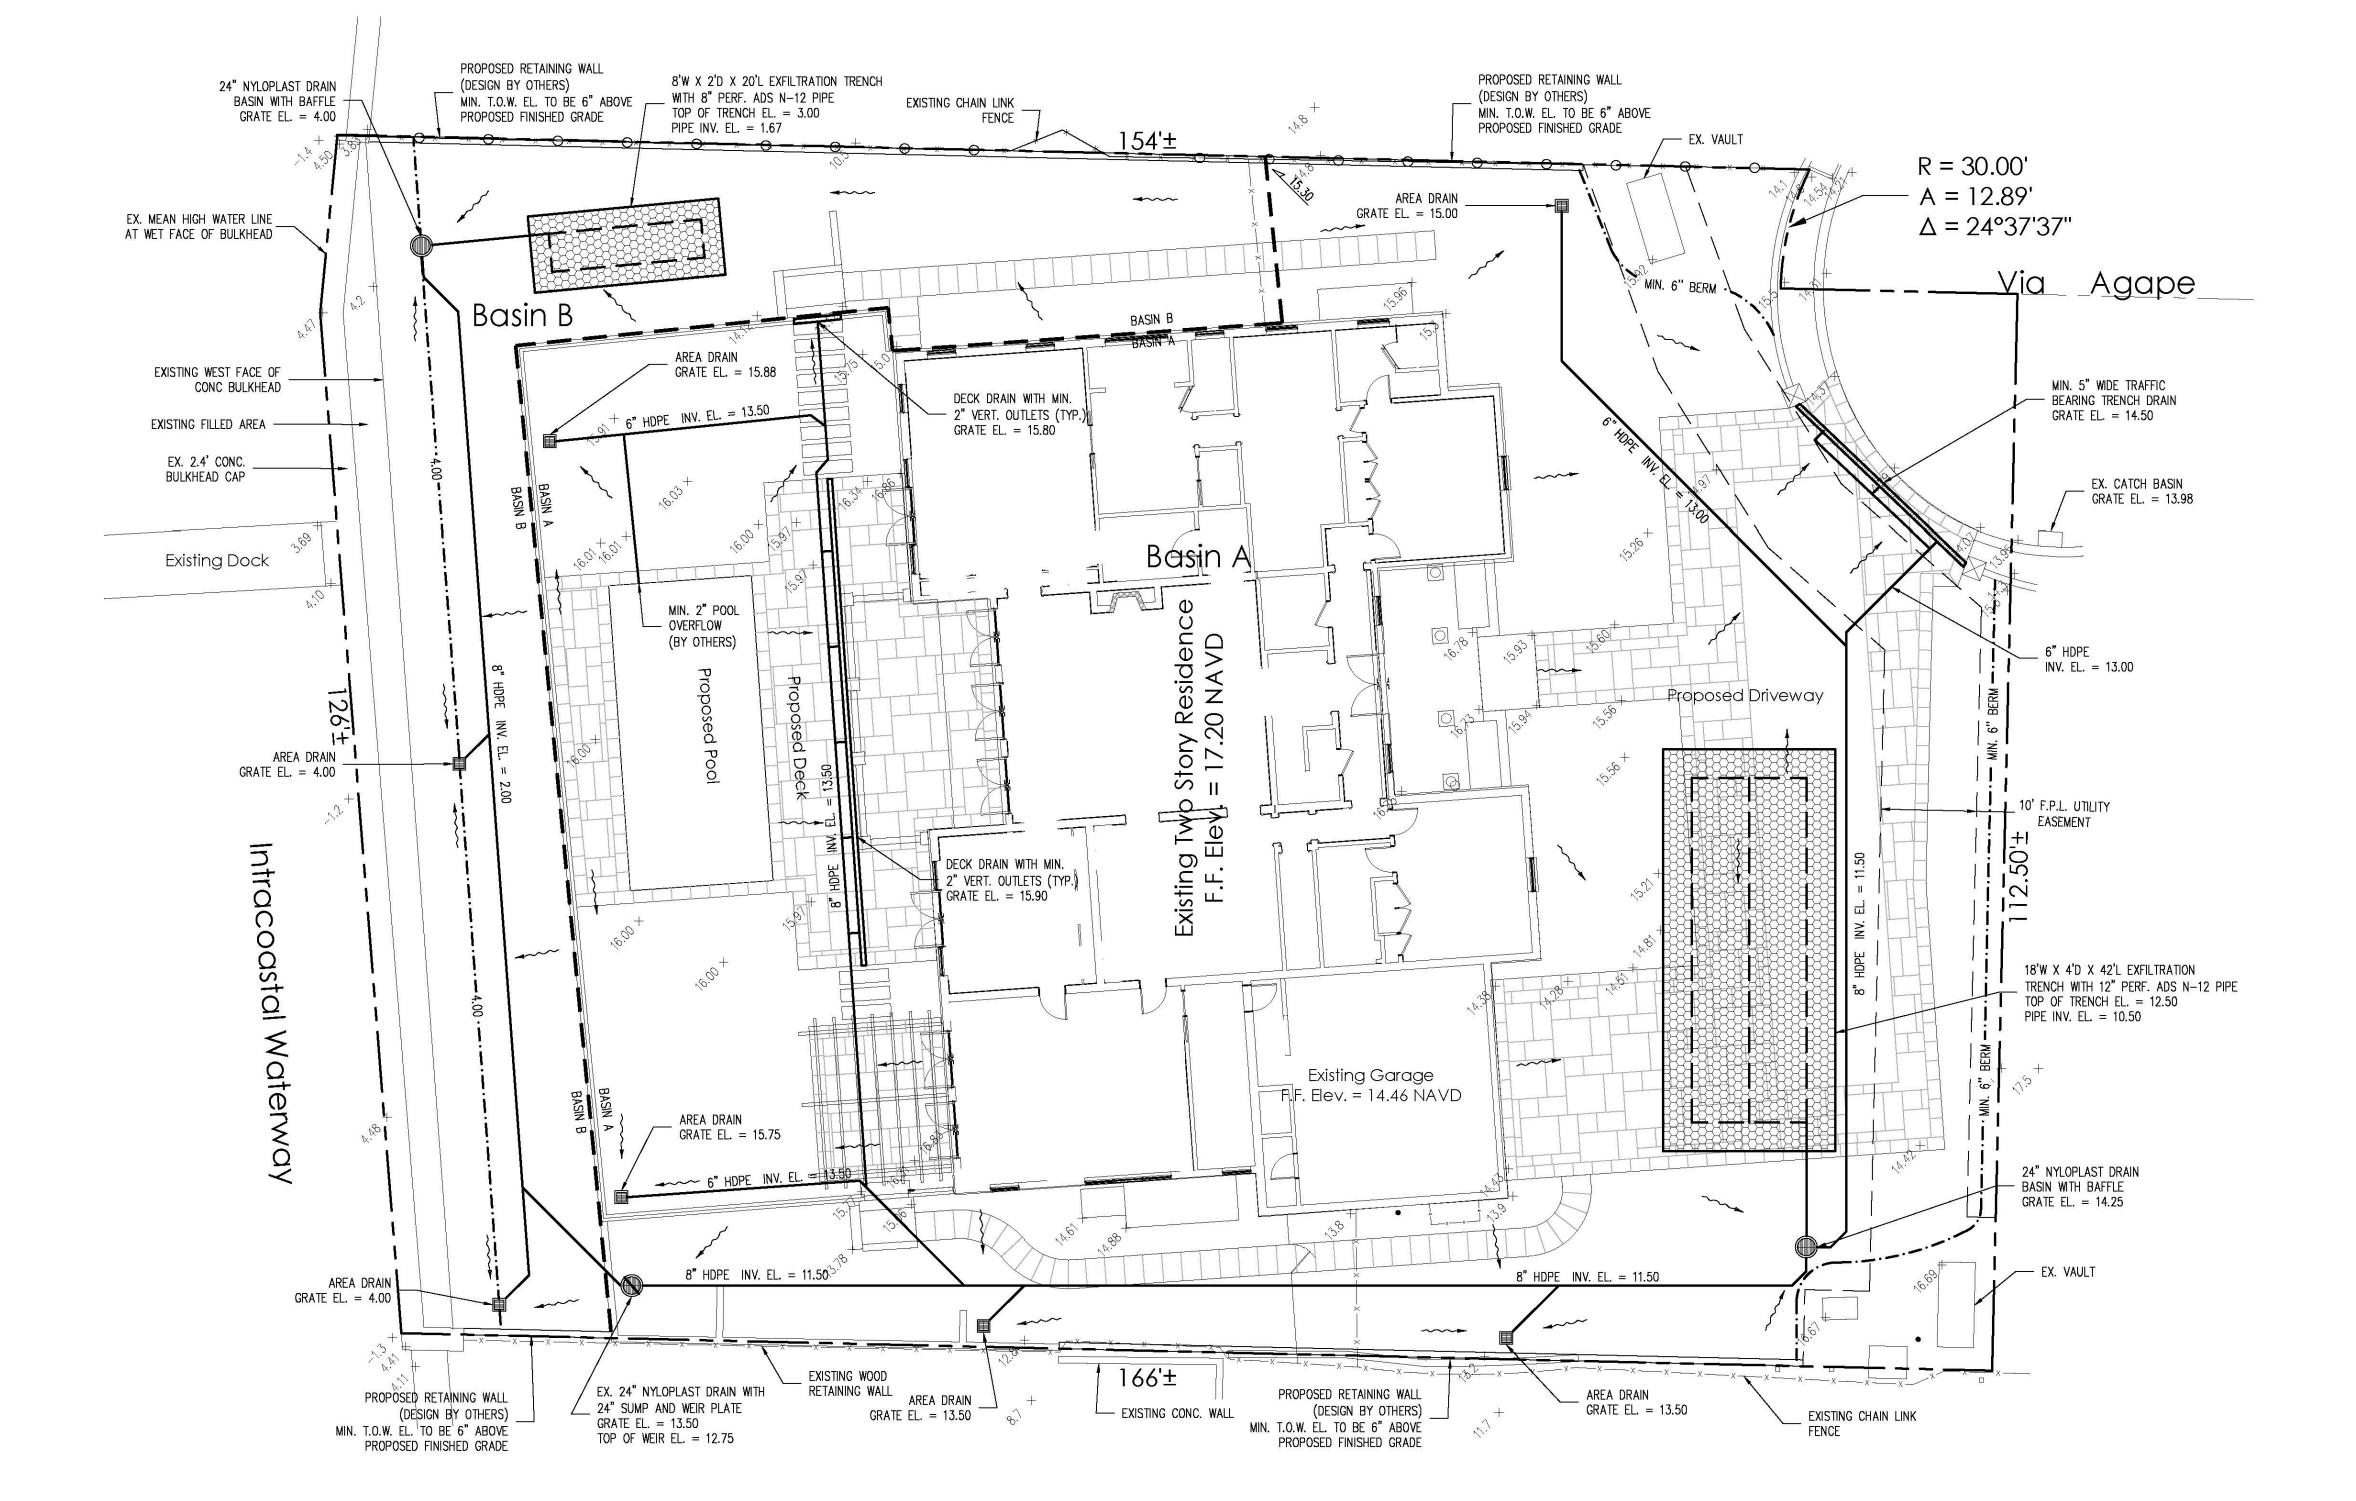





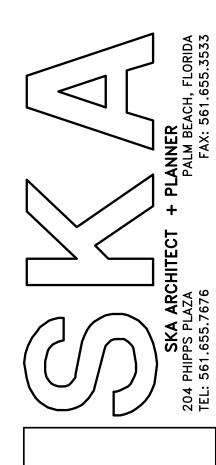

### LOGISTICS PLAN AND CONSTRUCTION TIMELINE

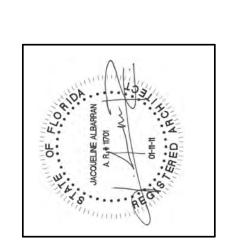

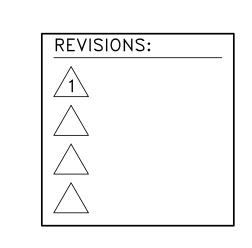

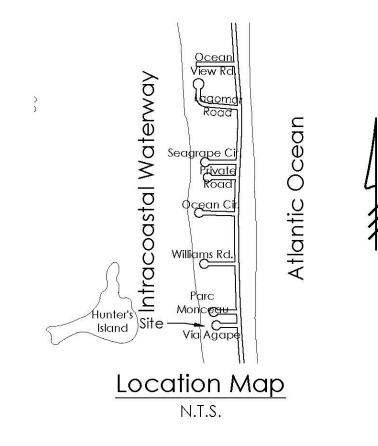

### Legend

EXISTING ELEVATION PER WALLACE SURVEYING CORP. (NAVD-88)

PROPOSED ELEVATION (NAVD-88)


---7.00--- PROPOSED ELEVATION CONTOUR (NAVD-88)

FLOW DIRECTION

EXFILTRATION TRENCH

AREA DRAIN

24" NYLOPLAST DRAIN BASIN WITH BAFFLE

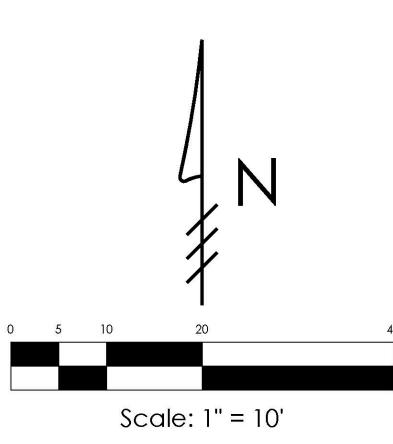

### STORMWATER RETENTION CALCULATIONS (Basin A)

A. <u>SITE INFORMATION</u>

Total Property Area = 21,268 sq.ft.

Proposed Drainage Area = 20,501 sq.ft.

Proposed Basin Area = 16,721sq.ft.

Drainage Area Impervious Surface = 12,021 sq.ft.

Drainage Area Pervious Surface = 4,700 sq.ft.

B. ESTIMATED STORMWATER RETENTION VOLUME

The retention volume is estimated using the Rational Method (Q=CiA)

C = 1.0 (impervious surface) C = 0.2 (pervious surface) i = 2 in/hr

> Impervious Surface Runoff Volume:  $1.0 \times 2 \text{ in/hr} \times 12,021 \text{ sq.ft.} \times 1 \text{ ft./}12 \text{ in.} = 2,004 \text{ cu.ft.}$

Pervious Runoff Volume:

 $0.2 \times 2 \text{ in/hr} \times 4,700 \text{ sq.ft.} \times 1 \text{ ft./}12 \text{ in.} = 157 \text{ cu.ft.}$ 

Un-Saturated Trench Depth

Total Volume to be Retained = 2,161 cu.ft.

DS = Saturated Trench Depth

V = Volume Treated

C. PROPOSED EXFILTRATION TRENCH SIZING

Total Length of Trench Provided = 42 ft W = Trench Width = 18 ft Hydraulic Conductivity = 0.00005 cfs/sq.ft./ft. of head Depth to Water Table = 6.00 ft

= 4.00 ft

= 0.00 ft

= 2,593 cu.ft.

erosion control measures during construction. 6) Video inspection of storm drainage system required prior to installation of sod.

1) Exfiltration trenches and storm piping to be protected

2) Roof drain downspouts are to be connected to the

3) Exfiltration trench design uses an assumed value of

4) Contractor shall mill and overlay all roadway cuts a

5) Contractor is responsible for installing and maintaining

entire width of each affected lane.

proposed drainage system. Contractor to provide

engineer with downspout locations prior to installation

hydraulic conductivity. Client may obtain a site specific

test for hydraulic conductivity prior to exfiltration trench

minimum of 50 ft. on either side of the excavation the

from roots with a root barrier.

of drainage system.

installation.

Notes:

### STORMWATER RETENTION CALCULATIONS (Basin B)

A. <u>SITE INFORMATION</u>

Total Property Area = 21,268 sq.ft.

Proposed Drainage Area = 20,501 sq.ft.

Proposed Basin Area = 3,780 sq.ft.

Drainage Area Impervious Surface = 394 sq.ft.

Drainage Area Pervious Surface = 3,386 sq.ft.

B. <u>ESTIMATED STORMWATER RETENTION VOLUME</u>

The retention volume is estimated using the Rational Method (Q=CiA)

C = 1.0 (impervious surface) C = 0.2 (pervious surface)

i = 2 in/hr

Impervious Surface Runoff Volume:  $1.0 \times 2 \text{ in/hr} \times 394 \text{ sq.ft.} \times 1 \text{ ft./12 in.} = 66 \text{ cu.ft.}$ 

Pervious Runoff Volume: 0.2 x 2 in/hr x 3,386 sq.ft. x 1 ft./12 in. = 113 cu.ft.

Total Volume to be Retained = 179 cu.ft.

C. PROPOSED EXFILTRATION TRENCH SIZING

= 20 ft = 8 ft Trench Width Hydraulic Conductivity = 0.00005 cfs/sq.ft./ft. of head

Depth to Water Table

Total Length of Trench Provided

= 2.50 ft Un-Saturated Trench Depth = 1.50 ft Saturated Trench Depth = 0.50 ft

= 222 cu.ft. Volume Treated

Plan Background from Hardscape Plan by SMI Landscape Architecture Received 4/10/24

ARC-24-001 ZON-24-006 © 2024 Gruber Consulting Engineers, Inc.

### **GRUBER** CONSULTING **ENGINEERS**

2475 Mercer Avenue, Suite 305 West Palm Beach, FL 33401 6 561.312.2041 

48 HOURS BEFORE DIGGING CALL 1-800-432-4770

SUNSHINE STATE ONE CALL OF FLORIDA, INC. Contractor is responsible for obtaining location of existing

utilities prior to commencement of construction activities.

**ENTURES** Drainage Plan For ENUE Grading

RTH

3

PROJECT INFORMATION:

Project No. | 2024-0002 Issue Date 05/10/2024

ptual Site

1" = 10' Scale **REVISIONS:** 

CHAD M. GRUBER

FLORIDA P.E. NO. 57466 Digitally signed by Chad M No. 57486 \* Gruber #∄ Date: 2024.05.08

-04'00' This item has been electronically signed and sedled by Chad M. Gruber on the date adjacent to the seal using a SHA authentication code. Printed copies of this document are not considered signed and sealed and the SHA authentication code must be

17:31:26

verified on any electronic copies. SHEET NUMBER:








0' 10' 20' 30'



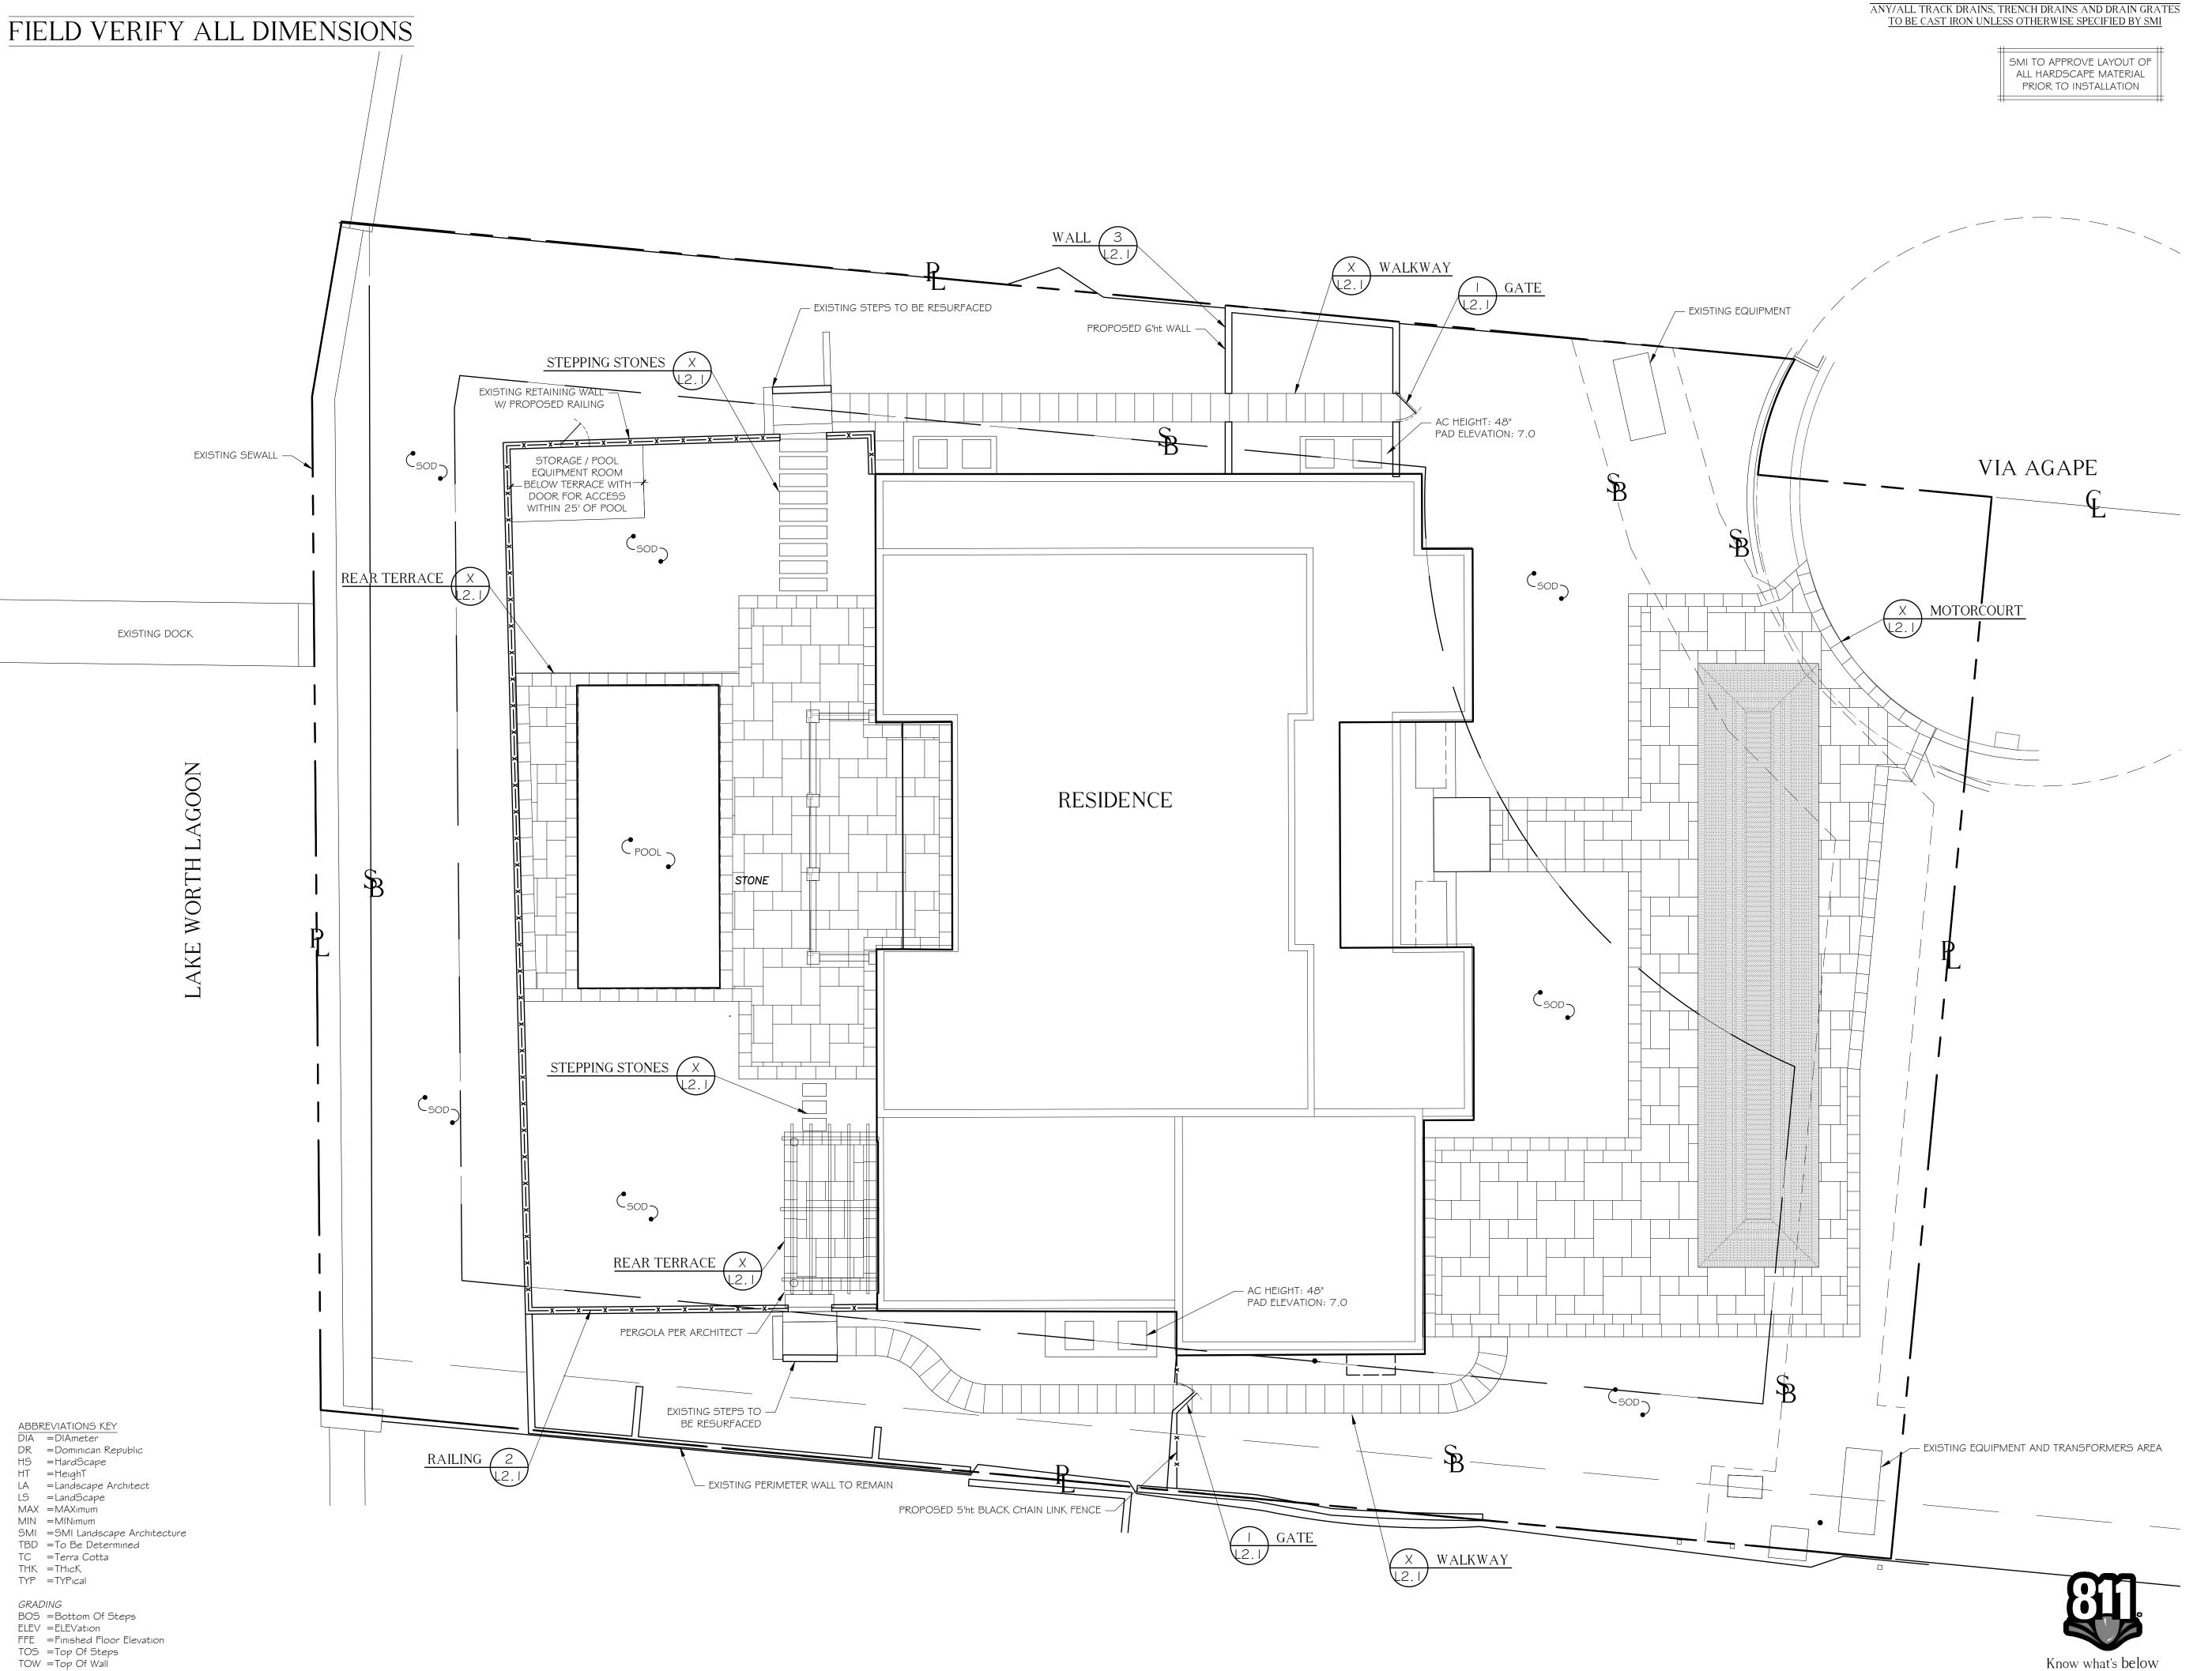

1741 South Ocean Blvd. Palm Beach, FL 33480



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NOTES:
-FOOTINGS FOR ALL STRUCTURES TO BE AT LEAST
3' BELOW GRADE TO ALLOW FOR PLANTINGS /
ROOT BALLS

-DRIP IRRIGATION MAY ONLY BE USED IF SPECIFIED BY SMI OR IF REQUIRED BY MUNICIPALITY

- 6 08.01.2024 PRESENTATION REV01 5 06.12.2024 PRESENTATION
- 4 05.10.2024 FINAL SUBMITTAL 3 04.29.2024 SECOND SUBMITTAL
- 3 04.29.2024 SECOND SUBMITTAL
   2 04.11.2024 FIRST SUBMITTAL
   1 04.01.2024 PRE APP


DATE DESCRIPTION
REVISIONS

Call before you dig

Preliminary


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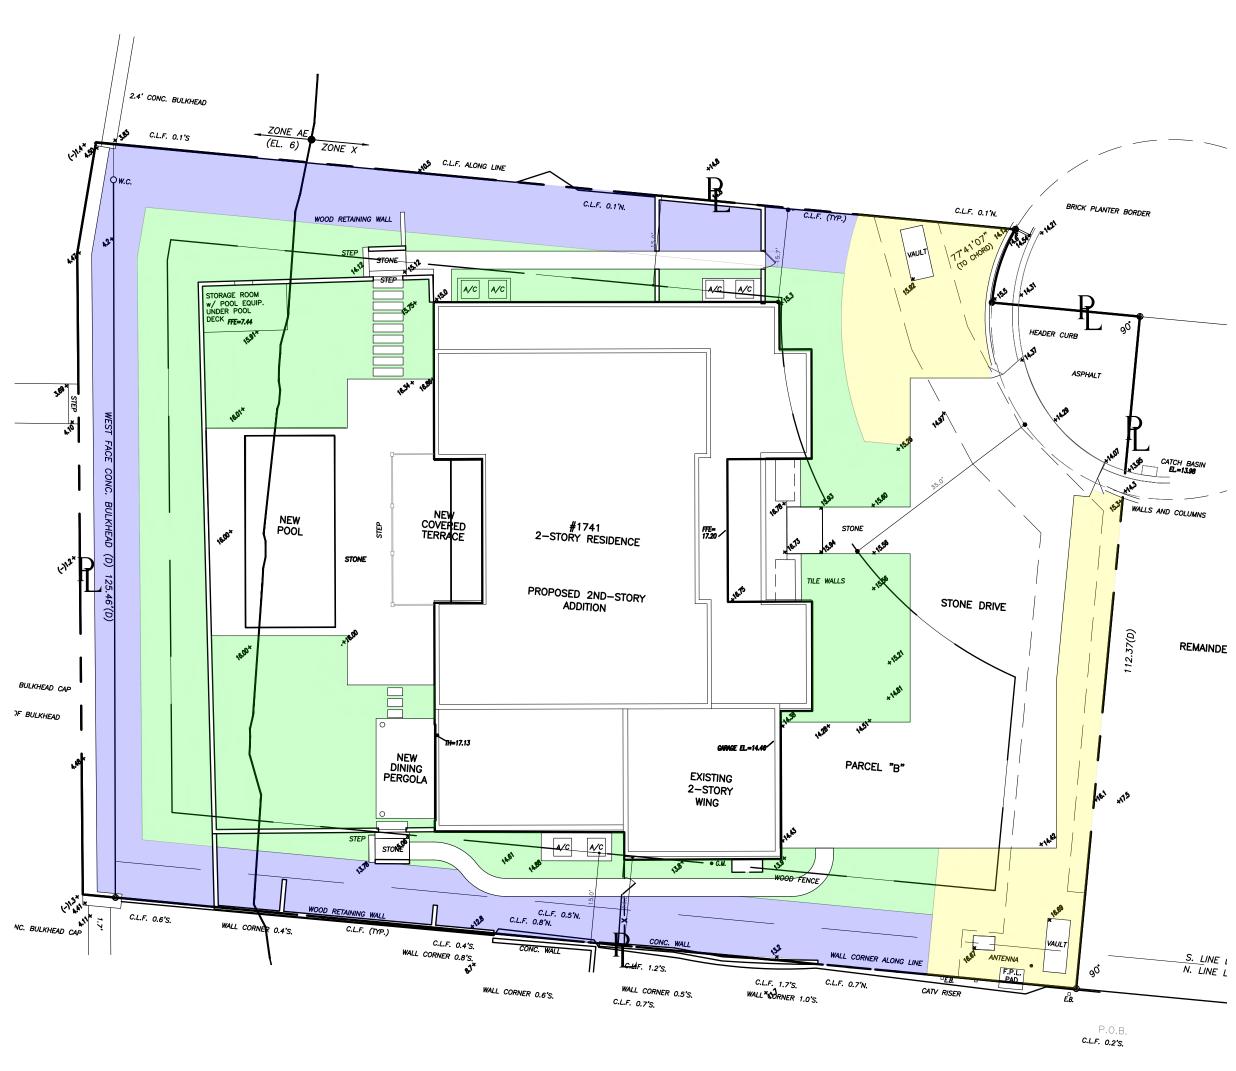
LANDSCAPE ARCHITECTURE
140 Royal Palm Way, Suite #206, Palm Beach, Florida 33480
Telephone: 561-655-9006 Fax: 561-655-9007
eMail: Office@smila.net www.smila.net
FL registration #LA 13000223

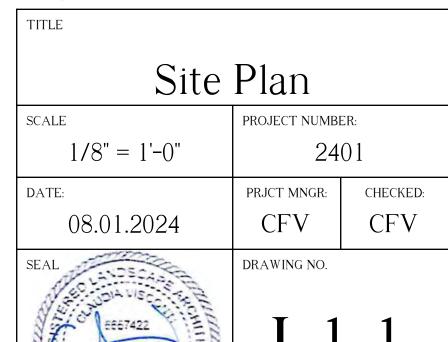

SHEET 1 OF 3

SMI TO APPROVE LAYOUT OF ALL HARDSCAPE MATERIAL PRIOR TO INSTALLATION



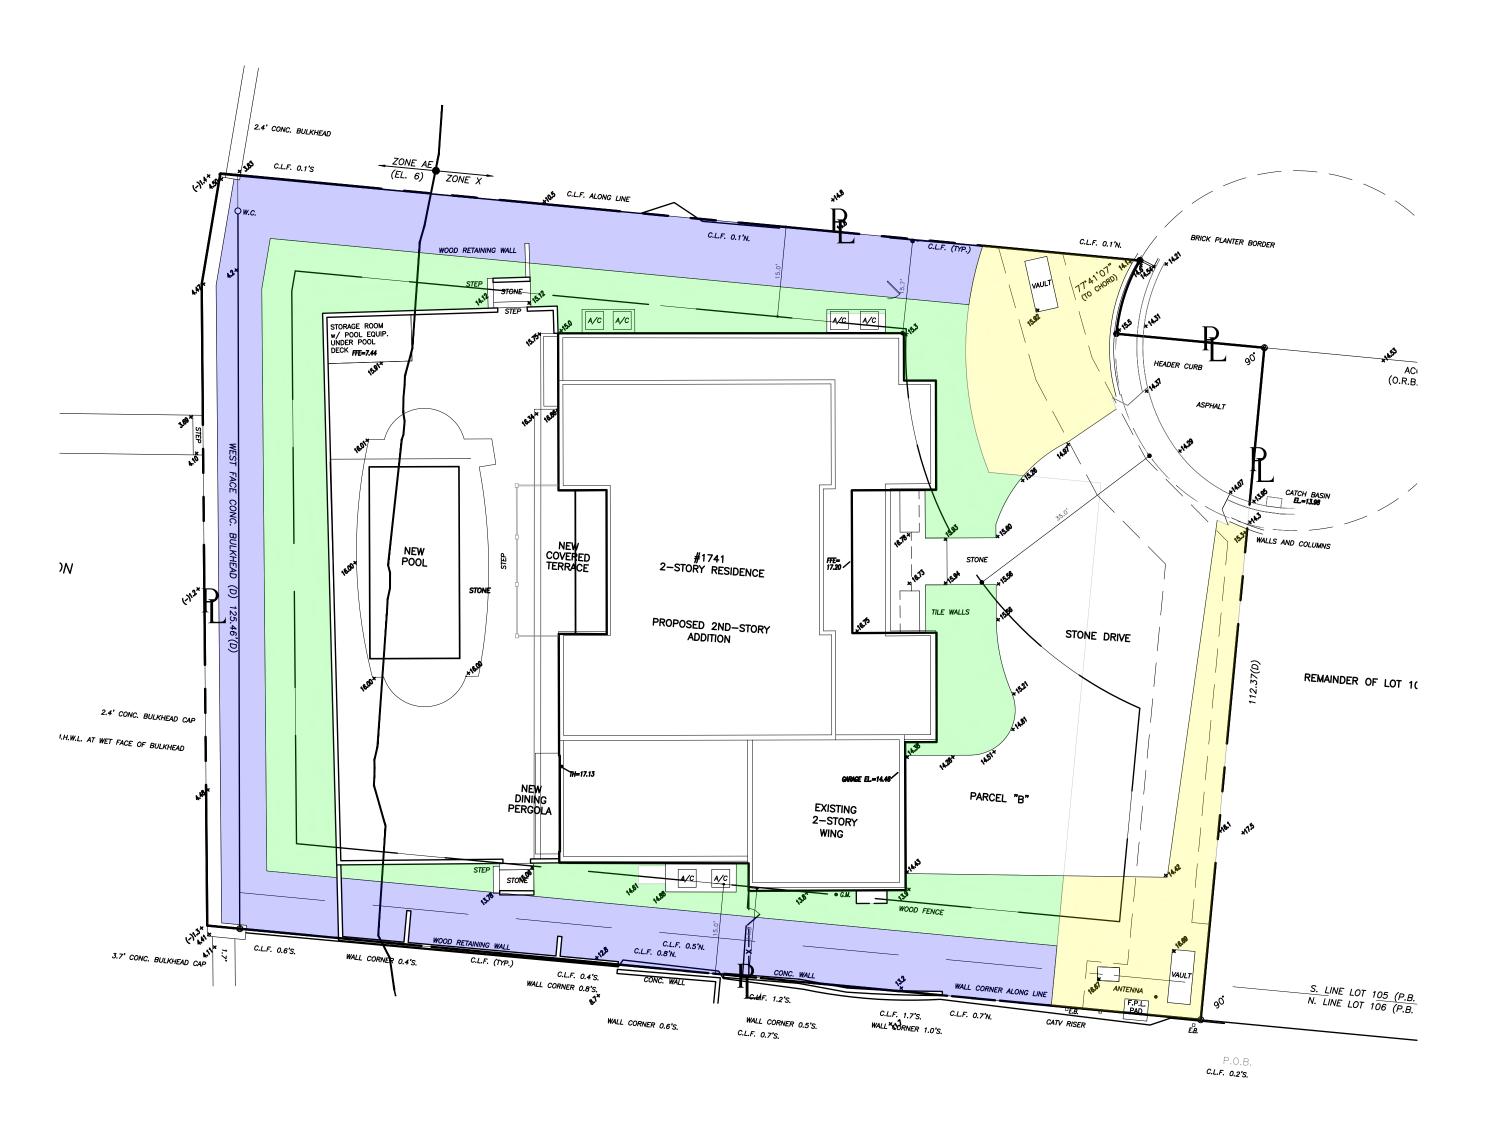

### EXISTING SITE PLAN

### Existing Color Key



Job # 2401


### Area Calculations:

All units in square feet, unless noted otherwise

R-A District	Required		Existing		Proposed	
It A District	Square Footage	Percentage	Square Footage	Percentage	Square Footage	Percentage
Open space/Pervious	8,388 or exist	50% or existing	8,388	39%	9,801	46%
Front Yard Pervious	1,665	45% or existing	1,665	45%	1,665	45%
Perimeter openspace	1,853	50% of of required open space shall be within 10' of the property line	3,705	92%	3,263	88%
Hardscape		7,751	35%	6,480	30%	
House		5,129	24%	5,389	25%	
Total Lot		21,268	100%	21,268	100%	

### PROPOSED SITE PLAN

### Proposed Color Key

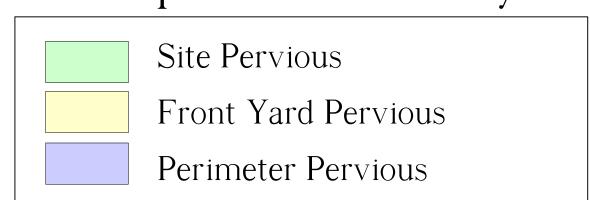



### Worth Avenue Ventures LLC

1741 South Ocean Blvd. Palm Beach, FL 33480



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-FOOTINGS FOR ALL STRUCTURES TO BE AT LEAST 3' BELOW GRADE TO ALLOW FOR PLANTINGS /

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DATE DESCRIPTION
REVISIONS


Preliminary

### SMI


140 Royal Palm Way, Suite #206, Palm Beach, Florida 33480 Telephone: 561-655-9006 eMail: Office@smila.net www.smila.net FL registration #LA 13000223

### Site Comparison Plan

SCALE	PROJECT NUMBI	ER:
N.T.S	24	01
DATE:	PRJCT MNGR:	CHECKED:
08.01.2024	CFV	CFV
SEAL	DRAWING NO.	

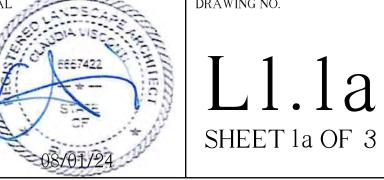



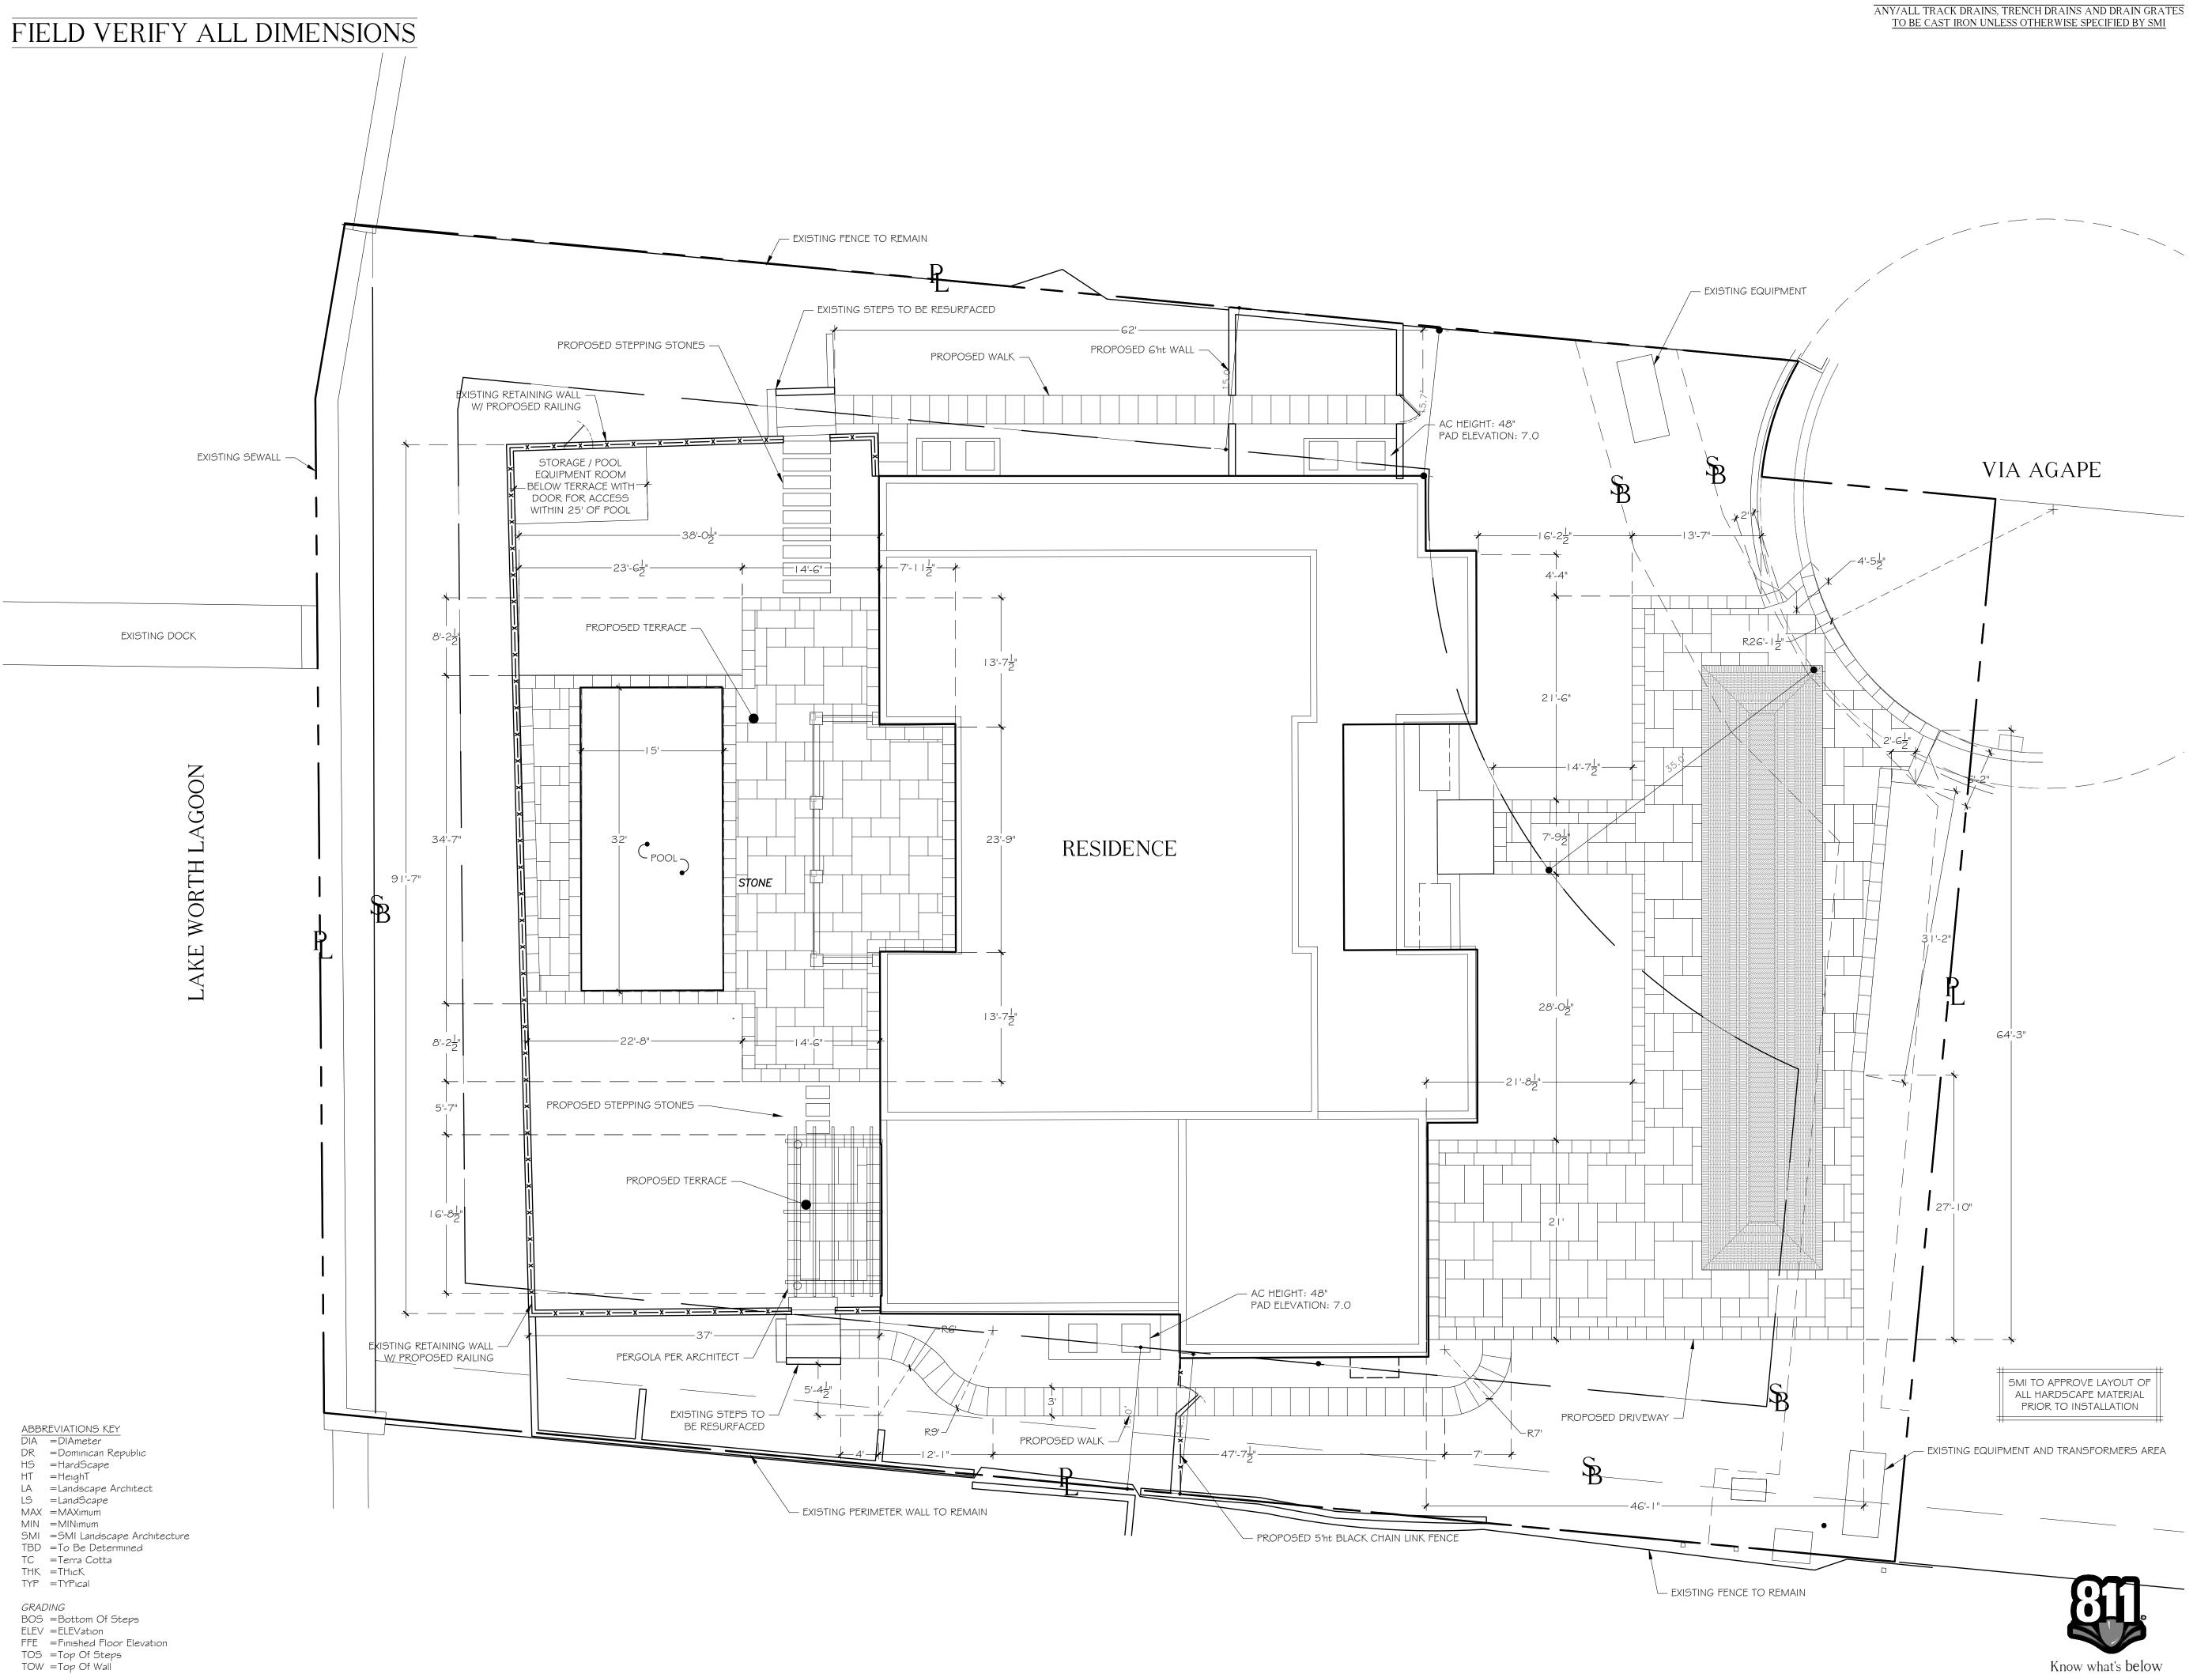

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DATE DESCRIPTION
REVISIONS

Preliminary

LANDSCAPE ARCHITECTURE 140 Royal Palm Way, Suite #206, Palm Beach, Florida 33480 Telephone: 561-655-9006 Fax: 561-655-9007 eMail: Office@smila.net www.smila.net FL registration #LA 13000223


TITLE

Know what's below

Call before you dig

### Hardscape Layout Plan

1		
SCALE	PROJECT NUMB	ER:
1/8" = 1'-0"	24	01
DATE:	PRJCT MNGR:	CHECKED:
08.01.2024	CFV	CFV
SEAL	DRAWING NO.	

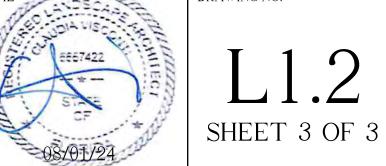

ANY/ALL TRACK DRAINS, TRENCH DRAINS AND DRAIN GRATES
TO BE CAST IRON UNLESS OTHERWISE SPECIFIED BY SMI FIELD VERIFY ALL DIMENSIONS




BOS =Bottom Of Steps

FFE = Finished Floor Elevation
TOS = Top Of Steps
TOW = Top Of Wall

ELEV = ELEVation




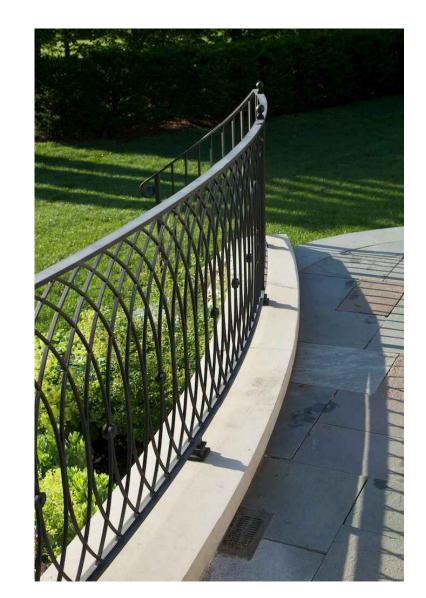


MOTORCOURT: LIMESTONE & PEBBLE INLAY

TERRACES & WALKWAY: LIMESTONE

RAILINGS AND GATES: ALUMINUM POWDER COATED (TEXTURED BLACK)

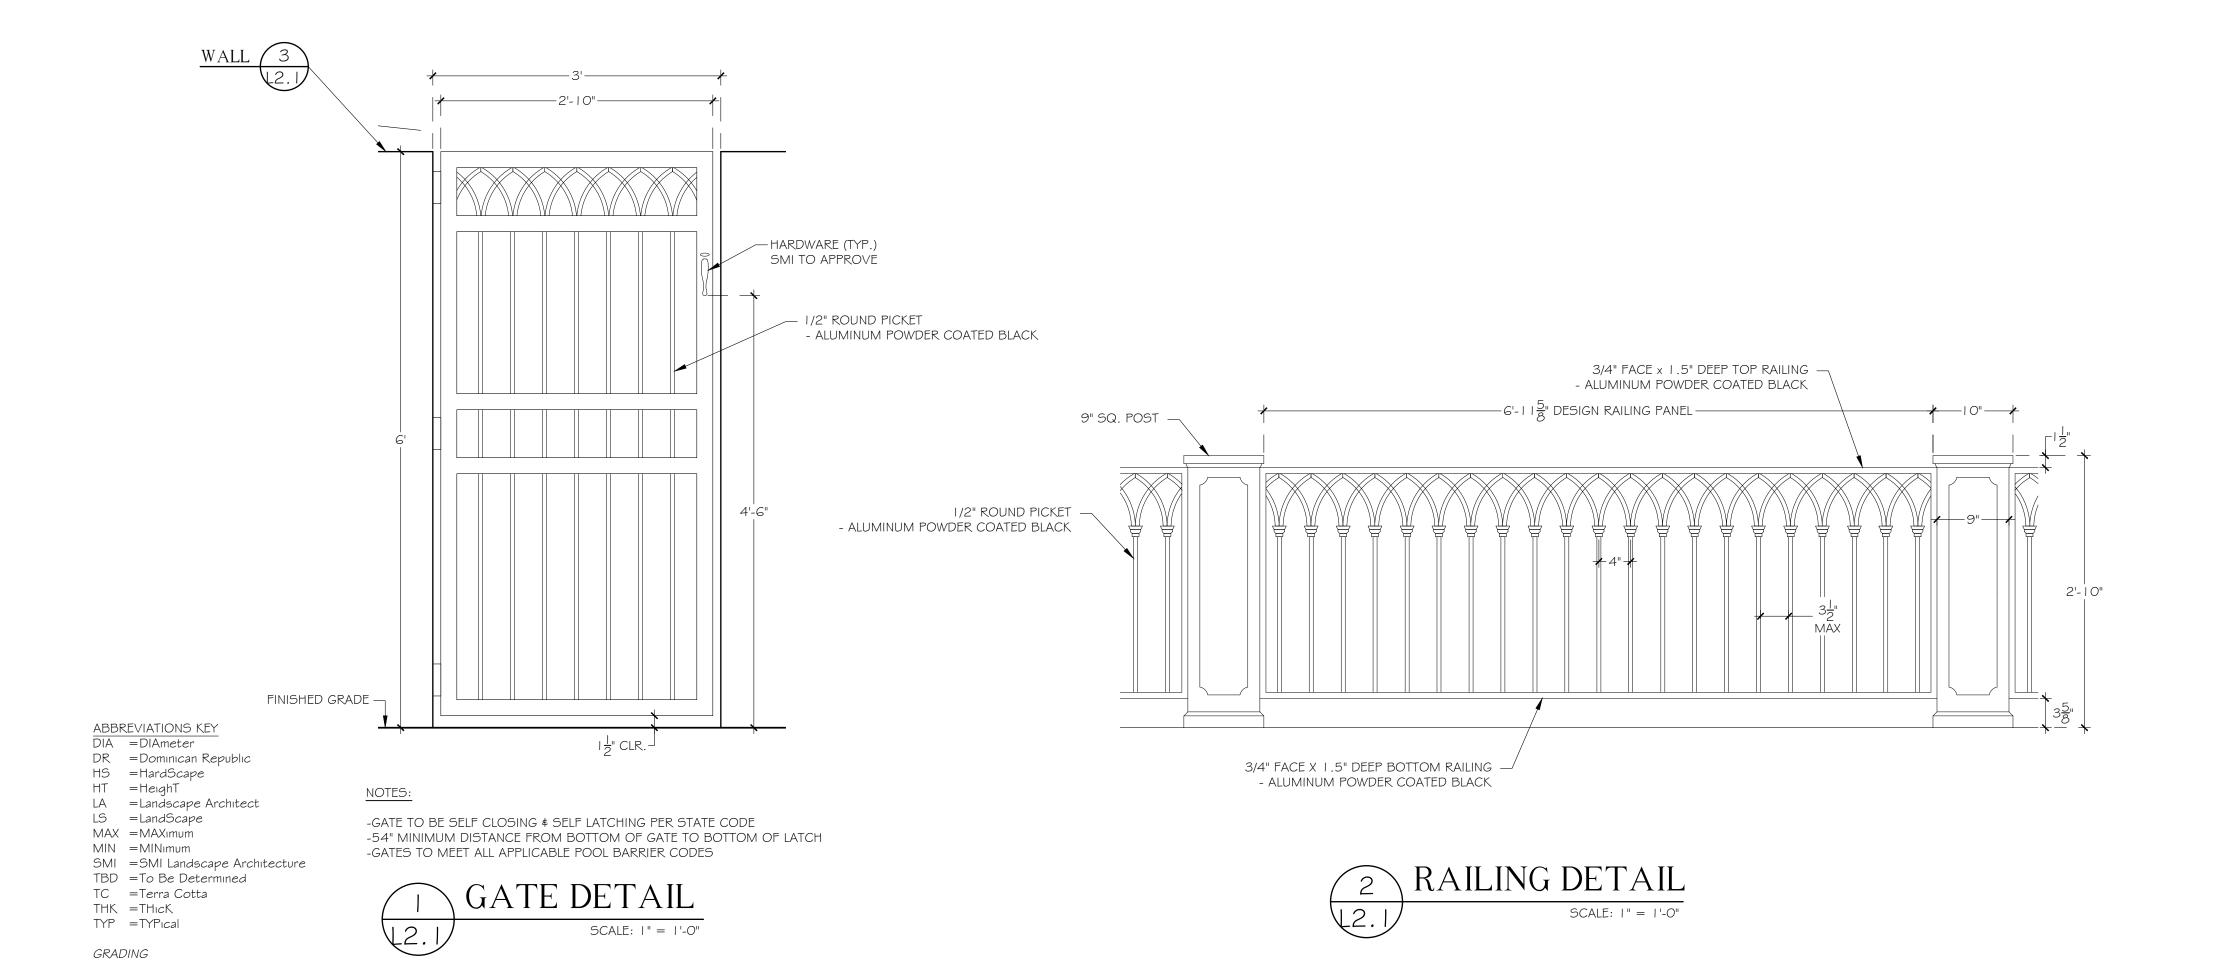

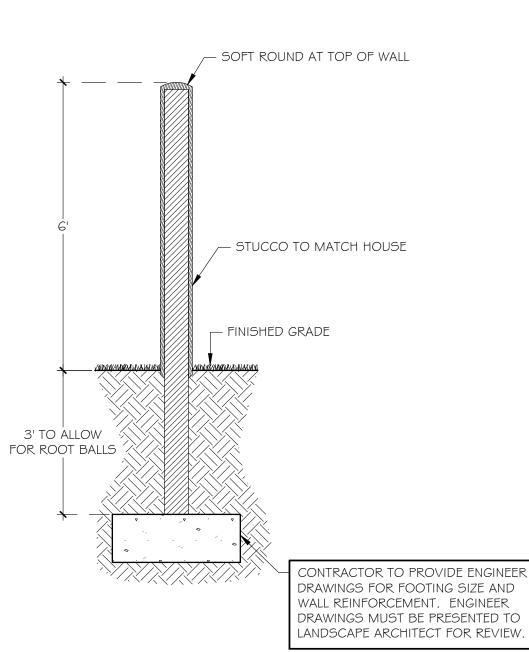





### Worth Avenue Ventures LLC

1741 South Ocean Blvd. Palm Beach, FL 33480

HARDSCAPE MOCK-UPS TO BE APPROVED BY OWNER / LA PRIOR TO INSTALLATION

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REVISIONS


Preliminary

LANDSCAPE ARCHITECTURE 140 Royal Palm Way, Suite #206, Palm Beach, Florida 33480 Telephone: 561-655-9006 Fax: 561-655-9007 eMail: Office@smila.net www.smila.net FL registration #LA 13000223

### Hardscape Details and Materials

SCALE	PROJECT NUMBI	ER:
As Noted	24	01
DATE:	PRJCT MNGR:	CHECKED:
08.01.2024	CFV	CFV
SEAL	DRAWING NO.	



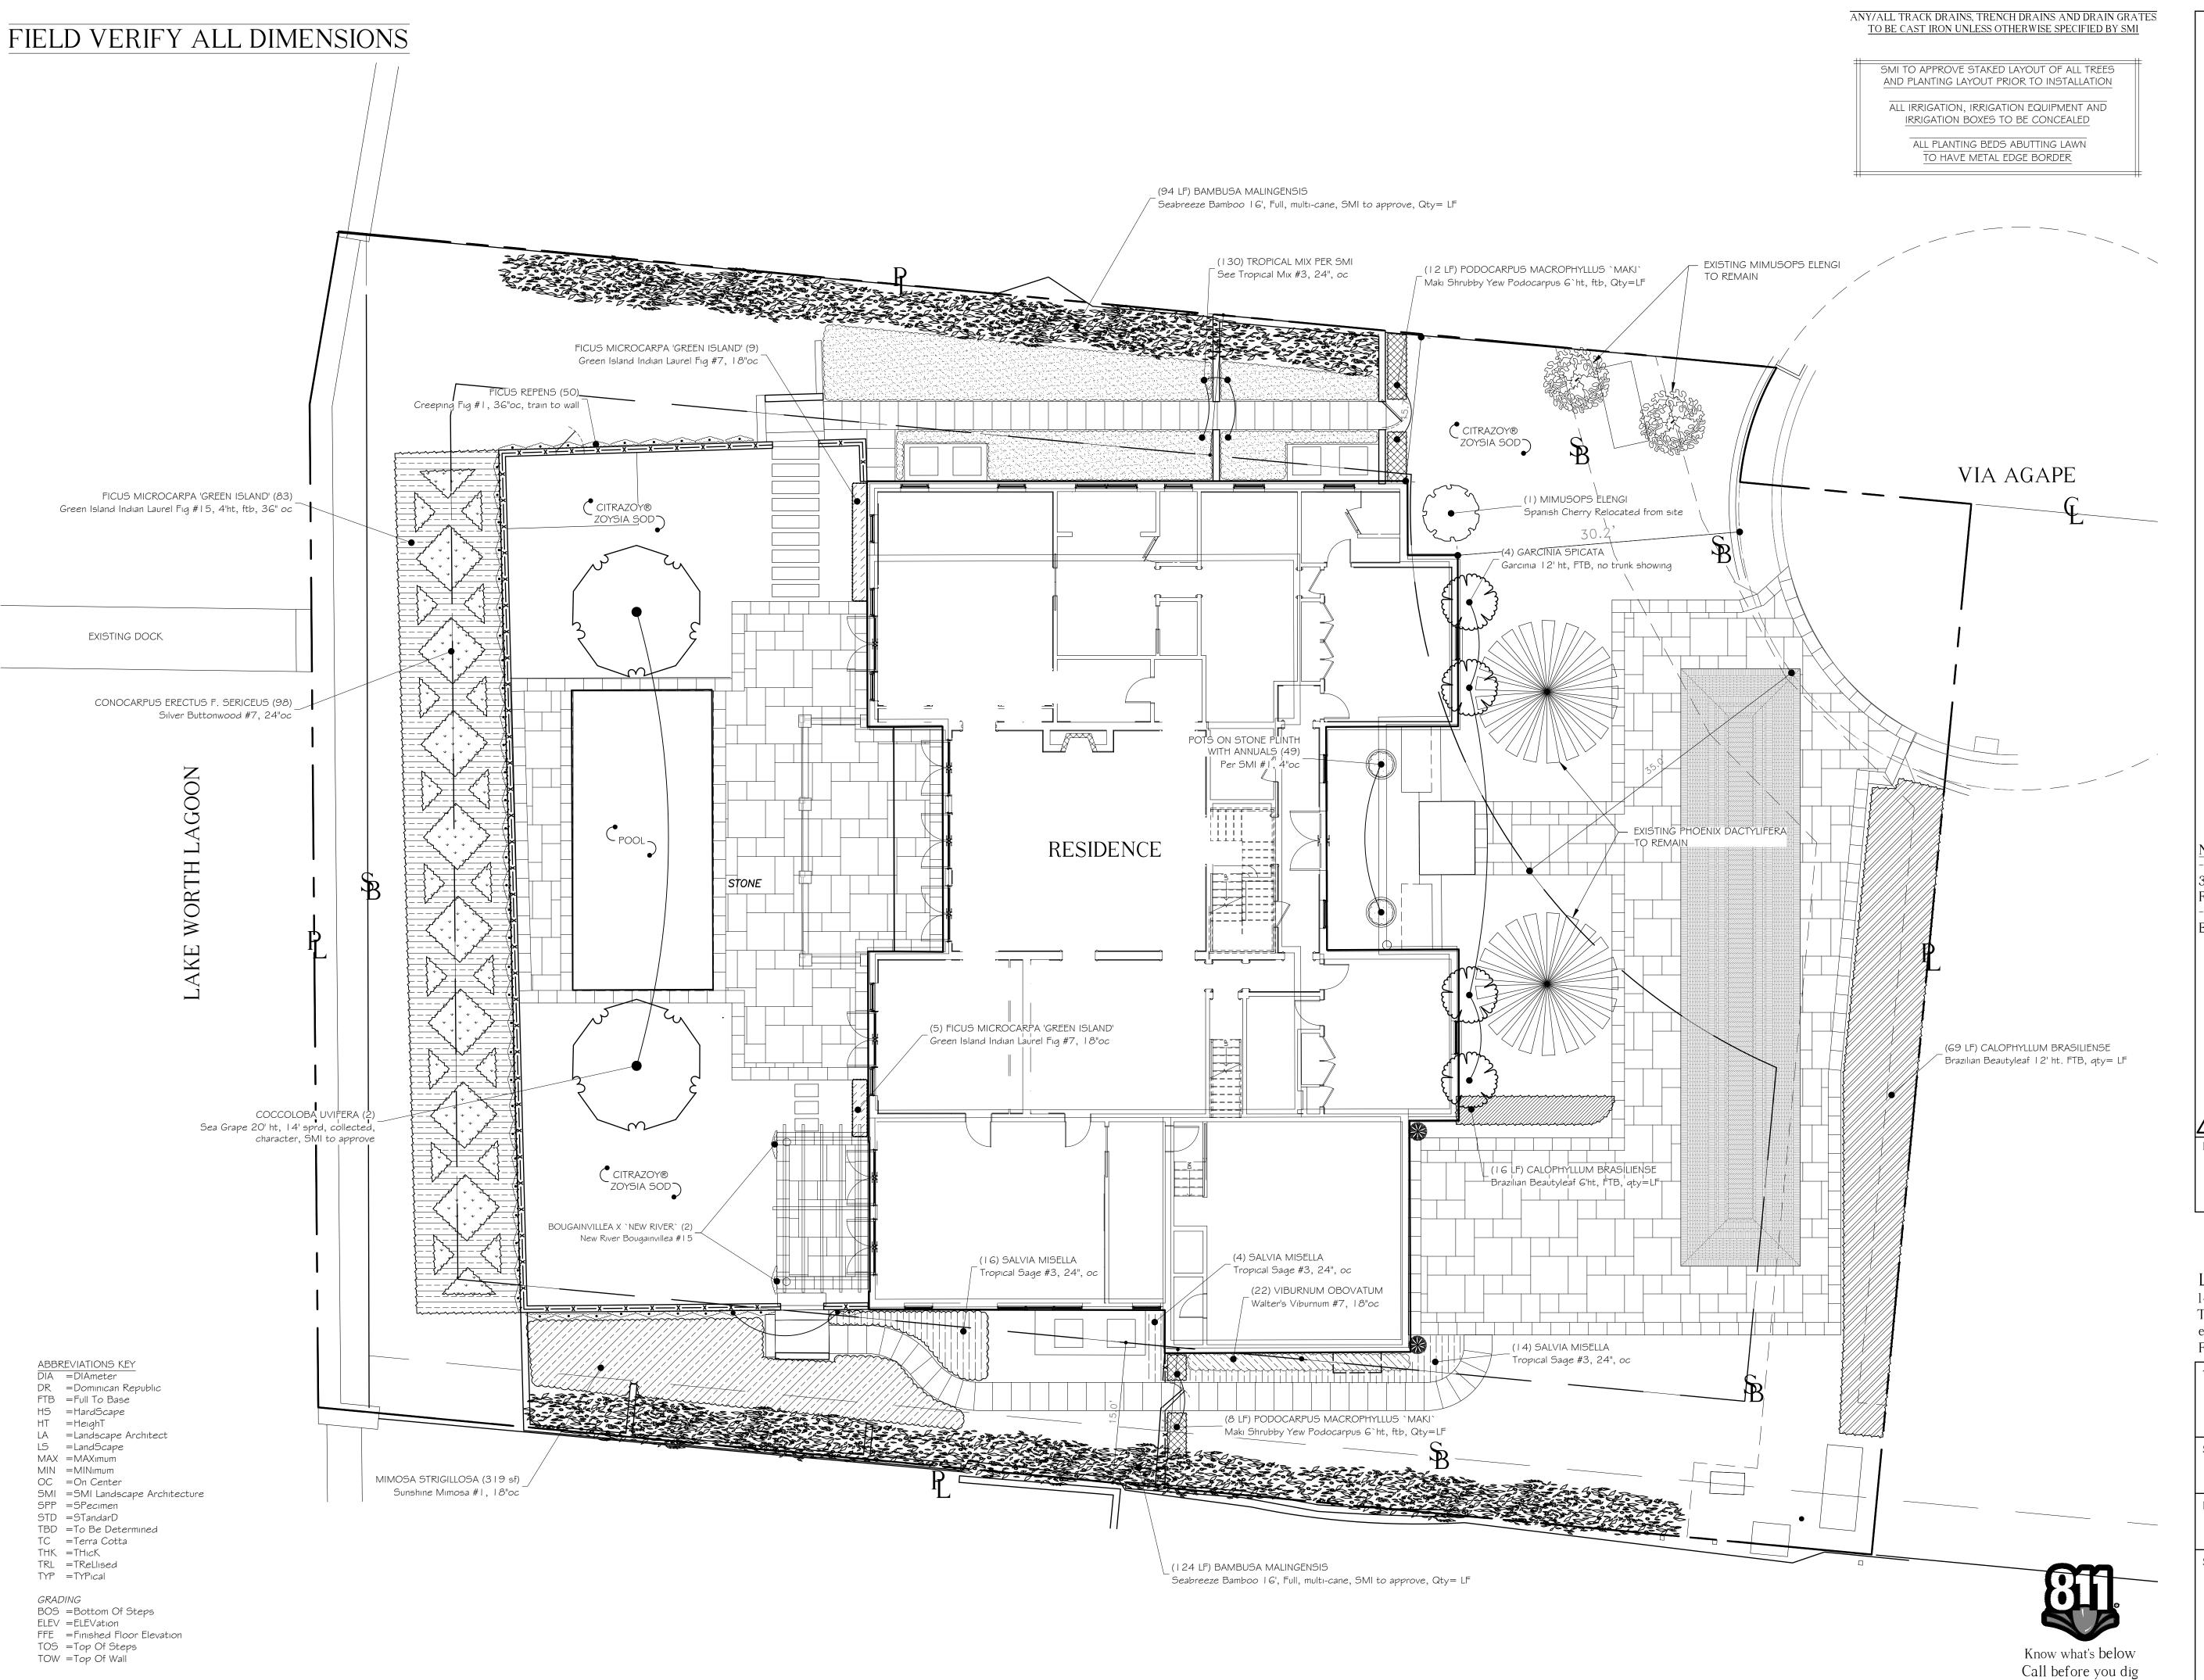

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NOTES:
-FOOTINGS FOR ALL STRUCTURES TO BE AT LEAST
3' BELOW GRADE TO ALLOW FOR PLANTINGS /
ROOT BALLS

-DRIP IRRIGATION MAY ONLY BE USED IF SPECIFIED BY SMI OR IF REQUIRED BY MUNICIPALITY

- 6 08.01.2024 PRESENTATION REV01 5 06.12.2024 PRESENTATION 4 05.10.2024 FINAL SUBMITTAL
- 4 05.10.2024 FINAL SUBMITTAL 3 04.29.2024 SECOND SUBMITTAL 2 04.11.2024 FIRST SUBMITTAL 1 04.01.2024 PRE APP

DATE DESCRIPTION
REVISIONS

Preliminary

### S M I


LANDSCAPE ARCHITECTURE
140 Royal Palm Way, Suite #206, Palm Beach, Florida 33480
Telephone: 561-655-9006 Fax: 561-655-9007
eMail: Office@smila.net www.smila.net
FL registration #LA 13000223


# Planting Plan SCALE 1/8" = 1'-0"PROJECT NUMBER: 2401DATE: 08.01.2024PRJCT MNGR: CHECKED: CFV SEAL DRAWING NO.




L3.1
SHEET 1 OF 3

### FIELD VERIFY ALL DIMENSIONS

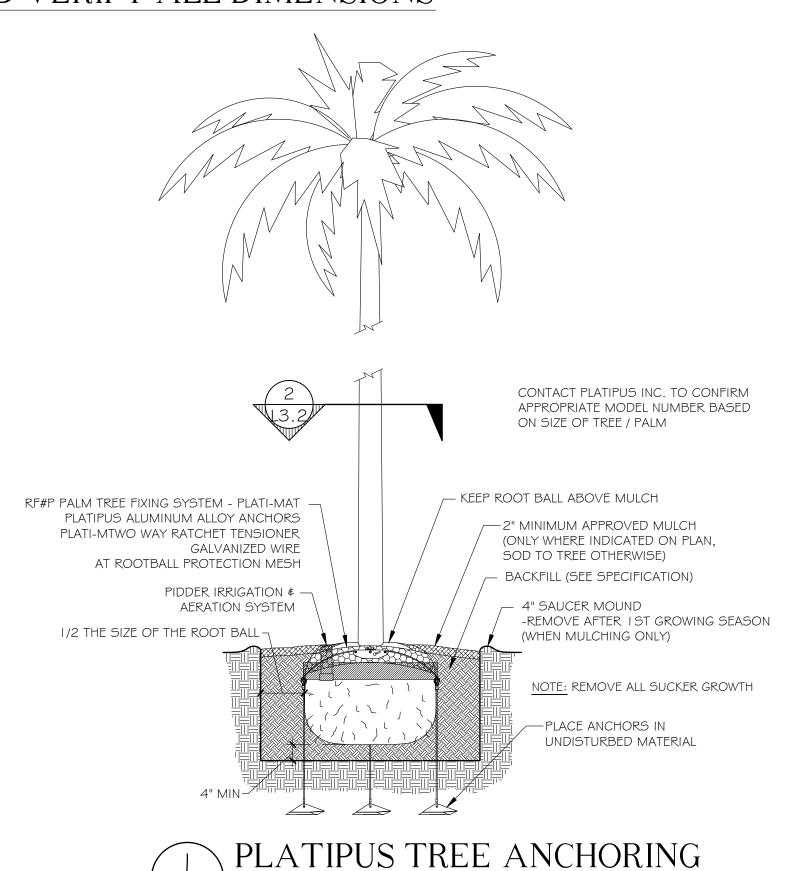

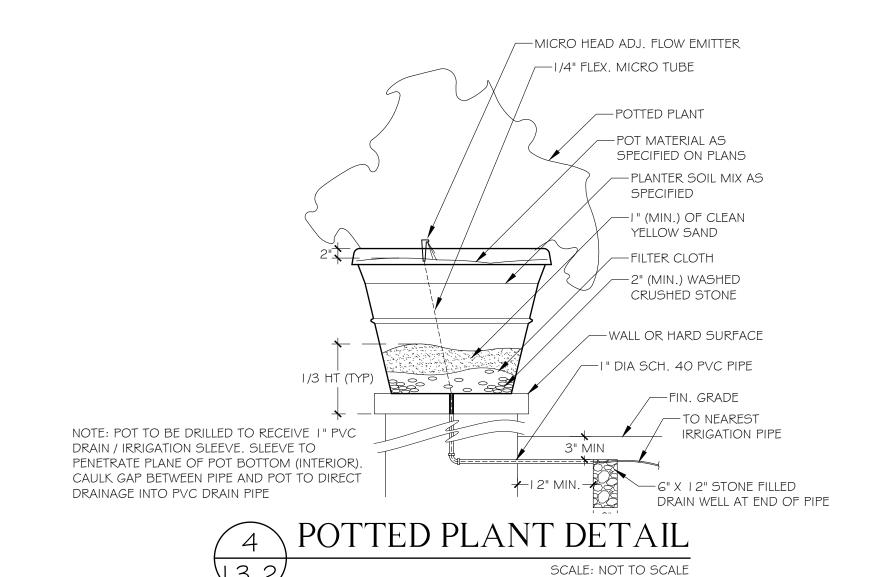


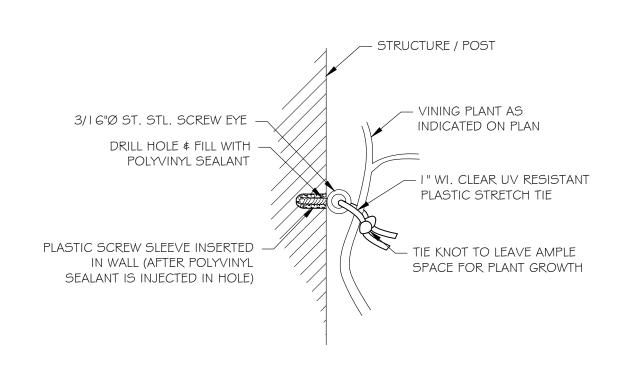


### PIN TO WALL



SCALE: NOT TO SCALE

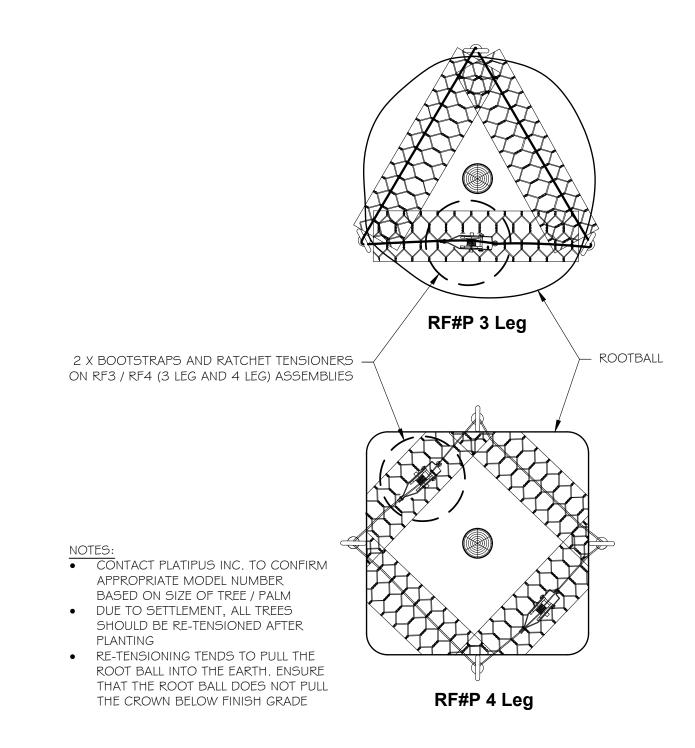


### PLATIPUS ROOTBALL BOOTSTRAP SCALE: NOT TO SCALE

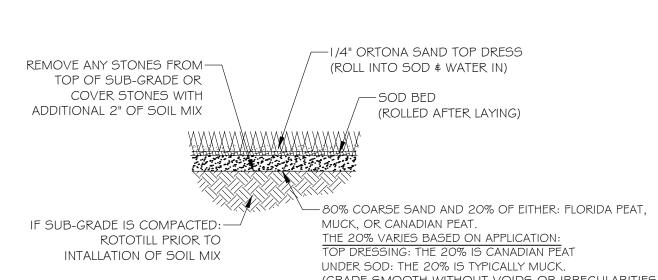

ALL SOD PLANTED BETWEEN STONE TO BE

CASHMERE ZOYSIA REGARDLESS OF



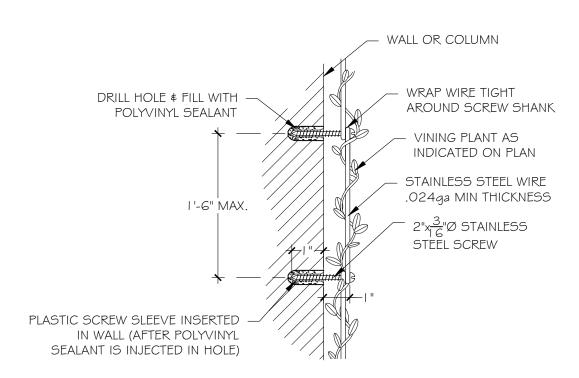


### WIRE TO WALL







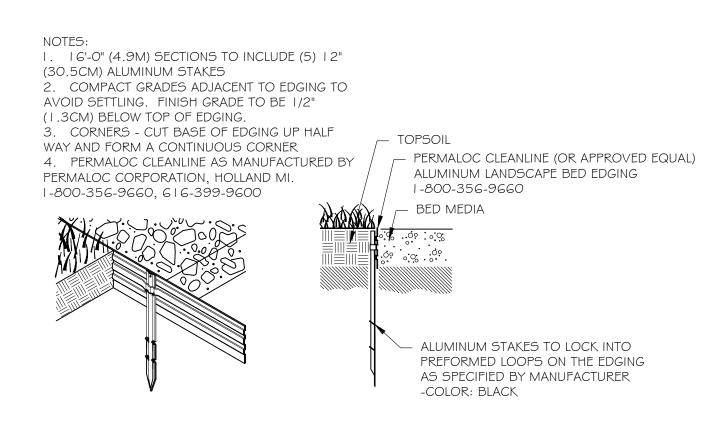







### SMI TO APPROVE STAKED LAYOUT OF ALL TREES AND PLANTING LAYOUT PRIOR TO INSTALLATION

ALL PLANTING BEDS TO HAVE STEEL EDGE BORDER

ALL IRRIGATION, IRRIGATION EQUIPMENT AND IRRIGATION BOXES TO BE CONCEALED


- KEEP ROOT CROWN ABOVE MULCH — 2" APPROVED MULCH - 3" SAUCER MOUND, REMOVE FINISHED GRADE -AFTER 1st GROWING SEASON

- BACKFILL (SEE SPECIFICATIONS)

TURN DOWN BURLAP

ONE THIRD IF B & B

SHRUB PLANTING DETAIL SCALE: NOT TO SCALE

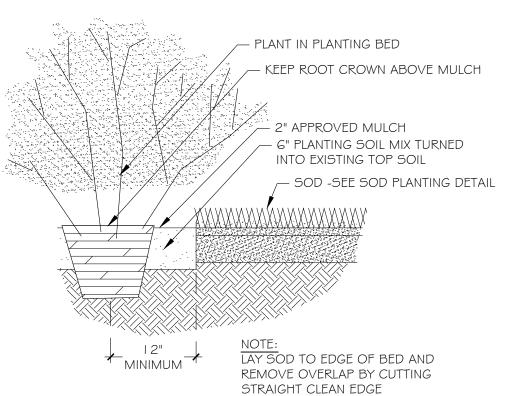



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LANDSCAPE ARCHITECTURE 140 Royal Palm Way, Suite #206, Palm Beach, Florida 33480 Telephone: 561-655-9006 Fax: 561-655-9007 eMail: Office@smila.net www.smila.net

TITLE Planting Details PROJECT NUMBER:

SCALE NOT TO SCALE 2401 CHECKED: PRJCT MNGR: CFV 08.01.2024 DRAWING NO.



SHEET 2 OF 3

PLEASE FURNISH FLORIDA CERTIFIED LANDSCAPE CONTACTORS (FCLC) REGISTRATION NUMBER WITH PROPOSAL.

GENERAL CONDITIONS

### SCOPE:

I. THE WORK INCLUDED IN THESE SPECIFICATIONS SHALL CONSIST OF THE FURNISHING OF ALL LABOR, TOOLS, MATERIALS, PERMITS, ETC., NECESSARY FOR THE EXECUTION OF THE WORK AS HEREIN SPECIFIED AND SHOWN ON THE

2. THE LANDSCAPE CONTRACTOR SHALL INSTALL ALL MATERIAL IN ACCORDANCE WITH SOUND NURSERY PRACTICE AND SHALL PERFORM MAINTENANCE AND WATERING UNTIL FINAL COMPLETION AND ACCEPTANCE BY THE LANDSCAPE ARCHITECT.

### EXAMINATION OF DRAWINGS AND SITE:

I. THE LANDSCAPE CONTRACTOR SHALL EXAMINE THE SITE AND FULLY ACQUAINT HIMSELF WITH ALL OF THE EXISTING CONDITIONS IN ORDER THAT NO MISUNDERSTANDING MAY AFTERWARDS ARISE AS TO THE CHARACTER OR AS TO THE EXTENT OF THE WORK TO BE DONE, AND LIKEWISE, IN ORDER TO ADVISE AND ACQUAINT HIMSELF WITH ALL PRECAUTIONS TO BE TAKEN IN ORDER TO AVOID INJURY TO PERSONS OR PROPERTY OF ANOTHER. NO ADDITIONAL COMPENSATION WILL BE GRANTED BECAUSE OF ANY UNUSUAL DIFFICULTIES THAT MAY BE ENCOUNTERED IN THE EXECUTION OR MAINTENANCE OF ANY PORTION OF THE WORK. ANY DISCREPANCIES, OR OMISSIONS OR DOUBTS AS TO MEANING SHALL BE COMMUNICATED TO THE LANDSCAPE ARCHITECT, WHO WILL MAKE ANY INTERPRETATIONS HE/SHE DEEMS NECESSARY.

### PLANT LIST:

I. ANY DISCREPANCY BETWEEN THE PLANT LIST AND THE DRAWINGS SHALL BE CONSIDERED AS CORRECT ON THE DRAWINGS.

### PROTECTION OF PUBLIC AND PROPERTY:

I. THE LANDSCAPE CONTRACTOR SHALL PROTECT ALL MATERIALS AND WORK AGAINST INJURY FROM ANY CAUSE AND SHALL PROVIDE AND MAINTAIN ALL NECESSARY GUARDS FOR THE PROTECTION OF THE PUBLIC. HE SHALL BE HELD RESPONSIBLE FOR ANY DAMAGE OR INJURY TO A PERSON OR PROPERTY WHICH MAY OCCUR AS A RESULT OF HIS FAULT OR NEGLIGENCE IN THE EXECUTION OF THE WORK.

2. THE LANDSCAPE CONTRACTOR SHALL MAINTAIN WORKMAN'S COMPENSATION, COMPREHENSIVE GENERAL LIABILITY INSURANCE (\$1,000,000) AND PROPERTY DAMAGE INSURANCE (\$1,000,000.00). A COPY OF THE CERTIFICATE OF INSURANCE MUST BE FURNISHED TO OWNER.

### GUARANTEE:

I. THE GUARANTEE PERIOD FOR ALL MATERIAL SHALL BEGIN AFTER FINAL APPROVAL BY LANDSCAPE ARCHITECT.

2. ALL MATERIAL EXCEPT SOD SHALL BE GUARANTEED FOR ONE YEAR PROVIDED IT RECEIVES PROPER MAINTENANCE (AS PRESCRIBED BY THE LANDSCAPE CONTRACTOR) BY THE OWNER AND IS NOT DAMAGED OR DESTROYED BY HURRICANES OR OTHER CAUSES BEYOND THE CONTRACTOR'S

3. IT IS THE RESPONSIBILITY OF THE LANDSCAPE CONTRACTOR TO BRING TO THE ATTENTION OF THE LANDSCAPE ARCHITECT THE OWNERS NEGLECT TO PROVIDE PROPER CARE OF THE MATERIAL

4. ALL REPLACEMENT COST OF GUARANTEED MATERIAL, INCLUDING EQUIPMENT AND LABOR, SHALL BE THE RESPONSIBILITY OF THE CONTRACTOR

### AWARD OF CONTRACT:

I. ONLY UNIT PRICE-INSTALLED BIDS FOR THE WORK WILL BE ACCEPTABLE. HOMEVER, THE OWNER RETAINS THE RIGHT TO DELETE PORTIONS OF THE WORK FROM THE CONTRACT AND/OR AWARD SEPARATE CONTRACTS FOR PHASES OF THE PROJECT. THE LANDSCAPE ARCHITECT RESERVES THE RIGHT TO REJECT ANY AND ALL BIDS WHEN SUCH REJECTIONS ARE IN THE INTEREST OF THE

### EXECUTION OF THE WORK:

I. THE LANDSCAPE CONTRACTOR SHALL HAVE HIS LABOR CREWS CONTROLLED AND DIRECTED BY A LANDSCAPE FOREMAN WELL VERSED IN PLANT MATERIALS, PLANTING, READING OF BLUEPRINTS AND COORDINATION BETWEEN JOB AND NURSERY IN ORDER TO EXECUTE INSTALLATION RAPIDLY AND CORRECTLY.

### MATER:

I. WATER SOURCE SHALL BE FURNISHED BY THE OWNER.

2. IT IS THE RESPONSIBILITY OF THE LANDSCAPE CONTRACTOR TO COORDINATE HIS WORK WITH IRRIGATION CONTRACTOR.

3. ALL PLANT MATERIAL INSTALLED PRIOR TO THE INSTALLATION OF THE IRRIGATION SYSTEM SHALL BE WATERED WITH A TEMPORARY SYSTEM BY THE LANDSCAPE CONTRACTOR.

### IRRIGATION:

-DRIP IRRIGATION MAY ONLY BE USED IF SPECIFIED BY SMI OR IF REQUIRED BY MUNICIPALITY

### GRADING:

I. THE GENERAL CONTRACTOR SHALL BE RESPONSIBLE FOR ALL SUBGRADE OF LANDSCAPE AREAS UNLESS OTHERWISE SPECIFIED. THE TERM SUBGRADE SHALL BE DEFINED AS 4"-6" BELOW FINISH GRADE UNLESS OTHERWISE NOTED ON

2. THE LANDSCAPE CONTRACTOR SHALL BE RESPONSIBLE FOR ALL FINISHED AND FINE GRADING WITHIN PLANTER BEDS AND THE FILLING OF PLANTER BOXES. THE LANDSCAPE CONTRACTOR SHALL REMOVE ALL EXCESS SOIL AND DEBRIS ACCUMULATED DURING HIS WORK.

3. THE SOD CONTRACTOR SHALL BE RESPONSIBLE FOR FINISH GRADE IN ALL SODDED AREAS. SEE SPECIFICATIONS RELATING TO SPECIES GROWERS.

### DIGGING

I. THE LANDSCAPE CONTRACTOR SHALL EXERCISE CARE IN DIGGING AND OTHER WORK SO AS NOT TO DAMAGE EXISTING WORK, INCLUDING UNDERGROUND AND OVERHEAD PIPES AND CABLES. SHOULD SUCH UNDERGROUND AND OVERHEAD OBSTRUCTIONS BE ENCOUNTERED WHICH INTERFERE WITH PLANTING, THE LANDSCAPE ARCHITECT OR THE OWNER'S AUTHORIZED REPRESENTATIVE SHALL BE CONSULTED AND WILL ADJUST THE LOCATION OF PLANTS TO CLEAR SUCH OBSTRUCTION OR MOVE THE OBSTRUCTION.

2. THE LANDSCAPE CONTRACTOR SHALL BE RESPONSIBLE FOR THE IMMEDIATE REPAIR OF ANY DAMAGE CAUSED BY HIS WORK PLANTING PITS

I. EXCAVATE CIRCULAR PITS WITH VERTICAL SIDES FOR ALL PLANTS, EXCEPT FOR HEDGES AND PLANTS SPECIFICALLY DESIGNATED TO BE PLANTED IN BEDS DIAMETER OF PITS OF TREES AND SHRUBS SHALL BE AT LEAST 1/3 LARGER THAN THE DIAMETER OF THE BALL

2. EXCAVATE PLANTING PITS AND PLANTING BEDS, PREPARE FINE SUBGRADE THROUGHOUT ALL PITS AND BEDS, AND PLACE THE PLANTS TO BE PLANTED FOR APPROVAL BY LANDSCAPE ARCHITECT BEFORE INSTALLATION.

I. REMOVE DEAD AND BROKEN BRANCHES FROM ALL PLANT MATERIAL IMMEDIATELY. PRUNE TO RETAIN TYPICAL GROWTH HABIT OF INDIVIDUAL PLANTS WITH AS MUCH HEIGHT AND SPREAD AS IS PRACTICAL.

2. HEDGE MATERIALS TO BE PULLED IN, TIED AND TRIMMED TO VERTICAL AFTER INSTALLATION, WITH A FINISHED APPEARANCE UNLESS OTHERWISE NOTED.

### TREE BRACING AND GUYING

I. LARGE TREES AND PALMS SHALL BE BRACED WITH CYPRESS POLES OR CLEAN LUMBER. BRACES SHALL BE PAINTED MATTE GREEN FINISH

2. SMALL TREES SHALL BE GUYED IN THREE DIRECTIONS WITH THREE STRANDS OF NO. 12 GALVANIZED WIRE ATTACHED TO ANCHORS DRIVEN BELOW GRADE. WIRES WHICH COME IN CONTACT WITH THE TREE ARE TO BE ENCASED IN RUBBER

### PLANT MATERIALS

I. NOMENCLATURE: PLANT NAMES SHALL CONFORM TO THE NAMES GIVEN IN HORTUS III AND IN STANDARDIZED PLANT NAMES, 2001, LATEST EDITION. PREPARED BY THE AMERICAN JOINT COMMITTEE ON HORTICULTURAL NOMENCLATURE. NAMES OF VARIETIES NOT INCLUDED THEREIN, CONFORM GENERALLY WITH NAMES ACCEPTED IN THE NURSERY TRADE.

2. QUALITY: PLANTS SHALL HAVE A HABIT OF GROWTH THAT IS NORMAL FOR THE SPECIES AND SHALL BE SOUND, HEALTHY, VIGOROUS AND FREE FROM INSECT PESTS, PLANT DISEASES AND INJURIES. TREES SHALL BE HEAVILY BRANCHED, OR IN PALMS, HEAVILY LEAFED. REQUIREMENTS FOR THE MEASUREMENT, BRANCHING GRADING, QUALITY, BALLING AND BURLAPPING OF PLANTS IN THE PLANT LISTS GENERALLY FOLLOW THE CODE OF STANDARDS CURRENTLY RECOMMENDED BY THE AMERICAN ASSOCIATION OF NURSERYMEN, INC., AND THE AMERICAN STANDARD FOR NURSERY STOCK. PLANT MATERIAL SHALL BE GRADED AS SPECIFIED ON THE DRAWINGS

GRADES SHALL CONFORM TO GRADES AND STANDARDS FOR NURSERY STOCK, STATE PLANT BOARD OF FLORIDA. PALMS WITH MARRED OR BURNED TRUNKS WILL NOT BE ACCEPTED. PLANTS WITH BROKEN, DAMAGED, OR INSUFFICIENT BALLS WILL BE REJECTED. ALL PLANTS SHALL BE FLORIDA FANCY.

3. SUBSTITUTIONS WILL BE PERMITTED ONLY UPON WRITTEN APPROVAL BY THE LANDSCAPE ARCHITECT.

### PLANTING SOIL

### SOIL BY 'ATLAS SOIL' OR APPROVED ALTERNATE

ALL PLANTING AREAS SHALL BE CLEANED OF ALL PLANT AND MATERIAL TWO WEEKS PRIOR TO INSTALLATION OF SOIL FOR REMOVAL OF ANY WEEDS.

GROUND COVER BEDS -REMOVE 6" OF EXISTING SOIL AND FILL WITH 4" OF 8270 MIX & TILL/MIX INTO EXISTING SOIL.

SHRUB BEDS -REMOVE 6" OF EXISTING SOIL AND FILL WITH A MIX OF 50% APPROVED SOIL \$ 50% EXISTING SOIL

TREE PITS -REMOVE SOIL IN THE AMOUNT OF 1/2 LARGER THAN THE BALL OF THE TREE AND REPLACE WITH A MIX OF 50% APPROVED SOIL \$ 50% EXISTING SOIL.

PALMS -REMOVE SOIL IN THE AMOUNT OF 1/2 LARGER THAN THE BALL OF THE PALM AND REPLACE WITH APPROPRIATE SOIL AND CLEAN YELLOW SAND FREE OF WEEDS.

### SOIL SPECS FOR PLANTING BEDS: ATLAS PEAT & SOIL 8270 MIX 20% can peat 25% fla peat 40% pine bark <u>15% airlite</u>

SMILA SOIL MIX (APPROVED SOIL) 50% Pinebark 40% Florida Peat 10% Coarse Sand 10lbs Dolomite per/Yard 18.5lbs TurfPro per/Yard 25 pounds Nutricote 18/6/8-360 P/yard optional.

SOIL SPECS FOR TREES AND LARGE SHRUBS:

. SOLE SOURCE - FROM ATLAS PEAT & SOIL INC., P.O. BOX 3867, BOYNTON BEACH, FLORIDA, 33424-3867, (561) 734-7300

PLANTING SOIL NOT MEETING THESE REQUIREMENTS WILL NOT BE ACCEPTED.

I. SOIL FOR PLANTING TREES, SHRUBS AND GROUND COVER SHALL BE SMILA SOIL UNLESS OTHERWISE SPECIFIED ON THE DRAWINGS.

GRADING PLAN AND GRADING SPECIFICATIONS. 3. LANDSCAPE ARCHITECT MAY REQUEST SOIL ANALYSIS FOR THE TESTING OF PLANTING SOIL UTILIZED BY THE SELECTED LANDSCAPE CONTRACTOR.

2. IT SHALL BE THE RESPONSIBILITY OF THE LANDSCAPE CONTRACTOR TO

REMOVE ANY EXCESS SOIL AND DEBRIS FROM THE SITE. REFER TO THE

TO PROTECT AGAINST GANODERMA PALM FUNGUS ALWAYS REMOVE ALL PALM STUMPS FROM PROPERTY - STUMPS ACT AS HOSTS TO THIS DESTRUCTIVE LONG LIVED FUNGUS.

### FERTILIZER

I. TREES USE ONE 21 GRAM AGRIFORM PLANTING TABLET PER 1/2" TRUNK DIAMETER. SPACE EQUALLY AROUND AT 2/3 DEPTH OF BALL.

2. SHRUBS: AGRIFORM PLANTING TABLETS SHALL BE APPLIED PER THE MANUFACTURERS SUGGESTED APPLICATION RATES.

3. SOD USE FERTILIZER AS PER BELOW WITH TRACE ELEMENTS APPLIED AT THE RATE OF 15 LBS. PER 1000 SQ. FT. PRIOR TO LAYING SOD.

4. POWDERED MYCCHORIZAE MIX; <u>DIE HARD</u>, 'PLANT HEALTH' CARE OR EQUAL) [2 AND LIQUID B-THRIVE (OR EQUAL) SHOULD BE ADDED TO ALL TREES, SHRUBS AND GROUND COVER PLANTING BEDS AS PER MANUFACTERES DIRECTIONS.

5. ALL TREES, SHRUBS, GROUND COVER AND SOD TO USE LESCO 13-3-13 FERTILIZER AS PER MANUFACTURERS SPECIFICATIONS

### MULCH

ALL MULCH FOR THE PROJECT SHALL BE ATLAS GROW. MULCH SHALL BE APPLIED 2" IN TREES AND PALMS AS SPECIFIED, AND ALL PLANTING BEDS, HEDGE AND SHRUBS. KEEP CROWN OF ROOT BALL ABOVE

SOLE SOURCE - FROM ATLAS PEAT \$ SOIL INC., P.O. BOX 3867, BOYNTON BEACH, FLORIDA, 33424-3867, (561) 134-1300

SUBMIT BAG TO LANDSCAPE ARCHITECT FOR APPROVALS.

SABAL PALMS

I. SABAL PALMS SHALL HAVE A MINIMUM TRUNK DIAMETER OF 12" MEASURED 2" ABOVE GROUND.

### HEDGES

I. THE LANDSCAPE CONTRACTOR SHALL PROVIDE FULL MATERIAL TO PRODUCE QTY A SOLID SCREEN FROM THE TOP OF HEDGE TO THE BASE OF HEDGE.

2. THE LANDSCAPE CONTRACTOR SHALL BE RESPONSIBLE TO ADD FILLERS TO 319 sf | Mimosa strigillosa THE HEDGE AS NEEDED TO PRODUCE A SOLID FULL TO BASE (F.T.B.), SCREEN TO BE INCLUDED IN THE CONTRACTED PRICE. 3. PLANT MATERIAL WITH WEAK OR THIN FOLIAGE WILL NOT BE ACCEPTED

I. MATERIALS & INSTALLATION OF VINE SUPPORTS SHALL BE <u>INCLUDED</u> IN UNIT COST OF VINE SPECIFIED

### SODDING

I. THE LANDSCAPE CONTRACTOR SHALL SOD ALL AREAS INDICATED AND NOTED ON THE DRAWINGS.

2. NO SODDING SHALL OCCUR UNTIL ALL AREAS TO BE SODDED ARE CLEARED OF ANY ROUGH GRASS, WEEDS, AND DEBRIS, THE GROUND BROUGHT TO AN EVEN GRADE AND SPECIFIED AMENDMENTS HAVE BEEN ADDED. SEE DETAILS FOR SPECIFIC AMENDMENTS AS PER SOD TYPE. ALL SODDED AREAS WILL BE TREATED WITH 'ROUNDUP' HERBICIDE PER MANUFACTURER'S SPECIFICATIONS AT LEAST TEN DAYS PRIOR TO SOD INSTALLATION.

3. THE SOD SHALL BE FIRM, TOUGH TEXTURE, HAVING A COMPACTED GROWTH OF GRASS WITH GOOD ROOT DEVELOPMENT. IT SHALL CONTAIN NO NOXIOUS WEEDS, OR ANY OTHER OBJECTIONABLE VEGETATION, FUNGUS, INSECTS OR DISEASE. PREPARATION OF AREAS SHALL BE PERFORMED WELL ENOUGH IN ADVANCE TO ALLOW SUFFICIENT TIME TO WORK PROPERLY. THE SOIL EMBEDDED IN THE SOD SHALL BE GOOD, CLEAN EARTH, FREE FROM STONES AND DEBRIS. THE SOD SHALL BE FREE FROM FUNGUS, VERMIN, AND OTHER DISEASES.

4. BEFORE BEING CUT AND LIFTED, THE SOD SHALL HAVE BEEN MOMED AT LEAST THREE TIMES WITH A LAWN MOWER, WITH THE FINAL MOWING NOT MORE THAN SEVEN DAYS BEFORE THE SOD IS CUT. THE SOD SHALL BE CAREFULLY CUT INTO UNIFORM DIMENSIONS.

5. SOLID SOD SHALL BE LAID WITH CLOSELY ABUTTING JOINTS WITH A TAMPED OR ROLLED EVEN SURFACE.

6. WATERING SHALL BE ACCOMPLISHED UNTIL ACCEPTANCE OF THE WORK BY THE LANDSCAPE ARCHITECT.

7. MAINTENANCE OF MATERIAL SHALL BE THE RESPONSIBILITY OF THE LANDSCAPE CONTRACTOR UNTIL FINAL APPROVAL OF LANDSCAPE ARCHITECT.

8. IT SHALL BE THE RESPONSIBILITY OF THE LANDSCAPE CONTRACTOR TO BRING THE SOD EDGE IN A NEAT, CLEAN MANNER TO THE EDGE OF ALL PAVING AND SHRUB AREAS. 9. SEE PLANS FOR DETAILS. RE: SOD VARIETIES

IO. FOR SOD, APPLY DEPTH OF SOIL AS PER PLANTING DETAILS PAGE. REMOVE ANY STONES FROM TOP OF SUB-GRADE OR COVER STONES WITH ADDITIONAL 2" OF SOIL MIX.

II. ALL SOD AREA SHALL BE TREATED WITH 'ROUND UP' TWO WEEKS PRIOR TO INSTALLATION FOR REMOVAL OF ANY EXISTING OBJECTIONABLE PLANTS. DOSAGE AND APPLICATION PER MANUFACTURERS SPECIFICATIONS.

### CLEAN UP

I. THE LANDSCAPE CONTRACTOR SHALL AT ALL TIMES KEEP THE PREMISES FREE FROM ACCUMULATIONS OF WASTE MATERIALS OR RUBBISH CAUSED BY HIS EMPLOYEES OR WORK. HE SHALL LEAVE ALL PAVED AREAS "BROOM CLEAN" WHEN COMPLETED WITH THE WORK.

2. MARKS AND DAMAGE TO EXISTING PAVING MATERIALS SHALL BE THE RESPONSIBILITY OF THE LANDSCAPE CONTRACTOR.

ALL PALMS, TREES, AND LARGE SPECIMEN PLANTS SHALL BE STAKED BY THE LANDSCAPE CONTRACTOR FOR LA APPROVAL OF LAYOUT AND LOCATIONS PRIOR TO INSTALLING SAME.

TREE STAKE PAINT FORMULA BEHR PREMIUM PLUS EXT FLAT -ACCENT BASE (4670) 01 09 THALO GREEN YELLOW OXIDE 02 04 0 LAMP BLACK 0 00 0

SUBMIT SAMPLE

QUANTITIES FOR LARGE HEDGES / BUFFERS REPRESENT LINEAR FEET OF PLANT, UNLESS NOTED OTHERWISE IN THE PLANT SIZE SPEC

### PLANT LIST All plants to be Florida Fancy

PLANT SCHEDULE QTY BOTANICAL NAME **COMMON NAME** SIZE Coccoloba uvifera Sea Grape 20' ht, 14' sprd, collected, character, SMI to approve Garcinia spicata Garcinia 12' ht. FTB. no trunk showing Spanish Cherry Relocated from site Mimusops elengi 16', Full, multi-cane, SMI to approve, Qty= LF Bambusa malingensis Seabreeze Bamboo Calophyllum brasiliense Brazilian Beautyleaf 12' ht. FTB, aty= LF 6'ht, FTB, qty=LF Calophyllum brasiliense Brazilian Beautyleaf Podocarpus macrophyllus `Maki` Maki Shrubby Yew Podocarpus 6 ht. ftb. Qtv=LF New River Bougainvillea Bougainvillea x `New River` Ficus repens #1, 36"oc, train to wall Creeping Fig QTY BOTANICAL NAME **COMMON NAME** #7, 24"oc Silver Buttonwood Conocarpus erectus f. sericeus #15, 4'ht, ftb, 36" oc Ficus microcarpa 'Green Island' Green Island Indian Laurel Fig #7. 18"oc Ficus microcarpa 'Green Island' Green Island Indian Laurel Fig Pots on stone plinth with Annuals | Per SMI #1, 4"oc See Tropical Mix #3, 24", oc Tropical mix per smi Walter's Viburnum #7, 18"oc Viburnum obovatum |BOTANICAL NAME COMMON NAME SIZE Sunshine Mimosa #1, 18"oc Tropical Sage #3, 24", oc

Tropical Mix List				
QTY	BOTANICAL NAME	COMMON NAME	SIZE	NOTES
21	Alocasia odora	Elephant Ear	#3, 24"oc	Not Native
22	Begonia odorata 'Alba'	White Sweet Begonia	#3, 24"oc	Not Native
22	Farfugium japonicum	Leopard Plant	#3, 24"oc	Not Native
22	Monstera deliciosa	Split-Leaf Philodendron	#3, 24"oc	Not Native
22	Philodendron x 'Burle Marx'	Burle Marx Philodendron	#3, 24"oc	Not Native
21	Philodendron x 'Congo'	Congo Philodendron	#3, 24"oc	Not Native

SMI TO APPROVE STAKED LAYOUT OF ALL TREES AND PLANTING LAYOUT PRIOR TO INSTALLATION

ALL IRRIGATION, IRRIGATION EQUIPMENT AND

ALL PLANTING BEDS TO HAVE STEEL EDGE BORDER

IRRIGATION BOXES TO BE CONCEALED SMI TO APPROVE LOCATIONS OF ANY / ALL IRRIGATION BOXES

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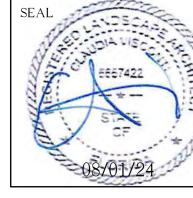
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TITLE Planting Specifications PROJECT NUMBER: SCALE

NONE 2401 DATE: CHECKED: PRJCT MNGR 08.01.2024 CFV DRAWING NO.





SHEET 3 OF 3

FIELD VERIFY ALL DIMENSIONS

### Town of Palm Beach

Planning Zoning and Building 360 S County Rd Palm Beach, FL 33480 www.townofpalmbeach.com

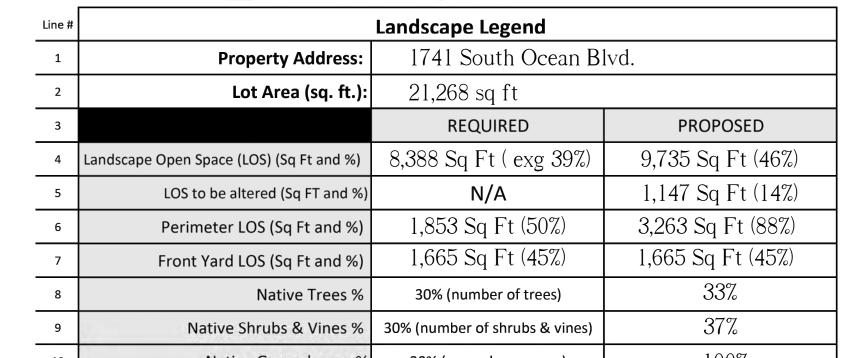

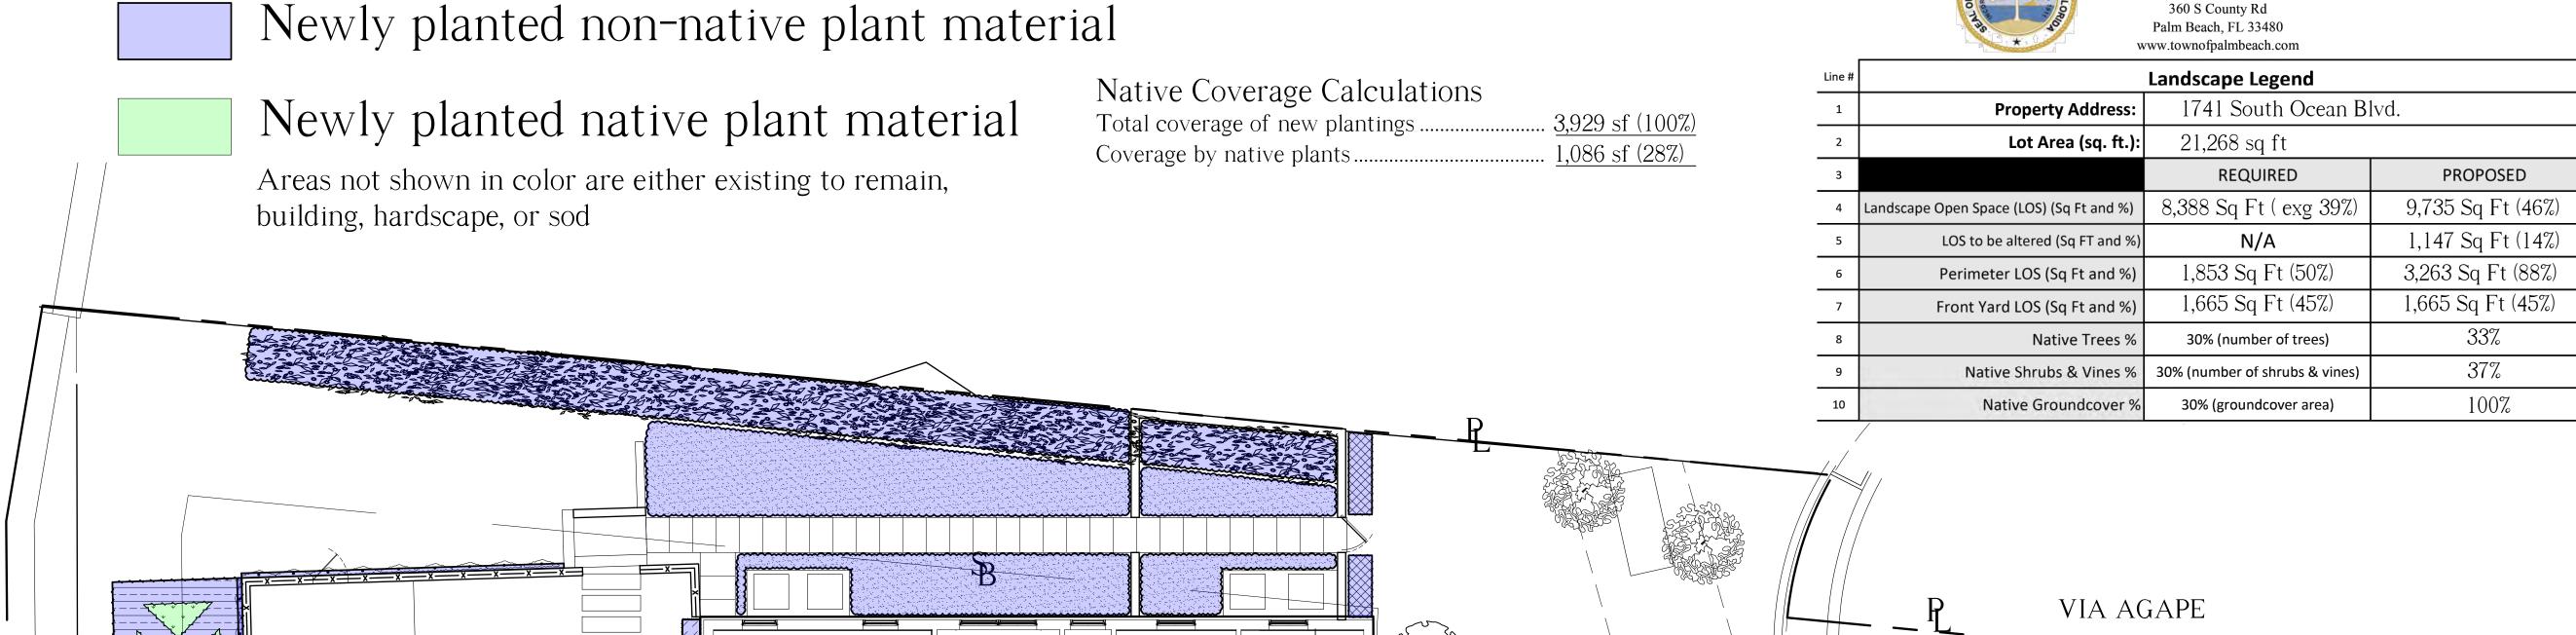

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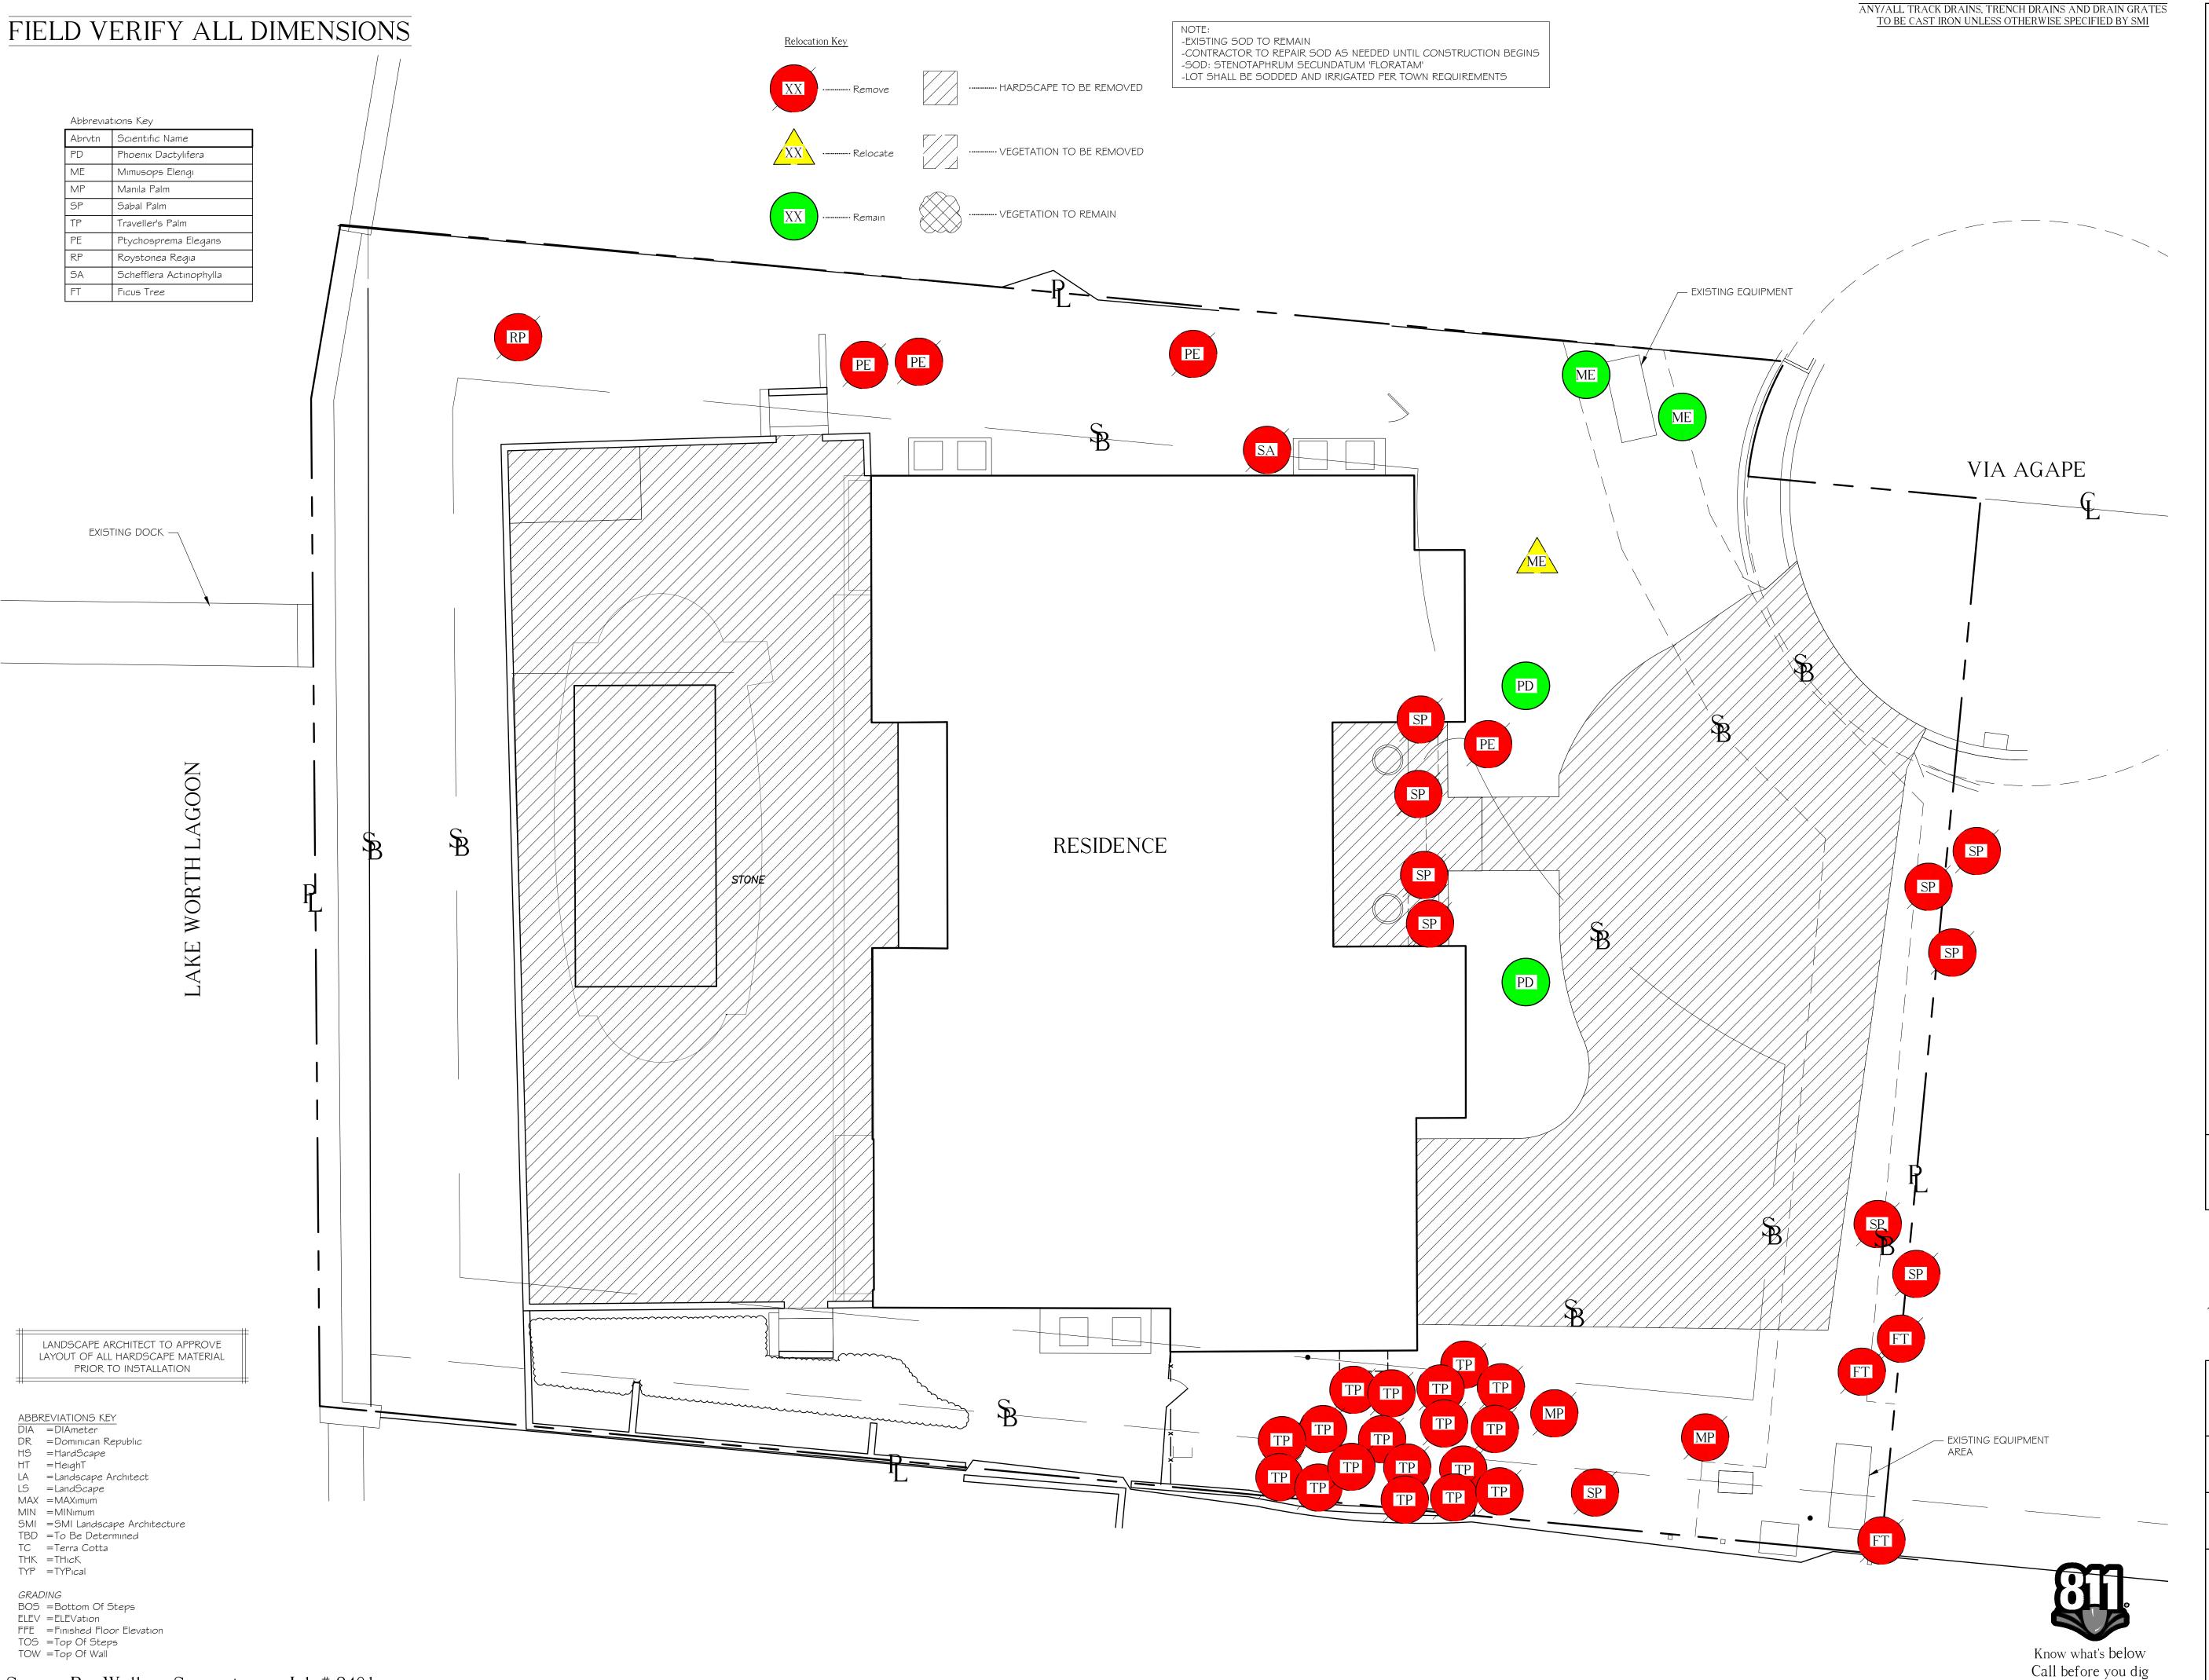
Preliminary

LANDSCAPE ARCHITECTURE 140 Royal Palm Way, Suite #206, Palm Beach, Florida 33480 Fax: 561-655-9007 Telephone: 561-655-9006 eMail: Office@smila.net www.smila.net FL registration #LA 13000223

### TITLE Native Calculations SCALE PROJECT NUMBER: 1/8" = 1'-0" 2401 PRJCT MNGR: CHECKED: 08.01.2024 CFV DRAWING NO.

SHEET 1 OF 1

POOL



1741 South Ocean Blvd. Palm Beach, FL 33480



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NOTES:
-FOOTINGS FOR ALL STRUCTURES TO BE AT LEAST
3' BELOW GRADE TO ALLOW FOR PLANTINGS /
ROOT BALLS

-DRIP IRRIGATION MAY ONLY BE USED IF SPECIFIED BY SMI OR IF REQUIRED BY MUNICIPALITY


- 6 08.01.2024 PRESENTATION REV01 5 06.12.2024 PRESENTATION
- 4 05.10.2024 FINAL SUBMITTAL 3 04.29.2024 SECOND SUBMITTAL
- 3 04.29.2024 SECOND SUBMITTAL
   2 04.11.2024 FIRST SUBMITTAL
   1 04.01.2024 PRE APP


DATE DESCRIPTION
REVISIONS

Preliminary

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Telephone: 561-655-9006 Fax: 561-655-9007
eMail: Office@smila.net www.smila.net
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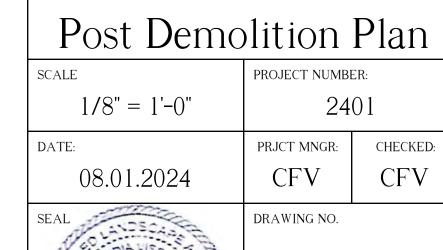
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- 2 04.11.2024 FIRST SUBMITTAL 1 04.01.2024 PRE APP

DATE DESCRIPTION
REVISIONS
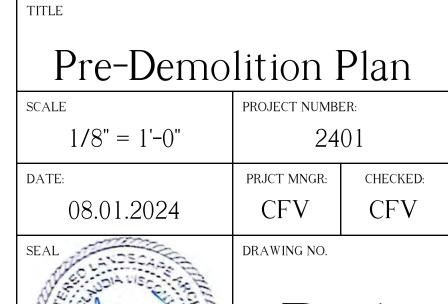
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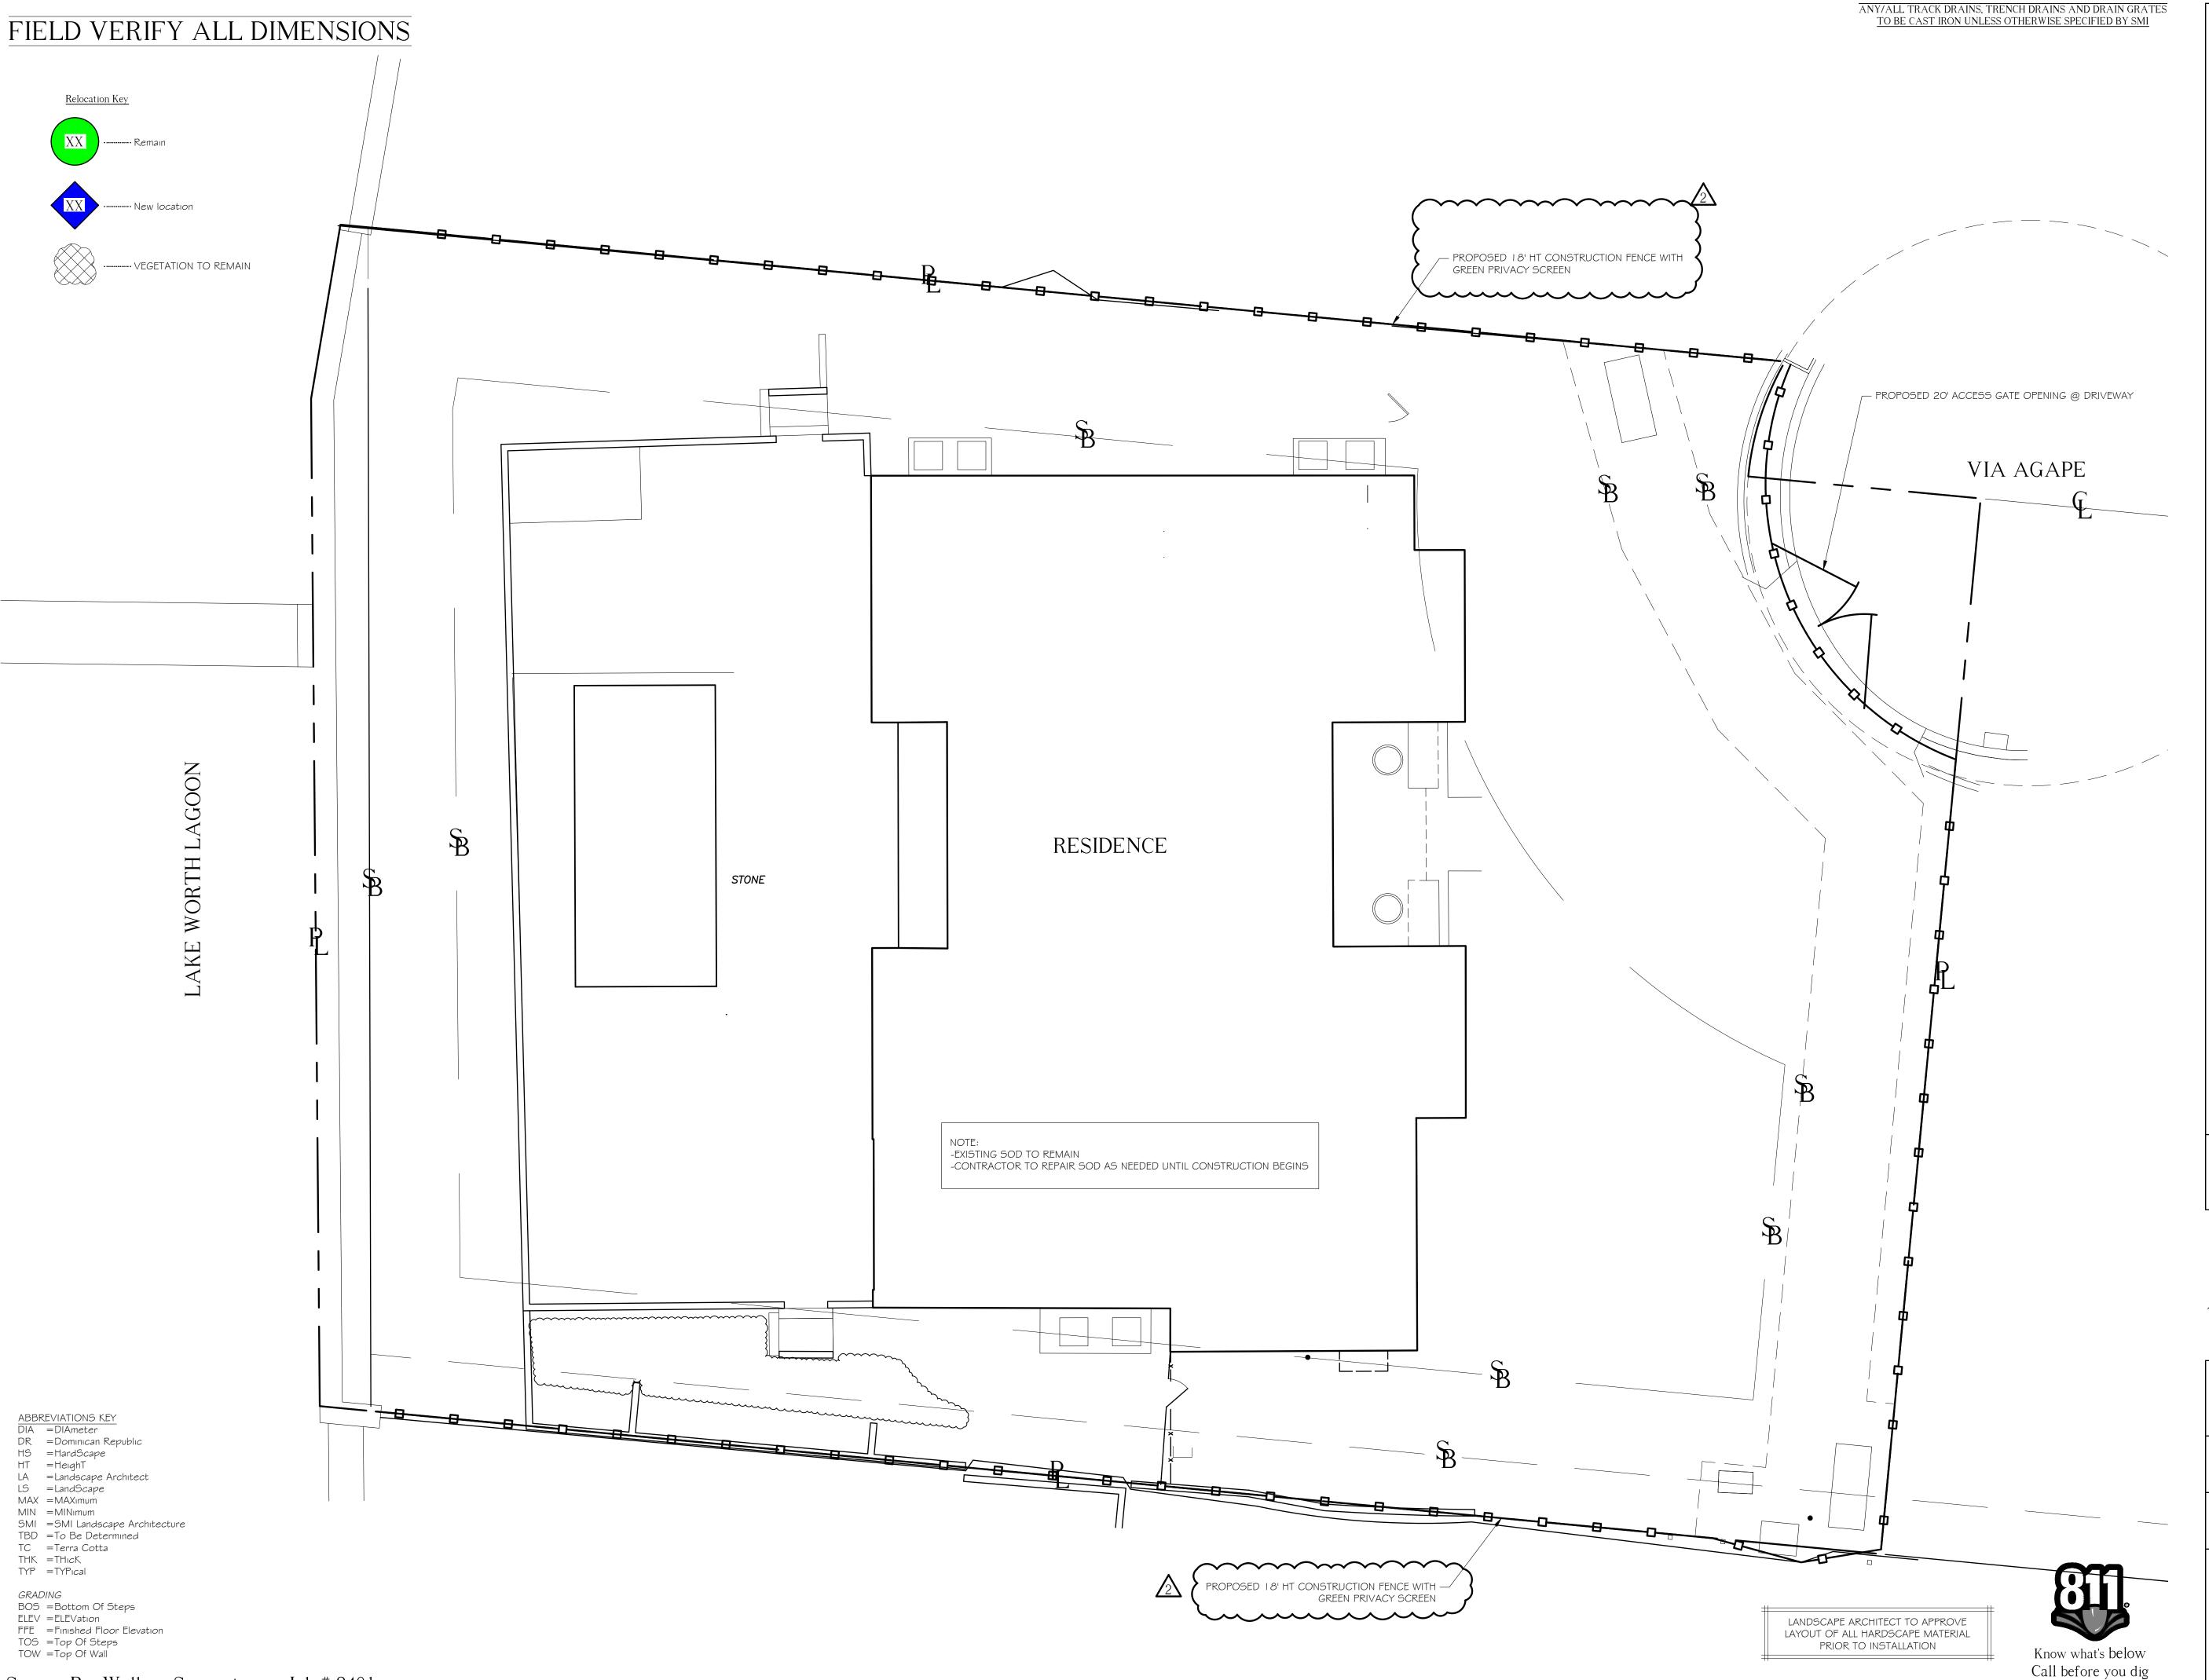
LANDSCAPE ARCHITECTURE 140 Royal Palm Way, Suite #206, Palm Beach, Florida 33480 Telephone: 561-655-9006 Fax: 561-655-9007 eMail: Office@smila.net www.smila.net FL registration #LA 13000223

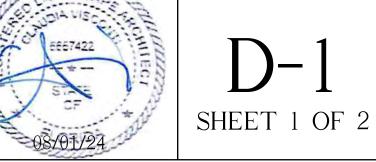



Know what's below Call before you dig

PRIOR TO INSTALLATION



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eMail: Office@smila.net www.smila.net
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Screening Plan				
SCALE	PROJECT NUMB	ER:		
1/8" = 1'-0"	2401			
DATE:	PRJCT MNGR:	CHECKED:		
08.01.2024	CFV	CFV		
SEAL SEE7422	DRAWING NO.	_ 1		

ANY/ALL TRACK DRAINS, TRENCH DRAINS AND DRAIN GRATES
TO BE CAST IRON UNLESS OTHERWISE SPECIFIED BY SMI FIELD VERIFY ALL DIMENSIONS



West Elevation Facing East Proposed



East Elevation Facing West Proposed SCALE: NTS



### Worth Avenue Ventures LLC

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 4 05.10.2024 FINAL SUBMITTAL


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SHEET 1 OF 2

ANY/ALL TRACK DRAINS, TRENCH DRAINS AND DRAIN GRATES
TO BE CAST IRON UNLESS OTHERWISE SPECIFIED BY SMI



North Elevation Facing South Proposed

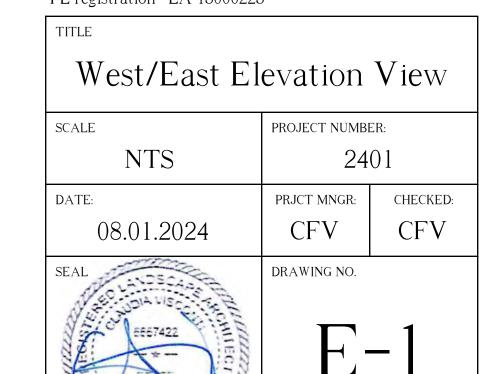

South Elevation Facing North Proposed



### Worth Avenue Ventures LLC

1741 South Ocean Blvd. Palm Beach, FL 33480

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DATE DESCRIPTION
REVISIONS


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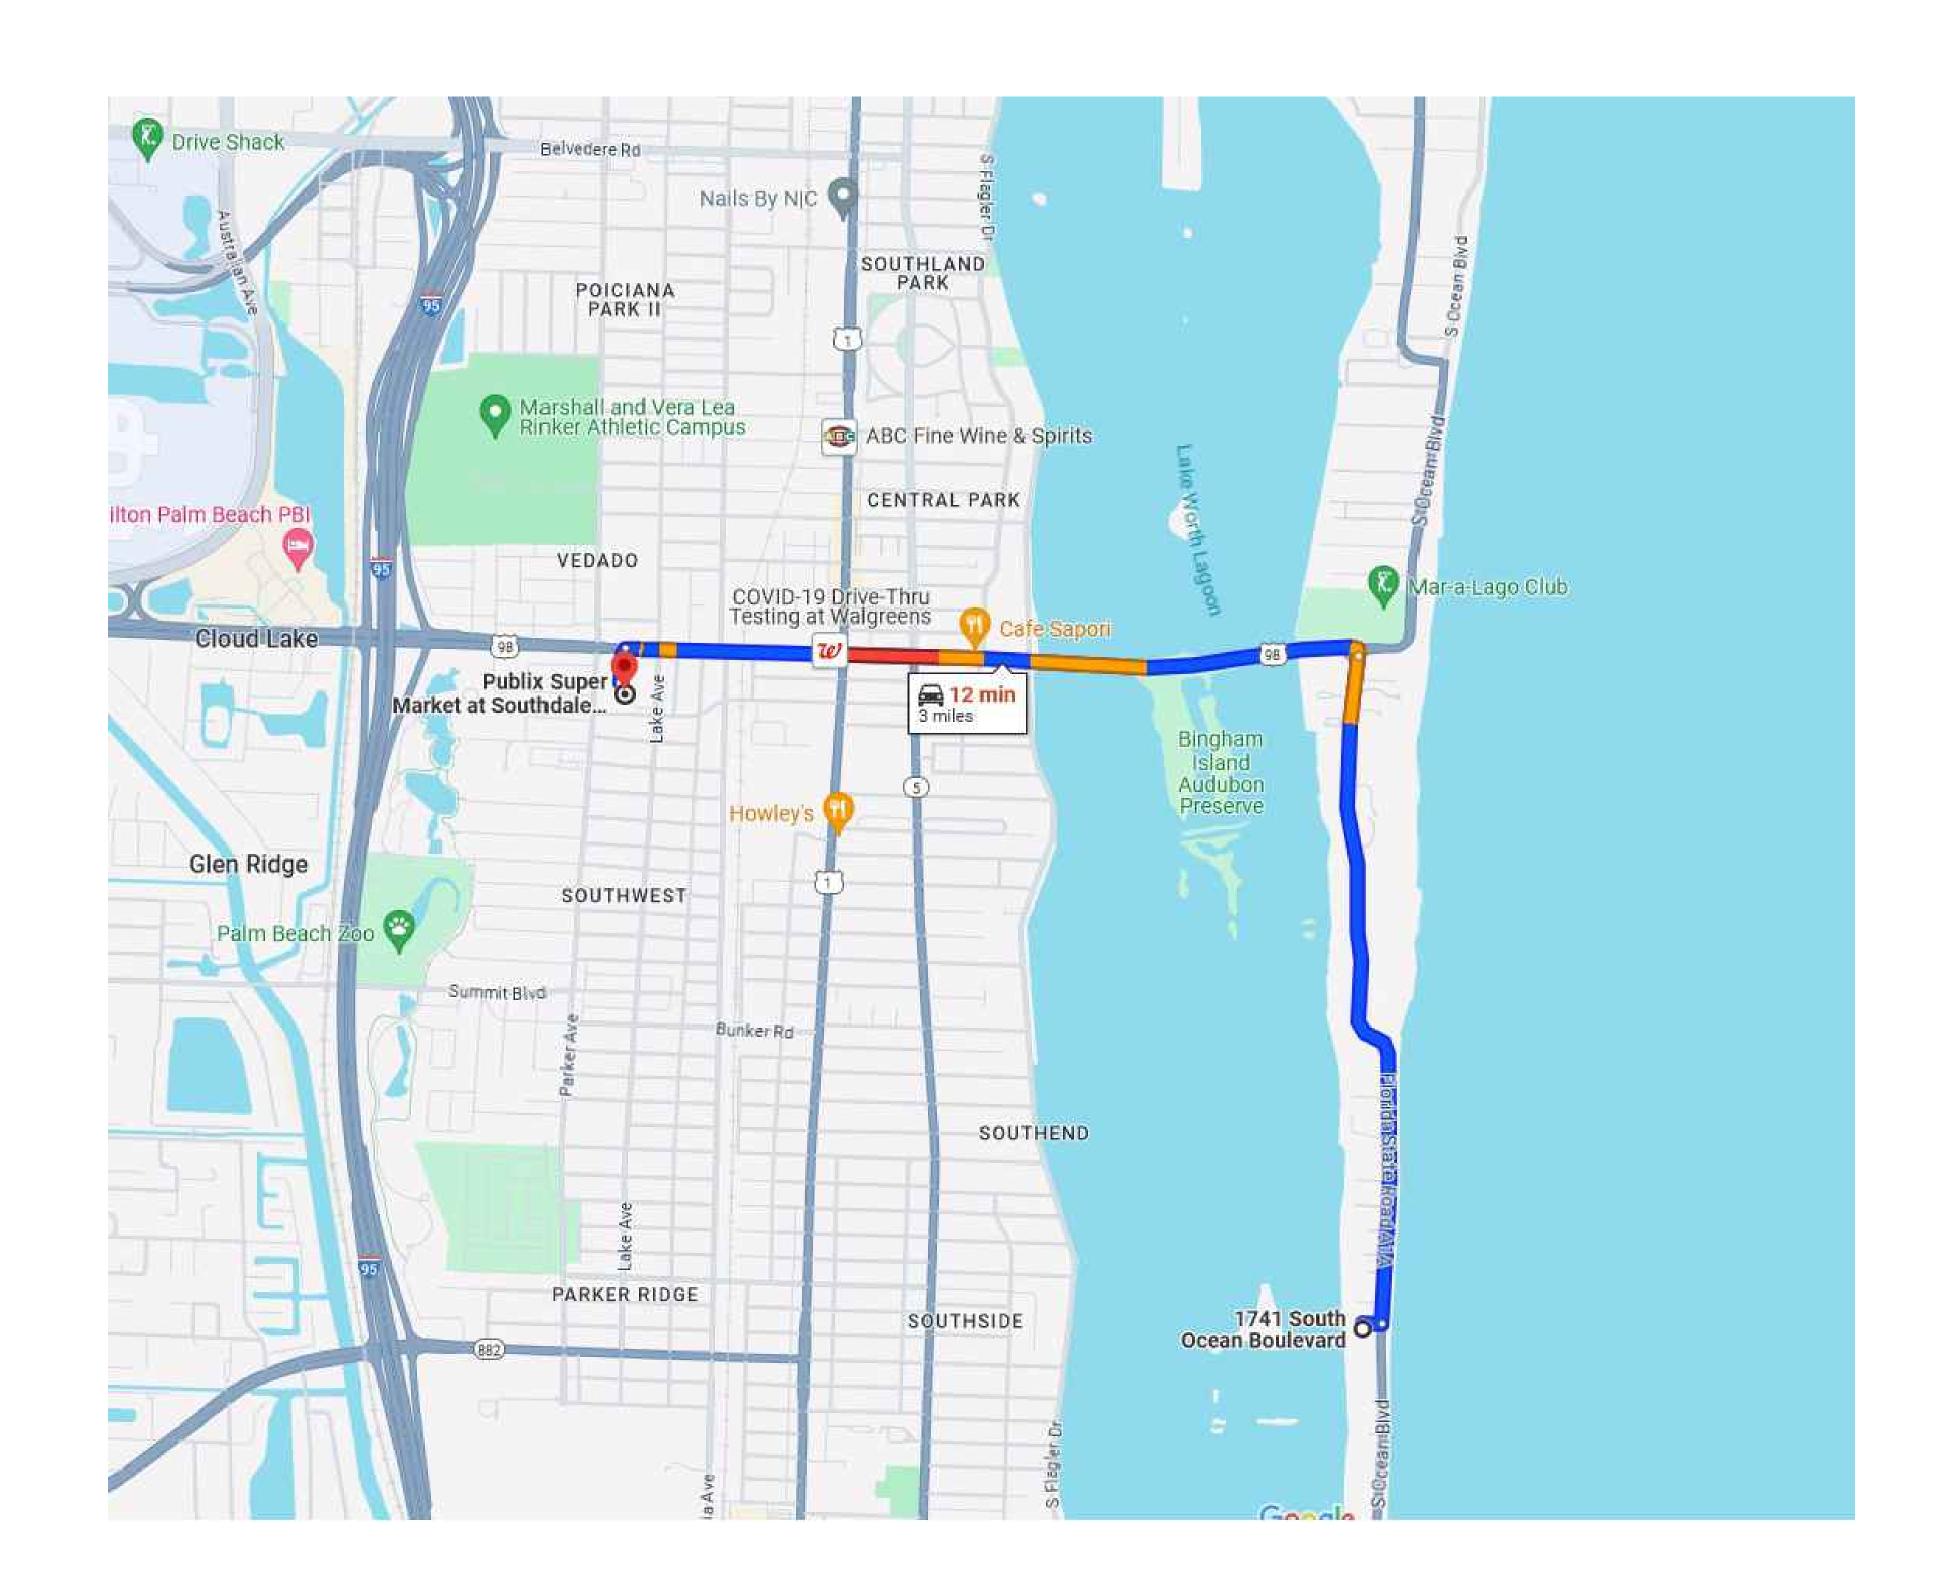
TITLE

### North/South Elevation View

SCALE	PROJECT NUMB	ER:
NTS	24	01
DATE:	PRJCT MNGR:	CHECKED:
08.01.2024	CFV	CFV
SEAL	DRAWING NO	



SHEET 2 OF 2

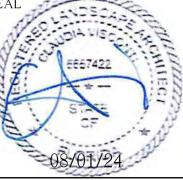

### Proposed Route Map for Truck Traffic

A. Roadways: Deliveries and workers will be using the southern bridge. Head east on southern blvd, continue straight to stay on Southern Blvd. At the traffic circle, take the 1st exit onto S Ocean Blvd turn right onto Via Agape.

B. Maximum truck length= 60 feet

C. Total number of estimated deliveries generated by project= 60

June 26, 2024	
1 Month	Mobilization
2 Months	Site/Building Preparation
1 Month	Roof Truss Delivery and Set Trusses
1.5 Months	Window/Door Deliveries and Installation
.5 Month	Dry-In
1.5 Months	Interior Framing
2 Months	Rough-In
.5 Month	Drywall
6 Months	Finishes
2 Months	Landscape & Hardscape Installation
+/- 24 Months	Final Inspection



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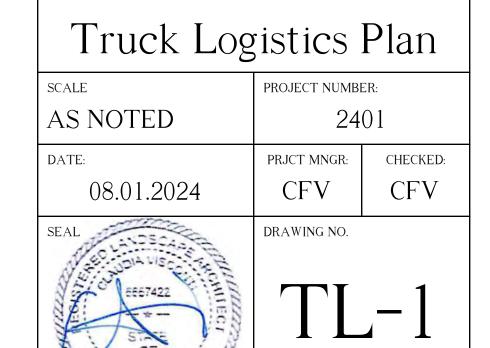
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SHEET 1 OF 1









0' 10' 20' 30'



### LEGEND

= ARC LENGTH = AIR CONDITIONING A.E. = ACCESS EASEMENT = ALSO KNOWN AS = ASPHALT = BUILDING = BENCHMARK = BACK OF CURB = BACK OF WALK = CALCULATED (C) CATV = CABLE ANTENNA TELEVISION = CHORD BEARING = CONCRETE BLOCK STRUCTURE = COASTAL CONSTRUCTION CONTROL LINE = CHORD C.L.F. = CHAIN LINK FENCE = CLEAR CLR. = CORRUGATED METAL PIPE C.M.P. CONC. = CONCRETE = DESCRIPTION DATUM (D) D.B. = DEED BOOK D.E. = DRAINAGE EASEMENT = DRILL HOLE = ELECTRIC BOX E.B. = ELEVATION = ENCROACHMENT = EDGE OF PAVEMENT = EDGE OF WATER E.O.W. ESM'T = EASEMENT = FINISH FLOOR ELEVATION FND. = FOUND F.O.C. = FACE OF CURB = GAS METER = INVERT I.T.W.C.D. = INDIAN TRAIL WATER CONTROL DISTRICT = LIMITED ACCESS EASEMENT = LICENSE BOARD = LAKE WORTH DRAINAGE DISTRICT = FIELD MEASUREMENT = MANHOLE M.H.W.L.= MEAN HIGH WATER LINE = MEAN LOW WATER LINE N.A.V.D. = NORTH AMERICAN VERTICAL DATUMN.G.V.D. = NATIONAL GEODETIC VERTICAL DATUMN.P.B.C.I.D.= NORTHERN PALM BEACH COUNTY IMPROVEMENT DISTRICT = NOT TO SCALE O.A. = OVERALL O/H = OVERHEAD UTILITY LINE O.R.B. = OFFICIAL RECORD BOOK O/S = OFFSET = PLANTER = PLAT DATUM = PLAT BOOK = PALM BEACH COUNTY = POINT OF CURVATURE = POINT OF COMPOUND CURVATURE P.E. = POOL EQUIPMENT = PAGE = POINT OF INTERSECTION P/O = PART OF P.O.B. = POINT OF BEGINNING P.O.C. = POINT OF COMMENCEMENT = POINT OF REVERSE CURVATURE = PERMANENT REFERENCE MONUMENT = PROPOSED P.T. = POINT OF TANGENCY PVM'T = PAVEMENT = RADIAL (R) = RADIUS RGE. = RANGE R.P.B. = ROAD PLAT BOOK R/W= RIGHT OF WAY = SURVEY DATUM S.B. = SETBACK SEC. = SECTION S/D = SUBDIVISION = SQUARE FEET S.F.W.M.D. = SOUTH FLORIDA WATER MANAGEMENT DISTRICT S.I.R.W.C.D= SOUTH INDIAN RIVER WATER CONTROL DISTRICT = STATE ROAD STA. = STATION STY. = STORY = THRESHOLD ELEVATION T.O.B. = TOP OF BANK T.O.C. = TOP OF CURB TWP. = TOWNSHIP TYP. = TYPICAL U/C = UNDER CONSTRUCTION U.E. = UTILITY EASEMENT U.R. = UNRECORDED W.C. = WITNESS CORNER = WATER MANAGEMENT EASEMENT W.M.M.E. = WATER MANAGEMENT MAINTENANCE EASEMENT W.M.T. = WATER MANAGEMENT TRACT = BASELINE = CENTERLINE = CENTRAL ANGLE/DELTA = CONCRETE MONUMENT FOUND (AS NOTED) = CONCRETE MONUMENT SET (LB #4569) = ROD & CAP FOUND (AS NOTED) = 5/8" ROD & CAP SET (LB #4569) = IRON PIPE FOUND (AS NOTED) = IRON ROD FOUND (AS NOTED) = NAIL FOUND = NAIL & DISK FOUND (AS NOTED) = MAG NAIL & DISK SET (LB #4569) = PROPERTY LINE = UTILITY POLE = FIRE HYDRANT = WATER METER

= WATER VALVE

= LIGHT POLE

### **BOUNDARY SURVEY FOR:** WORTH AVENUE VENTURES LLC

This survey is made specifically and only for the following party for the purpose of a permit on the surveyed property.

Worth Avenue Ventures LLC

The undersigned surveyor assumes no responsibility or liability for any other purpose or to any other party other than stated above.

PROPERTY ADDRESS: 1741 South Ocean Blvd. Palm Beach, FL 33480

### **LEGAL DESCRIPTION:**

PARCEL "B":

A parcel of land in Section 11, Township 44 South, Range 43 East, Town of Palm Beach, Palm Beach County, Florida, more particularly described as follows:

From the point of intersection of a line parallel with and 6 feet South of the South line of Lot 105, PALM BEACH ESTATES, according to the Plat thereof on file in the office of the Clerk of the Circuit Court in and for Palm Beach County, Florida, in Plat Book 8, at Page 3, with the Westerly Right-of-Way line in Ocean Boulevard (as said Right-of-way is shown on Brockway, Weber & Brockway Survey Drawing, File Number TMD-893, dated July 1958), run Westerly along said line, a distance of 205.24 feet to the POINT OF BEGINNING; thence run Northerly, making an angle of 90 Degrees with the preceding course, a distance of 112.37 feet to a point on the centerline of an easement for access as described in Official Records Book 13493, Page 506, Palm Beach County Public Records;


thence run Westerly along the centerline of said easement, a distance of 24.76 feet to a point in a curve concave to the Southeast, said curve being the Westerly terminus of said access easement; thence run Northerly along the arc of said curve, having a radius of 30.00 feet and a central angle of 24 Degrees, 37 Minutes, 33 Seconds, a distance of 12.89 feet to a point in a line parallel with 119.00 feet Northerly from, measured at right angles to, the South line of said Lot 105;

thence run Westerly along said line, parallel with and 119.00 feet Northerly from, measured at right angles to, the South line of said Lot 105, a distance of 151.0 feet, more or less, to the West face of a concrete bulkhead on the Easterly shore of Lake Worth;

thence run Southerly along said concrete bulkhead, a distance of 125.46 feet more or less to the intersection with a line parallel and 6 feet South of the South line of aforementioned Lot 105; thence run Easterly along said line, a distance of 160.86 feet to the POINT OF BEGINNING. Together with all riparian rights thereunto belonging or in anywise appertaining. Subject to Right-of-Way and easements of record.

### PARCEL "B-1"

That portion of the South 106.25 feet of Lot 105, of PALM BEACH ESTATES, as recorded in Plat Book 8, Page 3, Public Records of Palm Beach County, Florida, lying East of the Right-of-way of Ocean Boulevard, less the South 50.12 feet thereof. Together with all littoral rights thereunto.

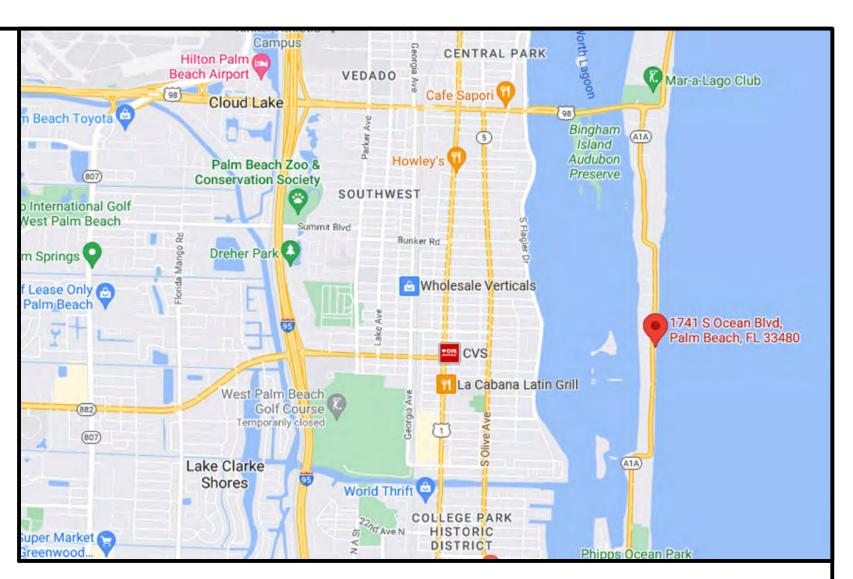

VICINITY SKETCH N.T.S.

### SHEET INDEX

REVISIONS

SHEET 1	LEGAL DESCRIPTION, NOTES AND CERTIFCATION
SHEET 2	PARCEL "B"
SHEET 3	PARCEL "B-2"

This property is located in Flood Zones AE (EL 6), X & VE (EL 10 and 12), according to F.I.R.M. (Flood Insurance Rate Map) No. 12099C 0593F, dated 10/05/2017.

- 1. No title policy or commitment affecting title or boundary to the subject property has been provided. It is possible there are deeds and easements, recorded or unrecorded, which could affect this
- survey and boundaries. This office has made no search of the Public Records. Elevations shown hereon, if any, are in feet and decimal parts thereof and are based on NAVD-88. The expected accuracy of the elevations shown hereon is 0.03' for the hard surface elevations (shown thus x 0.00) and 0.1' (shown thus x 0.0) for the soft surface elevations. Elevations shown hereon are U.S. survey feet unless otherwise noted.
- Description furnished by client or client's agent.
- 4. Unless presented in digital form with electronic seal and electronic signature this survey must bear the signature and the original raised seal of a Florida licensed surveyor or mapper this drawing, sketch, plat or map is for informational purposes only and is not valid.
- This survey cannot be transferred or assigned without the specific written permission of Wallace Surveying Corporation. Certificate of Authorization Number LB4569.
- Except as shown, underground and overhead improvements are not located. Underground foundations not located.
- The survey sketch shown hereon does not necessarily contain all of the information obtained or developed by the undersigned surveyor in his field work, office work or research.
- No responsibility is assumed by this surveyor for the construction of improvements, from building ties shown on this survey.
- Revisions shown hereon do not represent a "survey update" unless otherwise noted.
- 10. All dates shown within the revisions block hereon are for interoffice filing use only and in no way affect the date of the field survey stated herein.
- 11. In some instances, graphic representations have been exaggerated to more clearly illustrate the relationships between physical improvements and/or lot lines. In all cases, dimensions shown shall control the location of the improvements over scaled positions.
- 12. It is a violation of Rule 5J-17 of the Florida Administrative Code to alter this survey without the express prior written consent of the Surveyor. Additions and/or deletions made to the face of this
- survey will make this survey invalid. 13. The ownership of fences, perimeter walls and/or hedges shown hereon are not known and thus are not listed as encroachments. Fences, hedges and/or perimeter walls are shown in their relative
- 14. The expected horizontal accuracy of the information shown hereon is +/- 0.10'.

I HEREBY ATTEST that the survey shown hereon conforms to the Standards of Practice set forth by the Florida Board of Professional Surveyors and Mappers adopted in Rule 5J-17, Florida Administrative Code pursuant to Section 472.027, Florida Statutes, effective September 1, 1981.

DATE OF LAST FIELD SURVEY: 7/27/2023




WORTH AVENUE VENTURES LLC


**BOUNDARY SURVEY FOR:** 


'27/23 SURVEY AND TIE-IN UPDATE (TREES NOT UPDATED) B.M./M.B. 08-1215.5 PB351/28




5553 VILLAGE BOULEVARD, WEST PALM BEACH, FLORIDA 33407 \* (561) 640-4551 JOB NO.: 08-1215.2 F.B. PB341 PG. 64 OFFICE: M.B. 1/12/23 DWG. N□. 08-1215 C'K'Dı REF: 08-1215.DWG C.W.

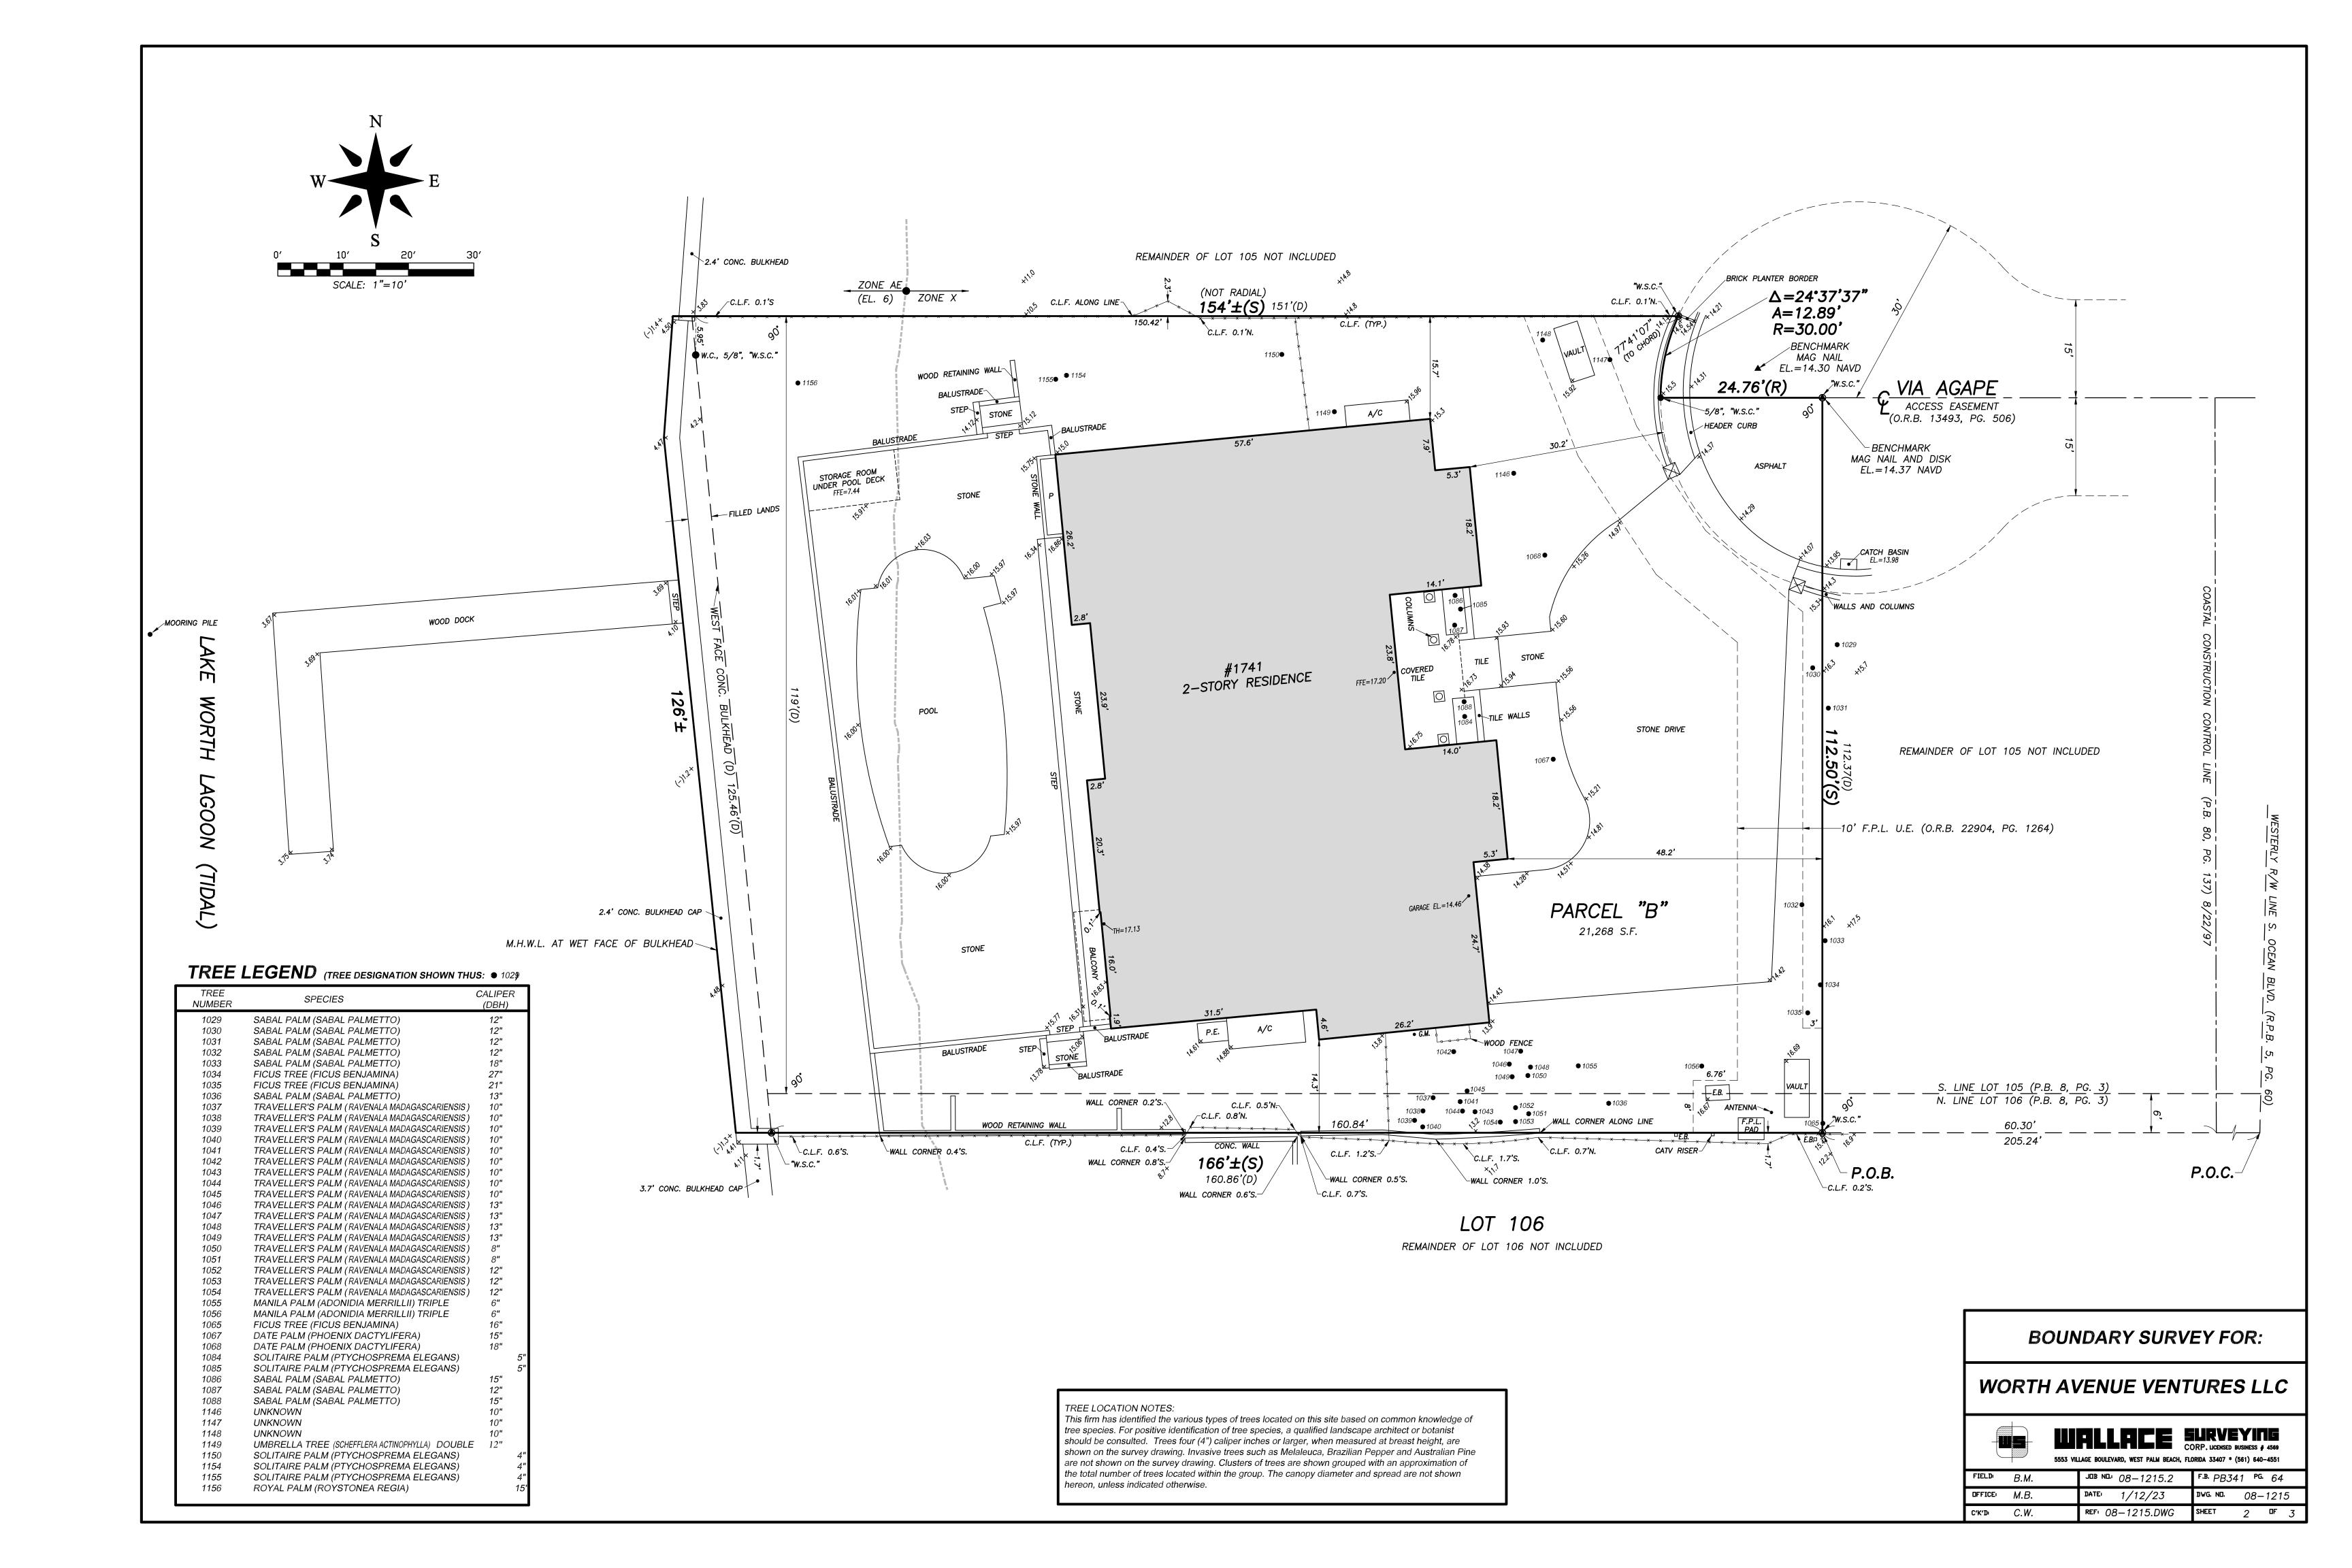

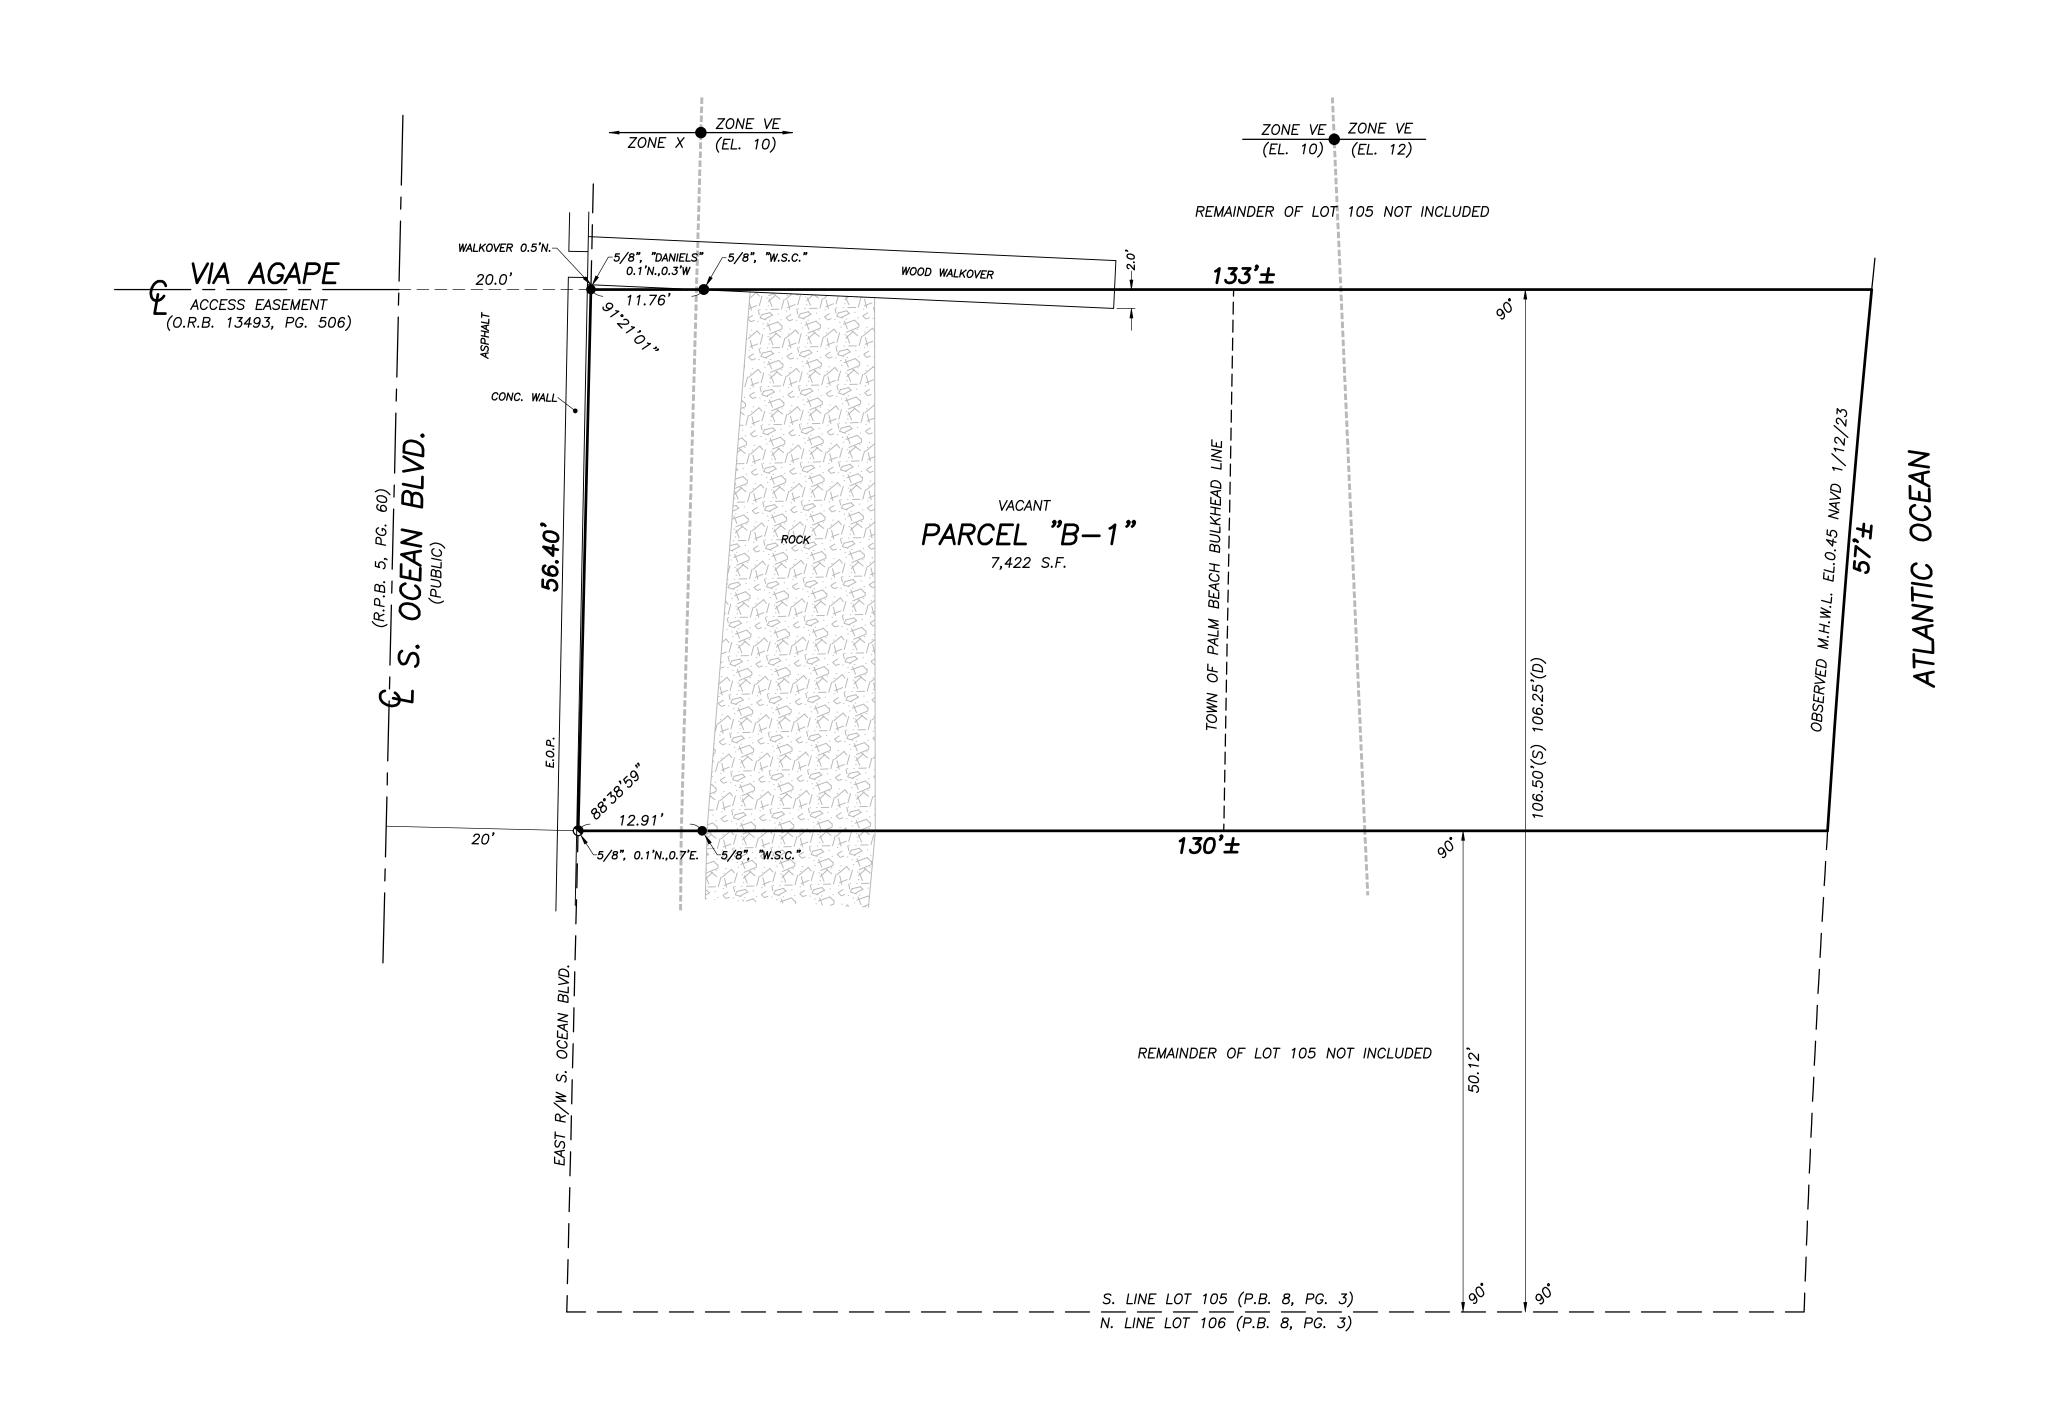

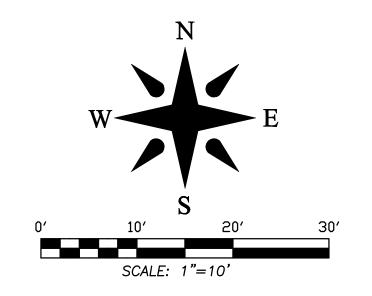

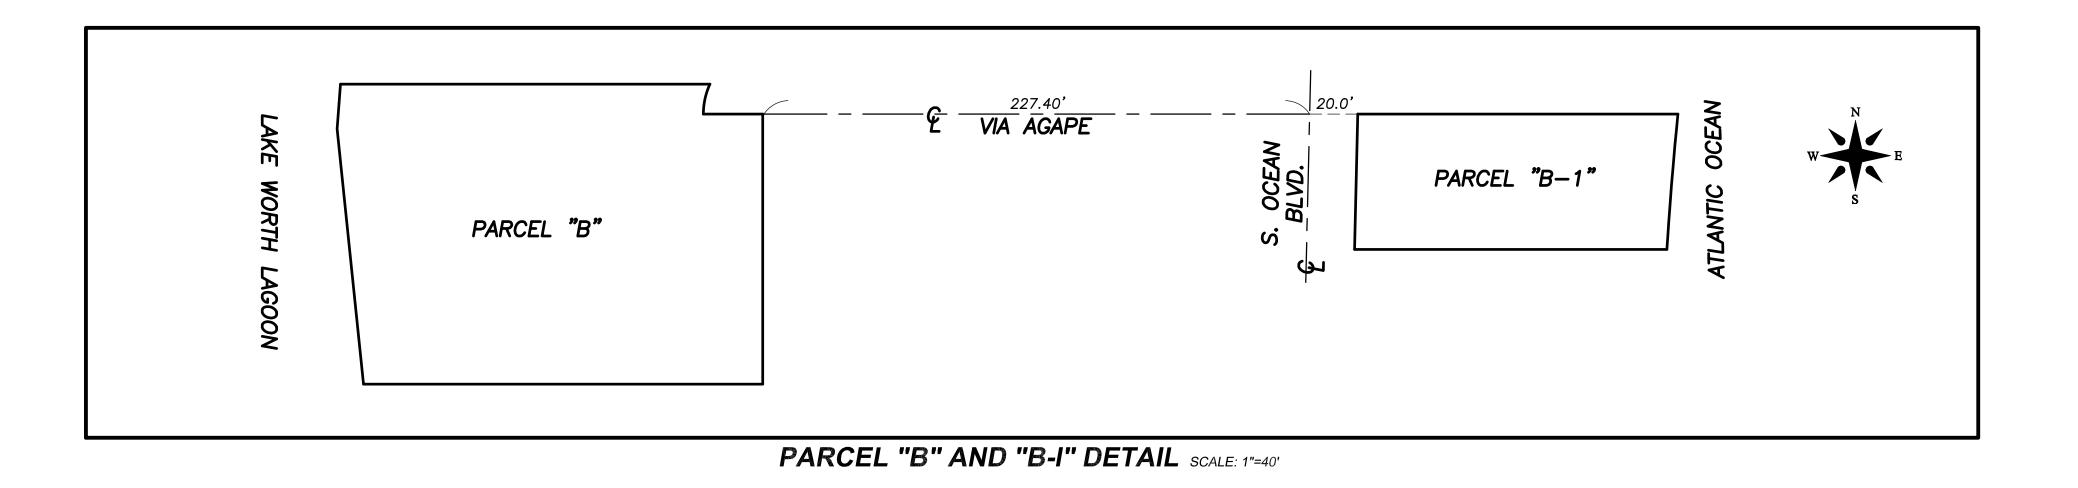

**BOUNDARY SURVEY FOR:** 

**WORTH AVENUE VENTURES LLC** 



LIFILE SURVEYING
CORP. LICENSED BUSINESS # 4569

FIELD: B.M. JOB NO.: 08-1215.2 F.B. PB341 PG. 64

OFFICE: M.B. DATE: 1/12/23 DWG. NO. 08-1215

C'K'D: C.W. REF: 08-1215.DWG SHEET 3 OF 3