

Aerial View



# Private Residence 336 W Australian Avenue Palm Beach

Application #:

ARC-23-0034

Final Jubmittal

D

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Date of Presentation: 07.24.24

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Scope of Work

Modified pool garden layout
Modified entry courtyard
Addition of generator
Associated landscape improvements
Relocation of pool equipment
Addition of pool heater
Addition of easter privacy wall

# Design Team/Consultants

#### Landscape Architects

ENVIRONMENT DESIGN GROUP

139 NORTH COUNTY ROAD SUITE 20B

PALM BEACH, FL 33480

561.832.4600

WWW.ENVIRONMENTDESIGNGROUP.COM

#### Civil Engineer


GRUBER CONSULTING ENGINEERS
2475 MERCER AVE
WEST PALM BEACH, FL 33401
561.312.2041

## Zoning Legend

PROPERTY ADDRESS	336 AUSTRALIAN AVENUE			
ZONING DISTRICT	R-C MEDIUM DENSITY RESIDENTIAL			
LOT AREA (SQ. FT.)		6,252 S.F	=.	
LOT WIDTH (W) & LOT DEPTH (D) (F	=T.)	50' & 125	5'	
STRUCTURE TYPE:		SINGLE	FAMILY HOME	
FEMA FLOOD ZONE DESIGNATION	<b>\</b> :	N/A		
ZERO DATUM FOR POINT OF MEA	AS. (NAVD)	N/A		
CROWN OF ROAD (COR) (NAVD)		N/A		
	REQ'D / PERN	MITTED	EXISTING	PROPOSED
LOT COVERAGE	N/A		2,238	N/A
ENCLOSED SQUARE FOOTAGE	N/A		2,138	N/A
FRONT YARD SETBACK (FT.)	25'		25'	N/A
SIDE YARD SETBACK (IST STORY) (FT.	10'		10'	N/A
SIDE YARD SETBACK (2ND STORY) (FT.)	10'		10'	N/A
REAR YARD SETBACK (FT.)	15'		15'	N/A
ANGLE OF VISION (DEG.)	N/A		N/A	N/A
BUILDING HEIGHT (FT.)	N/A		N/A	N/A
OVERALL BUILDING HEIGHT (FT.)	DING HEIGHT (FT.) N/A		N/A	N/A
CUBIC CONTENT RATIO (CCR) (R-B ONLY)	N/A		N/A	N/A
MAX. FILL ADDED TO SITE (FT.)	N/A		N/A	N/A
FINISHED FLOOR ELEVATION N/A (FFE) (NAVD)			N/A	N/A
BASE FLOOD ELEVATION (FFE) (NAVD)			N/A	N/A

## Landscape Legend

Property Address:	336 W Australian	1 Avenue
Lot Area:	6,252 <i>s</i> .f.	
	Required/Allowed	Proposed
Landscape Open∫pace:	2,813 /F (45%)	2,273 (36.35%)
LQ/ to be altered		M/A
Perimeter LQ/		1,695 ∕ F
Front Yard LQ/	500 JF (40%)	641 (51.28%)
Native Trees	30%	83%
Native∫hrubs & Vines	30%	31.82%
Mative Groundcover	30%	32.35%

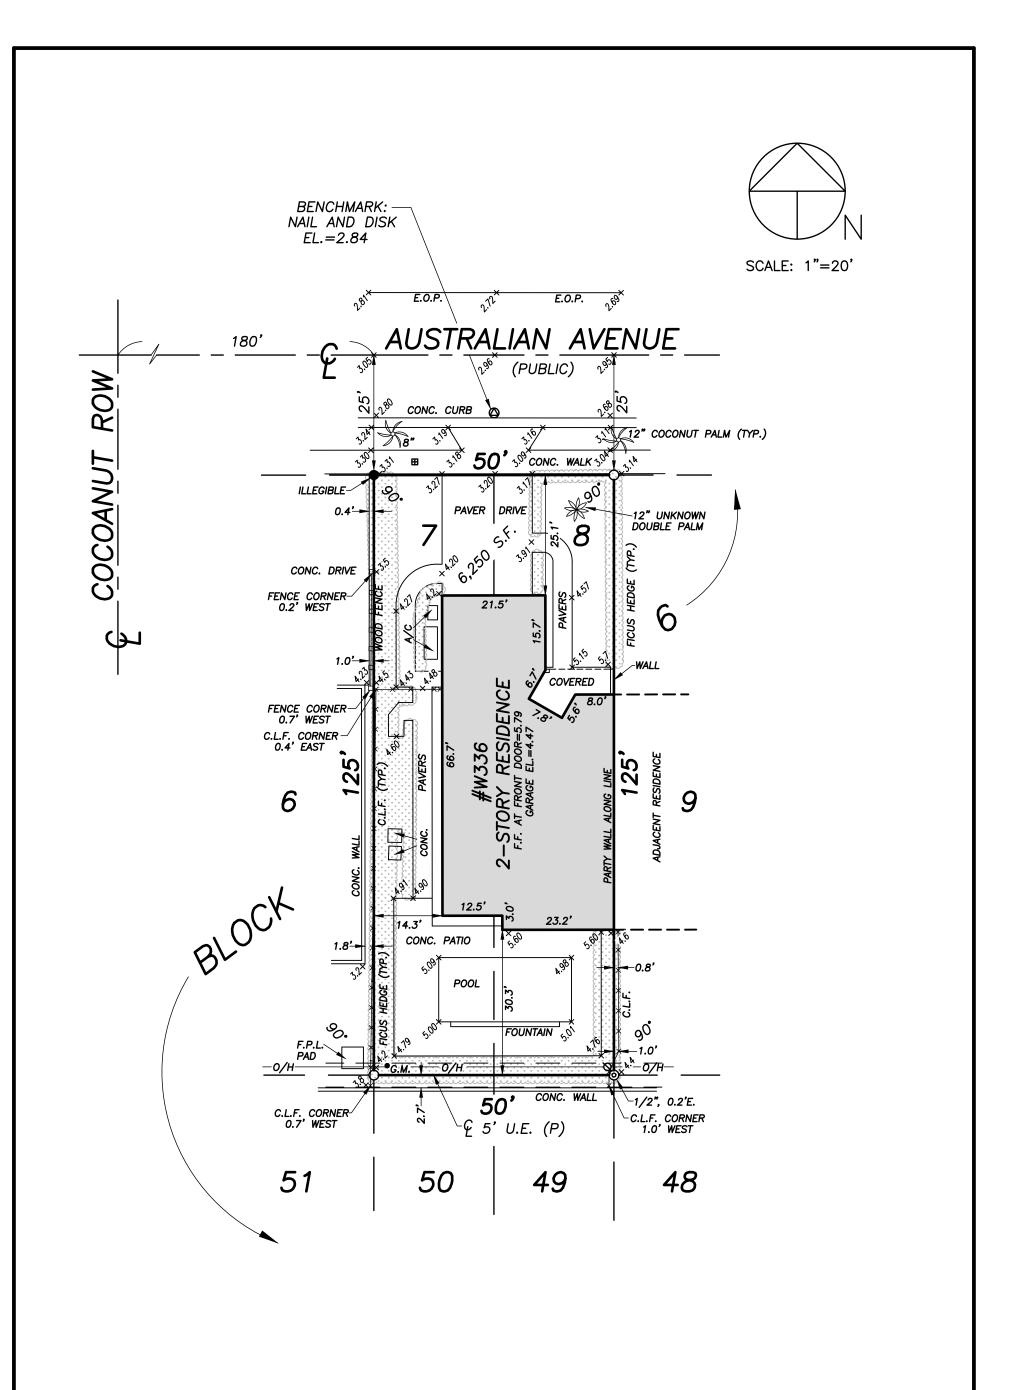



## ELRVEYITE CORP. LICENSED BUSINESS # 4569

5553 VILLAGE BOULEVARD, WEST PALM BEACH, FLORIDA 33407 \* (561) 640-4551

FIELD	B.M.	JDB ND: 11-1087.1	F.B. PB126 PG. 9
OFFICE:	M.B.	DATE: 4/19/11	DWG. ND. 11-1087
C'K'Dı	C.W.	REF: 11-1087.DWG	SHEET 2 DF 2

# BOUNDARY SURVEY FOR: MARK LOCKS

This survey is made specifically and only for the following party for the purpose of a landscape design on the surveyed property.

#### **Mark Locks**

The undersigned surveyor assumes no responsibility or liability for any other purpose or to any other party other than stated above.

#### PROPERTY ADDRESS:

336 Australian Ave, Palm Beach, FL 33480

#### **LEGAL DESCRIPTION:**

Lot 7 and 8, Block 6, **ROYAL PARK ADDITION TO THE TOWN OF PALM BEACH, FLORIDA,** according to the Plat thereof, on file in the Office of the Clerk of the Circuit Court in and for Palm Beach County, Florida, recorded in Plat Book 4, Page 1.

#### **FLOOD ZONE:**

This property is located in Flood Zone A7 (EL7), according to F.I.R.M. (Flood Insurance Rate Map) No. 120220 002 C, dated September 30, 1982.

#### NOTES:

- 1. No title policy or commitment affecting title or boundary to the subject property has been provided. It is possible there are deeds and easements, recorded or unrecorded, which could affect this survey and boundaries. This office has made no search of the Public Records
- 2. Elevations shown hereon, if any, are in feet and decimal parts thereof and are based on NGVD-29.
- Description furnished by client or client's agent.
- 4. Unless it bears the signature and the original raised seal of a Florida licensed surveyor or mapper this drawing, sketch, plat or map is for informational purposes only and is not valid.
- 5. This survey cannot be transferred or assigned without the specific written permission of Wallace Surveying Corporation. Certificate of Authorization Number LB4569.
- 6. Except as shown, underground and overhead improvements are not located.
- 7. Underground foundations not located.
- 8. The survey sketch shown hereon does not necessarily contain all of the information obtained or developed by the undersigned surveyor in his field work, office work or research.
- 9. No responsibility is assumed by this surveyor for the construction of improvements, from building ties shown on this survey.
- 10. Revisions shown hereon do not represent a "survey update" unless otherwise noted.
- 11. All dates shown within the revisions block hereon are for interoffice filing use only and in no way affect the date of the field survey stated herein.
- 12. In some instances, graphic representations have been exaggerated to more clearly illustrate the relationships between physical improvements and/or lot lines. In all cases, dimensions shown shall control the location of the improvements over scaled positions.

#### **CERTIFICATION:**

I HEREBY ATTEST that the survey shown hereon meets the minimum technical standards set forth by the Florida Board of Professional Surveyors and Mappers pursuant to section 472.027, Florida Statutes, and adopted in Rule 5J-17, Florida Administrative Code, effective September 1, 1981.


DATE OF LAST FIELD SURVEY: 4/19/2011

Craig L. Wallace Professional Surveyor and Mapper Florida Certificate No. 3357 Sheet 1 of 2

11-1087.001


#### **LEGEND**

Α	= ARC LENGTH	F.O.C.	= FACE OF CURB	P.O.C.	= POINT OF COMMENCEMENT	W.C.	= WITNESS CORNER
A/C	= AIR CONDITIONING	G.M.	= GAS METER	P.R.C.	= POINT OF REVERSE CURVATURE	W.M.E.	= WATER MANAGEMENT EASEMENT
A.E.	= ACCESS EASEMENT	INV.	= INVERT	P.R.M.	= PERMANENT REFERENCE MONUMENT	W.M.M.E.	
A.K.A.	= ALSO KNOWN AS	I.T.W.C.D.	= INDIAN TRAIL WATER CONTROL DISTRICT	PROP.	= PROPOSED		MAINTENANCE EASEMENT
ASPH.	= ASPHALT	L.A.E.	= LIMITED ACCESS EASEMENT	P.T.	= POINT OF TANGENCY	W.M.T.	= WATER MANAGEMENT TRACT
BLDG.	= BUILDING	L.B.	= LICENSE BOARD	PVM'T	= PAVEMENT	₽	= BASELINE
B.M.	= BENCHMARK	L.W.D.D.	= LAKE WORTH DRAINAGE DISTRICT	(R)	= RADIAL	Ģ	= CENTERLINE
B.O.C.	= BACK OF CURB	(M)	= FIELD MEASUREMENT	R	= RADIUS	Δ	= CENTRAL ANGLE/DELTA
B.O.W.	= BACK OF WALK	M.H.	= MANHOLE	RGE.	= RANGE	Ē	= CONCRETE MONUMENT FOUND
(C)	= CALCULATED	M.H.W.L.	= MEAN HIGH WATER LINE	R.P.B.	= ROAD PLAT BOOK	_	(AS NOTED)
CATV	= CABLE ANTENNA TELEVISION	MIN.	= MINIMUM	R/W	= RIGHT OF WAY		= CONCRETE MONUMENT SET
C.B.	= CHORD BEARING	M.L.W.L.	= MEAN LOW WATER LINE	(S)	= SURVEY DATUM	_	(LB #4569)
C.B.S.	= CONCRETE BLOCK STRUCTURE	N.V.G.D.	= NATIONAL GEODETIC VERTICAL DATUM	S.B.	= SETBACK	•	= ROD & CAP FOUND (AS NOTED)
C.C.C.L.	= COASTAL CONSTRUCTION CONTROL LINE	N.P.B.C.I.	D= NORTHERN PALM BEACH COUNTY	SEC.	= SECTION	0	= 5/8" ROD & CAP SET (LB #4569)
CH	= CHORD		IMPROVEMENT DISTRICT	S/D	= SUBDIVISION	0	= IRON PIPE FOUND (AS NOTED)
C.L.F.	= CHAIN LINK FENCE	N.T.S.	= NOT TO SCALE	S.F.	= SQUARE FEET	ø.	= IRON ROD FOUND (AS NOTED)
CLR.	= CLEAR	O.A.	= OVERALL	S.F.W.M.D	.= SOUTH FLORIDA WATER	7	
C.M.P.	= CORRUGATED METAL PIPE	O.D.	= OUTSIDE DIAMETER		MANAGEMENT DISTRICT	•	= NAIL FOUND (AS NOTED)
CONC.	= CONCRETE	O/H	= OVERHEAD UTILITY LINE	S.I.R.W.C.	D. = SOUTH INDIAN RIVER WATER		= NAIL & DISK FOUND
(D)	= DESCRIPTION DATUM	O.R.B.	= OFFICIAL RECORD BOOK		CONTROL DISTRICT	<b>A</b>	(AS NOTED)
D.B.	= DEED BOOK	O/S	= OFFSET	S.R.	= STATE ROAD	<b>\Delta</b>	= MAG NAIL & DISK SET
D.E.	= DRAINAGE EASEMENT	(P)	= PLAT DATUM	STA.	= STATION	Б	(LB #4569)
D.H.	= DRILL HOLE	P.B.	= PLAT BOOK	STY.	= STORY	E Z	= PROPERTY LINE
D/W	= DRIVEWAY	P.B.C.	= PALM BEACH COUNTY	S/W	= SIDEWALK	$\not\square$	= UTILITY POLE
EL.	= ELEVATION	P.C.	= POINT OF CURVATURE	T.O.B.	= TOP OF BANK	<u> </u>	= FIRE HYDRANT
ENC.	= ENCROACHMENT	P.C.C.	= POINT OF COMPOUND CURVATURE	T.O.C.	= TOP OF CURB	⊞	= WATER METER
E.O.P	= EDGE OF PAVEMENT	P.C.P.	= PERMANENT CONTROL POINT	TWP.	= TOWNSHIP	M	= WATER VALVE
E.O.W.	= EDGE OF WATER	PG.	= PAGE	TYP.	= TYPICAL		= LIGHT POLE
ESM'T	= EASEMENT	P.I.	= POINT OF INTERSECTION	U/C	= UNDER CONSTRUCTION	- <b>Q</b> -	- LIGITI FULE
F.F.	= FINISH FLOOR	P/O	= PART OF	U.E.	= UTILITY EASEMENT		
FND	= FOLIND	POB	= POINT OF BEGINNING	UR	= UNRECORDED		

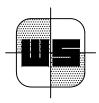





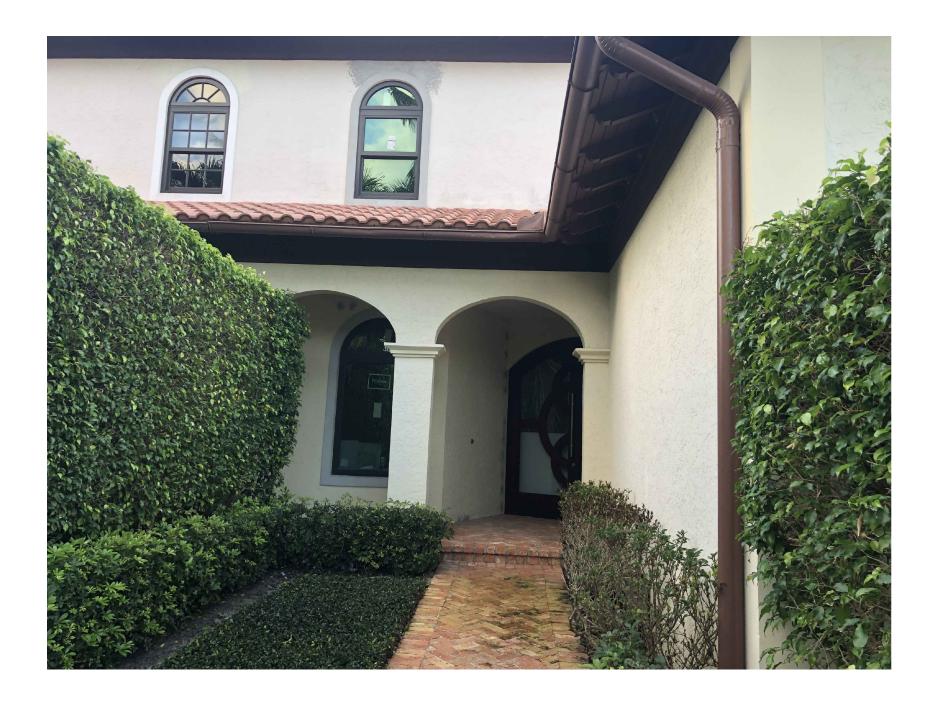

Existing Morthwest Corner



Existing Morth Side



Existing East Side



Existing East Buffer



Existing South Buffer

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Construction, as the term is generally understood, and that ENVIRONMENT DESIGN GROUP does not provide landscape architectural services during construction, including on—site monitoring, site visits, shop drawing review, design clarification, etc., the client agrees to indemnify and hold harmless ENVIRONMENT DESIGN GROUP from any liability arising from, acts or omissions in the performance of said services during construction by the client, and his/her agents, employees, or subcontractors.

48 HOURS BEFORE DIGGING CALL TOLL FREE 1-800-432-4770

ARC-23-0034 ZOM-24-0020 Existing Site Photos

**DE/IGN** ROUP Landscape Architecture Land Planning Landscape Management Dustin M. Mizell, MLA RLA #6666784 Dustin@environmentdesigngroup.com

JOB NUMBER: # 24103.00 LA DRAWN BY: Alex Bugrii

DATE: 05.23.2024

✓HEET L1.1

E AVIROAMEAT DE/IG/I GROUP 139 North County Road S#20-B Palm Beach, FI 33480 Phone 561.832.4600 Mobile 561.313.4424 Landscape Architecture Land Planning Landscape Management AUSTRALIAN AVE Dustin M. Mizell, MLA RLA #6666784 Dustin@environmentdesigngroup.com EXISTING FICUS NITIDA FICUS HEDGE EXISTING FICUS NITIDA FICUS HEDGE EXISTING FICUS MICRACARPA GREEN ISLAND FICUS EXISTING SCHEFFLERA ARBORICOLA SCHEFFLERA PLANT EXISTING WODYETIA BIFURCATA FOXTAIL PALM DRIVEWAY EXISTING SCHEFFLERA ARBORICOLA SCHEFFLERA PLANT EXISTING TRACHELOSPERMUM ASIATICUM JASMINE GROUNDCOVER Residen EXISTING SCHEFFLERA ARBORICOLA SCHEFFLERA PLANT A/C EXISTING SCHEFFLERA ARBORICOLA SCHEFFLERA PLANT RESIDENCE EXISTING SCHEFFLERA ARBORICOLA SCHEFFLERA PLANT EXISTING FICUS NITIDA FICUS HEDGE JOB NUMBER: # 24103.00 LA DRAWN BY: Alex Bugrii EXISTING SCHEFFLERA ARBORICOLA SCHEFFLERA PLANT DATE: 05.23.2024 POOL FOUNTAIN

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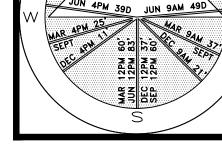
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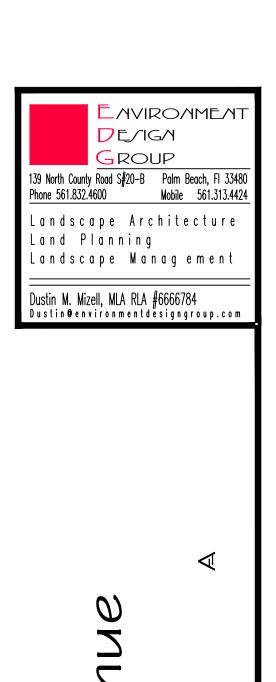
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Existing Vegetation Inventory Scale INVERTOR

ARC-23-0034 ZON-24-0020

/HEET L2.0






Resider

JOB NUMBER: # 24103.00 LA DRAWN BY: "Dustin Mizell DATE: 05.23.2024

/HEET L3.0

ARC-23-0034 ZON-24-0020 Demolition and Vegetation Action Plan Scale IN FEET O'

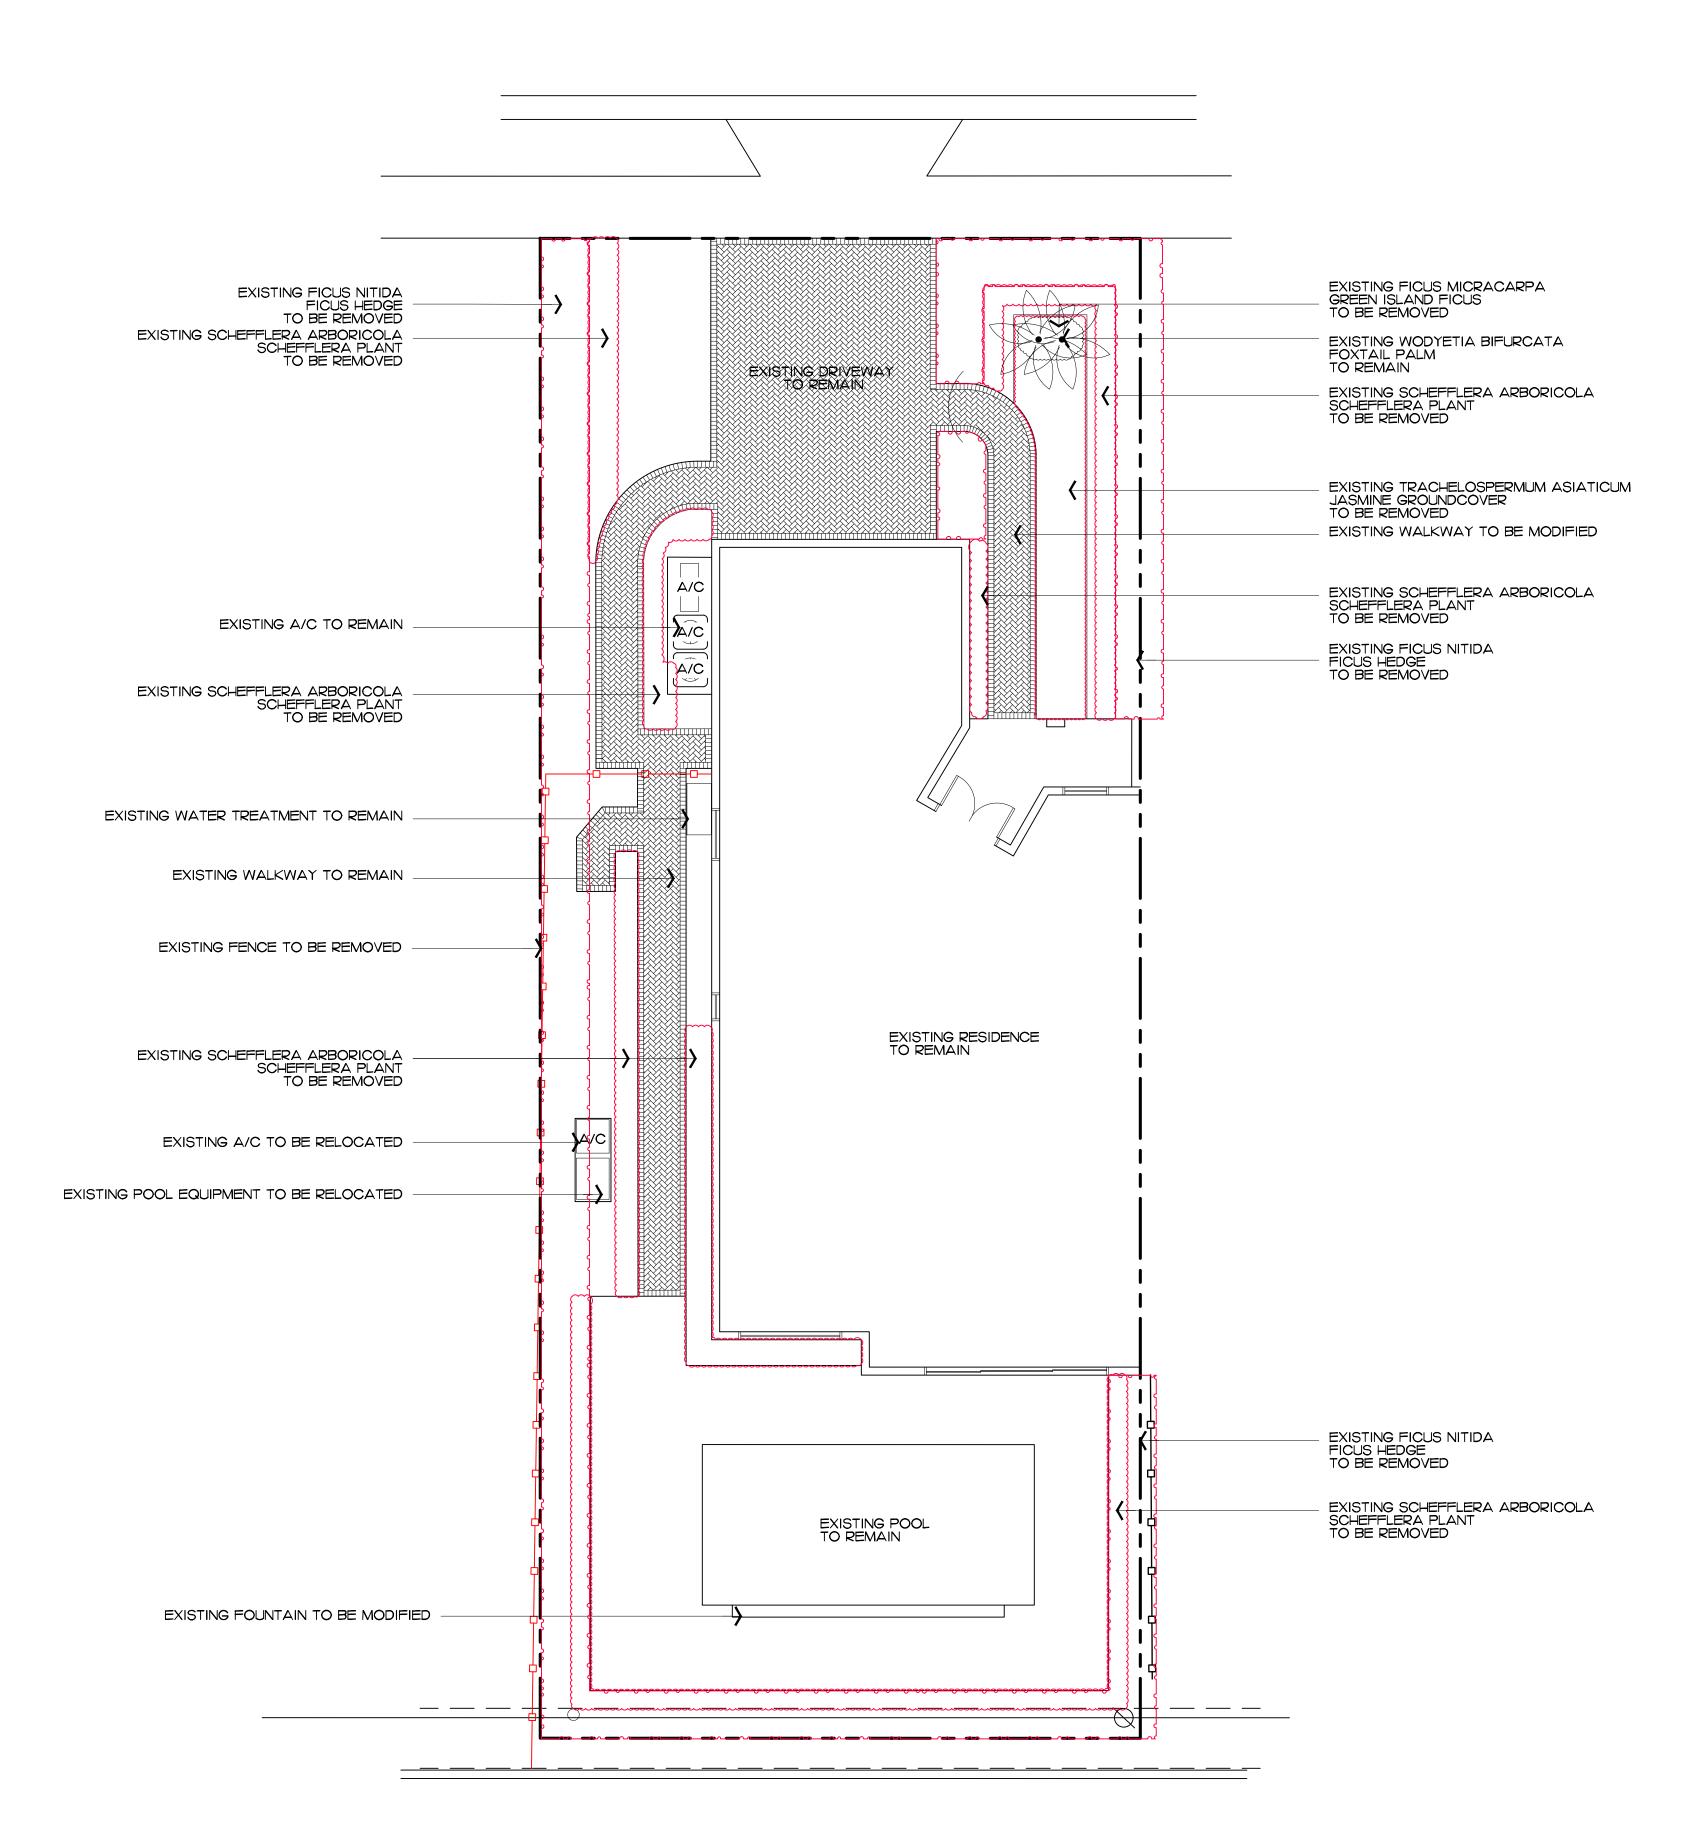

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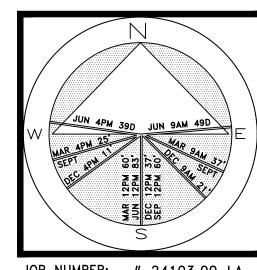
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# Resider



JOB NUMBER: # 24103.00 LA DRAWN BY: Dustin Mizell DATE: 05.23.2024

/HEET L4.0

ARC-23-0034 ZON-24-0020

18' HT. X 20' WIDE CHAIN-LINK ROLLING GATE W/ SCREENING EXISTING FICUS NITIDA FICUS HEDGE TO BE REMOVED NOTE: PLANTING ALONG THE PROPERTY LINE TO REMAIN AS SCREENING UNTIL A NEW SITE WALL, NEW FENCING, OR NEW LANDSCAPING IS INSTALLED EXISTING WODYETIA BIFURCATA FOXTAIL PALM TO REMAIN EXISTING DRIVEWAY TO REMAIN EXISTING FICUS NITIDA
FICUS HEDGE +/- 20' HT TYP
TO BE REMOVED
NOTE: PLANTING ALONG THE PROPERTY
LINE TO REMAIN AS SCREENING UNTIL
A NEW SITE WALL, NEW FENCING, OR
NEW LANDSCAPING IS INSTALLED 18' HT. CHAIN-LINK CONSTRUCTION FENCE W/ SCREENING NOTE: DUE TO CONSTRUCTION ON WEST SIDE OF A PROPERTY SCREENING FENCE IS NOT APPLICABLE EXISTING RESIDENCE TO REMAIN 18' HT. CHAIN-LINK CONSTRUCTION FENCE W/ SCREENING EXISTING FICUS NITIDA
FICUS HEDGE
TO BE REMOVED
NOTE: PLANTING ALONG THE PROPERTY
LINE TO REMAIN AS SCREENING UNTIL
A NEW SITE WALL, NEW FENCING, OR
NEW LANDSCAPING IS INSTALLED EXISTING POOL TO REMAIN EXISTING FOUNTAIN TO BE MODIFIED

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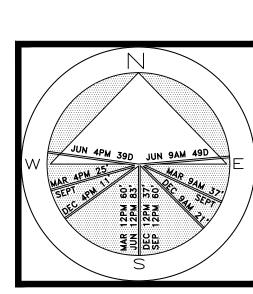
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Construction Screening Plan Scale IN FEET O'



Residen



JOB NUMBER: # 24103.00 LA DRAWN BY: Dustin Mizell DATE: 05.23.2024

/HEET L5.0

ARC-23-0034 ZOM-24-0020

18' HT. X 20' WIDE CHAIN-LINK ROLLING GATE W/ SCREENING DUMPSTER EXISTING FICUS NITIDA
FICUS HEDGE
TO BE REMOVED
NOTE: PLANTING ALONG THE PROPERTY
LINE TO REMAIN AS SCREENING UNTIL
A NEW SITE WALL, NEW FENCING, OR
NEW LANDSCAPING IS INSTALLED EXISTING PARKING AREA EXISTING WODYETIA BIFURCATA FOXTAIL PALM TO REMAIN EXISTING DRIVEWAY EXISTING FICUS NITIDA
FICUS HEDGE +/- 20' HT TYP
TO BE REMOVED
NOTE: PLANTING ALONG THE PROPERTY
LINE TO REMAIN AS SCREENING UNTIL
A NEW SITE WALL, NEW FENCING, OR
NEW LANDSCAPING IS INSTALLED 18' HT. CHAIN-LINK CONSTRUCTION FENCE W/ SCREENING A/C (A/C) EXISTING RESIDENCE TO REMAIN 18' HT. CHAIN-LINK CONSTRUCTION FENCE W/ SCREENING EXISTING FICUS NITIDA
FICUS HEDGE
TO BE REMOVED
NOTE: PLANTING ALONG THE PROPERTY
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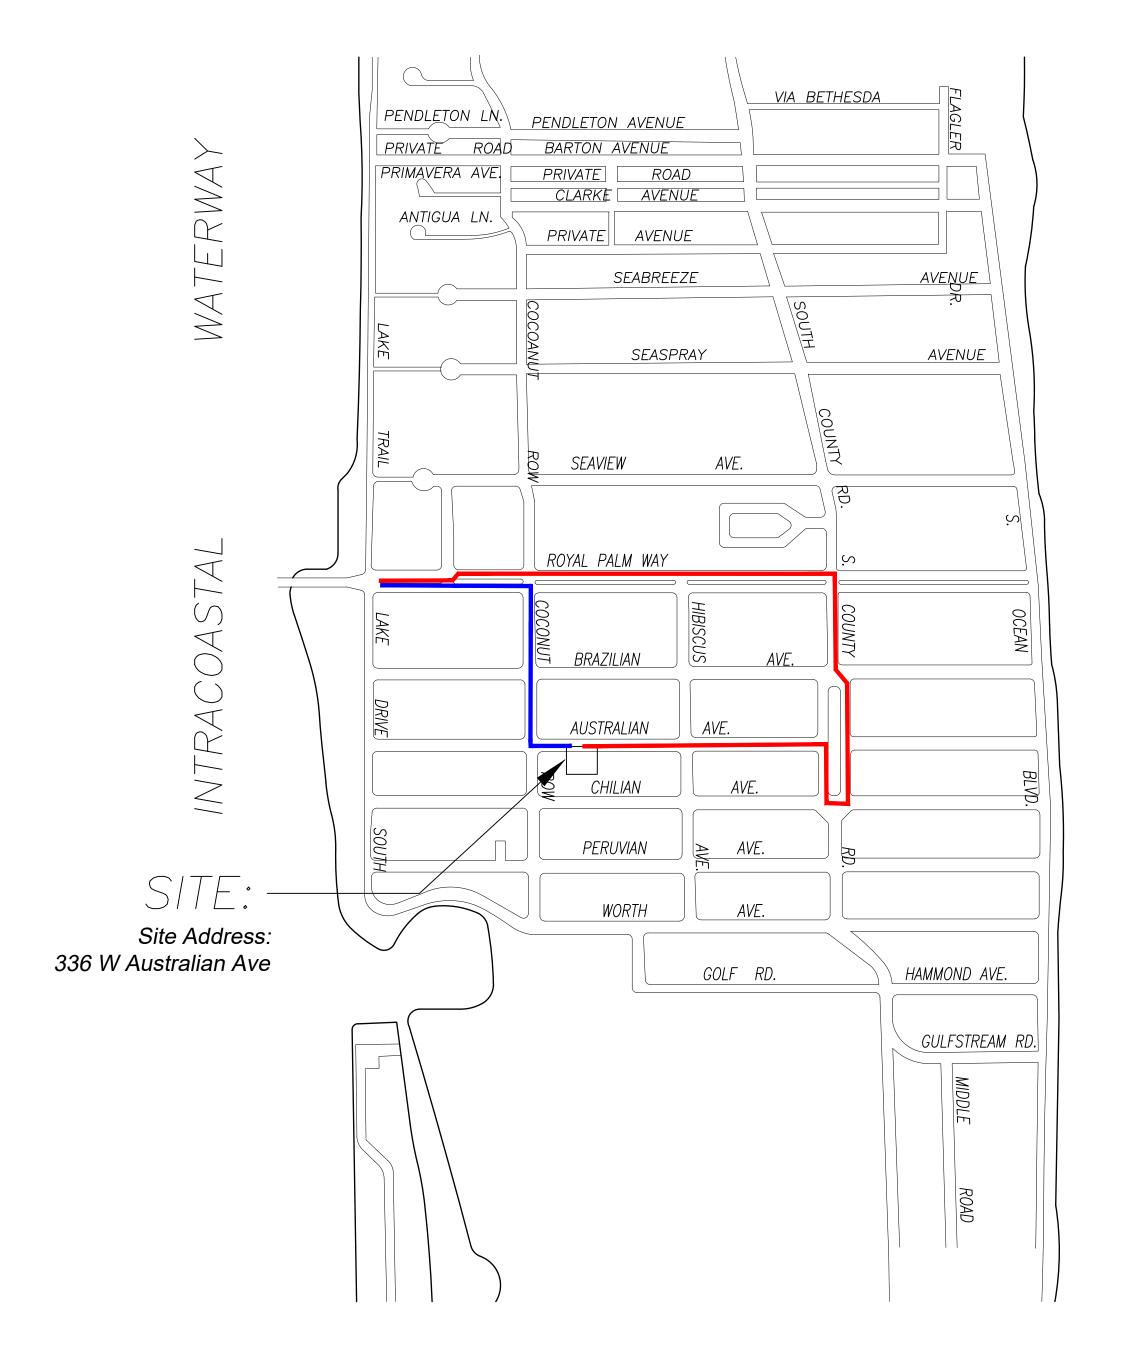
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Construction Staging Plan Scale IN FEET O'





CONCEPTUAL CONSTRUCTION SCHEDULE JUN 1TH 2024 - ARCOM MEETING JUL 15TH 2024 - TOWN COUNCIL OCT-NOV 2024 - SUBMIT FOR PERMIT • 1 MONTH -DEC 2024 - MOBILIZATION & DEMOLITION OF EXISTING STRUCTURES - SITE/BUILDING PREPARATION • 2 MONTHS • 1.5 MONTHS FOUNDATION • 2.5 MONTHS BLOCK DELIVERIES & CONC. POURS • 2 MONTHS - ROUGH-IN - LANDSCAPE/HARDSCAPE/GATE • 2 MONTHS INSTALLATION 2 MONTHS - FINAL INSPECTIONS +/-12 MONTHS - PROPOSED TOTAL CONSTRUCTION FOLLOWING BUILDING PERMIT

PROPOSED TRUCK INGRESS / EGRESS ROUTES MAP

SCHEDULE:

MONTH 1: DEMOLITION AND CLEANUP (3 - 5 DAYS)

LARGEST TRUCK ->

10-15 DUMP TRUCKS FOR DEBRIS REMOVAL TRAILER FOR EXCAVATOR / DEMOLITION LANDSCAPE TRUCKS -> SOD IRRIGATION

NOTE: SEE SEPARATE "CONSTRUCTION STAGING PLAN" SHEET FOR INFORMATION ON LOCATIONS FOR PARKING, MATERIAL STORAGE, DELIVERIES, DUMPSTER, PORTABLE TOILETS, TIRE CLEANING AREA, SILT FENCE, ETC.

PROPOSED INGRESS TRUCK ROUTE

PROPOSED EGRESS TRUCK ROUTE

/HEET L6.0 ARC-23-0034 ZOM-24-0020 Truck Logistics Plan

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of the Landscape Architect.

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Resider

 $\Box$ 

JOB NUMBER: # 24103.00 LA DRAWN BY: Alex Bugrii

DATE: 05.23.2024

Resider

JOB NUMBER: # 24103.00 LA DRAWN BY: Alex Bugrii

DATE: 05.23.2024

∫HEET L7.0

AREA IN SQ.FT.

ARC-23-0034 ZOM-24-0020 16'

6,252 S.F.

36.35%

51.28%

60.25%


PROPOSED

2,273 S.F.

641 S.F.

1,695 S.F.

## AUSTRALIAN AVE

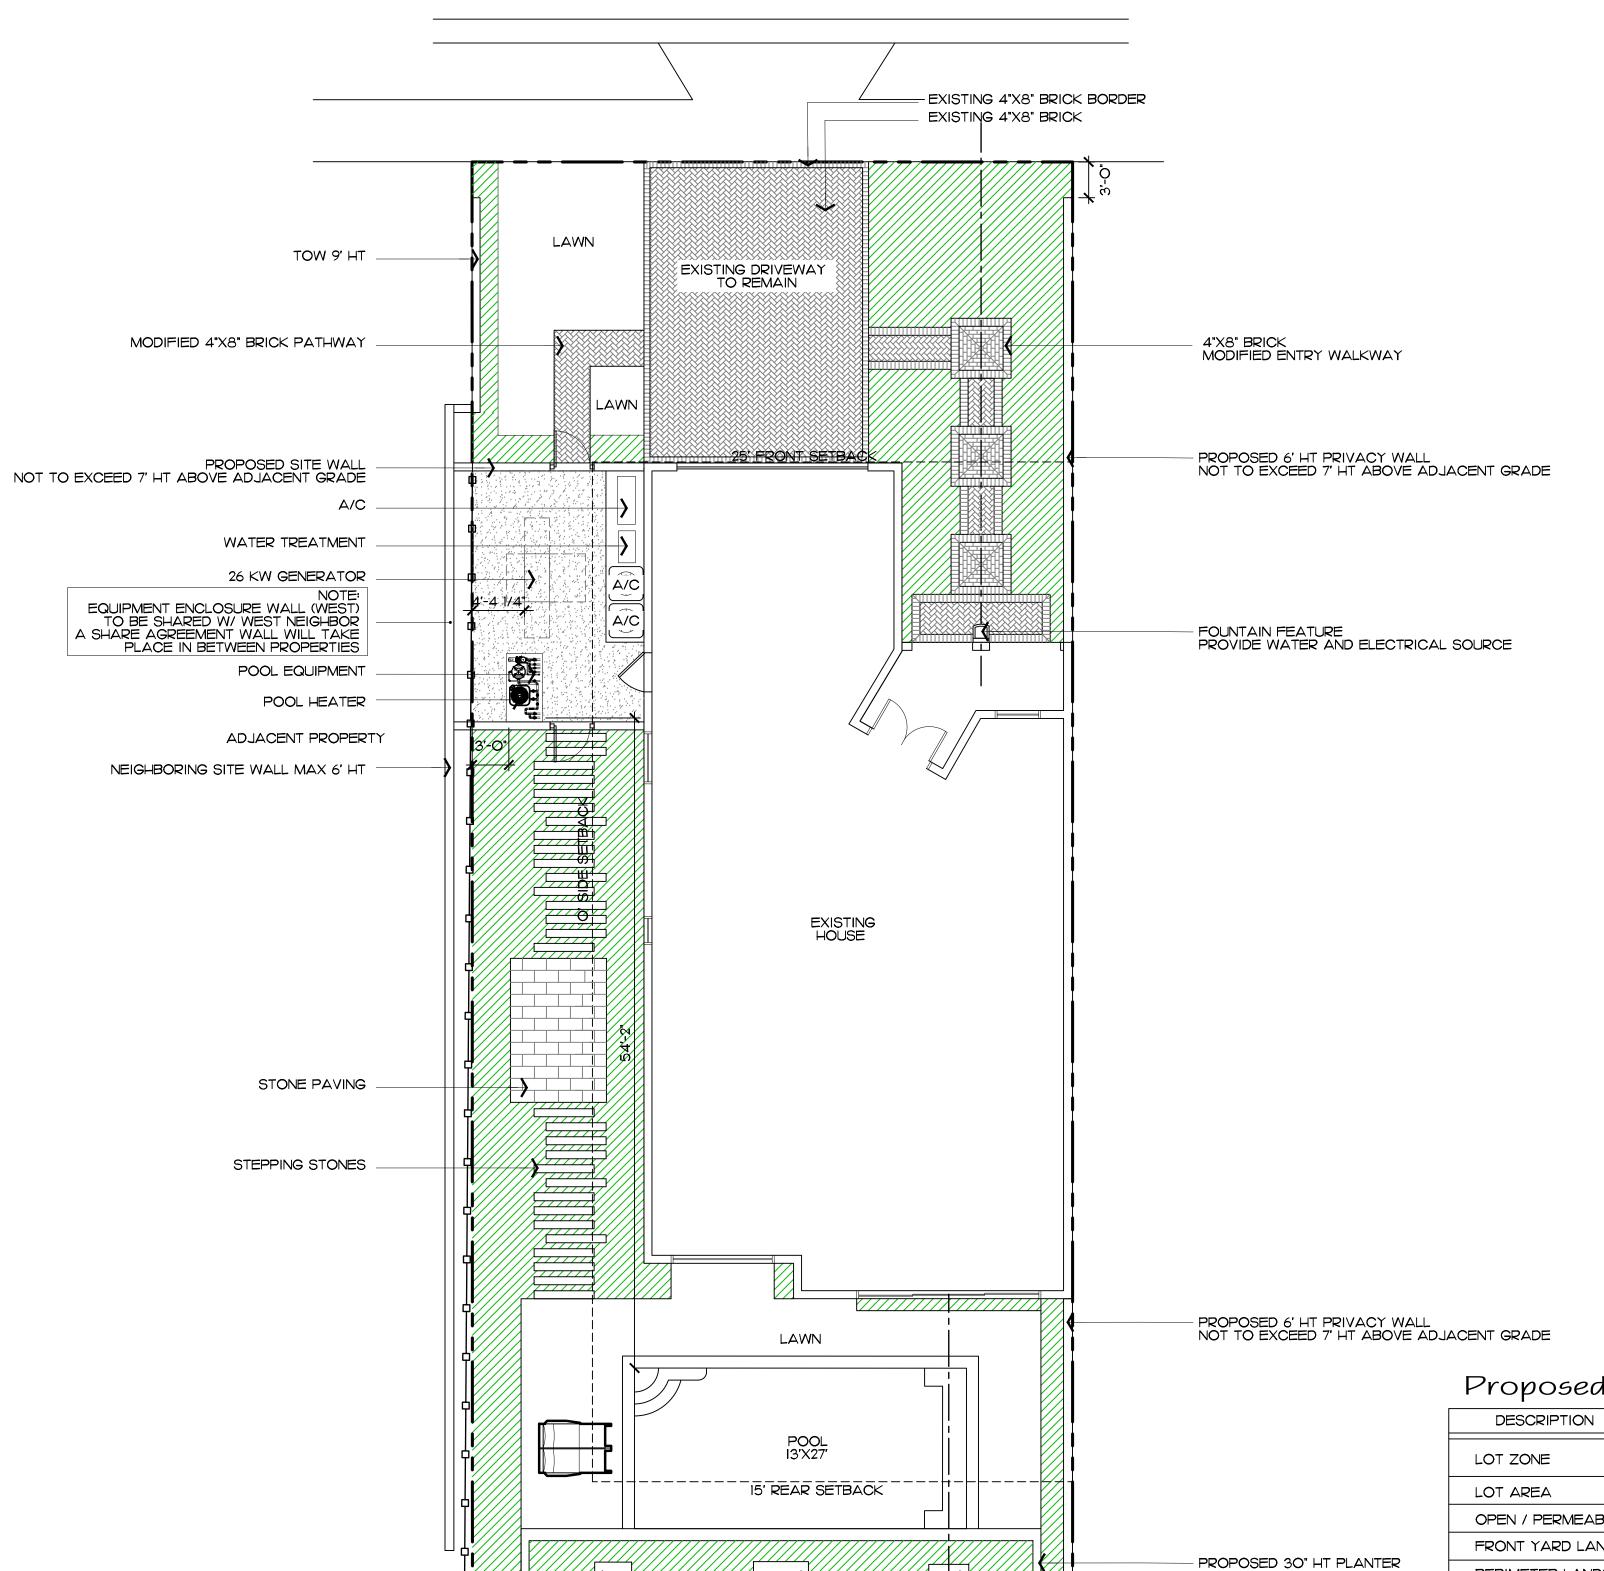

Proposed Site Data

-SCULPTURE PEDESTAL

REQUIRED EXISTING R-C MEDIUM DENSITY RESIDENTIAL 10,000 S.F. MINIMUM OPEN / PERMEABLE SPACE MINIMUM 45% 2,813 S.F. 1,672 S.F. 26.74% MINIMUM 40% OF FRONT YARD 500 S.F. MINIMUM 50% OF REQ'D OPEN SPACE 1,406 S.F. FRONT YARD LANDSCAPE 54.56% 682 S.F. PERIMETER LANDSCAPE WITHIN IO' OF PROPERTY LINE 54.14% 1,523 S.F.

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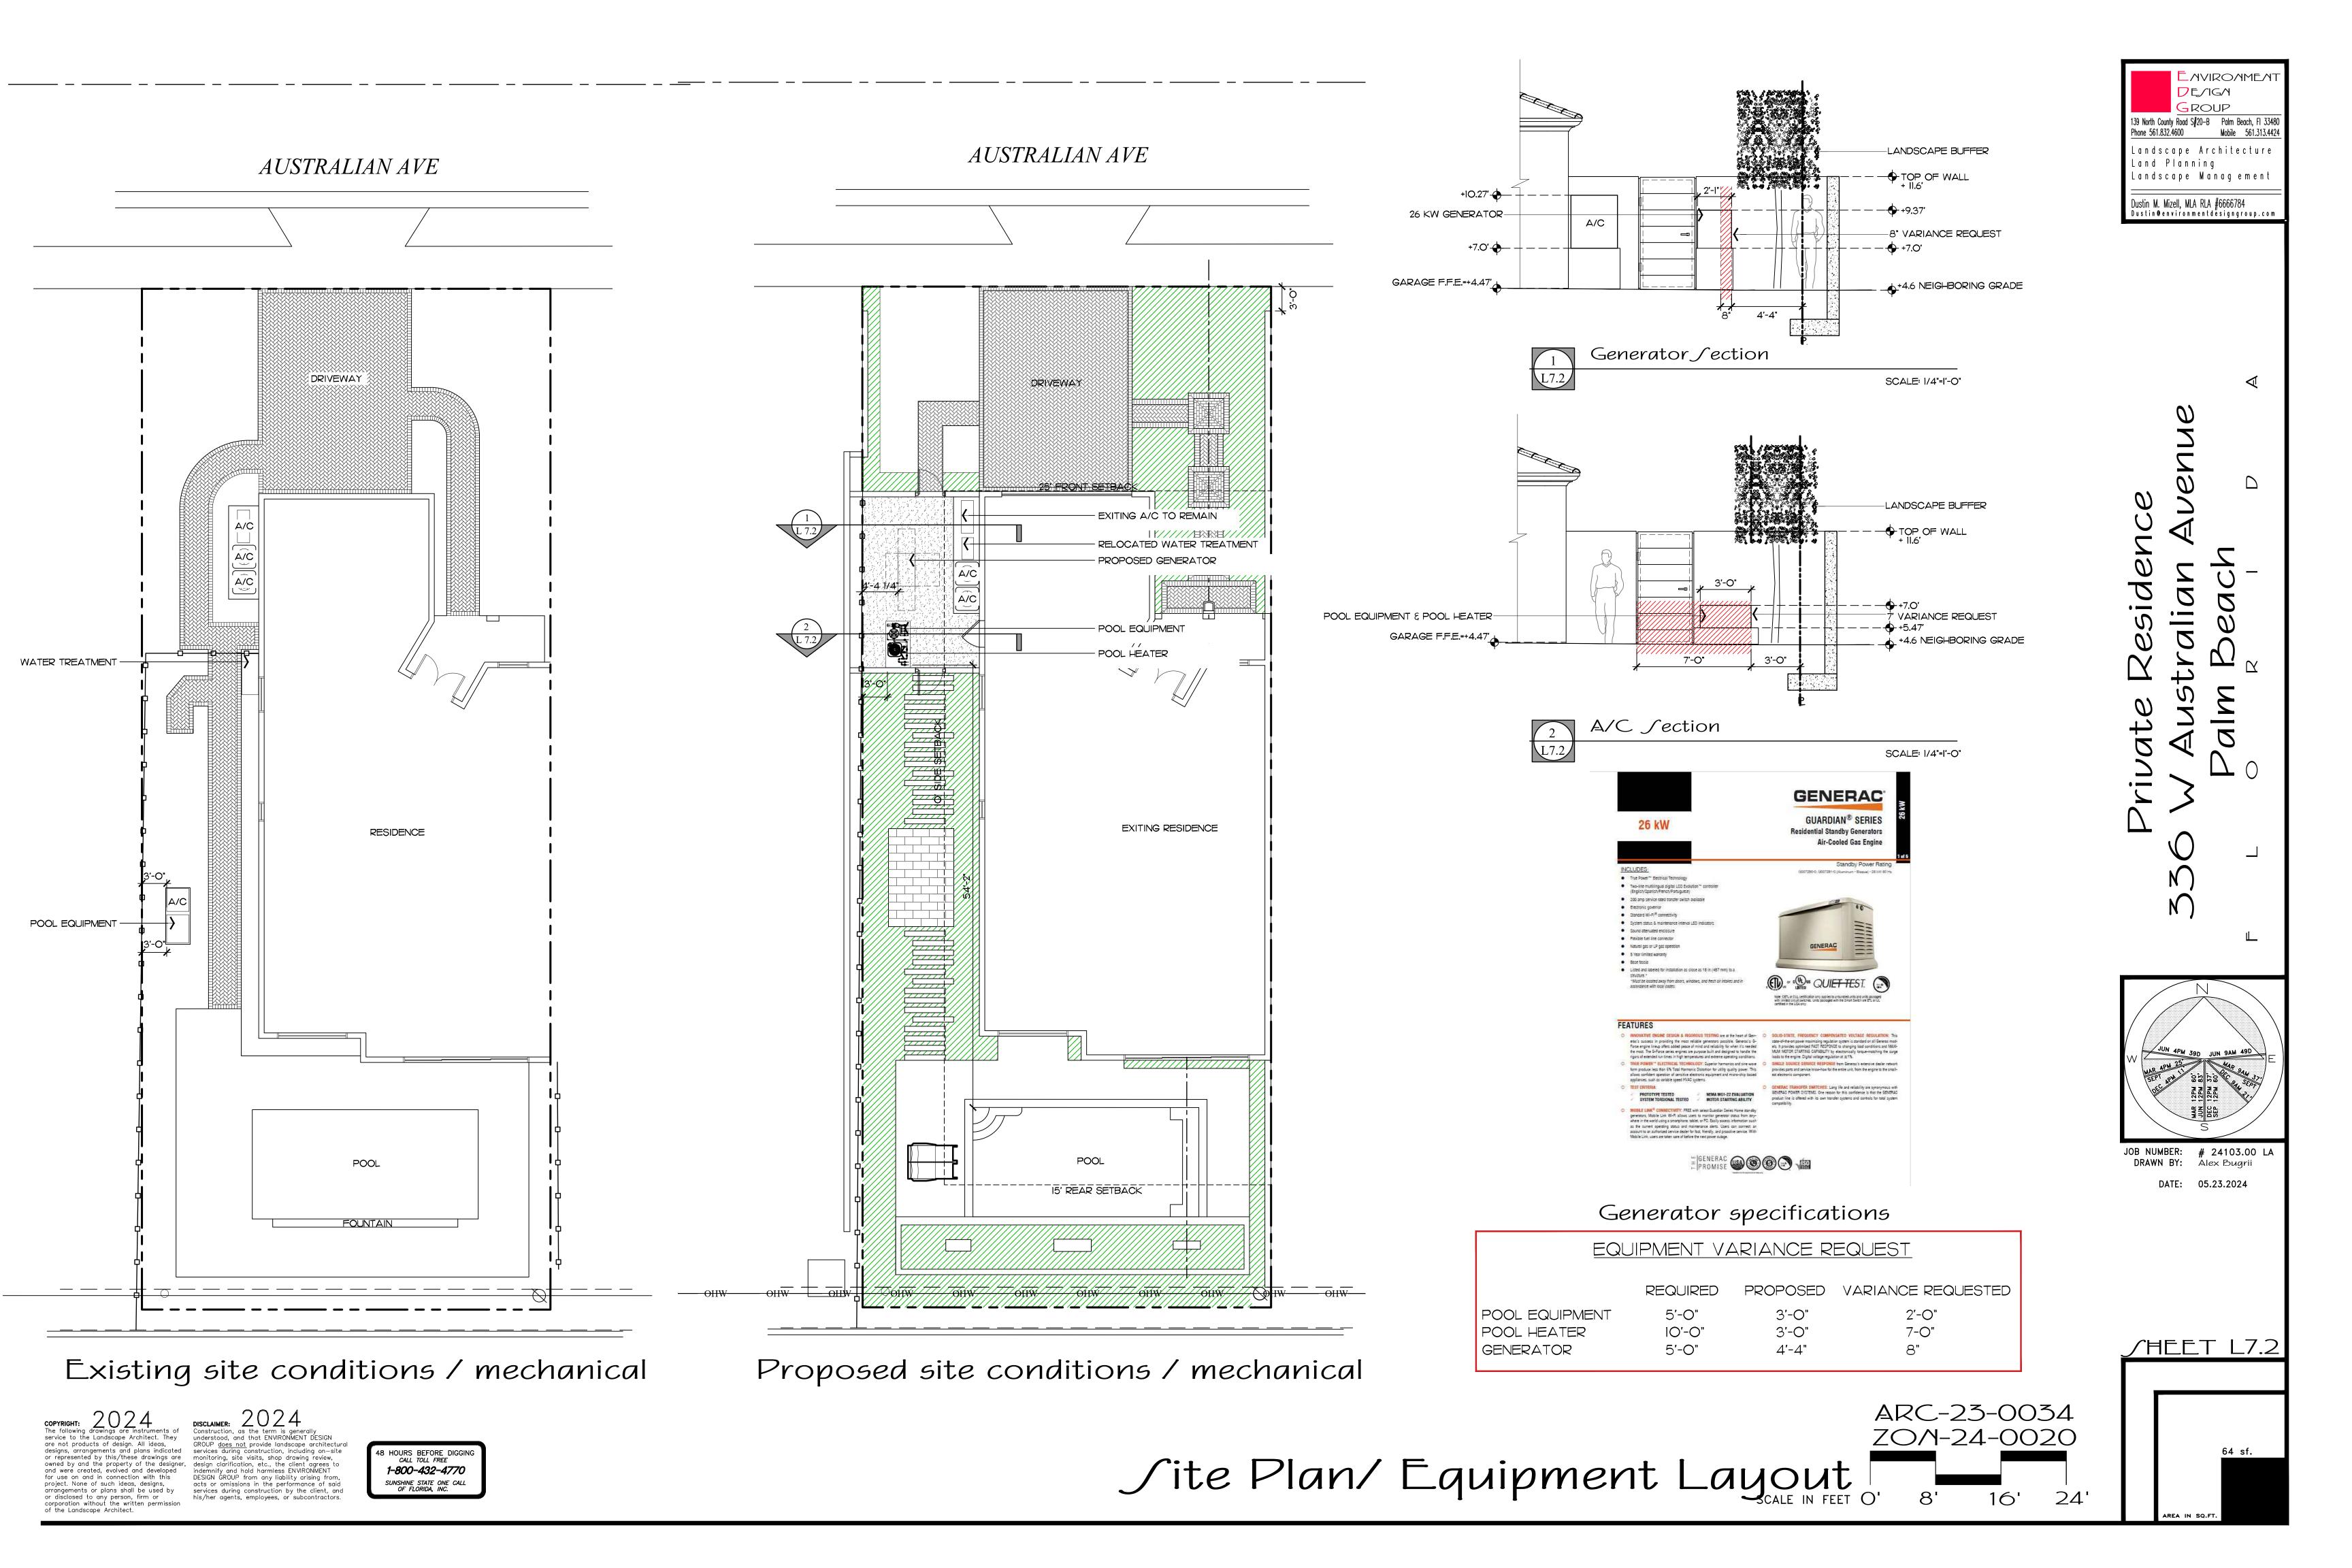
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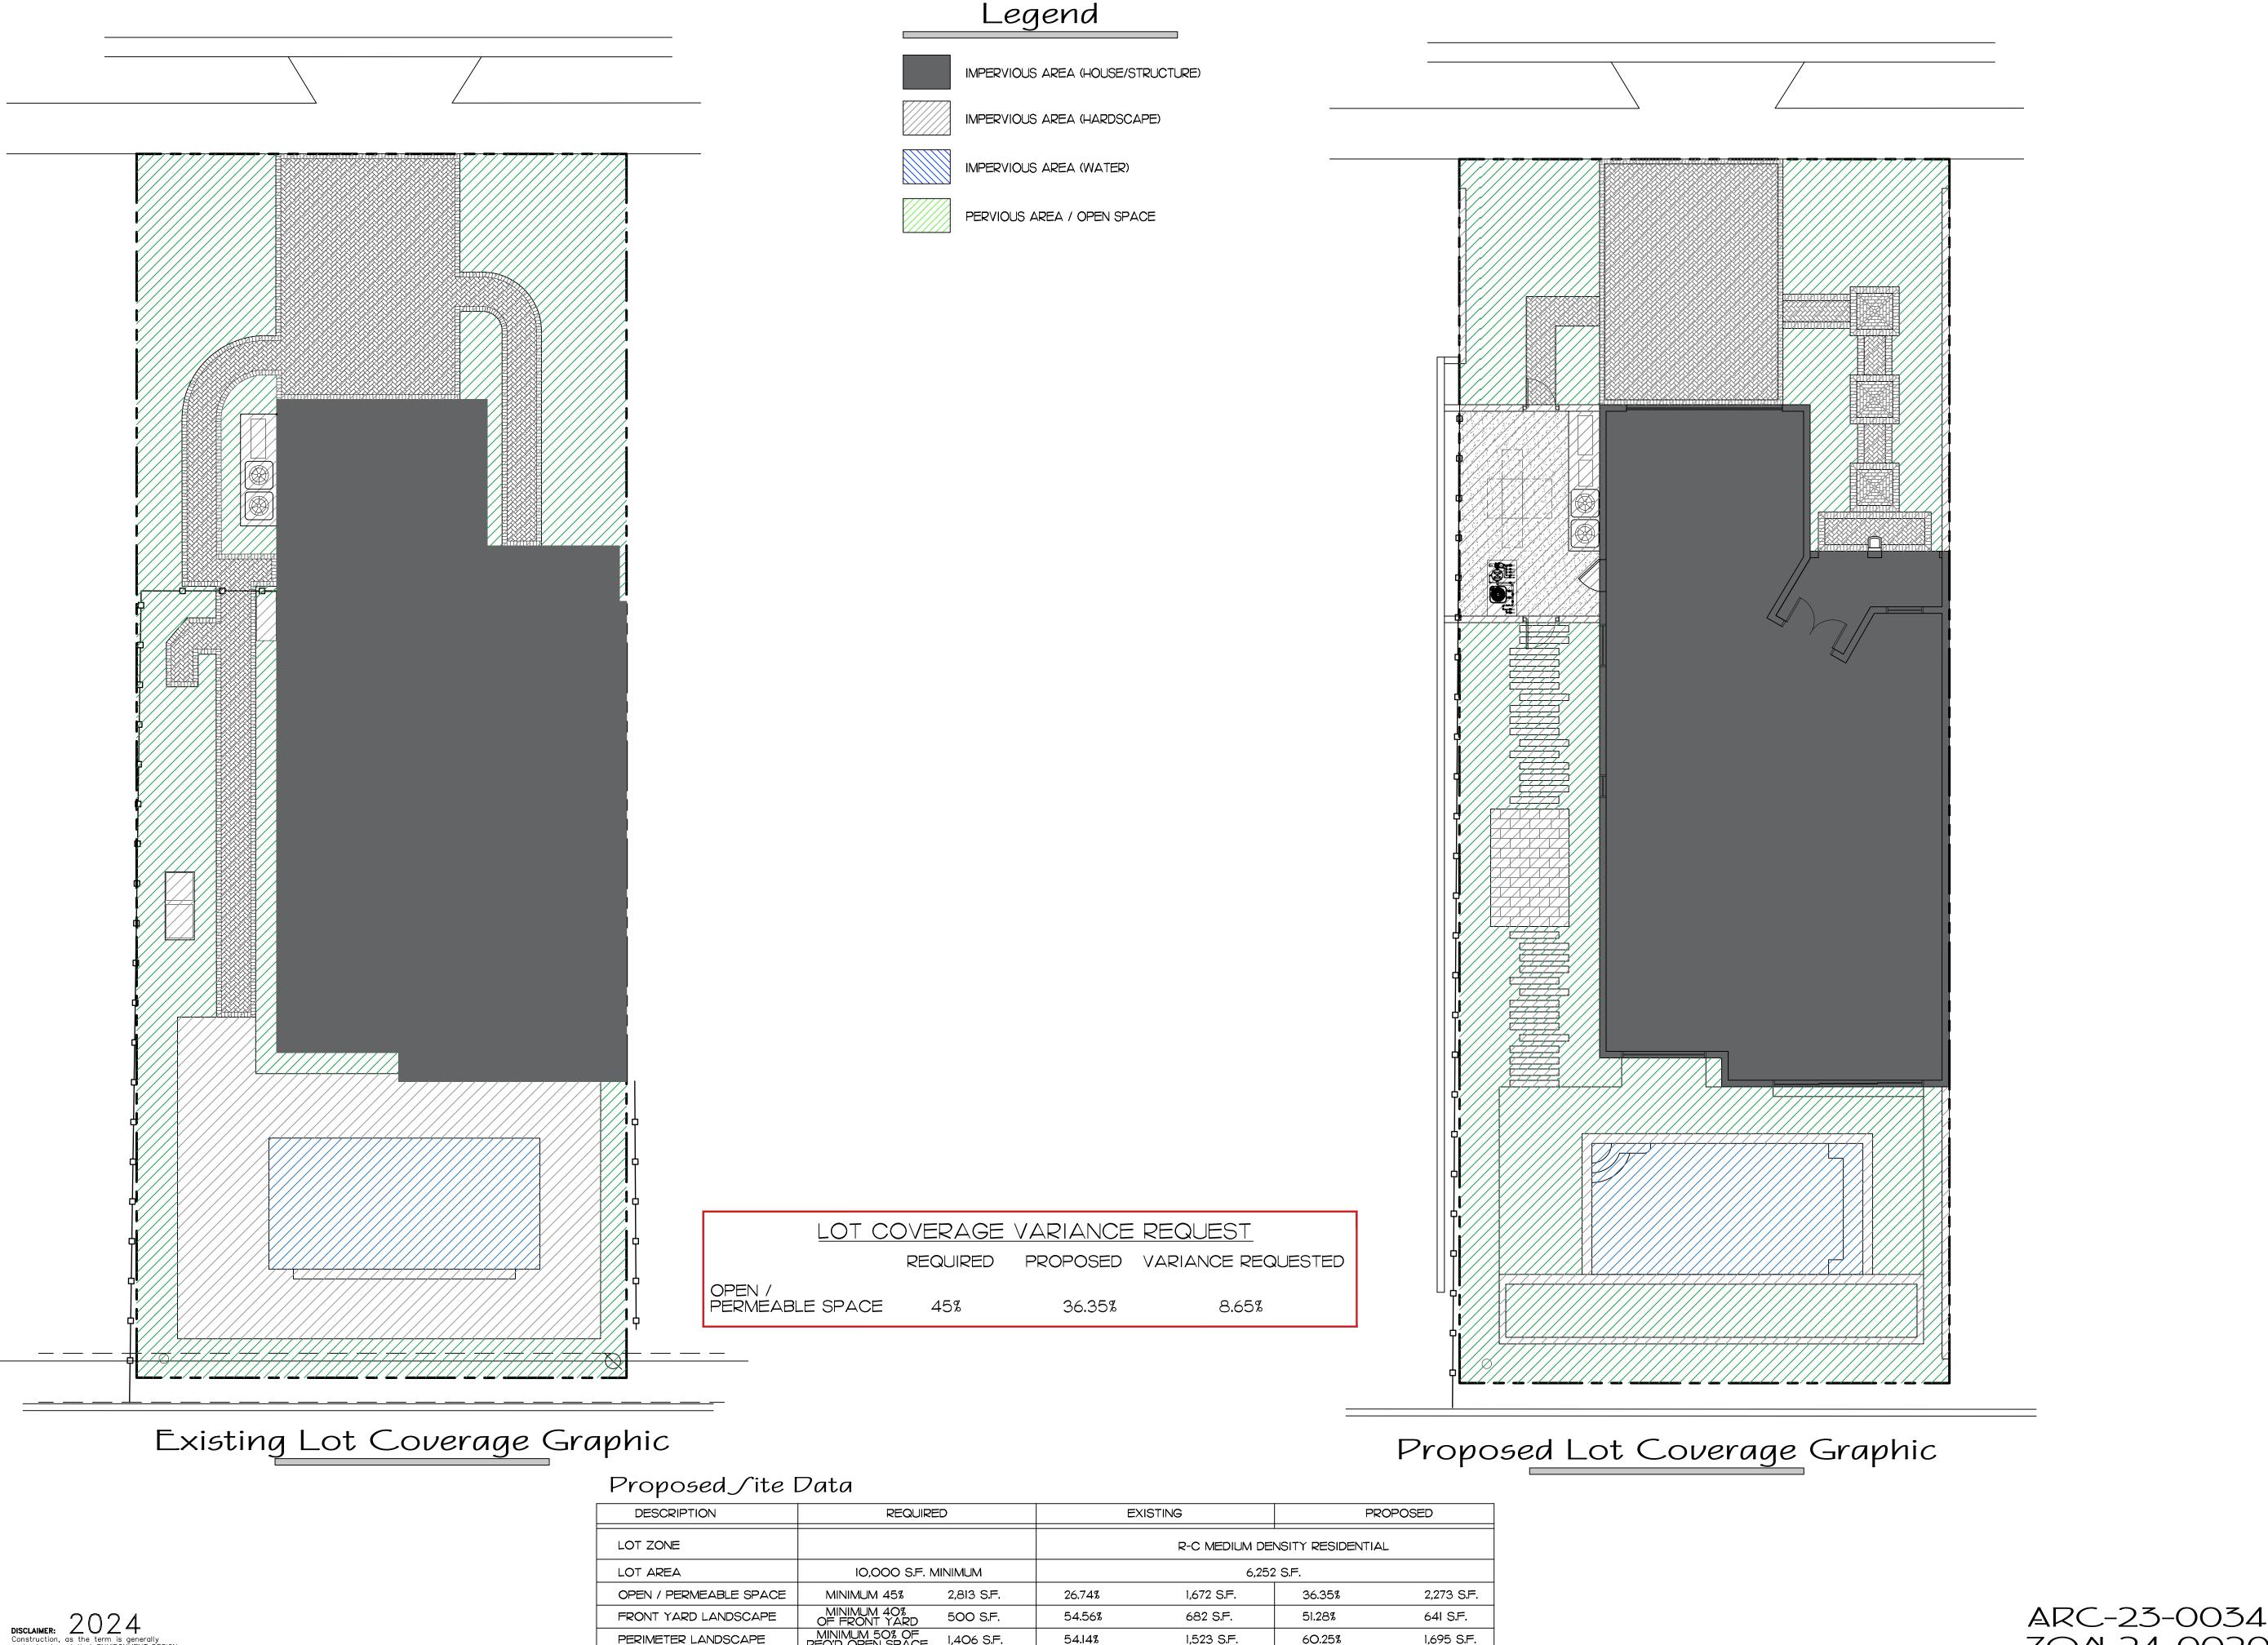
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SCULPTURE PEDESTAL





DE/IG/I GROUP 139 North County Road S#20-B Palm Beach, FI 33480 Phone 561.832.4600 Mobile 561.313.4424 Landscape Architecture Land Planning Landscape Management

Dustin M. Mizell, MLA RLA #6666784 Dustin@environmentdesigngroup.com

JOB NUMBER: # 24103.00 LA DRAWN BY: Alex Bugrii DATE: 05.23.2024

<u> </u>						
DESCRIPTION	REQUIRED		EXISTING		PROPOSED	
LOT ZONE			R-C MEDIUM DENSITY RESIDENTIAL			
LOT AREA	10,000 S.F. MINIMUM		6,252 S.F.			
OPEN / PERMEABLE SPACE	MINIMUM 45%	2,813 S.F.	26.74%	1,672 S.F.	36.35%	2,273 S.F.
FRONT YARD LANDSCAPE	MINIMUM 40% OF FRONT YARD	500 S.F.	54.56%	682 S.F.	51.28%	641 S.F.
PERIMETER LANDSCAPE WITHIN IO' OF PROPERTY LINE	MINIMUM 50% OF REQ'D OPEN SPACE	1,406 S.F.	54.14%	1,523 S.F.	60.25%	1,695 S.F.

Site Calculation/ Open Space Diagram

ZON-24-0020

/HEET L7.1


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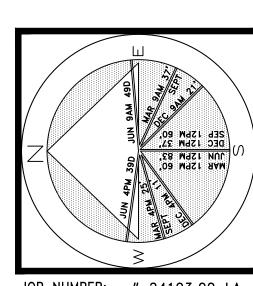
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## AUSTRALIAN AVE





ivate Residence / Australian Avenue

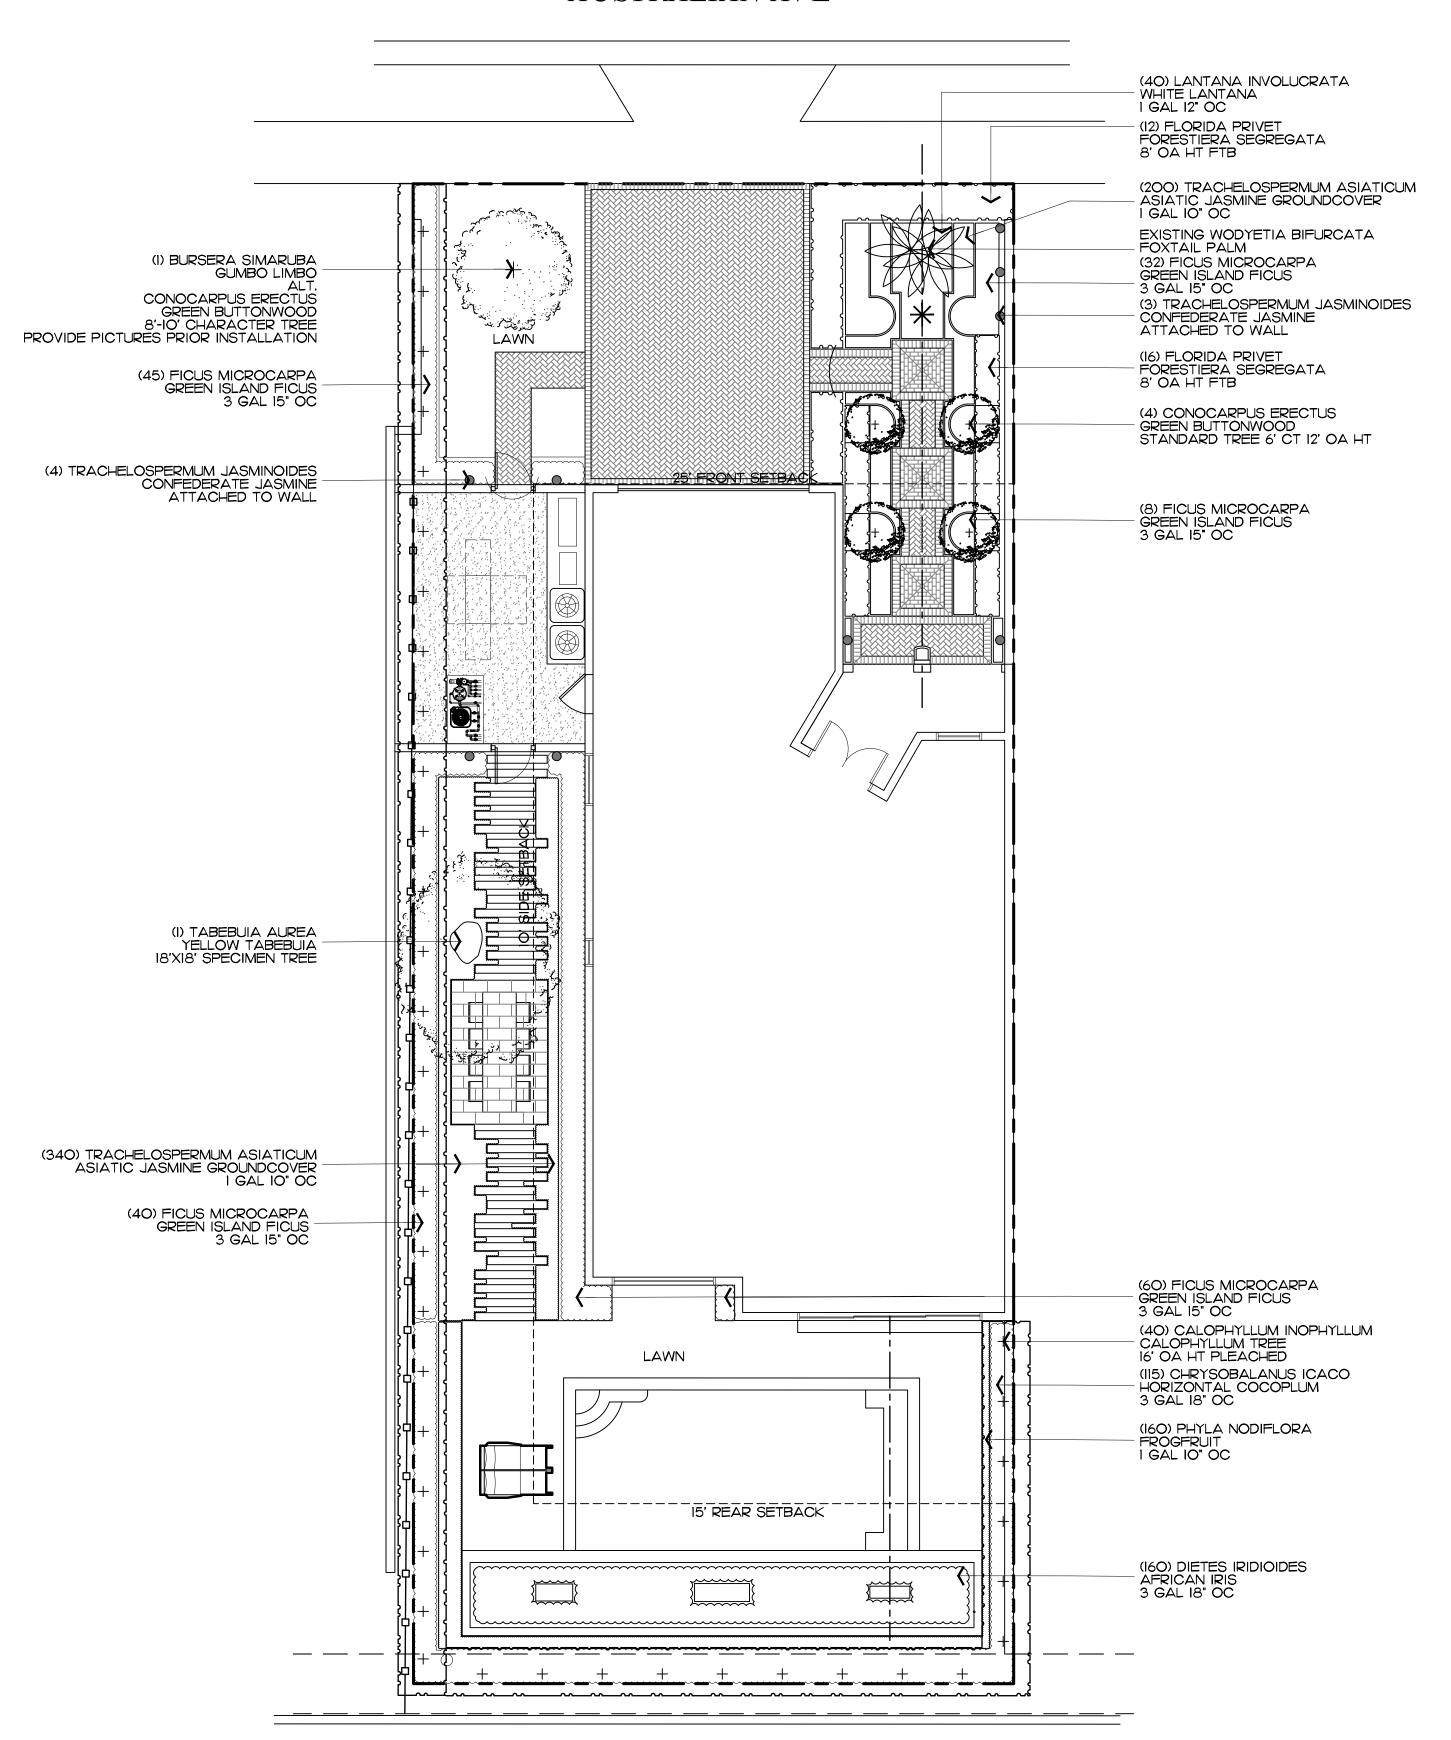

JOB NUMBER: # 24103.00 LA Alex Bugrii

DATE: 05.23.2024

∕ĦEET L8.0

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OF FLORIDA, INC.

Landscape Plan Scale IN FEET O'

ARC-23-0034 ZON-24-0020 711 N FEET O' 4' 8' 16'

64 sf.

AREA IN SQ.FT.



JOB NUMBER: # 24103.00 LA DRAWN BY: Dustin Mizell DATE: 05.23.2024

✓ĦEET L9.0

ARC-23-0034 ZOM-24-0020 Rendered Landscape Plan



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# Trees

SYMBOL	PLANT NAME	QTY.	DESCRIPTION	NATIVE
	TABEBUIA AUREA YELLOW TABEBUIA TREE	l	18'X18' CHARACTER SPECIMEN TREE PROVIDE IMAGE UPON INSTALLATION	NO
	CONOCARPUS ERECTUS GREEN BUTTONWOOD	4	STANDARD TREE 6' CT 12" OA HT	YES
+	BURSERA SIMARUBA ALT. CONOCARPUS ERECTUS	I	CHARACTER TREE 8'-10' OA HT	YES
	TOTAL TREES: NATIVE SPECIES:	6 5 (83%)		

# Groundcovers

SYMBOL/KEY	PLANT NAME		SF/QTY.	DESCRIPTION	NATIVE
	TRACHELOSPERMUM ASIATICUM JASMINE GOUNDCOVER		230 SF./ 540	I GAL IO" OC	NO
	PHYLA FROG FI		110 SF./ 160	I GAL IO" OC	YES
		TOTAL SF.: NATIVE SPECIES SF.:	340 SF. IIO SF. (32.35%)		

# Lawn & Mulch

SYMBOL/KEY	PLANT NAME	QTY.	DESCRIPTION
LAWN	DIAMOND ZOYSIA LAWN	AS NEEDED	SOD PALLETS
PLANTING BED	SHREDDED EUCALYPTUS MULCH	AS NEEDED	MULCH ALL BEDS 3" MIN. DEPTH

# Shrubs & Vines

SYMBOL/KEY	PLANT NAME		QTY.	DESCRIPTION	NATIVE
+ +	CALOPHYLLUM INOPHYLLUM CALOPHYLLUM TREE		40	14'-18' OA HT	NO
		LANUS ICACO AL COCOPLUM	115	3 GAL 18" OC	YES
	LANTANA IN WHITE LAN	IVOLUCRATA TANA	40	I GAL 12" OC	YES
	FICUS MICR GREEN INLA		185	3 GAL 15" OC	NO
	FLORIDA PR FORESTIER	PIVET PA SEGREGATA	28	8' OA HT FTB	YES
	DIETES IRIDIOIDES AFRICAN IRIS		160	3 GAL 18" OC	NO
	TRACHELOSPERMUM JASMINOIDES CONFEDERATE JASMINE VINE		7	ATTACHED TO WALL	NO
		TOTAL: NATIVE SPECIES:	575 183 (31.82%)		

ALL PLANT MATERIAL TO BE FLORIDA GRADE #1 OR GREATER PROVIDE PICTURES OF TREES/PALMS FOR LANDSCAPE ARCHITECT'S APPROVAL

JOB NUMBER: # 24103.00 LA DRAWN BY: Alex Bugrii DATE: 05.23.2024

/HEET L8.1 ARC-23-0034 ZOM-24-0020 Plant Schedule


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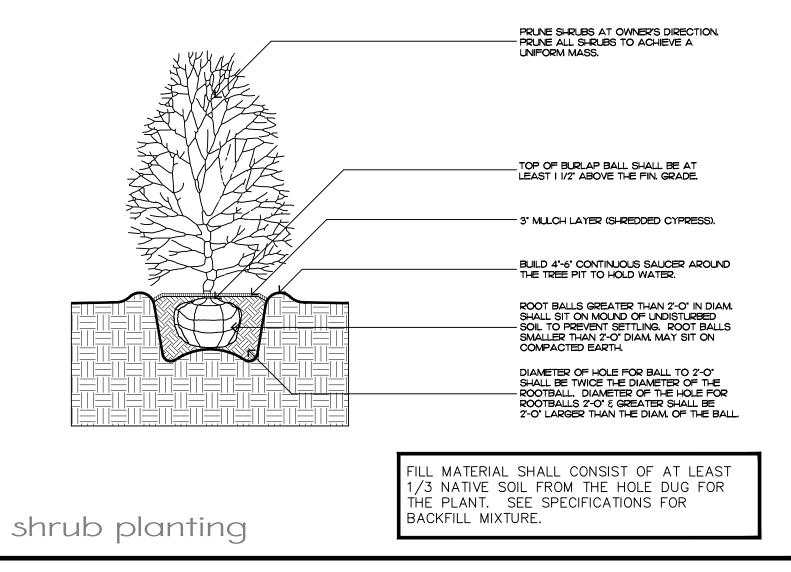
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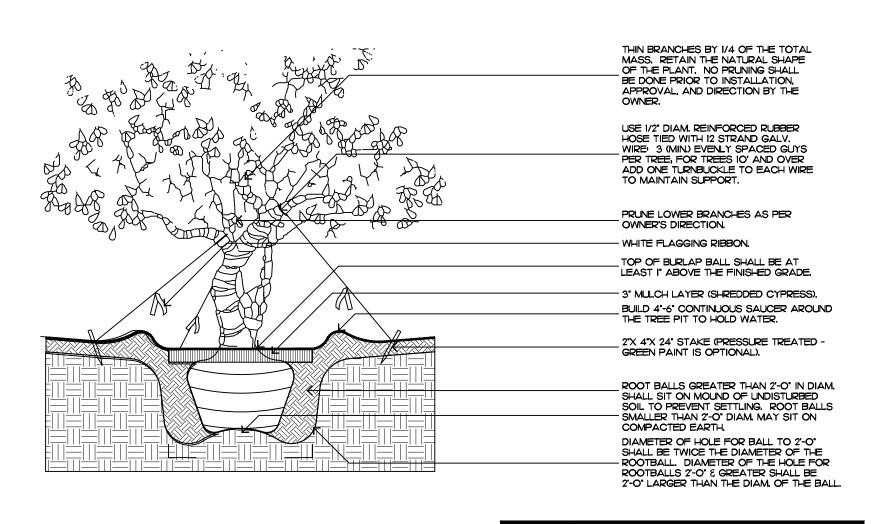
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tree planting


MATERIAL SHALL CONSIST OF AT LEAST /3 NATIVE SOIL FROM THE HOLE DUG FOR THE PLANT. SEE SPECIFICATIONS FOR BACKFILL MIXTURE.





FILL MATERIAL SHALL CONSIST OF AT LEAST 1/3 NATIVE SOIL FROM THE HOLE DUG FOR THE PLANT. SEE SPECIFICATIONS FOR BACKFILL MIXTURE.
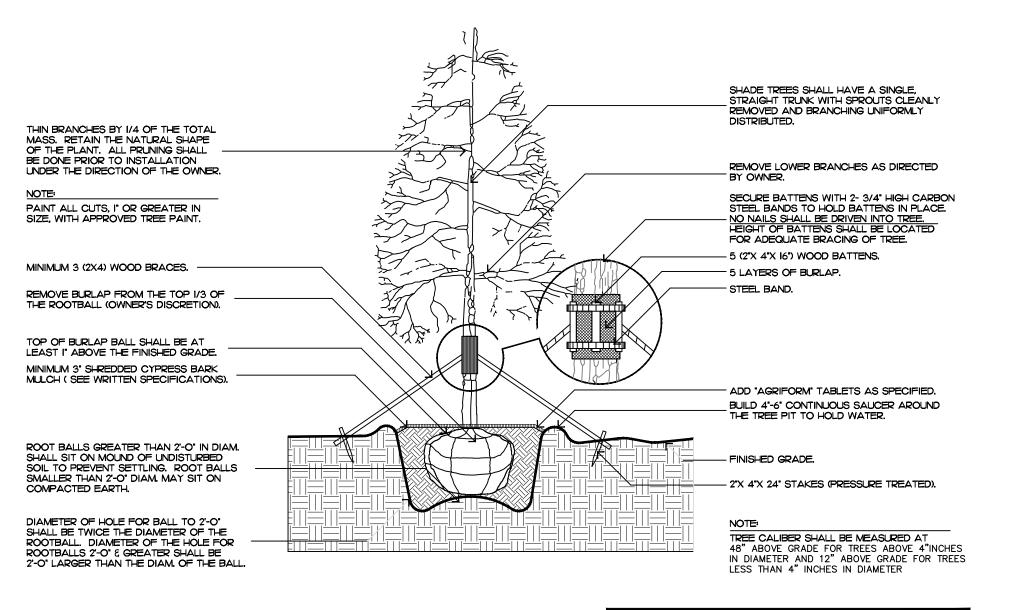
## irregular and multi-stem tree

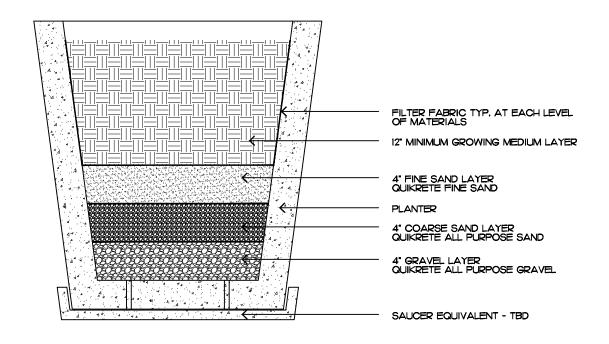


Typical Planter Sediment Filtration Detail


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shrub & ground cover layout

# Planting Motes

#### COMMERCIAL FERTILIZER:

FERTILIZER SHALL BE COMPLETELY ORGANIC, IT SHALL BE UNIFORM IN COMPOSITION, DRY AND FREE FLOWING. THIS FERTILIZER SHALL BE DELIVERED TO THE SITE IN THE ORIGINAL UNOPENED BAGS, EACH BEARING THE MANUFACTURER'S STATEMENT OF ANALYSIS, AND SHALL MEET THE FOLLOWING REQUIREMENTS:

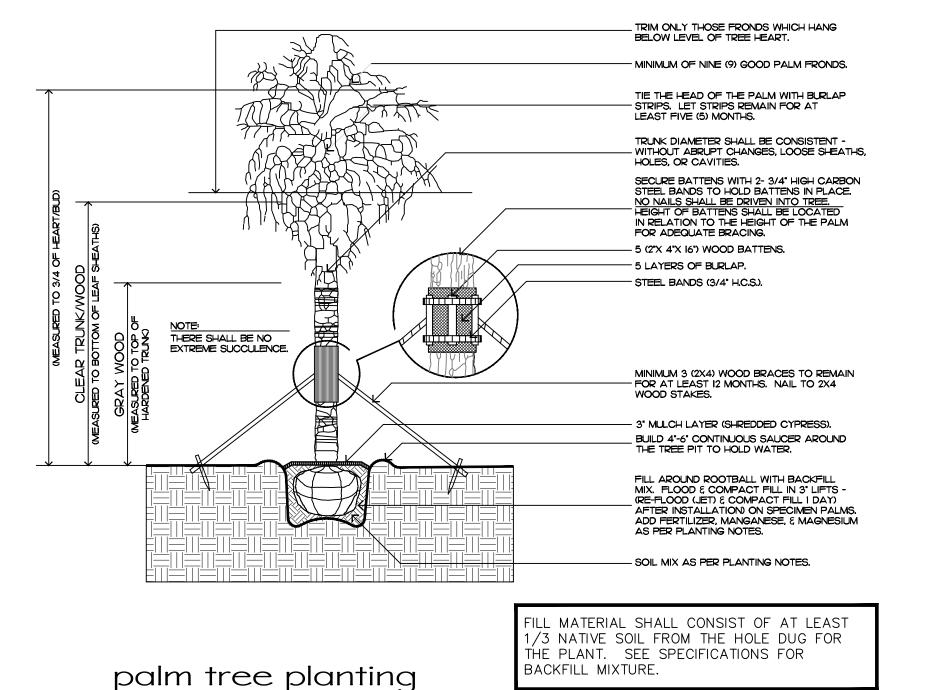SIX PERCENT (6%) PHOSPHOROUS SIX PERCENT (6%) POTASSIUM

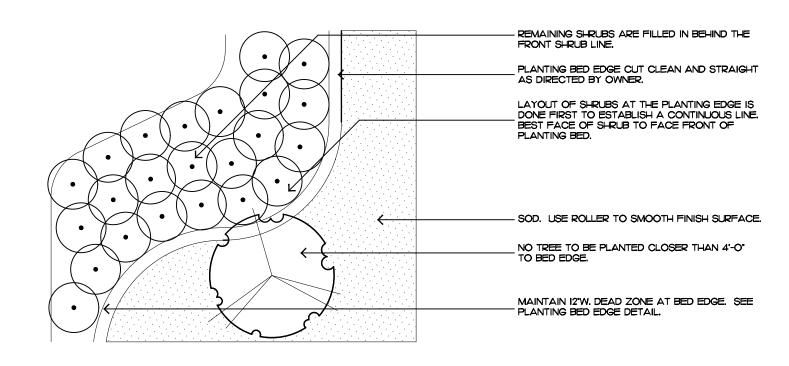FERTILIZER SHALL BE APPLIED TO ALL SHRUBS (1/3 LB. PER 3 GAL. POT, 1/4 LB. PER 1 GAL. POT) AND GROUNDCOVER. THE SAME FERTILIZER MIXTURE SHALL BE USED ON SOD AT A RATE OF 15 LBS. PER 1000 SQUARE FEET. A FOURTEEN PERCENT (14%) NITROGEN, FOURTEEN PERCENT (14%) PHOSPHOROUS AND FOURTEEN PERCENT (14%) POTASSIUM IS REQUIRED ON ALL TREES AND SHRUBS OVER 5'-O' IN HEIGHT (1/2 LB. PER 5'-O" OF SPREAD). AGRIFORM TABLETS WITH TWENTY PERCENT (20%) NITROGEN, TEN PERCENT (10%) PHOSPHOROUS, FIVE PERCENT (5%) POTASSIUM IN 21 GRAM SIZES SHALL BE APPLIED ALONG WITH THE FERTILIZER PROCESS (I WITH I GAL. PLANTS, 2 WITH 3 GAL. PLANTS AND 2 TABLETS PER I' OF TREE TRUNK CALIPER). BACK FILL HALFWAY UP THE ROOT BALL, PLACE ABOUT ONE INCH (I') FROM ROOT TIPS. MAGNESIUM SULFATE SHALL BE APPLIED TO ALL PALMS AT INSTALLATION AT A RATE OF 1/2 LB. PER INCH OF TRUNK CALIPER. MANGANESE SHALL BE APPLIED AT THE SAME RATE.

#### MULCH:

MULCH MATERIAL SHALL BE SHREDDED CYPRESS MULCH OR APPROVED EQUAL, MOISTENED AT THE TIME OF APPLICATION TO PREVENT WIND DISPLACEMENT. MULCH SHALL BE APPLIED TO A MINIMUM 3" DEPTH

#### **/OD:**

THE SOD SHALL BE FREE FROM WEEDS, FUNGUS, INSECTS AND DISEASES OF ANY KIND, CLEAN, STRONGLY ROOTED, UNIFORMLY SIZED STRIPS, MACHINE STRIPPED NOT MORE THAN TWENTY-FOUR (24) HOURS

#### JUB/TITUTION/:

NO SUBSTITUTION OF PLANT MATERIAL TYPES OR SIZES WILL BE ALLOWED WITHOUT WRITTEN AUTHORIZATION FROM THE OWNER. CONTAINER GROWN MATERIAL WILL NOT BE ACCEPTED AS SUBSTITUTE FOR BEB MATERIAL UNLESS PREVIOUSLY APPROVED. INTENDED SUBSTITUTIONS SHALL BE SPELLED OUT IN BID.

#### MEA/UREMENT/:

HEIGHT SHALL BE MEASURED FROM GROUND TO THE AVERAGE BRANCH HEIGHT OF CANOPY. SPREAD SHALL BE MEASURED TO THE END OF THE BRANCHING EQUALLY AROUND THE CROWN FROM THE CENTER OF THE TRUNK. MEASUREMENTS ARE NOT TO INCLUDE ANY TERMINAL GROWTH. SINGLE TRUNK TREES SHALL BE FREE OF "V" CROTCHES THAT COULD BE POINTS OF WEAK LIMB STRUCTURE OR DISEASE INFESTATION.

HEIGHT SHALL BE MEASURED FROM THE GROUND TO THE AVERAGE POINT WHERE

MATURE PLANT GROWTH STOPS. SPREAD SHALL BE MEASURED TO THE END OF BRANCHING EQUALLY AROUND THE SHRUB MASS. MEASUREMENT AREA NOT TO INCLUDE ANY TERMINAL GROWTH.

CLEAR TRUNK (C.T.) - SHALL BE MEASURED FROM THE GROUND AT TIME OF INSTALLATION TO THE POINT WHERE THE MATURE AGED TRUNK JOINS THE IMMATURE OR GREEN PORTION

OVERALL HEIGHT (O.A.) - SHALL BE MEASURED FROM THE GROUND AT THE TIME OF INSTALLATION TO THE AVERAGE FROND HEIGHT.

PALMS WITH MARRED OR BURNED TRUNKS WILL NOT BE ACCEPTED.

#### PLANTING JOIL AND BACKFILL:

PLANTING SOIL FOR USE IN PREPARING BACKFILL FOR PLANT PITS SHALL BE A FERTILE, FRIABLE AND NATURAL TOPSOIL, WITHOUT MIXTURE OF SUBSOIL MATERIALS, AND SHALL BE FREE FROM HEAVY CLAY STONES, LIME, LUMPS, SHELLS, PLANTS, ROOTS OR OTHER FOREIGN MATERIALS, WEEDS, OR NOXIOUS GRASSES (SUCH AS BERMUDA OR NUT GRASS). IT SHALL NOT CONTAIN TOXIC SUBSTANCES WHICH MAY BE HARMFUL TO THE PLANT GROWTH.

BACKFILL FOR SOD AREAS SHALL BE SUBJECT TO LESSER STANDARDS AT THE DISCRETION AND DECISION OF THE OWNER.

EXISTING TOPSOIL SHALL BE USED IN ALL PLANT MATERIAL PITS EXCEPT SABAL PALMS WHERE THE SOIL SHALL CONSIST OF CLEAN SAND.

PLANTING SOIL FOR USE IN BEDS FOR ANNUALS AND/OR PERENNIALS SHALL CONTAIN ONE-THIRD (1/3) POTTING SOIL OR A BLENDED TOPSOIL, TILL INTO TOP 10" - 12" OF SOIL WITH A TIME-RELEASE FERTILIZER.

#### PLANT MATERIALS:

PALMS, TREES, SHRUBS, GROUNDCOVERS AND VINES

PLANT SPECIES AND SIZE SHALL CONFORM TO THOSE INDICATED ON THE DRAWINGS. NOMENCLATURE SHALL CONFORM TO "STANDARDIZED PLANT NAMES", 1942 EDITION. ALL NURSERY STOCK SHALL BE IN ACCORDANCE WITH "GRADES AND STANDARDS FOR NURSERY PLANTS PARTS I & II", LATEST EDITION PUBLISHED BY THE FLORIDA DEPARTMENT OF AGRICULTURE AND CONSUMER SERVICES. UNLESS SPECIFIED OTHERWISE, ALL PLANTS SHALL BE FLORIDA GRADE NUMBER I OR BETTER AS DETERMINED BY THE FLORIDA DIVISION OF PLANT INDUSTRY. SPECIMEN MEANS AN EXCEPTIONALLY HEAVY, SYMMETRICAL TIGHTLY KNIT PLANT, SO TRAINED OR FAVORED IN ITS DEVELOPMENT THAT FIRST APPEARANCE IS UNQUESTIONABLE AND OUTSTANDINGLY SUPERIOR IN FORM, NUMBER OF BRANCHES, COMPACTNESS AND SYMMETRY. ALL PLANTS SHALL BE FRESHLY DUG, SOUND, HEALTHY, VIGOROUS, WELL BRANCHED AND FREE OF DISEASE AND INSECT EGGS AND LARVAE AND SHALL HAVE ADEQUATE ROOT SYSTEMS. TREES FOR PLANTING ROWS SHALL BE UNIFORM IN SIZE AND SHAPE. ALL MATERIALS SHALL BE SUBJECT TO APPROVAL BY THE OWNER. WHERE REQUIREMENTS ARE OMITTED FROM THE PLANT LIST, THE PLANTS FURNISHED SHALL BE NORMAL FOR THE VARIETY AND FLORIDA NUMBER I. PLANTS SHALL BE PRUNED PRIOR TO DELIVERY ONLY UPON THE APPROVAL OF THE OWNER.

### CONTAINER GROWN / TOCK:

ALL CONTAINER GROWN MATERIAL SHALL BE HEALTHY, VIGOROUS, WELL-ROOTED PLANTS AND ESTABLISHED IN THE CONTAINER IN WHICH THEY ARE SOLD. THE PLANTS SHALL HAVE TOPS OF GOOD QUALITY AND BE IN A HEALTHY GROWING CONDITION.

AN ESTABLISHED CONTAINER GROWN PLANT SHALL BE TRANSPLANTED INTO A CONTAINER AND GROWN IN THAT CONTAINER SUFFICIENTLY LONG ENOUGH FOR THE NEW FIBROUS ROOTS TO HAVE DEVELOPED SO THAT THE ROOT MASS WILL RETAIN ITS SHAPE AND HOLD TOGETHER WHEN REMOVED FROM THE

#### WARRANTY:

WARRANTY PLANTS, SHRUBS AND GROUNDCOVERS FOR A PERIOD OF NINETY (90) DAYS; TREES  $\xi$  PALMS FOR ONE YEAR (1) AGAINST UNHEALTHY CONDITION, EXCEPT AS MAY RESULT FROM NEGLECT BY OWNER, DAMAGE BY OTHERS, AND UNUSUAL PHENOMENA BEYOND INSTALLER'S CONTROL. REPLACE AT TIME REQUESTED BY THE OWNER OR LANDSCAPE ARCHITECT.

#### MAINTENANCE:

MAINTAIN LANDSCAPE WORK UNTIL THE LETTER OF SUBSTANTIAL COMPLETION BY THE GENERAL CONTRACTOR. INCLUDE WATERING, WEEDING, CULTIVATING, RESTORATION OF GRADE, MOWING AND TRIMMING GRASS, PRUNING TREES AND SHRUBS, PROTECTION FROM INSECTS AND DISEASES, FERTILIZATION AND SIMILAR OPERATIONS AS NEEDED TO ENSURE NORMAL GOOD HEALTH FOR LIVE PLANT MATERIAL. ARC-23-0034

ZON-24-0020

DE/IG/I ROUP 139 North County Road S#20-B Palm Beach, Fl 3348 Phone 561.832.4600 Mobile 561.313.442 Landscape Architecture Land Planning Landscape Management

Dustin M. Mizell, MLA RLA #6666784

Dustin@environmentdesigngroup.com

• — 0

JOB NUMBER: # 24103.00 LA DRAWN BY: Dustin Mizell

DATE: 05.23.2024

/HEET L8.2

Planting Details & Specifications



Front Elevation



Back / Rear Elevation

**D**E/IG/I GROUP 139 North County Road S#20-B Palm Beach, FI 33480 Phone 561.832.4600 Mobile 561.313.4424 Landscape Architecture Land Planning Landscape Management Dustin M. Mizell, MLA RLA #6666784 Dustin@environmentdesigngroup.com

JOB NUMBER: # 24103.00 LA DRAWN BY: Alex Bugrii

DATE: 05.23.2024

✓ĦEET L9.1

ARC-23-0034 ZOM-24-0020

Rendered Elevations

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West Elevation



East Elevation

ARC-23-0034 ZOM-24-0020 Rendered Elevations

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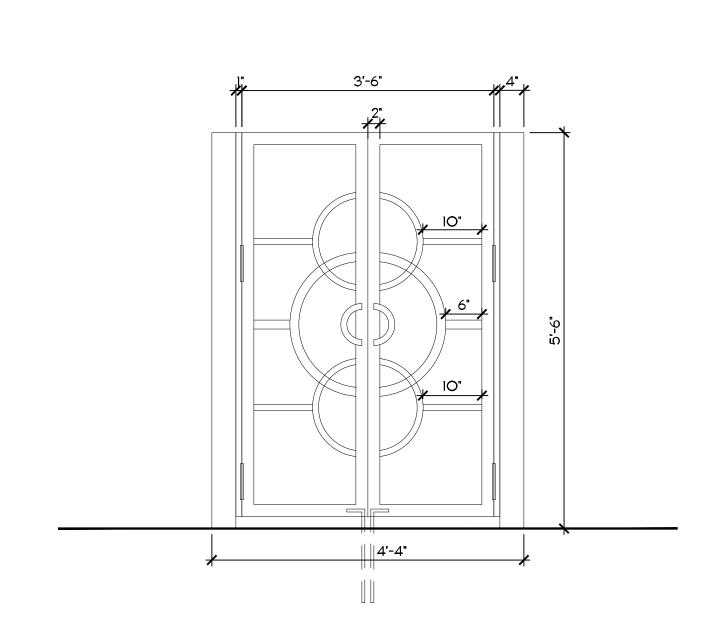
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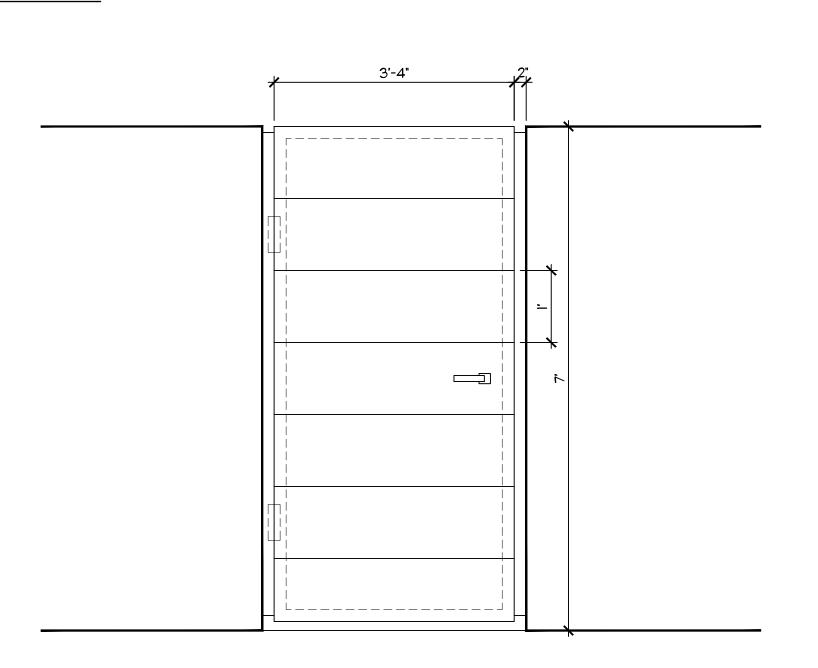
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Courtyard Entry Gate



Courtyard Entry Gate Detail



Courtyard Equipment Enclosure Gate Detail

ARC-23-0034 ZOM-24-0020 Gate Rendering

Landscape Architecture Land Planning Landscape Management Dustin M. Mizell, MLA RLA #6666784 Dustin@environmentdesigngroup.com

JOB NUMBER: # xxxxx.00 LA
DRAWN BY: Allison Padilla DATE: 06.04.2024

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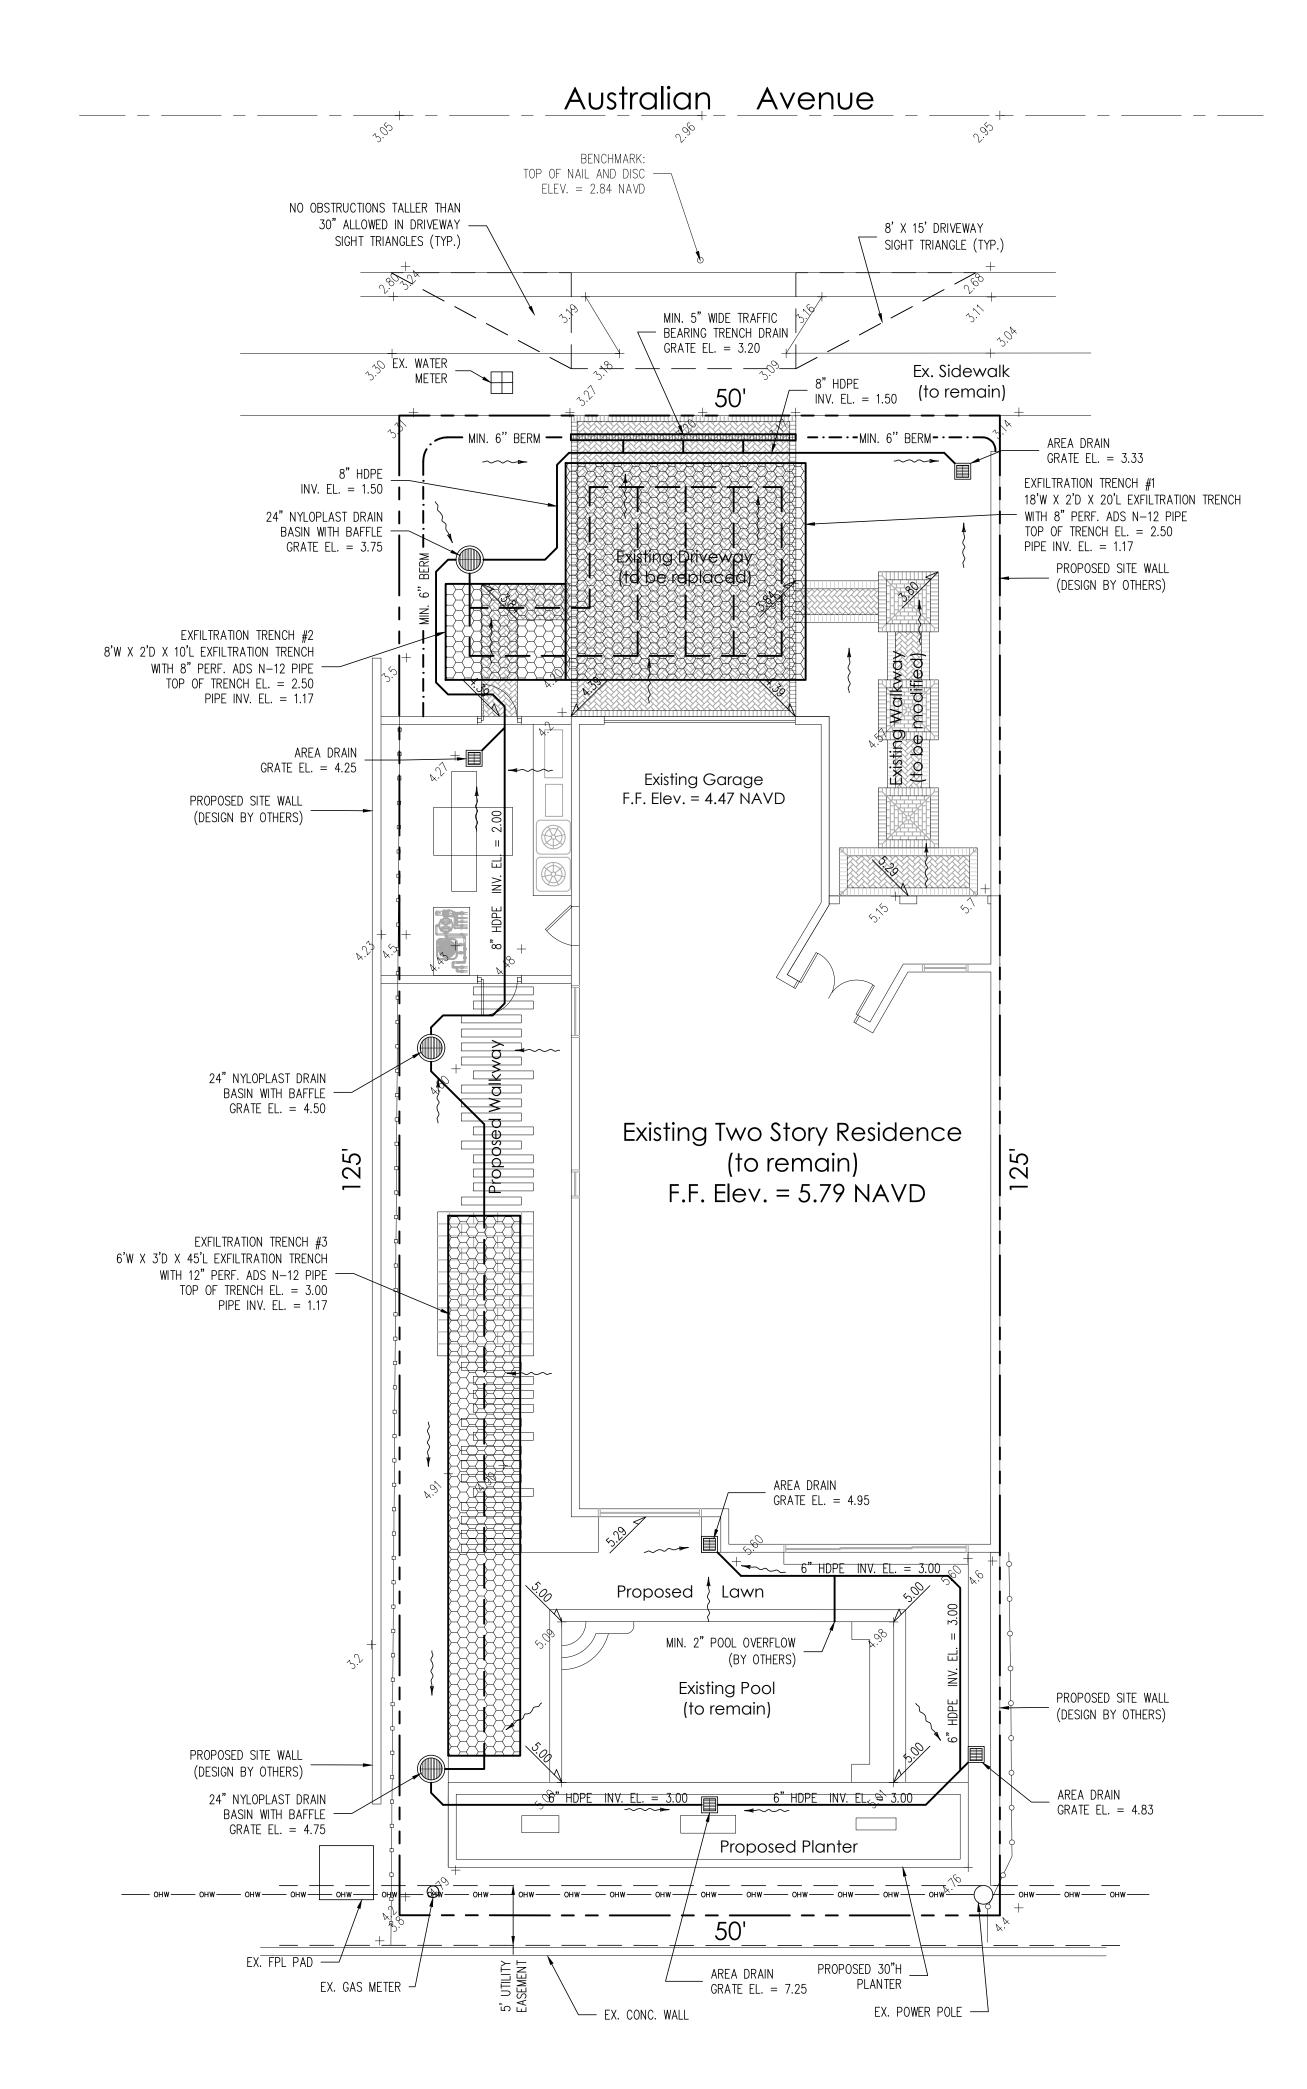
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STORMWATER RETENTION CALCULATIONS

A. <u>SITE INFORMATION</u>

Total Property Area = 6,253 sq.ft.

C = 1.0 (impervious surface) C = 0.2 (pervious surface)

Pervious Runoff Volume:

W = Trench Width

V = Volume Treated

W = Trench Width

V = Volume Treated

W = Trench Width

V = Volume Treated

Notes:

Exfiltration Trench #3

K = Hydraulic Conductivity

H2 = Depth to Water Table

DU = Un-Saturated Trench Depth

DS = Saturated Trench Depth

K = Hydraulic Conductivity

H2 = Depth to Water Table

DU = Un-Saturated Trench Depth

DS = Saturated Trench Depth

Impervious Surface Runoff Volume:

i = 2 in/hr

Drainage Area Impervious Surface = 3,745 sq.ft.

Drainage Area Pervious Surface = 2,508 sq.ft.

B. **ESTIMATED STORMWATER RETENTION VOLUME** 

1.0 x 2 in/hr x 3,745 sq.ft. x 1 ft./12 in. = 624 cu.ft.

 $0.2 \times 2 \text{ in/hr} \times 2,508 \text{ sq.ft.} \times 1 \text{ ft./12 in.} = 84 \text{ cu.ft.}$ 

Total Volume to be Retained = 708 cu.ft.

C. PROPOSED EXFILTRATION TRENCH SIZING

Hydraulic Conductivity

Depth to Water Table

Un-Saturated Trench Depth

Saturated Trench Depth

Total Length of Trench Provided

L = Total Length of Trench Provided = 10 ft

L = Total Length of Trench Provided = 45 ft

Total Volume Retained in Exfiltration Trenches = 740 cu.ft.

from roots with a root barrier.

of drainage system.

installation.

1) Exfiltration trenches and storm piping to be protected

2) Roof drain downspouts are to be connected to the

3) Exfiltration trench design uses an assumed value of

4) Contractor shall mill and overlay all roadway cuts a

5) Contractor is responsible for installing and maintaining

erosion control measures during construction.

7) All existing onsite storm drainage to be removed.

6) Video inspection of storm drainage system required

entire width of each affected lane.

prior to installation of sod.

proposed drainage system. Contractor to provide engineer with downspout locations prior to installation

hydraulic conductivity. Client may obtain a site specific

test for hydraulic conductivity prior to exfiltration trench

minimum of 50 ft. on either side of the excavation the

= 18 ft

= 1.70 ft

= 1.00 ft

= 1.70 ft = 1.00 ft

= 1.00 ft

= 6 ft

= 1.70 ft

= 1.50 ft

= 1.50 ft

= 352 cu.ft.

= 75 cu.ft.

= 313 cu.ft.


= 1.00 ft

= 0.00005 cfs/sq.ft./ft. of head

= 0.00005 cfs/sq.ft./ft. of head

= 0.00005 cfs/sq.ft./ft. of head

The retention volume is estimated using the Rational Method (Q=CiA)

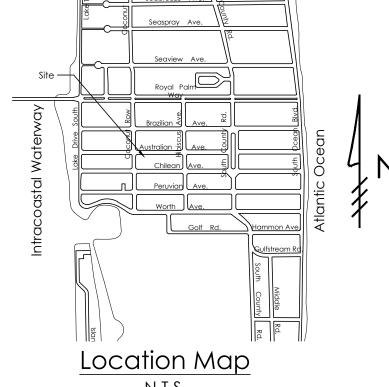

## Legend

EXISTING ELEVATION PER WALLACE SURVEYING CORP. (NAVD-88)

PROPOSED ELEVATION (NAVD-88)


---7.00--- PROPOSED ELEVATION CONTOUR (NAVD-88)

FLOW DIRECTION

EXFILTRATION TRENCH

AREA DRAIN

24" NYLOPLAST DRAIN BASIN WITH BAFFLE

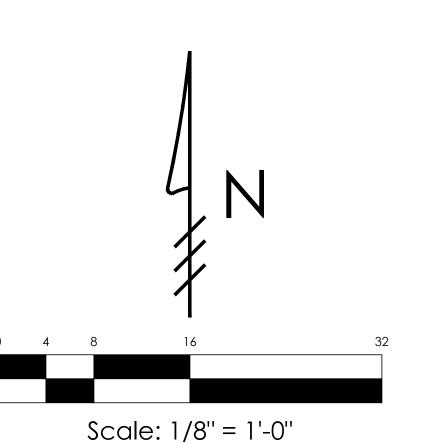

**GRUBER** CONSULTING **ENGINEERS** 

West Palm Beach, FL 33401 **6** 561.312.2041 □ office@gruberengineers.com

2475 Mercer Avenue, Suite 305

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Contractor is responsible for obtaining location of existing utilities prior to commencement

of construction activities.

Plan For: ATION rainage

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PROJECT INFORMATION: Project No. | 2024-0043 Issue Date 05/23/2024 Scale 1/8" = 1'-0"

**REVISIONS:** 

Ω

CHAD M. GRUBER FLORIDA P.E. NO. 57466

This item has been electronically signed and sealed by Chad M. Gruber a SHA authentication code. Printed copies of this document are not considered signed and sealed and the SHA authentication code must be verified on any electronic copies.

SHEET NUMBER:

**C**-1

Plan Background from Hardscape Plan by Environment Design Group Received 5/21/24

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