Zoning Legend

PROPERTY ADDRESS	1464 NORTH OCEAN BLVD
ZONING DISTRICT	R-B MEDIUM DENSITY
LOT AREA (SQ. FT.)	9,768.92.
LOT WIDTH (W) & LOT DEPTH (D) (FT.)	90' (W) X 100' (D)
STRUCTURE TYPE:	SINGLE FAMILY
FEMA FLOOD ZONE DESIGNATION:	N/A
ZERO DATUM FOR POINT OF MEAS. (NAVD)	N/A
CROWN OF ROAD (COR) (NAVD)	N/A

OROVINOI ROAD (COR) (NAVD)	17/		
	REQ'D / PERMITTED	EXISTING	PROPOSED
LOT COVERAGE	N/A	N/A	N/A
ENCLOSED SQUARE FOOTAGE	N/A	N/A	N/A
FRONT YARD SETBACK (FT.)	N/A	N/A	N/A
SIDE YARD SETBACK (IST STORY) (FT.	N/A	N/A	N/A
SIDE YARD SETBACK (2ND STORY) (FT.)	N/A	N/A	N/A
REAR YARD SETBACK (FT.)	N/A	N/A	N/A
ANGLE OF VISION (DEG.)	N/A	N/A	N/A
BUILDING HEIGHT (FT.)	N/A	N/A	N/A
OVERALL BUILDING HEIGHT (FT.)	N/A	N/A	N/A
CUBIC CONTENT RATIO (CCR) (R-B ONLY)	N/A	N/A	N/A
MAX. FILL ADDED TO SITE (FT.)	N/A	N/A	N/A
FINISHED FLOOR ELEVATION (FFE) (NAVD)	N/A	N/A	N/A
BASE FLOOD ELEVATION (FFE) (NAVD)	N/A	N/A	N/A

Landscape Legend

	REQ'D / PERMITTED	APPROVED	PROPOSED
LANDSCAPE OPEN SPACE (LOS) (SQ. FT. AND %)	45% MINIMUM 4,396 S.F.	46.77% 4,569 S.F.	40.69% 3,975 S.F.
LOS TO BE ALTERED (SQ. FT. AND %)	N/A	N/A	14.65% 644 S.F.
PERIMETER LOS (SQ. FT. AND %)	50% MIN. 2,198 S.F.	66.26% 2,913 S.F	57.2% 2,518 S.F.
FRONT YARD LOS (SQ. FT. AND %)	40% MIN. 900 S.F.	51.3% 1,403 S.F.	51.3% 1,403 S.F.
NATIVE TREES %	N/A	N/A	
NATIVE SHRUBS & VINES %	30%	N/A	100%
NATIVE GROUNDCOVER %	30%	N/A	55.55%



Private Residence
1464 A Ocean Blvd
Town of Palm Beach
ARC-24-033
ZON-24-039


Second Submittal: 02/26/2024 ARCOM Meeting Date: 05/29/2024

Scope of Work

Additional Deck Pavers, Artificial turf and planting areas.

Variance Request

40.69% landscape open space in lieu of 45% required.

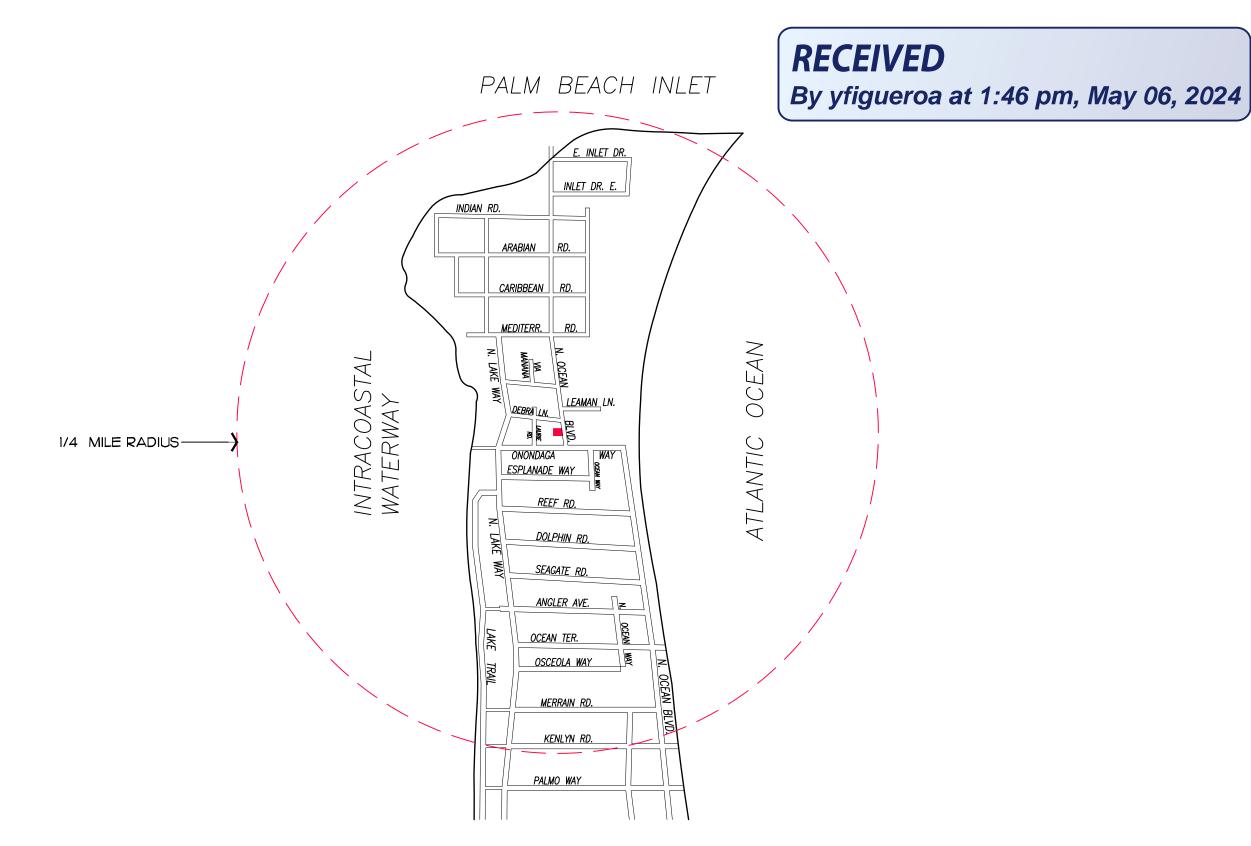

Vicinity/Location Map

Sheet Index


Coversheet

- L1.0 *S*ite Plan
- L1.2 Hardscape Materials
- L1.3 Existing Conditions Images
- L1.4 Landscape Open Space Calculations
- L1.5 Perimeter Open Space Diagram
- L1.6 Modified∫ite Wall
- L2.0 Variance Request Diagram
- L2.1 Variance Request Hardship
- L3.0 Landscape Plan & Schedule


Survey

Civil Engineering Plan

Previously Approved Landscape Plans

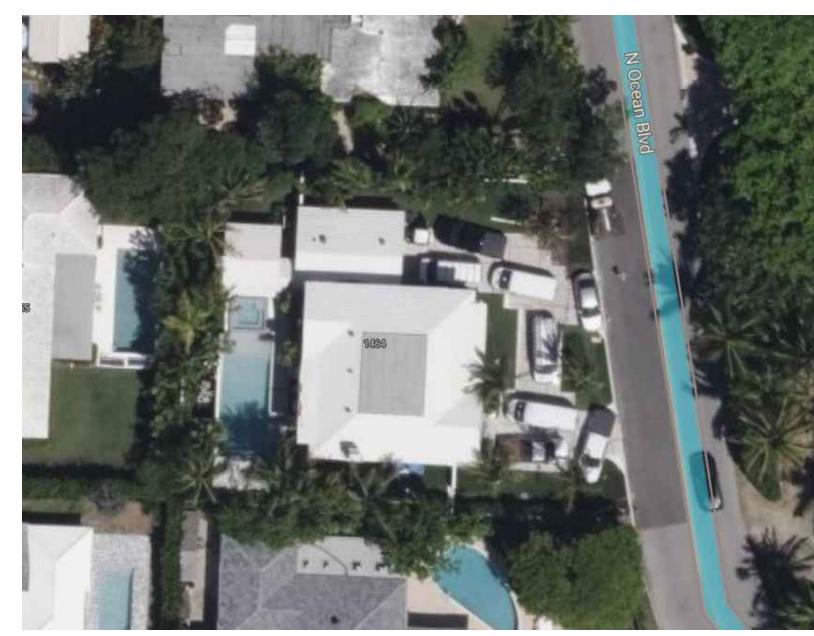

Aerial View

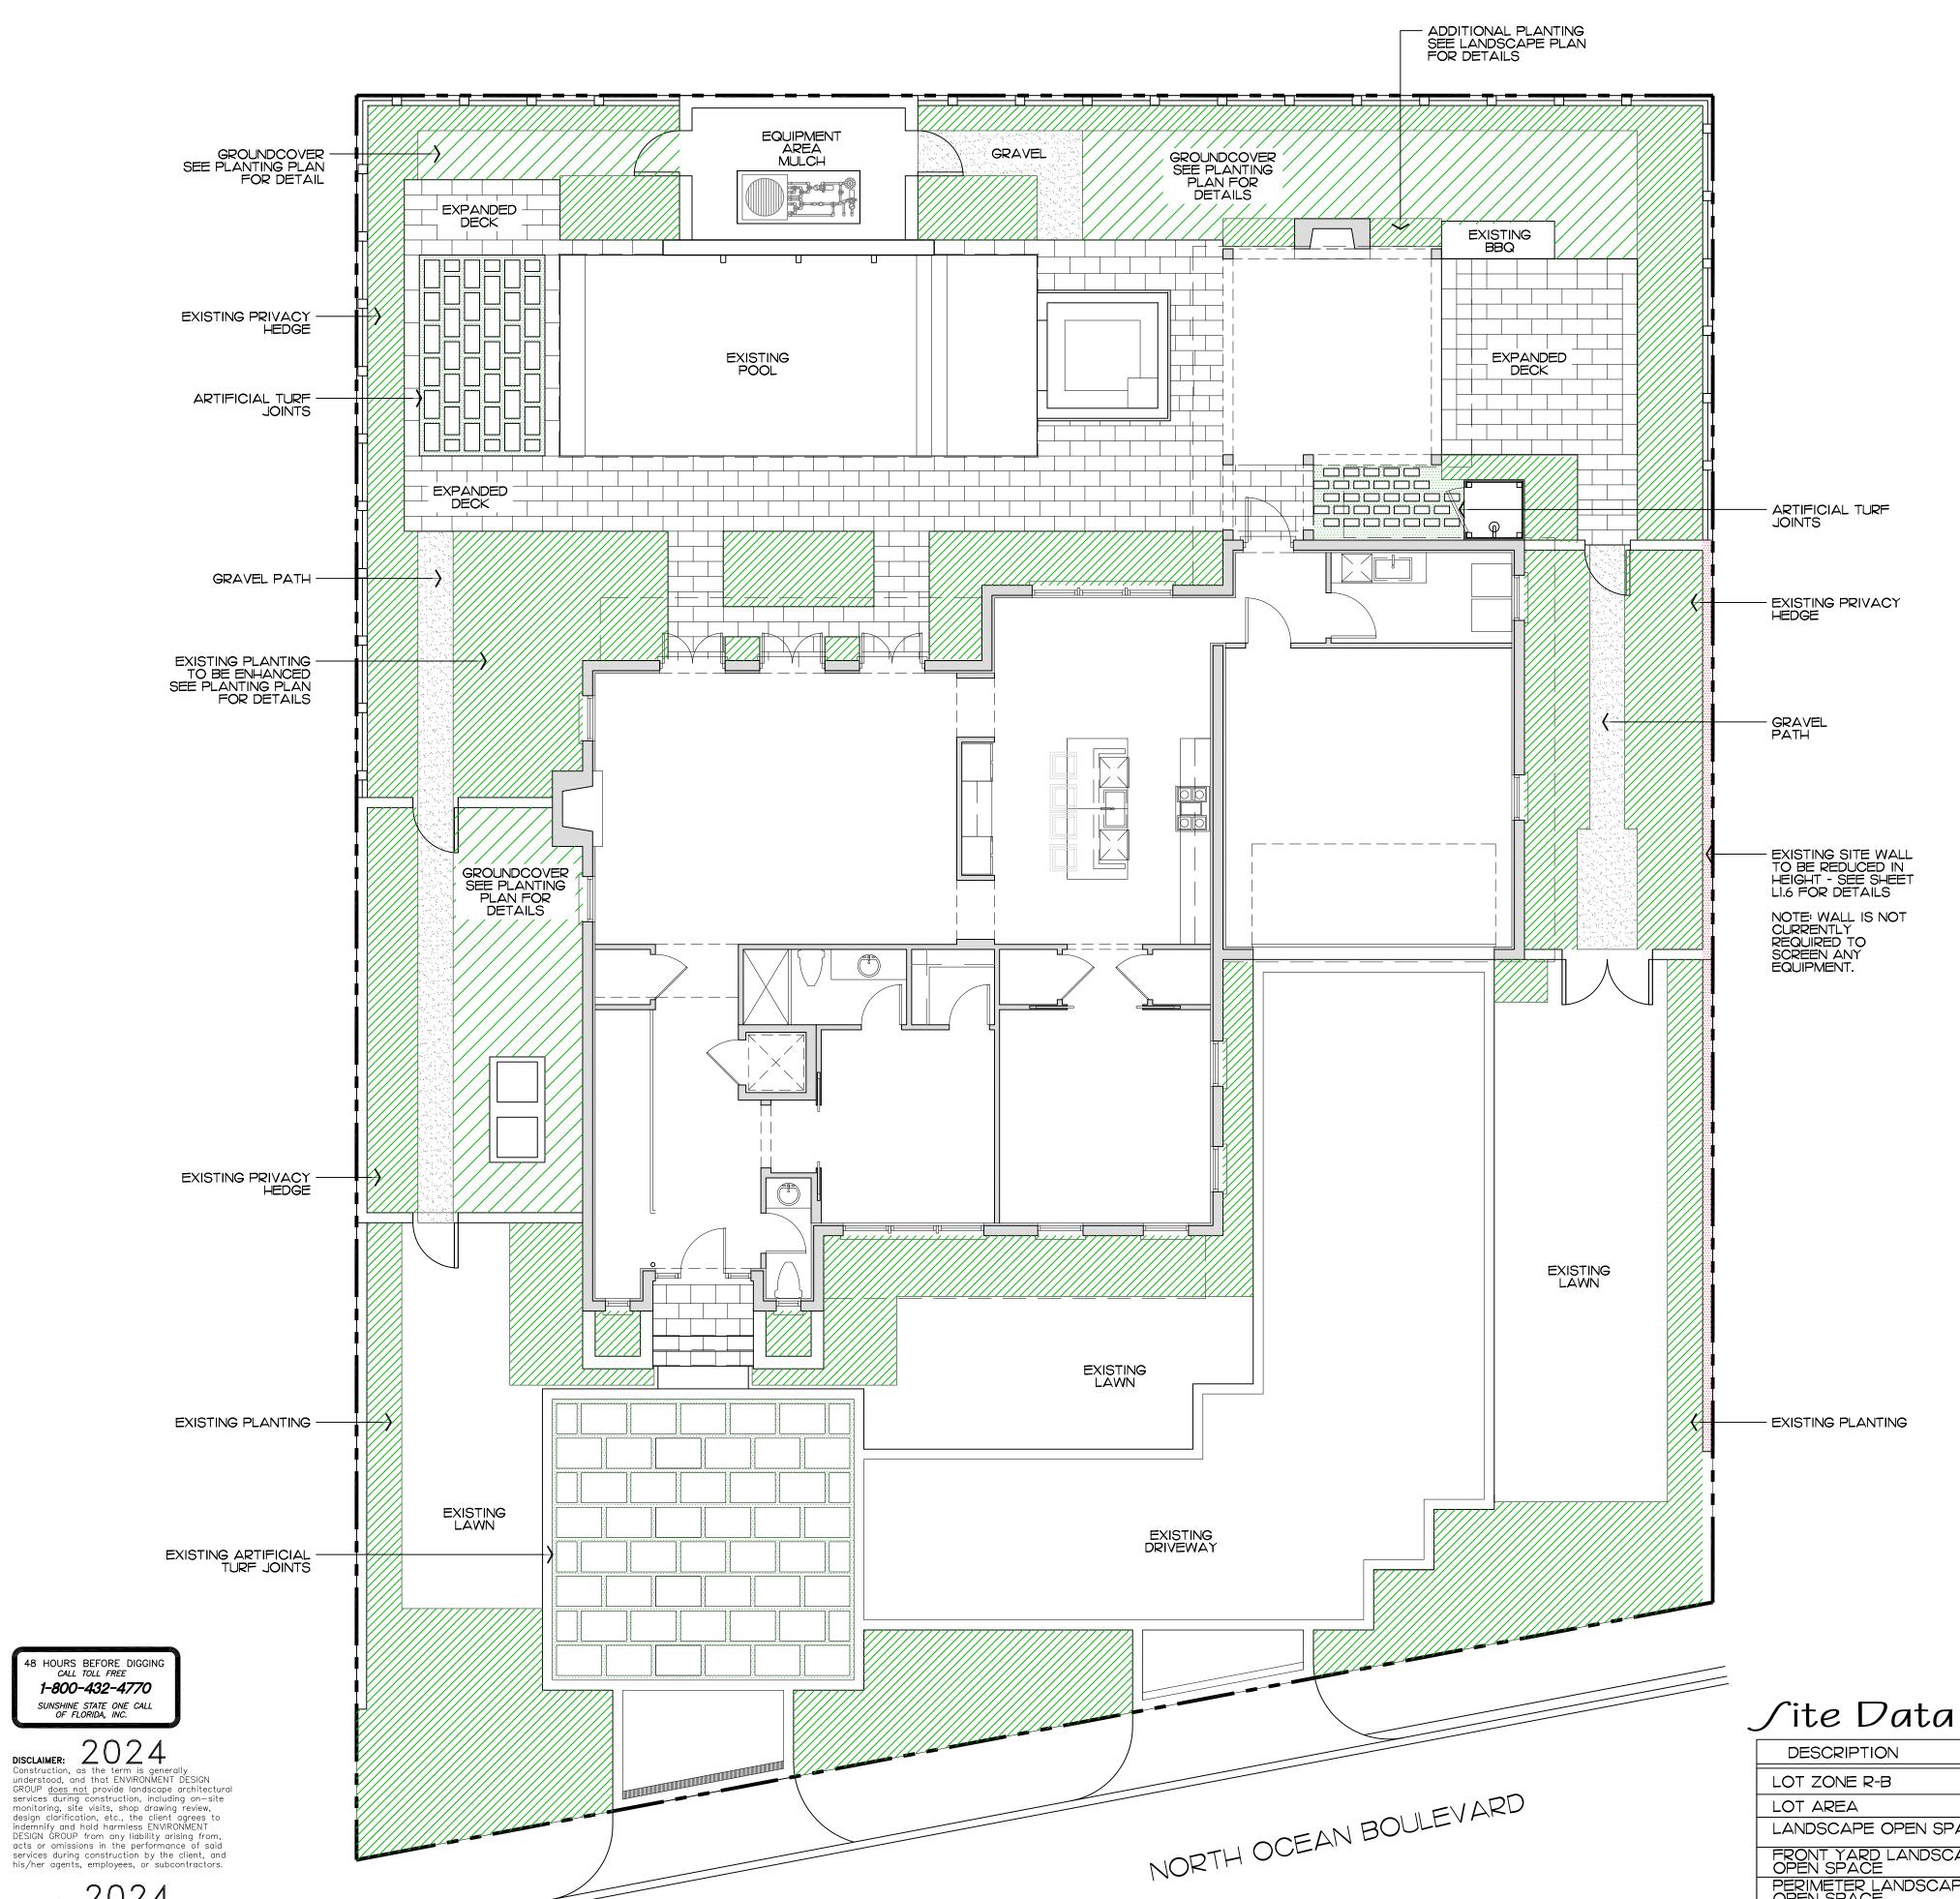


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Variance Request

* 40.69% Landscape Open Space in lieu of 45% required

(4.31% variance)



JOB NUMBER: # 202068.00 LA DRAWN BY: Sean Twomey DATE: 02.26.2024

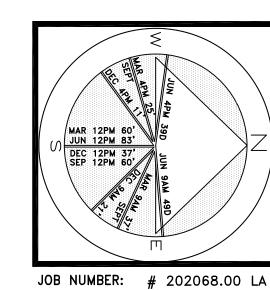
JHEET L1.0

DESCRIPTION	REQUIRED	PREVIOUSLY APPROVED	EXISTING	CURRENTLY PROPOSED
LOT ZONE R-B		R-B	R-B	R-B
LOT AREA	10,000 S.F. MINIMUM	9,768.92 SF	9,768.92 SF	9,768.92 SF
LANDSCAPE OPEN SPACE	MINIMUM 45% 4,396 S.F.	46.1% 4,506 S.F.	30.0% 2,931 S.F.	40.69% 3,975 S.F.
FRONT YARD LANDSCAPE OPEN SPACE	MINIMUM 40% 1,099.2 S.F.	49.I I,349 S.F.	49.1 1,349 S.F.	49.I I,349 S.F.
PERIMETER LANDSCAPE OPEN SPACE	MINIMUM 50% 2,198 S.F.	66.4% 2,919 S.F.	36.9% I,664 S.F.	57.2% 2,518 S.F.

NOTE: ARTIFICIAL TURF HAS ALREADY BEEN INSTALLED.


* SEE SHEET LI.2 FOR REQUESTED VARIANCE DIAGRAM



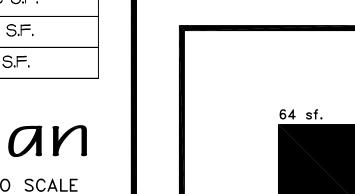



✓HEET L1.1

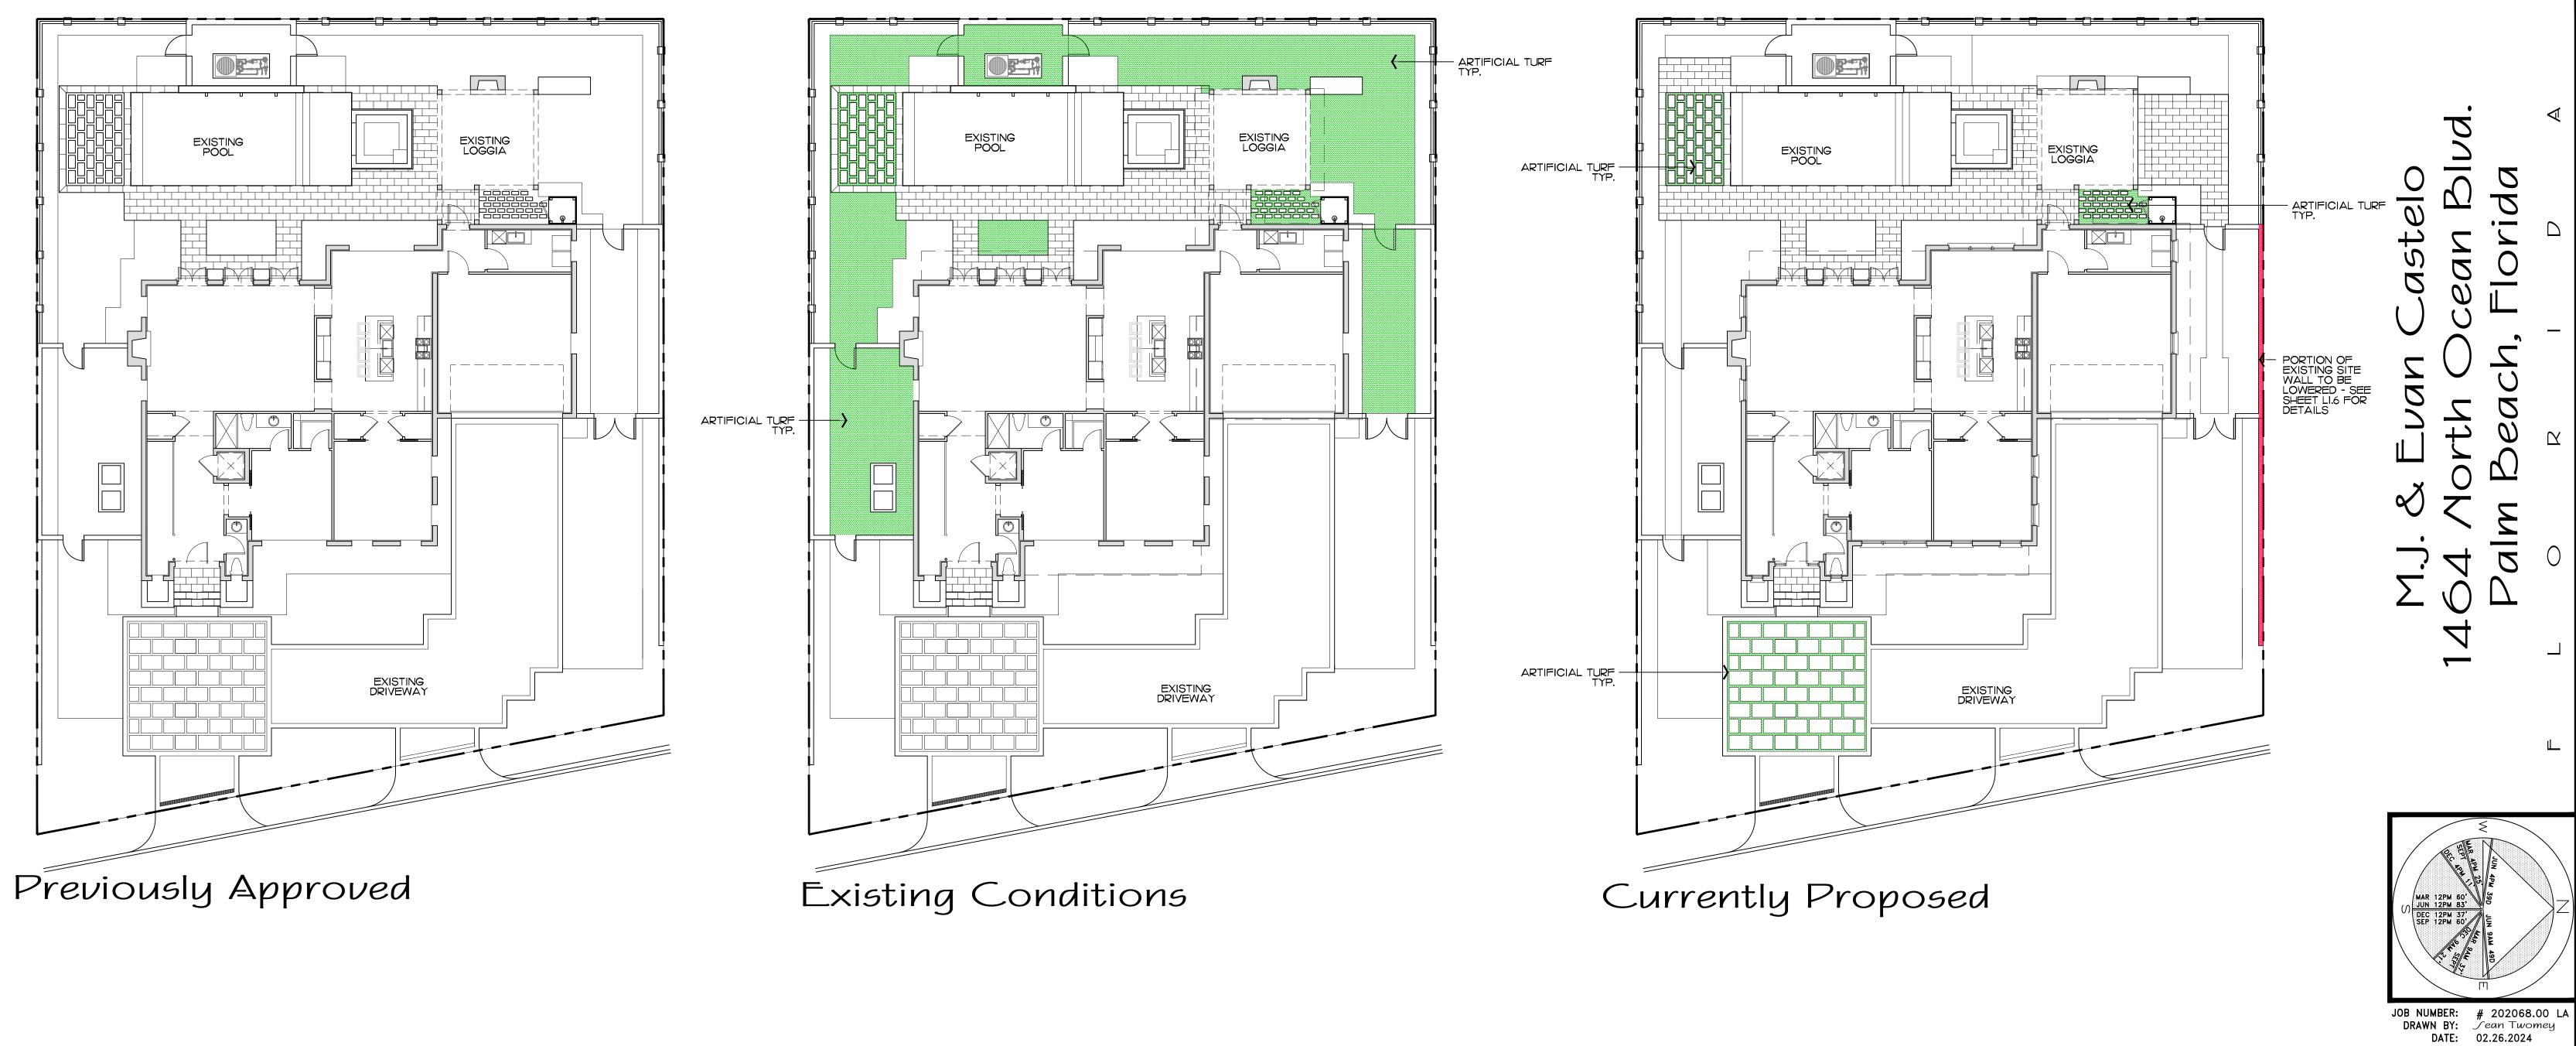

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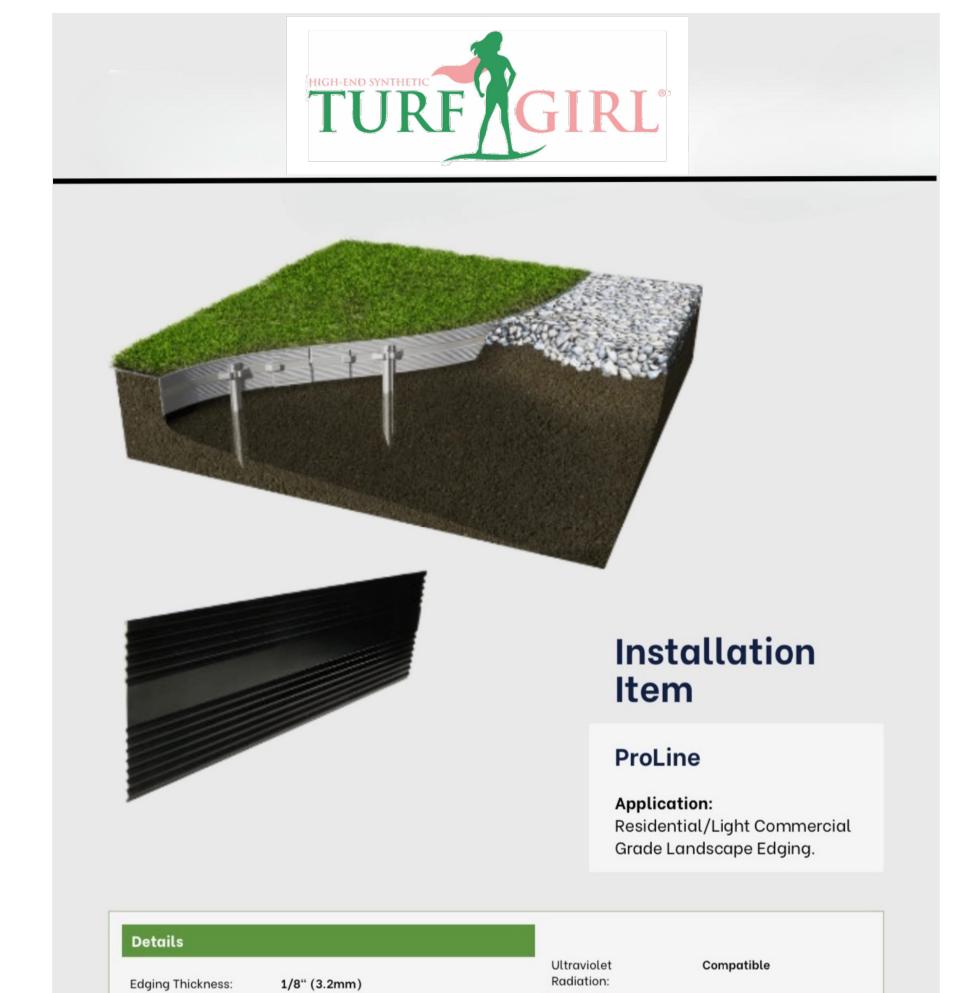
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✓HEET L1.2



4" (102mm)

16' (4.8m)

Black DuraFlex

12" (305mm) (STANDARD)

at extreme low temperature)

+Positive (Extruded Aluminum is great

Edging Height:

Edging Length:

Edging Finish:

Stake Length:

Extreme Low

Temperature:

Combustibility:

-Negative (Extruded

therefore is safe)

Aluminum will not burn,

Very Lightweight, High

Strength (higher at lower


temperature), Corrosion

Resistance, Ease of

Fabrication.



18" X 18" CORAL STONE STEPPING STONES W/ LIVING GROUNDCOVER JOINTS

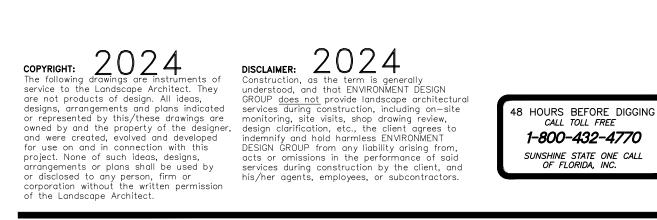

Pile height:

Face weight:

Total weight:

Blade shape:

9,800

TURFUSA

Synthetic Turfs | Lush Sport

15 Years
Turf USA Warranty

Uses & Traffic:

Field green/Spring green Roll size:

Guage:

Backing:

Coating: **PU**

Stitch Rate/4": ~**14.5**

Sporting & commercial Landscape, playgrounds, medium-heavy traffic

Turf USA

warrantee:

15 x 100 ft

15 years

+28 inches per hour

www.turfusa.com


www.turfusa.com









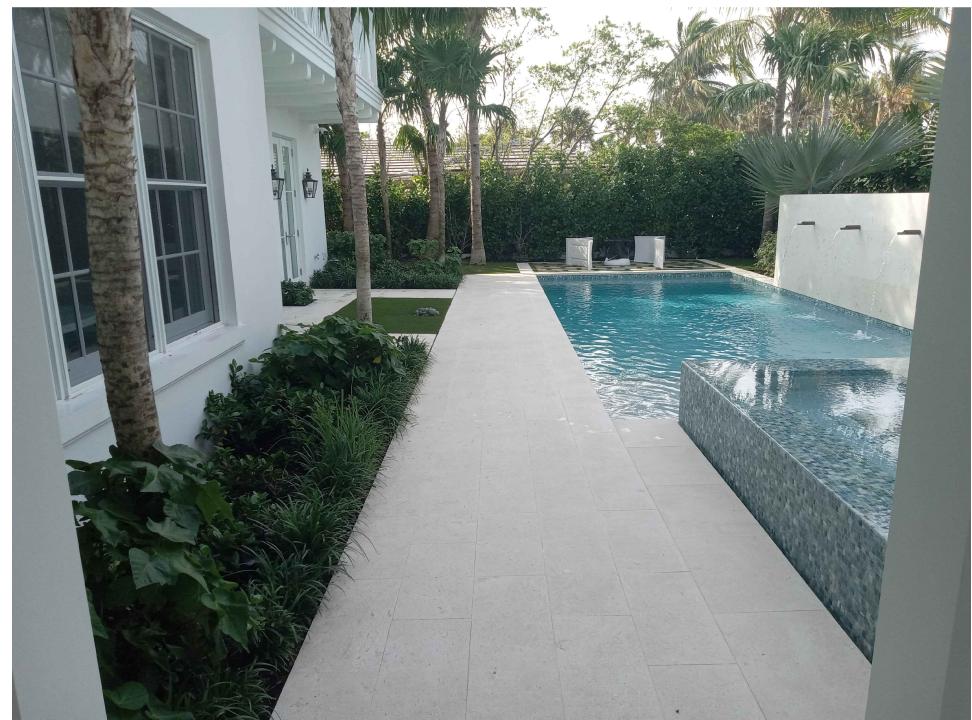



E AVIROAMENT

GROUP

139 North County Road S#20-B Palm Beach, FI 33480 Phone 561.832.4600 Mobile 561.313.4424

Landscape Architecture Land Planning Landscape Management

Dustin M. Mizell, MLA RLA #6666784 Dustin@environmentdesigngroup.com

NOTE: ARTIFICIAL TURF HAS ALREADY BEEN INSTALLED, THERE ARE NO MODIFICATIONS PROPOSED TO THE PREVIOUSLY APPROVED LANDSCAPE.

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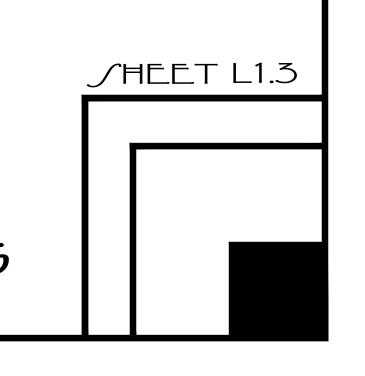
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1-800-432-4770

Existing Conditions - Images



Variance Request

* 40.69% Landscape Open Space in lieu of 45% required

(4.31% variance)

∫ite Data

DESCRIPTION	REQUIRED	PREVIOUSLY APPROVED	EXISTING	CURRENTLY PROPOSED
LOT ZONE R-B		R-B	R-B	R-B
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PERIMETER LANDSCAPE OPEN SPACE	MINIMUM 50% 2,198 S.F.	66.4% 2,919 S.F.	36.9% 1,664 S.F.	57.2% 2,518 S.F.

^{*} SEE SHEET LI.2 FOR REQUESTED VARIANCE DIAGRAM

Legend


IMPERVIOUS AREA (HOUSE/STRUCTURE)

IMPERVIOUS AREA (HARDSCAPE)


PERVIOUS AREA / OPEN SPACE






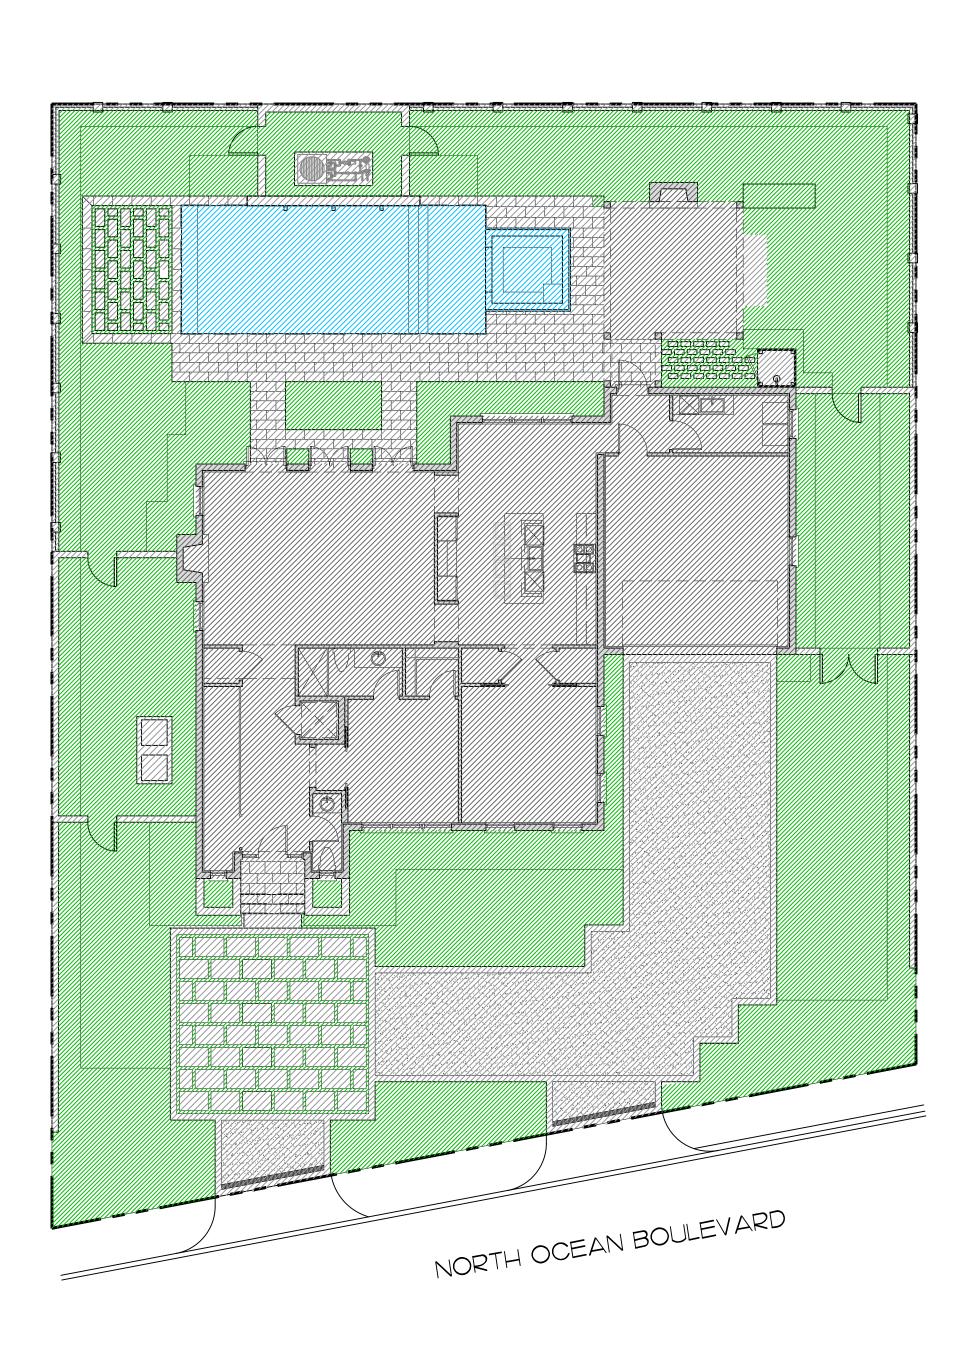


Previously Approved

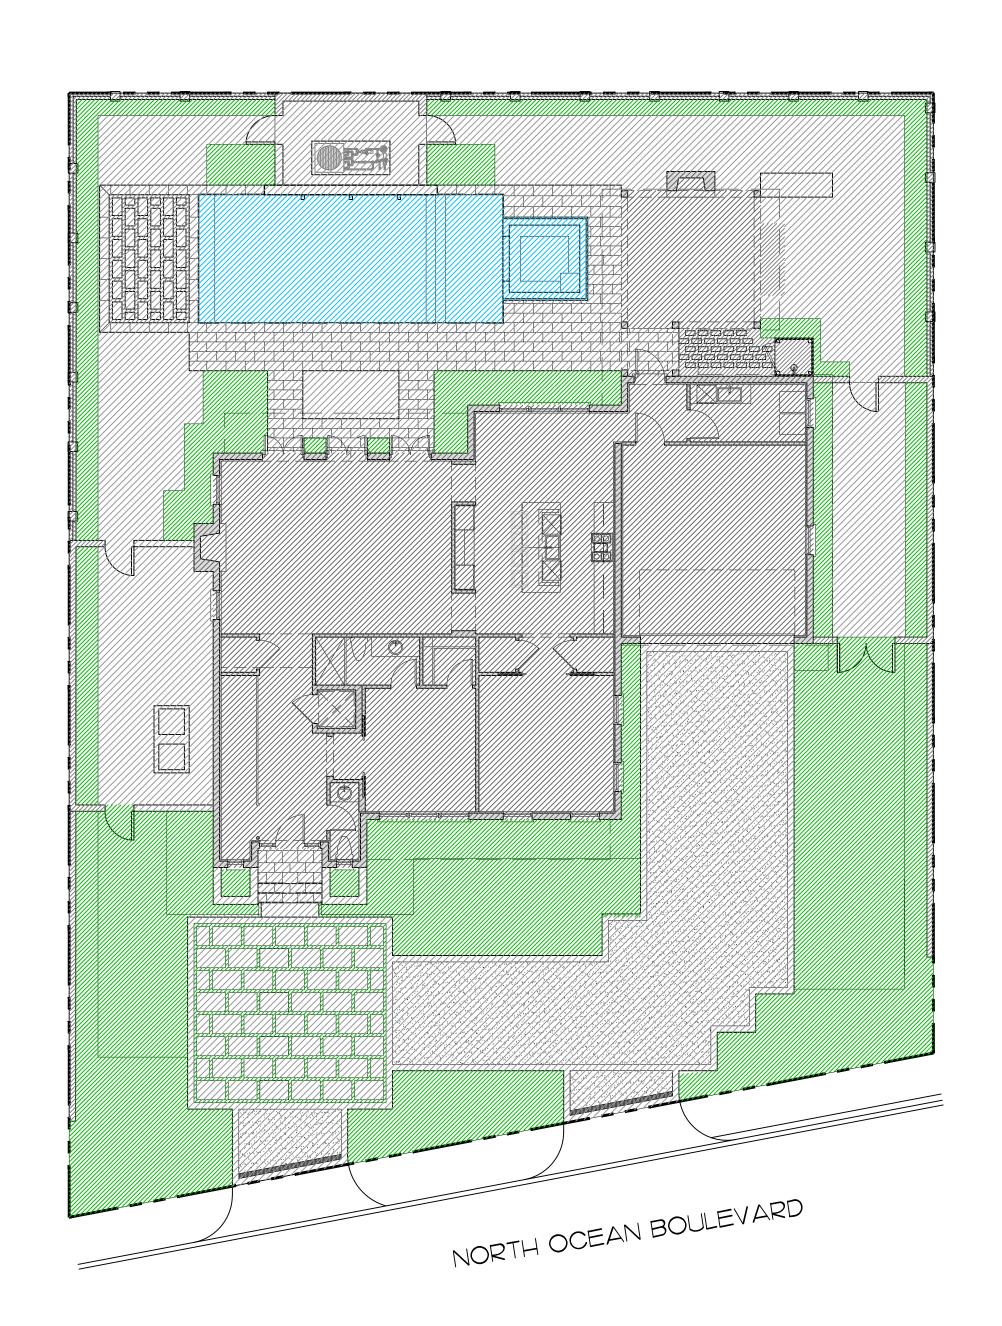

Existing Conditions

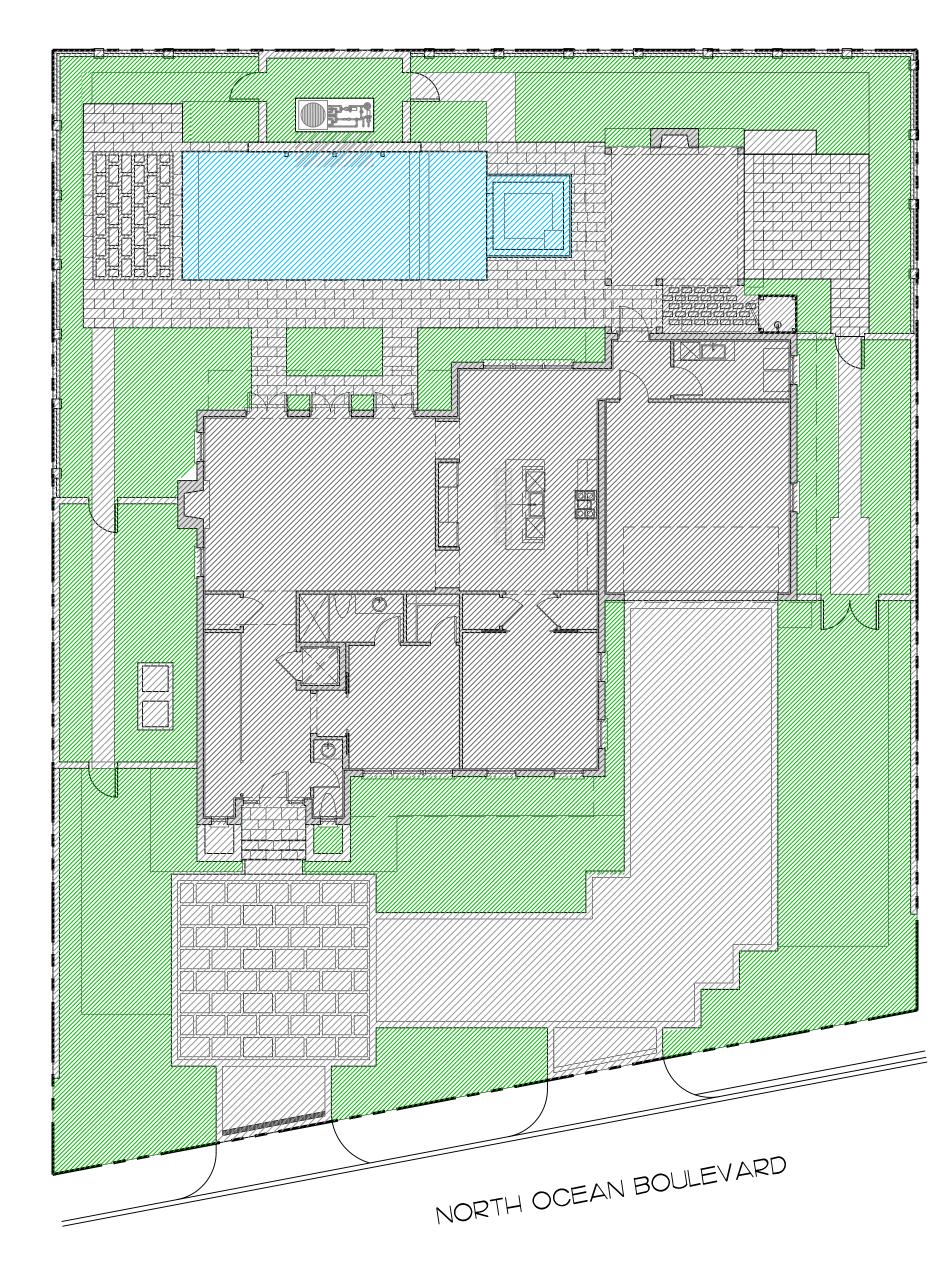

Currently Proposed

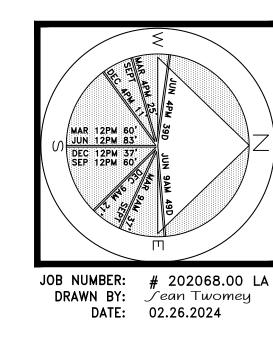

copyright:

2024


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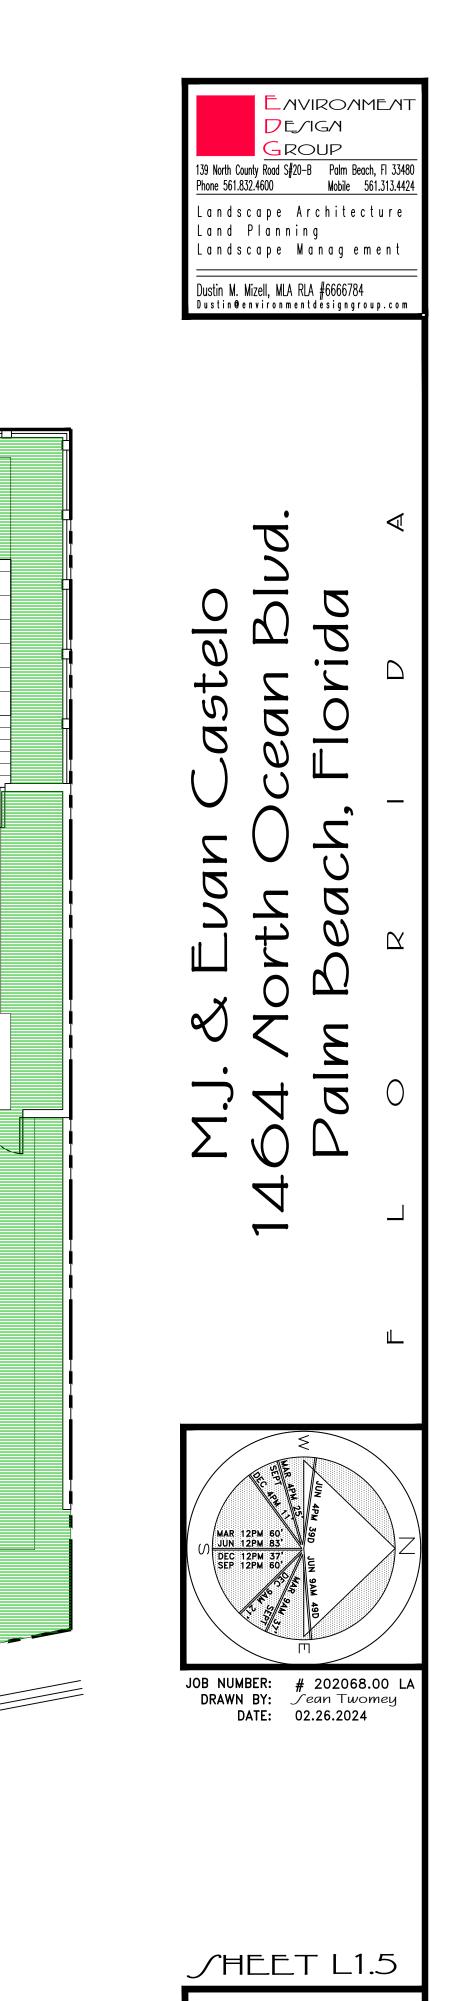
DISCLAIMER:


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Landscape Open Space Calculations





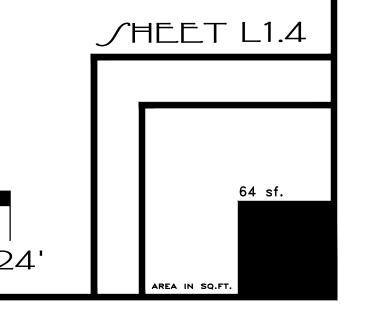

Existing Conditions
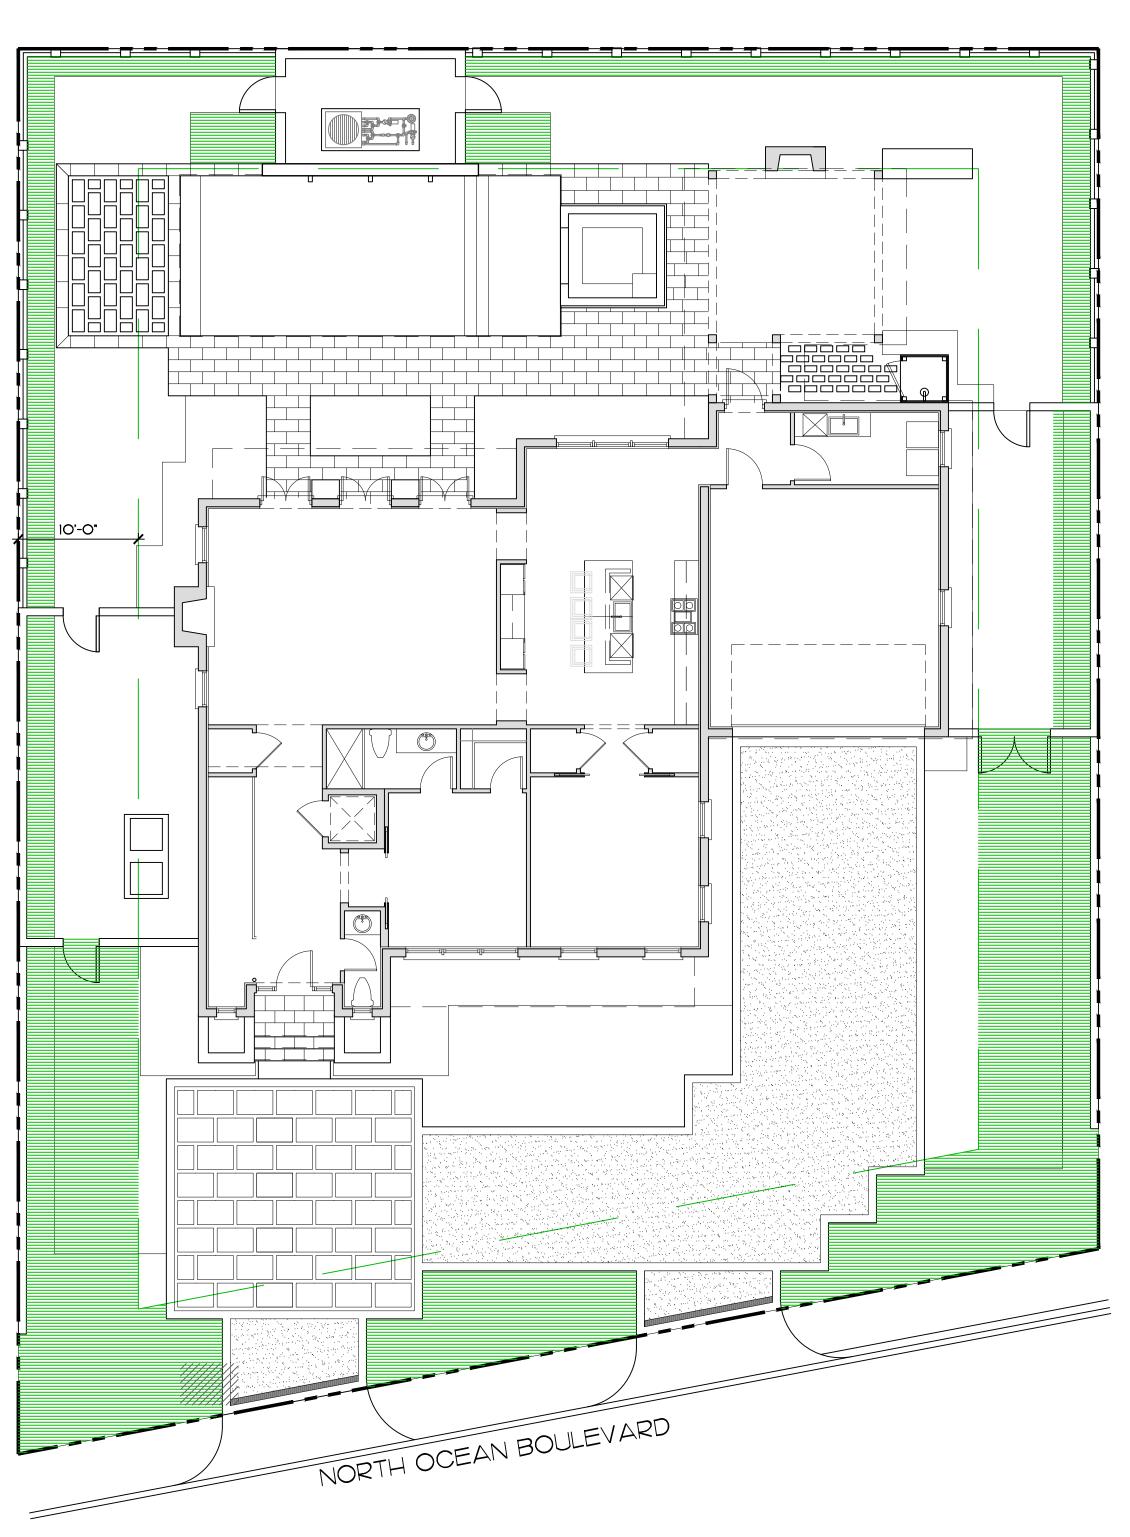
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48 HOURS BEFORE DIGGING

CALL TOLL FREE


1-800-432-4770

PERIMETER PERVIOUS AREA / OPEN SPACE

Currently Proposed

Perimeter Open Space Diagram Scale in FEET O'

NOTE: ARTIFICIAL TURF HAS ALREADY BEEN INSTALLED.

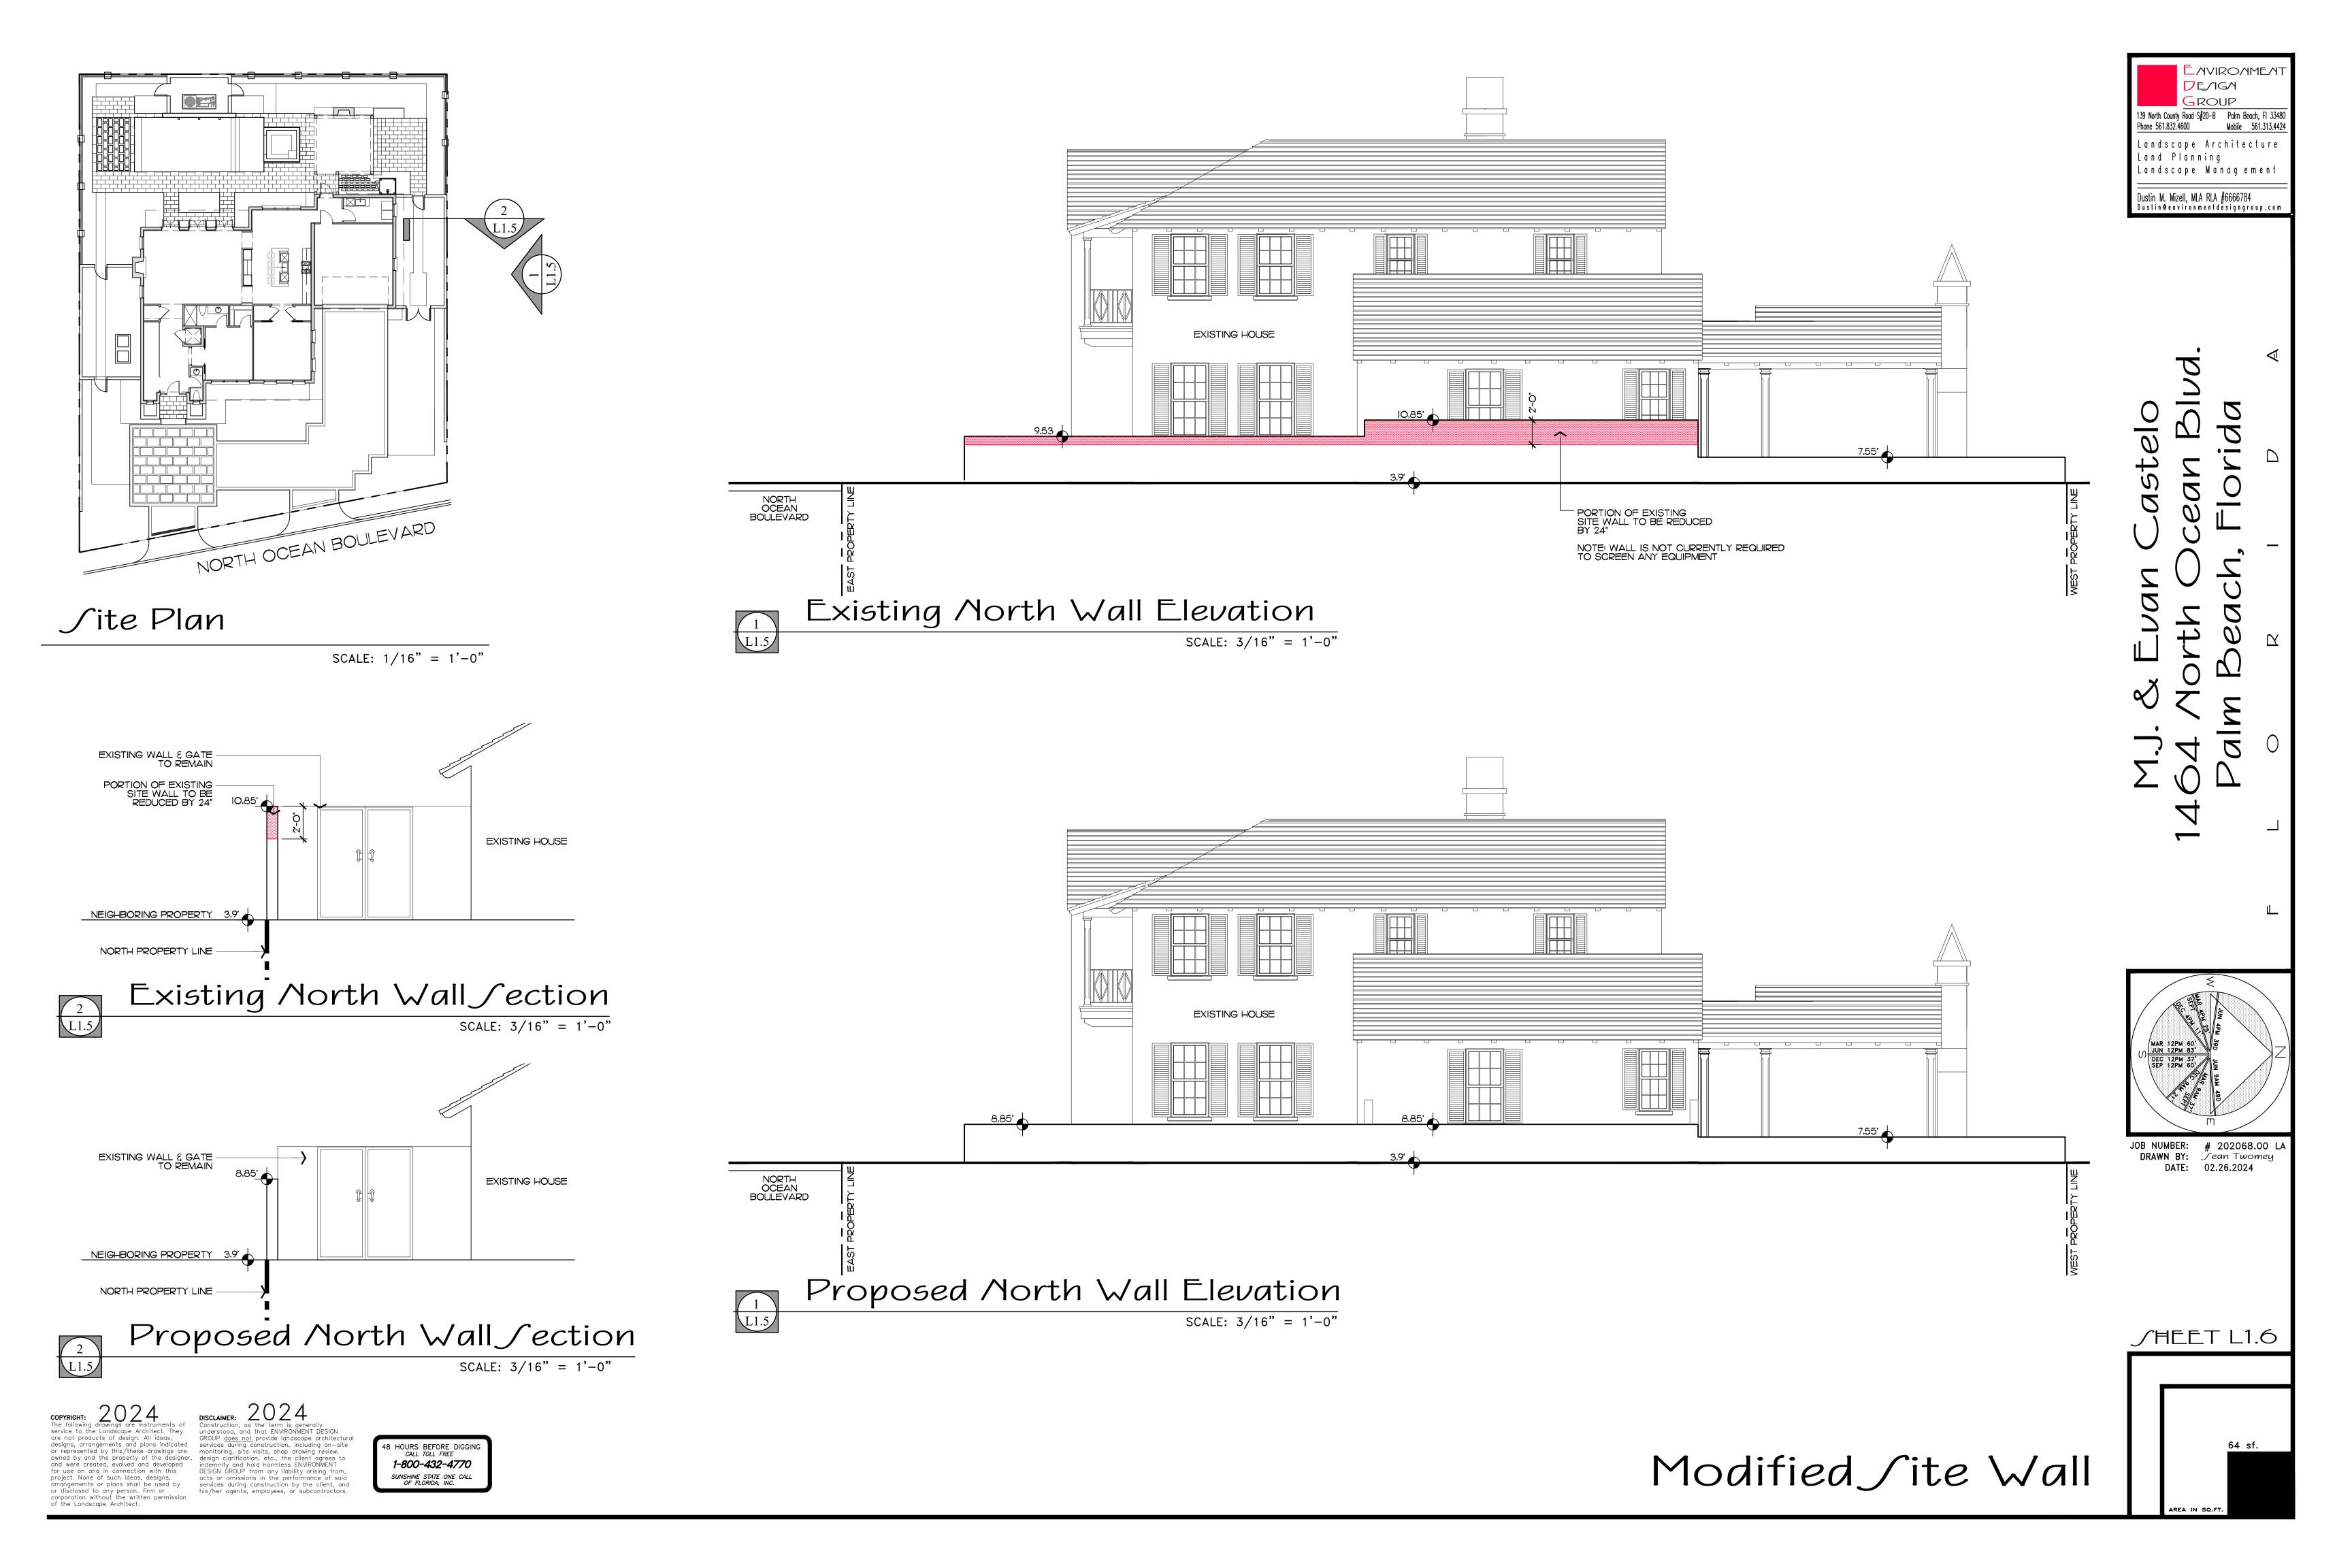



_ AVIROAMEAT


DE/IGM GROUP 139 North County Road S#20-B Palm Beach, Fl 33480 Phone 561.832.4600 Mobile 561.313.4424

Landscape Architecture

Landscape Management

Dustin M. Mizell, MLA RLA #6666784 Dustin@environmentdesigngroup.com

Land Planning

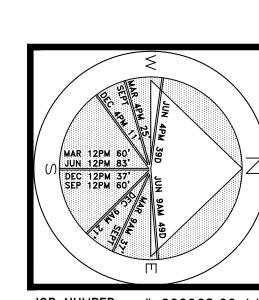

✓HEET L2.0

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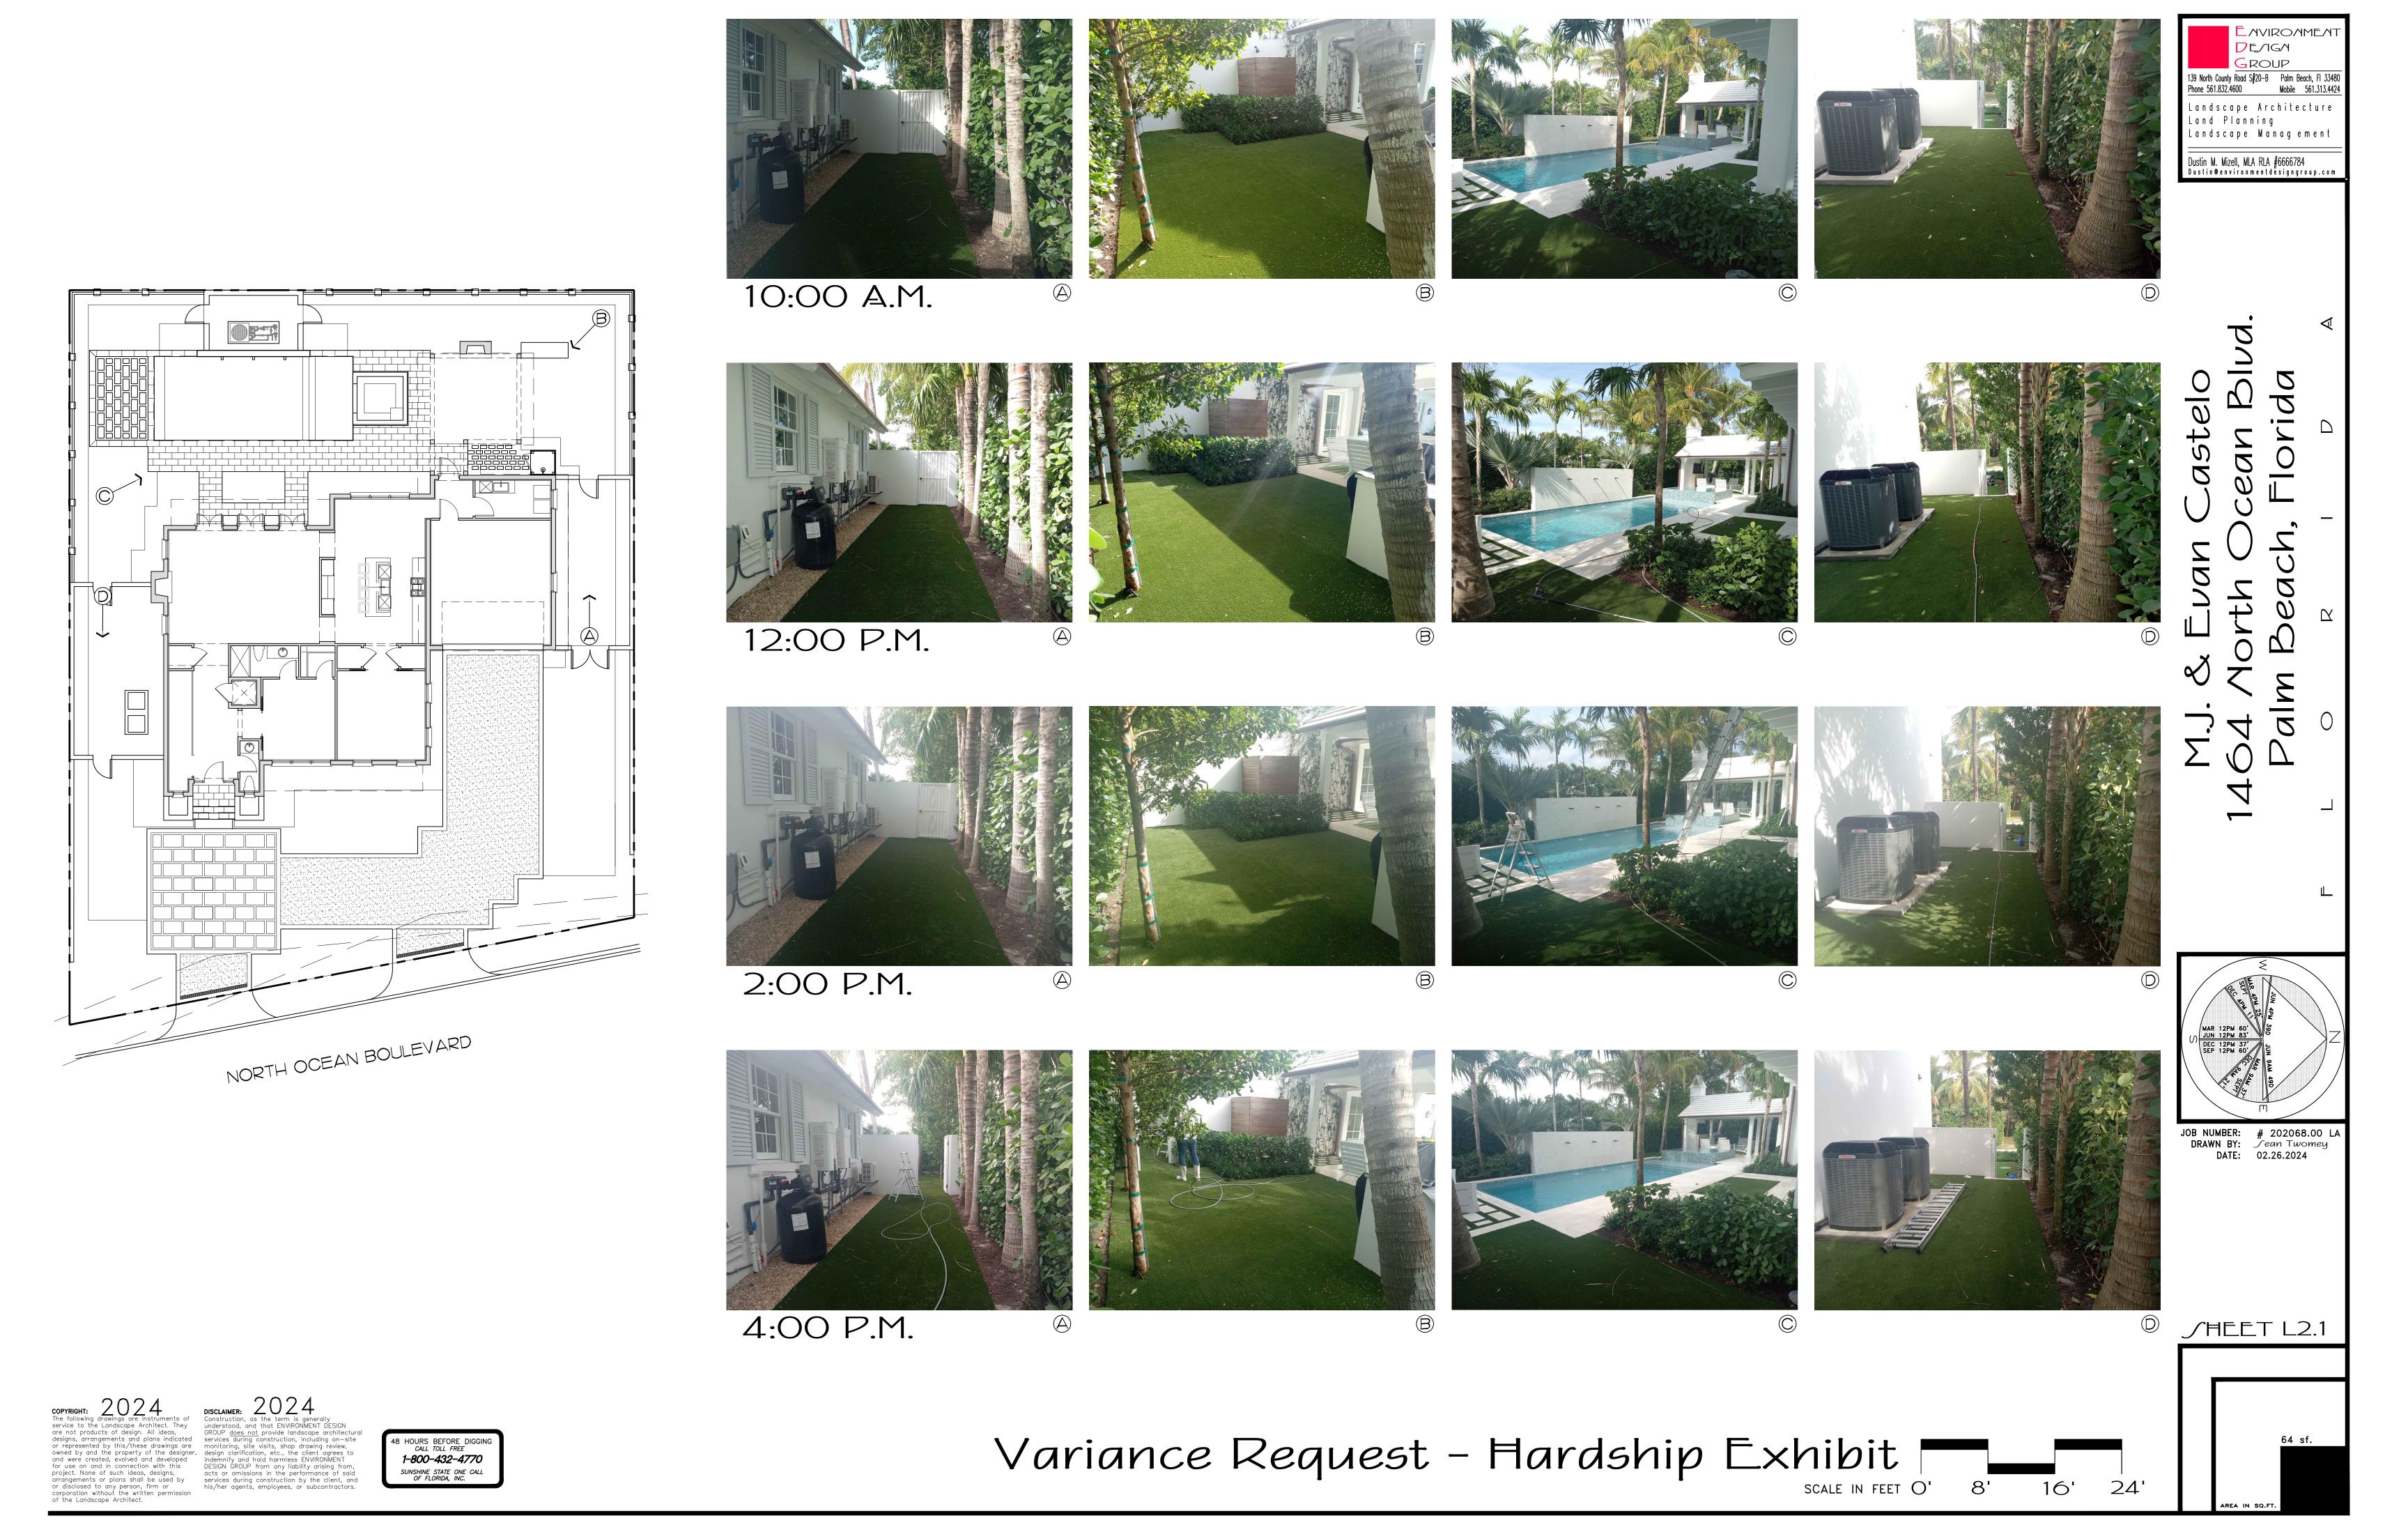
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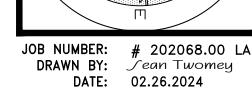
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Variance Request - Diagram Scale IN FEET O'







JHEET L3.0

Shrubs & Vines

SYMBOL	PLANT NAME		QTY.	DESCRIPTION	NATIVE
	NEPHROLEPIS BISERATTA MACHO FERN		16	3 GA., 24" O.C.	YES
		TOTAL: NATIVE SPECIES:	16 16 (100%)		

Groundcovers

- (IO) NEPHROLEPIS BISERRATA MACHO FERN - 3 GAL., 24" O.C.

— (6) NEPHROLEPIS BISERRATA MACHO FERN - 3 GAL., 24" O.C.

-(80) PHYLA NODIFLORA FROG FRUIT - I GAL., 12" O.C.

-(40) PHYLA NODIFLORA FROG FRUIT - I GAL., 12" O.C.

EXISTING PLANTING

- (200) TRACHELOSPERMUM ASIATICUM JASMINE MINIMA GROUNDCOVER I GAL., 12" O.C.

EXISTING PLANTING

EXISTING LOGGIA

GRAVEL

EXISTING PLANTING

EXISTING PLANTING

EXISTING PLANTING

EXISTING LAWN

EXISTING DRIVEWAY

NORTH OCEAN BOULEVARD

EXISTING POOL

ST. AUGUSTINE LAWN

SYMBOL	PLANT N	JAME	QTY.	DESCRIPTION	NATIVE
	PHYLA NC FROG FI		310	1 GAL., 12" O.C.	YES
	TRACHEL(JASMINE	DSPERMUM ASIATICUM E MINIMA	248	1 GAL., 12" O.C.	NO
		TOTAL: NATIVE SPECIES:	558 310 (55.55%)		

NOTE: LANDSCAPING IS ONLY PROPOSED IN AREAS THAT EXISTING ARTIFICIAL TURF WILL BE REMOVED. NO EXISTING LANDSCAPING WILL BE REMOVED OR AFFECTED BY PROPOSED IMPROVEMENTS. ONLY SMALL SHRUBS ARE BEING PROPOSED, NO DELIVERY TRUCKS WILL BE NECESSARY

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EXISTING LAWN

EXISTING PLANTING

Landscape Plan & Schedule

SCALE IN FEET O'

(48) TRACHELOSPERMUM ASIATICUM — JASMINE MINIMA GROUNDCOVER I GAL., 12" O.C.


(18) PHYLA NODIFLORA — FROG FRUIT - I GAL., 12" O.C.


(36) PHYLA NODIFLORA – FROG FRUIT - I GAL., 12" O.C.

(26) PHYLA NODIFLORA — FROG FRUIT - I GAL., 12" O.C.

(IIO) PHYLA NODIFLORA — FROG FRUIT - I GAL., I2" O.C.

(IO) NEPHROLEPIS BISERRATA — MACHO FERN - 3 GAL., 24" O.C.

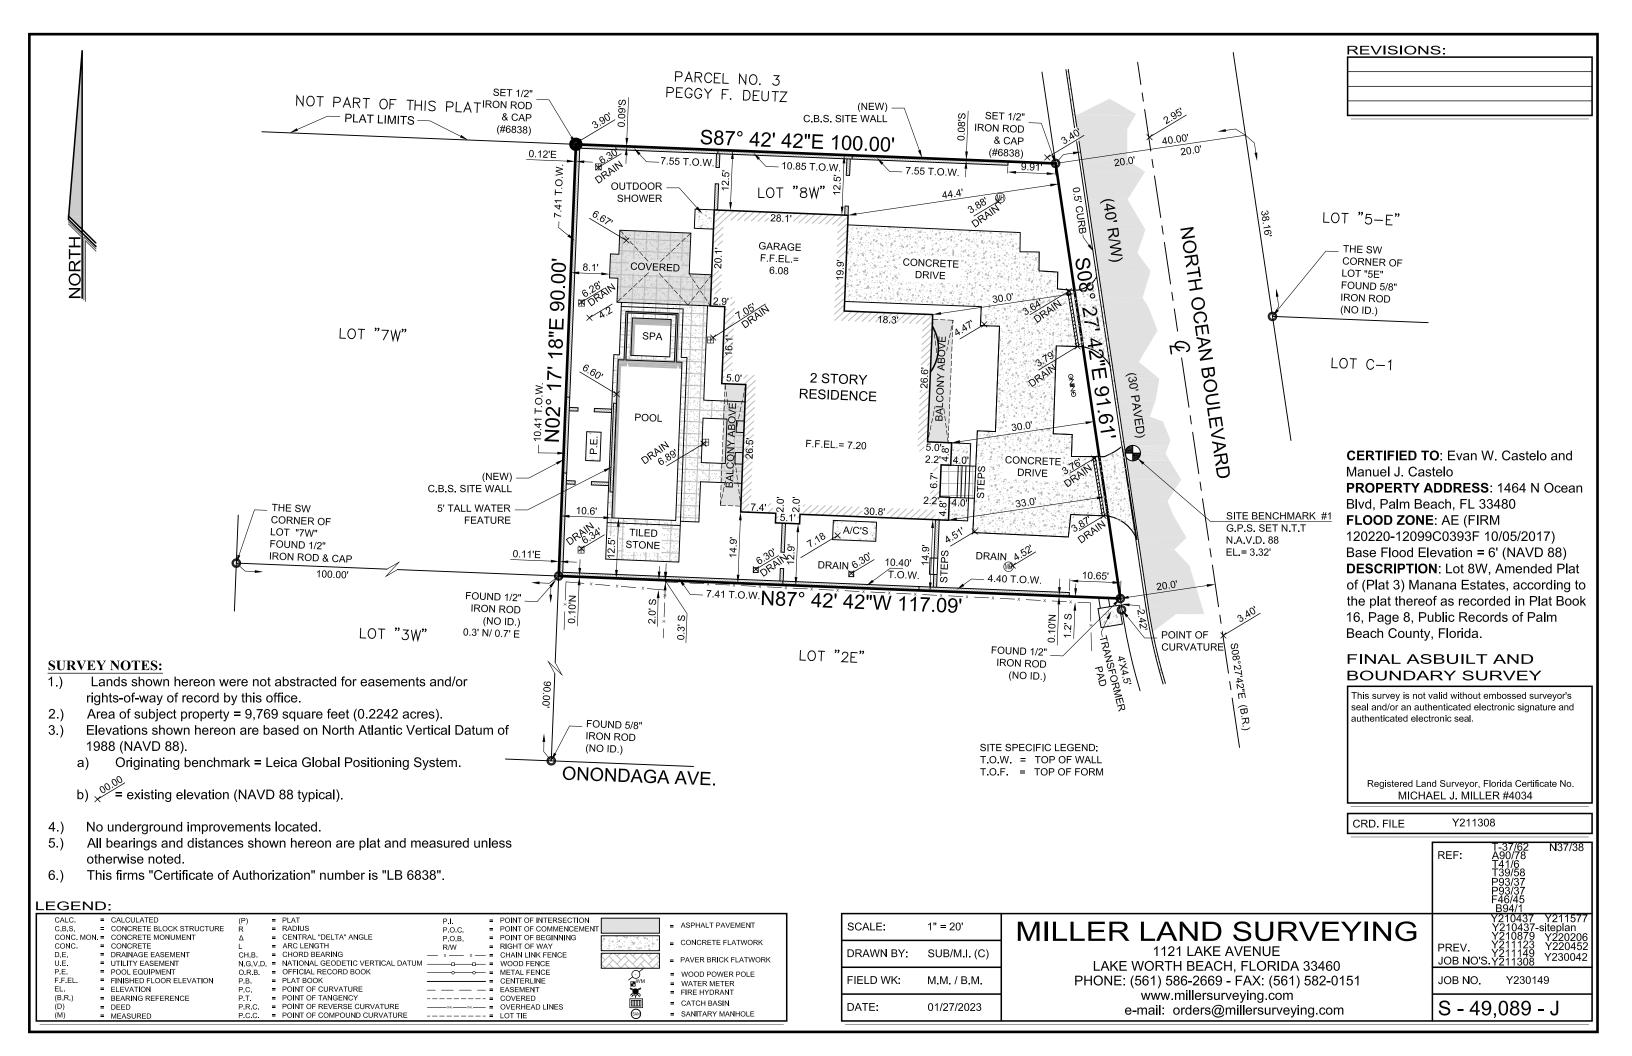

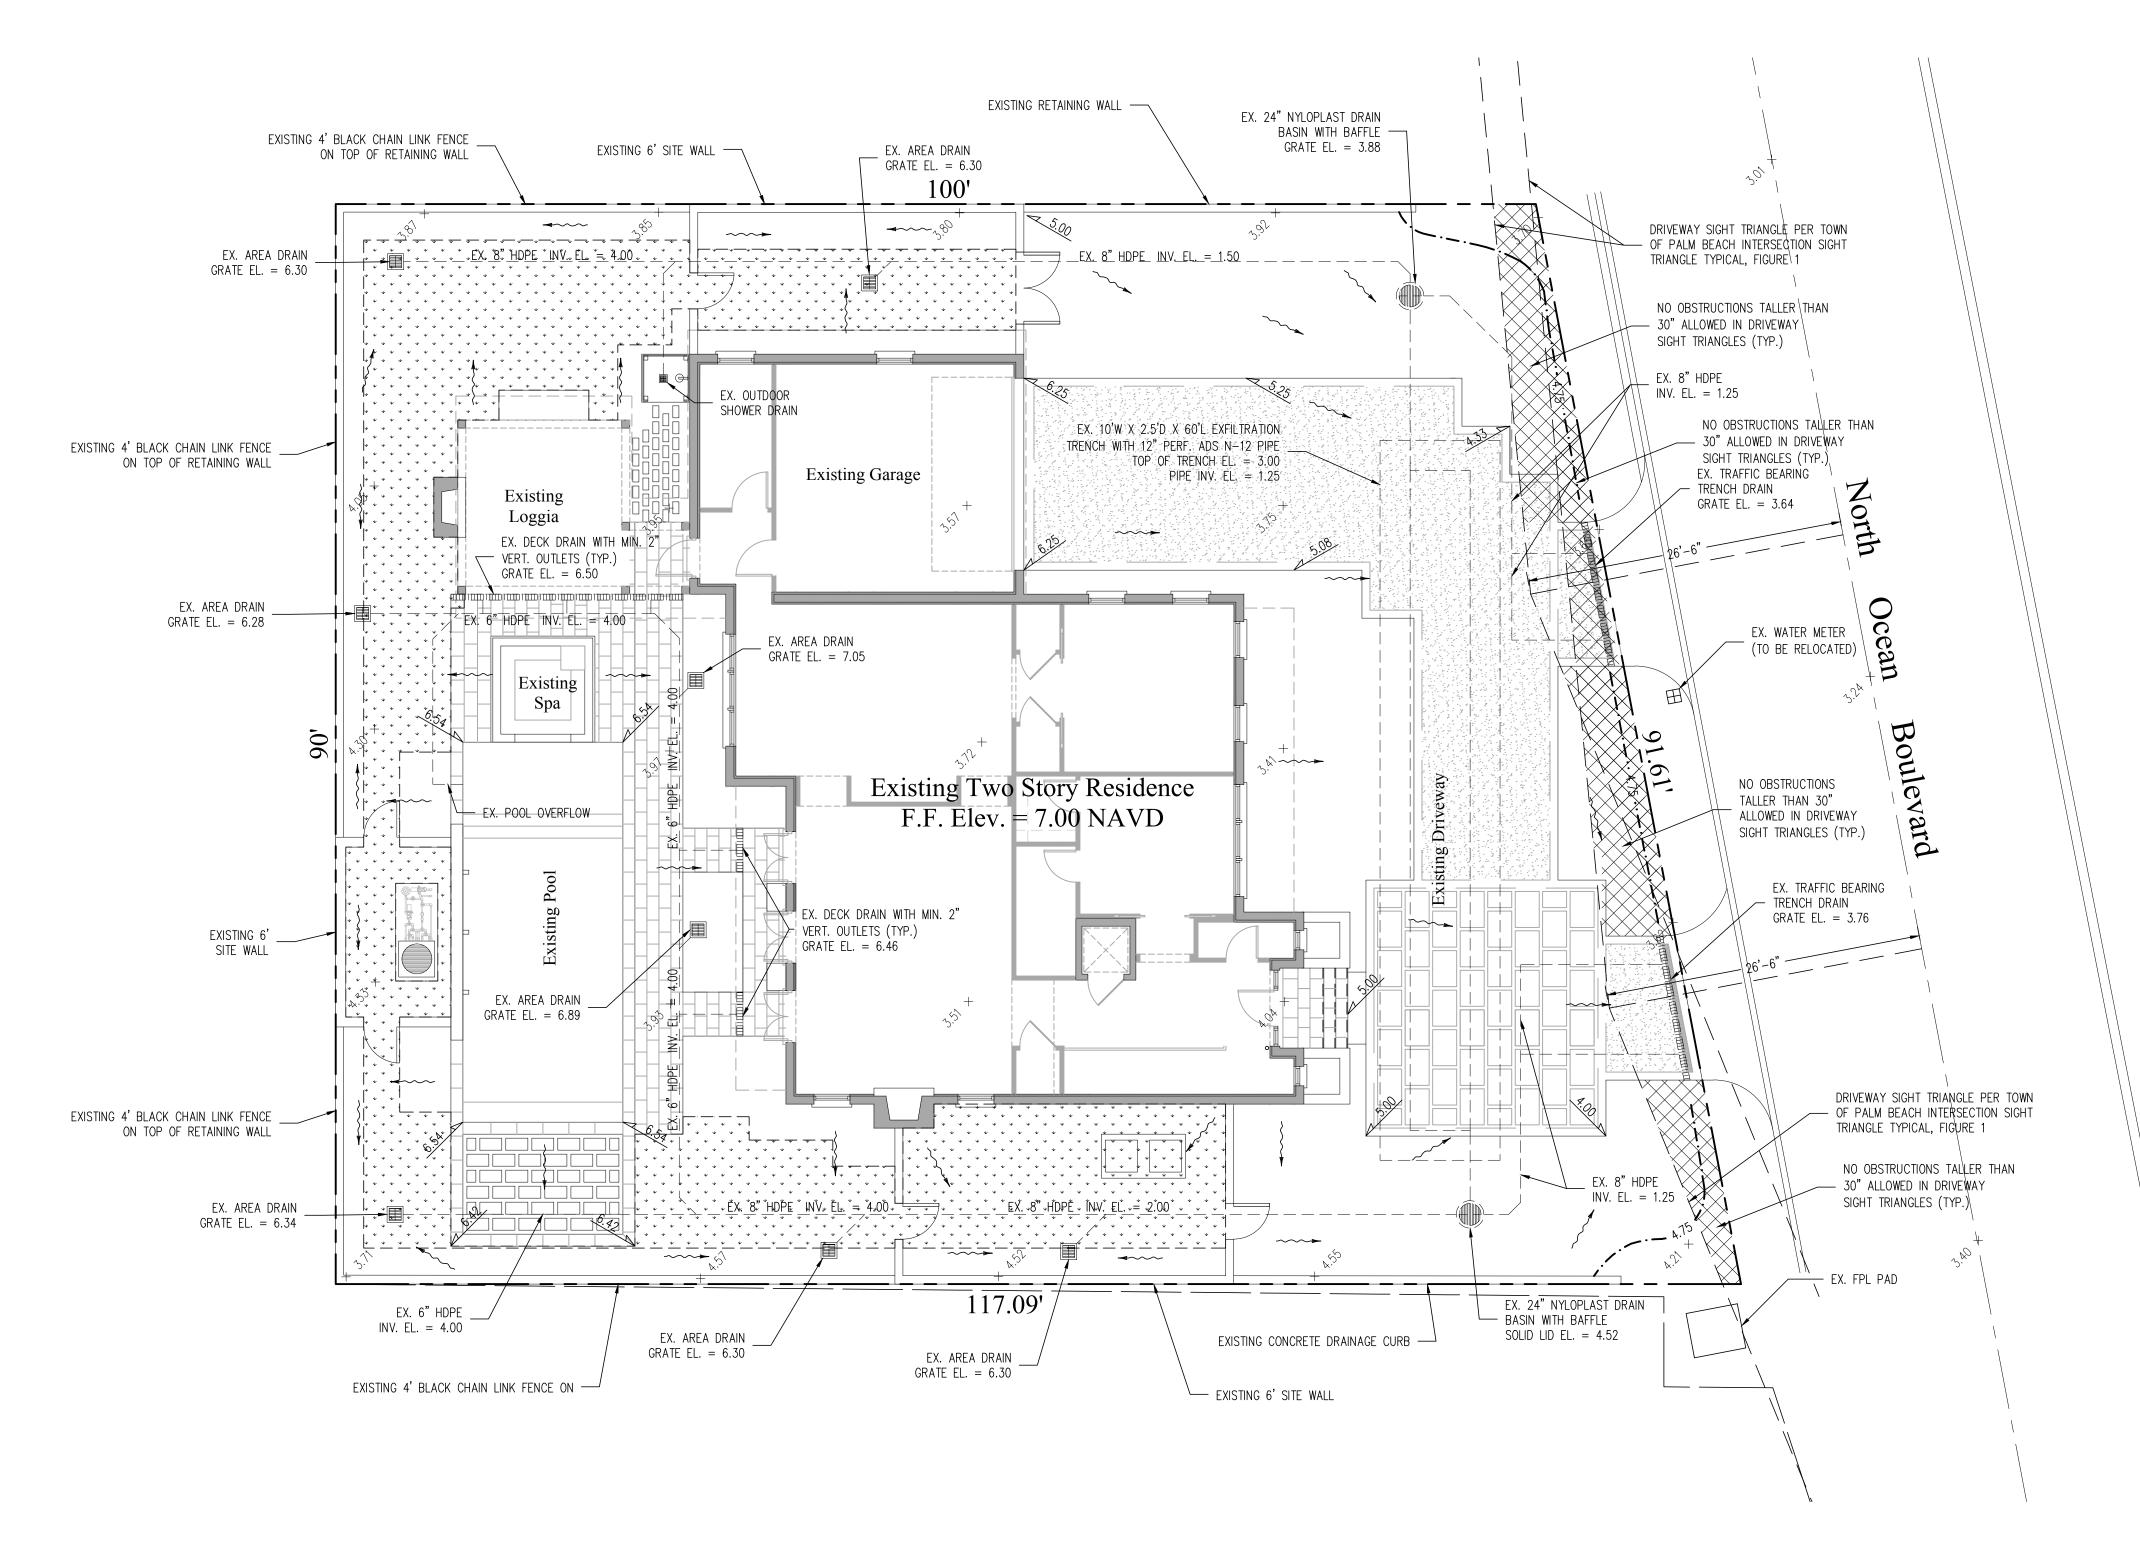

Drainage Area Pervious Surface = 2,931 sq.ft.

Drainage Area Synthetic Turf Surface = 1,416 sq.ft.

B. ESTIMATED STORMWATER RETENTION VOLUME

The retention volume is estimated using the Rational Method (Q=CiA)

C = 1.0 (impervious surface)

Impervious Surface Runoff Volume:

Pervious Runoff Volume:

 $0.2 \times 2 \text{ in/hr } \times 2,931 \text{ sq.ft.} \times 1 \text{ ft./12 in.} = 98 \text{ cu.ft.}$

2) Roof drain downspouts are to be connected to the proposed $0.2 \times 2 \text{ in/hr} \times 1,416 \text{ sq.ft.} \times 1 \text{ ft./12 in.} = 48 \text{ cu.ft.}$ drainage system. Contractor to provide engineer with

downspout locations prior to installation of drainage system. 3) Contractor shall mill and overlay all roadway cuts a minimum

of 50 ft. on either side of the excavation the entire width of each affected lane.

Notes:

roots with a root barrier.

4) Contractor is responsible for installing and maintaining erosion control measures during construction.

1) Exfiltration trenches and storm piping to be protected from

5) Video inspection of storm drainage system required prior to

installation of sod.

STORMWATER RETENTION CALCULATIONS

A. SITE INFORMATION

Total Property Area = 9,769 sq.ft.

Drainage Area Impervious Surface = 5,422 sq.ft.

C = 0.2 (pervious surface)

 1.0° x 2 in/hr x 5,422 sq.ft. x 1 ft./12 in. = 910 cu.ft.

Synthetic Turf Runoff Volume:

V = Volume Treated

Total Volume to be Retained = 1,056 cu.ft.

C. EXISTING EXFILTRATION TRENCH SIZING

L = Total Length of Trench Provided = 60 ft = 10 ft W = Trench Width = 0.000126 cfs/sq.ft./ft. of head K = Hydraulic Conductivity

H2 = Depth to Water Table = 2.14 ft DU = Un-Saturated Trench Depth = 1.50 ft

DS = Saturated Trench Depth = 1.00 ft= 1,273 cu.ft.

48 HOURS BEFORE DIGGING CALL 1-800-432-4770 SUNSHINE STATE ONE CALL OF FLORIDA, INC. Contractor is responsible for obtaining location of existing utilities prior to commencement of construction activities.



Legend

EXISTING ELEVATION PER PINNACLE SURVEYING (NAVD-88)

PROPOSED ELEVATION (NAVD-88)

Location Map

N.T.S.


---7.00--- PROPOSED ELEVATION CONTOUR (NAVD-88)

FLOW DIRECTION

EXFILTRATION TRENCH

AREA DRAIN

24" NYLOPLAST DRAIN BASIN WITH BAFFLE

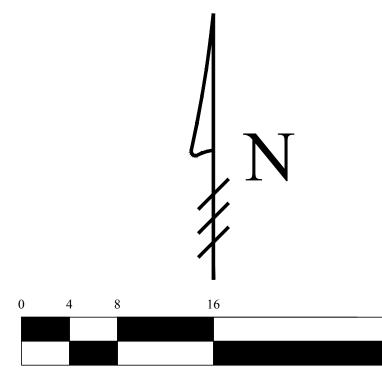

Scale: 1/8" = 1'-0"

/1\ 04/30/21 REVISE EXFILTRATION TRENCH LAYOUT AND CALCULATIONS TO REFLECT SOIL TEST RESULT

/2\ 06/07/21 UPDATE PLAN BACKGROUND; REVISE PROPOSED GRADING AND DRAINAGE;

REVISE PERIMETER WALL TYPES /3\ 03/13/23 UPDATE PLAN WITH AS-BUILT DRAINAGE CONFIGURATION

4 02/12/24 ADD AREA OF SYNTHETIC TURF; REVISE STORMWATER RETENTION CALCULATIONS

Chad M. Gruber

04/30/2021 06/07/2021

03/13/2023

4 02/12/2024

8

10

Residence

Existin

This item has been electronically signed and sealed by Chad M. Gruber on the date adjacent to the seal using a SHA authentication code. Printed copies of this document are not considered signed and sealed and the SHA authentication code must be verified on any electronic copies.

> Plan Background from Hardscape Plan by Environment Design Group Received 1/26/24 © 2024 Gruber Consulting Engineers, Inc.

Sheet No. **C-**1

FL P.E. No. 57466

DE/IGN 3 ROUP 139 North County Road S#20—B Palm Beach, Fl 3348(Phone 561.832.4600 Mobile 561.313.4424

Landscape Architecture

Landscape Management

Dustin@environmentdesigngroup.com

Dustin M. Mizell, MLA RLA #6666784

Land Planning

JOB NUMBER: # 202068.00 LA
DRAWN BY: Matt Jackman DATE: 12.2.2020 1.13.2021

SHEET L7a

ARCOM: B-004-2021 TC: Z-20-00314

Planting Plan Scale IN FEET O' 24'

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PREVIOUSLY APPROVED

Trees & Palms

SYMBOL	PLANT NAME	QTY.	QTY. DESCRIPTION	
	COCOS NUCIFERA COCONUT PALM	4	20' CT HT, STRAIGHT TRUNK	NO
(+)	COCCOLOBA UVIFERA SEAGRAPE	ı	20' HT, CHARACTER TRUNK	YES
\odot	ILEX ATTENUATA 'EAGLESTON' EAGLESTON HOLLY	6	14' HT	YES
	LATANIA LODDIGESII BLUE LATANIA	2	12' HT	NO
*	PTYCHOSTERMA ELEGANS ALEXANDER PALM	3	I2' CT HT	NO
3 4 4 4 4 4 4 4 4 4 4 4 4 4 4 4 4 4 4 4	RHAPIS EXCELSA SHADY LADY	2	6' HT, FULL	NO
30 - 4 - 4 - 4 - 4 - 4 - 4 - 4 - 4 - 4 -	RHAPIS EXCELSA SHADY LADY	2	6' HT, FULL	NO
	THRINAX RADIATA THATCH PALM	12	8' CT HT	YES
	VEITCHIA MERRILLII ADONIDIA PALM	2	12' CT HT	NO
Clarent	lac Vinac 8		oundcou	

•		•	•	•
hrubs,	Vines,	&	Groui	ndcovers

SYMBOL/KEY	PLANT NAME	QTY.	DESCRIPTION	NATIVE
	ALOCASIA ODORA CALIFORNIA DWARF ALOCASIA	16	#3, 24" HT, 24" OC	NO
	CARISSA MACROCARPA EMERALD BLANKET	240	#3, 18" HT, 12" OC	NO
	CLUSIA GUTTIFERA SMALL LEAF CLUSIA	125	8' HT, 30" OC	NO
	CLUSIA GUTTIFERA SMALL LEAF CLUSIA	29	3' HT, 24" OC	NO
	CONOCARPUS ERECTUS SILVER BUTTOWNOOD HEDGE	30	6' HT., 24" O.C. MATCH EXISTING	YES
+	DOMBEYA BURGESSIAE DOMBEYA SEMINOLE	5	4' HT	NO
	FICUS MICROCARPA GREEN ISLAND FICUS	70	#3, 24", 18" OC	NO
	HAMELIA PATENS FIREBUSH	15	4' HT, 30" OC	YES
	LIRIOPE MUSCARI LIRIOPE	80	#3, 18" HT, 18" OC	NO
	TRACHELOSPERMUM ASIATICUM JASMINE MINIMA	40	4" LINERS, 6" OC	NO
	BOUGINVILLEA BOUGINVILLEA	6	12' HT ESP. TO WALL	NO
	TRACHELOSPERMUM JASMINOIDES CONFEDERATE JASMINE	3	8' HT, ESP TO WALL IN SQUARE PATTERN	NO
Existi	ng Trees			
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SYMBOL	PLANT NAME	QTY.	DESCRIPTION	NATIVE
	COCOS NUCIFERA COCONUT PALMS	2	MOVED TO STAGING AREA	NO
	SABAL PALMETTO SABAL PALM	12	MOVED TO STAGING AREA	YES

Lawn & Mulch

SYMBOL/KEY	PLANT NAME	QTY.	DESCRIPTION
LAWN	SUPREME PASPALUM LAWN	AS NEEDED	SOD PALLETS
PLANTING BED	SHREDDED EUCALYPTUS MULCH	AS NEEDED	MULCH ALL BEDS 3" MIN, DEPTH

DEMIGN GROUP

139 North County Road S#20-B Palm Beach, Fl 33480 Phone 561.832.4600 Mobile 561.313.4424

Landscape Architecture Land Planning

Landscape Management

Dustin M. Mizell, MLA RLA #6666784 Dustin@environmentdesigngroup.com

JOB NUMBER: # 202068.00 LA
DRAWN BY: Matt Jackman
DATE: 12.2.2020
1.13.2021

/HEET L7b

ARCOM: B-004-2021 TC: Z-20-00314

Plant Schedule

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