RECEIVED

By yfigueroa at 1:00 pm, Feb 26, 2024

960 N OCEAN BLVD - PALM BEACH - FLORIDA - 33480



LOCATION MAP

SECOND SUBMITTAL

02/26/2024

PROJECT No.: 2023-14 DATE OF HEARING: 04/24/2024


ARCOM# ARC-24-047




PORTUONDO PEROTTI ARCHITECTS, INC.

5717 S.W. 8th STREET
MIAMI, FLORIDA 33144
PH: (305) 260 -9331
FAX: (305) 260 -9318
E-MAIL: info@PORTUONDO-PEROTTI.COM

	PROJECT DIRECTORY		INDEX OF DRAWI	NGS		
	OWNER	ARCHITECT	TURE	FIRST SUBMITTAL	SECOND SUBMITTAL	REV-
		SHEET NO.	TITLE	02/08/2024	02/26/2024	
١.	MR. AND MRS. CARDINALE 960 N OCEAN BLVD					
	PALM BEACH, FLORIDA. 33480		COVER SHEET	X	X	
	ARCHITECT		SURVEY	X	X	
	PORTUONDO PEROTTI ARCHITECTS 5717 SW 8th STREET MIAMI, FLORIDA. 33144 PHONE (305) 260-9331 FAX (305) 260 9318 LICENSE # AAC001407	A-001	SITE SETBACK DIAGRAM UPPER LEVEL SETBACK DIAGRAM	X	X	
<u>2</u> .		A-001.1	ZONING DATA	X	X	
		A-001.2		X	X	
		A-001.3 A-001.4	CUBIC CONTENT DIAGRAM EXISTING DIAGRAM	X	X	
		A-001.4 A-001.5	AREA DIAGRAMS	X	X	
	LANDSCAPE ARCHITECT	A-001.6	UPPER LEVEL AREA DIAGRAM	X	X	
١.	LAGUARDIA DESIGN GROUP LANDSCAPE ARCHITECTURE	A-001.7	YARD SECTION DIAGRAM	X	X	
,	38 SCUTTLE HOLE ROAD WATER MILL, NEW YORK 11976	A-001.8	CONSTRUCTION STAGING PLAN	X	x	
	PH:(631) 726-1403	A-001.9	EXISTING FLOOR PLAN	1	X	
		A-001.10	EXISTING FLOOR PLAN	1	X	
		A-001.11	VARIANCE DIAGRAM		Х	
		A-002	LOCATION PLAN	х	X	
		A-002.1	NEIGHBORHOOD VICINITY ELEVATIONS	Х	Х	
		A-002.2	STREETSCAPE ELEVATIONS	Х	х	
		A-002.3	NEIGHBORHOOD RESIDENCE PHOTOS	Х	Х	
	BUILDING DEPARTMENT	A-002.4	NEIGHBORHOOD RESIDENCE PHOTOS	Х	Х	
	TOWN OF PALM BEACH BUILDING DEPARTMENT	A-002.5	SUBJECT PROPERTY EXISTING PHOTOS	Х	Х	
-	360 SOUTH COUNTY ROAD	A-002.5	VICINITY LOCATION MAP (1/4 MILE)	Х	Х	
	PALM BEACH, FL. 33480 PH: (561) 838-5400	A-003	TRUCK LOGISTIC PLAN	Х	Х	
,	SCOPE OF WORK NEW TWO STORY CABANA WITH RELATED LANDSCAPE, HARDSCAPE, AND CIVIL WORK. WE PROPOSE A 6.0' FT H SAFETY LOW WALL WE ARE PROPOSING A METAL TRELLIS LOCATED NORTH OF THE POOL. WE ARE REMOVING 28 SQ.FT OF THE MAIN ONE	A-100	EXISTING / PROPOSED SITE PLAN	Х	Х	
ł		A-100.1	PROPOSED SITE PLAN	Х	Х	
		A-101	EXISTING / PROPOSED MAIN FLOOR PLAN	Х	Х	
		A-101.1	PROPOSED MAIN FLOOR PLAN	Х	Х	
		A-101.2	EXISTING / PROPOSED MAIN FLOOR PLAN CABANA	X	X	
		A-101.3	PROPOSED MAIN FLOOR PLAN CABANA	X	X	
	STORY RESIDENCE AND ADDING 30 SQ.FT TO THE	A-102	PROPOSED UPPER FLOOR PLAN CABANA	X	X	
	EXISTING ONE STORY RESIDENCE AT THE GYM AREA	A-103	EXISTING / PROPOSED ROOF PLAN	X	X	
	* WE ARE PROPOSING A METAL/GLASS SKYLIGHT AT	A-103.1	PROPOSED ROOF PLAN		X	
	THE LIVING ROOM AREA. * WE ARE REMOVING AND REPLACING WINDOWS &	A-103.2 A-103.3	EXISTING / PROPOSED ROOF PLAN CABANA	X	X	
	DOORS.	A-103.3 A-200	PRPOSED ROOF PLAN CABANA EXISTING ELEVATIONS	X	X	
		A-200 A-201	EXISTING LEEVATIONS EXISTING / PROPOSED ELEVATIONS	X	X	
		A-201	EXISTING / PROPOSED ELEVATIONS EXISTING / PROPOSED ELEVATIONS	X	X	
		A-202 A-203	PROPOSED ELEVATIONS PROPOSED ELEVATIONS	X	X	
		A-203 A-204	PROPOSED ELEVATIONS PROPOSED ELEVATIONS	X	X	
		A-205	RENDER ELEVATIONS	<u> </u>	X	
		A-206	RENDER ELEVATIONS	1	X	
		A-300	EXISTING / PROPOSED SECTIONS	х	X	
		A-301	PROPOSED BUILDING SECTIONS	X	X	
		A-302	PROPOSED BUILDING SECTIONS	X	X	
		A-400	CHIMNEY DETAIL	х	Х	
		A-401	POOL LOUNGE ENLARGED FLOOR PLAN AND SECTION	Х	Х	
		A-402	RAILING DETAIL		Х	
		A-403	PERGOLA AND LIGHT FIXTURE DETAIL		Х	
		A-601	DOORS SCHEDULE		Х	
		A-602	WINDOWS AND SHUTTERS SCHEDULE		Х	
		D-100	DEMO / EXISTING SITE PLAN	Х	Х	
		D-101	DEMO / EXISTING FLOOR PLAN	Х	Х	
		D-101.1	DEMO / EXISTING FLOOR PLAN	Х	Х	
		D-103	DEMO / EXISTING ROOF PLAN	Х	Х	
		D-103.1	DEMO / EXISTING ROOF PLAN	Х	Х	
		D-200	DEMO / EXISTING ELEVATIONS	Х	Х	
		D-201	DEMO / EXISTING ELEVATIONS	Х	Х	

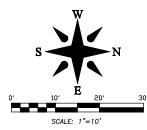

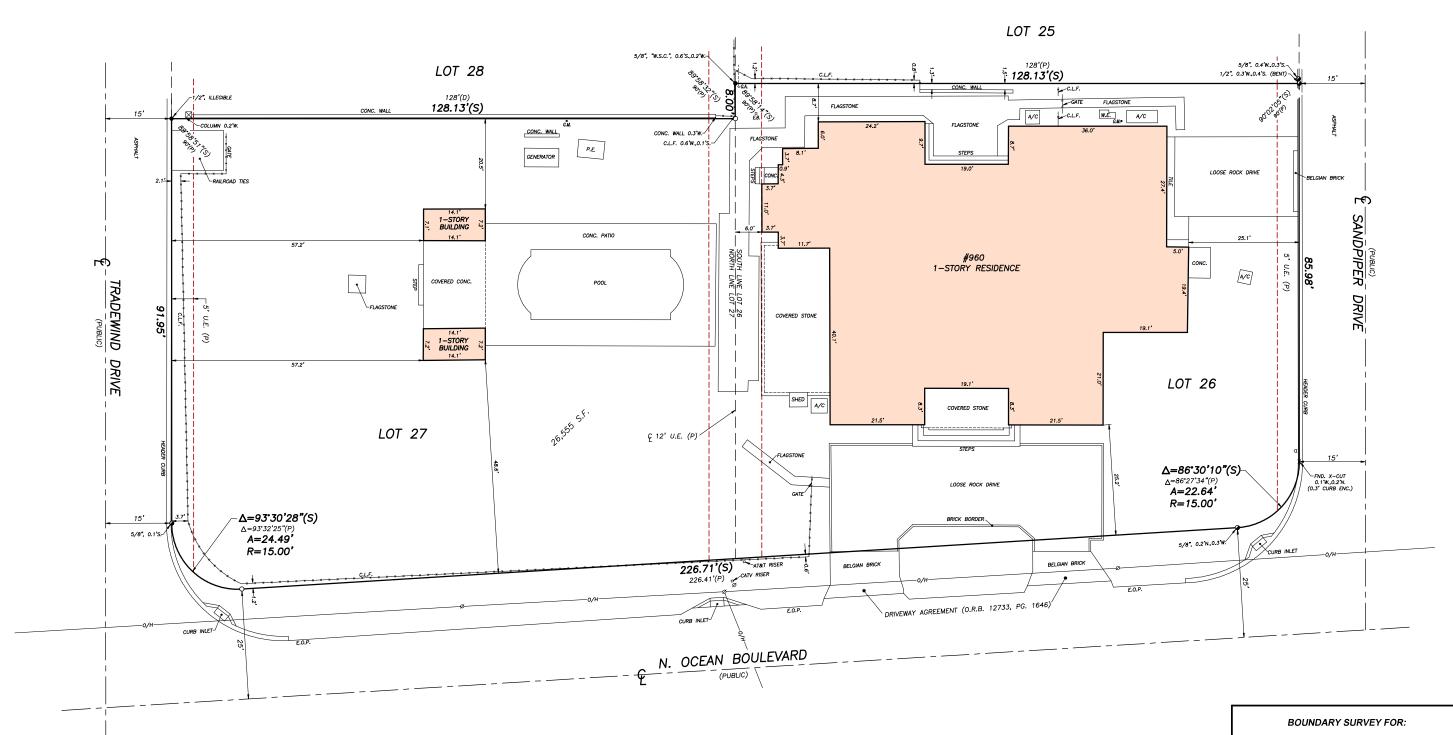

ALAN D. BLEZNAK & KATHLEEN BLEZNAK





IRLERCE SURVEYING
CORP. DICHOSO NUSHESS # 494

FIELD B.M. JOB NO. 10-1040 F.B. PB349 PG. 65

OFFICE M.B. DATE 6/27/23 DVG. NO. 10-1040

CNYD C.W. REF. 10-1040.DWG SHEET 2 DF 2

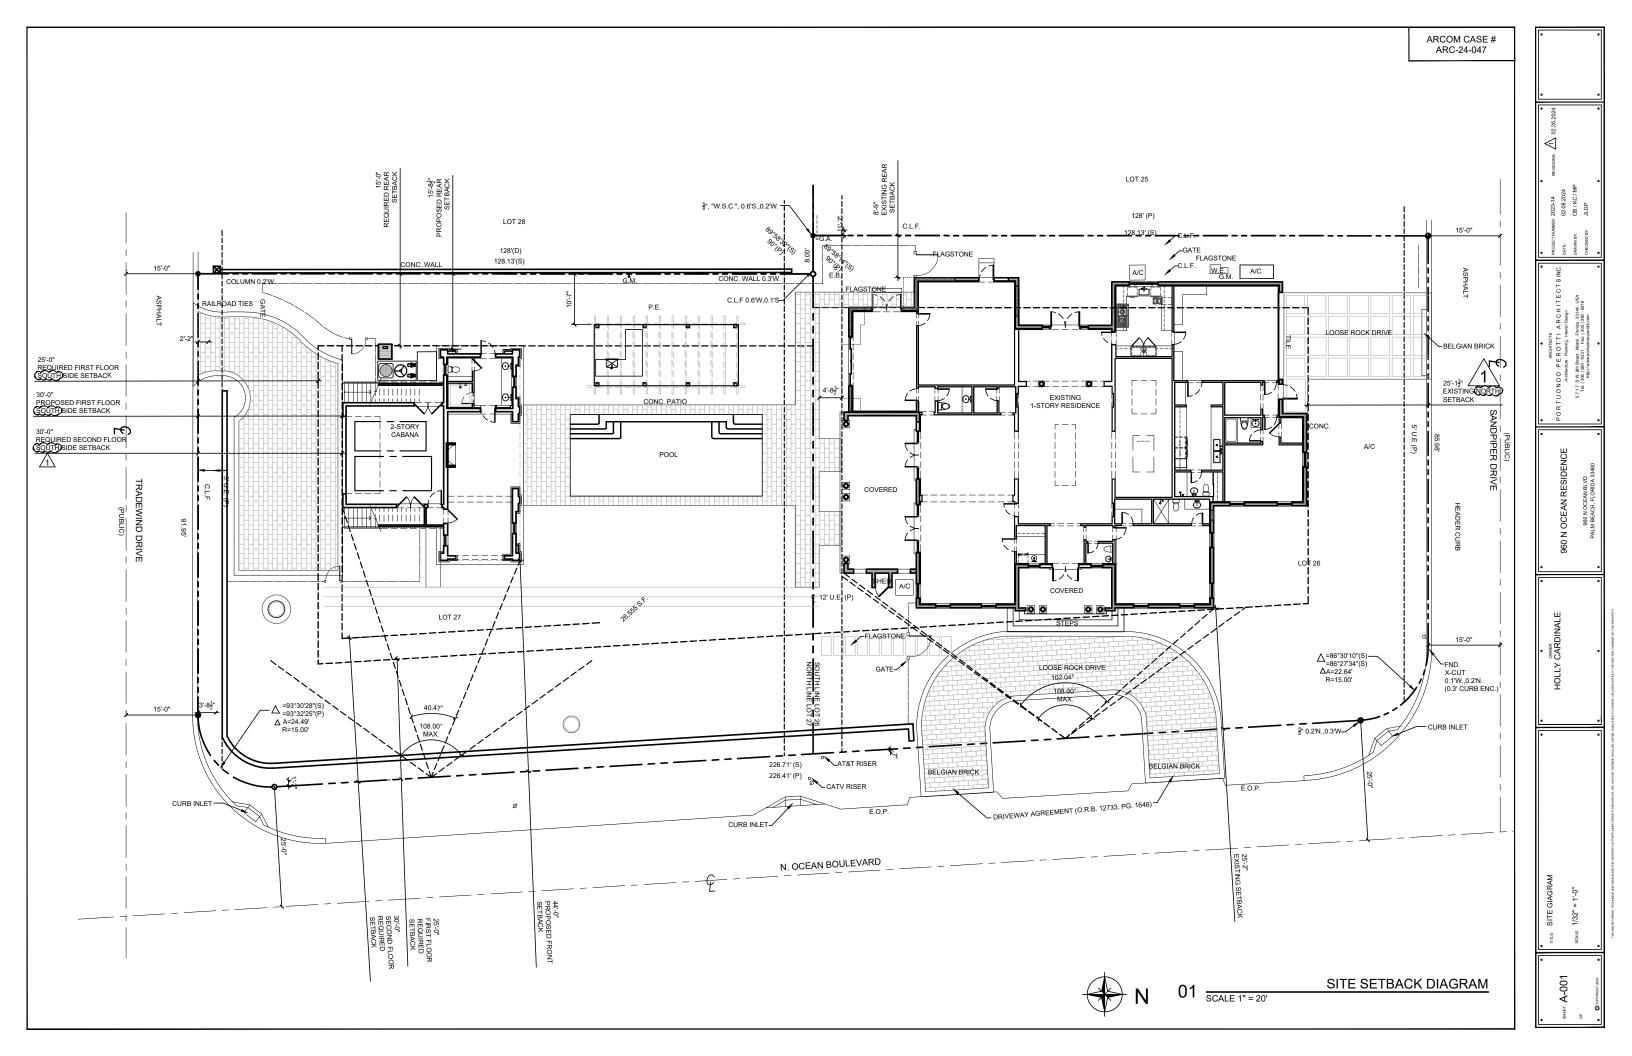

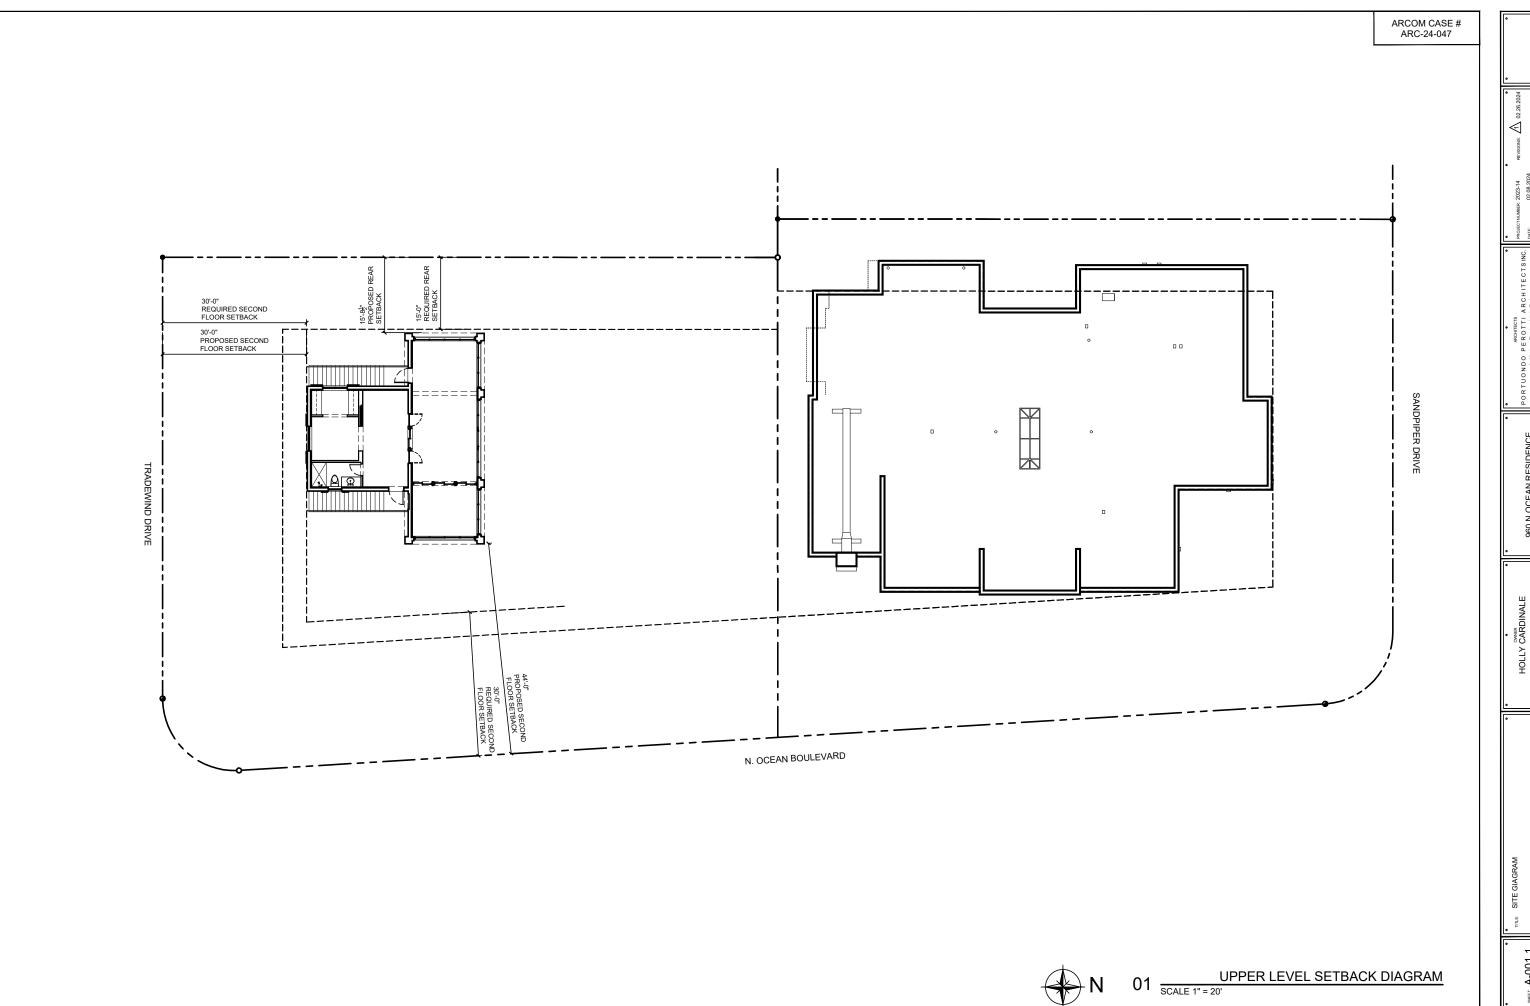

960 N OCEAN RESIDENCE A-001.1



Town of Palm Beach

Planning Zoning and Building 360 S County Rd Palm Beach, FL 33480 www.townofpalmbeach.com

Line #	Zoning Legend			
1	Property Address:	960 N Ocean Blvd, Palm Beach, Florida 33480		
2	Zoning District:	R-B LOW DENSITY RESIDENTIAL		
3	Lot Area (sq. ft.):	26,552 sq.ft		
4	Lot Width (W) & Depth (D) (ft.):	256.71' X 106.91' IRREGULAR		
5	Structure Type: (Single-Family, Multi-Family, Comm., Other)	SINGLE FAMILY RESIDENCE		
6	FEMA Flood Zone Designation:	AE 6.0		
7	Zero Datum for point of meas. (NAVD)	7.0 NAVD		
-8	Crown of Road (COR) (NAVD)	NAVD		

9		REQ'D / PERMITTED	EXISTING	PROPOSED	
10	Lot Coverage (Sq Ft and %)	25% (6,638)	5,681	26.6% (7,047)	
11	Enclosed Square Footage (1st & 2nd Fl., Basement, Accs. Structure, etc)	N/A	N/A	N/A	
12	*Front Yard Setback (Ft.)	25'-0"	25'-2"	44'-0"	
13	* Side Yard Setback (1st Story) (Ft.)	25'-0"	25'-2"(N) / 57'-2" (S)	25'-2"(N) / 30'-0"(S)	
14	* Side Yard Setback (2nd Story) (Ft.)	30-0"	N/A	189'-2"(N) / 30'-0"(S)	
15	*Rear Yard Setback (Ft.)	15'-0"	8'-9"	15'-8"	
16	Angle of Vision (Deg.)	108 Deg	16.4 Deg	40 Deg	
17	Building Height (Ft.)	25'-0"	15'-0"	25'-0"	
18	Overall Building Height (Ft.)	25'-0"	15'-0"	21'-3"	
19	Cubic Content Ratio (CCR) (R-B ONLY)	101,813.11 CF (3.83)	57,729 CF (2.17)	81,545.0 CF (3.07)	
20	** Max. Fill Added to Site (Ft.)		N/A		
21	Finished Floor Elev. (FFE)(NAVD)	7.0' NAVD	N/A	7.0' NAVD	
22	Base Flood Elevation (BFE)(NAVD)	N/A	6.0' NAVD	6.0' NAVD	
23	Landscape Open Space (LOS) (Sq Ft and %)		N/A		
24	Perimeter LOS (Sq Ft and %)		N/A		
25	Front Yard LOS (Sq Ft and %)		N/A		
26	*** Native Plant Species %	Please refer to TOPB Landscape Legend.			

^{*} Indicate each yard area with cardinal direction (N,S,E,W)

** Difference of Fin. Floor Elev. (FFE) and highest Crown of Rd (COR) divided by two. (FFE -COR) / 2 = Max. Fill (Sec. 134-1600)

*** Provide Native plant species info per category as requited by <u>Ord. 003-2023</u> on separate TOPB Landscape Legend Enter N/A if value is not applicable.
Enter N/C if value is not changing.

REV BF 20230626

LEGAL DESCRIPTION

Lots 26 and 27,DODGE STATES,Palm Beach Florida, according to the Plat thereof on file in the Office of the Clerk of the Circuit Court in and for Palm Beach County, Florida, in Plat Book 27,Page 119.

PROPERTY ADDRESS

960 N OCEAN BLVD, PALM BEACH FL 33480

ZONING CLASSIFICATION

R-B- LOW DENSITY RESIDENTIAL

FLOOD CRITERIA

FLOOD ZONE: AE-6

BASE FLOOD ELEVATION: 7.0' NAVD

PROPOSED MAIN LEVEL T.O. SLAB ELEVATION (P.O.M): EXISTING NAVD

LOT AREA

GROSS LOT AREA = 26,552.00

 LANDSCAPE OPEN SPACE

 MINIMUM REQUIRED:
 50% OF LOT AREA=
 13,276.00
 SQ.FT.

 PROVIDED:
 53.95% OF LOT AREA=
 14,325.00
 SQ.FT.

 FRONT YARD AREA:
 6,322.00 SQ. FT
 45% OF FRONT YARD =
 2,844.90
 SQ.FT.

78.61% PROPOSED:

4,970.00

LOT COVERAGE AREA

PERMITTED: 25% ALLOWED: **6,638.00** SQ.FT.

EXISTING: 5,681.00 SQ.FT.

PROPOSED: 1,366.00 SQ.FT.

TOTAL: 7,047.00 SQ.FT.

TOTAL: 7,047.00 VARIANCE OVER BY: 409.00 SQ.FT. SECOND FLOOR BUILDING SETBACKS **GROUND FLOOR** MAIN HOUSE REQUIRED EXISTING 25'-0" FRONT: 25'-2" SIDE STREET NORTH: $\sqrt{1}$ 25'-0" 25'-2" SIDE STREET SOUTH: 25'-0" 134'-1" REAR: 15'-0" 8'-9" **CABANA** (auxiliary structure) REQUIRED **PROPOSED** REQUIRED PROPOSED FRONT: 25'-0" 44'-0" 30'-0" 44'-0" SIDE STREET SOUTH: 25'-0" 30'-0" 30'-0" 30'-0"

189'-2"

15'-8"

25'-0"

15'-0"

BUILDING HEIGHT

REAR:

MAXIMUM OVERALL HEIGHT ALLOWED EXISTING / PROPOSED:

SIDE STREET NORTH: \\[\frac{1}{1} \]

25'-0" 21'-3"

30'-0"

15'-0"

189'-2"

15'-8"

	LOT COVERAGE	l			
FIRST LEVEL	A/C	NON A/C	TOTAL AREA	LOT COVERAGE	l
MAIN HOUSE EXIST.	4,968.00 SQ. FT.		4,968.00 SQ. FT.	4,968.00 SQ. FT.	l
GYM EXTENSION	30.00 SQ. FT.		30.00 SQ. FT.	30.00 SQ. FT.	
COVERED TERRACE EXIST.		533.00 SQ. FT.	533.00 SQ. FT.	533.00 SQ. FT.	
ENTRY FOYER EXIST.		180.00 SQ. FT.	180.00 SQ. FT.	180.00 SQ. FT.	
MAIN LEVEL BATH	216.00 SQ. FT.		216.00 SQ. FT.	216.00 SQ. FT.	l
MAIN LEVEL CABANA		490 SQ. FT.	490.00 SQ. FT.	490.00 SQ. FT.	l
GARAGE		462.00 SQ. FT.	462.00 SQ. FT.	462.00 SQ. FT.	
STORAGE		168.00 SQ. FT.	168.00 SQ. FT.	168.00 SQ. FT.	
					l
SECOND LEVEL CABANA UPPER LEVEL	1,166.00 SQ. FT.		1,166.00 SQ. FT.		
TOTALS	6,380.00 SQ. FT.	1,833.00 SQ. FT.	8,213.00 SQ. FT.	7,047.00 SQ. FT.	l

ARCOM CASE # ARC-24-047

SQ.FT.

SQ.FT.

4 revisions: A 02.26.2024 2024 C./ MP

PROJECT NUMBER: 2023-14

DATE: 02.08.2024

DRAWN BY: CB / KC / MP

CHECKED BY: JLGP

ARCHTECTS

ARCHITECTS

Architecture - Parming - Interior Design

S W. Mis Street - Marin - Frontial 33144, USA


(1 (50) 200-2015 | Fax: (20) 200-2018

960 N OCEAN RESIDENCE
960 N OCEAN BLVD
PAIN MERAPH FI ORINA 33480

HOLLY CARDINALE

ONING DATA

ет. **А-**001.2

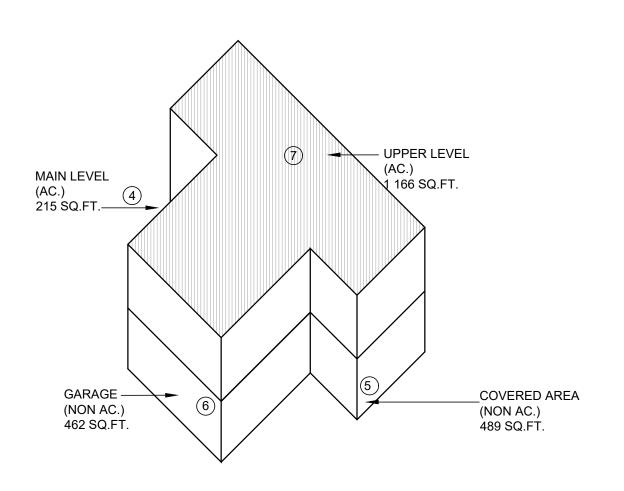


960 N OCEAN

CUBIC CONTENT CALCULATION (PER SURVEY)


ZONE	DESCRIPTION	AREA	BLDG HT. (From TOPB POM)	VOLUME	TOTAL
1	MAIN HOUSE (960 N OCEAN)	4,998.00 SF	9.50 FT	47,481.00 CF	
2	EXIST. COVERED TERRACE (960 N OCEAN)	521.00 SF	12.00 FT	6,252.00 CF	
3	EXIST. ENTRY FOYER	180.00 SF	12.00 FT	2,160.00 CF	
4	MAIN LEVEL	215.00 SF	8.80 FT	1,892.00 CF	75,831.60
5	COVERED AREA	489.00 SF	8.80 FT	4,303.20 CF	
6	GARAGE	462.00 SF	8.80 FT	4,065.60 CF	
7	UPPER LEVEL	1,166.00 SF	8.30 FT	9,677.80 CF	
				TOTAL	75,831.60


		$\frac{1}{2}$	
LOT AREA:		26,600.00 SF	
C.C.R. (MAX):	3.83	101,984.40 CF	
ADD. 5% FOR LOGGIAS*:	0.192	5,099.22 CF	*0
TOTAL MAX VOLUME:	4.026	107,083.62 CF	
TOTAL VOLUME PROPOSED:	2.851	75,831.60 CF	


*ORD. 04-2018

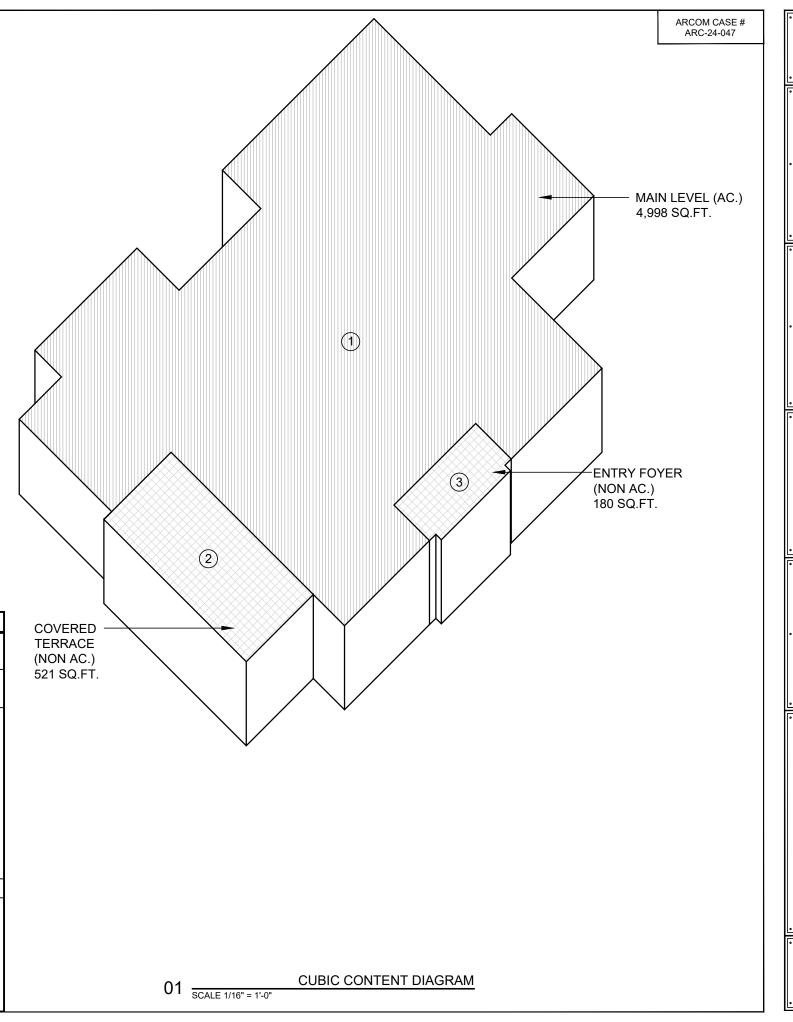


960 N OCEAN RESIDENCE

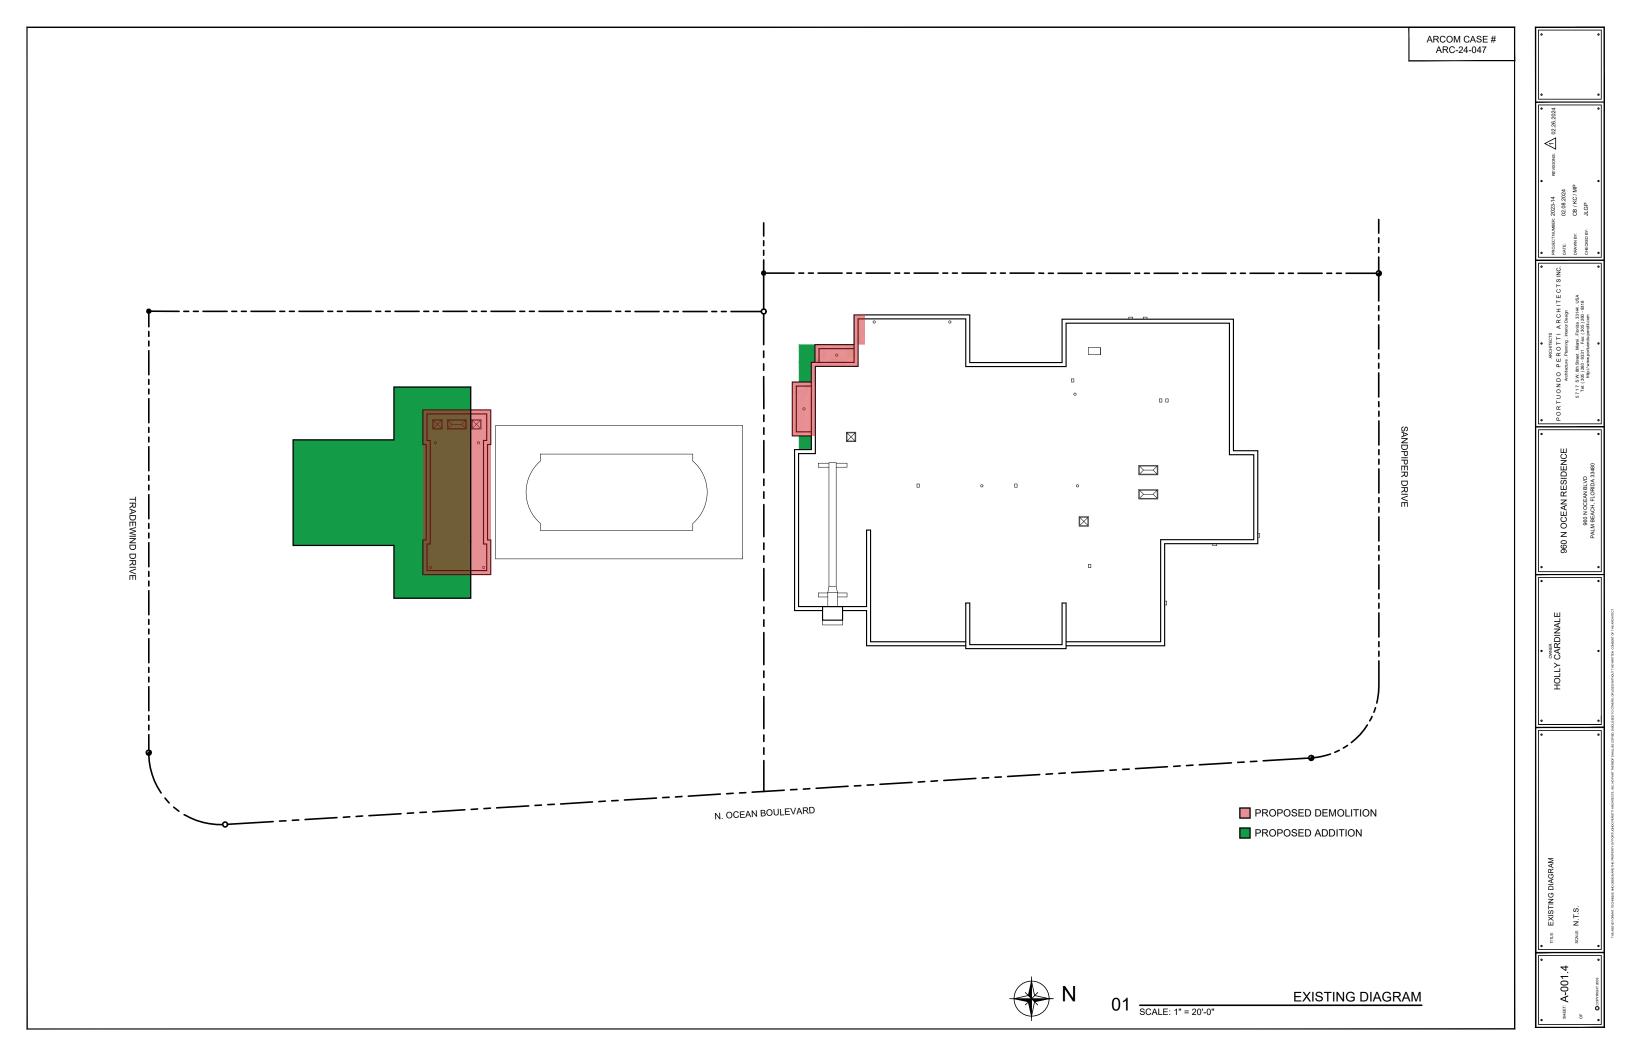


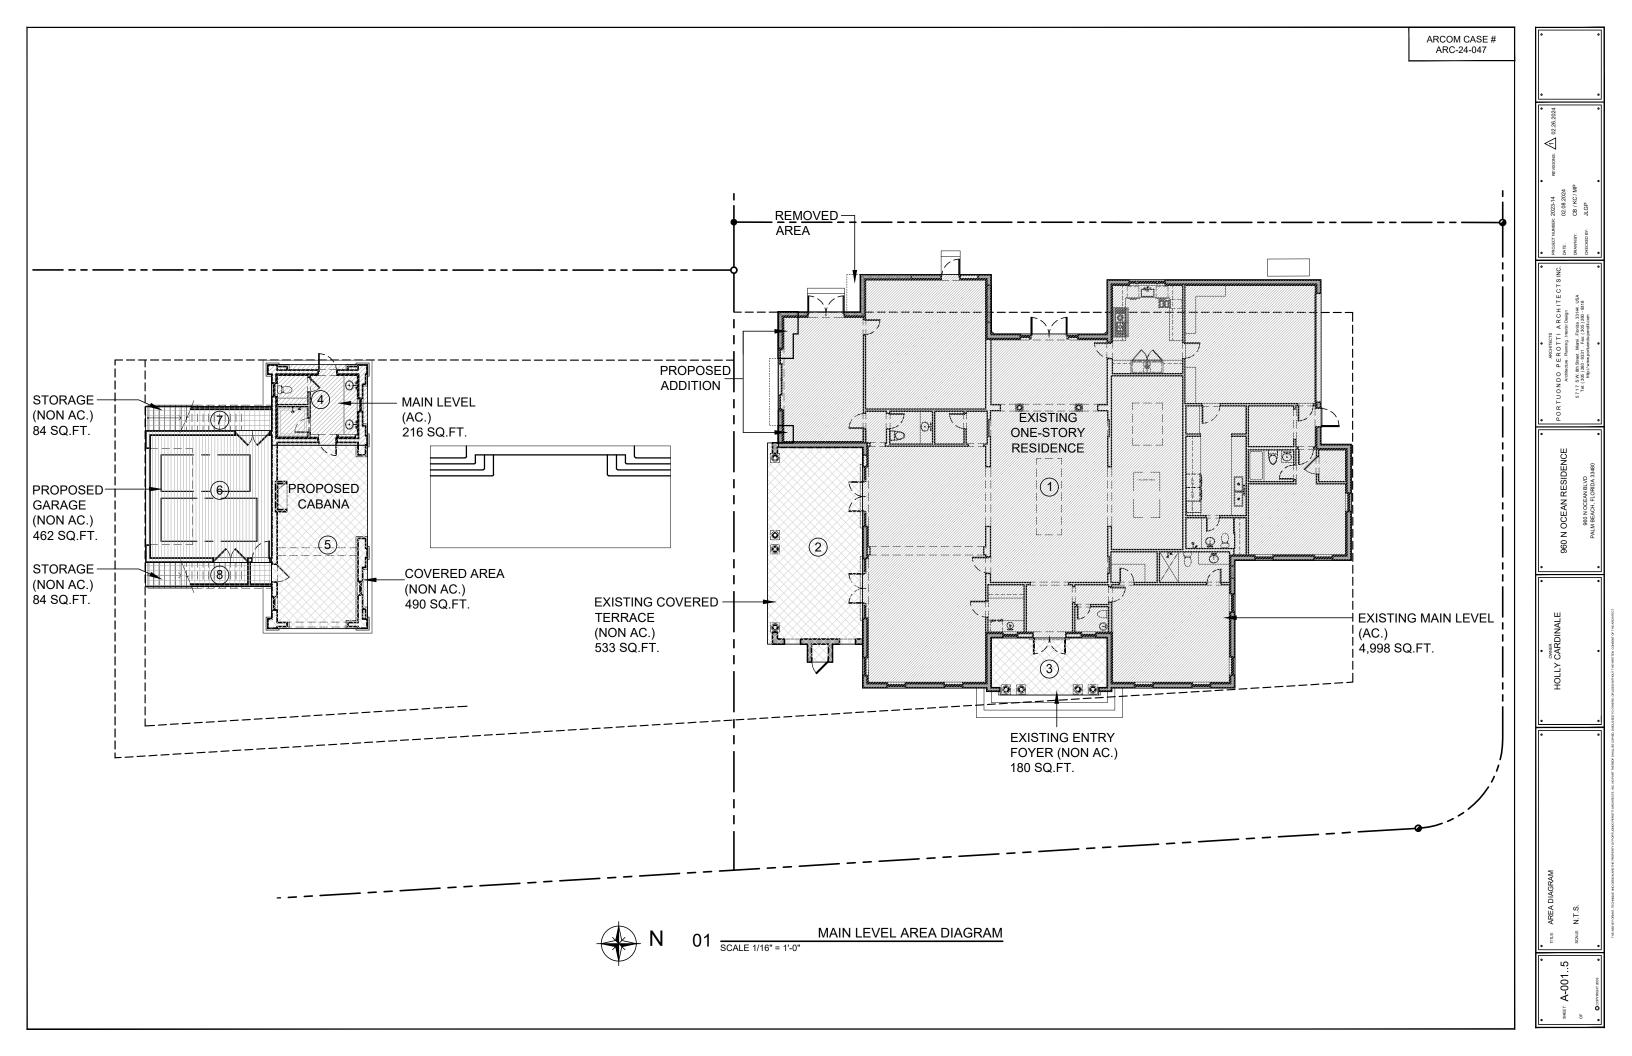


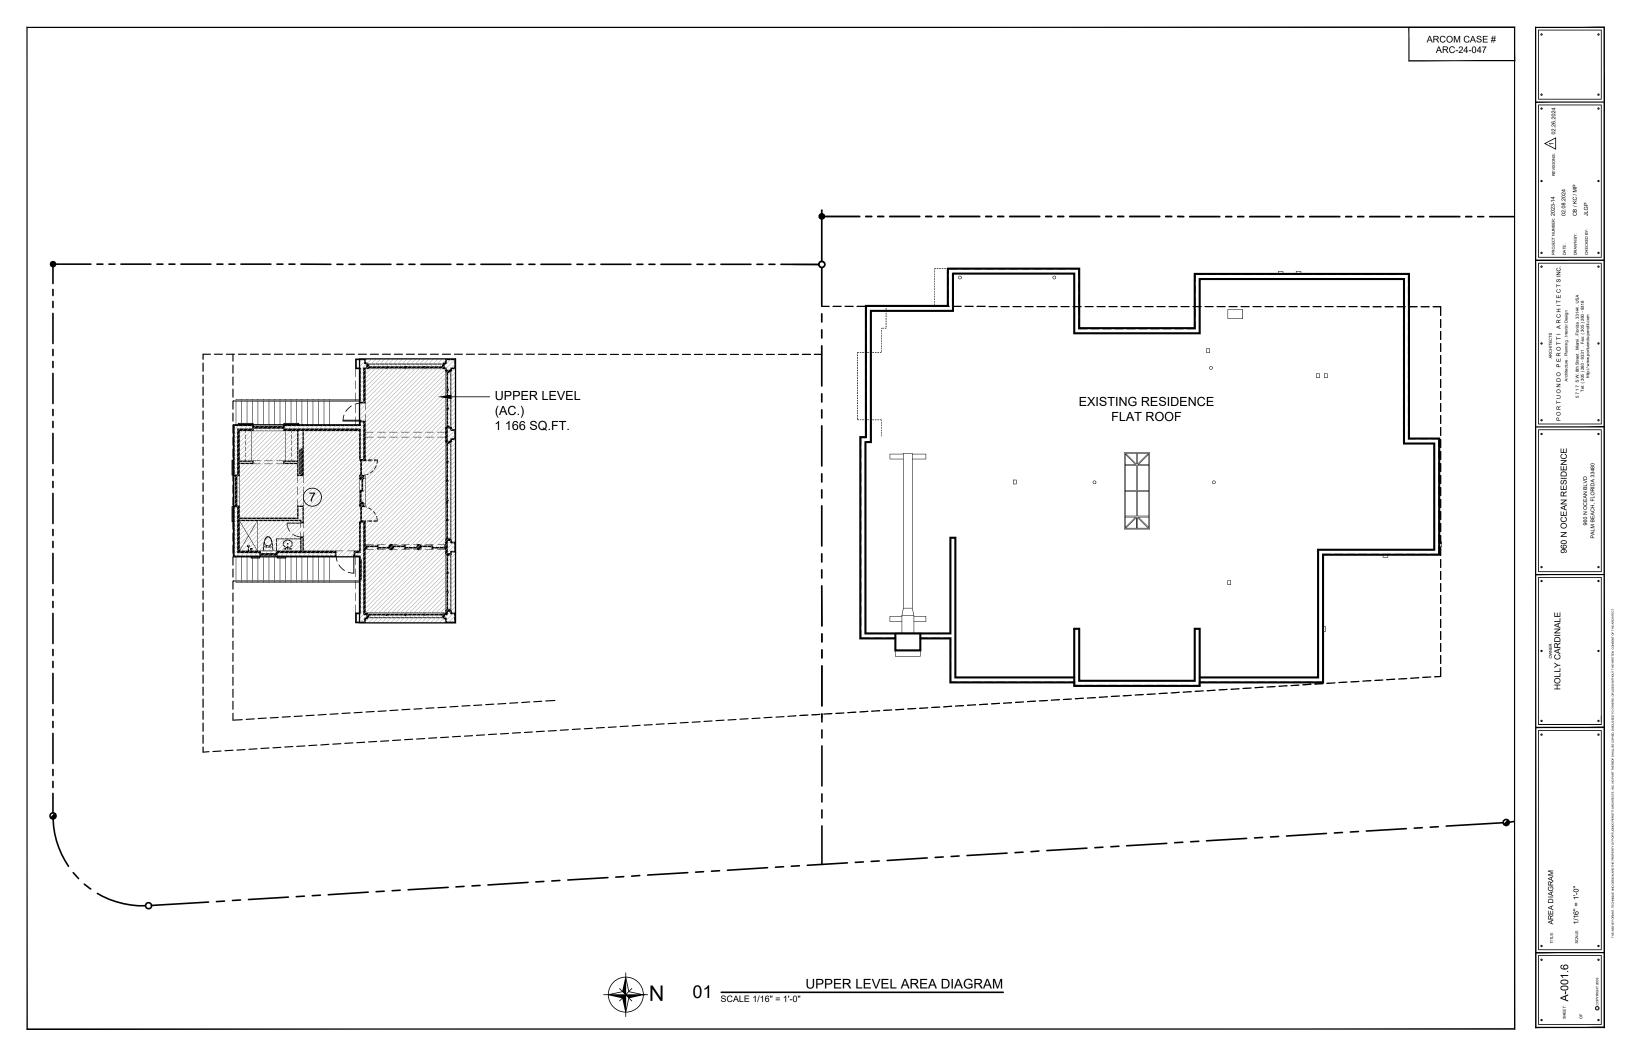


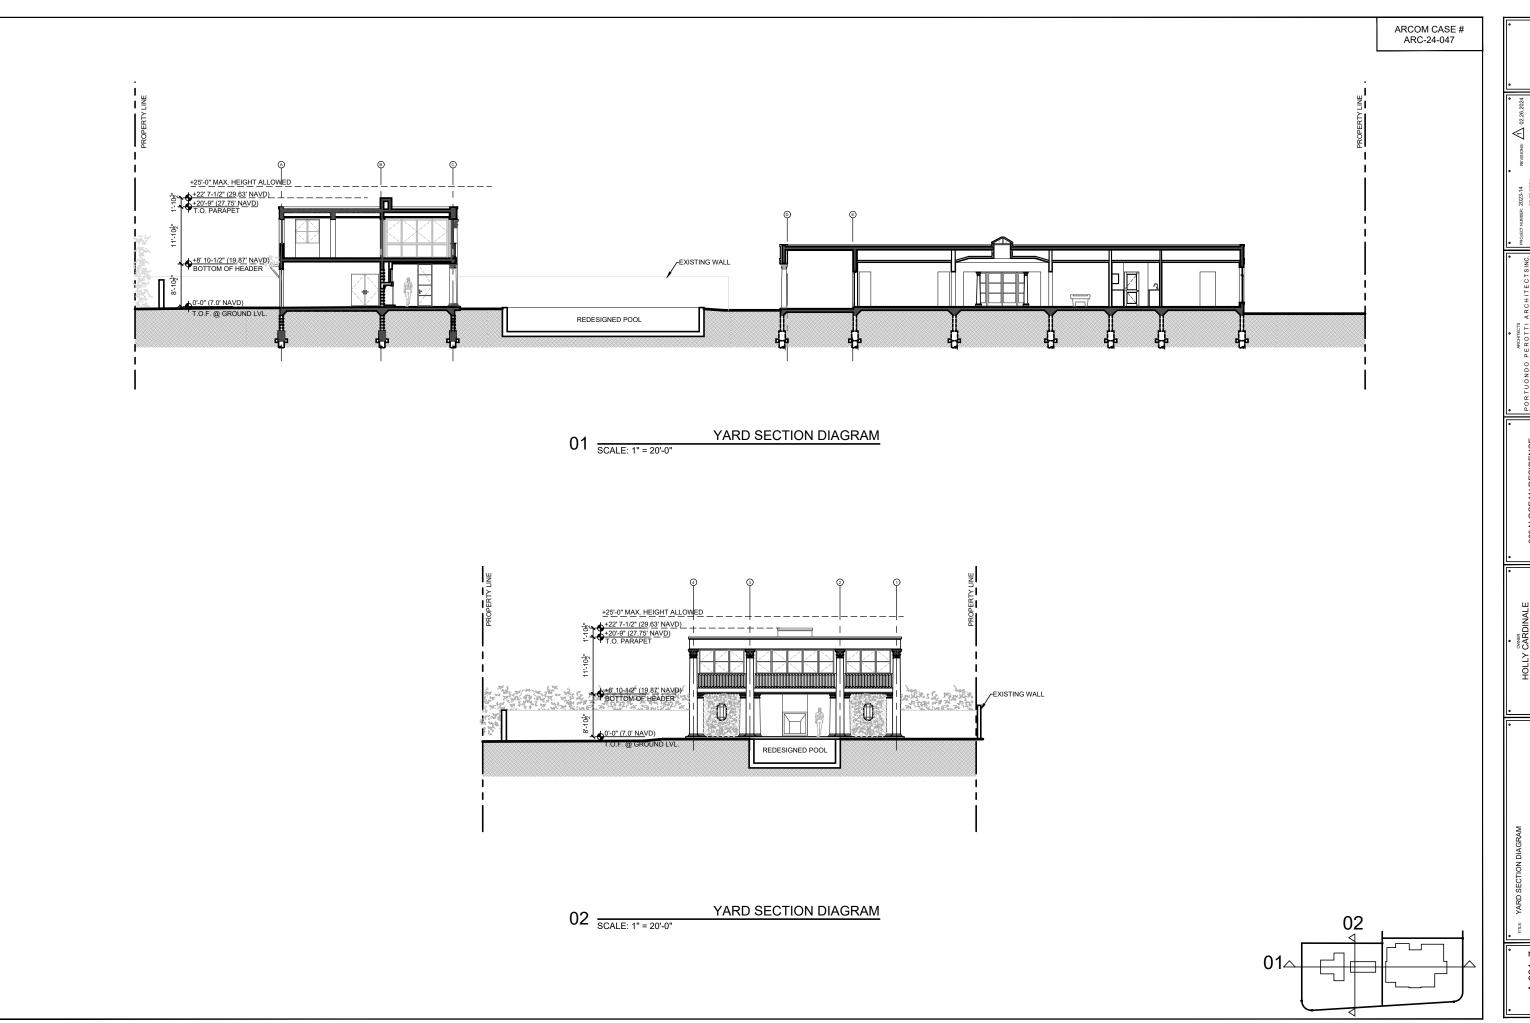



 \triangleleft 960 N OCEAN RESIDENCE A-001..7

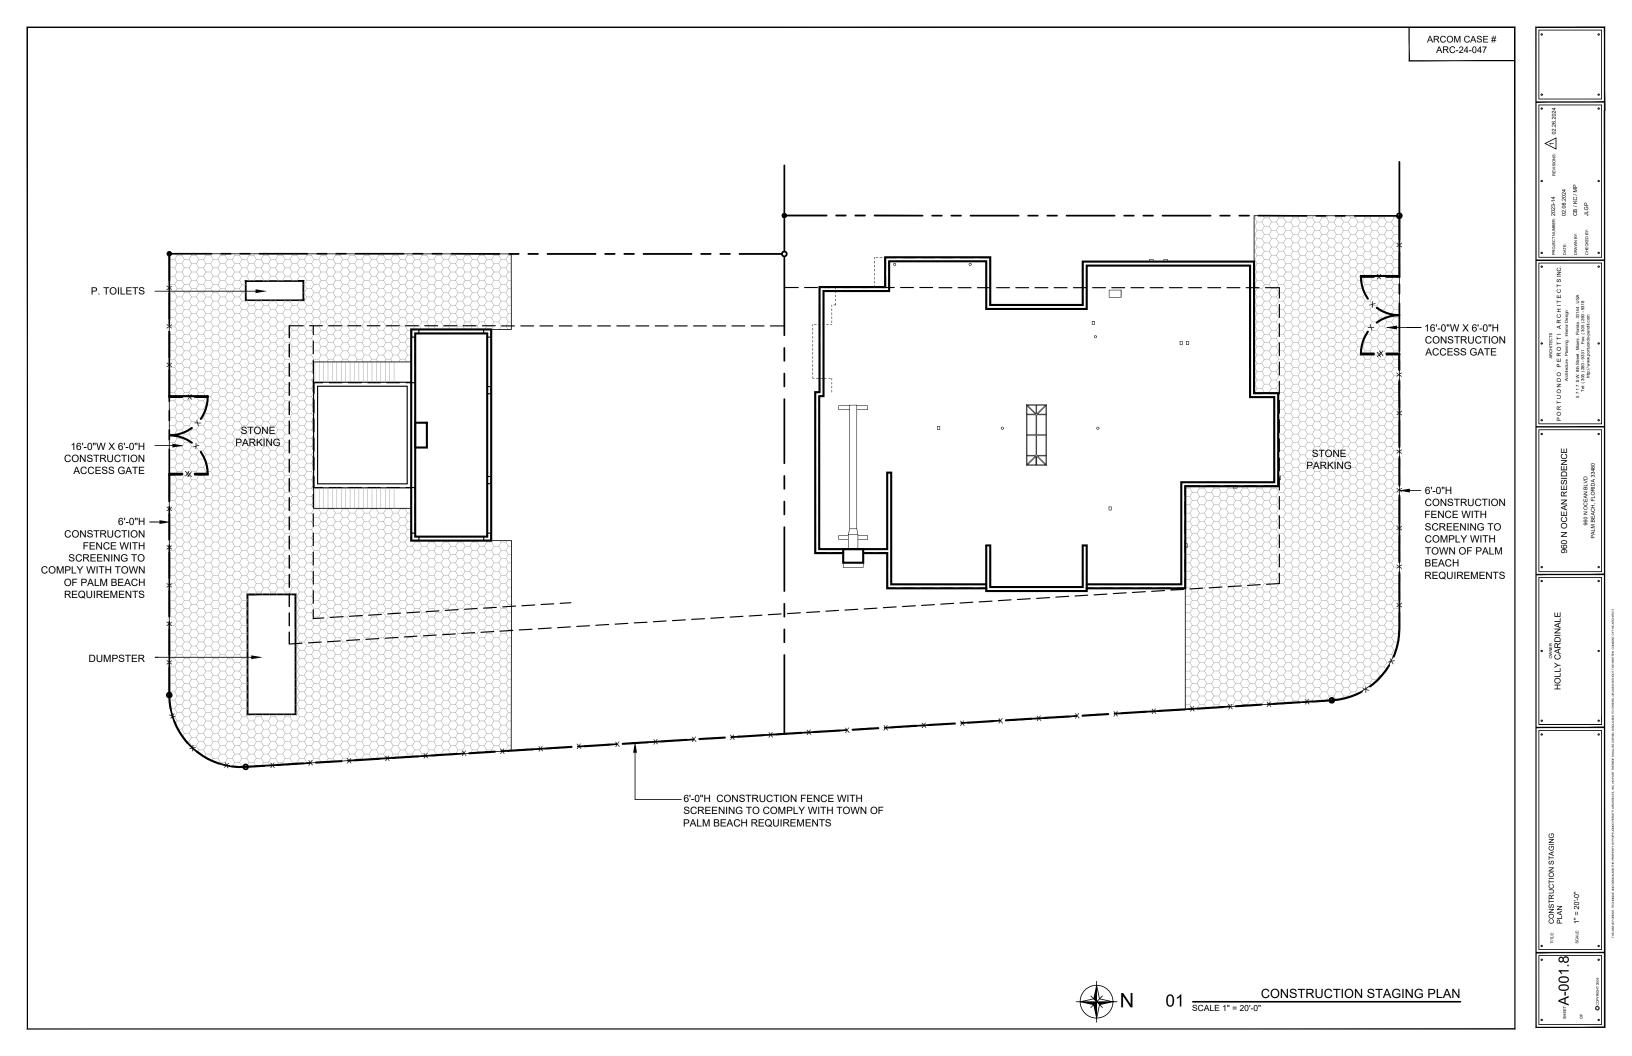


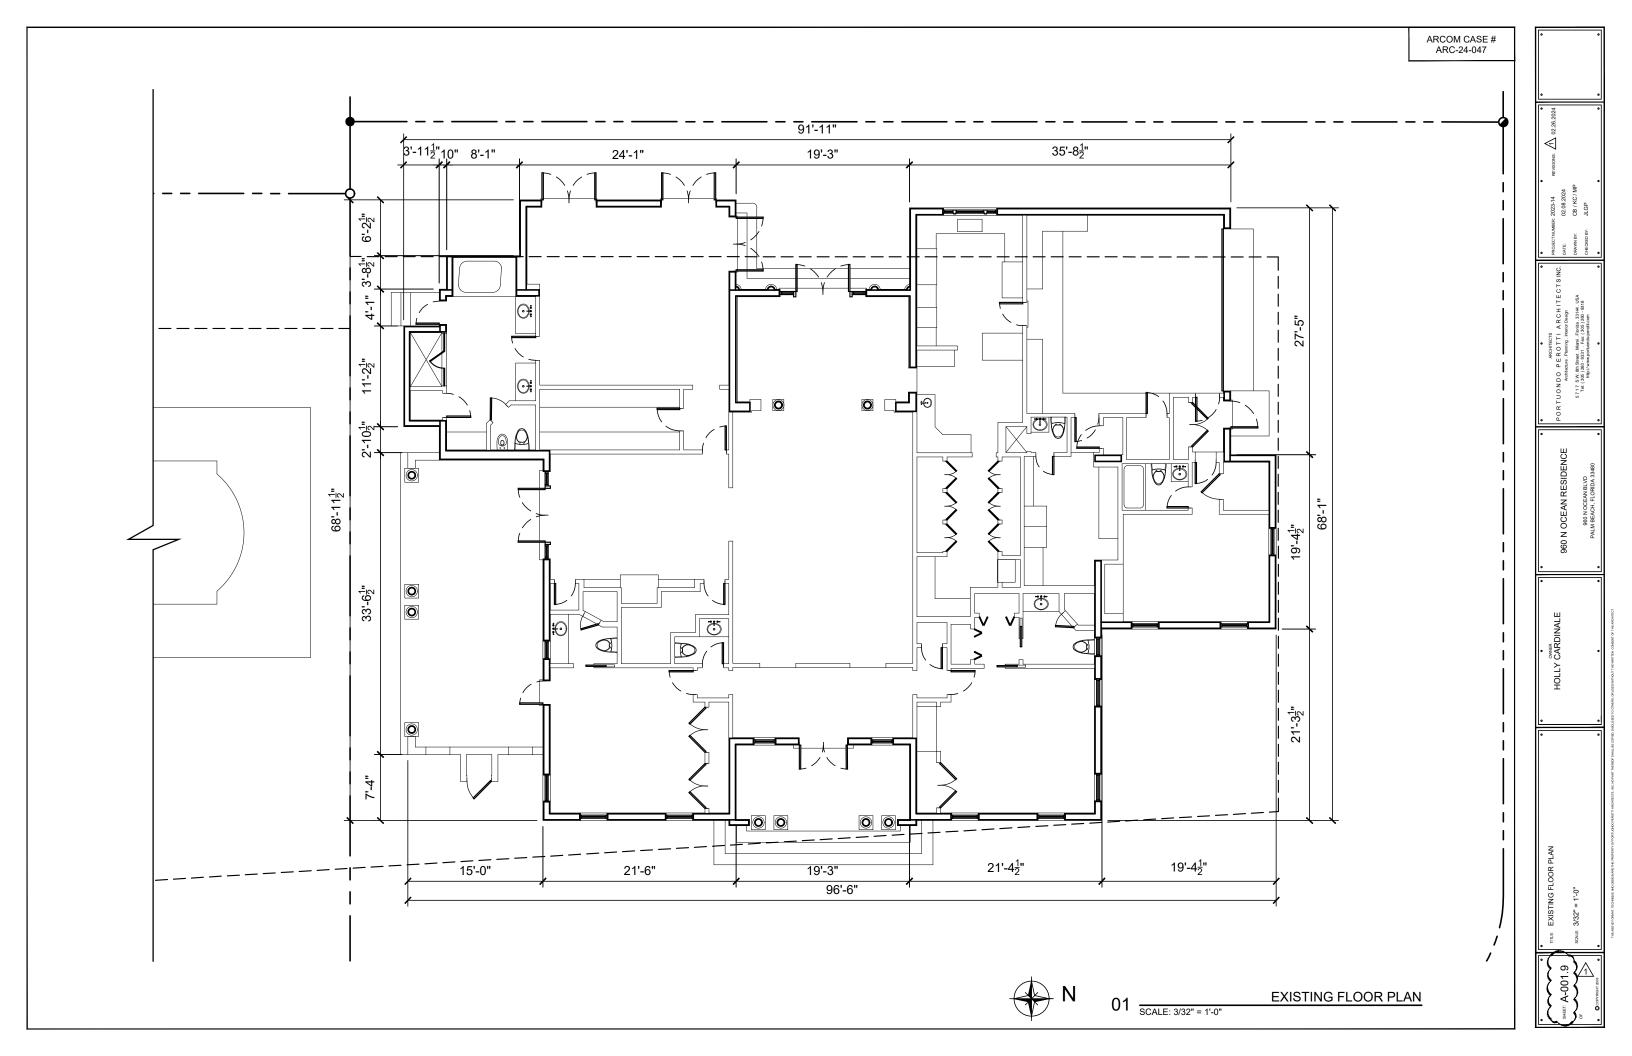


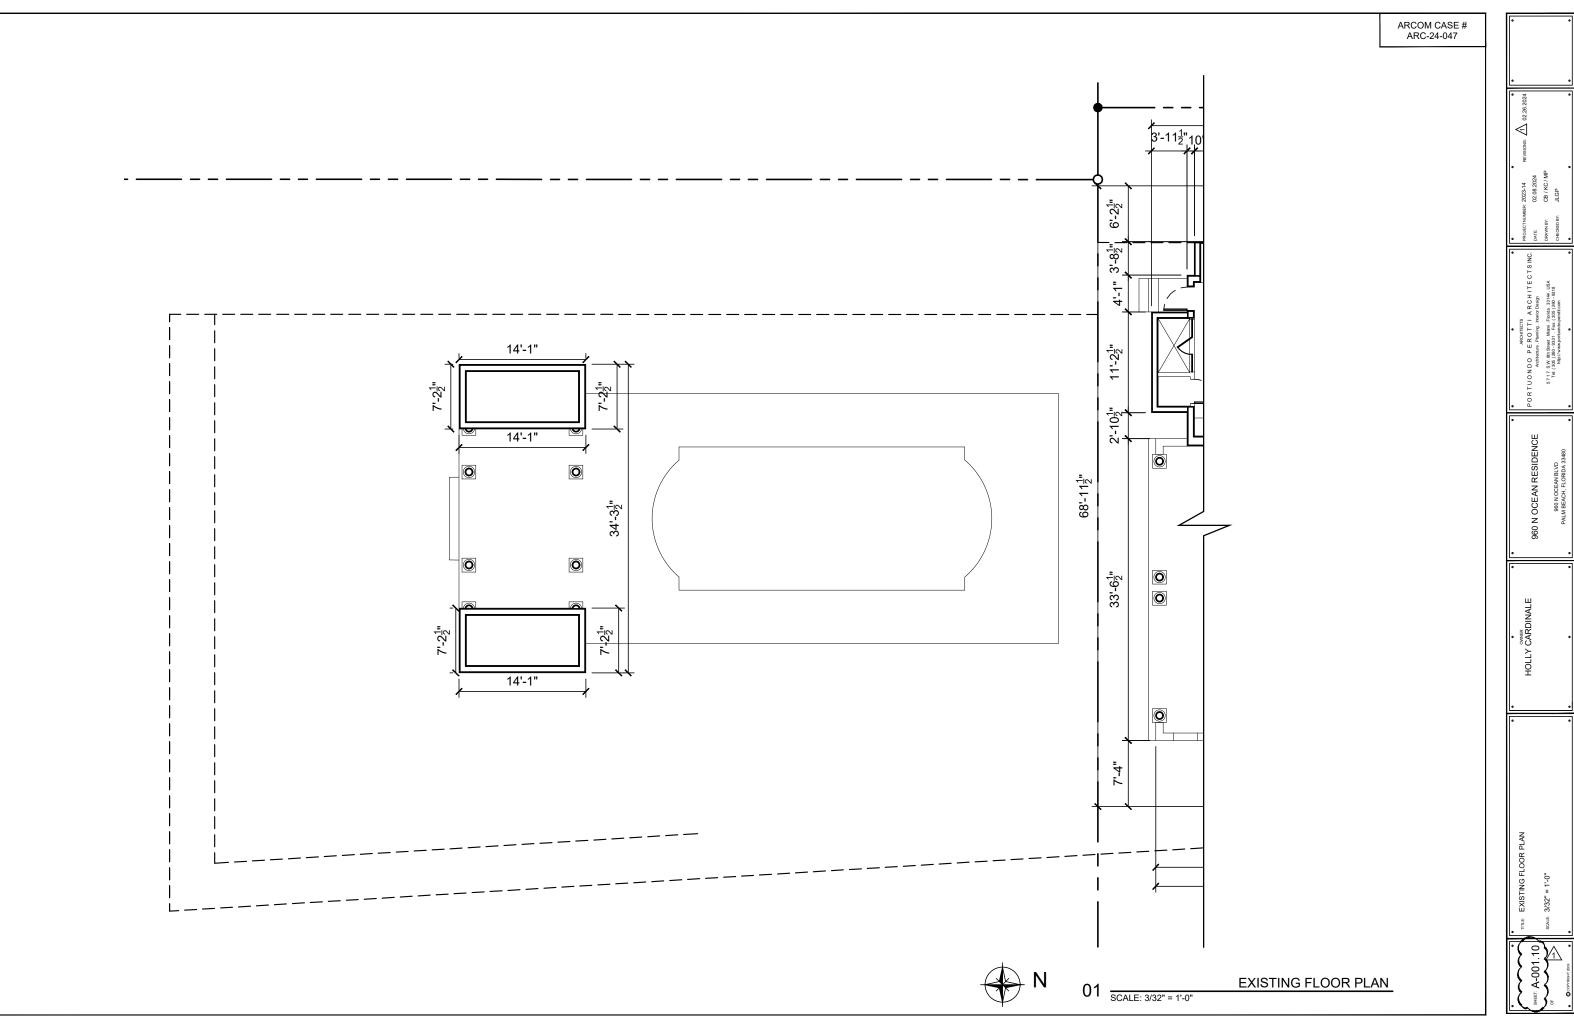

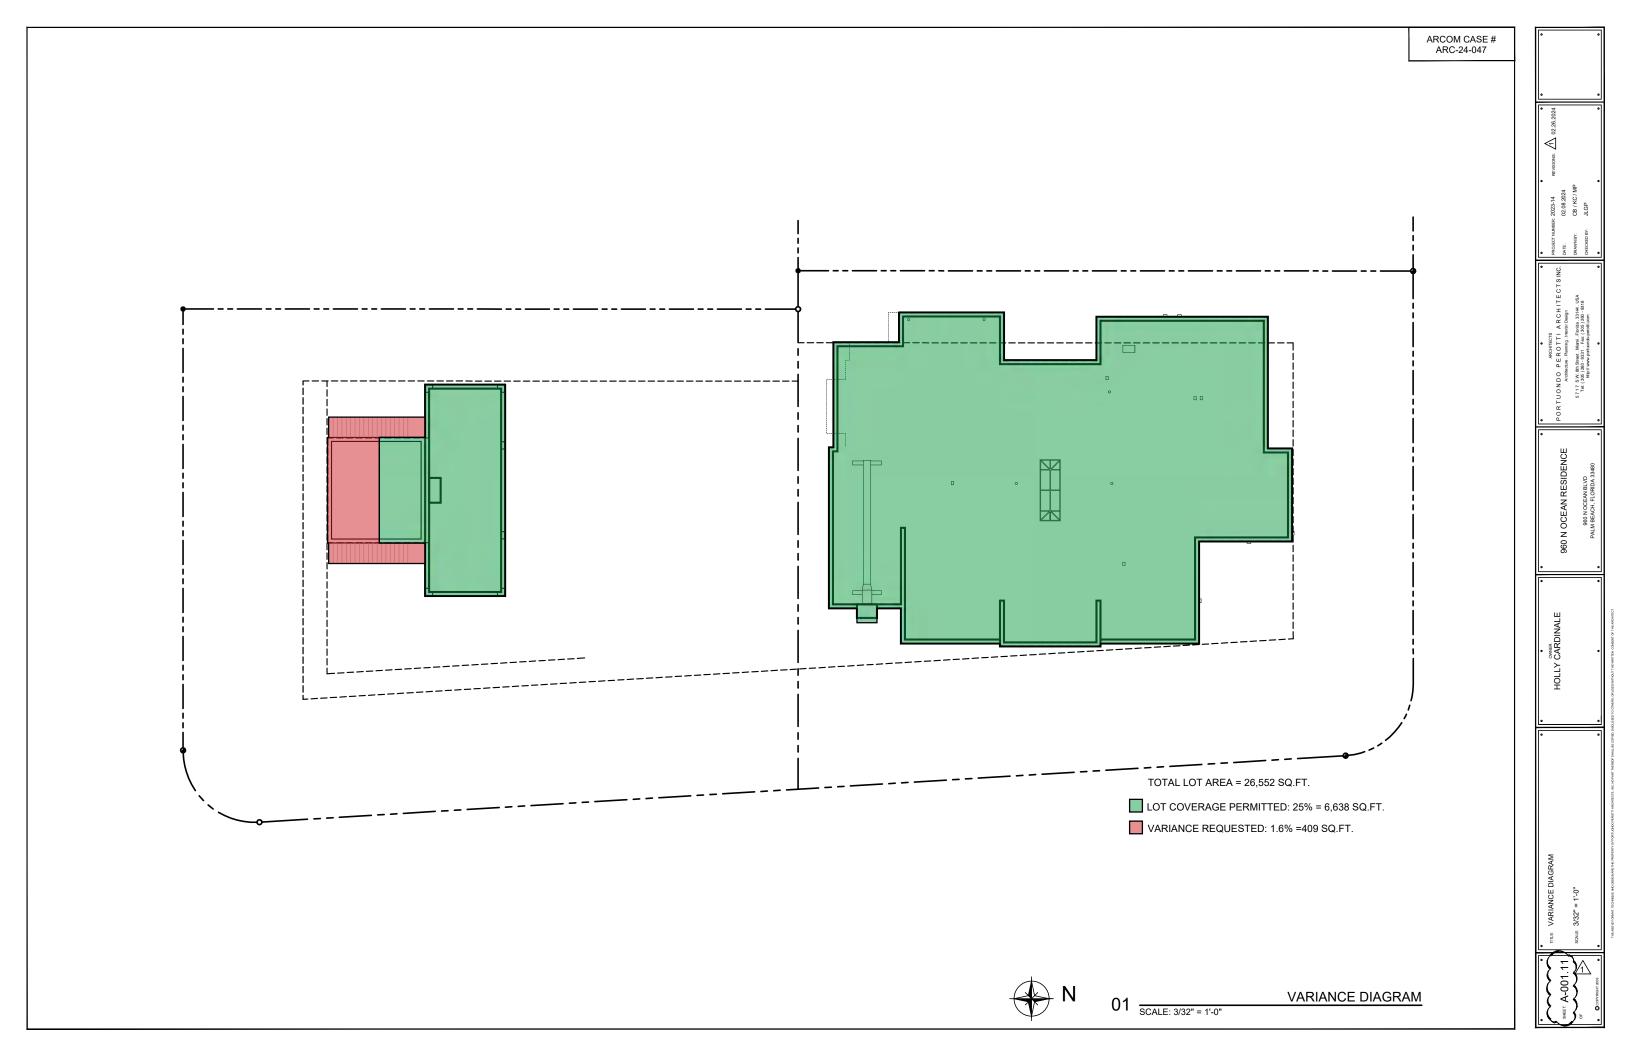

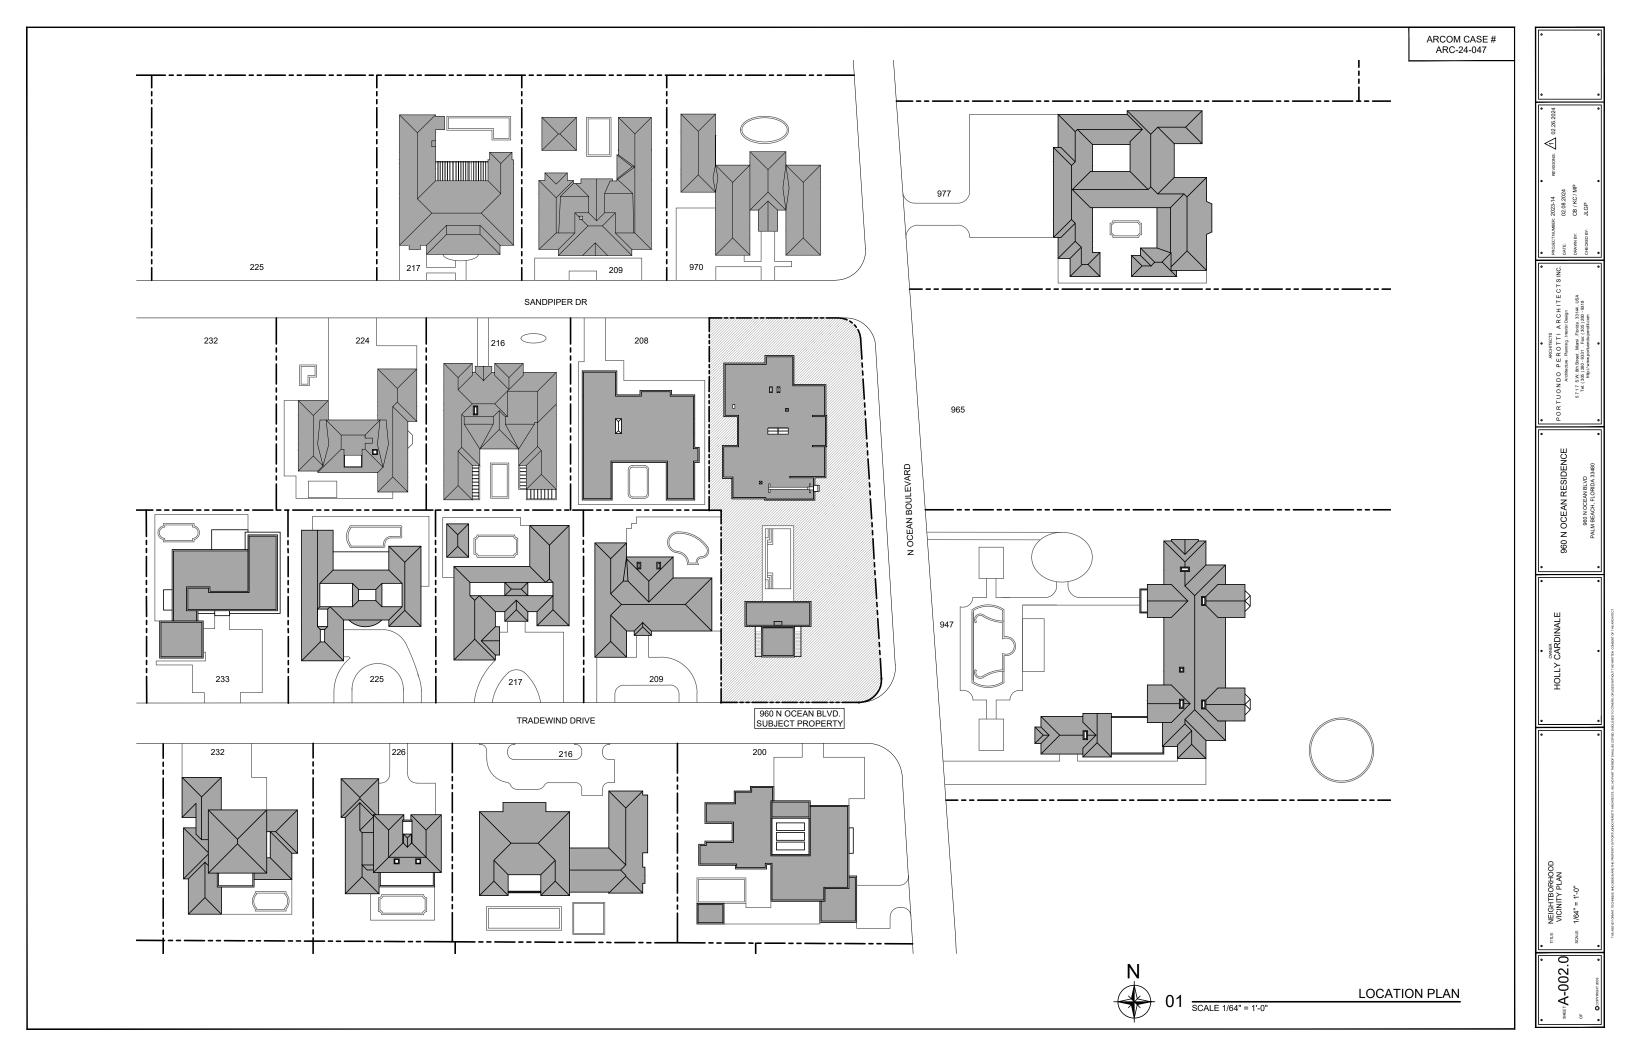

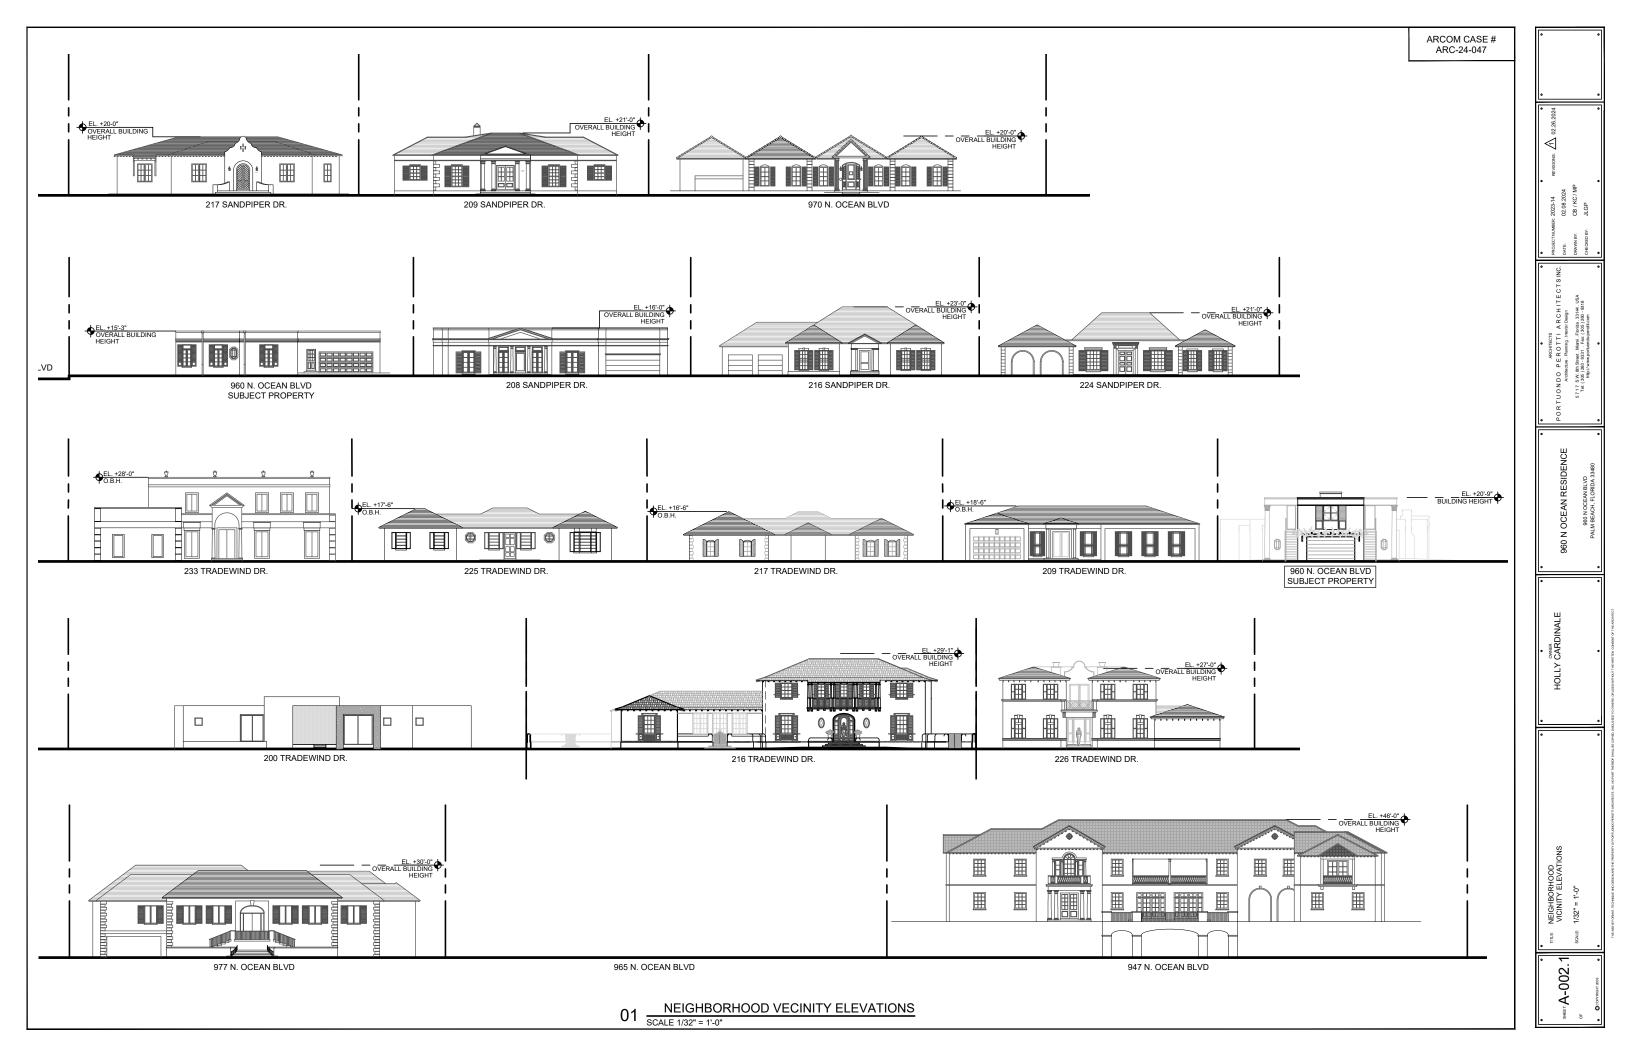

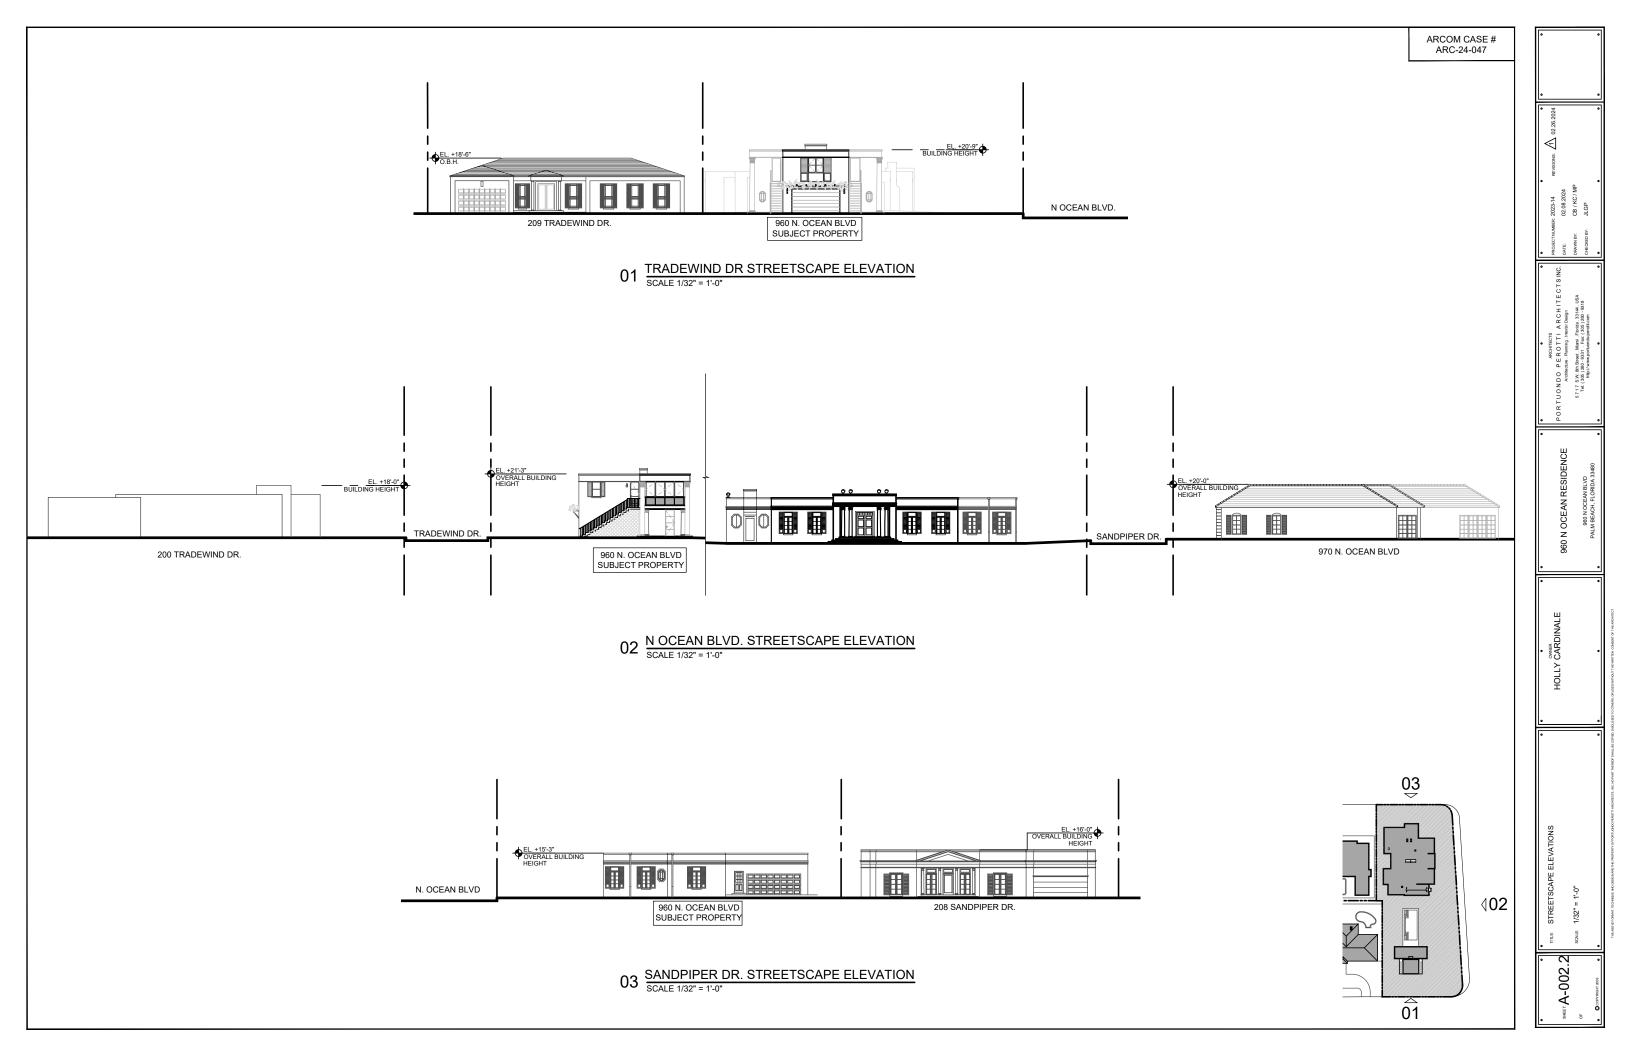

217 SANDPIPER DR



209 SANDPIPER DR



970 N OCEAN BLVD



208 SANDPIPER DR



216 SANDPIPER DR



224 SANDPIPER DR



225 TRADEWIND DR



217 TRADEWIND DR



209 TRADEWIND DR

ADJACENT RESIDENCES




200 TRADEWIND DR



216 TRADEWIND DR



226 TRADEWIND DR

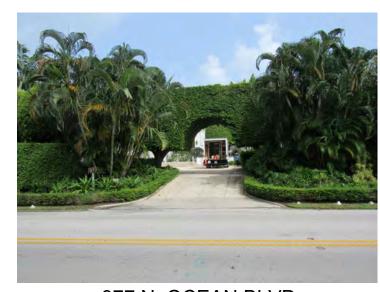

977 N OCEAN BLVD



965 N OCEAN BLVD



947 N OCEAN BLVD

жет.А-002.4



VIEW 01



VIEW 02




VIEW 03




VIEW 04




VIEW 05

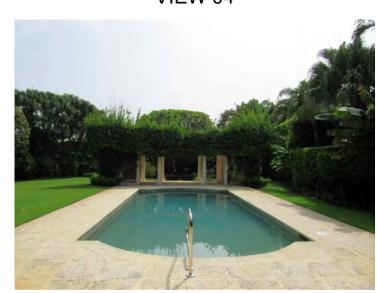

VIEW 06

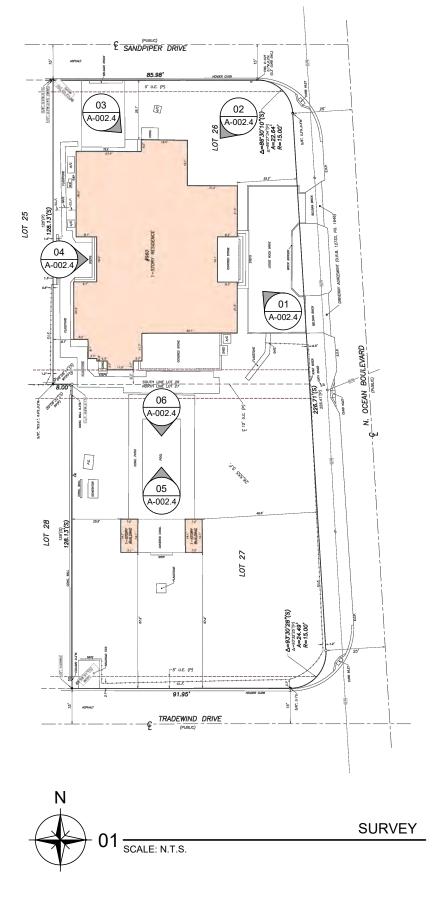

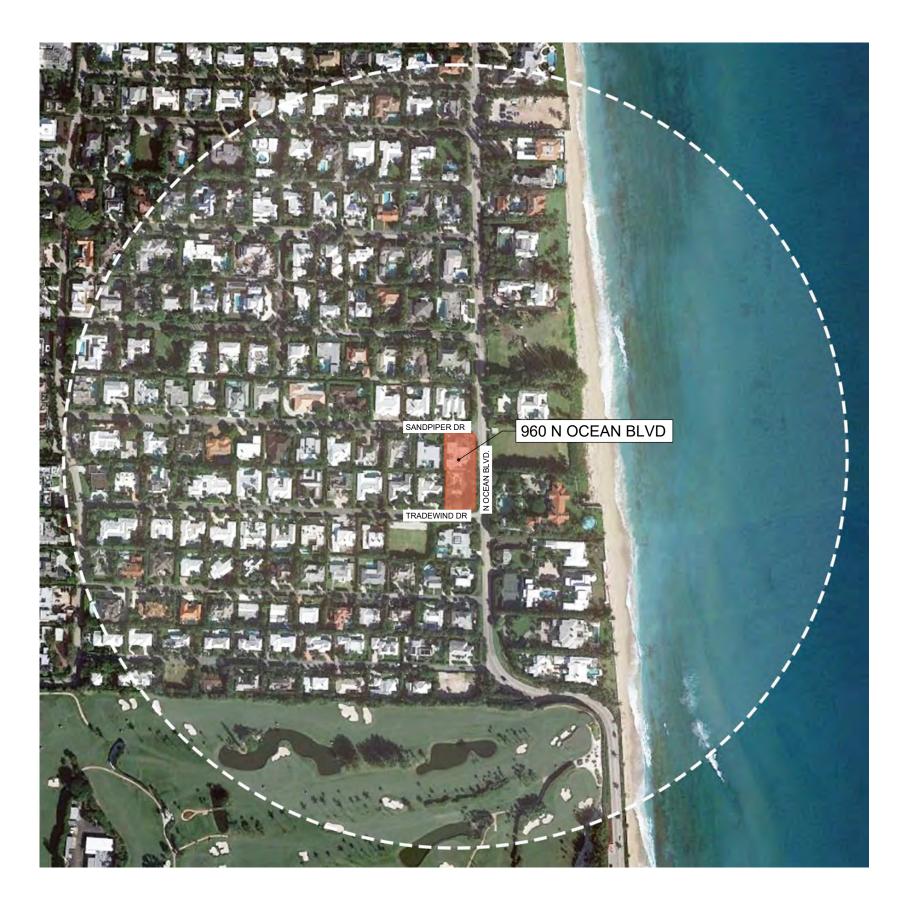



inde: VICINITY MAP

. энет.**А-002.6**


ROUGH SCHEDULE OF CONSTRUCTION


TRUCK LOGISTIC PLAN




960 N OCEAN RESIDENCE


энег.А-003

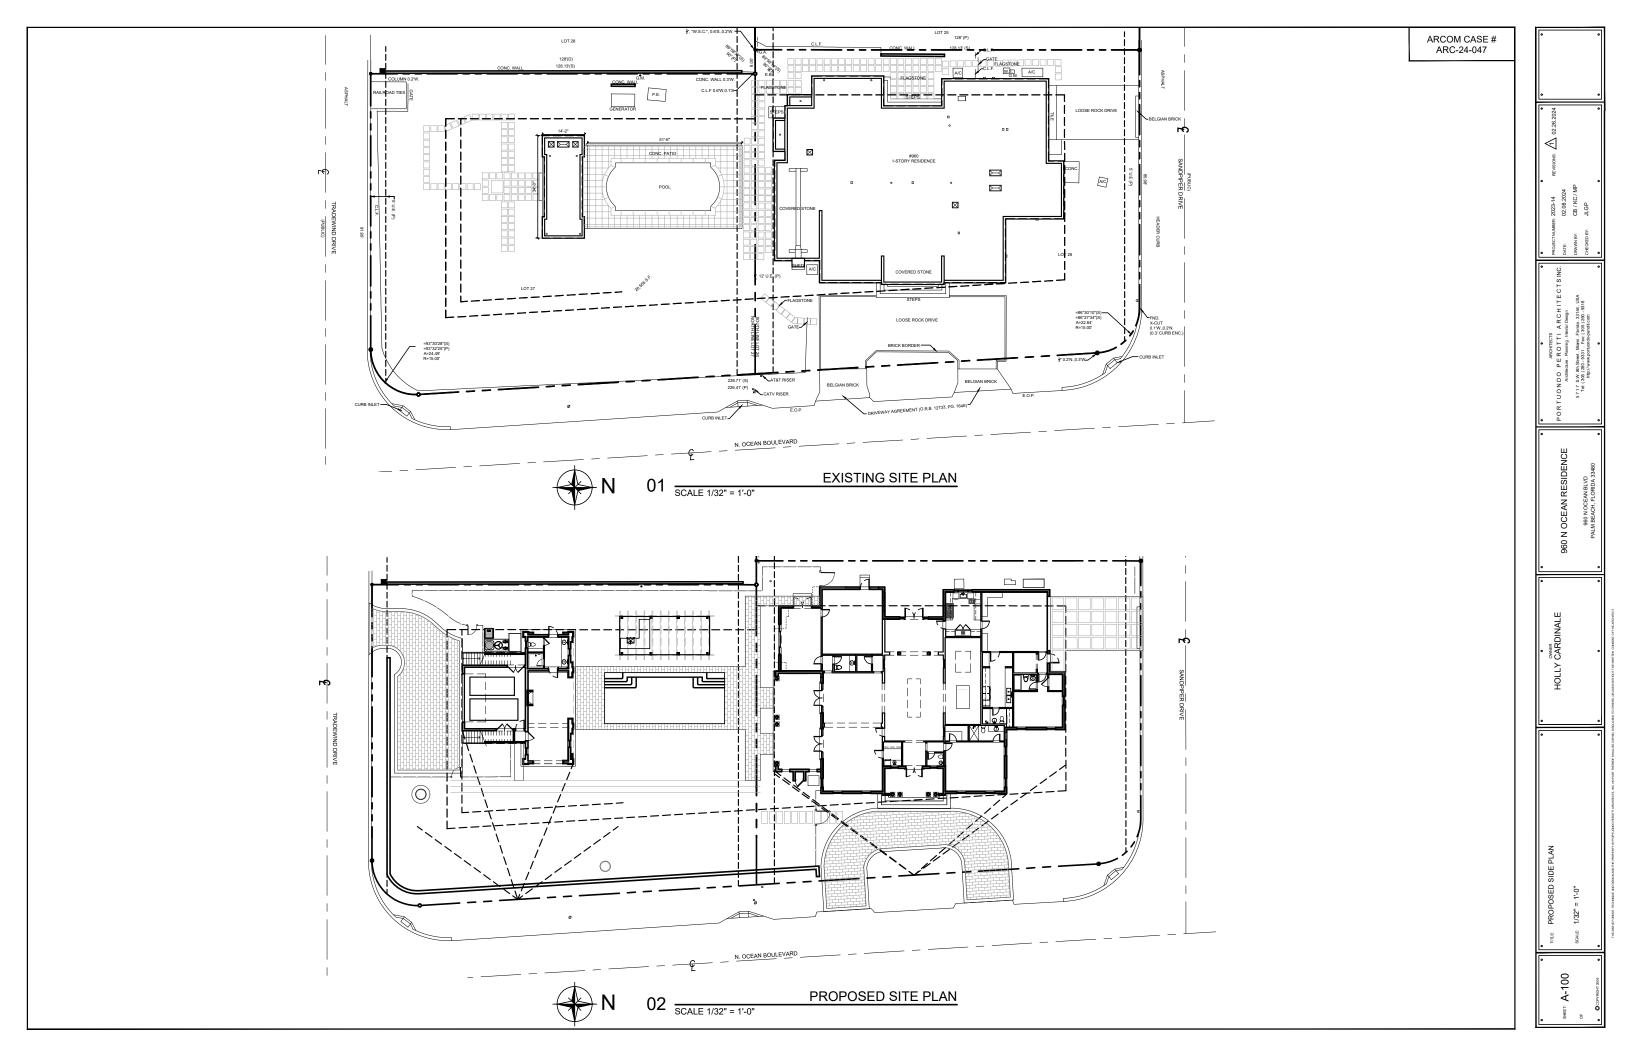


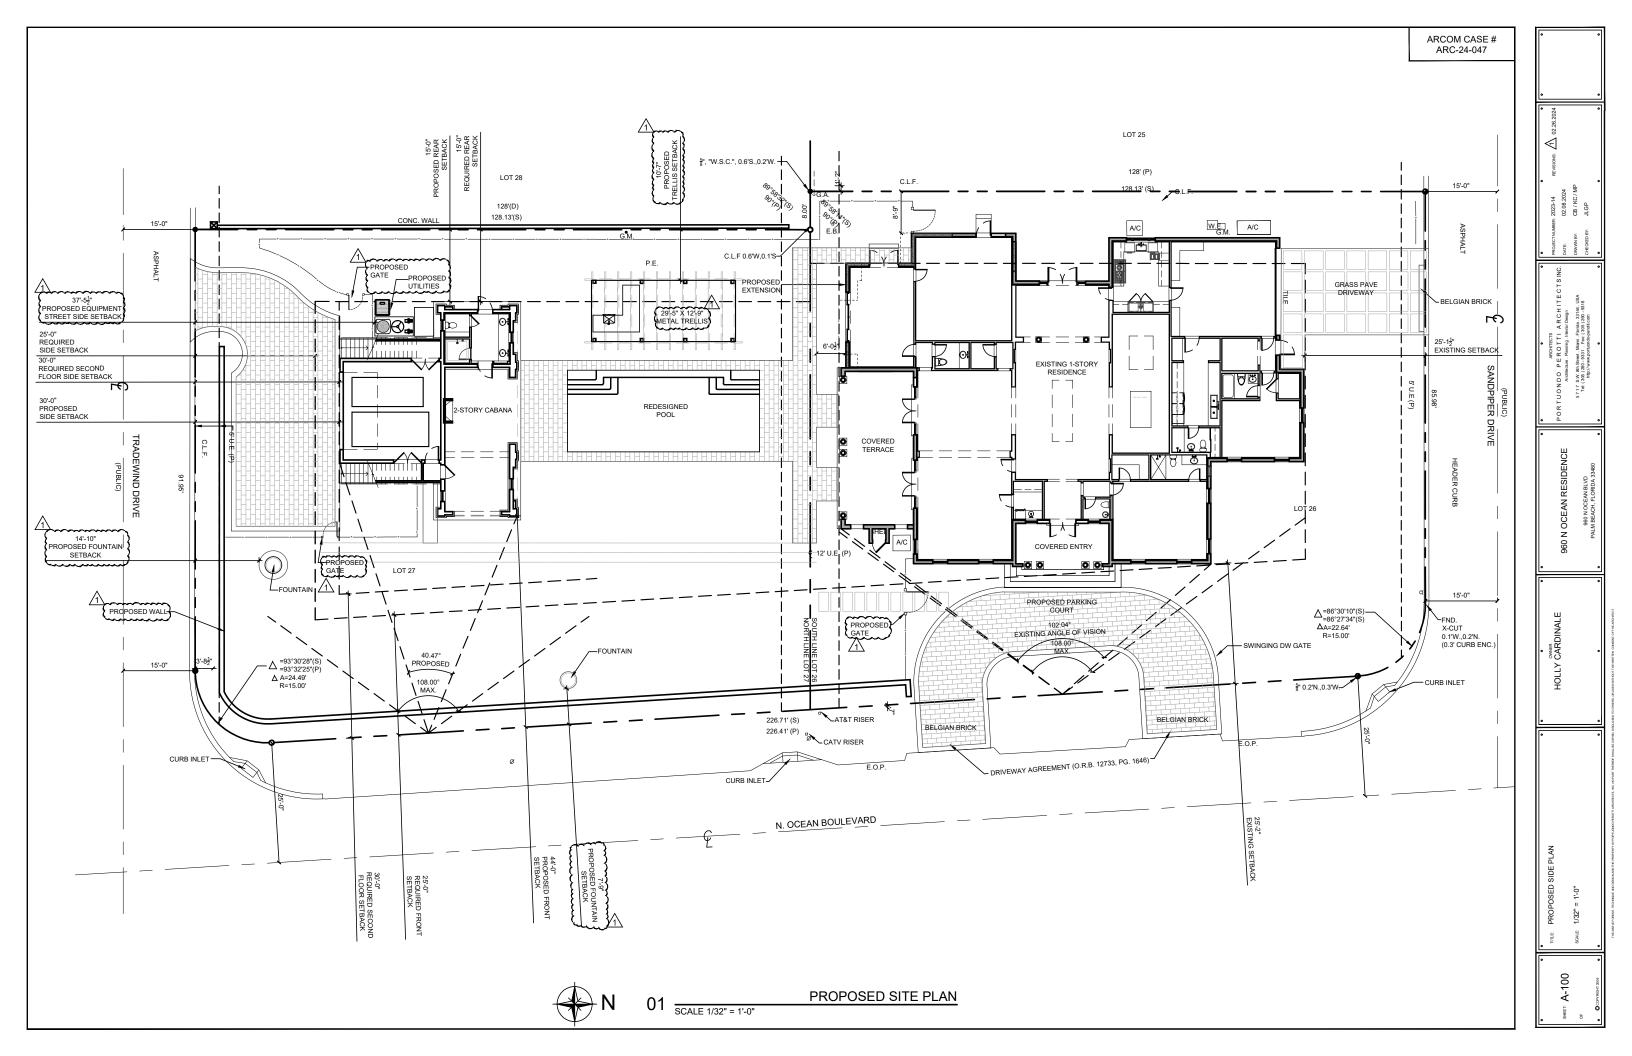

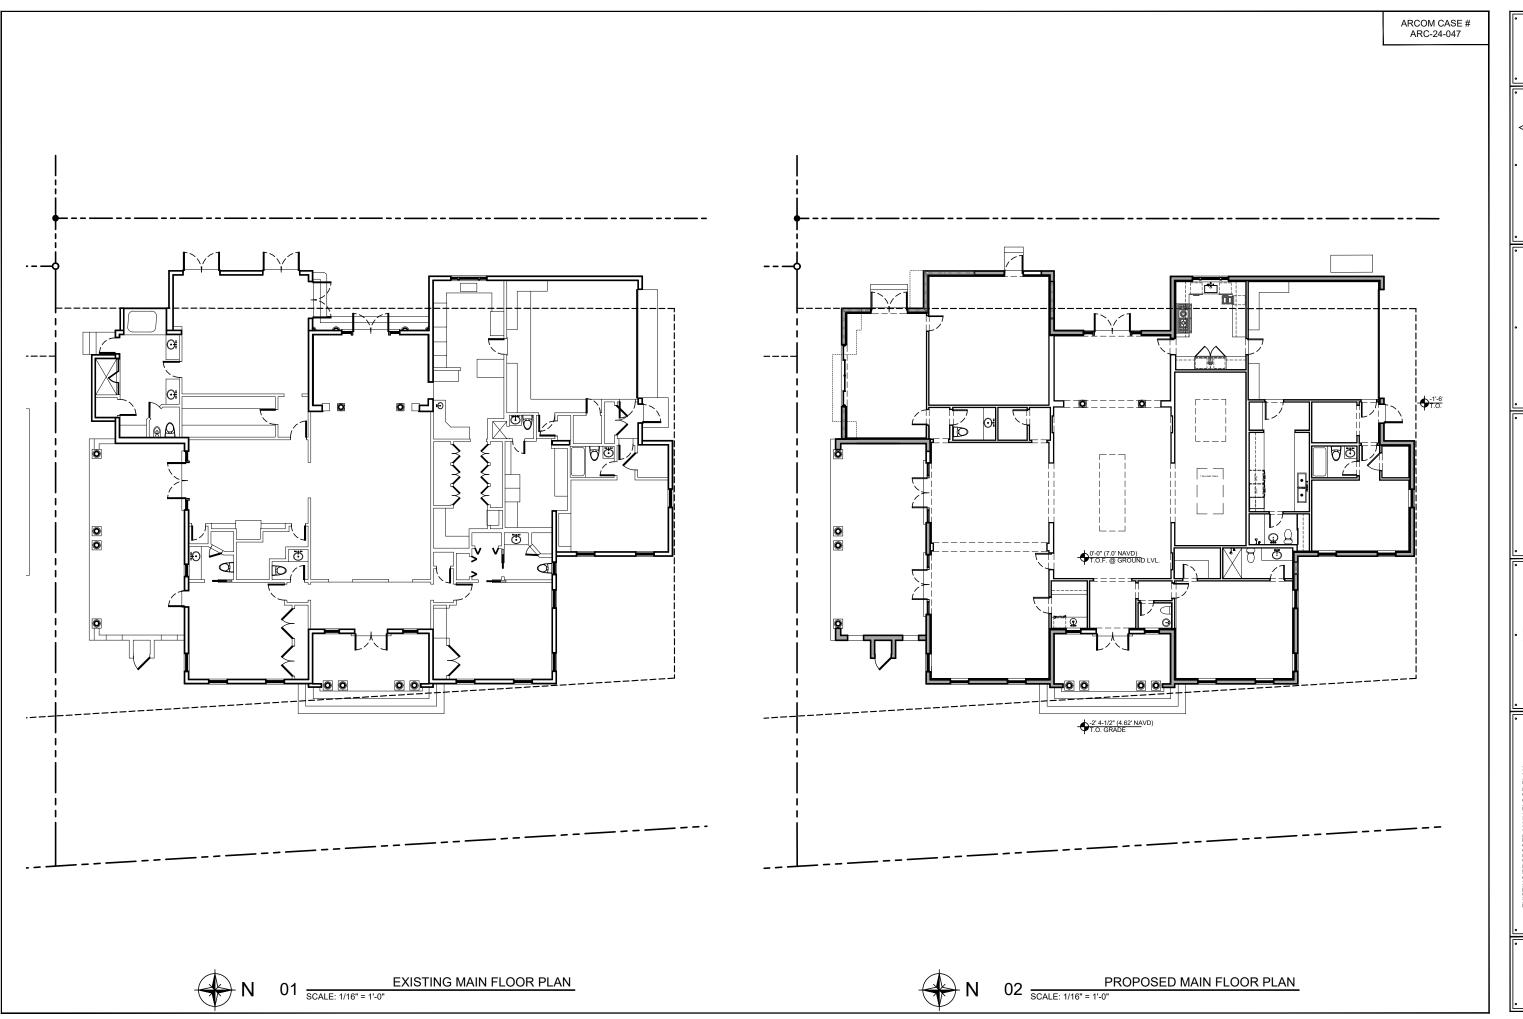



™A-101

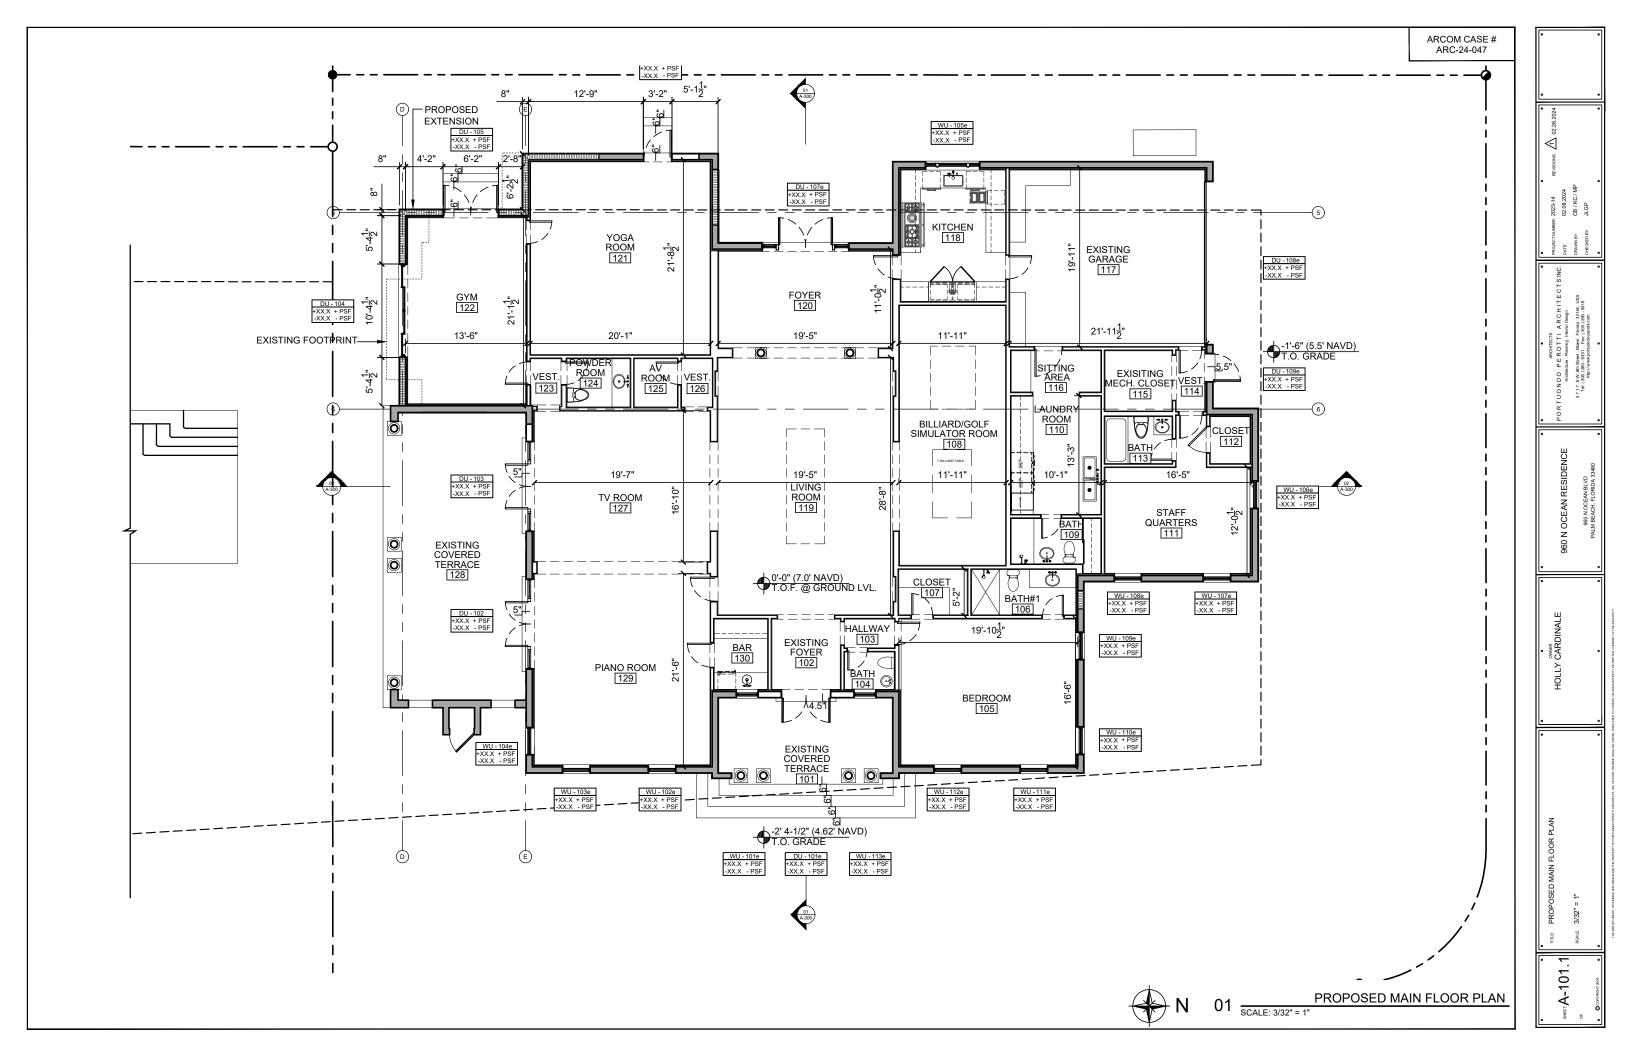


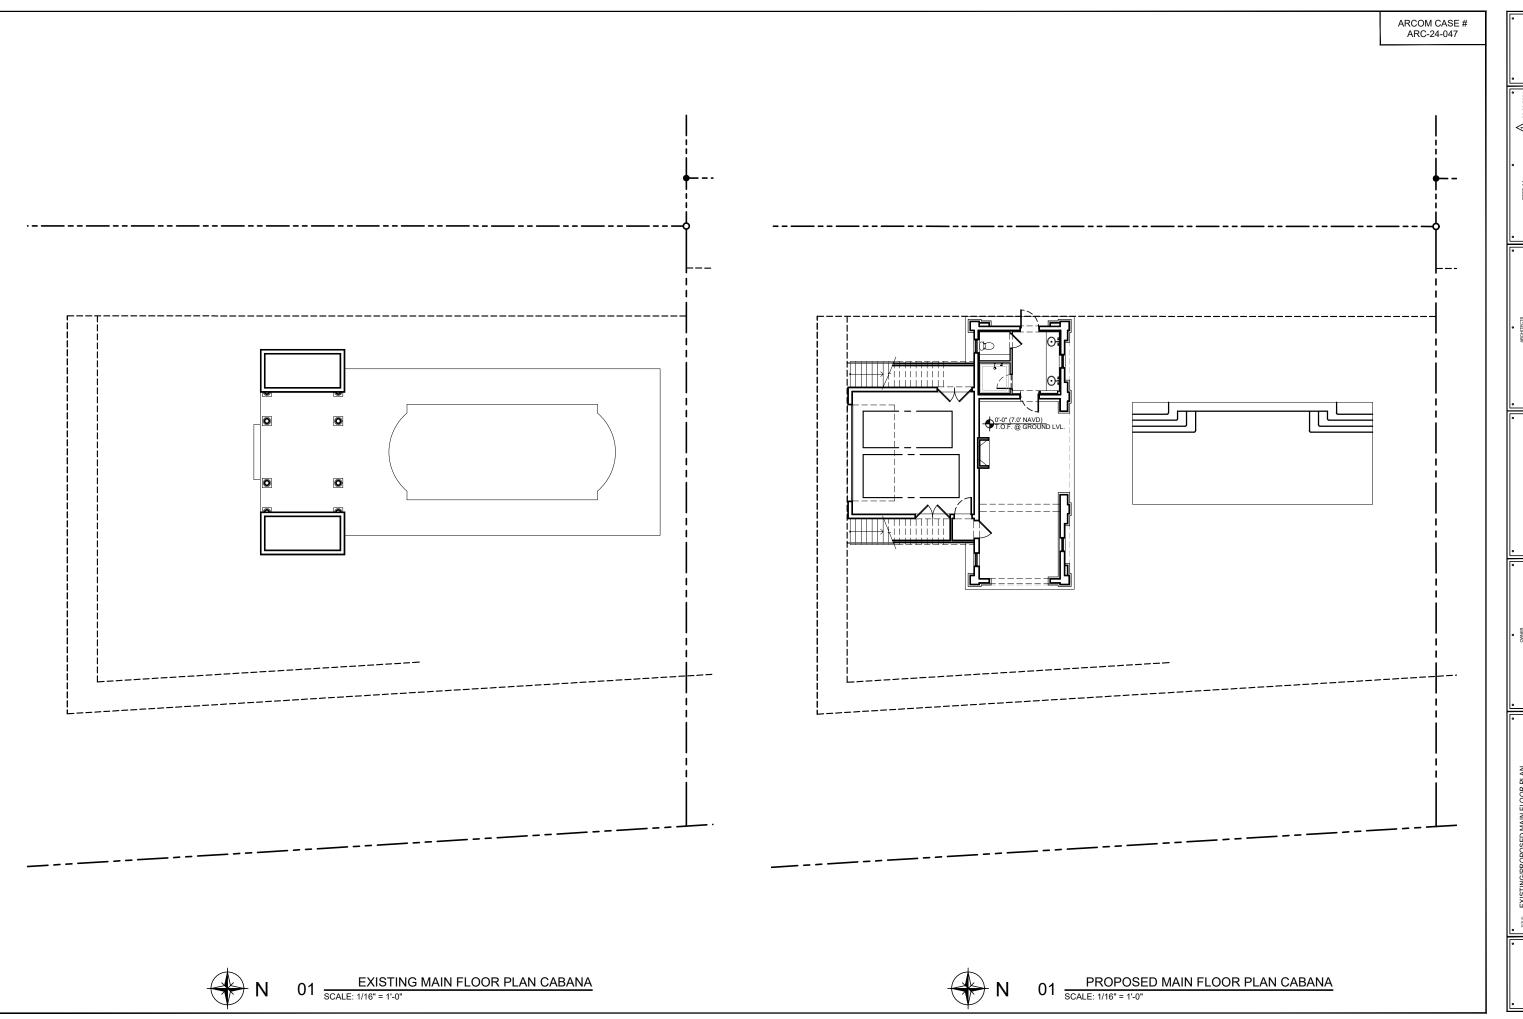

"A-101.2

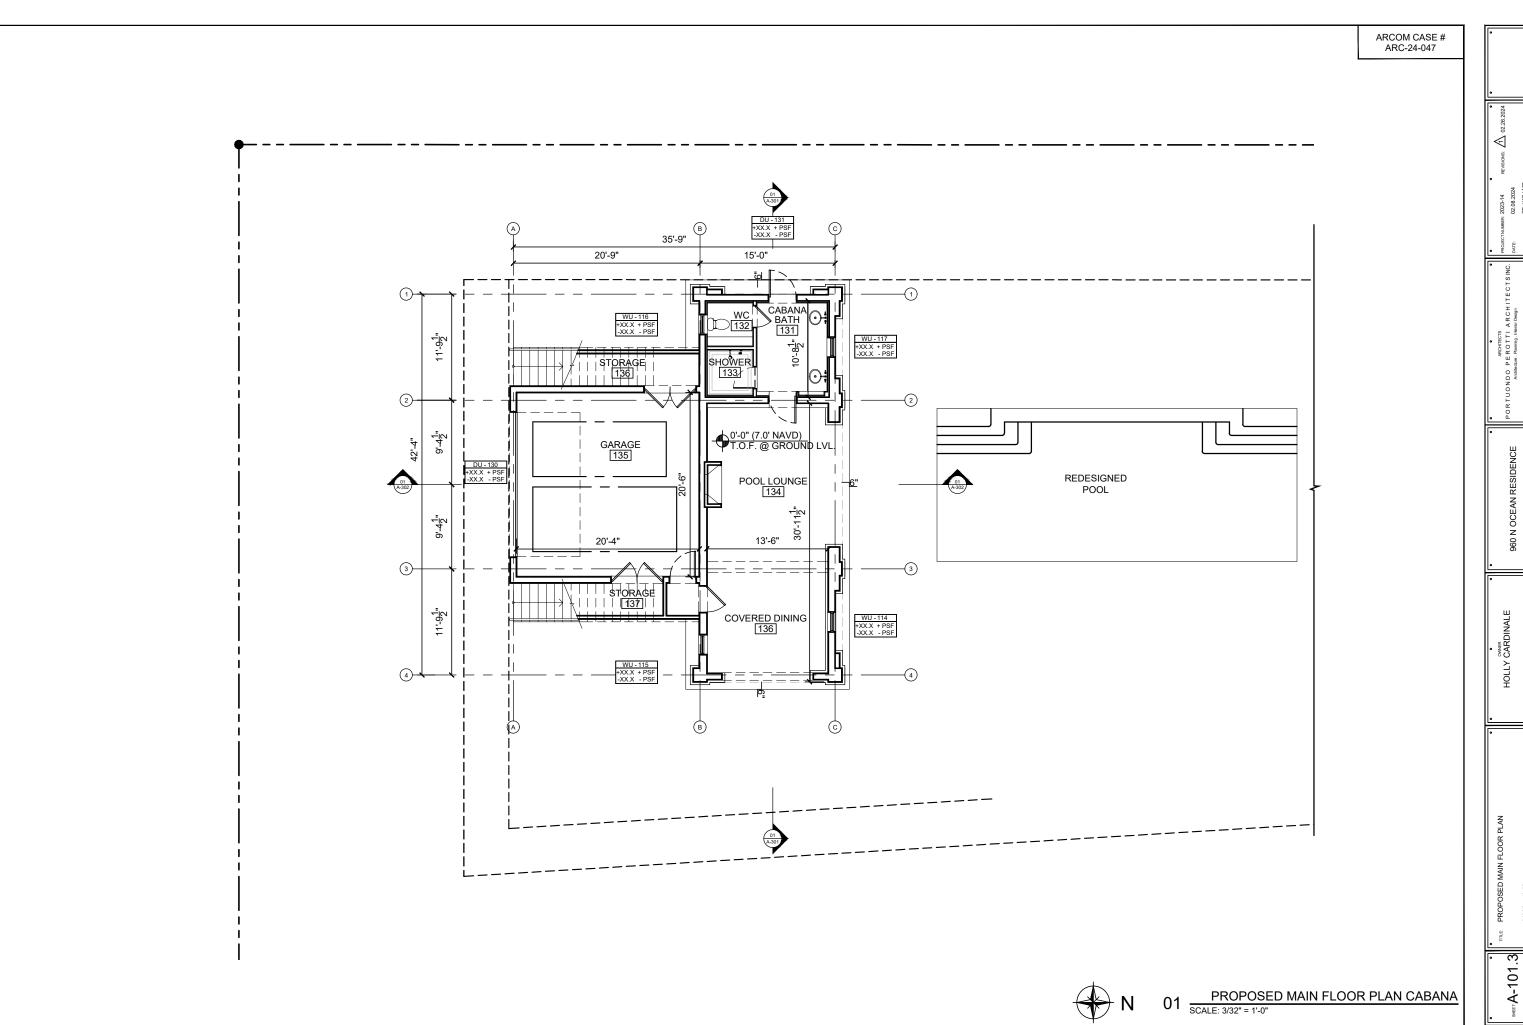


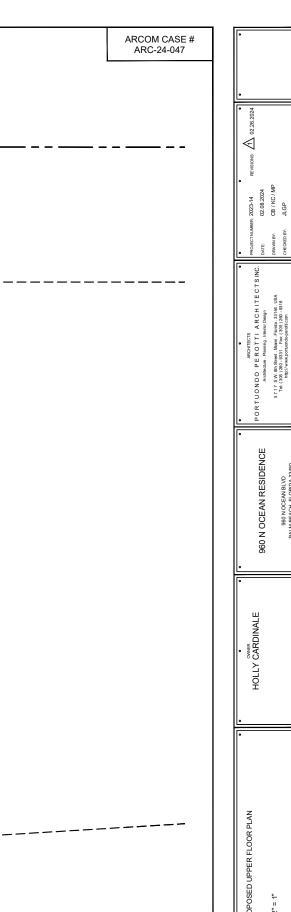

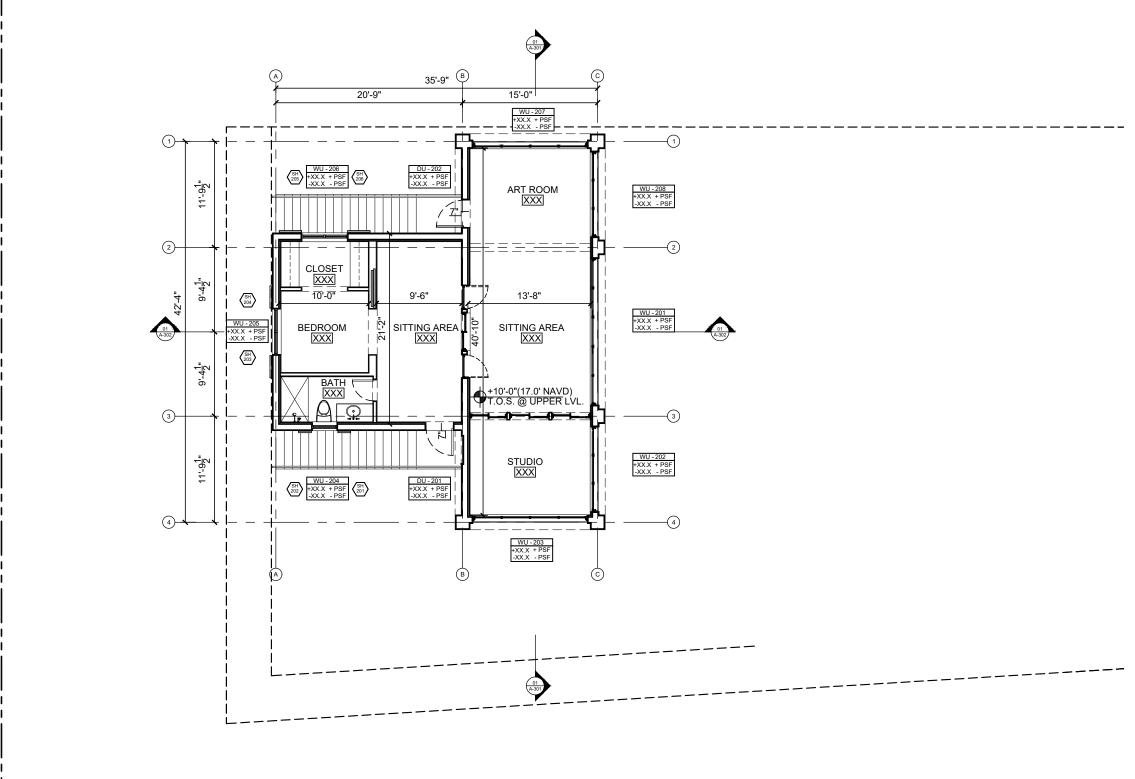



01 PROPOSED UPPER FLOOR PLAN (CABANA)
SCALE: 3/32" = 1"

энет,А-102

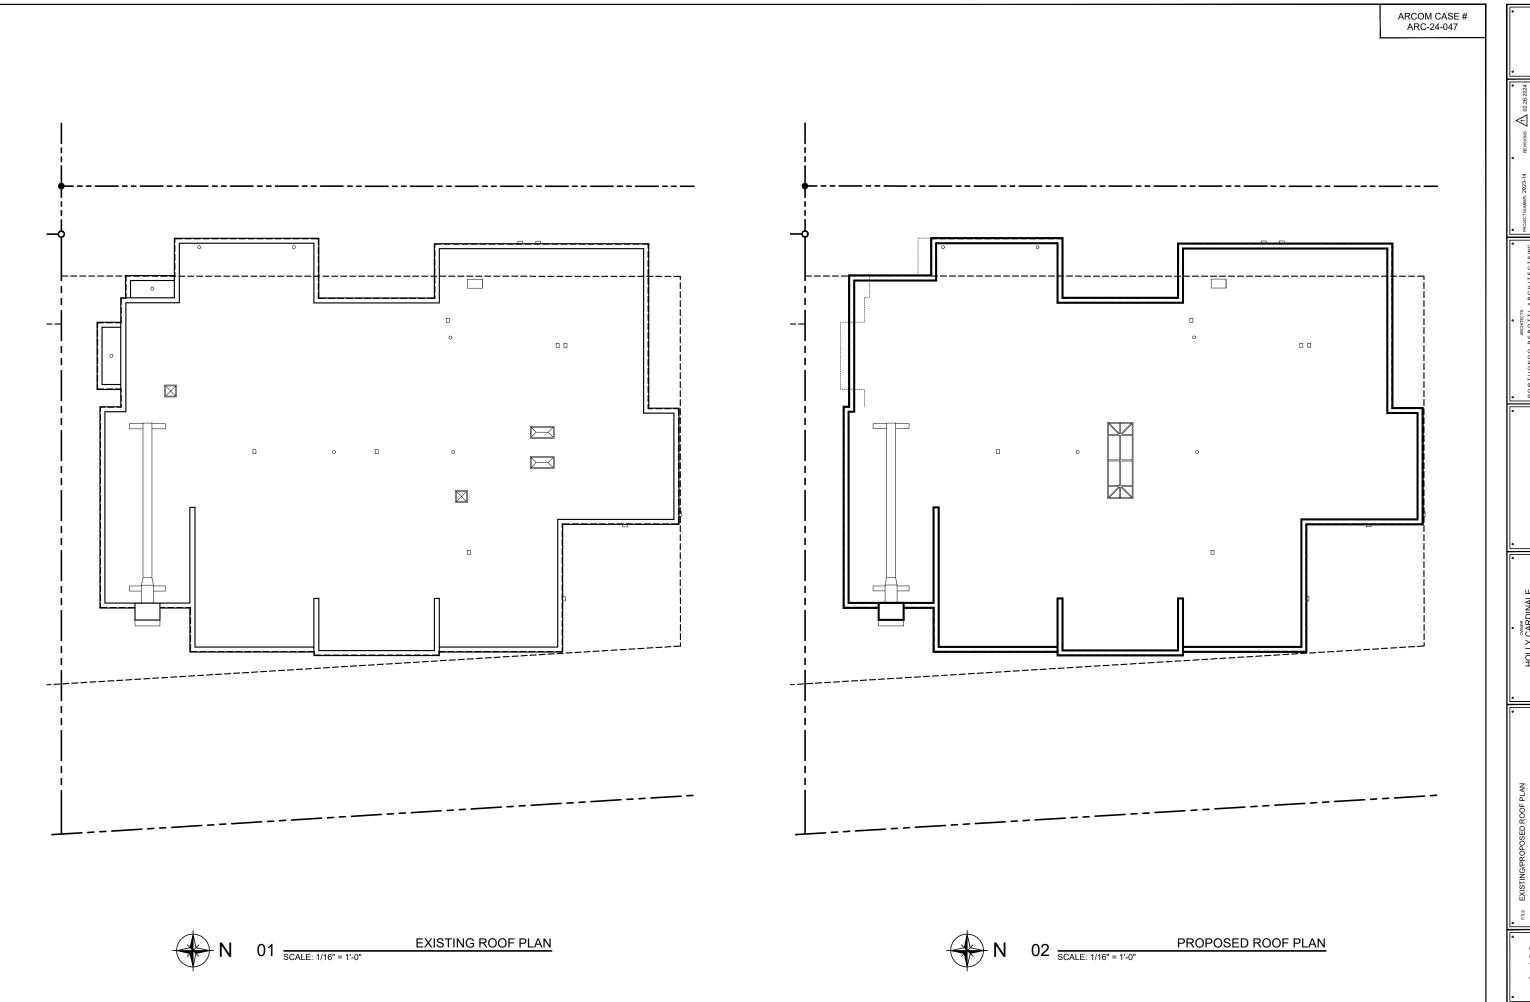



[□]A-103

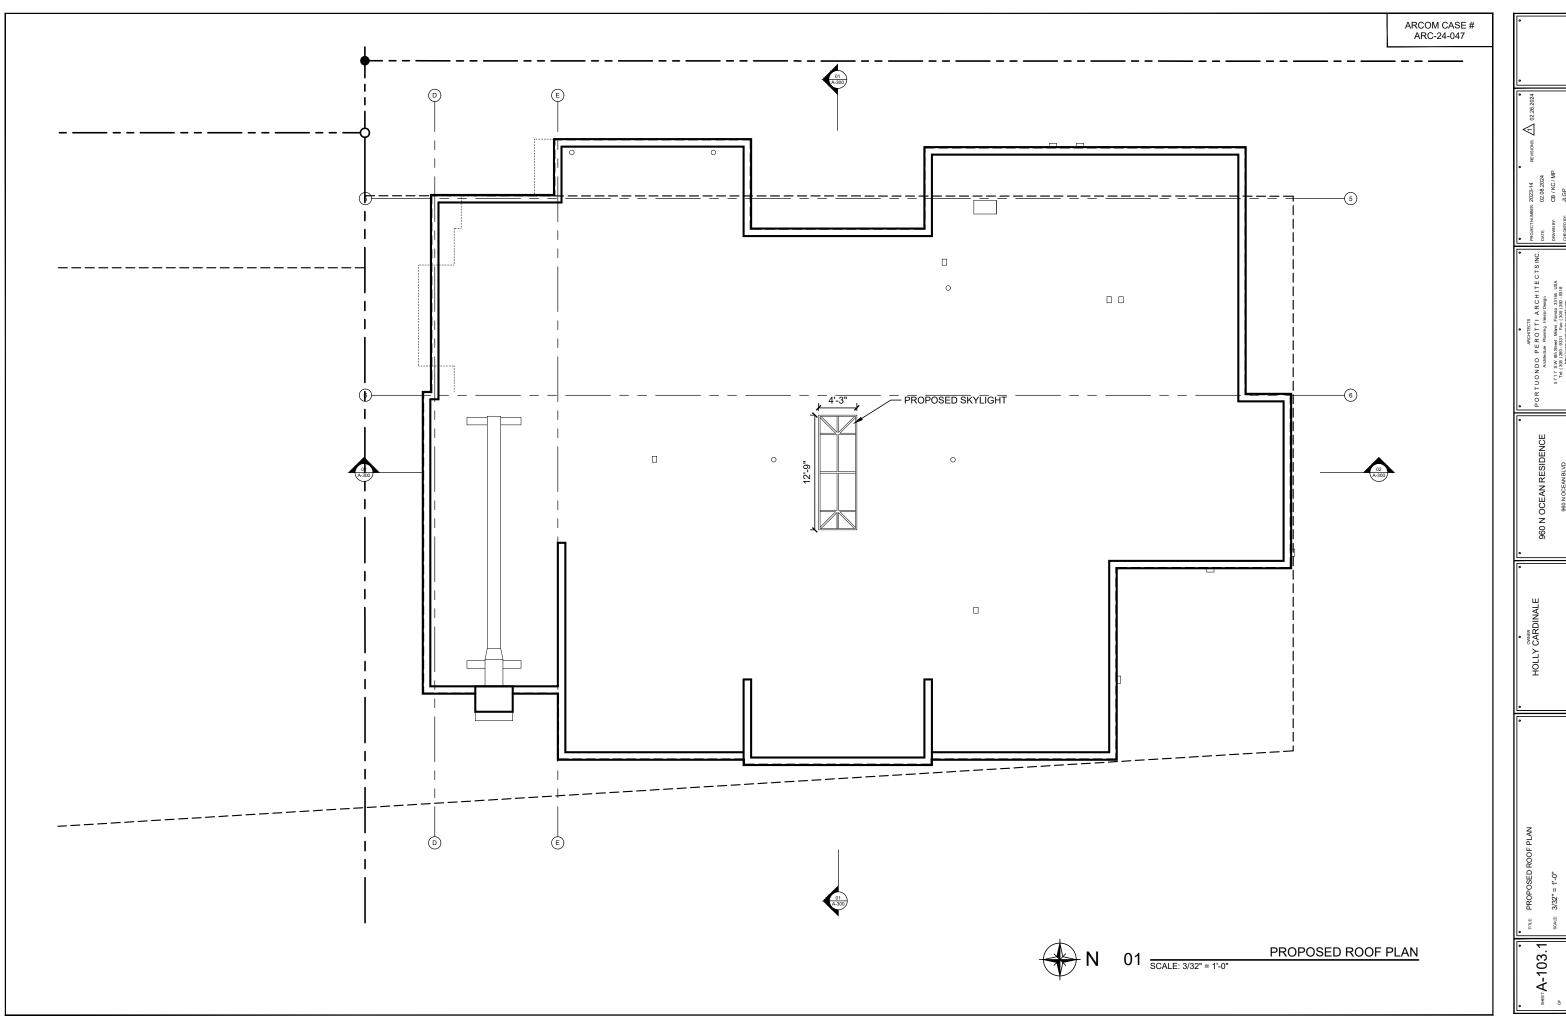

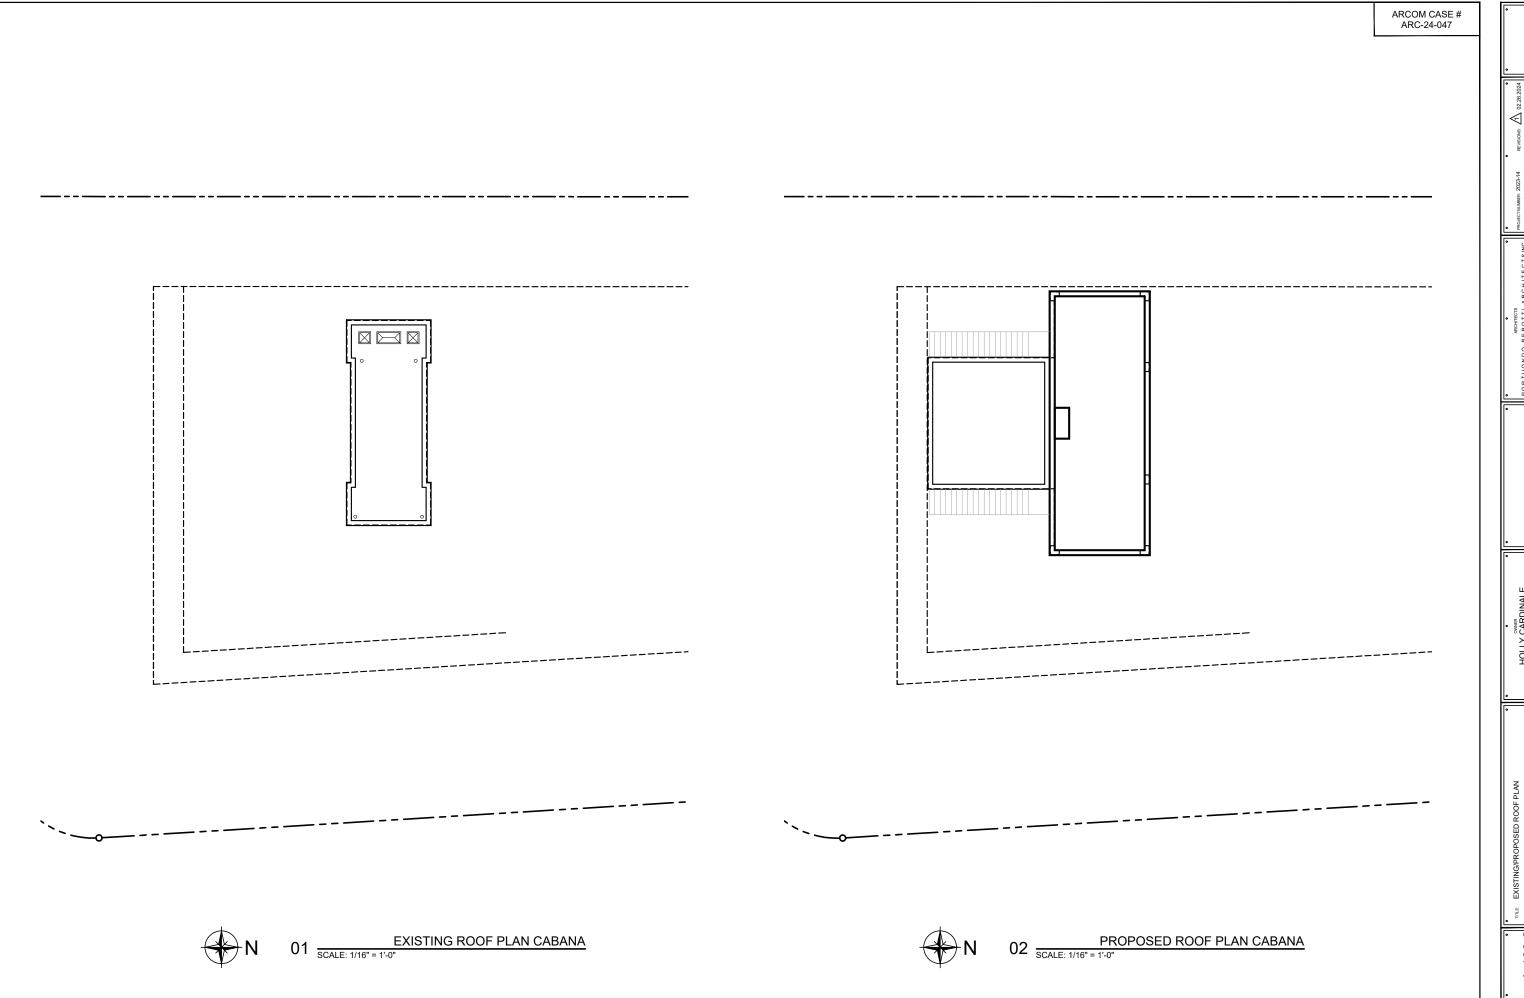



-A-103.2

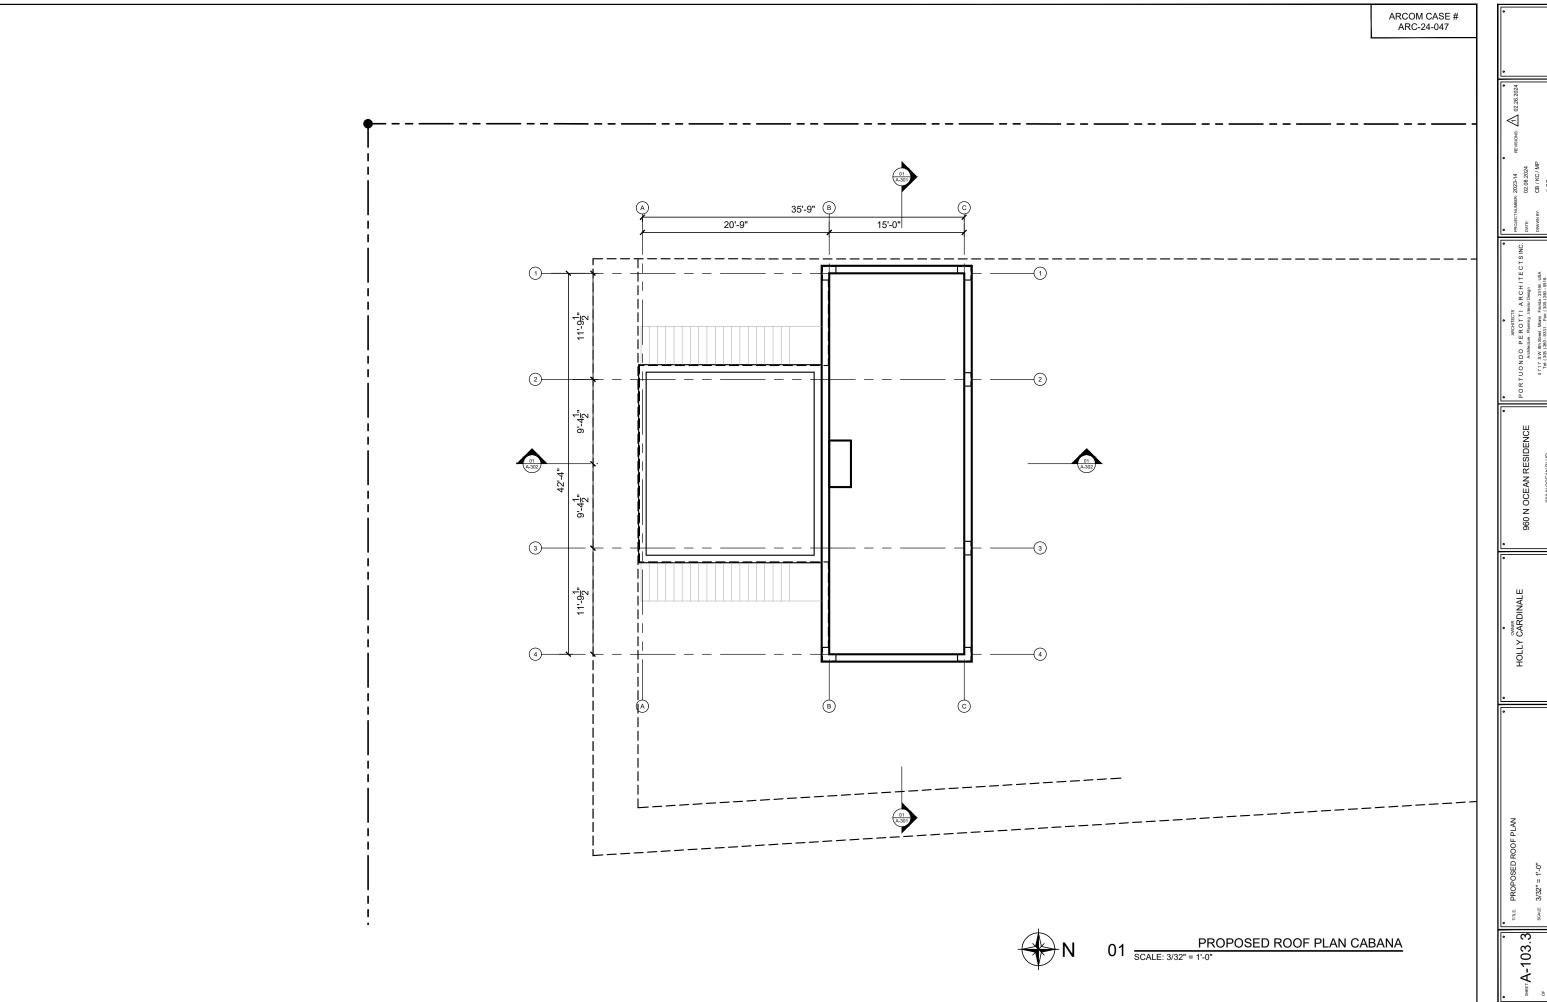

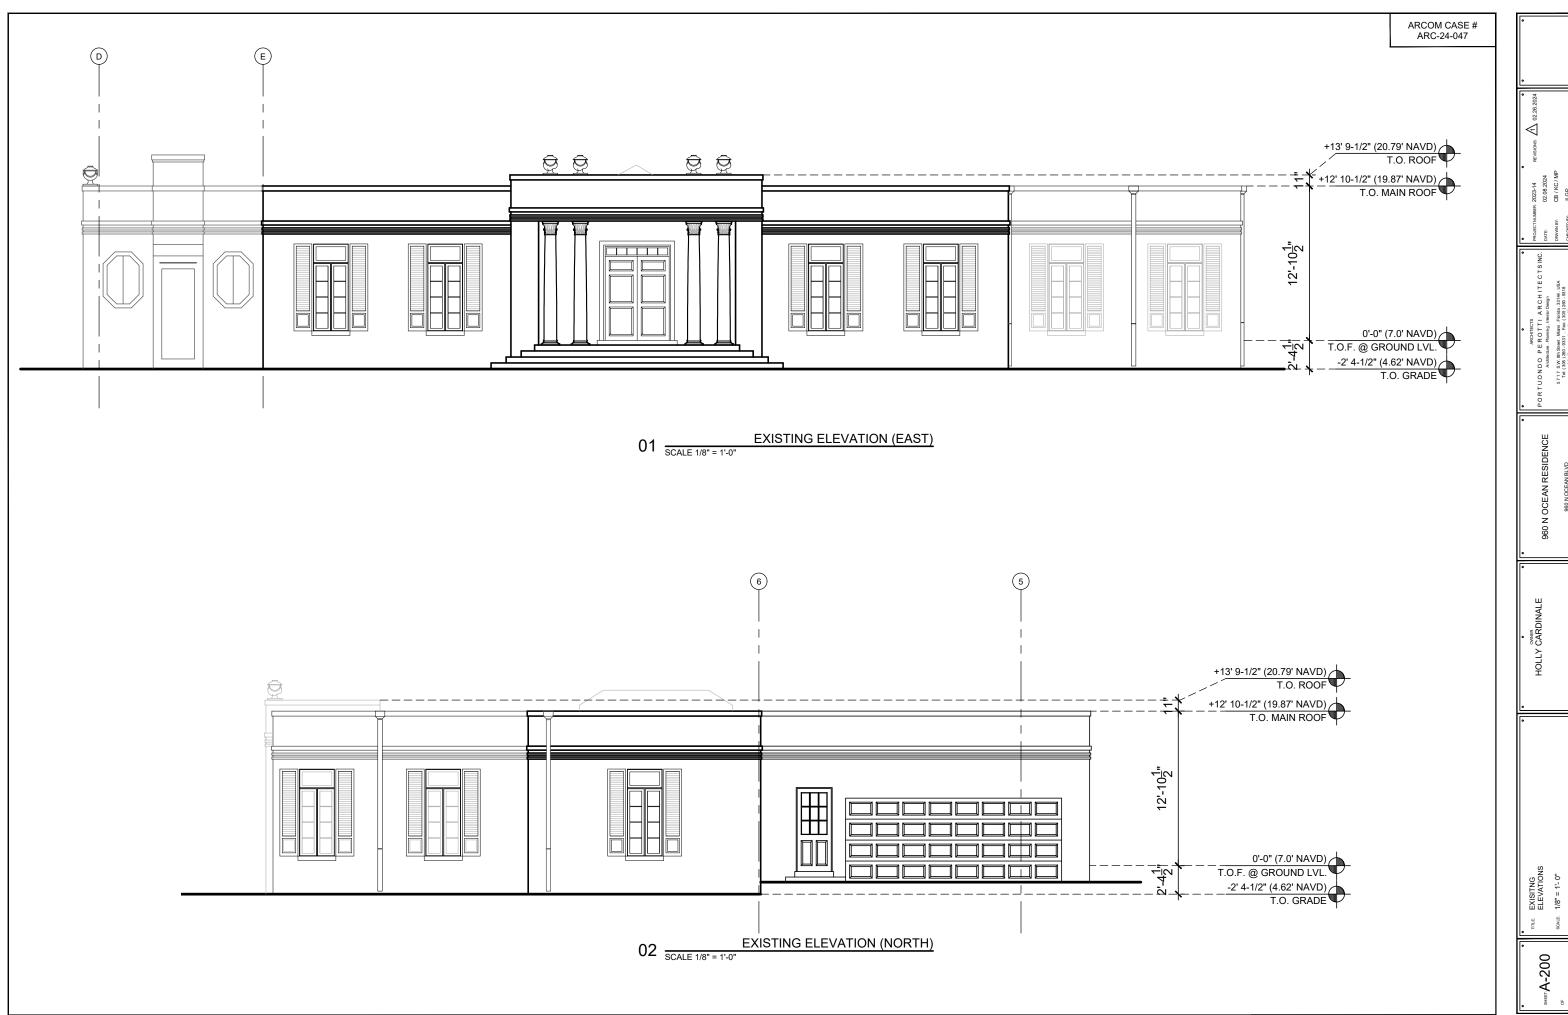


энет.А-200

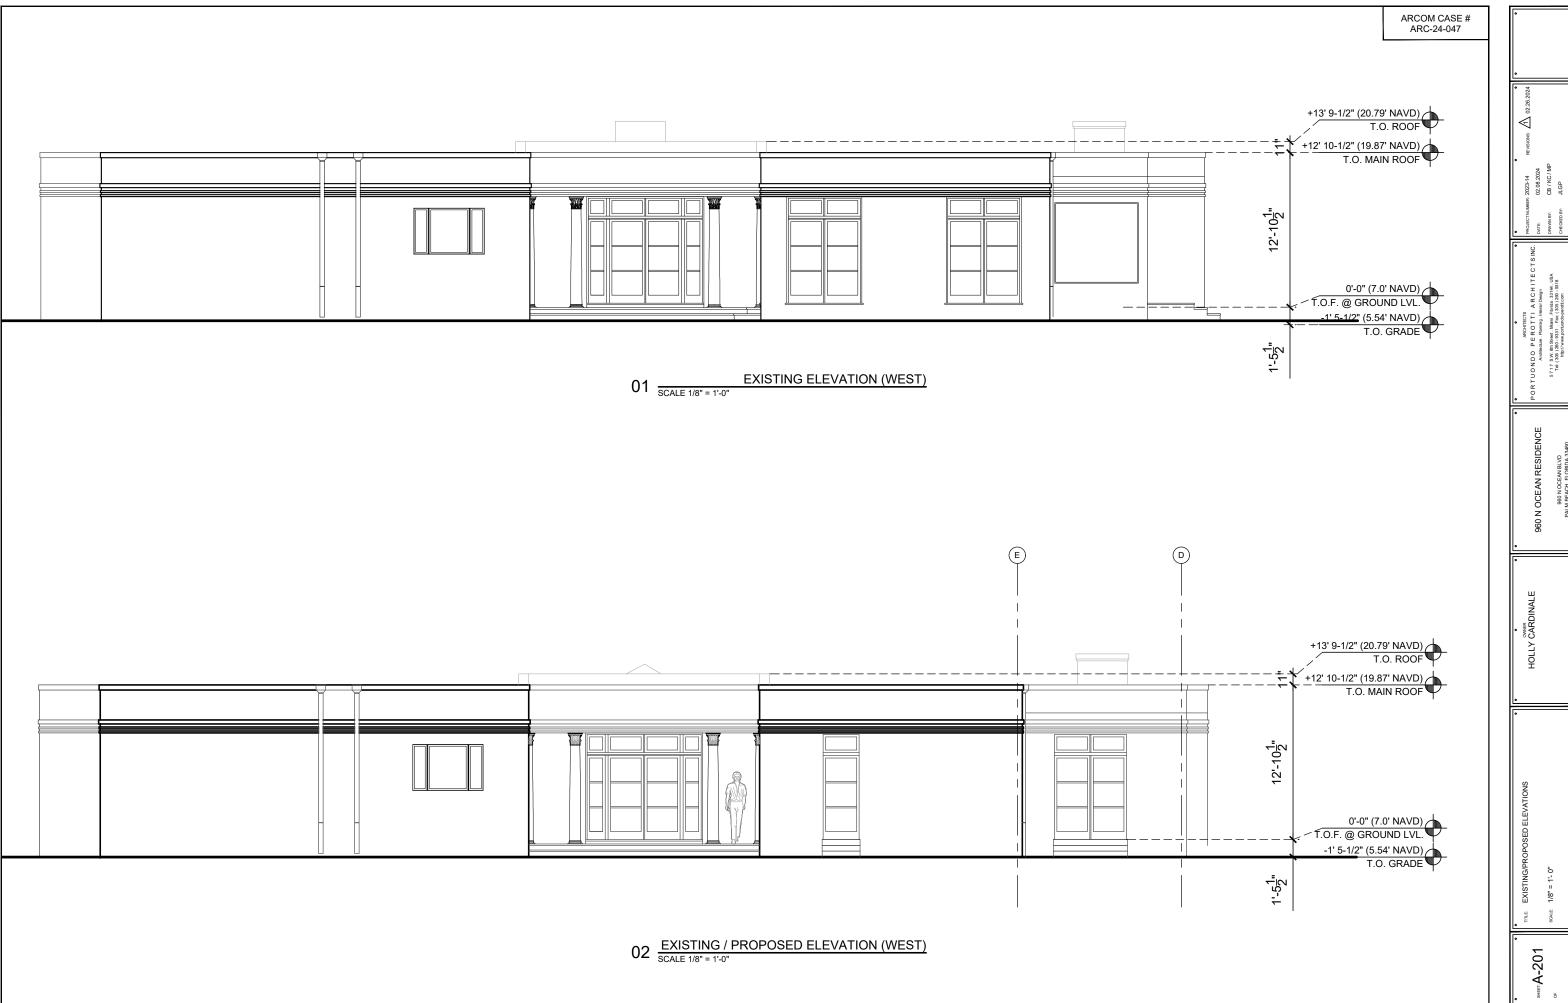


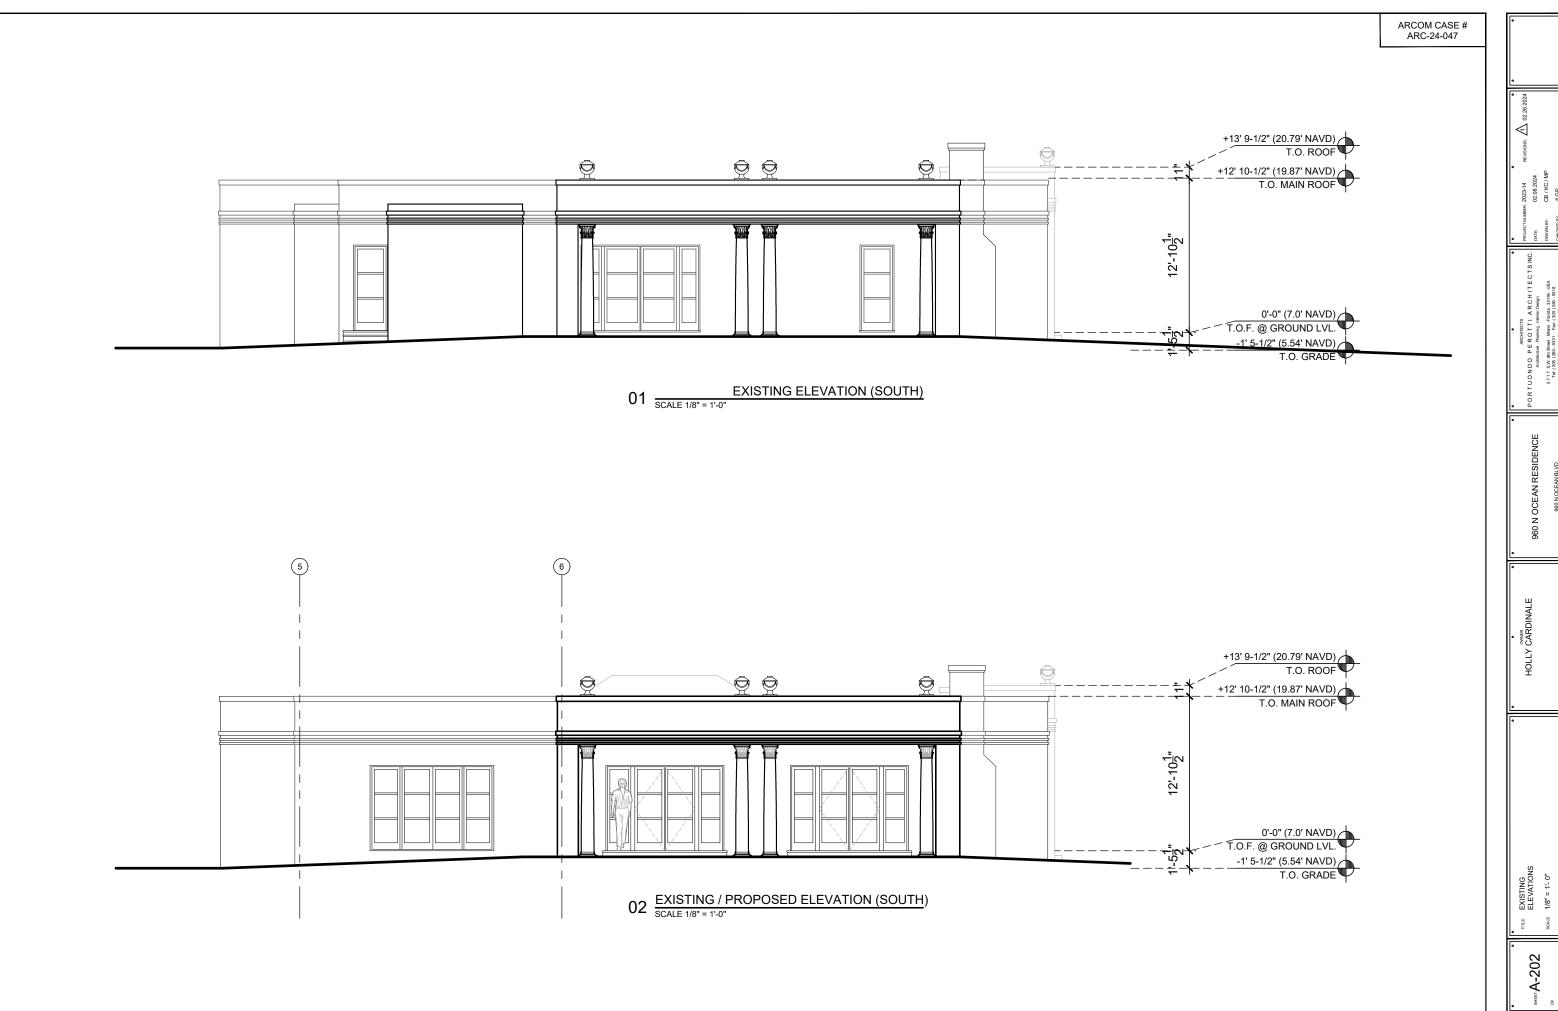

960 N OCEAN RESIDENCE OWNER HOLLY CARDINALE

--A-202

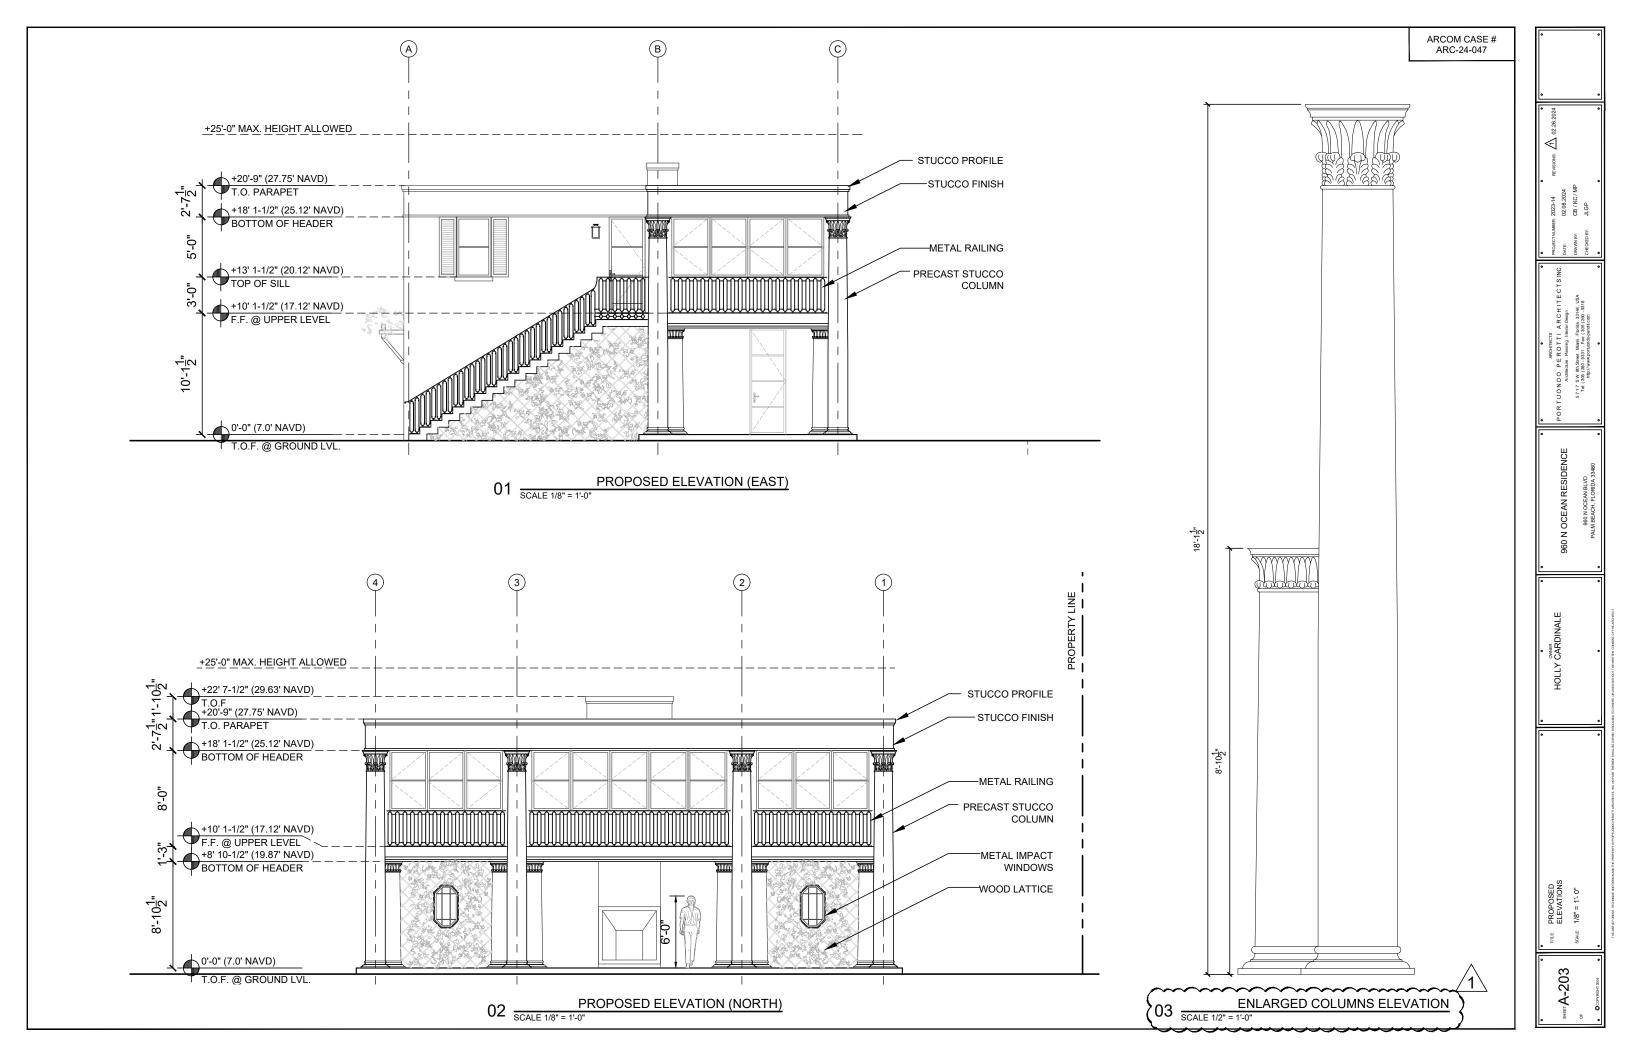

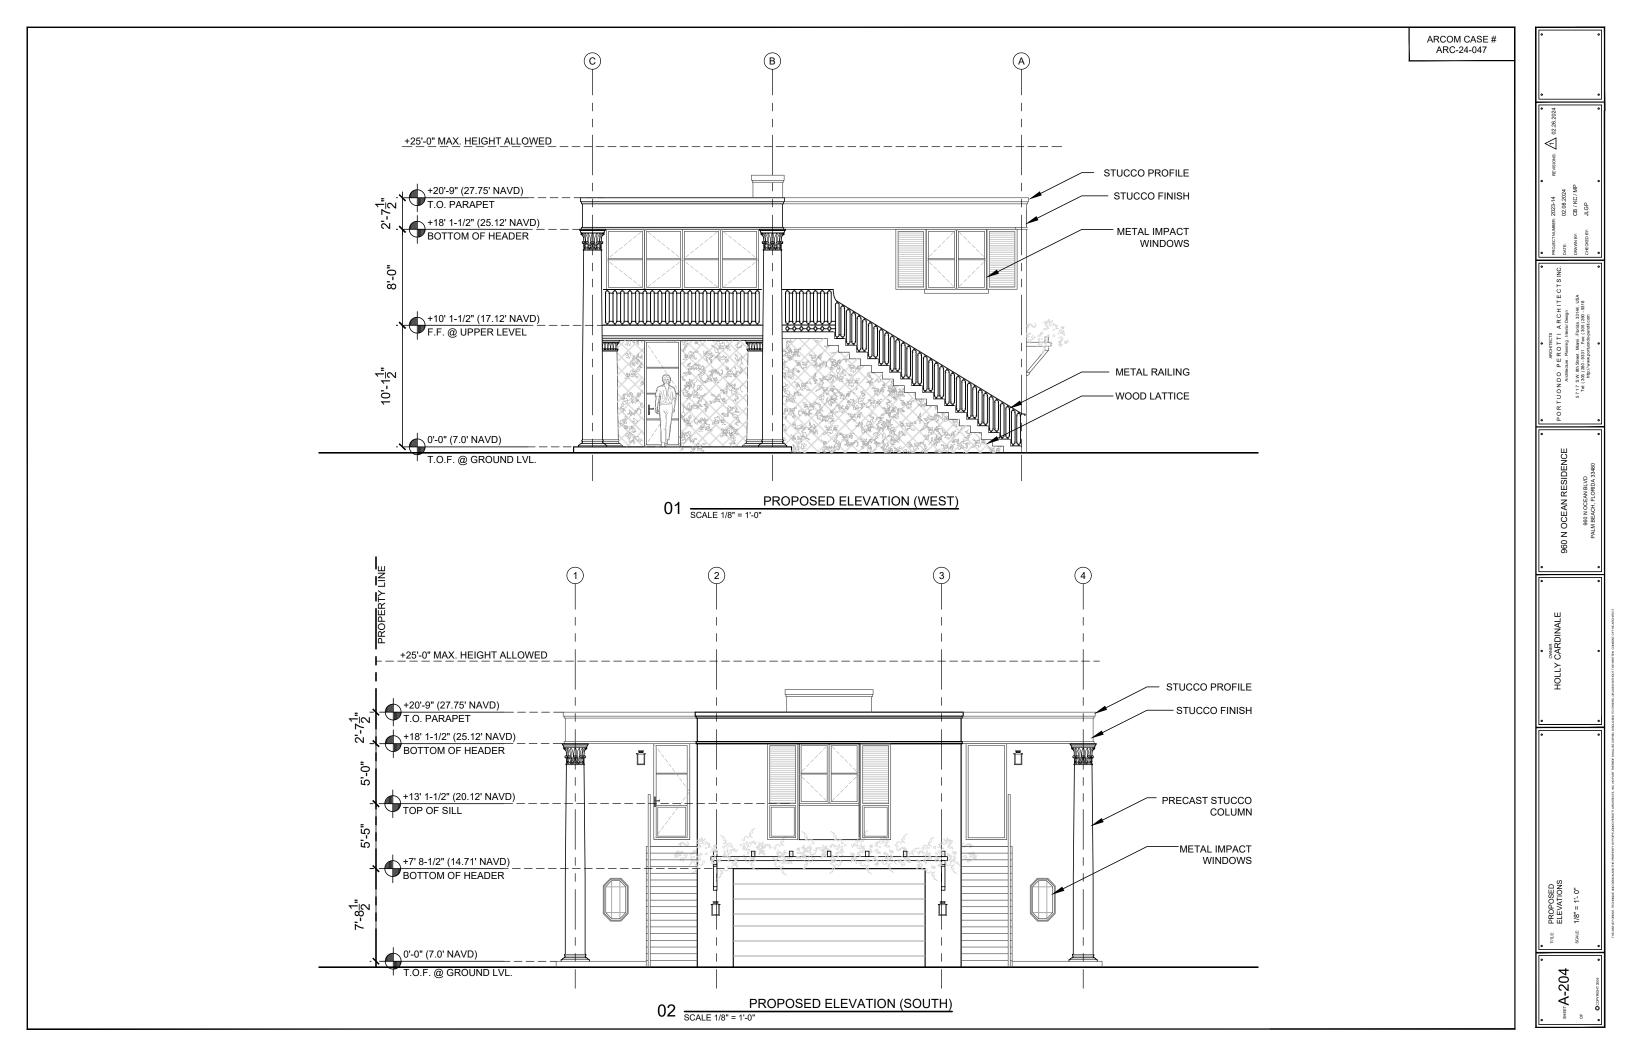

* revisions. \$\int 02.26.2024\$ |


INC.
DATE.
02.08.2024
DIAM.
DATE.
02.08.2024
DIAMN BY:
CHECKED BY:
JI.GP


ONDO P ER OTT IT ARCH IT ECTS IN Chiedran - Panning Innino Design 717 S.W. 8h Savet, Marri Fronta, 33144, USA Tet. (38) 380 - 9331 - Enc. (305) 380 - 9318 Tet. (395) 380 - 931 - Enc. (305) 380 - 9318

50 N OCEAN RESIDENCE


N.T.S.

THE TA-205 SCA COOPERITION SCA

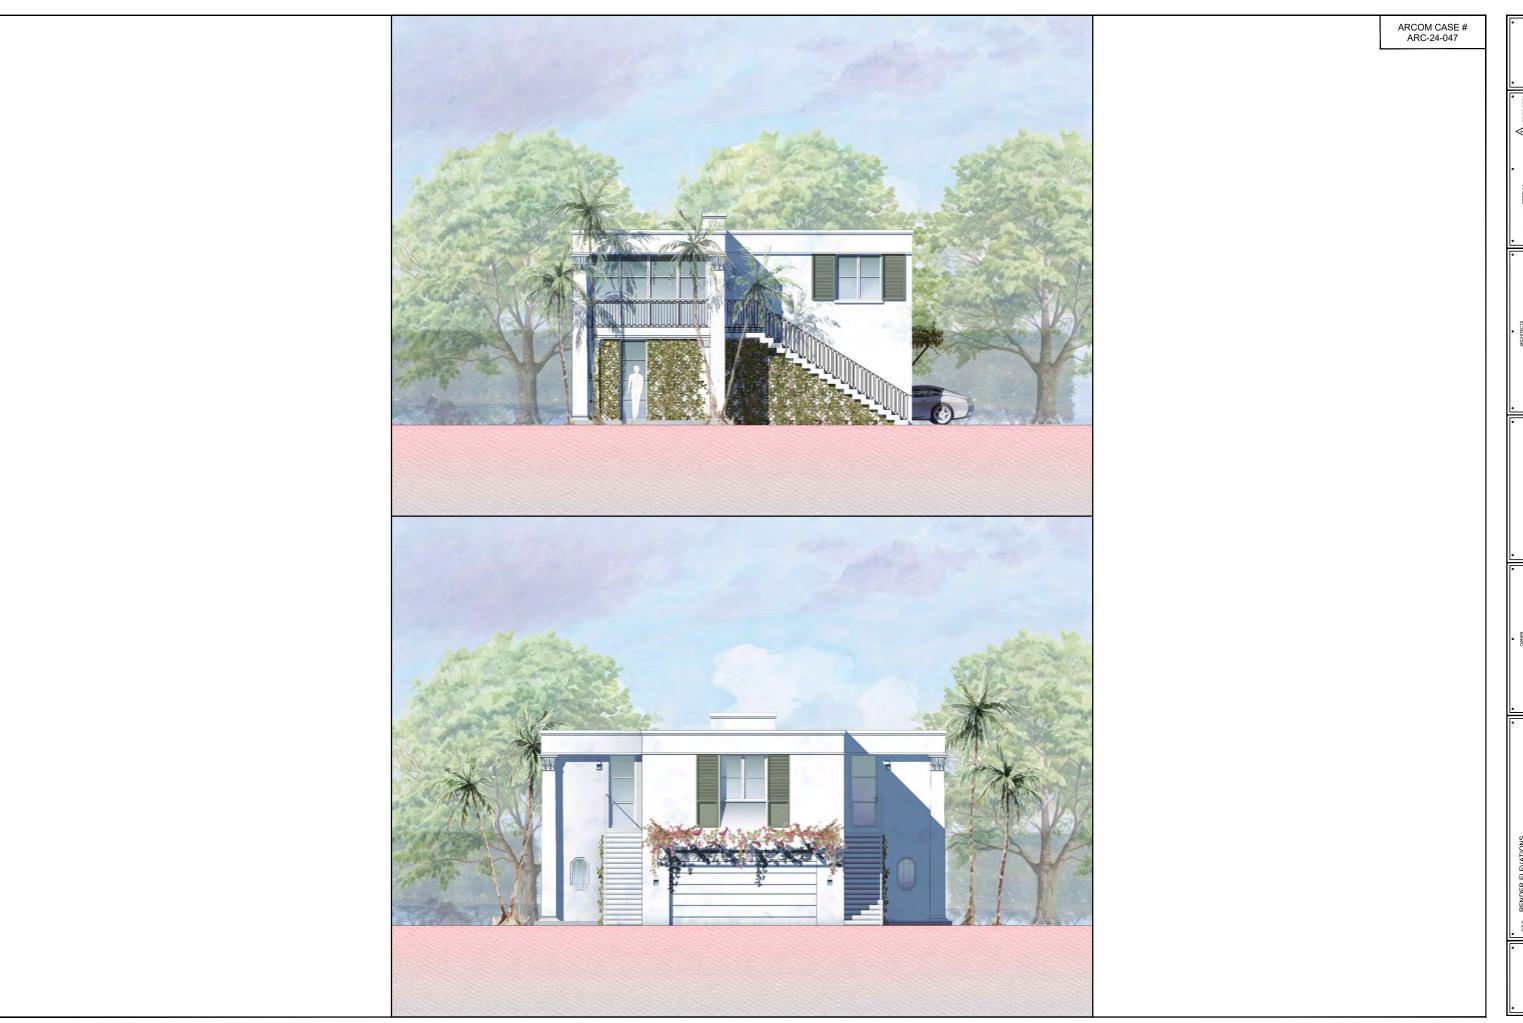

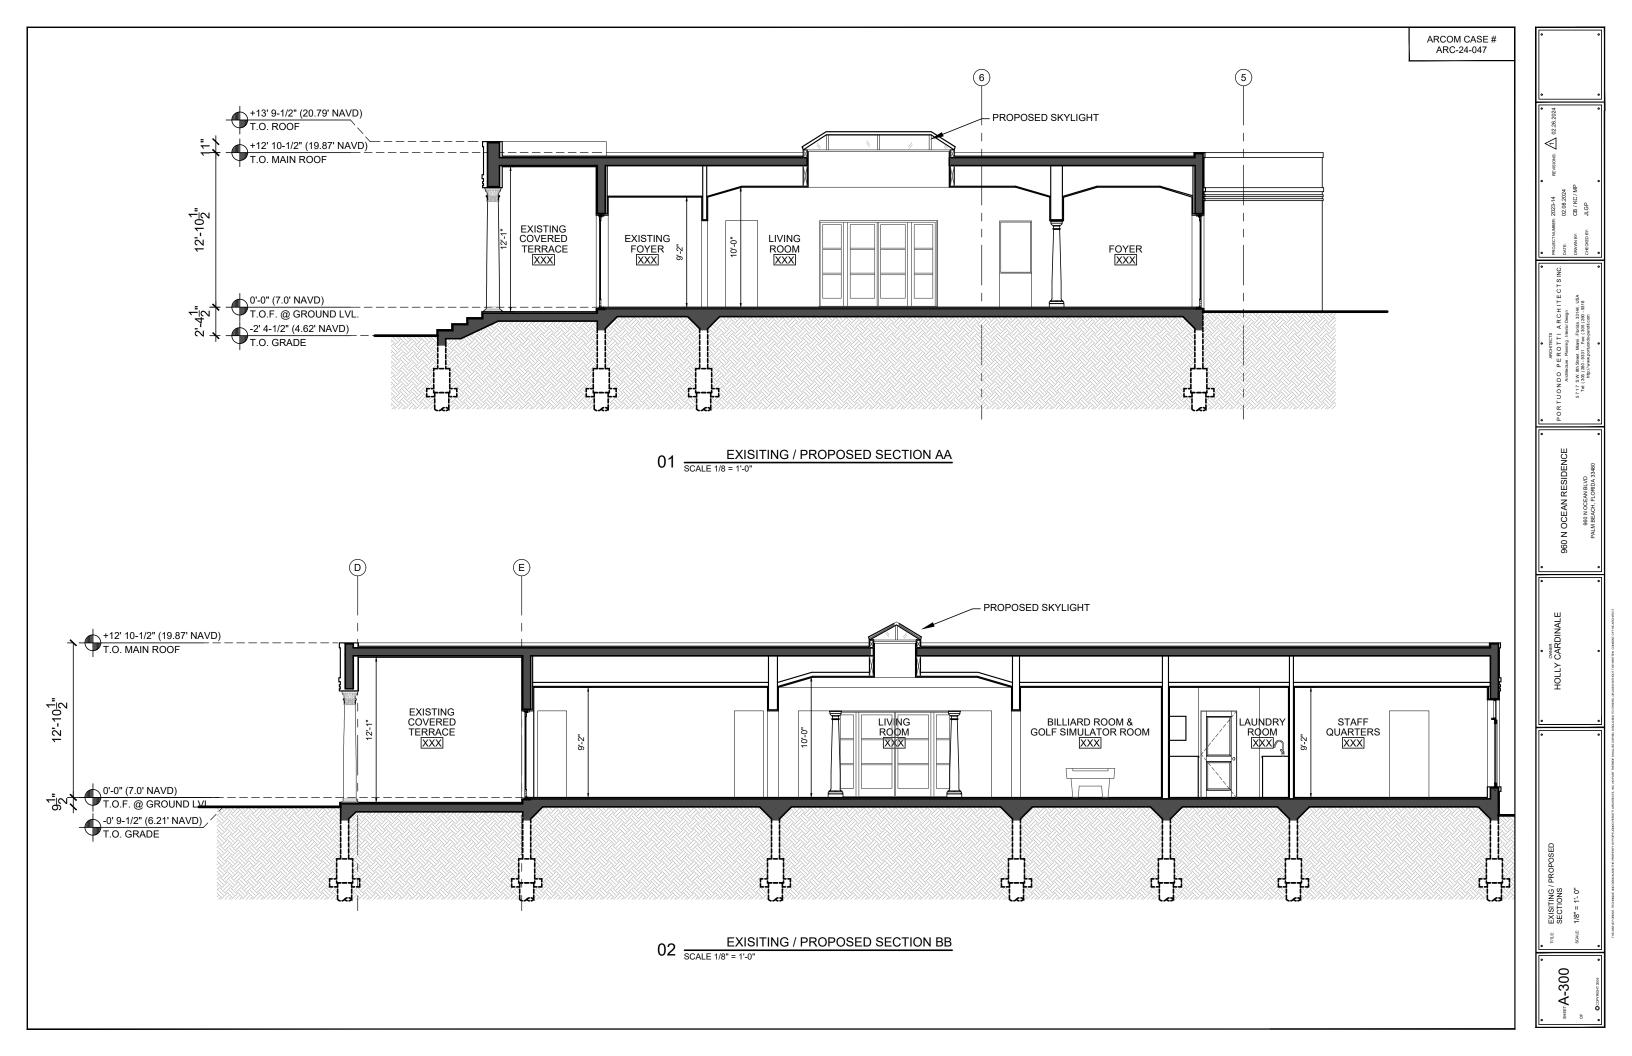



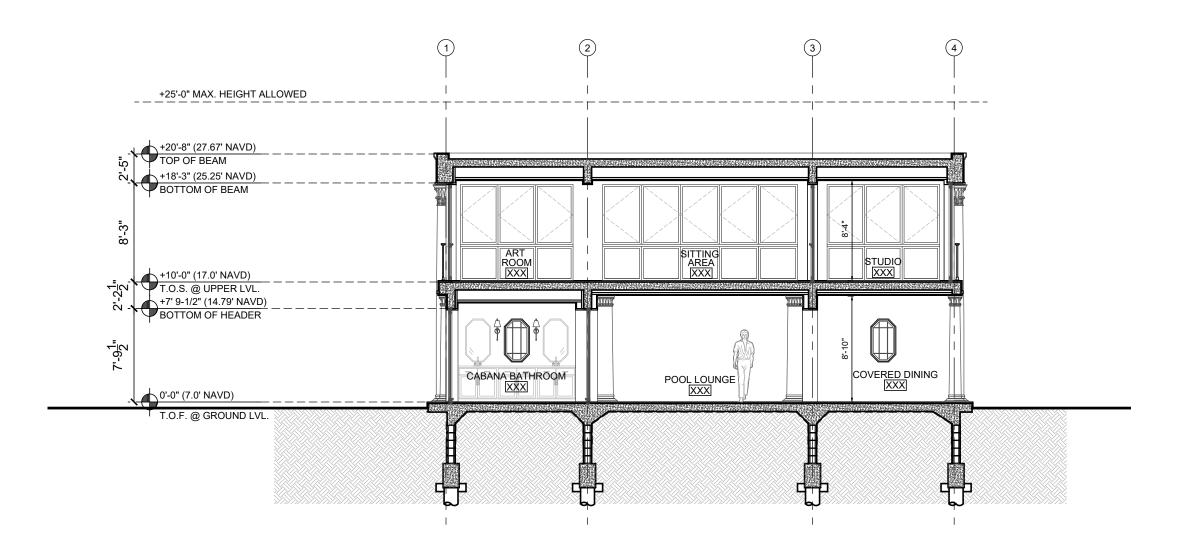


PROPOSED SECTION CC 01 SCALE 1/8" = 1'-0"

 \triangleleft 960 N OCEAN RESIDENCE OWNER HOLLY CARDINALE

PROPOSED SECTIONS 1/8" = 1'- 0"

--A-301

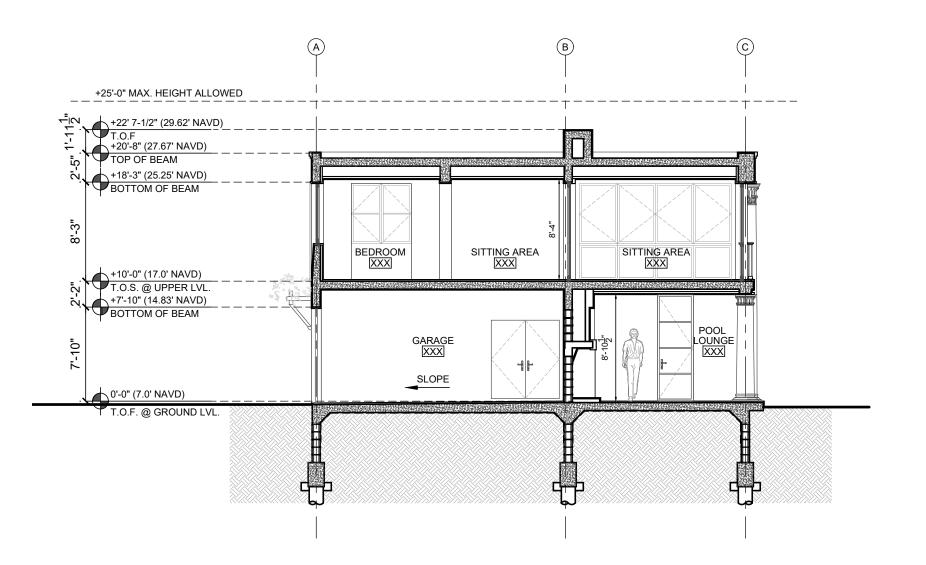



01 PROPOSED SECTION DD


 \triangleleft 960 N OCEAN RESIDENCE OWNER HOLLY CARDINALE

> PROPOSED SECTIONS 1/8" = 1-0"


> > энет.А-302

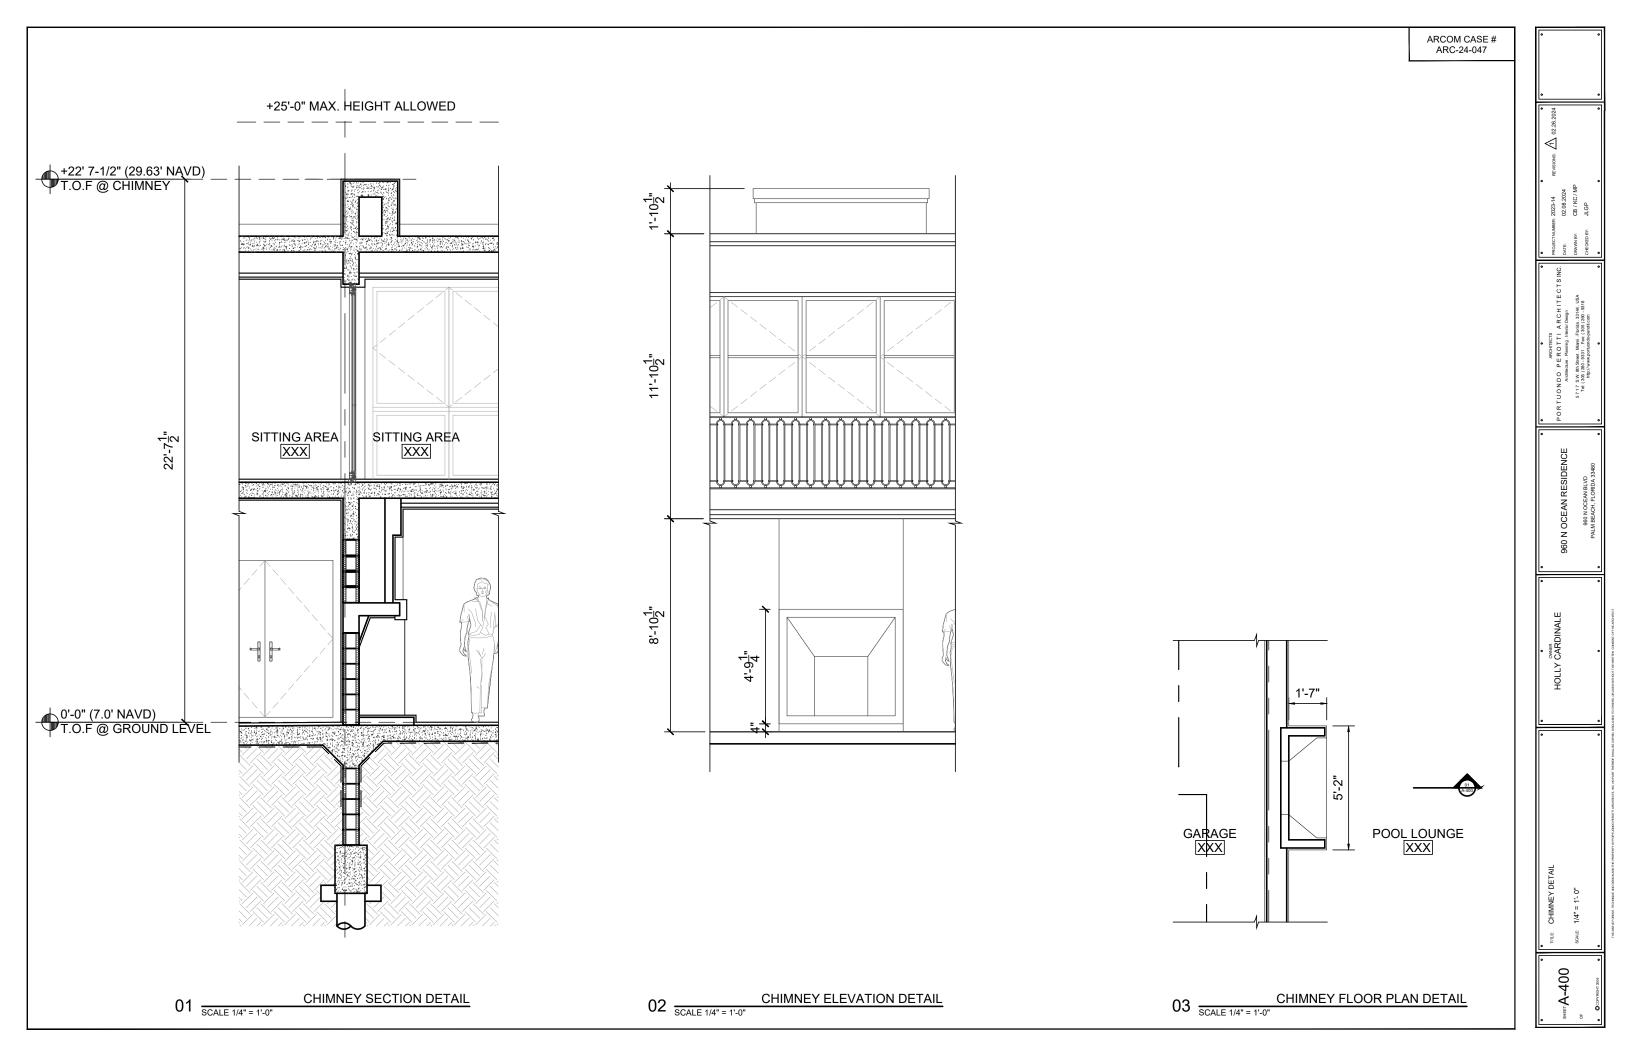

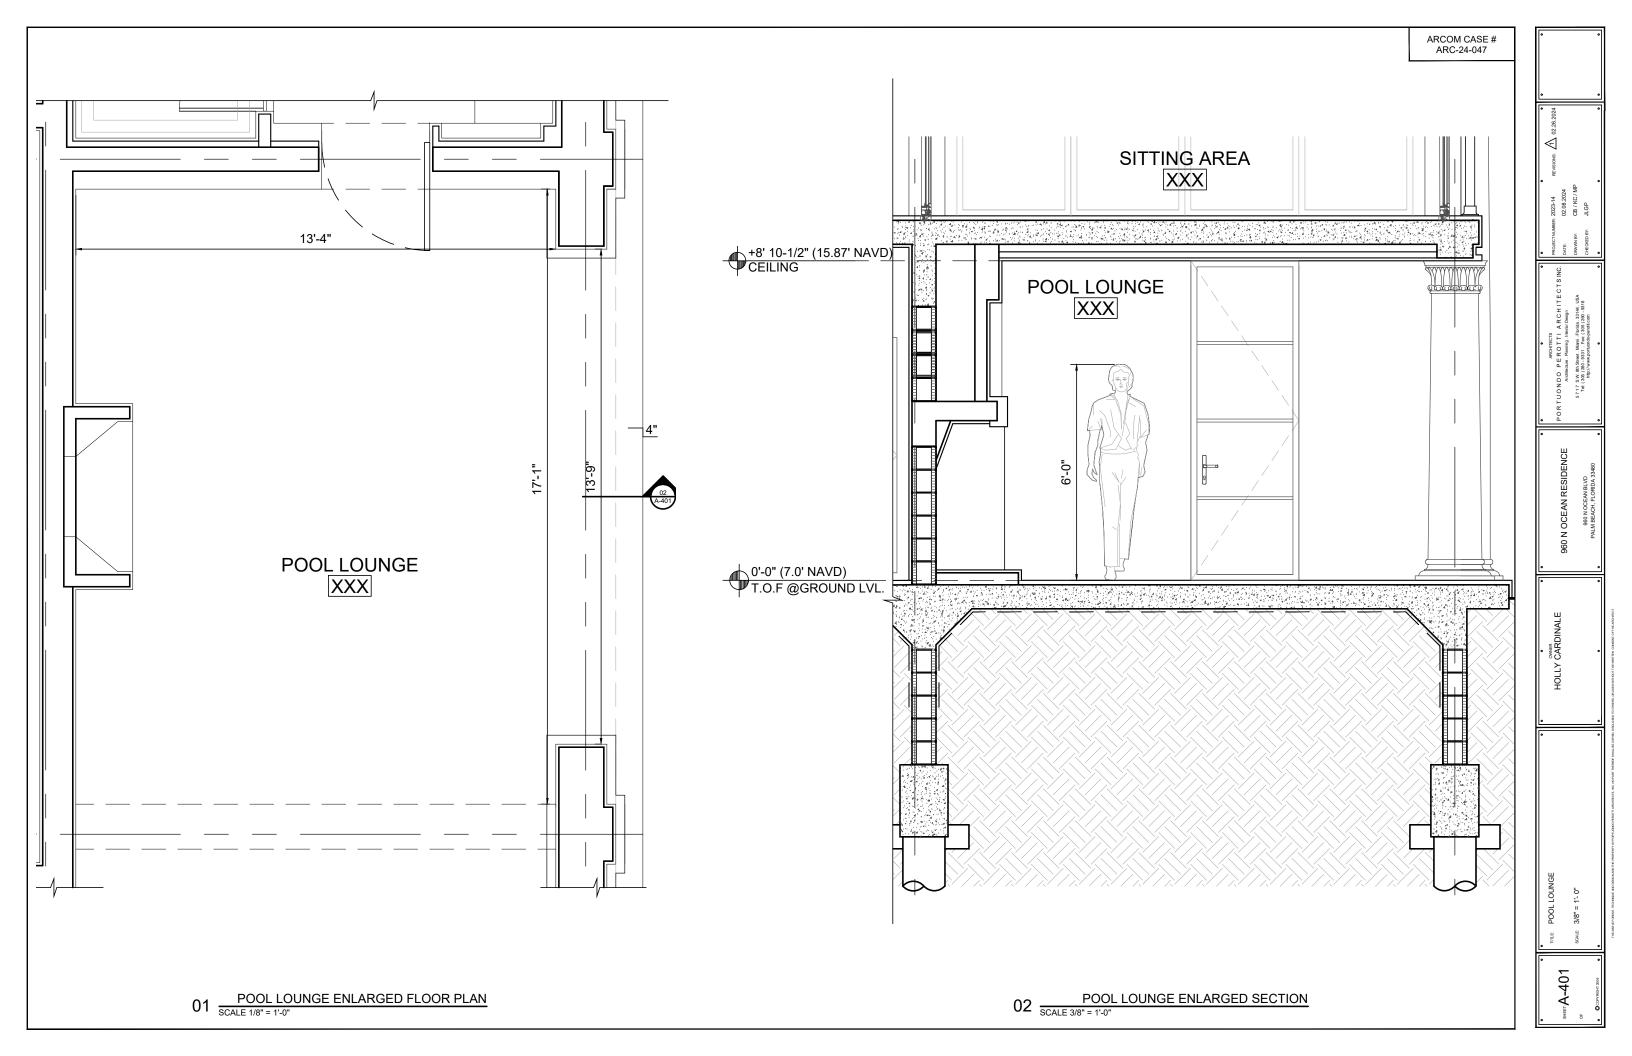

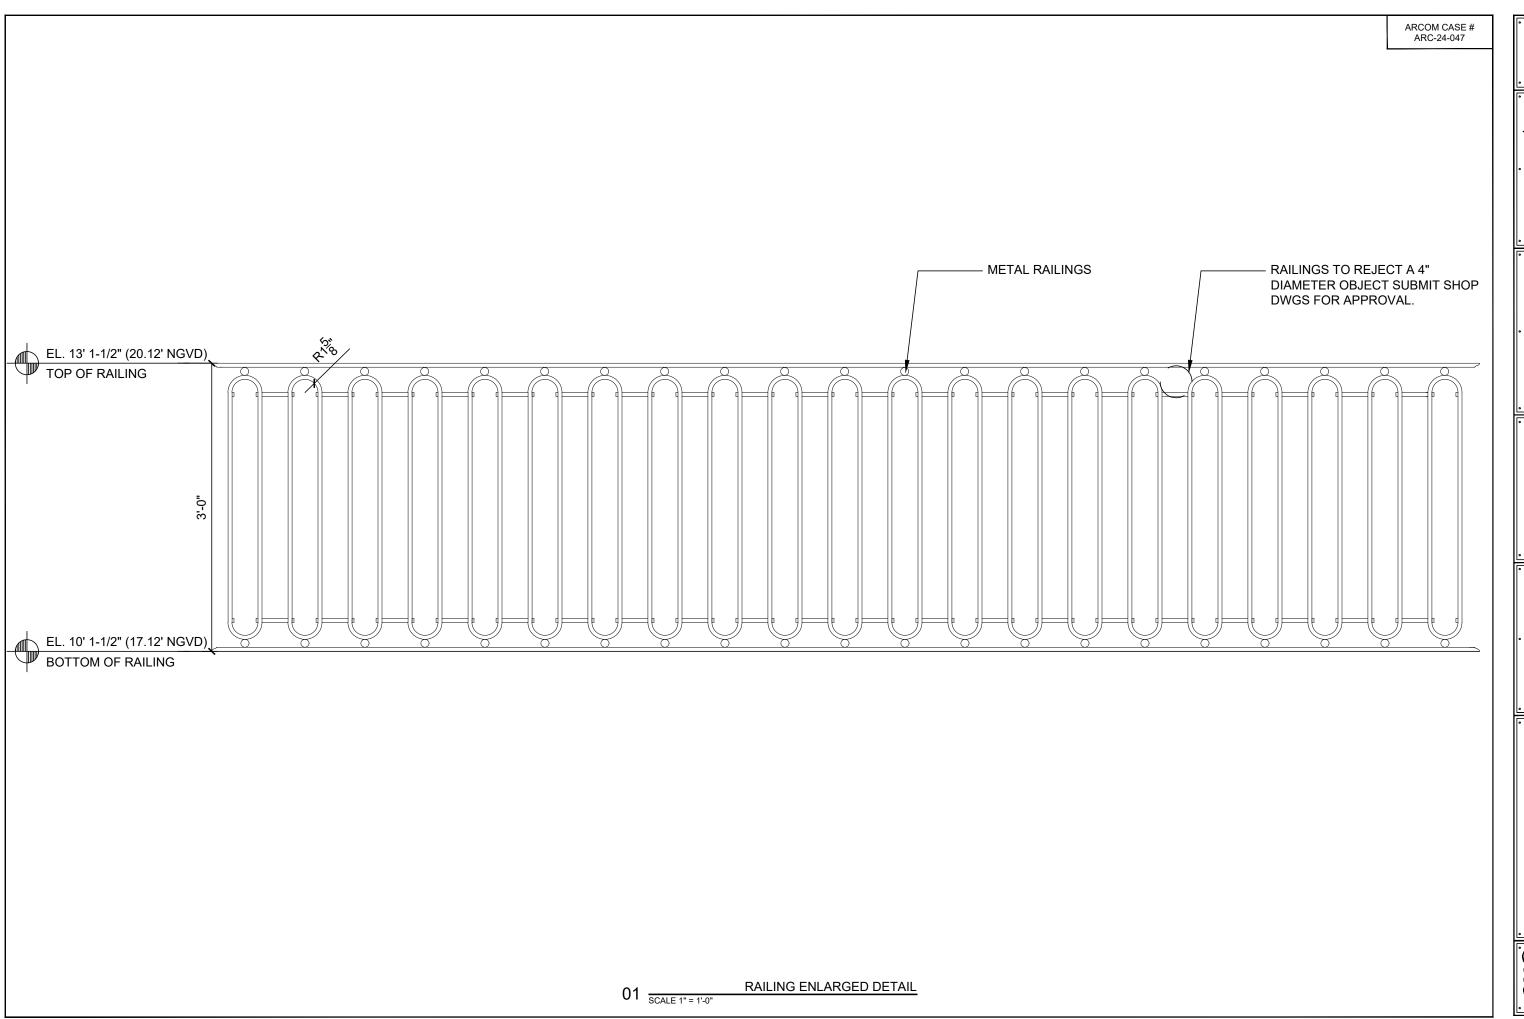

A 02.26 960 N OCEAN RESIDENCE

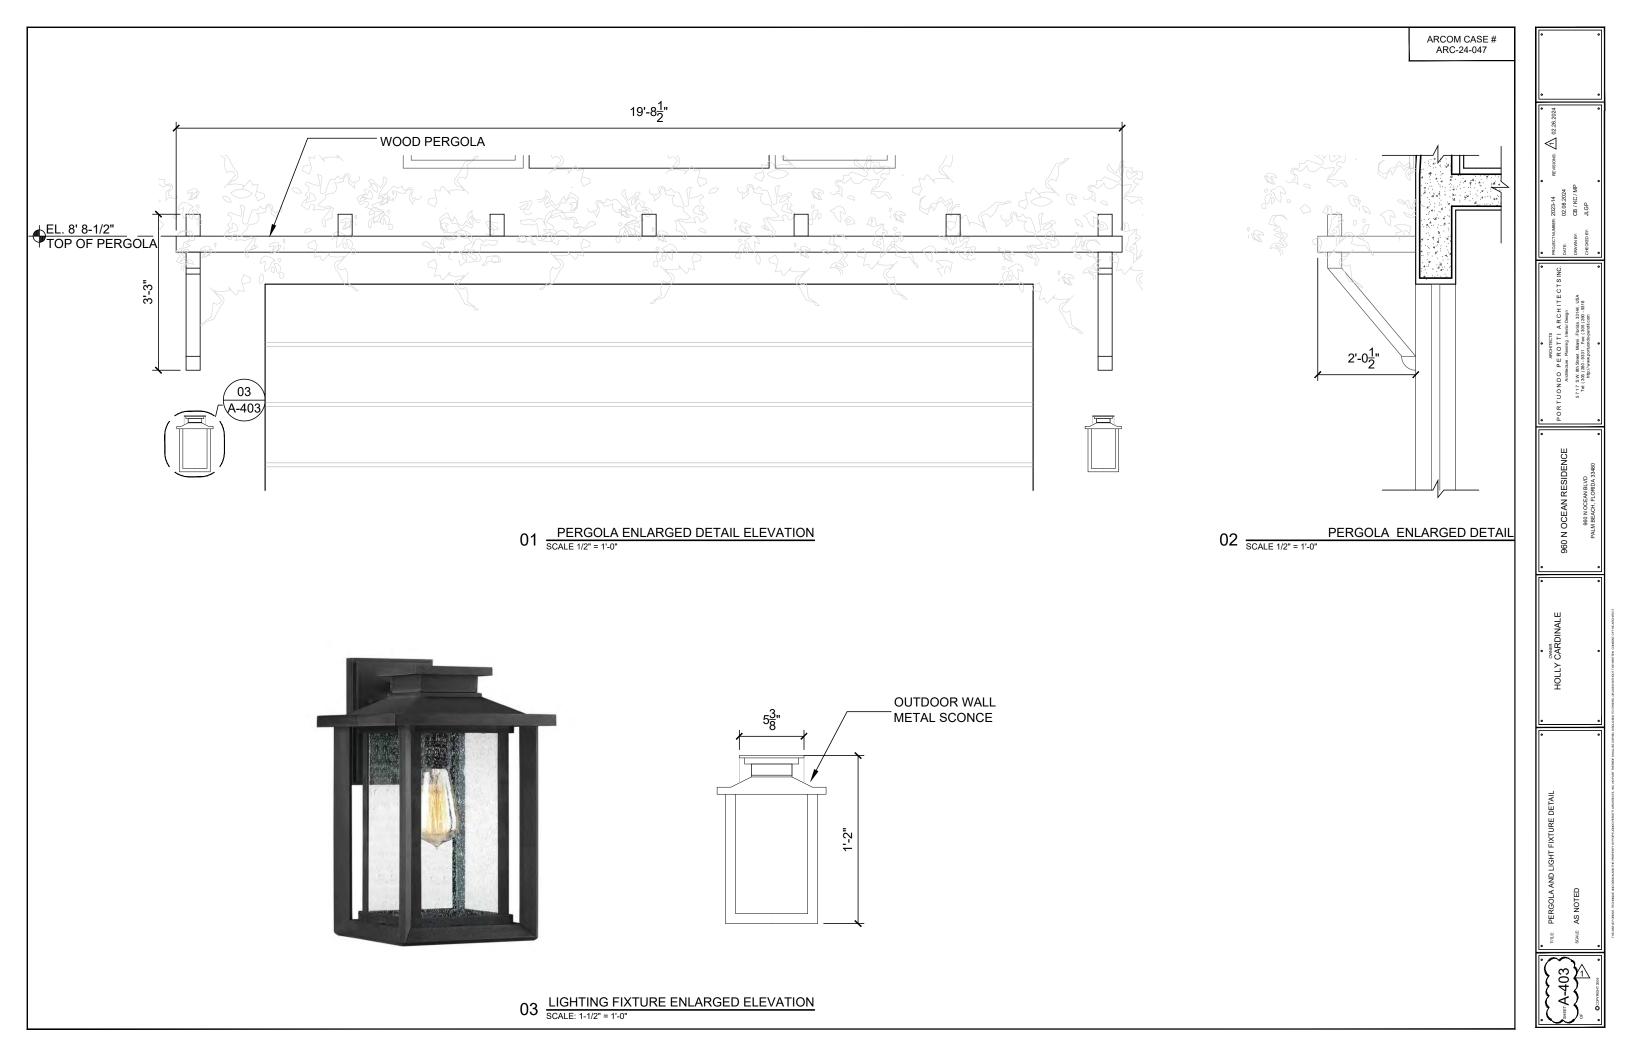

REGENCY STYLE AT PALM BEACH:



Octagonal windows - wood shutters



Columns - tripartite division



Fireplace



Two-story building - flat roof



Columns - stucco trim



Vines in walls

E C T S INC.

| PROJECTYNIARER 2023-14 REVISIONS AND A DATE. 02.08.2024 | DRAWN BY. CB / KC / MP

A CHECKED BY. ALGP

PORTUONDO PEROTTI ARC Architecture, Plemma, Interior Dea 5717 SW, Brosent Marri, Enclas, 3 Tet. (505) 200-5331 - Ere; (305) 201 Tet. (105) 200-5331 - Ere; (305) 201

960 N OCEAN KESIDENCE 960 N OCEAN BLVD PALM BEACH, FLORIDA 33480

S.T.S.

SHET A-404

REGENCY STYLE EXISTING FEATURES AT EXISTING HOUSE:



Wood shutters



Vines in walls



Casement doors, stucco finish



Coral stone steps, stucco trim



Octagonal windows



Egyptian style columns

R310.1.4 Operational constraints. Emergency escape and rescue openings shall be operational from the inside of the room without the use of keys, tools or special knowledge.

R4410.2.6.1. Swinging or Sliding doors of glass without a continuous frame shall be of only fully tempered glass not less than $\frac{1}{2}$ inch (9.5mm) in thickness

 \triangleleft 5717 Tel:

960 N OCEAN RESIDE

DOORS 1/8"

A-601

206

Α

2'-6"

5'-0"

WOOD

PAINT: BENJAMIN MOORE HERB BOUQUET 640

A R C H I T E C T S INC.

A R C H I T E C T S INC.

DATE:

PORTUONDO PEROTT
Architecture, Parming.
57.17 xW. Bits Street. Marrix


960 N OCEAN RESIDEN


CARDINALE


HOLLY CARD

CHIMNEY DETAIL 1/4" = 1'- 0"




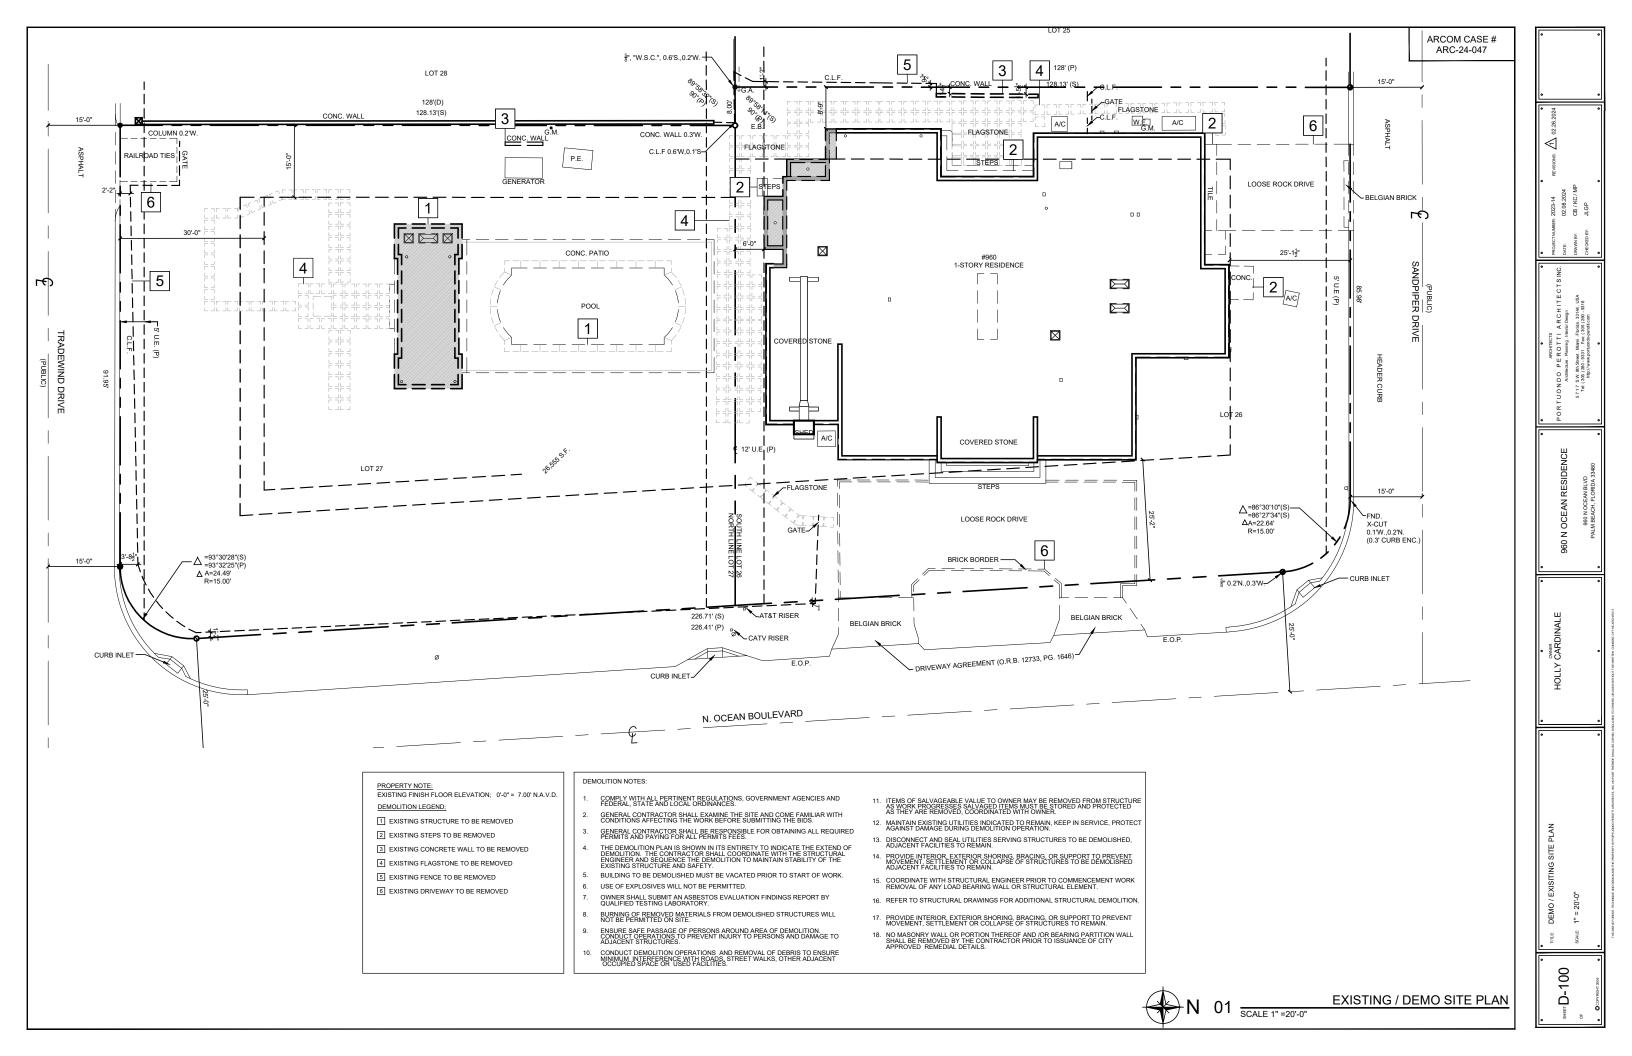

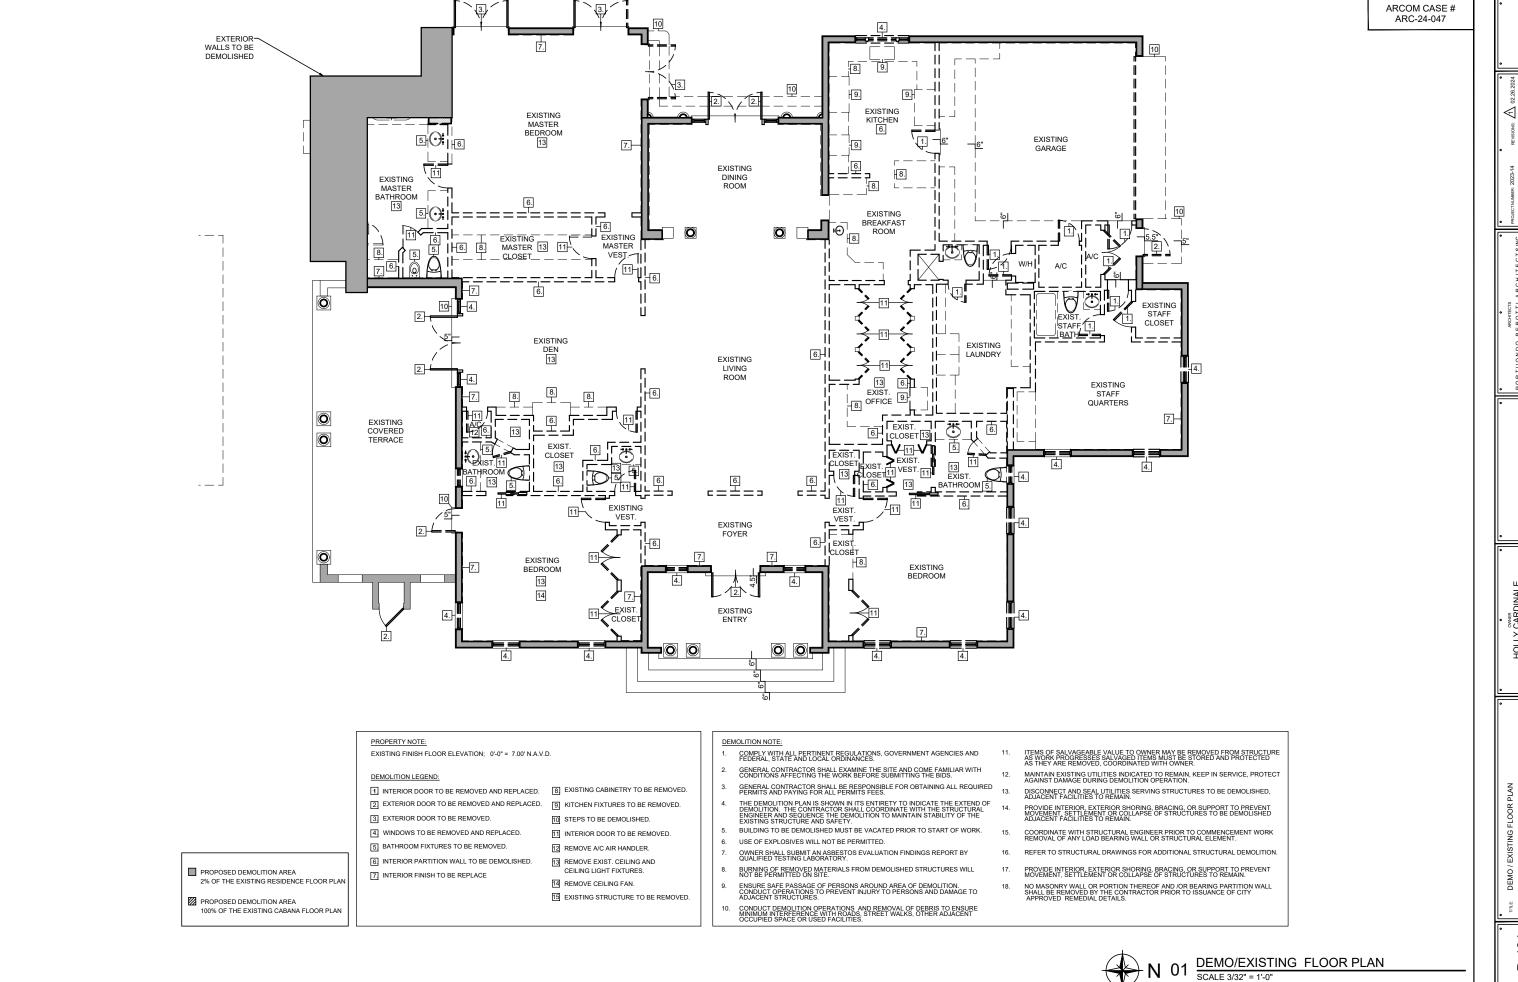


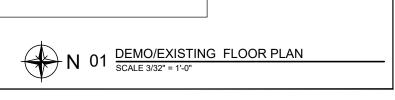


960 N OCEAN RESIDEN

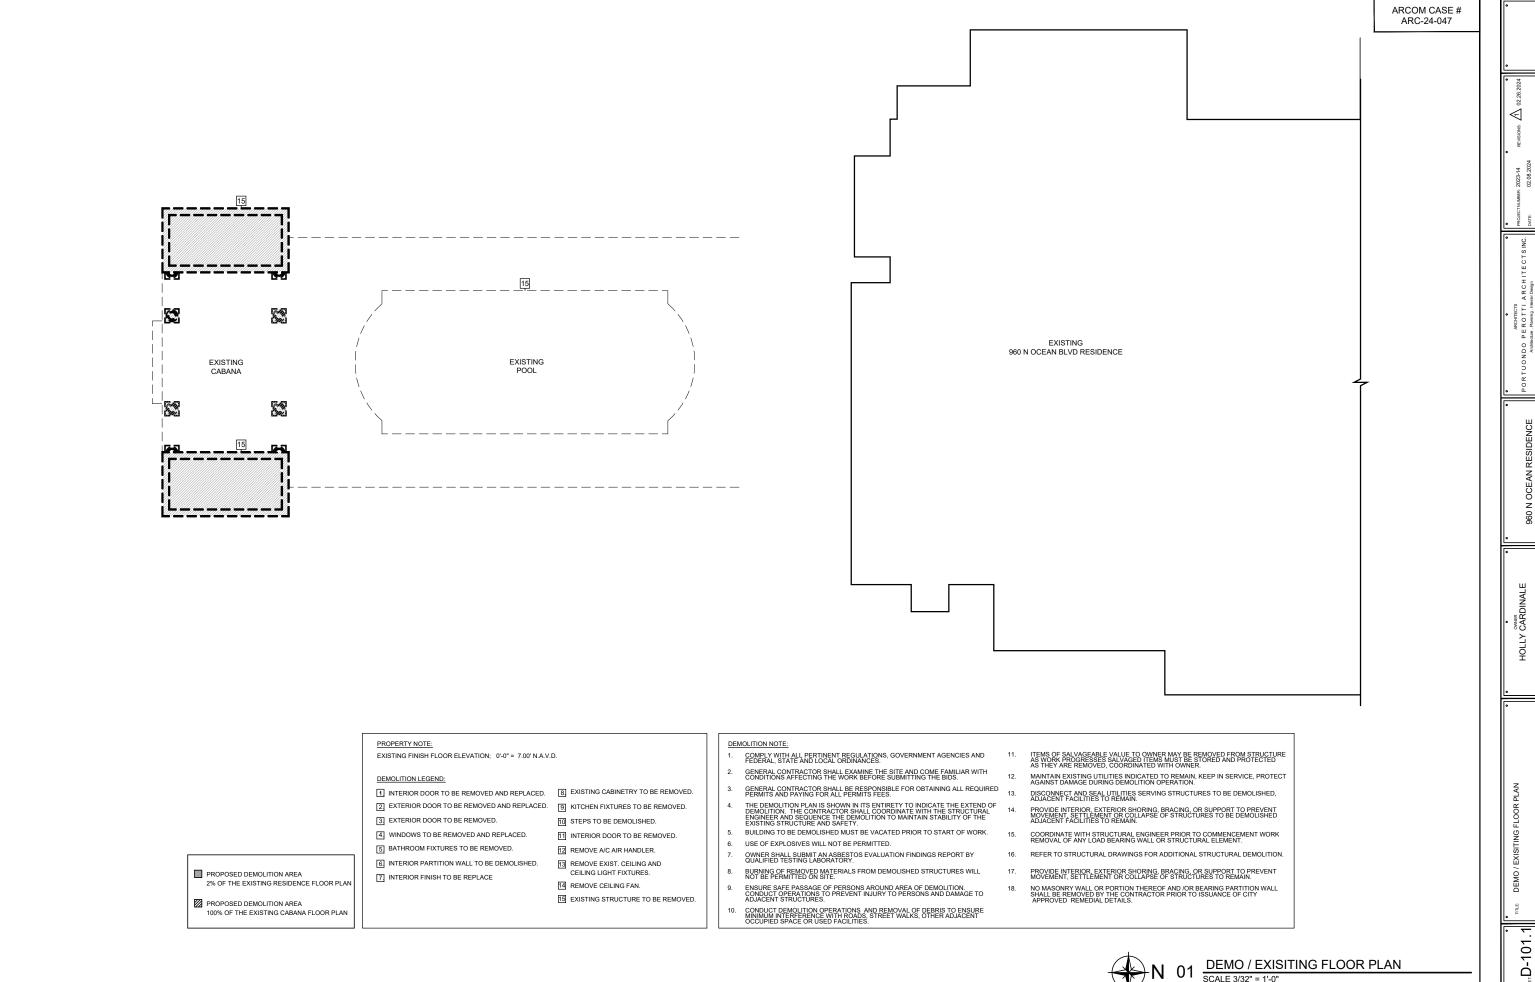

-N 01 DEMO / EXISITING FLOOR PLAN
SCALE 3/32" = 1'-0"

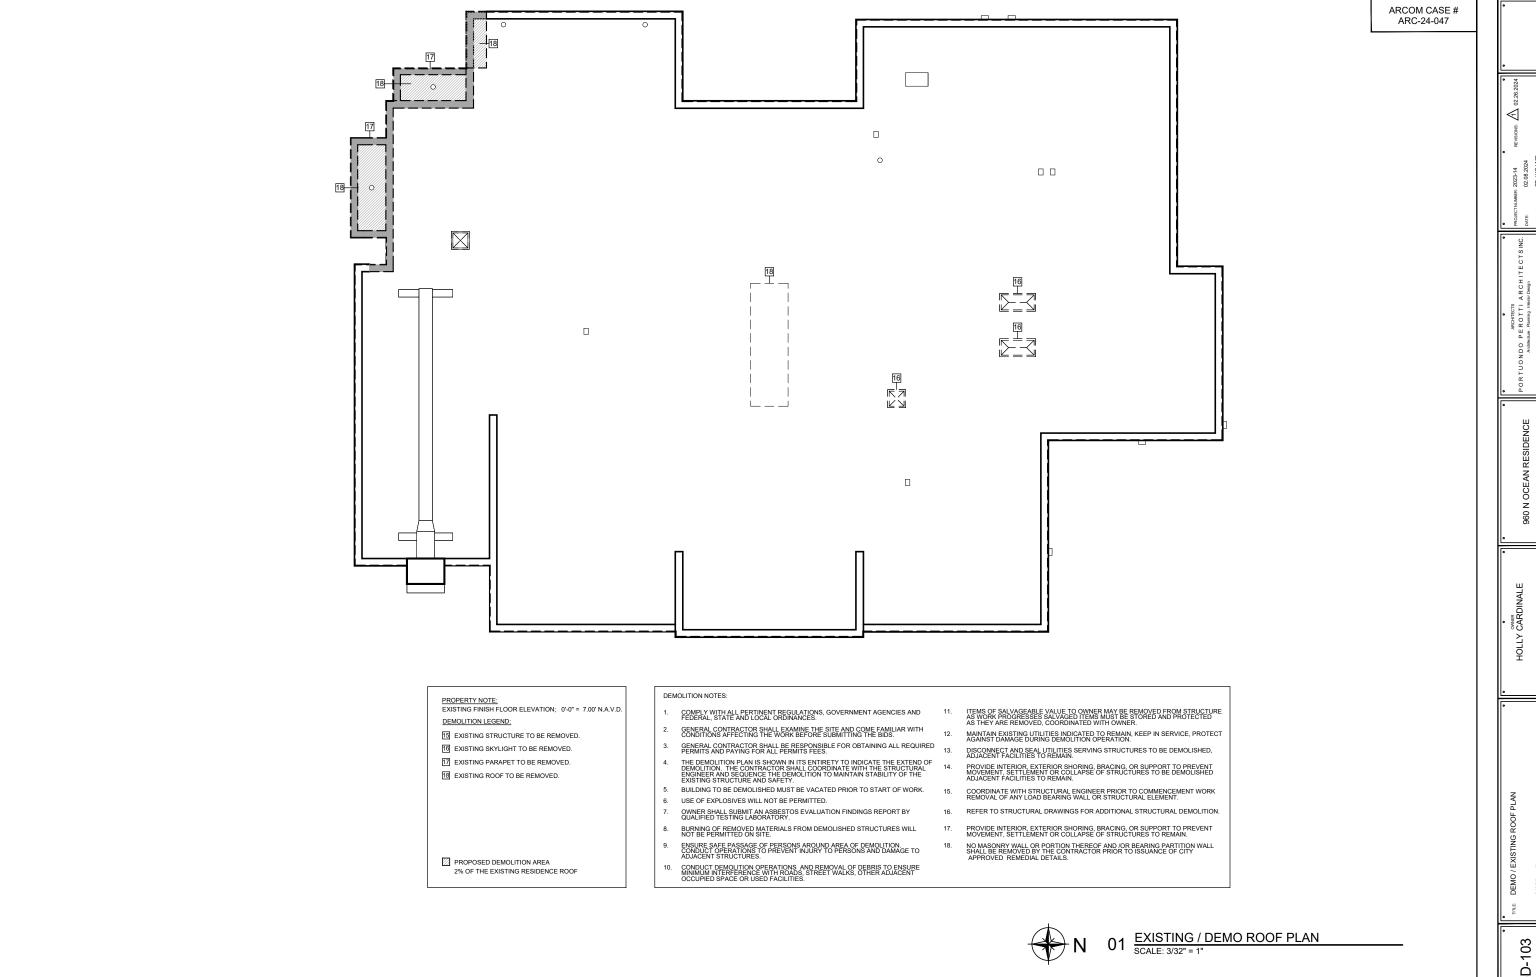


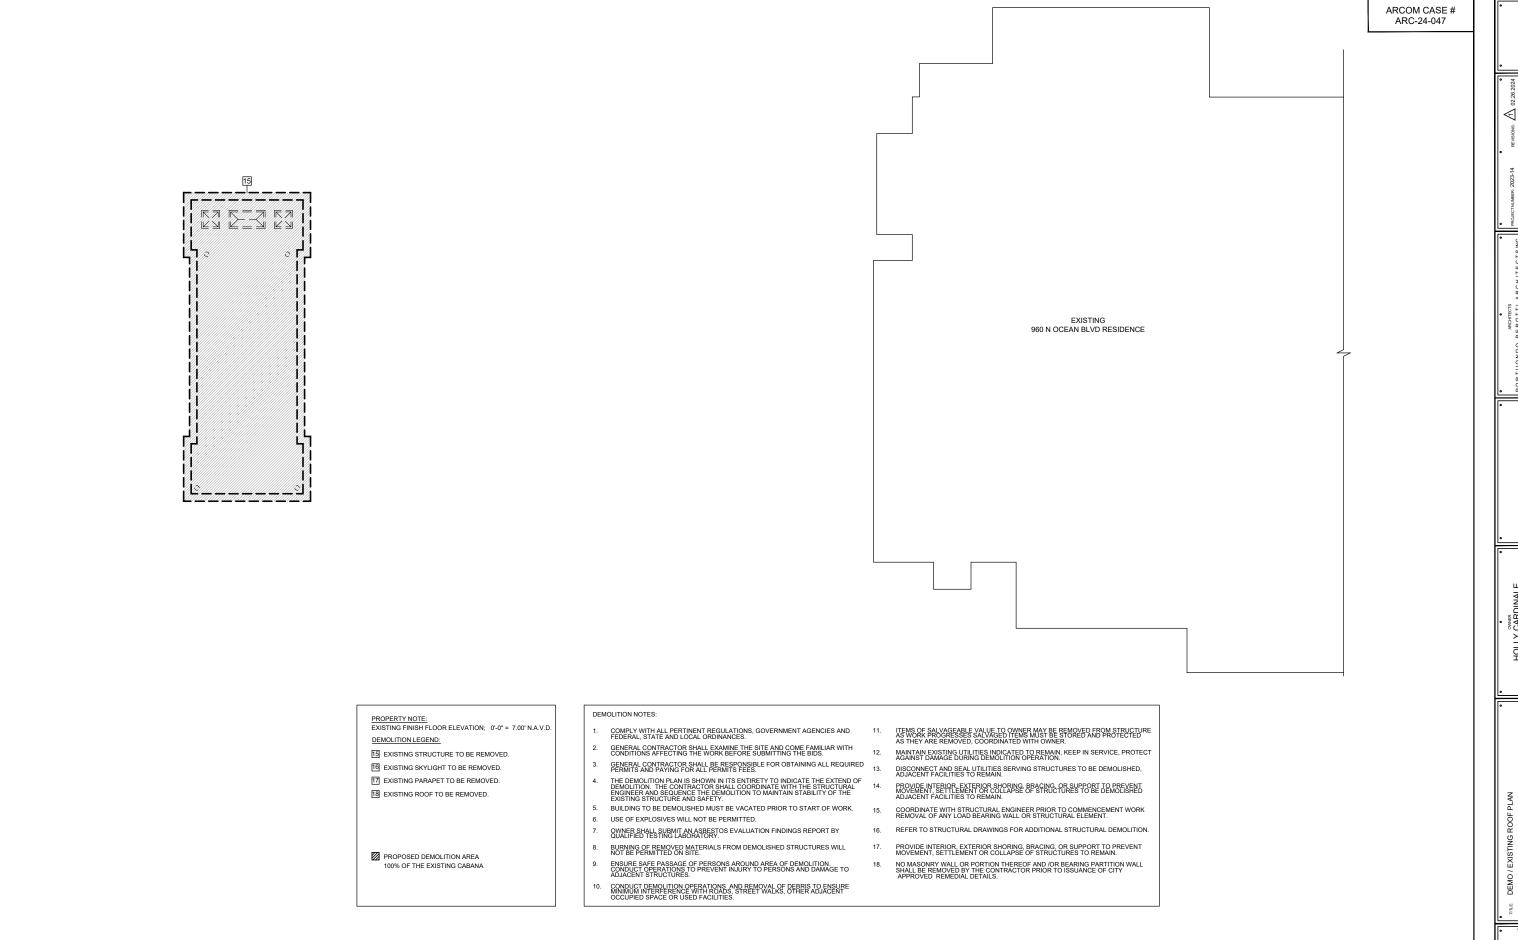


960 N OCEAN RESIDENCE

[™]D-103.



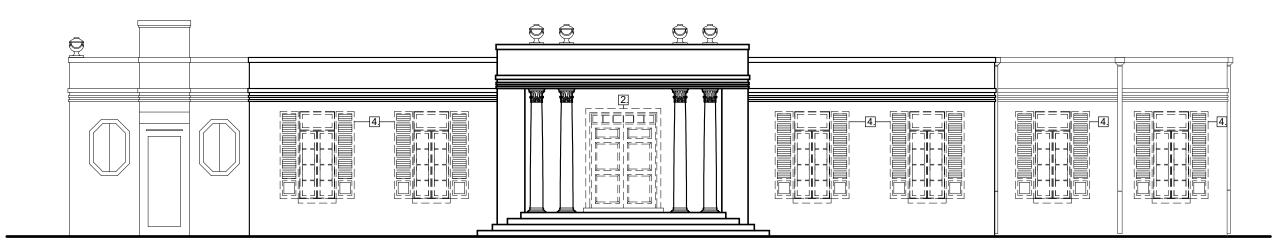

EXISTING / DEMO ELEVATION 01 SCALE 3/32" = 1'-0"

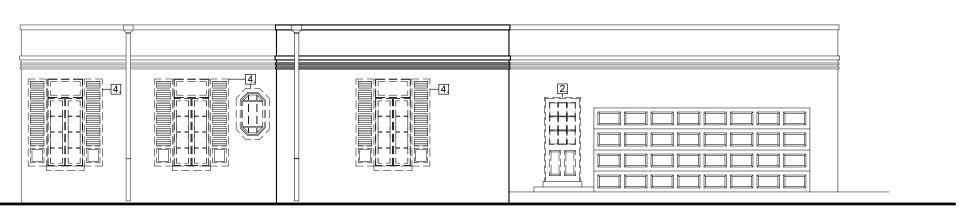

EXISTING / DEMO ELEVATION 02 SCALE 3/32" = 1'-0"

DEMOLITION LEGEND: 2 EXTERIOR DOOR TO BE REMOVED AND REPLACED. 3 EXTERIOR DOOR TO BE REMOVED. 4. WINDOWS TO BE REMOVED AND REPLACED. 10 STEPS TO BE DEMOLISHED. 15 EXISTING STRUCTURE TO BE REMOVED. [6] EXISTING SKYLIGHT TO BE REMOVED. [7] EXISTING PARAPET TO BE REMOVED. 18 EXISTING ROOF TO BE REMOVED. 19 EXISTING WALL TO BE REMOVED.

PROPERTY NOTE: EXISTING FINISH FLOOR ELEVATION; 0'-0" = 7.00' N.A.V.D.

COMPLY WITH ALL PERTINENT REGULATIONS, GOVERNMENT AGENCIES AND FEDERAL, STATE AND LOCAL ORDINANCES.

GENERAL CONTRACTOR SHALL EXAMINE THE SITE AND COME FAMILIAR WITH CONDITIONS AFFECTING THE WORK BEFORE SUBMITTING THE BIDS.

GENERAL CONTRACTOR SHALL BE RESPONSIBLE FOR OBTAINING ALL REQUIRED PERMITS AND PAYING FOR ALL PERMITS FEES.

THE DEMOLITION PLAN IS SHOWN IN ITS ENTIRETY TO INDICATE THE EXTEND OF DEMOLITION. THE CONTRACTOR SHALL COORDINATE WITH THE STRUCTURAL ENGINEER AND SEQUENCE THE DEMOLITION TO MAINTAIN STABILITY OF THE EXISTING STRUCTURE AND SAFETY.

BUILDING TO BE DEMOLISHED MUST BE VACATED PRIOR TO START OF WORK.

USE OF EXPLOSIVES WILL NOT BE PERMITTED.

OWNER SHALL SUBMIT AN ASBESTOS EVALUATION FINDINGS REPORT BY QUALIFIED TESTING LABORATORY.

BURNING OF REMOVED MATERIALS FROM DEMOLISHED STRUCTURES WILL NOT BE PERMITTED ON SITE.

CONDUCT DEMOLITION OPERATIONS AND REMOVAL OF DEBRIS TO ENSURE MINIMUM INTERFERENCE WITH ROADS, STREET WALKS, OTHER ADJACENT OCCUPIEDS PRACE OR USED FACILITIES:

MAINTAIN EXISTING UTILITIES INDICATED TO REMAIN, KEEP IN SERVICE, PROTEC AGAINST DAMAGE DURING DEMOLITION OPERATION.

DISCONNECT AND SEAL UTILITIES SERVING STRUCTURES TO BE DEMOLISHED, ADJACENT FACILITIES TO REMAIN.

PROVIDE INTERIOR, EXTERIOR SHORING, BRACING, OR SUPPORT TO PREVENT MOVEMENT, SETTLEMENT OR COLLAPSE OF STRUCTURES TO BE DEMOLISHED ADJACENT FACILITIES TO REMAIN.

COORDINATE WITH STRUCTURAL ENGINEER PRIOR TO COMMENCEMENT WORK REMOVAL OF ANY LOAD BEARING WALL OR STRUCTURAL ELEMENT.

REFER TO STRUCTURAL DRAWINGS FOR ADDITIONAL STRUCTURAL DEMOLITION.

PROVIDE INTERIOR, EXTERIOR SHORING, BRACING, OR SUPPORT TO PREVENT MOVEMENT, SETTLEMENT OR COLLAPSE OF STRUCTURES TO REMAIN.


NO MASONRY WALL OR PORTION THEREOF AND /OR BEARING PARTITION WALL SHALL BE REMOVED BY THE CONTRACTOR PRIOR TO ISSUANCE OF CITY APPROVED REMEDIAL DETAILS.

 \triangleleft 5 7 1 7 S.W. 8th Street. Tel: (305) 260 - 933: 960 N OCEAN RESIDENCE


CARD

EXISTING / DEMO ELEVATIONS



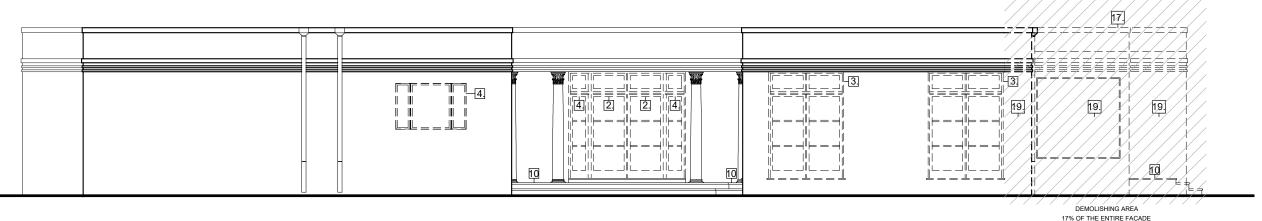

EXISTING / DEMO ELEVATION 01 SCALE 3/32" = 1'-0"

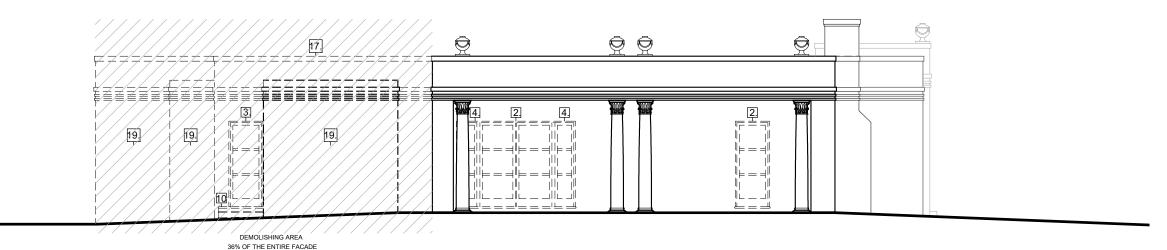

EXISTING / DEMO ELEVATION 02 SCALE 3/32" = 1'-0"

DEMOLITION LEGEND: 2 EXTERIOR DOOR TO BE REMOVED AND REPLACED. 3 EXTERIOR DOOR TO BE REMOVED. $\boxed{4}$ WINDOWS TO BE REMOVED AND REPLACED. 10 STEPS TO BE DEMOLISHED. 15 EXISTING STRUCTURE TO BE REMOVED. [6] EXISTING SKYLIGHT TO BE REMOVED. 17 EXISTING PARAPET TO BE REMOVED. 18 EXISTING ROOF TO BE REMOVED.

19 EXISTING WALL TO BE REMOVED.


PROPERTY NOTE: EXISTING FINISH FLOOR ELEVATION; 0'-0" = 7.00' N.A.V.D.

DEMOLITION NOTES:


- COMPLY WITH ALL PERTINENT REGULATIONS, GOVERNMENT AGENCIES AND FEDERAL, STATE AND LOCAL ORDINANCES.
- GENERAL CONTRACTOR SHALL EXAMINE THE SITE AND COME FAMILIAR WITH CONDITIONS AFFECTING THE WORK BEFORE SUBMITTING THE BIDS.
- GENERAL CONTRACTOR SHALL BE RESPONSIBLE FOR OBTAINING ALL REQUIRED PERMITS AND PAYING FOR ALL PERMITS FEES. 13.
- THE DEMOLITION PLAN IS SHOWN IN ITS ENTIRETY TO INDICATE THE EXTEND OF DEMOLITION. THE CONTRACTOR SHALL COORDINATE WITH THE STRUCTURAL ENGINEER AND SEQUENCE THE DEMOLITION TO MAINTAIN STABILITY OF THE EXISTING STRUCTURE AND SAFETY.
- BUILDING TO BE DEMOLISHED MUST BE VACATED PRIOR TO START OF WORK.
- USE OF EXPLOSIVES WILL NOT BE PERMITTED.
- OWNER SHALL SUBMIT AN ASBESTOS EVALUATION FINDINGS REPORT BY QUALIFIED TESTING LABORATORY.
- BURNING OF REMOVED MATERIALS FROM DEMOLISHED STRUCTURES WILL NOT BE PERMITTED ON SITE.
- CONDUCT DEMOLITION OPERATIONS AND REMOVAL OF DEBRIS TO ENSURE MINIMUM INTERFERENCE WITH ROADS, STREET WALKS, OTHER ADJACENT OCCUPIED SPACE OR USED FACILITIES:

- ITEMS OF SALVAGEABLE VALUE TO OWNER MAY BE REMOVED FROM STRUCTURE AS WORK PROGRESSES ALVAGED ITEMS MUST BE STORED AND PROTECTED AS THEY ARE REMOVED, COORDINATED WITH OWNER.
- MAINTAIN EXISTING UTILITIES INDICATED TO REMAIN, KEEP IN SERVICE, PROTECT AGAINST DAMAGE DURING DEMOLITION OPERATION. DISCONNECT AND SEAL UTILITIES SERVING STRUCTURES TO BE DEMOLISHED, ADJACENT FACILITIES TO REMAIN.
- PROVIDE INTERIOR, EXTERIOR SHORING, BRACING, OR SUPPORT TO PREVENT MOVEMENT, SETTLEMENT OR COLLAPSE OF STRUCTURES TO BE DEMOLISHED ADJACENT FACILITIES TO REMAIN.
- COORDINATE WITH STRUCTURAL ENGINEER PRIOR TO COMMENCEMENT WORK REMOVAL OF ANY LOAD BEARING WALL OR STRUCTURAL ELEMENT.
- REFER TO STRUCTURAL DRAWINGS FOR ADDITIONAL STRUCTURAL DEMOLITION
- PROVIDE INTERIOR, EXTERIOR SHORING, BRACING, OR SUPPORT TO PREVENT MOVEMENT, SETTLEMENT OR COLLAPSE OF STRUCTURES TO REMAIN.
- NO MASONRY WALL OR PORTION THEREOF AND /OR BEARING PARTITION WALL SHALL BE REMOVED BY THE CONTRACTOR PRIOR TO ISSUANCE OF CITY APPROVED REMEDIAL DETAILS.


 \triangleleft 960 N OCEAN RESIDENCE EXISTING / DEMO ELEVATIONS

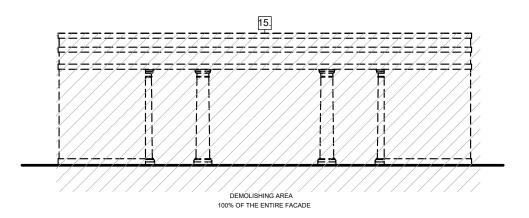


EXISTING / DEMO ELEVATION (CABANA) SCALE 1/8" = 1'-0"

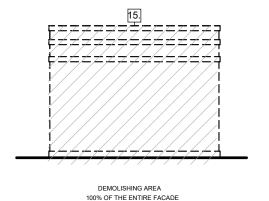

03 EXISTING / DEMO ELEVATION (CABANA)
SCALE 1/8" = 1'-0"

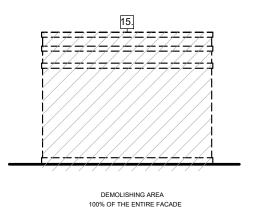

02 EXISTING / DEMO ELEVATION (CABANA) SCALE 1/8" = 1'-0"

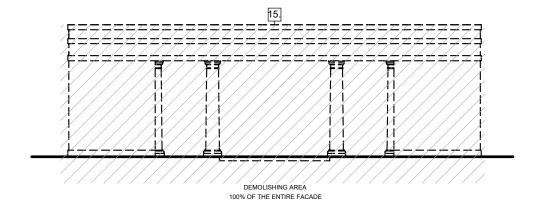

EXISTING / DEMO ELEVATION (CABANA) SCALE 1/8" = 1'-0"

PROPERTY NOTE: EXISTING FINISH FLOOR ELEVATION; 0'-0" = 7.00' N.A.V.D.

DEMOLITION LEGEND:

- 2 EXTERIOR DOOR TO BE REMOVED AND REPLACED.
- $\ensuremath{\ensuremath{\,\square}}$ EXTERIOR DOOR TO BE REMOVED.
- $\boxed{4}$ WINDOWS TO BE REMOVED AND REPLACED.
- 10 STEPS TO BE DEMOLISHED.
- 15 EXISTING STRUCTURE TO BE REMOVED.
- [6] EXISTING SKYLIGHT TO BE REMOVED.
- 17 EXISTING PARAPET TO BE REMOVED.

18 EXISTING ROOF TO BE REMOVED. 19 EXISTING WALL TO BE REMOVED.

- COMPLY WITH ALL PERTINENT REGULATIONS, GOVERNMENT AGENCIES AND FEDERAL, STATE AND LOCAL ORDINANCES.
- GENERAL CONTRACTOR SHALL EXAMINE THE SITE AND COME FAMILIAR WITH CONDITIONS AFFECTING THE WORK BEFORE SUBMITTING THE BIDS.
- GENERAL CONTRACTOR SHALL BE RESPONSIBLE FOR OBTAINING ALL REQUIRED PERMITS AND PAYING FOR ALL PERMITS FEES. 13.
- THE DEMOLITION PLAN IS SHOWN IN ITS ENTIRETY TO INDICATE THE EXTEND OF DEMOLITION. THE CONTRACTOR SHALL COORDINATE WITH THE STRUCTURAL ENGINEER AND SEQUENCE THE DEMOLITION TO MAINTAIN STABILITY OF THE EXISTING STRUCTURE AND SAFETY.
- BUILDING TO BE DEMOLISHED MUST BE VACATED PRIOR TO START OF WORK.
- USE OF EXPLOSIVES WILL NOT BE PERMITTED.
- OWNER SHALL SUBMIT AN ASBESTOS EVALUATION FINDINGS REPORT BY QUALIFIED TESTING LABORATORY.
- BURNING OF REMOVED MATERIALS FROM DEMOLISHED STRUCTURES WILL NOT BE PERMITTED ON SITE.
- CONDUCT DEMOLITION OPERATIONS AND REMOVAL OF DEBRIS TO ENSURE MINIMUM INTERFERENCE WITH ROADS, STREET WALKS, OTHER ADJACENT OCCUPIED SPACE OR USED FACILITIES:

- ITEMS OF SALVAGEABLE VALUE TO OWNER MAY BE REMOVED FROM STRUCTURE AS WORK PROGRESSES SALVAGED HIEMS MUST BE STORED AND PROTECTED AS THEY ARE REMOVED, COORDINATED WITH OWNER.
- MAINTAIN EXISTING UTILITIES INDICATED TO REMAIN, KEEP IN SERVICE, PROTECT AGAINST DAMAGE DURING DEMOLITION OPERATION. DISCONNECT AND SEAL UTILITIES SERVING STRUCTURES TO BE DEMOLISHED, ADJACENT FACILITIES TO REMAIN.
- PROVIDE INTERIOR, EXTERIOR SHORING, BRACING, OR SUPPORT TO PREVENT MOVEMENT, SETTLEMENT OR COLLAPSE OF STRUCTURES TO BE DEMOLISHED ADJACENT FACILITIES TO REMAIN.
- COORDINATE WITH STRUCTURAL ENGINEER PRIOR TO COMMENCEMENT WORK REMOVAL OF ANY LOAD BEARING WALL OR STRUCTURAL ELEMENT.
- REFER TO STRUCTURAL DRAWINGS FOR ADDITIONAL STRUCTURAL DEMOLITION
- PROVIDE INTERIOR, EXTERIOR SHORING, BRACING, OR SUPPORT TO PREVENT MOVEMENT, SETTLEMENT OR COLLAPSE OF STRUCTURES TO REMAIN.
- NO MASONRY WALL OR PORTION THEREOF AND /OR BEARING PARTITION WALL SHALL BE REMOVED BY THE CONTRACTOR PRIOR TO ISSUANCE OF CITY APPROVED REMEDIAL DETAILS.

 \triangleleft 960 N OCEAN RESIDENCE

FIRST ARCOM SUBMITTAL

CARDINALE RESIDENCE 960 N OCEAN BLVD PALM BEACH, FL 33480

LANDSCAPE ARCHITECT:
LAGUARDIA DESIGN LANDSCAPE
ARCHITECTURE P.C.
PO BOX 268 - 38 SCUTTLE HOLE ROAD
WATERMILL NY, 11976
T: (631) 726-1403
F: (631) 726-1478

117 EAST 24TH STREET NEW YORK, NY 10010

3725 SOUTH DIXIE HIGHWAY WEST PALM BEACH, FL 33405

PROJECT TEAM:
CHRIS LAGUARDIA - CHRIS@LAGUARDIADESIGN.COM, x101
JUSTIN LEANZA - JUSTIN@LAGUARDIADESIGN.COM, x120

ARCHITECT:
PORTUONDO PEROTTI ARCHITECTS, INC.
5717 SW 8 ST, SUITE 200
MIAMI, FL 33144
T: 305.260.9331

GENERAL CONTRACTOR: THE CURY GROUP 1475 CENTREPARK BLVD. SUITE 100 WEST PALM BEACH, FL 33401 T: 561.533.8888

SURVEYOR:
WALLACE SURVEYING CO.
5553 VILLAGE BOULEVARD
WEST PALM BEACH, FL, 33407
T: 561.640.4551

GENERAL CONDITIONS:

UNLESS NOTED OTHERWISE HEREIN, THE GENERAL CONDITIONS OF THE STANDARD FORM OF AGREEMENT BETWEEN OWNER AND CONTRACTOR SHORT FORM AGREEMENT FOR SMALL CONSTRUCTION CONTRACT AIA DOC #A107 DATED 4/87 SHALL APPLY.

CONTRACTOR SHALL OBTAIN ALL INSPECTIONS & APPROVALS AS REQUIRED, INCLUDING CERTIFICATE OF OCCUPANCY.

SUBSTITUTIONS SHALL NOT BE MADE WITHOUT WRITTEN AUTHORIZATION BY THE LANDSCAPE ARCHITECT.

THE PREMISES SHALL BE KEPT REASONABLY CLEAN AT ALL TIMES.

AT THE COMPLETION OF WORK, CONTRACTOR

SHALL REMOVE ALL WASTE MATERIALS,
TOOLS, RUBBISH, ETC., CLEAN ALL GLASS,
AND LEAVE WORK BROOM CLEAN, UNLESS
OTHERWISE SPECIFIED.

CONTRACTOR SHALL CARRY LIABILITY INSURANCE TO PROTECT CONTRACTOR, OWNER AND ARCHITECT, AS WELL AS WORKMAN'S COMPENSATION IN AMOUNTS AS REQUIRED BY LAW. ALL WORK SHALL COMPLY WITH STATE AND LOCAL CODES.

THE CONTRACTOR SHALL INDEMNIFY AND HOLD HARMLESS THE OWNER AND THE LANDSCAPE ARCHITECT AND THEIR AGENTS AND EMPLOYEES FROM AND AGAINST ALL **CLAIMS, DAMAGES, LOSSES AND EXPENSES INCLUDING ATTORNEYS' FEES ARISING OUT OF** OR RESULTING FROM THE PERFORMANCE OF THE WORK, PROVIDED SUCH CLAIM, DAMAGE, LOSS OR EXPENSE (A) IS ATTRIBUTABLE TO **BODILY INJURY, SICKNESS, DISEASE, OR** DEATH, OR TO INJURY TO OR DESTRUCTION OF TANGIBLE PROPERTY (OTHER THAN THE WORK ITSELF) INCLUDING THE LOSS OF USE RESULTING THEREFROM, AND (B) IS CAUSED IN WHOLE OR IN PART BY ANY NEGLIGENT ACT OR OMISSION OF THE CONTRACTOR, OR SUBCONTRACTOR, ANYONE DIRECTLY OR INDIRECTLY EMPLOYED BY ANY OF THEM OR ANYONE FOR WHOSE ACTS OF THEM MAY BE LIABLE, REGARDLESS OF WHETHER OR NOT IT IS CAUSED IN PART BY A PARTY INDEMNIFIED HEREUNDER.

ALL WORK AND MATERIALS INCLUDING BUT NOT LIMITED TO MASONRY, SWIMMING POOL, DRAINAGE AND GRADING, ELECTRICAL, AND CARPENTRY ARE TO BE CAREFULLY SUPERVISED BY THE CONTRACTOR TO BE SURE THAT THEY ARE IN ACCORDANCE WITH THE DRAWINGS, SPECIFICATIONS, APPLICABLE CODES AND GOOD PRACTICE. DEVIATIONS FROM THE DRAWINGS AND SPECIFICATIONS SHALL NOT BE PERMITTED UNLESS AUTHORIZED IN WRITING BY THE LANDSCAPE ARCHITECT. THE CONTRACTOR SHALL BE RESPONSIBLE FOR ANY SHOP DRAWINGS WHICH MAY BE REQUIRED.

THE CONTRACTOR SHALL VERIFY ALL CONDITIONS AT THE SITE. ANY DISCREPANCIES MUST BE BROUGHT TO THE ATTENTION OF THE LANDSCAPE ARCHITECT PRIOR TO COMMENCEMENT OF CONSTRUCTION. THE CONTRACTOR SHALL BE RESPONSIBLE FOR CORRECTIONS NOT REPORTED ONCE WORK HAS STARTED.

OWNERSHIP OF DOCUMENTS:
THESE DRAWINGS AND SPECIFICATIONS ARE INSTRUMENTS OF THE SERVICE AND SHALL REMAIN THE PROPERTY OF THE LANDSCAPE ARCHITECT WHETHER OR NOT THE PROJECT FOR WHICH THEY ARE MADE IS EXECUTED. THEY ARE NOT TO BE USED ON ANY OTHER PROJECT EXCEPT BY THE WRITTEN AUTHORIZATION OF THE LANDSCAPE ARCHITECT.

DO NOT SCALE THE DRAWINGS.

IF A DIMENSION IS NEEDED THAT DOES NOT EXIST ON THE DRAWINGS CONTACT THE LANDSCAPE ARCHITECT FOR ADDITIONAL INFORMATION.

CHANGE ORDERS, DELETIONS, ADDITIONS:
ANY MODIFICATIONS TO WORK OUTLINED IN
THE ATTACHED DRAWING(S), OR THE
ASSOCIATED APPROVED CONTRACT, MUST BE
APPROVED IN WRITING BEFORE EXECUTING THE
WORK. THIS INCLUDES, ADDITIONS,
SUBSTITUTIONS, DELETIONS OR ADJUSTMENTS
TO THE SCOPE OF APPROVED WORK. ANY
INVOICES FOR ADDITIONAL WORK, THAT HAS
NOT BEEN APPROVED IN WRITING, SHALL BE
CONSIDERED INVALID AND WILL NOT BE
FUNDED.

CORRECTION OF WORK: THE CONTRACTOR SHALL RE-EXECUTE ANY WORK THAT FAILS TO CONFORM TO THE REQUIREMENTS OF THE CONTRACT AND SHALL REMEDY DEFECTS TO TO FAULTY MATERIALS OR WORKMANSHIP UPON WRITTEN NOTICE FROM THE LANDSCAPE ARCHITECT FOR A PERIOD OF (90) DAYS FROM THE DATE OF COMPLETION OF THE CONTRACT.

SCHEDULE A PRE-CONSTRUCTION MEETING WITH THE LANDSCAPE ARCHITECT AT LEAST (7) DAYS BEFORE BEGINNING WORK. THE PURPOSE OF THE CONFERENCE IS TO REVIEW ANY QUESTIONS THE CONTRACTOR MAY HAVE REGARDING THE WORK, ADMINISTRATIVE PROCEDURES DURING CONSTRUCTION AND PROJECT WORK SCHEDULE.

DURING INSTALLATION KEEP THE SITE FREE OF TRASH, PAVEMENTS REASONABLE CLEAN, AND WORK AREA IN AN ORDERLY CONDITION AT THE END OF EACH DAY. ONCE INSTALLATION IS COMPLETE, WASH ALL SOIL FROM PAVEMENTS AND OTHER STRUCTURES.

DRAWING LIST:						
SHEET NAME:	COMMENTS:	CURRENT REVISION:				
CS COVER SHEET	GC / LC SCOPE	02-07-2024 FIRST ARCOM SUBMITTAL				
L1.1 EXISTING CONDITIONS PLAN	GC / LC SCOPE	02-07-2024 FIRST ARCOM SUBMITTAL				
L2.1 SITE PLAN	GC / LC SCOPE	02-07-2024 FIRST ARCOM SUBMITTAL				
L2.2 ELEVATIONS	GC / LC SCOPE	02-07-2024 FIRST ARCOM SUBMITTAL				
L5.1 ARCOM LANDSCAPE: OPEN SPACE	LC SCOPE	02-07-2024 FIRST ARCOM SUBMITTAL				
L5.2 ARCOM LANDSCAPE: PLANTING PLAN	LC SCOPE	02-07-2024 FIRST ARCOM SUBMITTAL				
L8.1 ARCOM LANDSCAPE: DETAILS	LC SCOPE	02-07-2024 FIRST ARCOM SUBMITTAL				



SPECIFICATIONS

- ALL BIDS TO REFERENCE BID SET DATED
MONTH DAY, YEAR AND THE SPECIFICATIONS
INCLUDED ON THIS PAGE.

- THE FOLLOWING SPECIFICATIONS CORRESPOND TO THE LINE ITEMS LISTED ON THE ATTACHED BID SHEET. ALL CONTRACTORS MUST COMPLETE ATTACHED BID SHEET.

A. SITE PREPARATION & REMOVALS

1. UTILITY MARK-OUT: ALL EXISTING UTILITIES
TO BE MARKED OUT PRIOR TO EXCAVATION.
EXISTING WELLS, ELECTRIC, TELEPHONE,
CABLE, GAS, SEPTIC, DRYWELLS, ETC. TO BE
IDENTIFIED. MARK-OUT TO BE MAINTAINED
THROUGHOUT DURATION OF PROJECT.
PROPOSED UTILITIES TO BE MARKED OUT AND
REVIEWED WITH LANDSCAPE ARCHITECT
PRIOR TO INSTALLATION. ALL UTILITIES
DESIGNATED AS 'TO BE DEMOLISHED' SHALL
BE UNHOOKED AT SOURCE (IE: TANK, PANEL)
AND PROPERLY ABATED. CERTIFICATES &
INSPECTIONS, WHERE APPLICABLE, ARE
RESPONSIBILITY OF THE CONTRACTOR.

2. EXISTING VEGETATION CLEARING AND REMOVAL: ALL EXISTING VEGETATION DESIGNATED AS 'TO BE REMOVED' PER SHEET L3.1 - DEMO, STAGING & TRANSPLANT PLAN OR AS TAGGED IN FIELD PER LANDSCAPE ARCHITECT. ALL DEBRIS AND STUMPS ARE TO BE COMPLETELY REMOVED AND DUMPED OFF SITE.

3. HARDSCAPE DEMOLITION AND REMOVAL:
EXISTING STRUCTURES DESIGNATED AS 'TO
BE REMOVED' PER SHEET L3.1 - DEMO,
STAGING & TRANSPLANT PLAN. ALL DEBRIS
TO BE HAULED OFF SITE IN DUMPSTER(S)
PROVIDED BY CONTRACTOR. DUMPSTER
LAYOUT AS PER SHEET L3.1 - DEMO, STAGING
& TRANSPLANT PLAN.

4. TRANSPLANTING: ALL EXISTING TREES AND SHRUBS DESIGNATED AS 'TO BE TRANSPLANTED' PER SHEET L3.1 - DEMO, STAGING & TRANSPLANT PLAN OR AS TAGGED IN FIELD PER LANDSCAPE ARCHITECT. TRANSPLANTED MATERIAL TO BE LOCATED IN STAGING AREA AS PER SHEET L3.1 - DEMO, STAGING & TRANSPLANT PLAN. CONTRACTOR TO REGULARLY MONITOR THE **HEALTH OF TRANSPLANTS AND IRRIGATE BY** HAND AT LEAST TWICE WEEKLY OR MORE AS NECESSARY THROUGHOUT DURATION OF CONSTRUCTION. TRANSPLANTS TO BE HEELED NO LESS THAN 12" INTO EXISTING GRADE AND MULCHED WITH 3" LAYER OF SHREDDED HARDWOOD MULCH. TRANSPLANT PRICE TO INCLUDE COST OF DIGGING, PLACING OR STAGING AND PLACING MATERIAL, AS INDICATED IN TRANSPLANT SCHEDULE. PLANTS TO RECEIVE ROOT GROWTH STIMULANT FOLLOWING RELOCATION, EITHER TO STAGING AREA OR FINAL LOCATION.

5. STRIP EXISTING LAWN: EXISTING LAWN TO BE STRIPPED AND HAULED AWAY... OR... COMPOSTED INTO PILES. WINDROWS TO RECEIVE ANNUAL RYE GRASS SEED TO CONTROL WIND EROSION AND DUST.

6. STRIP TOPSOIL: EXISTING TOPSOIL WITHIN THE PROJECT LIMIT OF DISTURBANCE IS TO BE STRIPPED AND STOCKPILED INTO 6' HT. WINDROWS AT THE STAGING AREA PER SHEET L3.1 - DEMO, STAGING & TRANSPLANT PLAN. ALL EXISTING TOP-SOIL TO REMAIN ON-SITE (UNLESS OTHERWISE NOTED).

7. EXPORT FILL: EXCESS FILL TO BE REMOVED AND HAULED OFFSITE. REVIEW QUANTITIES WITH LANDSCAPE ARCHITECT PRIOR TO REMOVAL.

8. EROSION CONTROL FENCING: LAYOUT AS PER SHEET SHEET L3.1 - DEMO, STAGING & TRANSPLANT PLAN AND IN ACCORDANCE WITH DETAIL #, SHEET L#.

9. SITE PROTECTION FENCING: LAYOUT AS PER SHEET SHEET L3.1 - DEMO, STAGING & TRANSPLANT PLAN AND IN ACCORDANCE WITH DETAIL #, SHEET L#.

10. UTILITY UPGRADE, RELOCATION,
ABATEMENT: AS PER SHEET SHEET L3.1 DEMO, STAGING & TRANSPLANT PLAN.
CONTRACTOR TO PROVIDE LANDSCAPE
ARCHITECT WITH ACCURATE AS BUILT
LOCATIONS OF ALL NEW/REVISED UTILITY
LINES.

B. GRADING AND DRAINAGE

1. ROUGH GRADING: PROVIDE AND PLACE CLEAN SANDY LOAM FILL TO AREAS AS INDICATED ON SHEET L4.1 - GRADING AND DRAINAGE

PLAN. FILL TO BE PLACED IN 12" LIFTS AND TRACK COMPACTED. ALLOWANCE SHOULD BE MADE FOR LANDSCAPE CONTRACTOR TO INSTALL 6" OF TOPSOIL (OR SOIL MIX PER LANDSCAPE ARCHITECT) TO ALL LAWN AND PLANTING AREAS AS PER SHEET L2.1 - SITE PLAN.

2. SUB-SOILING: UPON COMPLETION OF ROUGH GRADING AND PRIOR TO THE SPREADING OF ANY TOPSOIL, SUB-SOILING SHALL OCCUR TO A DEPTH OF 18" AT ALL PROPOSED PLANTING AND LAWN LOCATIONS SHOWN ON SHEET L5.1
- PLANTING PLAN. SUB-SOILING TO BE DONE WITH A CULTIVATOR HOOK TO ALLEVIATE CONSTRUCTION COMPACTION. ALL EXISTING CLAY SOILS ENCOUNTERED DURING PLANTING BED PREPARATION TO BE HAULED OFF-SITE.

3. BED PREP OF PLANTING AREAS: BEDS TO BE FILLED WITH 'HUDSON RIVER PLANTING MIX - TYPE 'A', AS PER EAST COAST MINES.

4. IMPORTED TOPSOIL: TOPSOIL TO BE FERTILE AND FRIABLE. TOPSOIL TO CONTAIN LESS THAN 5% TOTAL VOLUME OF THE COMBINATION OF SUBSOIL, REFUSE, ROOTS LARGER THAN 1" DIAMETER, HEAVY, STICKY OR STIFF CLAY, STONES LARGER THAN 2" IN DIAMETER, NOXIOUS SEEDS, STICKS, BRUSH, LITTER, OR ANY SUBSTANCE DELETERIOUS TO PLANT GROWTH. TOPSOIL SHALL BE SUITABLE FOR GERMINATION OF SEEDS AND THE SUPPORT OF VEGETATIVE GROWTH. IMPORTED TOPSOIL SHALL NOT CONTAIN WEED SEEDS IN QUANTITIES THAT CAUSE NOTICEABLE WEED INFESTATIONS IN FINAL PLANTING BEDS.

4. IMPORTED COMPOST: COMPOST TO BE BLENDED AND GROUND LEAF, WOOD, AND OTHER PLANT BASED MATERIAL, COMPOSTED FOR A MINIMUM OF 9 MONTHS AND AT TEMPERATURE SUFFICIENT TO BREAK DOWN ALL WOODY FIBERS, SEEDS AND LEAF STRUCTURES, FREE OF TOXIC MATERAL AT LEVELS THAT ARE HARMFUL TO PLANTS OR HUMANS. SOURCE MATERIAL SHALL BE YARD WASTE TRIMMINGS BLENDED WITH OTHER PLANT OR MANURE BASED MATERIAL DESIGNED TO PRODUCE COMPOST HIGH IN FUNGAL MATERIAL.

4. IMPORTED SANDY FILL: SAND TO BE CLEAN AND FREE OF TOXIC MATERIALS.

5. RESPREAD EXISTING TOPSOIL: RESPREAD EXISTING STOCKPILED TOPSOIL AS NEEDED AS PER SHEET SHEET L4.1 - GRADING & DRAINAGE PLAN.

6. CLAY REMOVAL: ALL CLAY ENCOUNTERED DURING GRADING & DRAINAGE TO BE REMOVED AND HAULED OFF-SITE.

7. PRECAST DRYWELLS: PROVIDE AND INSTALL CONCRETE DRYWELLS LOCATED AND SIZED PER SHEET L4.1 - GRADING AND DRAINAGE PLAN AND IN ACCORDANCE WITH DETAIL #, SHEET L#.

8. PLANTING & LAWN DRAIN INLET BOX: LAYOUT AND INSTALL DRAINS @ ASSOCIATED PIPING AS PER SHEET SHEET L4.1 - GRADING PLAN AND IN ACCORDANCE WITH DETAIL #, SHEET L#.

9. DRIVEWAY CATCH BASINS: LAYOUT AND INSTALL DRAINS @ ASSOCIATED PIPING AS PER SHEET SHEET L4.1 - GRADING PLAN AND IN ACCORDANCE WITH DETAIL #, SHEET L#.

10. SAND TRENCHES IN LAWN: LAYOUT AND INSTALL WICKS AS PER SHEET SHEET L4.1 - GRADING PLAN AND IN ACCORDANCE WITH DETAIL #, SHEET L#. ALL CLAY ENCOUNTERED TO BE REMOVED AND HAULED OFF-SITE.

11. SAND TRENCHES IN LAWN: LAYOUT AND INSTALL WICKS AS PER SHEET SHEET L4.1 - GRADING PLAN AND IN ACCORDANCE WITH DETAIL #, SHEET L#. ALL CLAY ENCOUNTERED TO BE REMOVED AND HAULED OFF-SITE.

12. MULCH: INSTALL A 3" LAYER OF SHREDDED HARDWOOD MULCH (HAMPTON ESTATE BLACK MULCH) TO ALL NEW SHRUB PLANTINGS AND TREE BERMS. INSTALL 3" 'SWEET PEET' AT ALL PERENNIAL BED LOCATIONS.

C. DRIVEWAY

1. STRIP & STOCKPILE EXISTING DRIVEWAY

BASE: EXISTING DRIVEWAY CURBING TO BE
REMOVED AND HAULED OFF SITE. EXISTING
DRIVEWAY SUB-BASE AND GRAVEL FINISH TO
BE STRIPPED AND STOCKPILED FOR USE AS
BASE MATERIAL IN PROPOSED DRIVEWAY
LOCATION.

2. COMPACTED MARL BASE: PLACE 6-8" OF MARL SUB-BASE MIX INTO PROPOSED DRIVEWAY LOCATION SHOWN ON SHEET L2.

SITE PLAN AND IN ACCORDANCE WITH DETAIL
#, SHEET L#. MARL TO BE COMPACTED WITH A VIBRATORY COMPACTOR TO 20,000 PSI. MAIL TO BE FREE OF ORGANIC MATER ALS.

3. STEEL DRIVEWAY EDGE: O BE LAID OUT PER SHEET L2.1 - SITE PLACEIN A CORDANCE WITH DETAIL #, SHEET L#, STEEL ELGING TO BE 'HOT ROLLED' STEEL ONL'S ROUGH WELDS TO BE GROUND SMOOTH. STEEL SHALL PITCHA MINIMUM OF 1/8' PER FOUT AWAY FROM ALL STRUCTURES TO LOWE WAY DRAWS OR SWALES ALL DO DEGREE CORNERS TO BE (2) WELDED NY CES. NO BENDS AT NW COLDITON.

DRIVEWAY FINISH: TO BE 1400 OU PER SHEEN 2.1 - SITE PLAN IN ACCOMDANCE WITH JET IIL #, SHEET L#. ASPHALT AGGREGATE TO HAY & A \frac{3}{8}" TO \frac{3}{4}" TOLERANCE. ASPHALT TO BE ROLLED WITH A VIBRATORY ROLLER TO 6,000 PSI. GRAVEL FINISH SAMPLE TO BE APPROVED BY LANDSCAPE ARCHITECT.

5. PVC SLEEVES: PROVIDE AND INSTALL 6"
SCHEDULE 80 PVC CONDUIT SLEEVES IN
ACCORDANCE WITH SHEET L2.1 - SITE PLAN.
SLEEVES TO BE USED FOR FUTURE LIGHTING,
IRRIGATION, ETC.

6. JEEP TRACK: LAYOUT AS PER SHEET

SHEET L2.1 - SITE PLAN AND IN ACCORDANCE
WITH DETAIL #, SHEET L#.

7. GRASS PAVE GEOBLOCK PAVERS: LAYOUT AS PER SHEET SHEET L2.1 - SITE PLAN AND IN ACCORDANCE WITH DETAIL #, SHEET L#.

SHEET L2.1 - SITE PLAN AND IN ACCORDANCE WITH DETAIL #, SHEET L#.

D. SWIMMING POOL

8. DRIVEWAY APRONS: LAYOUT AS PER SHEET

1. POOL AND SPA SPECS: <u>SEE SHEET L7.1</u>

E. GENERAL HARDSCAPES (MASONRY)
GENERAL NOTES:

- NO CONCRETE WORK SHALL BE PERMITTED DURING TEMPERATURES BELOW 40 DEGREES FAHRENHEIT AND FALLING. NO CONCRETE SHALL BE PLACED ON FROZEN SURFACES. NO ADDITIVES SHALL BE PERMITTED, UNLESS OTHERWISE SPECIFIED BY LANDSCAPE ARCHITECT. ALL POURED WALLS, COLUMNS AND FOOTINGS SHALL REST ON VIRGIN SOIL. NO FOOTING SHALL BE SET HIGHER OR LOWER THAN 30 DEGREES ANGLE FROM ANOTHER FOOTING. SOIL BEARING CAPACITY SHALL BE ASSUMED TO BE MINIMUM 3000 PSI, SUBJECT TO FIELD INSPECTION.

- ALL CONCRETE TO BE MIN. 3000 PSI @ 28 DAYS, UNLESS OTHERWISE SPECIFIED BY LANDSCAPE ARCHITECT. PROVIDE ALL NECESSARY SLEEVES AND VENTS.

- REBAR SPACING AS SHOWN ON DETAILS SHEETS. SPLICE TOLERANCE OF 20x BAR DIAMETER MINIMUM. ALL STEEL REINFORCING BARS TO BE GRADE 60 STEEL UNLESS OTHERWISE SPECIFIED. WHERE CMU BLOCKING IS SPECIFIED USE ASTM 145 WITH FULL MORTAR BEDS AND FILL ALL CORES SOLID.

- GRANULAR FILL BELOW SLAB ON GRADE.

SOIL SHALL BE SAND AND GRAVEL MIXTURE WITH NO MORE THAN 5% PASSING THE 200 MESH SIEVE, FREE OF ORGANIC OR OTHER DELETERIOUS MATERIAL, WITH A MOISTURE CONTENT BETWEEN 3% AND 6%. IT SHALL BE PLACED IN HORIZONTAL LAYERS WITH A THICKNESS PRIOR TO COMPACTION NOT EXCEEDING 12". EACH LAYER SHALL BE COMPACTED WITH NO LESS THAN TWO (2) PASSES OF A VIBRATORY PAD TAMPER WEIGHING NO LESS THAN 500 POUNDS. COMPACTION SHALL ACHIEVE A MINIMUM OF 90% OF THE MAXIMUM DRY DENSITY IN ACCORDANCE WITH ASTM D-1557 (MODIFIED PROCTOR).

CONTRACTOR SHALL FULLY GUARANTEE FOR THE PERIOD OF TWO YEARS ALL MASONRY WORK. ALL WORK SHALL BE DONE A A WORKMANSHIP LIKE MANNER AND IN ACCORDANCE WITH STANDARD BUILDING PRACTICES.

1. FRONT ENTRY WALKWAY: LAYOUT AS PER SHEET <u>SHEET L2.1 - SITE PLAN</u> AND IN ACCORDANCE WITH *DETAIL #, SHEET L#.*

2. DINING TERRACE: LAYOUT AS PER SHEET SHEET L2.1 - SITE PLAN AND IN ACCORDANCE WITH DETAIL #, SHEET L#.

3. POOL TERRACE: LAYOUT AS PER SHEET SHEET L2.1 - SITE PLAN AND IN ACCORDANCE WITH DETAILS #, SHEET L#.

4. OUTDOOR KITCHEN: LAYOUT AND INSTALL IN ACCORDANCE WITH SHEETS L# & L# - GRILL ENCLOSURE DETAILS, PROVIDE NATURAL GAS, ELECTRICAL AND WATER SERVICE TO GRILL LOCATION. ALL WORK TO COMPLY WITH LOCAL AND NYS FIRE CODES. PROVIDE AND INSTALL UNITS PER MANUFACTURES SPECIFICATIONS.

5. MONOLITHIC STEPS AT FLOATING TERRACE:
LAYOUT AS PER SHEET SHEET L2.1 - SITE
PLAN AND IN ACCORDANCE WITH DETAIL #,
SHEET L#.

6. COMPACTED GRIT PATHWAYS: LAYOUT AS PER SHEET SHEET L2.1 - SITE PLAN AND INSTALLED IN ACCORDANCE WITH DETAIL # SHEET L#.

7. STEEL EDGING: LAYOUT AS VER SHELT SHEET L2.1 - SITE PLAN AND INSTALLED IN ACCORDANCE WITH DETAIL #, SAVET L#.

8. CUSTOM FIRE FEATURE LAYOUT AS PER
SHEET L2.1 - SITE YEAR AND IN ACCORDANCE
WITH DETAILS HOWN ON SHEET L# MASONRY DETAILS. PROVIDE NATURAL GAS
AND ELECTRICAL RVICE TO FIRE FEATURE
LOCATION, PROVIDE AND INSTALL
FIRE UNIT AS PER CODE REQUIREMENTS.
PROVIDE AND INSTALL PEMOTE IGNITION
SYSTEM PER CODE REQUIREMENTS. PROVIDE
AND INSTALL QUICK DISCONNECT SYSTEM.
PROVIDE AND INSTALL FIRE PICK - SAMPLE

TO BE PROVIDED TO LANDSCAPE ARCHITECT

F. GENERAL CONSTRUCTION (SITE CARPENTRY)

OR APPROVAL

1. DRICHWAY (ATES: PROVIDE PRICING FOR LUTOMATIC DRIVEWAY GATES AS SHOWN ON LUTET L2: 1- SITE PLAN AND IN ACCORDANCE WITH DE AIL #, SHEET L#. SUPPLY ALL GATE ELECTRIC, TELE-COMMUNICATION, AND TOUCH PADS, AND CONDUIT SLEEVES FROM HOUSE. CONTRACTOR TO PROVIDE SHOP DRAWINGS FOR LANDSCAPE ARCHITECT'S APPROVAL.

2. POOL ENCLOSURE FENCE: PROVIDE AND INSTALL POOL CODE FENCE AS SHOWN ON SHEET SHEET L2.1 - SITE PLAN AND IN ACCORDANCE WITH DETAIL #, SHEET L#.

3. CUSTOM POOL CODE PEDESTRIAN GATE
(DOUBLE GATE): CONSTRUCT POOL GATE TO
NYS CODE, AS SHOWN ON SHEET SHEET L#SITE PLAN AND IN ACCORDANCE WITH DETAIL
#, SHEET L#.

4. CUSTOM POOL CODE PEDESTRIAN GATE
(SINGLE GATE): CONSTRUCT POOL GATE TO
NYS CODE, AS SHOWN ON SHEET SHEET L#SITE PLAN AND IN ACCORDANCE WITH DETAIL
#, SHEET L#.

5. 6' HT. DOUBLE SIDED SOLID FENCE: LAYOUT AS PER SHEET L# - SITE PLAN AND IN ACCORDANCE WITH DETAIL #, SHEET L#.

6. 6' HT. SOUND ATTENDUATION FENCE: LAYOUT AS PER SHEET L# - SITE PLAN AND IN ACCORDANCE WITH DETAIL #, SHEET L#.

7. CUSTOM ARBOR: LAYOUT AS PER SHEET L#SITE PLAN AND IN ACCORDANCE WITH DETAIL
#, SHEET L#.

8. CUSTOM POOL EQUIPMENT ENCLOSURE:

IN ACCORDANCE WITH <u>DETAIL</u> #, <u>SHEET L#</u>.

9. CUSTOM TRASH ENCLOSURE: LAYOUT AS PER <u>SHEET L2.1 - SITE PLAN</u> AND IN ACCORDANCE

LAYOUT AS PER SHEET L2.1 - SITE PLAN AND

WITH <u>DETAIL #, SHEET L#</u>.

10. ACQ WALL WITH FULL CRIBBING: LAYOUT AS PER SHEET L2.1 - SITE PLAN AND IN

11. CUTTING GARDEN RAISED BEDS: LAYOUT AS PER <u>SHEET L2.1 - SITE PLAN</u> AND IN ACCORDANCE WITH *DETAIL* #, SHEET L#

ACCORDANCE WITH DETAIL #, SHEET L#.

G.PLANTING
GENERAL NOTES:

- ALL PLANTS TO CONFORM TO THE ANSI Z60.1
AMERICAN STANDARD FOR NURSERY STOCK,
MOST CURRENT EDITION. PLANTS TO CARRY A
FULL TWO YEAR GUARANTEE. WARRANTY
PERIOD TO BEGIN AT TIME OF SUBSTANTIAL
COMPLETION - THE DATE AT THE END OF
PLANTING, PLANTING SOIL, AND IRRIGATION
INSTALLATION WHERE THE LANDSCAPE
ARCHITECT ACCEPTS THAT ALL WORK IN
THESE SECTIONS IS COMPLETE. PLANTS TO BE
WATERED TWICE PER WEEK BY HAND UNTIL
AUTOMATIC IRRIGATION SYSTEM IS
OPERATIONAL. LAYOUT PLANTS ABOVE
GROUND FOR APPROVAL BY LANDSCAPE
ARCHITECT PRIOR TO PLANTING.

IN THE CASE OF A DISCREPANCY IN PLANT
QUANTITIES BETWEEN THE PLAN DRAWINGS
AND THE PLANT CALLOUTS, LIST OR PLANT

SCHEDULE, THE NUMBER OF PLANTS OR SQUARE FOOTAGE OF THE PLANTING BED ACTUALLY DRAWN ON THE PLAN SHALL BE DEEMED CORRECT AND PREVAIL.

PLANT SUBSTITUTIONS FOR PLANTS NOT AVAILABLE: SUBMIT ALL REQUESTS FOR SUBSTITUTIONS OF PLANT SPECIES, OR SIZE TO THE LANDSCAPE ARCHITECT, FOR APPROVAL, PRIOR TO PURCHASING THE PROPOSED SUBSTITUTION.

1. TREES: ALL TREES TO BE PLANTED IN ACCORDANCE WITH DETAILS #, SHEET L#.

2. EVERGREEN TREES: ALL TREES TO BE PLANTED IN ACCORDANCE WITH DETAILS #, SHEET L#.

3. <u>SHRUBS</u>: PROVIDE AND PLANT ALL SHRUBS AS INDICATED ON <u>SHEET L5.1 - PLANTING PLAN</u>.

4. GROUNDCOVERS, GRASSES & PERENNIALS: PROVIDE AND PLANT ALL GROUNDCOVERS, GRASSES & PERENNIALS AS INDICATED ON SHEET L5.1 - PLANTING PLAN.

5. SOD & FINE GRADING (INCLUDE TOPSOIL): SOD ALL LAWN AREAS AS INDICATED SHEET L5.1 - PLANTING PLAN. FROM DELEA SOD FARMS, OR EQUAL. SOD TO BE CUT INTO 2' x 5' ROLLS AND SET IN STAGGERED ROWS. PRICE TO INCLUDE IMPORTED 'HUDSON RIVER PLANTING MIX- TYPE B, AS PER EAST COAST MINES. PRICE TO INCLUDE ALL FINE GRADING AS PER SHEET L# - SITE PLAN TO BE PERFORMED WITH A LIGHT TRACK MACHINE. ANY LOOSE GRAVEL OR DEBRIS AT SURFACE OF TOP-SOIL TO BE REMOVED USING METAL HAND RAKES.

H. TENNIS COURT

1. RE-SURFACE COURT, INSTALL GATES & NEW NET POSTS: PATCH AND LEVEL COURT AS NEEDED TO MEET ELEVATIONS SHOWN ON SHEET L2.1 - SITE PLAN. INSTALL TENNIS PLAYING SURFACE IN ACCORDANCE WITH DETAIL #, SHEET L#. FINISH COLOR COATING SAMPLES TO BE PROVIDED FOR REVIEW AND APPROVAL BY CLIENT & LANDSCAPE ARCHITECT. PROVIDE AND INSTALL NEW CUSTOM NET POSTS AND TENNIS NET (HAMPTONS TENNIS OR EQUAL). PROVIDE AND INSTALL 6" LAYER OF GRAVEL AT TENNIS COURT BORDER - SAMPLE TO BE PROVIDED TO LANDSCAPE ARCHITECT FOR APPROVAL.

2. COURT RETAINING WALL: WALL TO BE 36" HT.
REINFORCED CONCRETE INSTALLED IN
ACCORDANCE WITH DETAIL #, SHEET L#.

* PROVIDE OPTION FOR STONE VENEER W/:
8" THICK WALL W/ #4 REBAR @ 12" O.C.B.W.

PENN WALL STONE VENEER
 2" MUD LAYER W/ S.S. MASONRY CLIPS

3. COURT PLAYING SURFACE: COURT TO BE INSTALLED IN ACCORDANCE WITH THE DETAILS & SPECIFICATIONS SHOWN ON SHEET L10 - COURT DETAILS. COURT PERIMETER BORDER TO BE 6"x12" LIMESTONE SET IN 2" MUD LAYER AND CONCRETE SLUMP FOOTING W/ (2) #4 REBAR EMBEDDED AND TIED @ 12" SPACING.

4. COURT DRAIN & DRYWELLS: DEDICATED COURT DRAIN INLET TO BE SET IN CONCRETE SLUMP FOOTING IN ACCORDANCE WITH DETAIL #, SHEET #. INLET TO BE TIED INTO (7) 4X8 PRECAST CONCRETE DRYWELL(S), W/TRAFFIC BEARING COVERS AND ACCESS COVER AS INDICATED ON PLANS. DRYWELL(S) TO BE WRAPPED W/FILTER FABRIC AND BACKFILLED W/CLEAN SAND.

5. <u>COURT FENCE</u>: FENCE TO BE 5' HT. BLACK VINYL COATED CHAIN LINK FENCE INSTALLED IN ACCORDANCE WITH <u>DETAIL</u> #, <u>SHEET L#</u>.

I. LANDSCAPE LIGHTING

1. PROPOSED OUTDOOR LIGHT FIXTURES TO BE LAID OUT PER SHEET L6.1 - ELECTICAL PLAN AND TIED INTO HOUSE SWITCH LOCATIONS.
ALL WORK TO CONFORM TO NYS ELECTRICAL CODE AND INSTALLED BY A LICENSED ELECTICTIAN. PROVIDE UL CERTIFICATE UPON COMPLETION. BUILDER TO PROVIDE EXTERIOR PULL BOXES FOR ALL CONNECTIONS.
PROVIDE ABOVE GROUND MOCKUP PRIOR TO BUYING WIRES. FINAL LOCATIONS OF TRANSFORMERS & PULL BOXES TO BE APPROVED BY LANDSCAPE ARCHITECT PRIOR TO INSTALLATION.

J. IRRIGATION

1. TAP INTO EXISTING PUBLIC WATER
SOURCE/EXISTING IRRIGATION
WELL/PROPOSED IRRIGATION WELL. PROVIDE
DEDICATED VALVE BOX, REGULATOR &
BACKWASH VALVE AND 2 HORSEPOWER
VARIABLE SPEED PUMP (MIN). FINAL LOCATION
OF WELLS AND VALVE BOXES TO BE
APPROVED BY LANDSCAPE CONTRACTOR
PRIOR TO INSTALLATION.

2. INSTALL AUTOMATIC WATERING SYSTEM FOR **ENTIRE PROPERTY. HEADS TO HAVE 50% OVERLAP IN COVERAGE AT ALL BEACHGRASS LOCATIONS.** ALL NEW TREE & SHRUB PLANTINGS TO RECEIVE 'NETA-FIM' DRIP **IRRIGATION AT THE MANUFACTURER'S** RECOMMENDED SPACING. DRIP LINES TO BE STAPLED DOWN WITH 9" GALVANIZED U-STAPLES AT 12" O.C. AND COVERED WITH MULCH. DECIDUOUS TREES TO BE ON DEDICATED DRIP ZONE. EVERGREEN SCREEN TREES TO BE ON DEDICATED DRIP ZONE WITH 'NETA-FIM' SPIRALED OVER ENTIRE TREE PIT AT 8" O.C.. PRIVET TO BE ON DEDICATED DRIP ZONE. PROVIDE (2) PRESSURIZED HOSE BIBS IN THE SYSTEM AND A PRESSURIZED BIB AT THE POOL EQUIPMENT. PROVIDE MINIMUM 18 ZONE CLOCK WITH SURGE PROTECTION. **IRRIGATION CLOCK LOCATION TO BE** APPROVED BY LANDSCAPE ARCHITECT PRIOR TO INSTALLATION. CONTRACTOR TO PROVIDE ITEMIZED BREAKDOWN OF INDIVIDUAL COMPONENTS OF SYSTEM INCLUDING

3. CONTRACTOR SHALL WARRANTY ALL IRRIGATION WORKMANSHIP AND MATERIALS FOR A PERIOD OF TWO FULL YEARS FOLLOWING THE ACCEPTANCE OF THE WORK. WARRANTY PERIOD TO BEGIN AT TIME OF SUBSTANTIAL COMPLETION - THE DATE AT THE END OF PLANTING, PLANTING SOIL, AND IRRIGATION INSTALLATION WHERE THE LANDSCAPE ARCHITECT ACCEPTS THAT ALL WORK IN THESE SECTIONS IS COMPLETE.

NUMBER OF HEADS AND FEET OF DRIP.

LANDSCAPE ARCHI

PROJECT DATA:

BASED ON SURVEY BY:

WALLACE SURVEYING CORP.

JOB NO: 10-1040, DATED 06/27/23

PBCTM#:
50-43-43-10-24-000-0260

26,552 SF

ZONE:
R-B | LOW DENSITY RESIDENTIAL
(50-PALM BEACH)

SEE CHART
FLOOD ZONE:
AE (EL. 6)

EASEMENT/OTHER:

COVERAGE

SEE PLAN

LOT AREA:

ANDSCADE LAGGERACHITE

SOLAGO LAGGERACHITE

SOLAGO

ANY MODIFICATIONS TO WORK OUTLINED IN THE ATTACHED DRAWING(S), OR THE ASSOCIATED APPROVED CONTRACT, MUST BE APPROVED IN WRITING BEFORE EXECUTING THE WORK. THIS INCLUDES, ADDITIONS, SUBSTITUTIONS, DELETIONS OR ADJUSTMENTS TO THE SCOPE OF APPROVED WORK. ANY INVOICES FOR ADDITIONAL WORK, THAT HAS NOT BEEN APPROVED IN WRITING, SHALL BE CONSIDERED INVALID AND WILL NOT BE FUNDED.

PRELIMINARY
NOT FOR CONSTRUCTION
DATA SHOWN FOR DESIGN
DEVELOPMENT ONLY

LaGuardia Design Landscape Architects

Water Mill, NY 11976
Phone:631-726-1403
Fax:631-726-1478

These drawings & specifications are the property of LaGuardia Design Landscape Architecture P.C. & are for use solely with respect to this project. They are not to be used by the owner, contractor, sub-contractors or suppliers on other projects or for additions to this project outside the scope of the work.
LaGuardia Design Landscape Architecture P.C. shall be deemed the author & retain all common law, statutory & other

described herein, including all technical drawings, are

oprietary & cannot be copied, duplicated, or commercial

ploited, in whole or in part without written authorization

Guardia Design Landscape Architecture F

COPYRIGHT © 2019 ALL RIGHTS RESERVED

DRAWN BY: JL

CHECKED BY: CL

38 Scuttle Hole Road

PROJECT:
CARDINALE RESIDENCE
LOCATION:

960 N OCEAN BLVD PALM BEACH, FL 33480 DRAWING:

COVER SHEET


SCALE: DATE:

NTS FEBRUARY 23, 2024

ISSUED:
- 01/26/2024 FOR REVIEW
- 02/07/2024 FOR PERMIT
- 02/26/2024 FOR PERMIT

SHEET NUMBER:

しつ

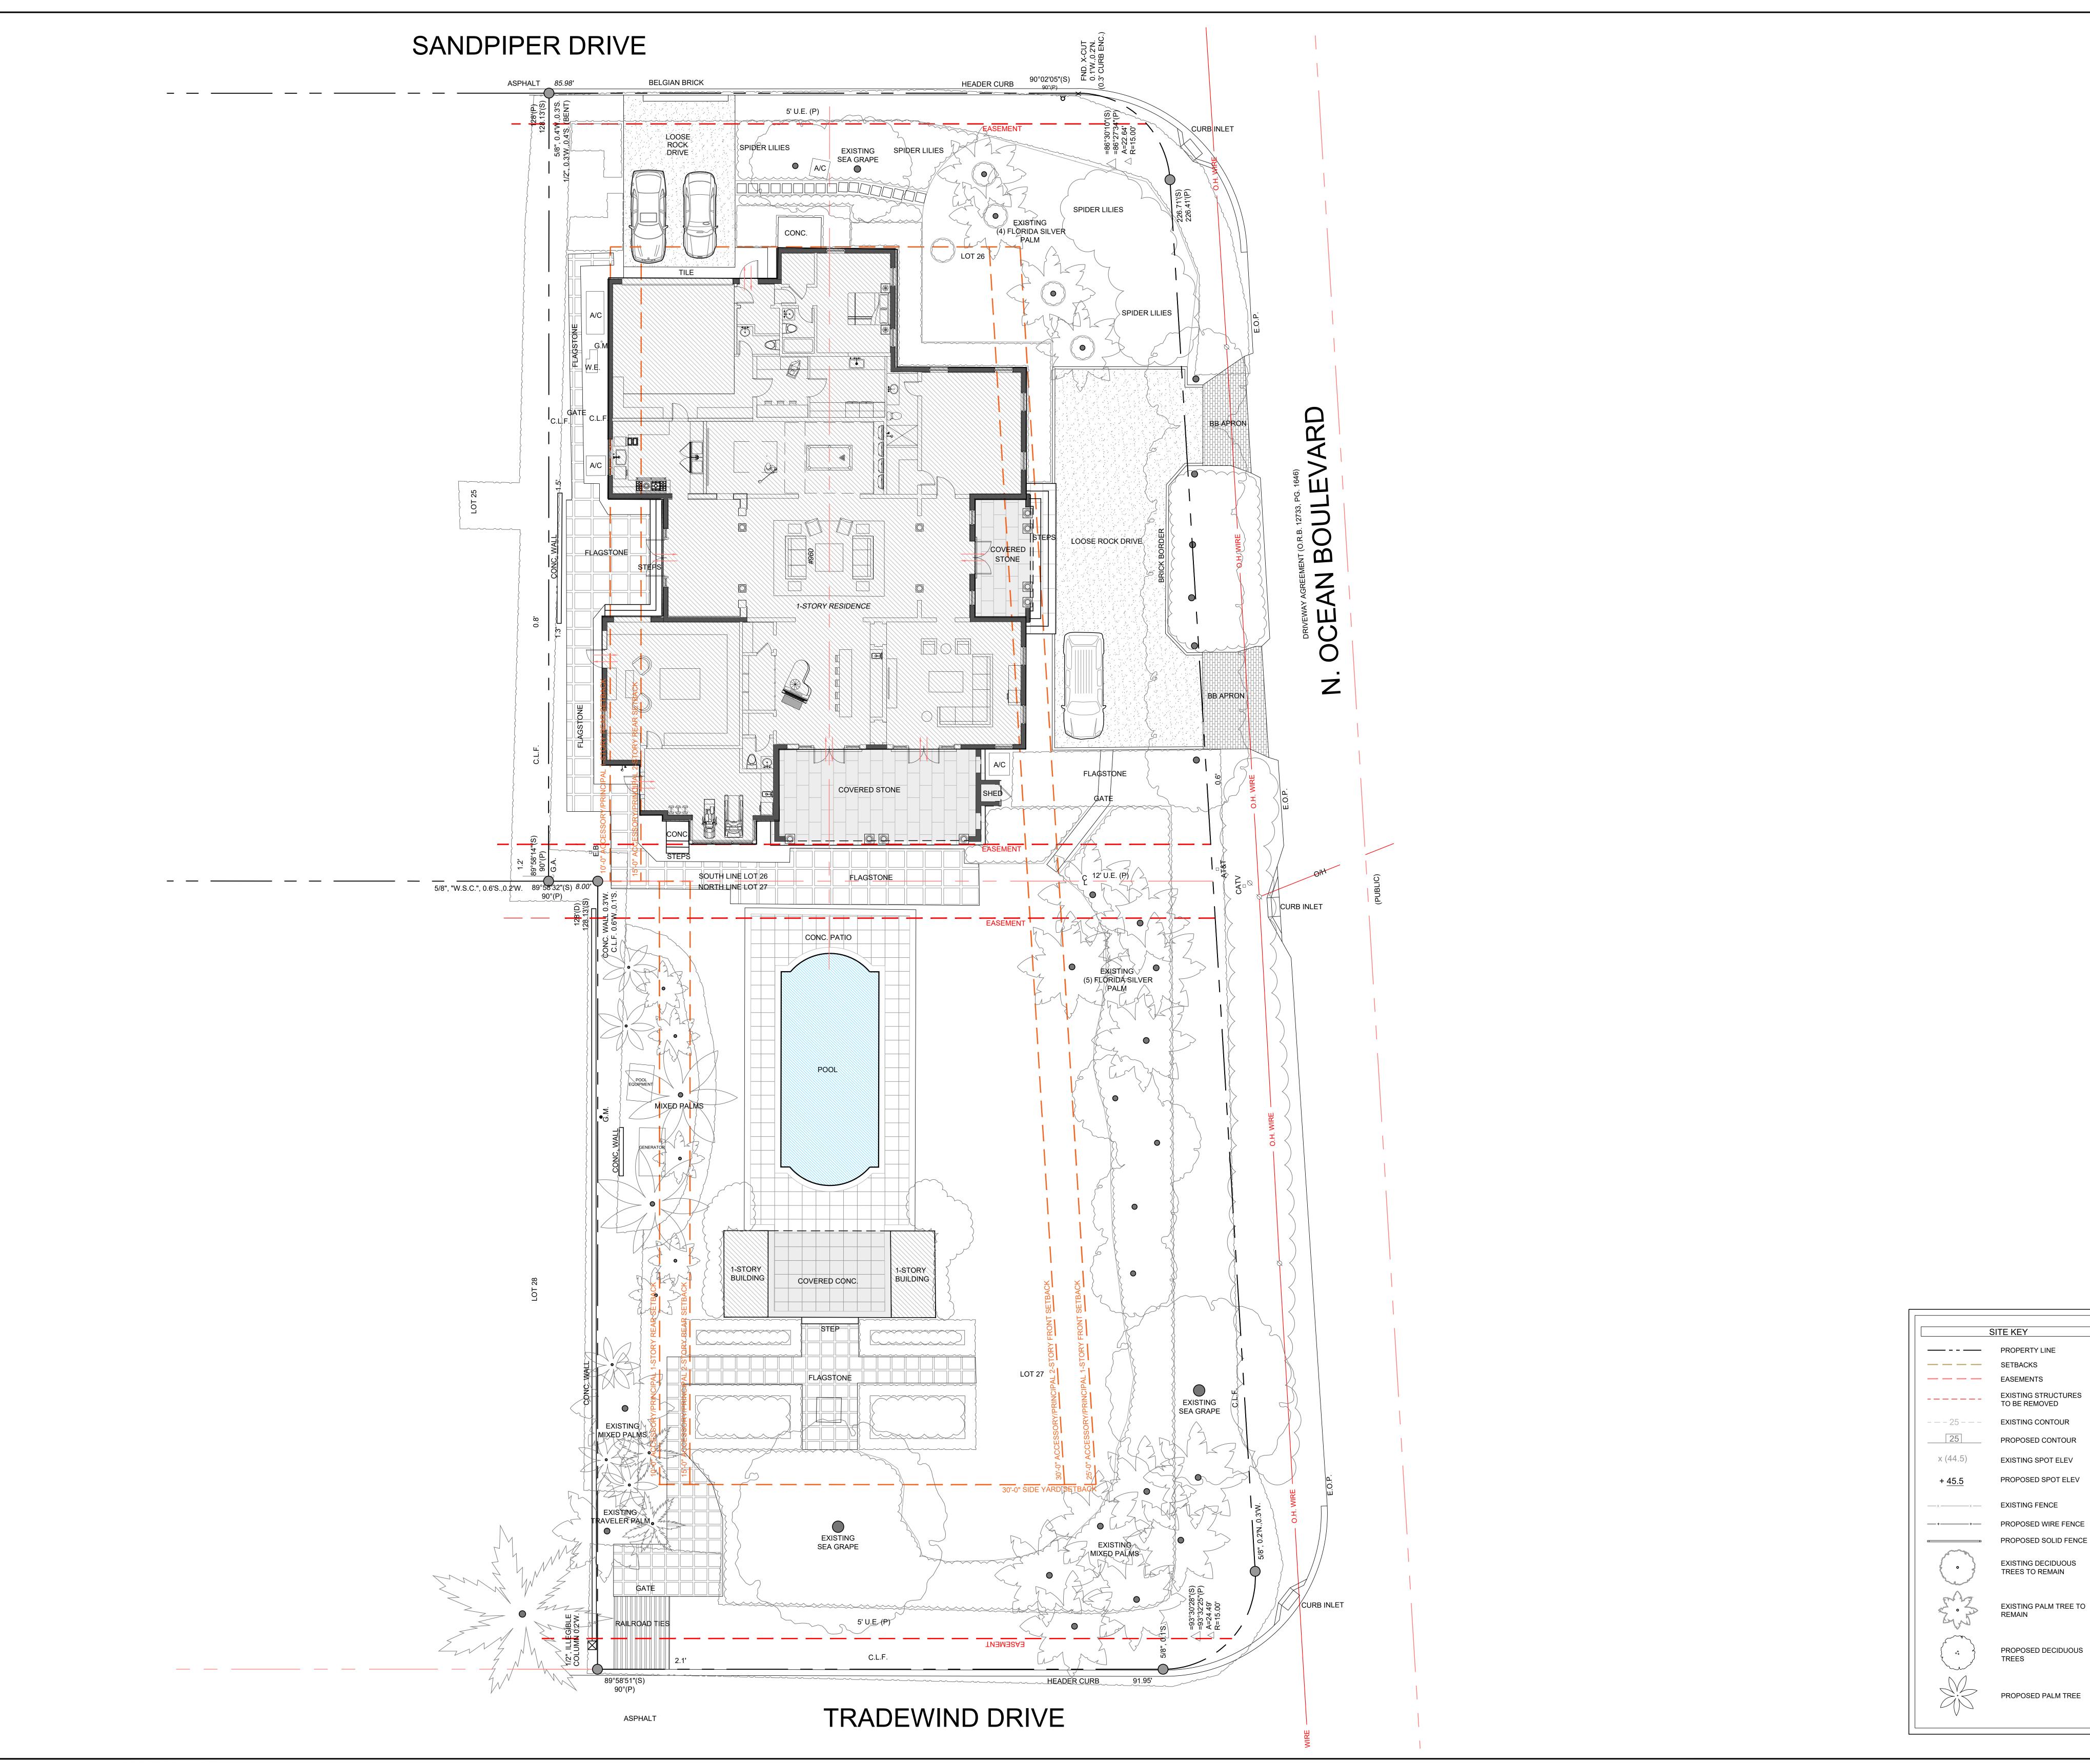



PROJECT DATA: BASED ON SURVEY BY: WALLACE SURVEYING CORP. JOB NO: 10-1040, DATED 06/27/23

PBCTM#: 50-43-43-10-24-000-0260

LOT AREA: 26,552 SF

R-B | LOW DENSITY RESIDENTIAL (50-PALM BEACH)

COVERAGE: SEE CHART

FLOOD ZONE: AE (EL. 6)

EASEMENT/OTHER:



CHANGE ORDERS, DELETIONS, ADDITIONS:
ANY MODIFICATIONS TO WORK OUTLINED IN THE
ATTACHED DRAWING(S), OR THE ASSOCIATED APPROVED
CONTRACT, MUST BE APPROVED IN WRITING BEFORE
EXECUTING THE WORK. THIS INCLUDES, ADDITIONS,
SUBSTITUTIONS, DELETIONS OR ADJUSTMENTS TO THE SCOPE OF APPROVED WORK. ANY INVOICES FOR ADDITIONAL WORK, THAT HAS NOT BEEN APPROVED IN WRITING, SHALL BE CONSIDERED INVALID AND WILL NOT BE FUNDED.

NOT FOR CONSTRUCTION DATA SHOWN FOR DESIGN DEVELOPMENT ONLY

LaGuardia Design Landscape Architects 38 Scuttle Hole Road Water Mill, NY 11976 Phone:631-726-1403 Fax:631-726-1478

hese drawings & specifications are the property of LaGuardia esign Landscape Architecture P.C. & are for use solely with espect to this project. They are not to be used by the owner, contractor, sub-contractors or suppliers on other projects or for additions to this project outside the scope of the work. LaGuardia Design Landscape Architecture P.C. shall be deemed the author & retain all common law, statutory & other reserved rights, in addition to the copyrights. The design shown & described herein, including all technical drawings, are proprietary & cannot be copied, duplicated, or commercially exploited, in whole or in part without written authorization of LaGuardia Design Landscape Architecture P.C. COPYRIGHT © 2019 ALL RIGHTS RESERVED

960 N OCEAN BLVD PALM BEACH, FL 33480

EXISTING CONDITIONS

SCALE: DATE:

DRAWN BY: JL CHECKED BY: CL PROJECT:

LOCATION:

DRAWING:


ISSUED:

CARDINALE RESIDENCE

- 01/26/2024 FOR REVIEW - 02/07/2024 FOR PERMIT - 02/26/2024 FOR PERMIT

1/8"=1'-0" FEBRUARY 23, 2024

SHEET NUMBER:

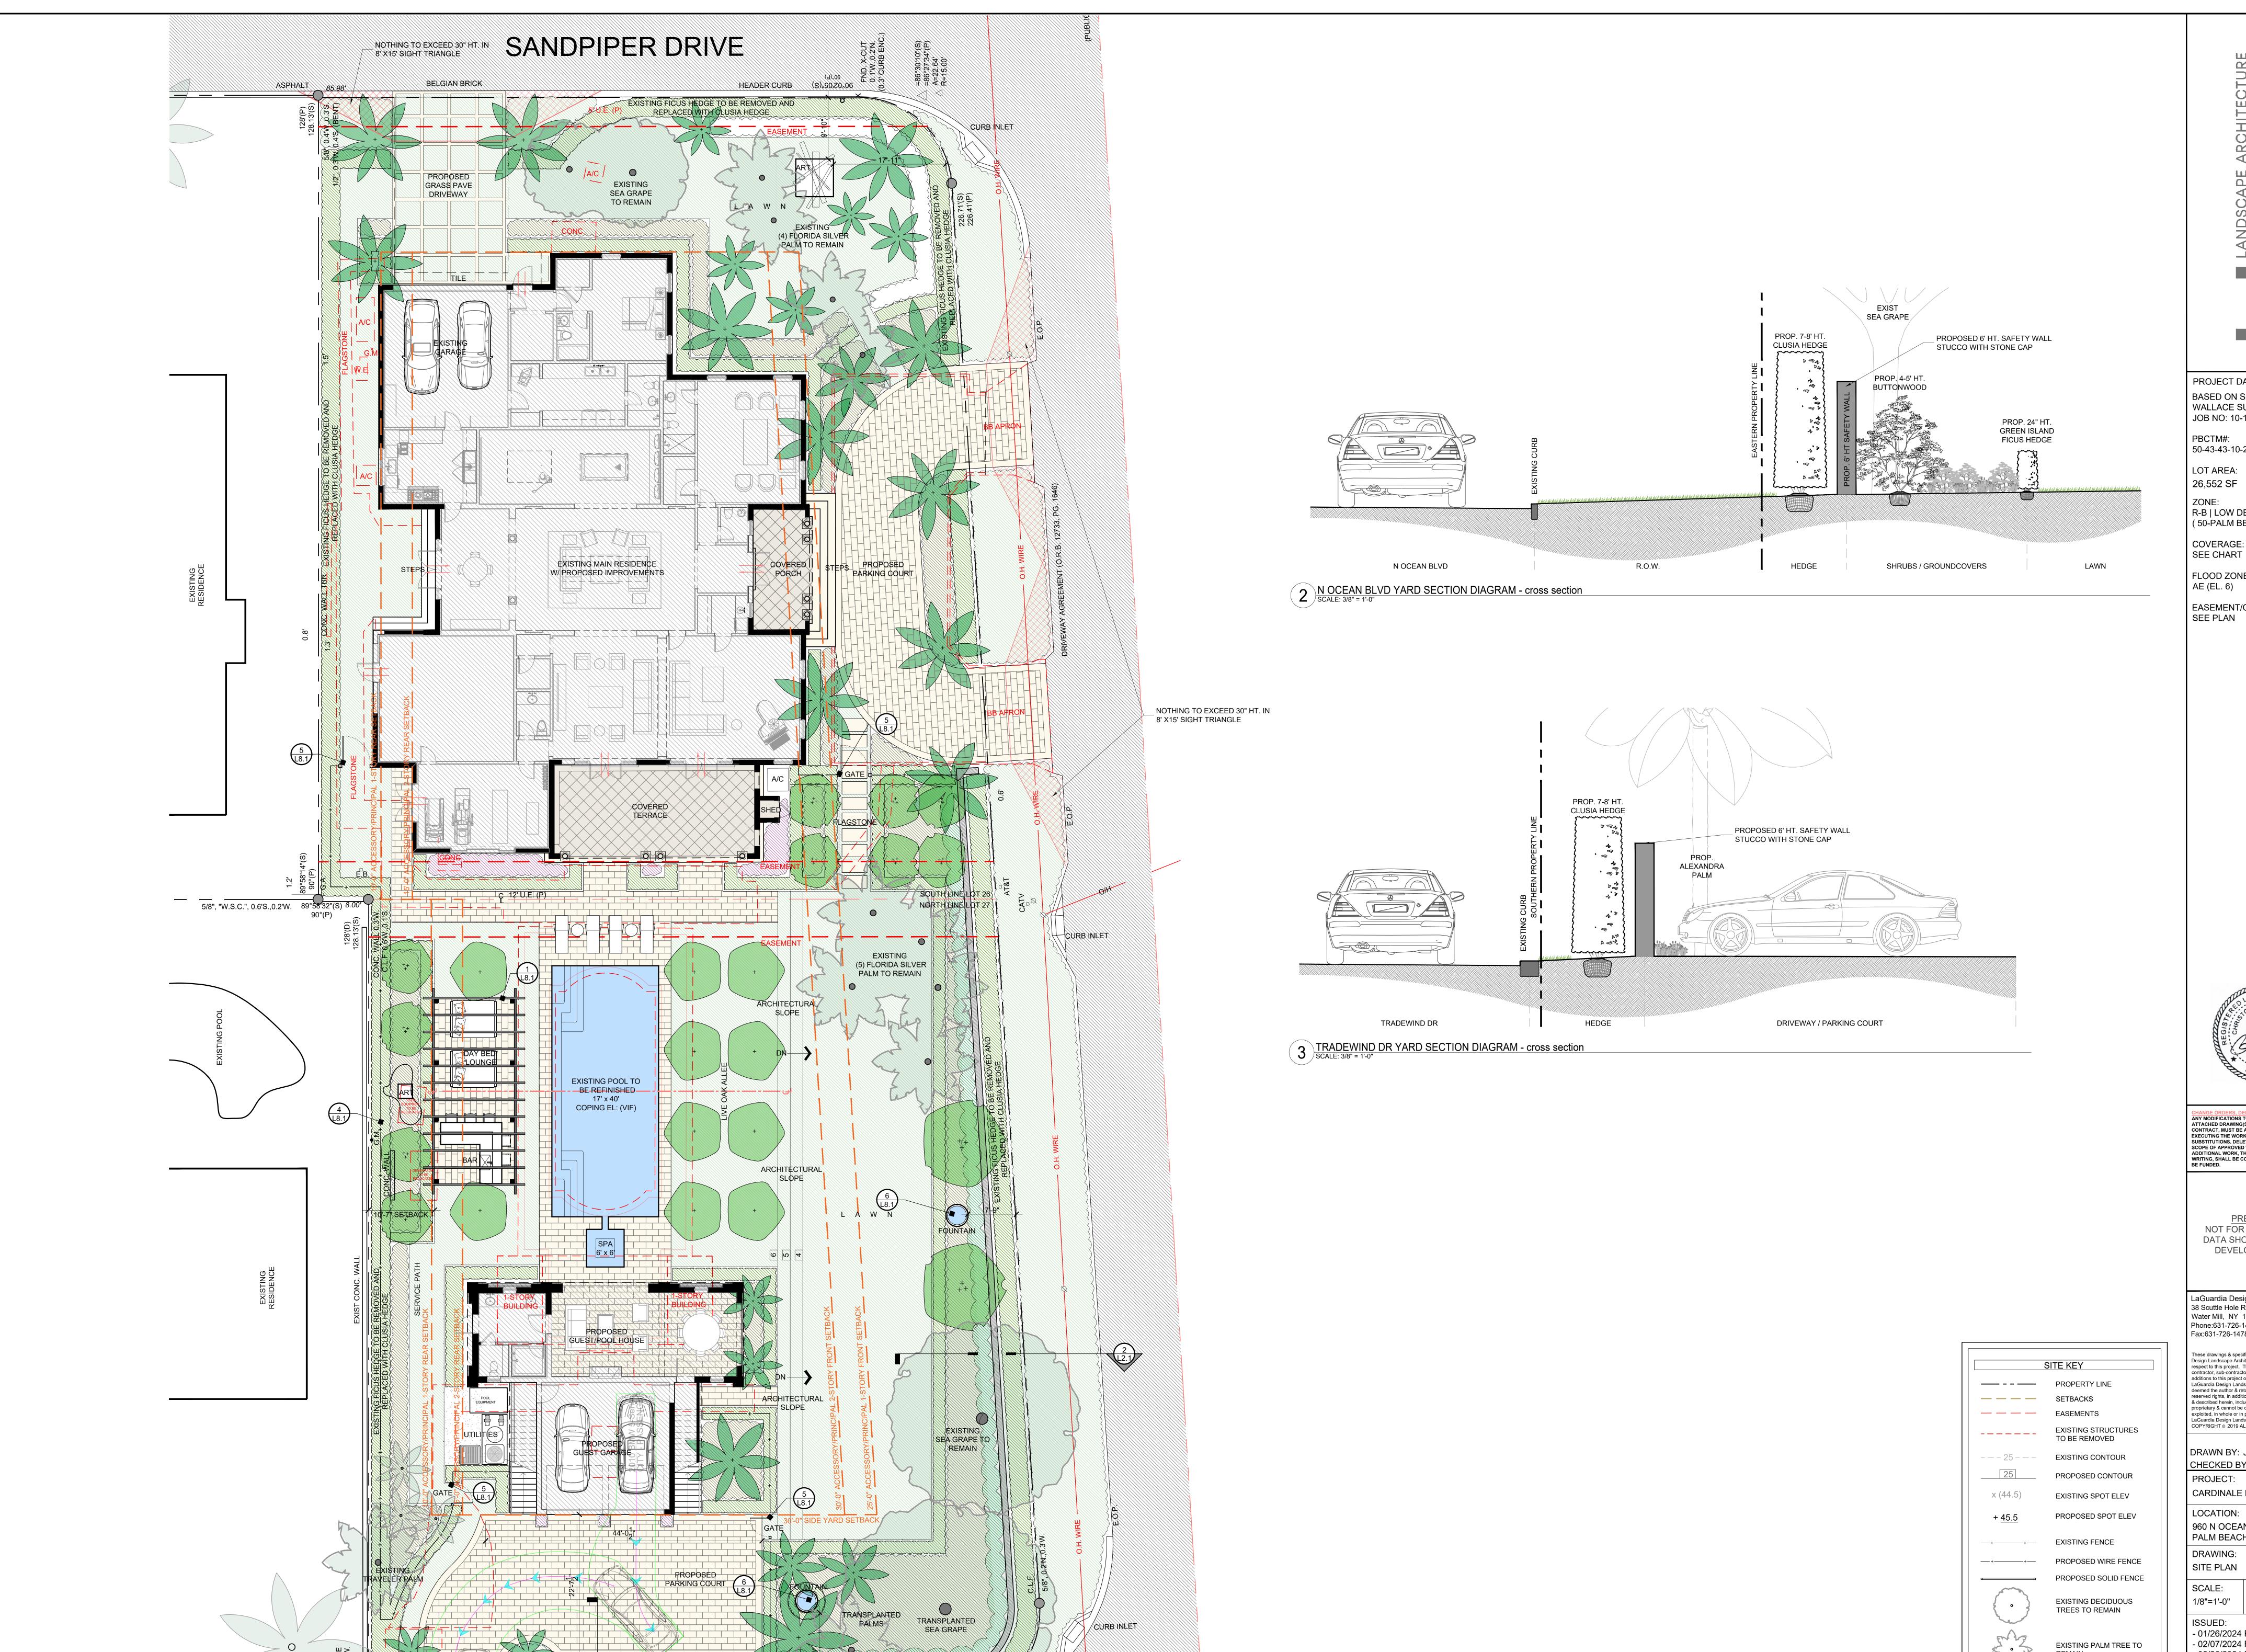

EXISTING FICUS HEDGE TO BE REMOVED AND WES

ASPHALT

NOTHING TO EXCEED 30" HT. IN 8' X15' SIGHT TRIANGLE

TRADEWIND DRIVE

HEADER CURB

PROJECT DATA: BASED ON SURVEY BY: WALLACE SURVEYING CORP. JOB NO: 10-1040, DATED 06/27/23


50-43-43-10-24-000-0260 LOT AREA: 26,552 SF

R-B | LOW DENSITY RESIDENTIAL (50-PALM BEACH)

SEE CHART

FLOOD ZONE:

EASEMENT/OTHER: SEE PLAN

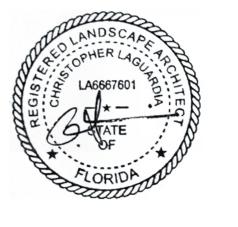

CHANGE ORDERS, DELETIONS, ADDITIONS:

ANY MODIFICATIONS TO WORK OUTLINED IN THE
ATTACHED DRAWING(S), OR THE ASSOCIATED APPROVED
CONTRACT, MUST BE APPROVED IN WRITING BEFORE
EXECUTING THE WORK. THIS INCLUDES, ADDITIONS,
SUBSTITUTIONS, DELETIONS OR ADJUSTMENTS TO THE
SCOPE OF APPROVED WORK. ANY INVOICES FOR
ADDITIONAL WORK, THAT HAS NOT BEEN APPROVED IN
WRITING, SHALL BE CONSIDERED INVALID AND WILL NOT
BE FLINDED

PRELIMINARY NOT FOR CONSTRUCTION DATA SHOWN FOR DESIGN DEVELOPMENT ONLY

LaGuardia Design Landscape Architects 38 Scuttle Hole Road Water Mill, NY 11976 Phone:631-726-1403 Fax:631-726-1478

These drawings & specifications are the property of LaGuardia Design Landscape Architecture P.C. & are for use solely with respect to this project. They are not to be used by the owner, contractor, sub-contractors or suppliers on other projects or for additions to this project outside the scope of the work. LaGuardia Design Landscape Architecture P.C. shall be deemed the author & retain all common law, statutory & other reserved rights, in addition to the copyrights. The design shown & described herein, including all technical drawings, are proprietary & cannot be copied, duplicated, or commercially exploited, in whole or in part without written authorization of LaGuardia Design Landscape Architecture P.C. COPYRIGHT © 2019 ALL RIGHTS RESERVED

DRAWN BY: JL CHECKED BY: CL

PROJECT:

CARDINALE RESIDENCE LOCATION:

960 N OCEAN BLVD PALM BEACH, FL 33480

DRAWING: SITE PLAN


SCALE: DATE: 1/8"=1'-0" | FEBRUARY 23, 2024

- 01/26/2024 FOR REVIEW - 02/07/2024 FOR PERMIT - 02/26/2024 FOR PERMIT

SHEET NUMBER:

PROPOSED DECIDUOUS

PROPOSED PALM TREE

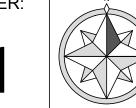



1 NORTH ELEVATION - TRADEWIND DR SCALE: 3/16" = 1'-0"





PROJECT DATA: BASED ON SURVEY BY: WALLACE SURVEYING CORP. JOB NO: 10-1040, DATED 06/27/23

PBCTM#: 50-43-43-10-24-000-0260

LOT AREA: 26,552 SF

R-B | LOW DENSITY RESIDENTIAL (50-PALM BEACH)

COVERAGE: SEE CHART

FLOOD ZONE: AE (EL. 6)

EASEMENT/OTHER: SEE PLAN



CHANGE ORDERS, DELETIONS, ADDITIONS:
ANY MODIFICATIONS TO WORK OUTLINED IN THE
ATTACHED DRAWING(S), OR THE ASSOCIATED APPROVED
CONTRACT, MUST BE APPROVED IN WRITING BEFORE
EXECUTING THE WORK. THIS INCLUDES, ADDITIONS,
SUBSTITUTIONS, DELETIONS OR ADJUSTMENTS TO THE
SCOPE OF APPROVED WORK. ANY INVOICES FOR
ADDITIONAL WORK, THAT HAS NOT BEEN APPROVED IN
WRITING, SHALL BE CONSIDERED INVALID AND WILL NOT
BE FUNDED.

PRELIMINARY NOT FOR CONSTRUCTION DATA SHOWN FOR DESIGN DEVELOPMENT ONLY

LaGuardia Design Landscape Architects 38 Scuttle Hole Road Water Mill, NY 11976 Phone:631-726-1403 Fax:631-726-1478

These drawings & specifications are the property of LaGuardia Design Landscape Architecture P.C. & are for use solely with respect to this project. They are not to be used by the owner, contractor, sub-contractors or suppliers on other projects or for additions to this project outside the scope of the work. LaGuardia Design Landscape Architecture P.C. shall be deemed the author & retain all common law, statutory & other reserved rights, in addition to the copyrights. The design shown & described herein, including all technical drawings, are proprietary & cannot be copied, duplicated, or commercially exploited, in whole or in part without written authorization of LaGuardia Design Landscape Architecture P.C. COPYRIGHT © 2019 ALL RIGHTS RESERVED

DRAWN BY: AML CHECKED BY: CL

PROJECT:

CARDINALE RESIDENCE

LOCATION:

960 N OCEAN BLVD PALM BEACH, FL 33480

DRAWING:


ELEVATIONS


SCALE: DATE:

AS SHOWN FEBRUARY 23, 2024 ISSUED: - 01/26/2024 FOR REVIEW - 02/07/2024 FOR PERMIT

- 02/26/2024 FOR PERMIT

SHEET NUMBER:

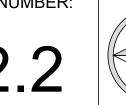

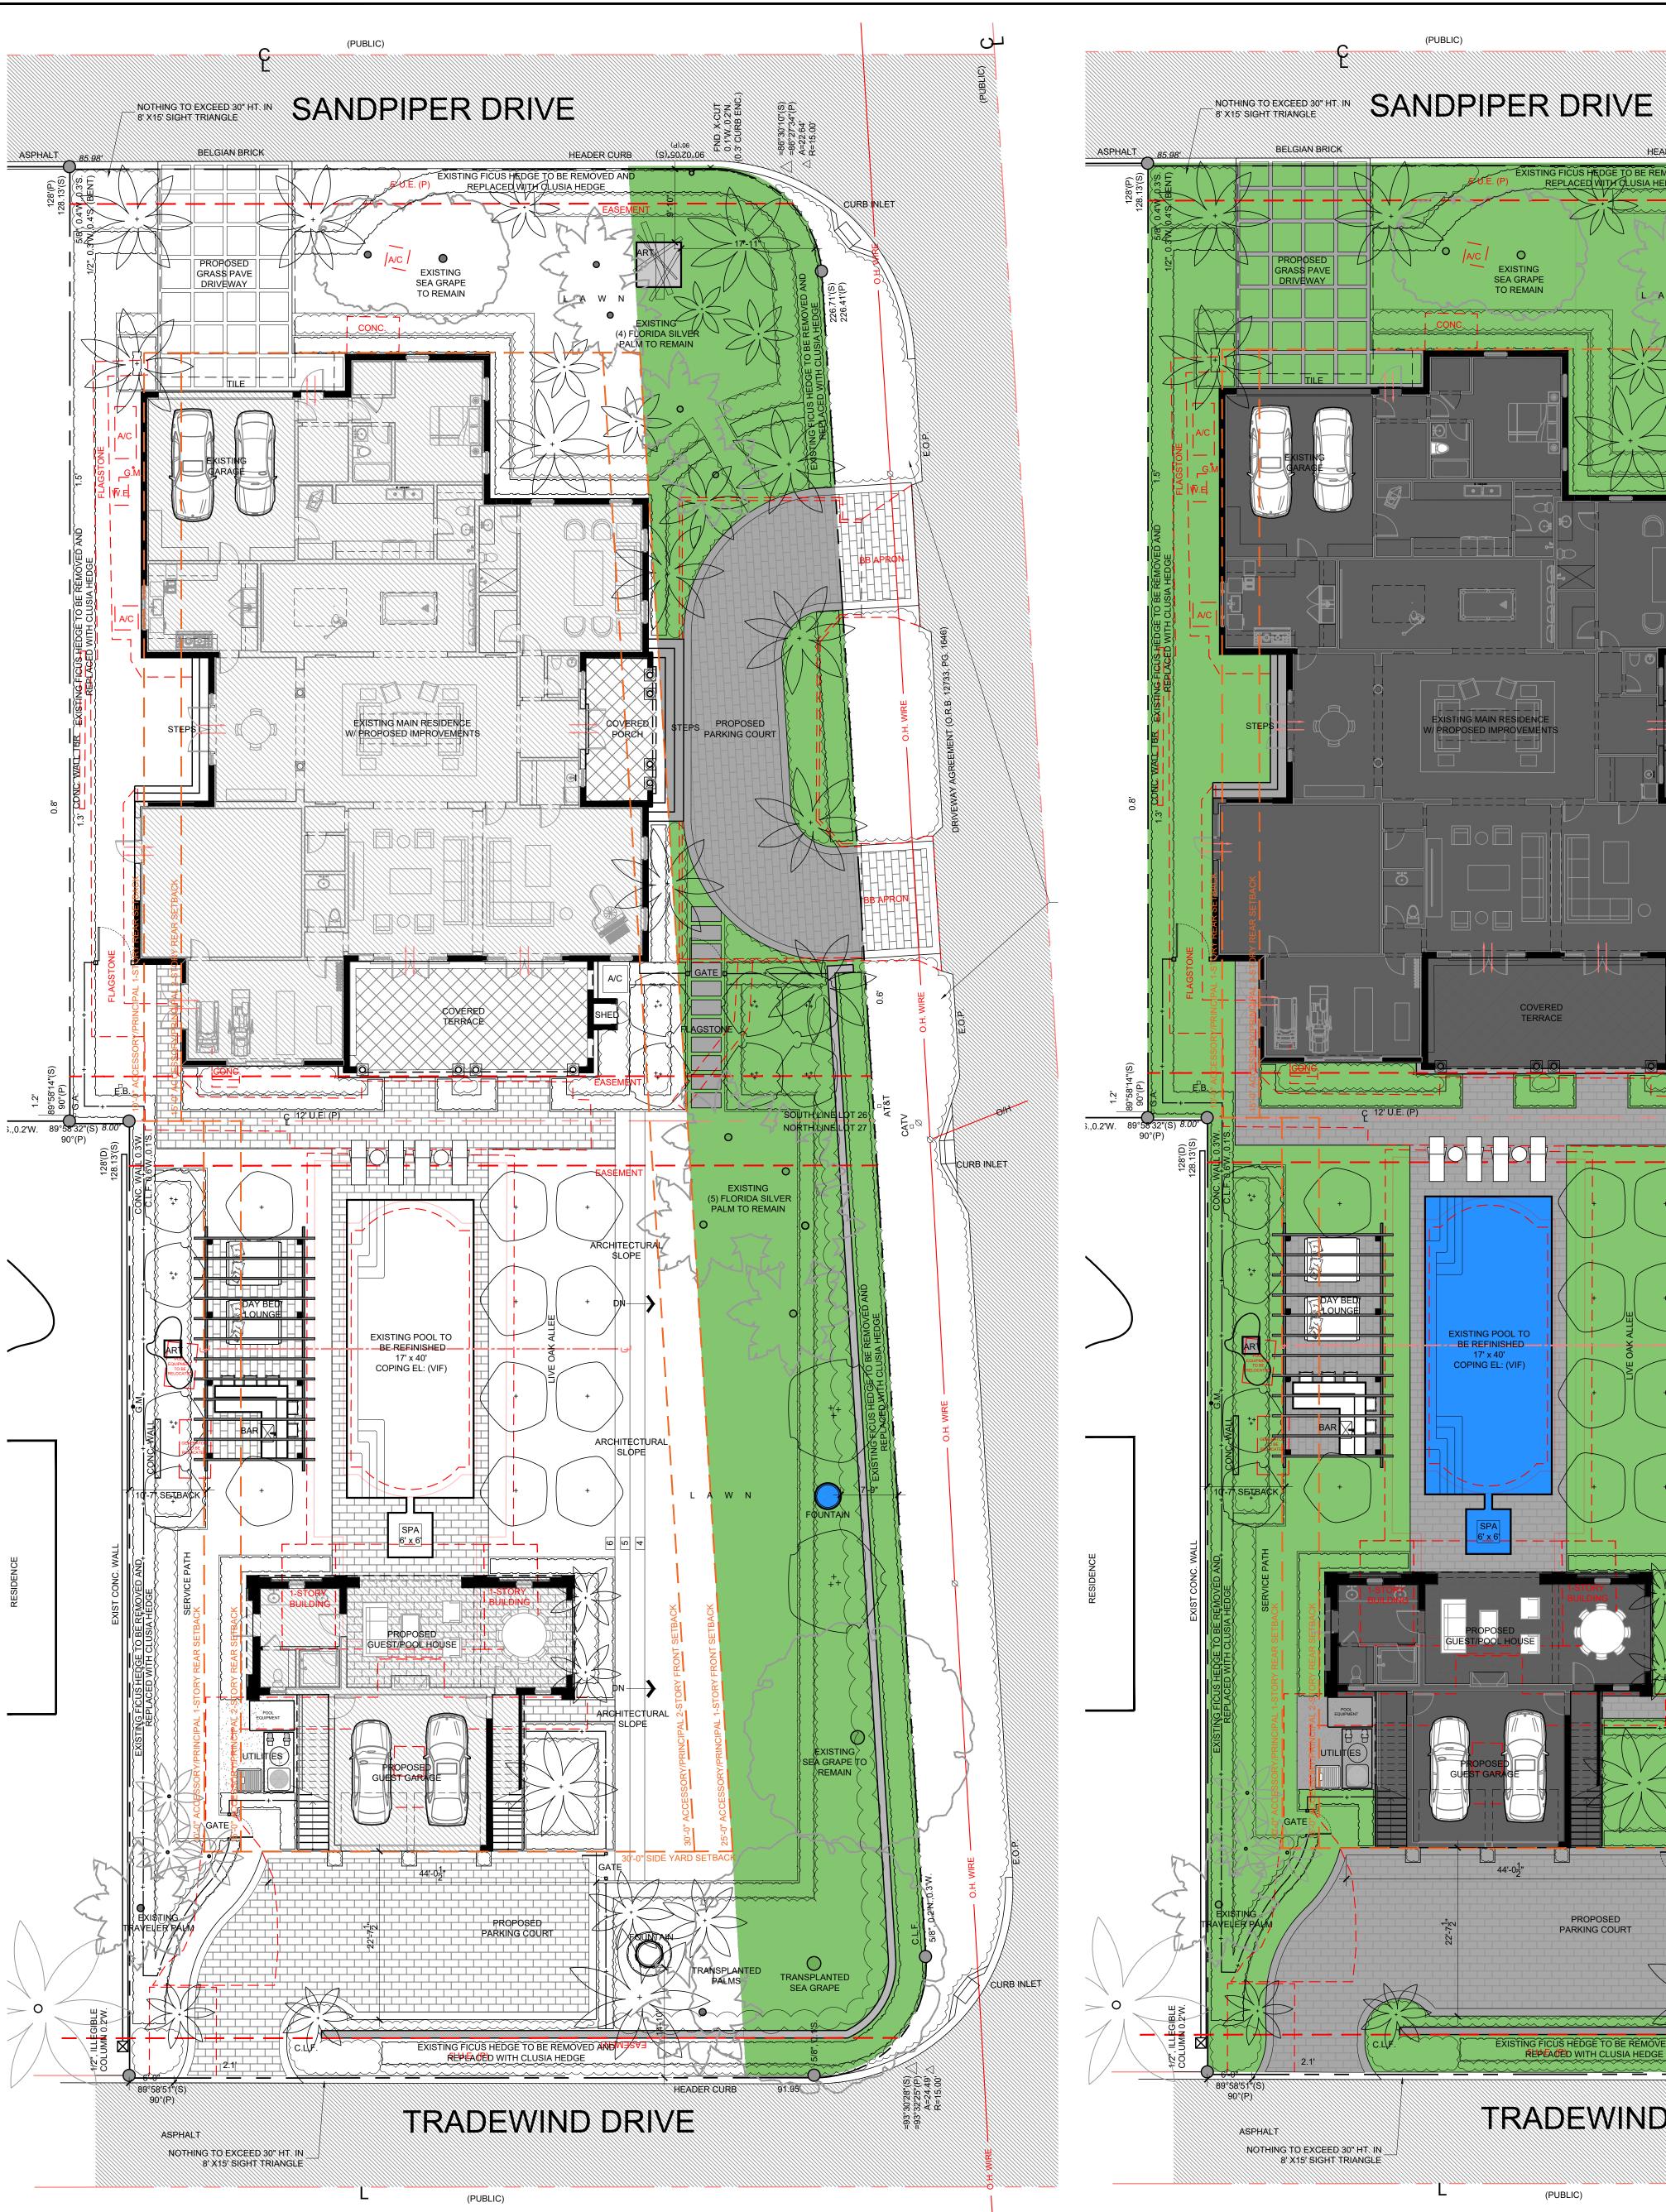

FRONT LANDSCAPE OPEN SPACE

PROP. FRONT LANDSCAPE OPEN SPACE 4,970 SF 78.6%

EXISTING FRONT LANDSCAPE OPEN SPACE 4,916 SF 77.8%

TOTAL FRONT YARD AREA

PROPOSED BUILDING COVERAGE

PROPOSED HARDSCAPE COVERAGE

PROPOSED WATER FEATURE COVERAGE

6,322 SF 100%


1,342 SF 21.2%

10 SF 0.02%

0 SF 0%



EXISTING FICUS HEDGE TO BE REMOVED AND REPLEACED WITH CLUSIA HEDGE HEADER CURB 91.95	=93°30′28°(S) =93°32′25°(P) =93°32′25°(P) A=24.49° R=15.00°
(PUBLIC)	######################################
TOTAL LANDSCAPE OPEN SF	PACE
TOTAL PROPERTY AREA	26,552 SF 100%
PROPOSED BUILDING COVERAGE	7,047 SF 26.6%
PROPOSED HARDSCAPE COVERAGE	4,439 SF 16.7%
PROPOSED WATER FEATURE COVERAGE	737 SF 2.78%
PROPOSED LANDSCAPE OPEN SPACE	14,325 SF 54.0%

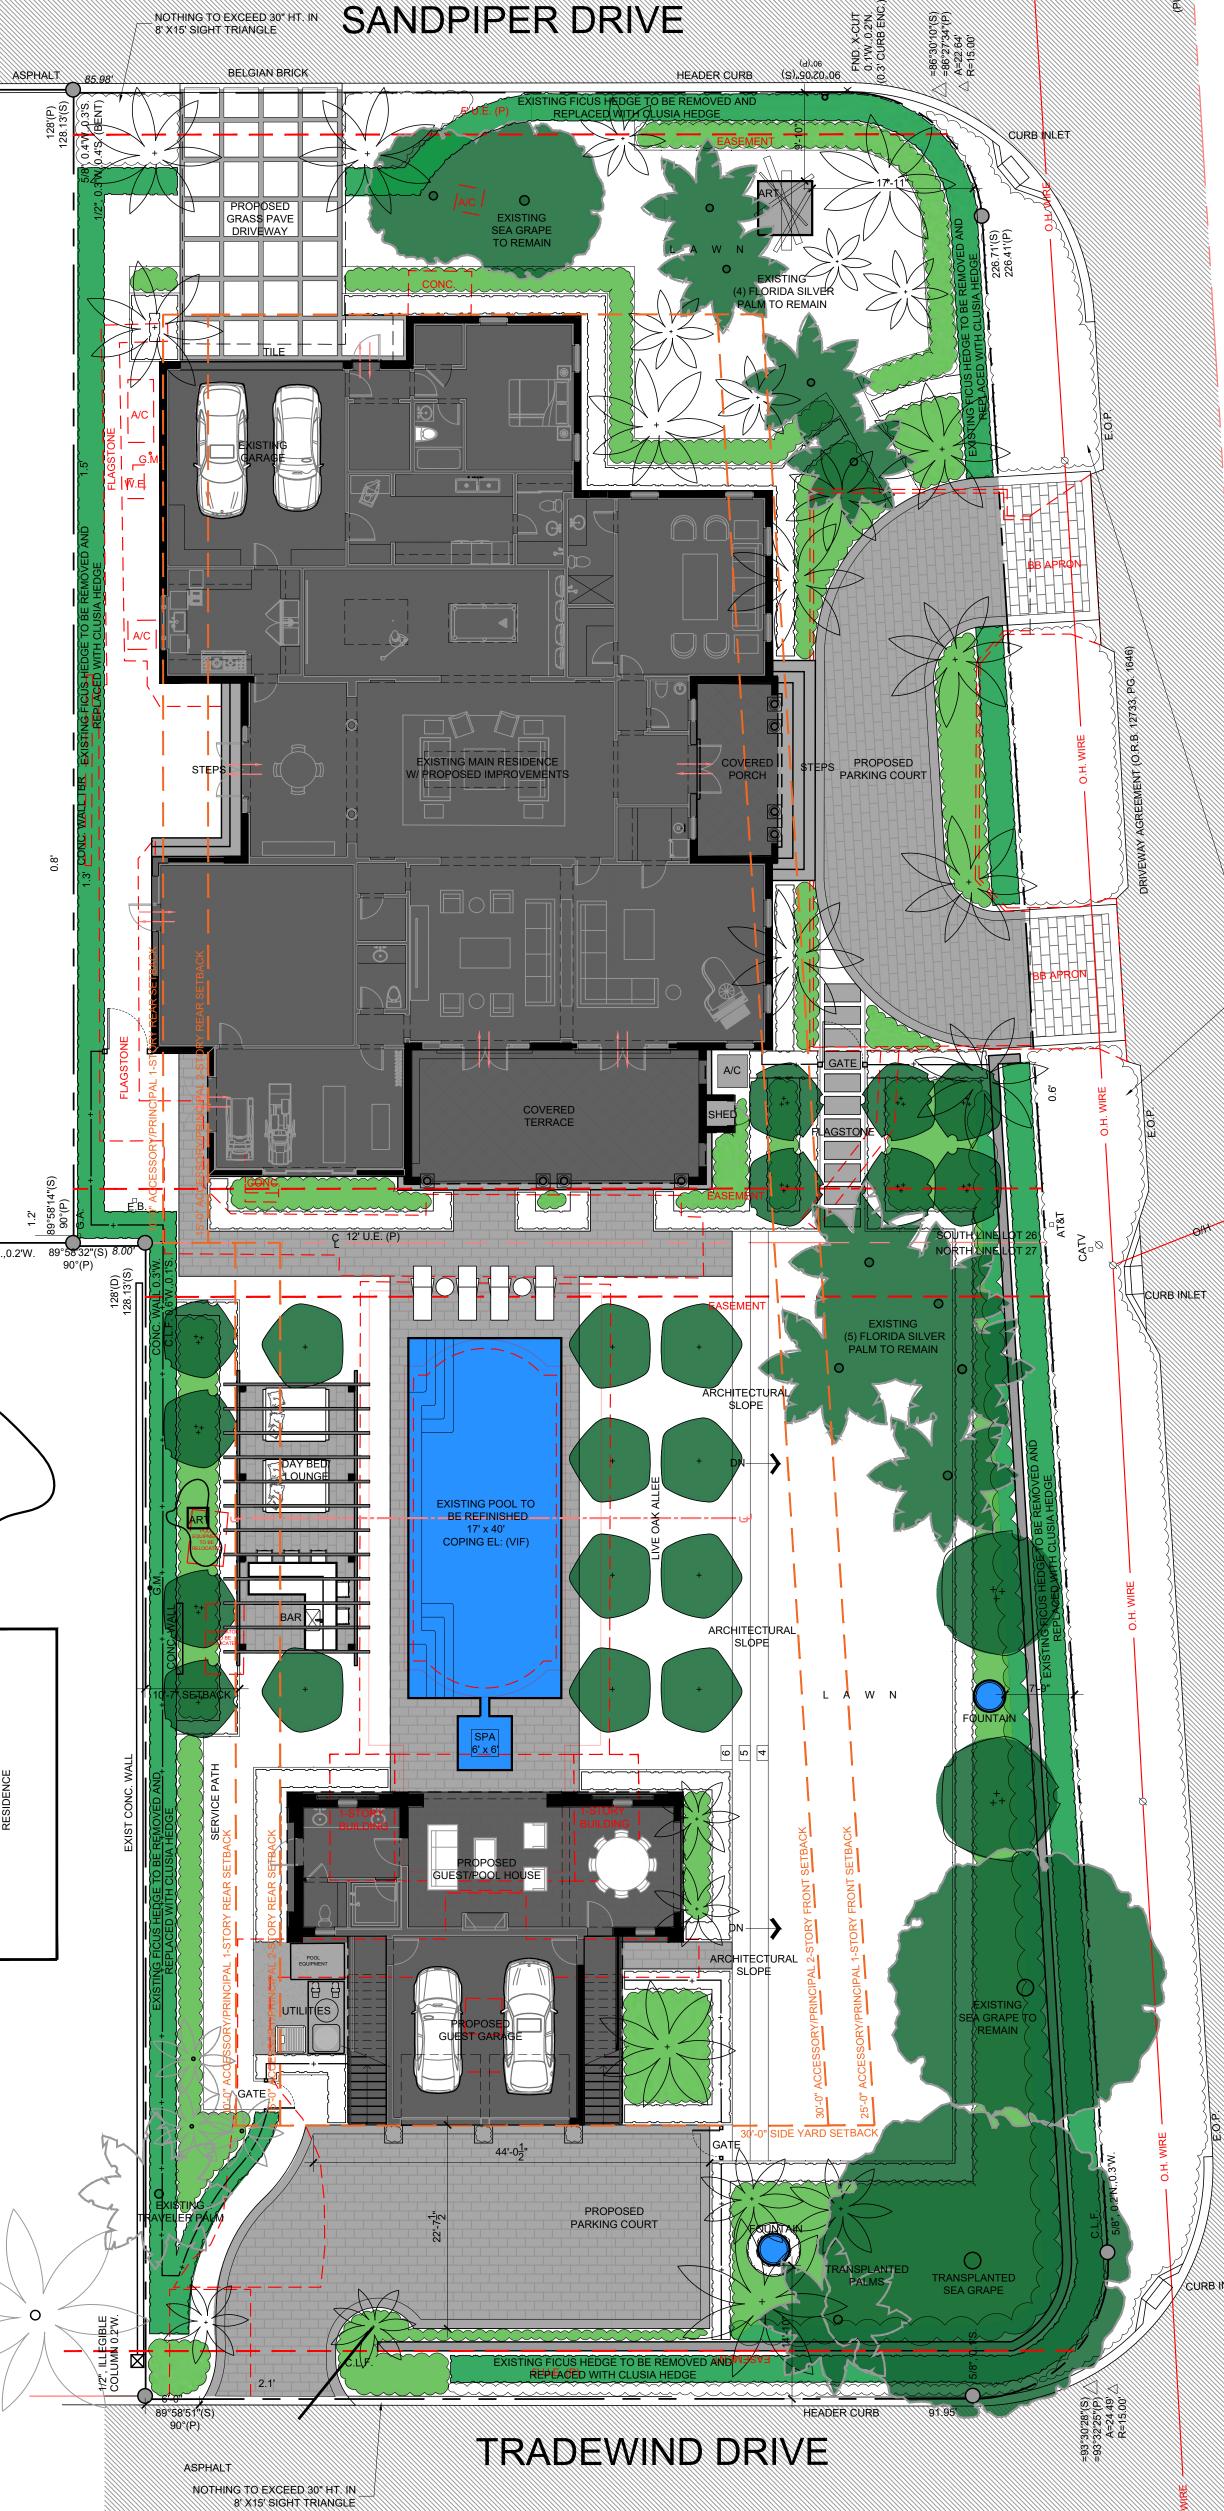

NATIVE PLANTINGS

PROPOSED BUILDING COVERAGE

PROPOSED NATIVE PLANTINGS

PROPOSED NATIVE SHRUBS

PROPOSED HARDSCAPE COVERAGE

PROPOSED/EXISTING NATIVE TREES

PROPOSED NATIVE GROUNDCOVERS

PROPOSED WATER FEATURE COVERAGE

ADDITIONAL WORK, THAT HAS NOT BEEN APPROVED IN WRITING, SHALL BE CONSIDERED INVALID AND WILL NOT BE FUNDED.
PRELIMINARY
NOT FOR CONSTRUCTION
DATA SHOWN FOR DESIGN
DEVELOPMENT ONLY

ANY MODIFICATIONS TO WORK OUTLINED IN THE

ATTACHED DRAWING(S), OR THE ASSOCIATED APPROVED CONTRACT, MUST BE APPROVED IN WRITING BEFORE EXECUTING THE WORK. THIS INCLUDES, ADDITIONS, SUBSTITUTIONS, DELETIONS OR ADJUSTMENTS TO THE

PROJECT DATA:

PBCTM#:

LOT AREA: 26,552 SF

COVERAGE: SEE CHART

FLOOD ZONE: AE (EL. 6)

EASEMENT/OTHER:

BASED ON SURVEY BY:

50-43-43-10-24-000-0260

(50-PALM BEACH)

WALLACE SURVEYING CORP JOB NO: 10-1040, DATED 06/27/2

R-B | LOW DENSITY RESIDENTIAL

LaGuardia Design Landscape Architects 38 Scuttle Hole Road Water Mill, NY 11976 Phone:631-726-1403

Fax:631-726-1478

These drawings & specifications are the property of LaGuardia Design Landscape Architecture P.C. & are for use solely with respect to this project. They are not to be used by the owner, contractor, sub-contractors or suppliers on other projects or for additions to this project outside the scope of the work. LaGuardia Design Landscape Architecture P.C. shall be deemed the author & retain all common law, statutory & other reserved rights, in addition to the copyrights. The design shown proprietary & cannot be copied, duplicated, or commercially exploited, in whole or in part without written authorization of LaGuardia Design Landscape Architecture P.C. COPYRIGHT © 2019 ALL RIGHTS RESERVED

		DRAWN BY: JL
		CHECKED BY: CL
		PROJECT:

CARDINALE RESIDENCE LOCATION:

960 N OCEAN BLVD PALM BEACH, FL 33480

LANDSCAPE OPEN SPACE

SCALE: DATE:


SEE L5.2 | 59.0%

SEE L5.2 33.0%

SEE L5.2 | 53.0%

3/32"=1'-0" FEBRUARY 23, 2024 - 01/26/2024 FOR REVIEW - 02/07/2024 FOR PERMIT - 02/26/2024 FOR PERMIT

SHEET NUMBER:

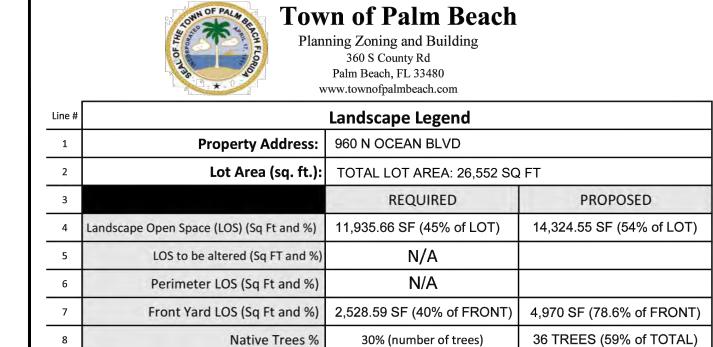

Native Trees %

1,443 SF (53% of TOTAL) Native Groundcover % 30% (groundcover area) To determine qualifying native vegetation use either: the Institute for Regional Conservation Natives for Your Neighborhood FL Statewide Plant List


Native Shrubs & Vines % 30% (number of shrubs & vines)

30% (number of trees)

277 SHRUBS (33% of TOTAL)

the Florida Native Plant Society Native Plants for Your Area List Note: Modification of >50% of existing landscape/greenscape are subject to minimum native plant requirements and must

submit a landscape and irrigation plan for review. This table shall be included on the landscape species index sheet as prepared by a licensed landscape architect and landscape openspace data shall be incorporated on to corresponding zoning legend. See Ord. 003-2023 REV BF 20230727

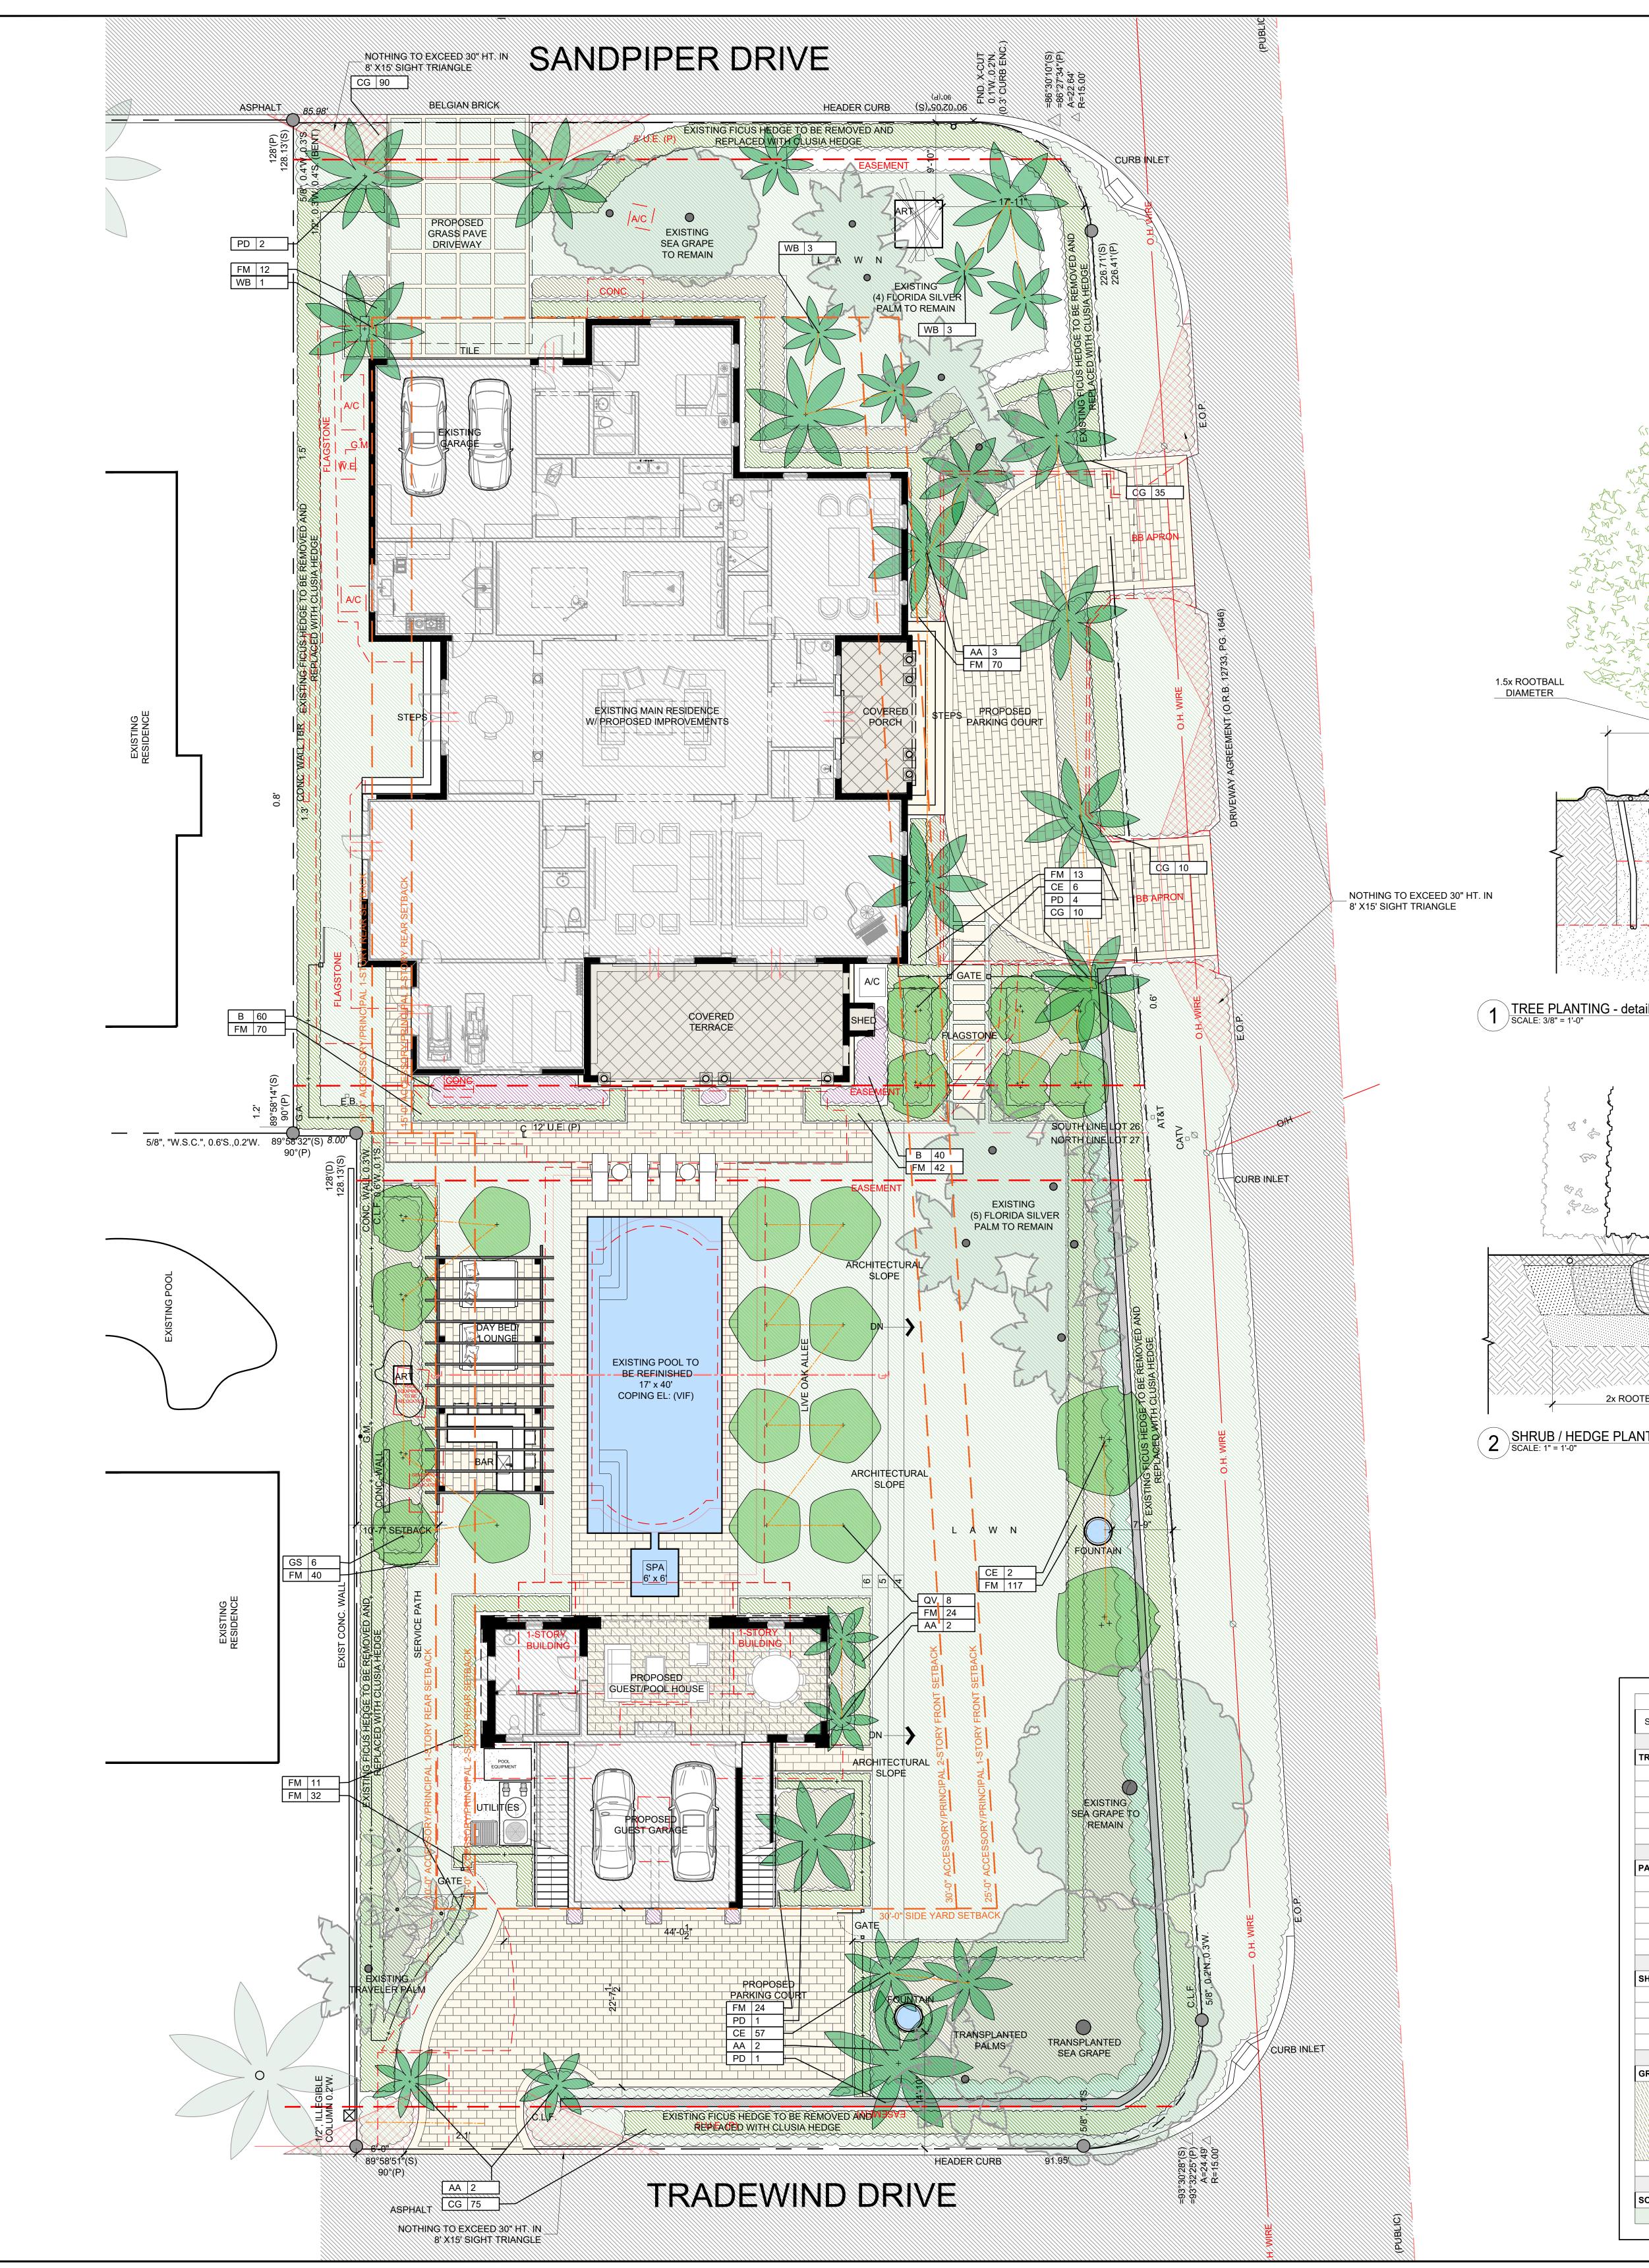

GENERAL NOTES:

- 2" SHREDDED HARDWOOD MULCH

RIM OF ROOT BALL TO BE SET 1"

"NETAFIM" DRIP IRRIGATION

TREES PER SPECIFICATIONS

BIOPAK' ROOT FERTILIZER PER

MANUFACTURER'S SPECIFICATIONS

4" PERFORATED PVC DRAIN PIPE SET VERTICALLY FROM GRADE DOWN TO EXISTING SAND LAYER IN 18" DIAMETER

- ROOTBALL TO SIT ON 4" LAYER OF SAND

- EXISTING SAND LAYER (FIELD VERIFY)

GRAVEL WICK (3 PER TREE)

- HEDGE PLANTING SPACED PER PLAN

FLUSH W/ PROPOSED FINISH GRADE

- 2-3" SHREDDED HARDWOOD MULCH

_ BACKFILL: 1:1:1 TOPSOIL:SAND:COMPOST MIXTURE

RIM OF ROOT BALL TO BE SET

ZONE ON ALL HEDGE SHRUBS.

(2) LINES "NETAFIM" DRIP

- 6" LAYER OF CLEAN SAND

- EXISTING UN-DISTURBED SOIL

- IRRIGATION DEDICATED

- DEDICATED ZONE ON ALL

— 3" LEVEL WATERING BERM

ABOVE PROPOSED FINISH GRADE


BACKFILL: 3:1 TOPSOIL TO COMPOST MIXTURE W/ RECOMMENDED AMOUNTS OF

1. ALL EXISTING NATIVE AND NON-INVASIVE PLANTS WITHIN THE PROPOSED REVEGETATION AREA WILL BE INVENTORIED AND PRESERVED. ALL INVASIVE PLANT MATERIAL WITHIN THESE REVEGETATION AREAS WILL BE REMOVED BY HAND AND WILL BE REPLACED WITH NATIVE PLANT SPECIES AS INDICATED ON SHEET L4: PLANTING PLAN, DATED NOVEMBER 14, 2014.


2. ALL NATIVE FESCUE LAWN AREAS WILL BE SEEDED WITH A NATIVE FESCUE SEED MIX CONSISTING OF THE FOLLOWING:

- FESTUCA RUBRA: CREEPING RED FESCUE - FESTUCA LONGIFOLIA: HARD FESCUE - FESTUCA OVINA: SHEEP FESCUE

THESE NATIVE FESCUE LAWN AREAS WILL NOT BE FERTILIZED FOR ESTABLISHMENT OR ANY OTHER REASON. A DEDICATED IRRIGATION ZONE WILL BE CREATED FOR ALL NATIVE FESCUE LAWN AREAS SO

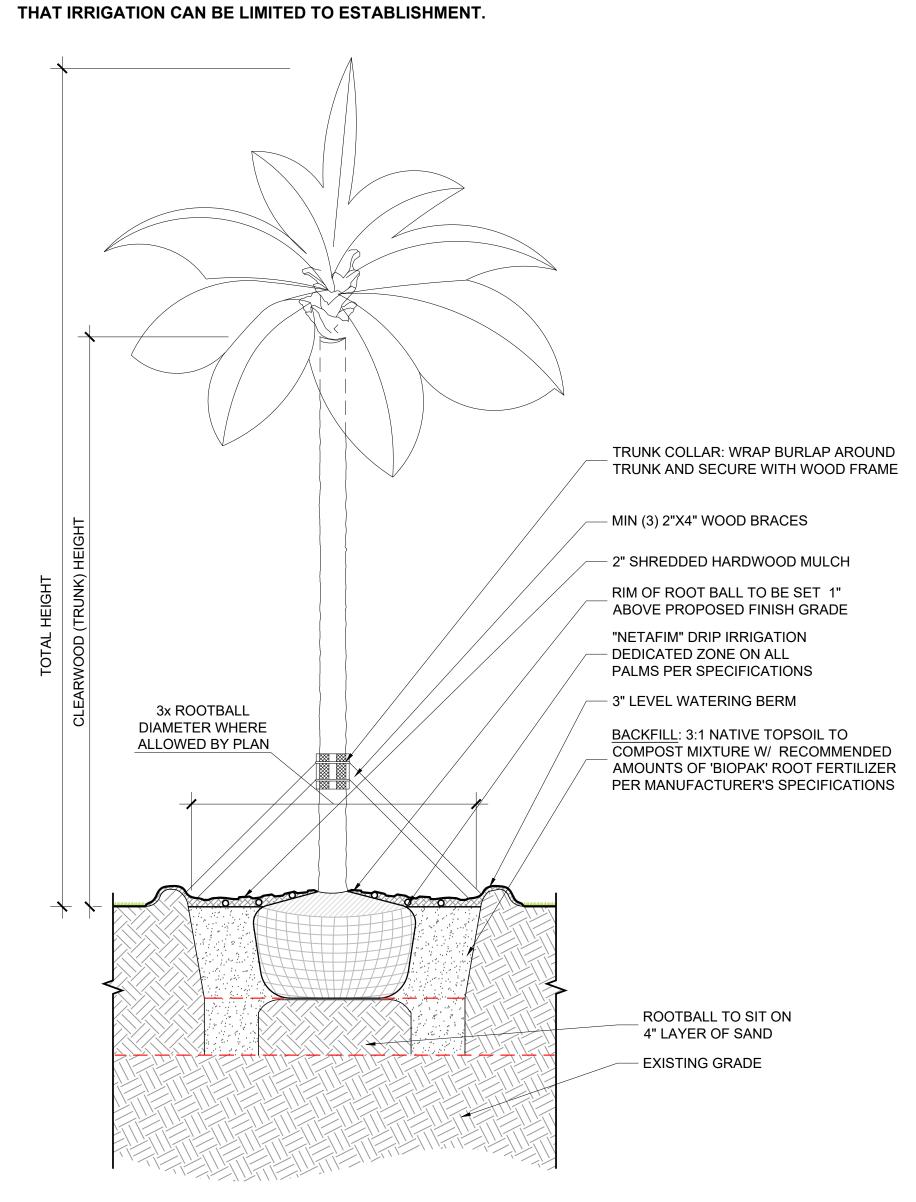



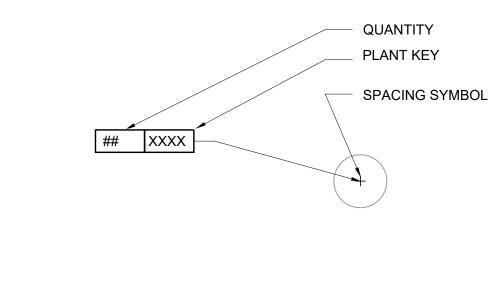

				PLANT	LIST					
SYMB KEY	QTY	COMMON NAME	BOTANICAL NAME	SIZE	MINIMUM FL PLANT GRADE	SPACING	NATIVE	NOTES		SITE KEY
										PROPERTY LI
REES		1								SETBACKS
CE	6	Green Buttonwood	Conocarpus erectus	4-5" CAL.	FANCY	-	Υ	SPECIMEN TREES, LIMBED UP TO 7'		EASEMENTS
BS	2	Gumbo-limbo	Bursera simaruba	8-9" CAL.	FANCY	-	Υ	SPECIMEN TREES		
GS	6	Lignum Vitae	Guaiacum sanctum	12-14' HT.	FANCY	-	Υ	SPECIMEN TREES		EXISTING STR TO BE REMOV
QV	8	Live Oak	Quercus virginiana	8-9" CAL.	FANCY	-	Υ	SPECIMEN TREES, LIMBED UP TO 7'		
TOTAL	22					% NATIVE	59%		25	EXISTING CON
									25	PROPOSED CO
ALMS										
AA	9	Alexandra palm	Archontophoenix alexandrae	18' HT.	#1 OR BETTER	-	-		x (44.5)	EXISTING SPC
PD	8	Date Palm	Phoenix dactylifera	14-16' HT.	FANCY	-	-		. 45.5	PROPOSED SI
WB1	4	Foxtail palm	Wodyetia bifurcata	12-14' HT.	#1 OR BETTER	-	-		+ 45.5	PROPOSED S
WB2	3	Foxtail palm	Wodyetia bifurcata	16' HT.	#1 OR BETTER	-	-			5)40 7 11.0 551
TOTAL	24					% NATIVE	00%		xx	EXISTING FEN
									_+	PROPOSED W
HRUBS / HEDGE	3									PROPOSED S
CE	57	Green Buttonwood	Conocarpus erectus	4-5' HT.	#1 OR BETTER	36" O.C.	Υ	HEAVY, HEDGE ALONG INTERIOR OF WALL		FROFOSED 3
FM	455	Green Island Ficus	Ficus microcarpa 'Green Island'	5 GAL.	#1 OR BETTER	18" O.C.	-			EXISTING DEC
CG	220	Small Leaf Clusia	Clusia guttifera	7-8' HT.	#1 OR BETTER	36" O.C.	Υ	REPLACE ALL EXISTING FICUS W/ CLUSIA HEDGE		TREES TO RE
TOTAL	1,918					% NATIVE	33%			
									ENTE	
ROUNDCOVER /	PERENNI	AL								EXISTING PAL
AA	42	Spineless Agave	Agave attenuata	3 GAL.	#1 OR BETTER	36" O.C.	-		Ture !	REMAIN
CI	529	Cocoplum	Chrysobalanus icao	1 GAL.	#1 OR BETTER	12" O.C.	Y		34	
CM	585	Natal Plum	Carissa macrocarpa	1 GAL.	#1 OR BETTER	12" O.C.	-			DDODOCED D
HI	247	Mangrove Spiderlily	Hymenocallis latifolia	1 GAL.	#1 OR BETTER	18" O.C.	Υ		+ + }	PROPOSED D TREES
Sr	64	Bird of paradise	Strelitzia reginae	7 GAL.	#1 OR BETTER	36" O.C.	-			
TOTAL	2,722	Sq Ft				% NATIVE	53%			
	•			•						PROPOSED
OD										
	3.800	Bentgrass	Agrostis stolonifera	Sod	_	_	_			

	SETBACKS
	EASEMENTS
	EXISTING STRUCTURES TO BE REMOVED
25	EXISTING CONTOUR
25	PROPOSED CONTOUR
x (44.5)	EXISTING SPOT ELEV
+ <u>45.5</u>	PROPOSED SPOT ELEV
xx	EXISTING FENCE
	PROPOSED WIRE FENCE
	PROPOSED SOLID FENCE
	EXISTING DECIDUOUS TREES TO REMAIN
EN S	EXISTING PALM TREE TO REMAIN
++	PROPOSED DECIDUOUS TREES
	PROPOSED PALM TREE

PROJECT DATA: BASED ON SURVEY BY: WALLACE SURVEYING CORP. JOB NO: 10-1040, DATED 06/27/23

PBCTM#: 50-43-43-10-24-000-0260

LOT AREA: 26,552 SF

R-B | LOW DENSITY RESIDENTIAL (50-PALM BEACH)

COVERAGE: SEE CHART

FLOOD ZONE: AE (EL. 6)

EASEMENT/OTHER:

SEE PLAN



ANY MODIFICATIONS TO WORK OUTLINED IN THE
ATTACHED DRAWING(S), OR THE ASSOCIATED APPROVED
CONTRACT, MUST BE APPROVED IN WRITING BEFORE
EXECUTING THE WORK. THIS INCLUDES, ADDITIONS, SUBSTITUTIONS, DELETIONS OR ADJUSTMENTS TO THE ADDITIONAL WORK, THAT HAS NOT BEEN APPROVED IN WRITING, SHALL BE CONSIDERED INVALID AND WILL NOT

PRELIMINARY NOT FOR CONSTRUCTION DATA SHOWN FOR DESIGN DEVELOPMENT ONLY

LaGuardia Design Landscape Architects 38 Scuttle Hole Road Water Mill, NY 11976 Phone:631-726-1403 Fax:631-726-1478

These drawings & specifications are the property of LaGuardia Design Landscape Architecture P.C. & are for use solely with respect to this project. They are not to be used by the owner, contractor, sub-contractors or suppliers on other projects or for additions to this project outside the scope of the work. LaGuardia Design Landscape Architecture P.C. shall be deemed the author & retain all common law, statutory & other reserved rights, in addition to the copyrights. The design shown & described herein, including all technical drawings, are proprietary & cannot be copied, duplicated, or commercially exploited, in whole or in part without written authorization of LaGuardia Design Landscape Architecture P.C. COPYRIGHT © 2019 ALL RIGHTS RESERVED


DRAWN BY: JL CHECKED BY: CL PROJECT: CARDINALE RESIDENCE LOCATION:

960 N OCEAN BLVD PALM BEACH, FL 33480 DRAWING: PLANTING PLAN

SCALE: DATE: 3/32"=1'-0" | FEBRUARY 23, 2024 ISSUED: - 01/26/2024 FOR REVIEW - 02/07/2024 FOR PERMIT - 02/26/2024 FOR PERMIT

SHEET NUMBER:



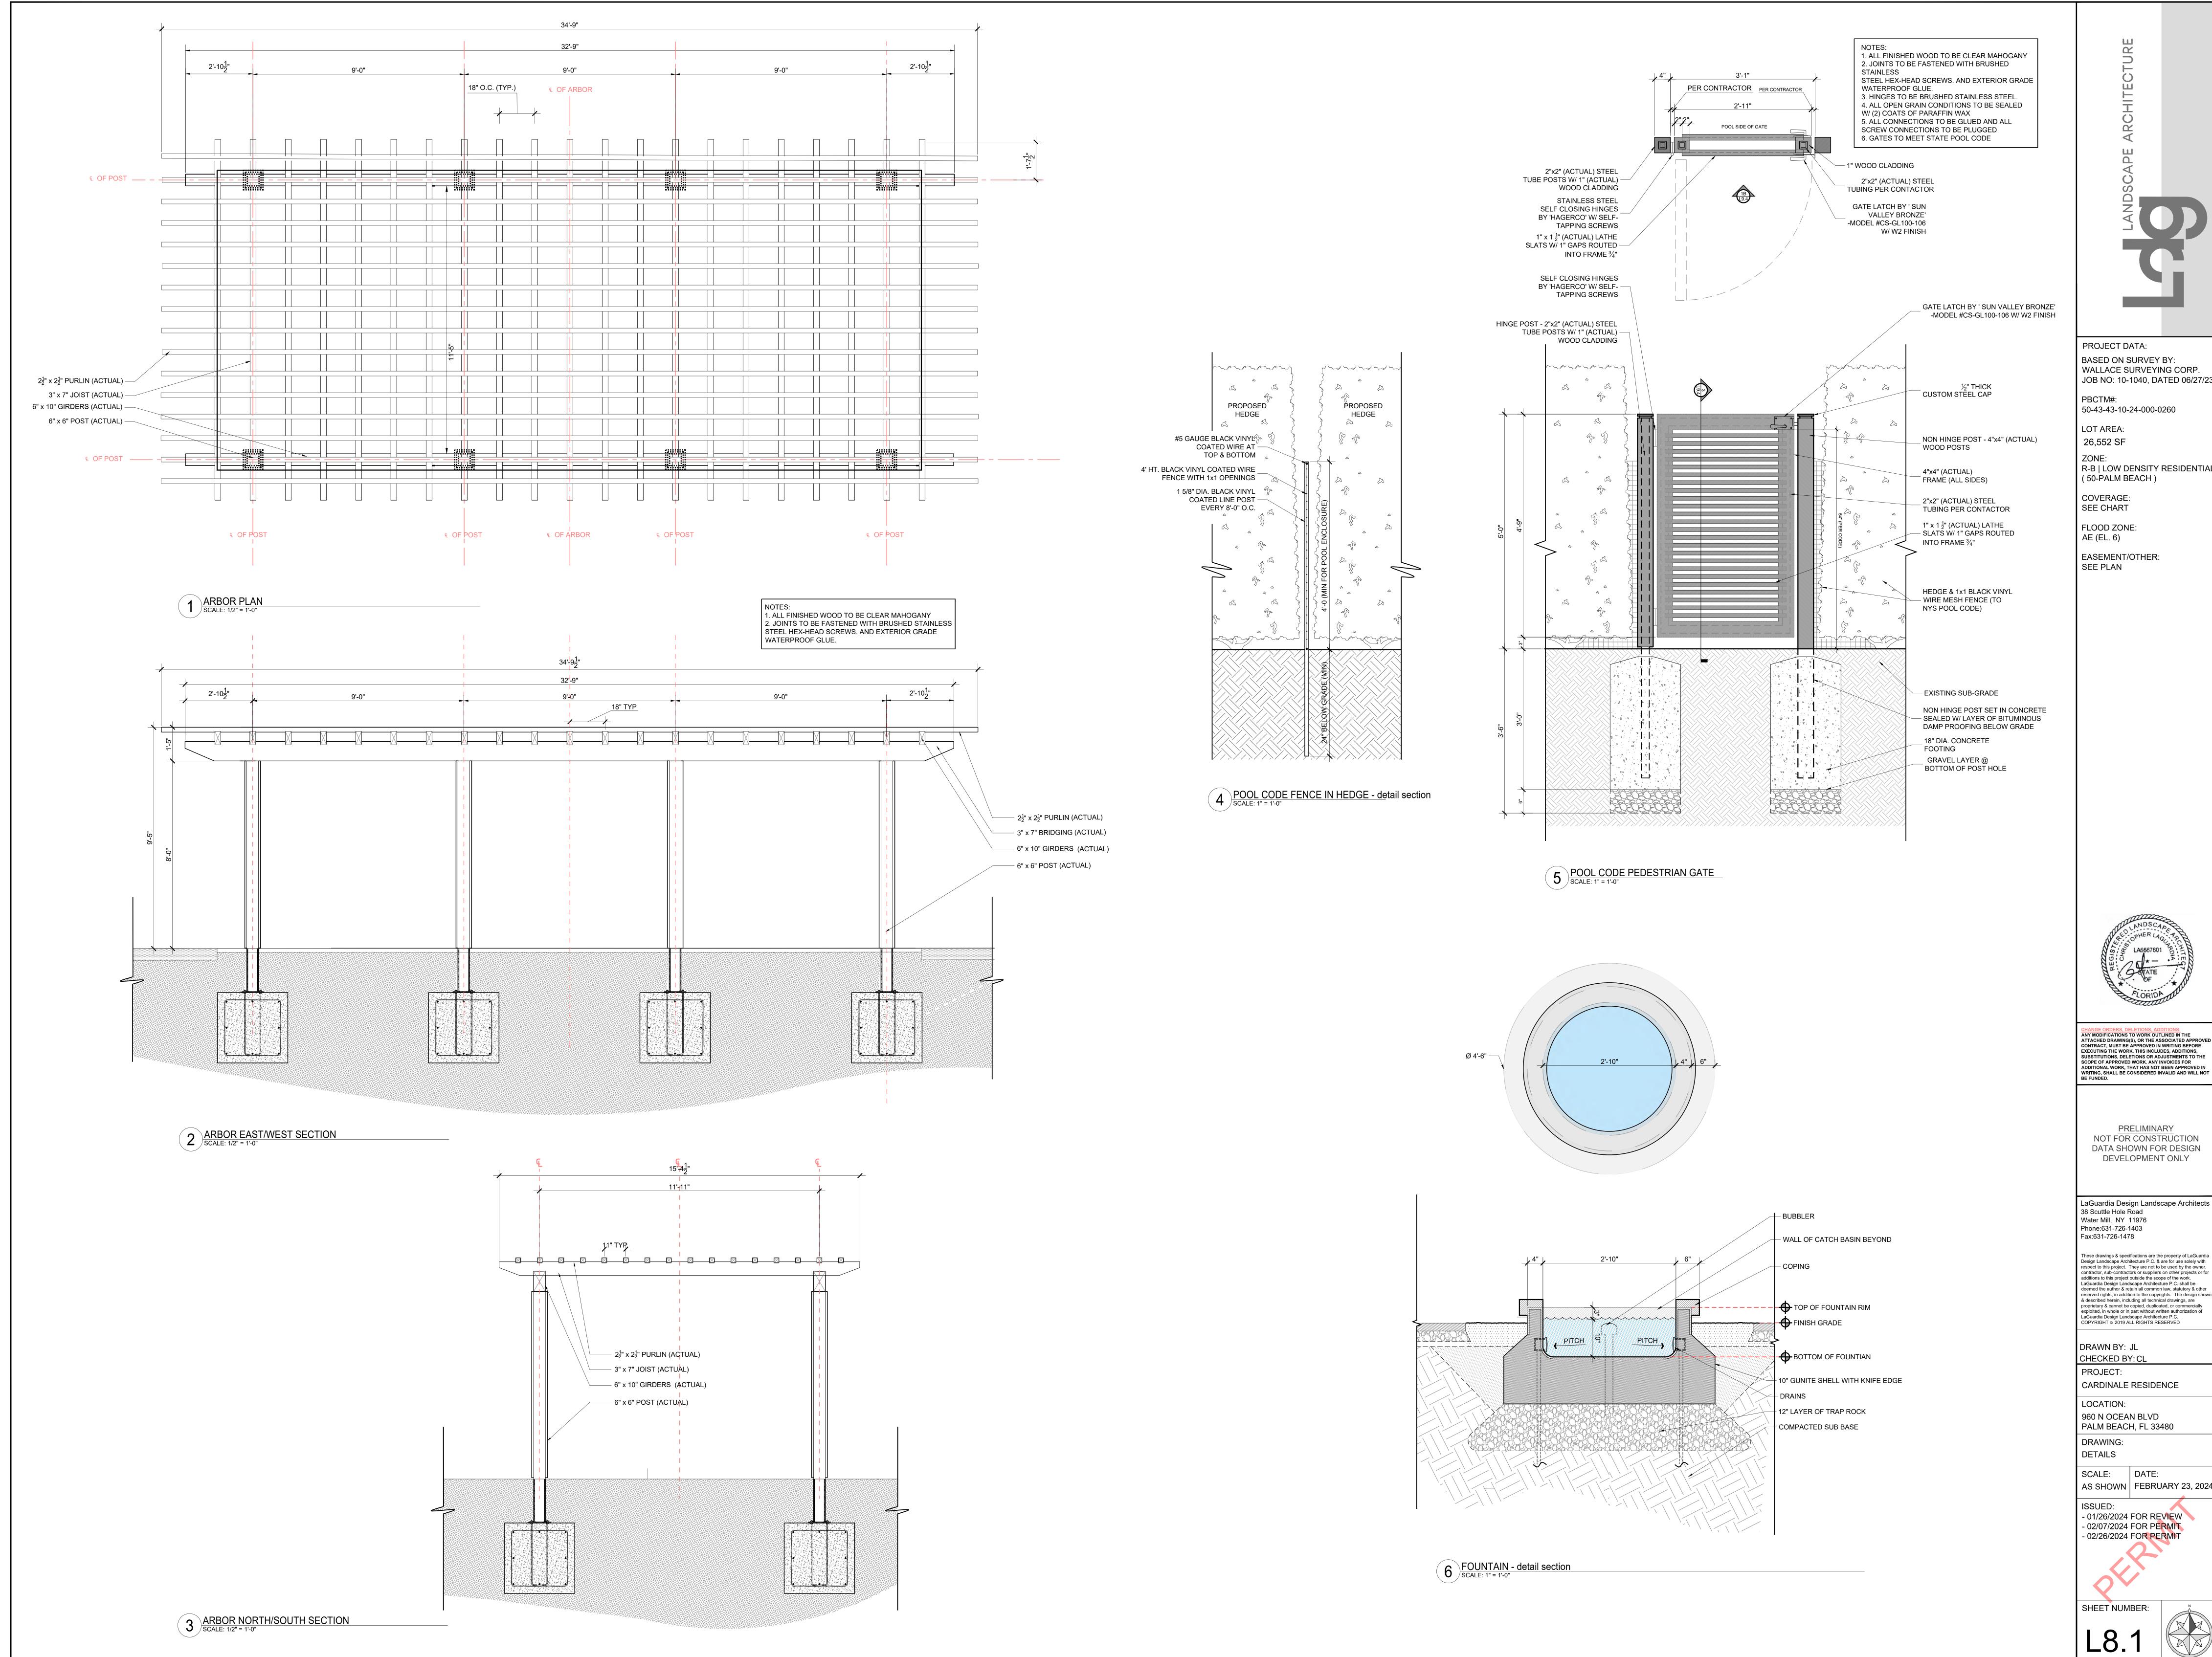

BASED ON SURVEY BY: WALLACE SURVEYING CORP. JOB NO: 10-1040, DATED 06/27/23 50-43-43-10-24-000-0260

R-B | LOW DENSITY RESIDENTIAL (50-PALM BEACH)

EASEMENT/OTHER:



CHANGE ORDERS, DELETIONS, ADDITIONS:
ANY MODIFICATIONS TO WORK OUTLINED IN THE
ATTACHED DRAWING(S), OR THE ASSOCIATED APPROVED
CONTRACT, MUST BE APPROVED IN WRITING BEFORE
EXECUTING THE WORK. THIS INCLUDES, ADDITIONS, SUBSTITUTIONS, DELETIONS OR ADJUSTMENTS TO THE ADDITIONAL WORK, THAT HAS NOT BEEN APPROVED IN WRITING, SHALL BE CONSIDERED INVALID AND WILL NOT

PRELIMINARY NOT FOR CONSTRUCTION DATA SHOWN FOR DESIGN

LaGuardia Design Landscape Architects

Design Landscape Architecture P.C. & are for use solely with respect to this project. They are not to be used by the owner, contractor, sub-contractors or suppliers on other projects or for additions to this project outside the scope of the work. LaGuardia Design Landscape Architecture P.C. shall be deemed the author & retain all common law, statutory & other reserved rights, in addition to the copyrights. The design shown & described herein, including all technical drawings, are proprietary & cannot be copied, duplicated, or commercially exploited, in whole or in part without written authorization of LaGuardia Design Landscape Architecture P.C. COPYRIGHT © 2019 ALL RIGHTS RESERVED

CARDINALE RESIDENCE

960 N OCEAN BLVD PALM BEACH, FL 33480

AS SHOWN FEBRUARY 23, 2024

- 01/26/2024 FOR REVIEW - 02/07/2024 FOR PERMIT - 02/26/2024 FOR PERMIT

