ZON-24-041 Second Submittal

Town Council Hearing: March 13, 2024

Addition to

Smith Residence

241 Sanford Avenue Palm Beach, FL 33480



Scope of Work:


- Addition of New Two-Story Structure at Rear of Existing Residence.
- New Structure to Match Existing in Color and Finished Materials.

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CONSULTANT CONTACT INFORMATION Architect Smith Architectural Group 205 Phipps Plaza Palm Beach, Florida (561) 832-0202

Drawing Sheet Index

NO.	DESCRIPTION	SCALE
Cover	Cover Sheet and Index	No Scale
A000	Existing and Proposed Site Plan	½"=1'-0"
A001	Location and Vicinity Maps	No Scale
A002	Site Calculation Graphics	
D100	Demolition Floor Plans	½"=1'-0"
A100	Existing and Proposed Partial First Floor Plan	½"=1'-0"
A101	Existing and Proposed Partial Second Floor Plan	½"=1'-0"
A102	Existing and Proposed Partial Roof Plans	
A200	Existing and Proposed Partial West Elevations	½"=1'-0"
A201	Existing and Proposed Partial North Elevations	½"=1'-0"
A202	Proposed Colored Elevations	½"=1'-0"
A203	Existing Photos	-
A204	Streetscape Photos	
A300	Wall Section	1"=1'-0"
CSP	Construction Staging and Screening Plan Truck Logistics Plan	

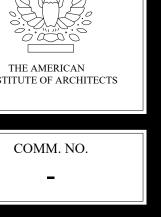

LPC

January 29, 2024

SMITH

Line #		Zoning Legend
1	Property Address:	241 Sanford Avenue
2	Zoning District:	R-B
3	Lot Area (sq. ft.):	11,950 Square Feet Total
4	Lot Width (W) & Depth (D) (ft.):	100.00' (W) x 119.50' (D)
5	Structure Type: (Single-Family, Multi-Family, Comm., Other)	Two-Story Single Family Residence
6	FEMA Flood Zone Designation:	AE
7	Zero Datum for point of meas. (NAVD)	5.52' NAVD

/	Zero Datum for point of meas. (NAVD)	5.52 NAVD		
8	Crown of Road (COR) (NAVD))) 6.00' NAVD		
9		REQ'D / PERMITTED	EXISTING	PROPOSED
10	Lot Coverage (Sq Ft and %)	30%	24.7%	25.3%
11	Enclosed Square Footage (1st & 2nd Fl., Basement, Accs. Structure, etc)		5,298 Sq Ft	5,436 Sq Ft
12	*Front Yard Setback (Ft.)	30' (Two-Story)	35.5'	NC
13	* Side Yard Setback (1st Story) (Ft.)	12.5'	5.1' (W)	NC
14	* Side Yard Setback (2nd Story) (Ft.)	15'	5.1' (W) / 7.5' (E)	NC
15	*Rear Yard Setback (Ft.)	15' (Two-Story)	34.7'	NC
16	Angle of Vision (Deg.)	100	100	NC
17	Building Height (Ft.)	22'-0"	18'-4"	NC
18	Overall Building Height (Ft.)	30'	28'-3 1/4"	NC
19	Cubic Content Ratio (CCR) (R-B ONLY)	3.98	3.78	3.88
20	** Max. Fill Added to Site (Ft.)			
21	Finished Floor Elev. (FFE)(NAVD)		5.25'	NC
22	Base Flood Elevation (BFE)(NAVD)	6.00'		
23	Landscape Open Space (LOS) (Sq Ft and %)	45% Min.	50.5%	49.9%
24	Perimeter LOS (Sq Ft and %)	50% Min.	72.8%	72.5%
25	Front Yard LOS (Sq Ft and %)	40% Min.	80.4%	NC

*** Native Plant Species %

Building Calculations

Existing 1st Floor Conditioned Space 2,557 SF
Existing 2nd Floor Conditioned Space 2,341 SF
Garage 400 SF


Proposed 1st Floor Conditioned Space 69 SF (2,626 SF New 1st Floor Total)
Proposed 2nd Floor Conditioned Space 69 SF (2,410 SF New 2nd Floor Total)

Total Enclosed Space 5,436 SF
Terrace 202 SF

100.00'Existing Pool and Patio 12'-6" One-Story Side Yard Bldg. Setback One-Story Side Yard Bldg. Setback Two-Story Side Yard Bldg, Setback Two-Story Side Yard Bldg. Setback Existing Two-Story Residence Existing Generator Existing Site Wall at
 Adjacent Property Existing A/C — ∠ Existing Driveway ¬ — Existing Walkway Max. Angle of Vision ___ Existing Fenceline, Piers, and Gate Existing 2'-0" Continuous Concrete Gutter 100.00' Existing Edge of Pavement Sanford Avenue

Existing Site Plan

Scale:

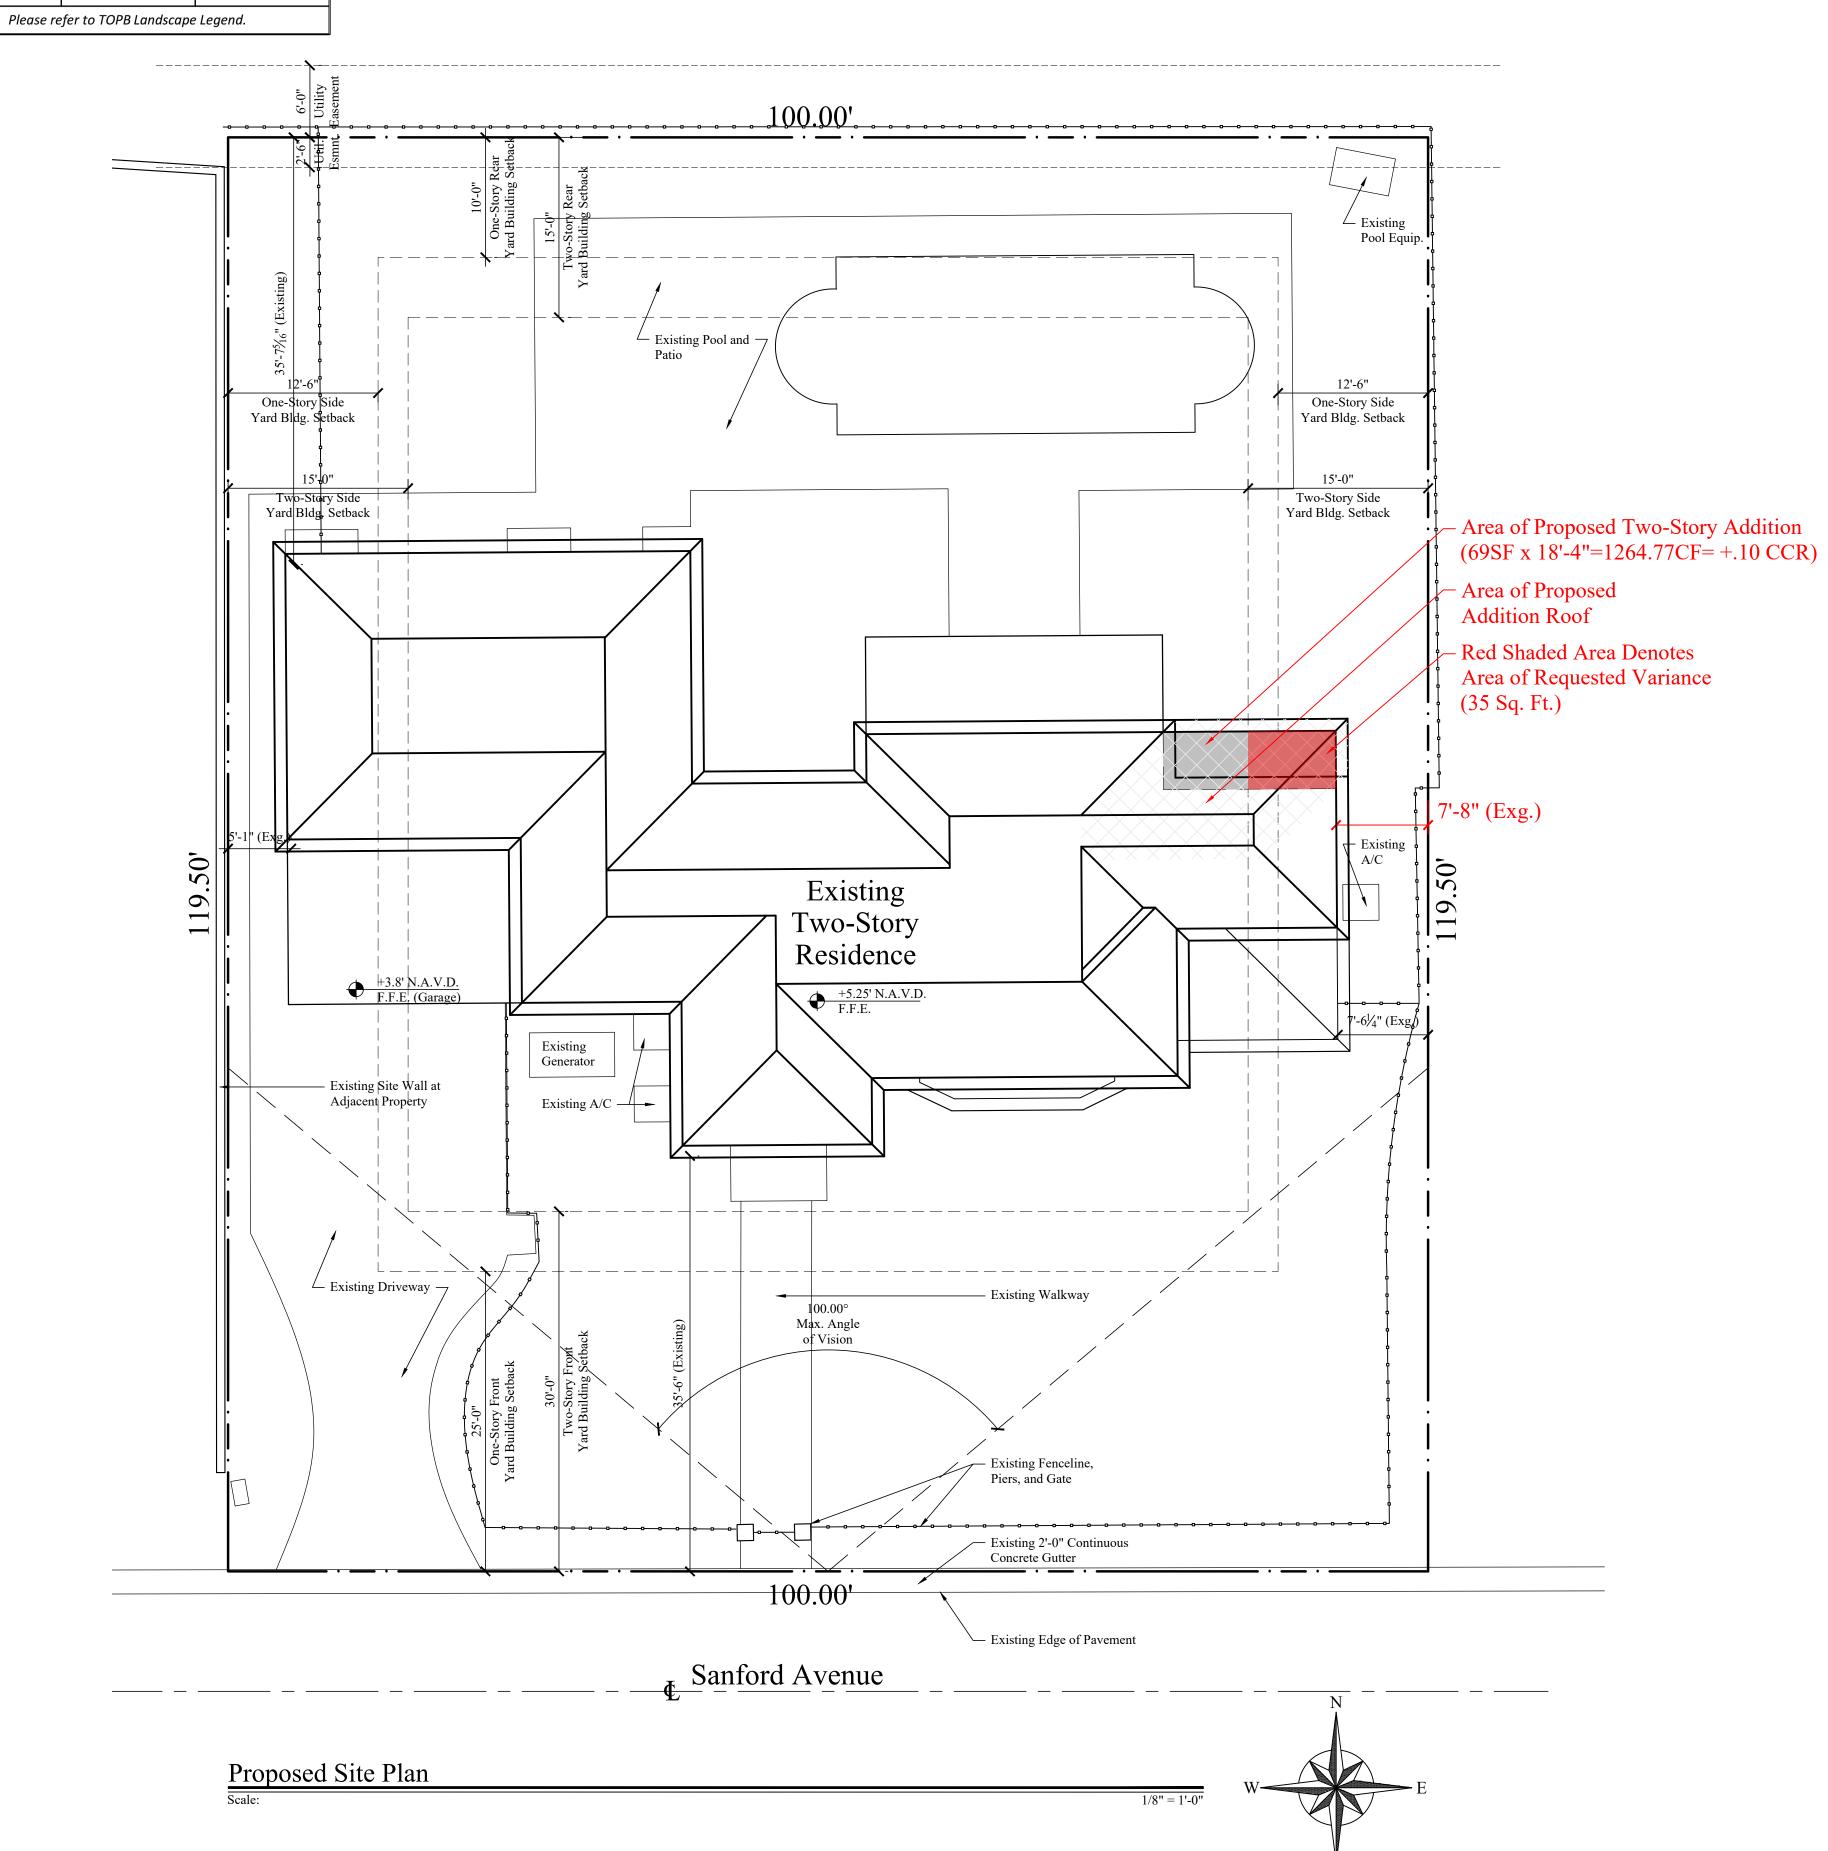

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January 29, 2024

SMITH ARCHITECTURAL GROUP, IN


205 PHIPPS PLAZA
PALM BEACH, FL 33480
561-832-0202

Ir. and Mrs. Jeffery W. Smith


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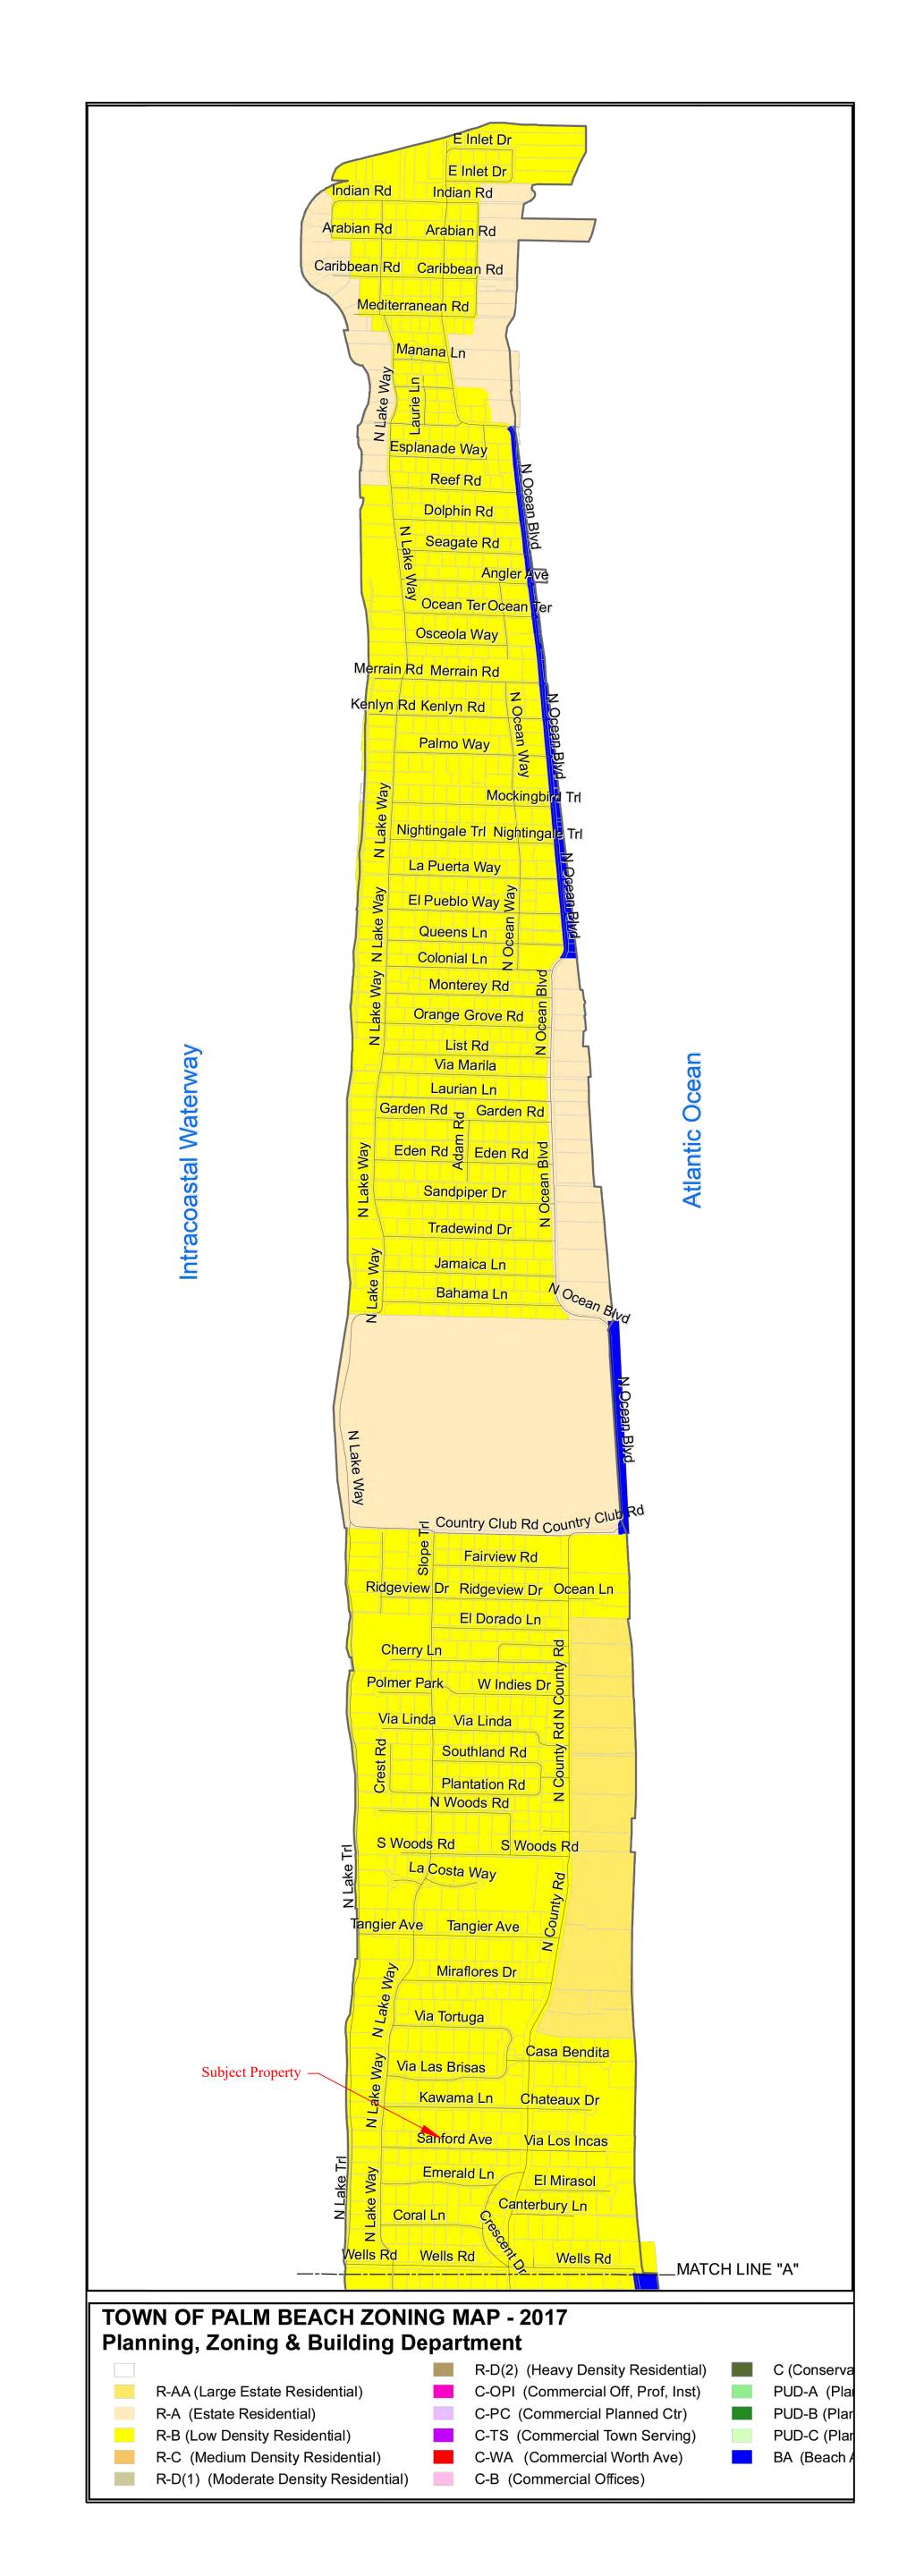
Jeffery W. Smith AR9772

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Vicinity Location Map



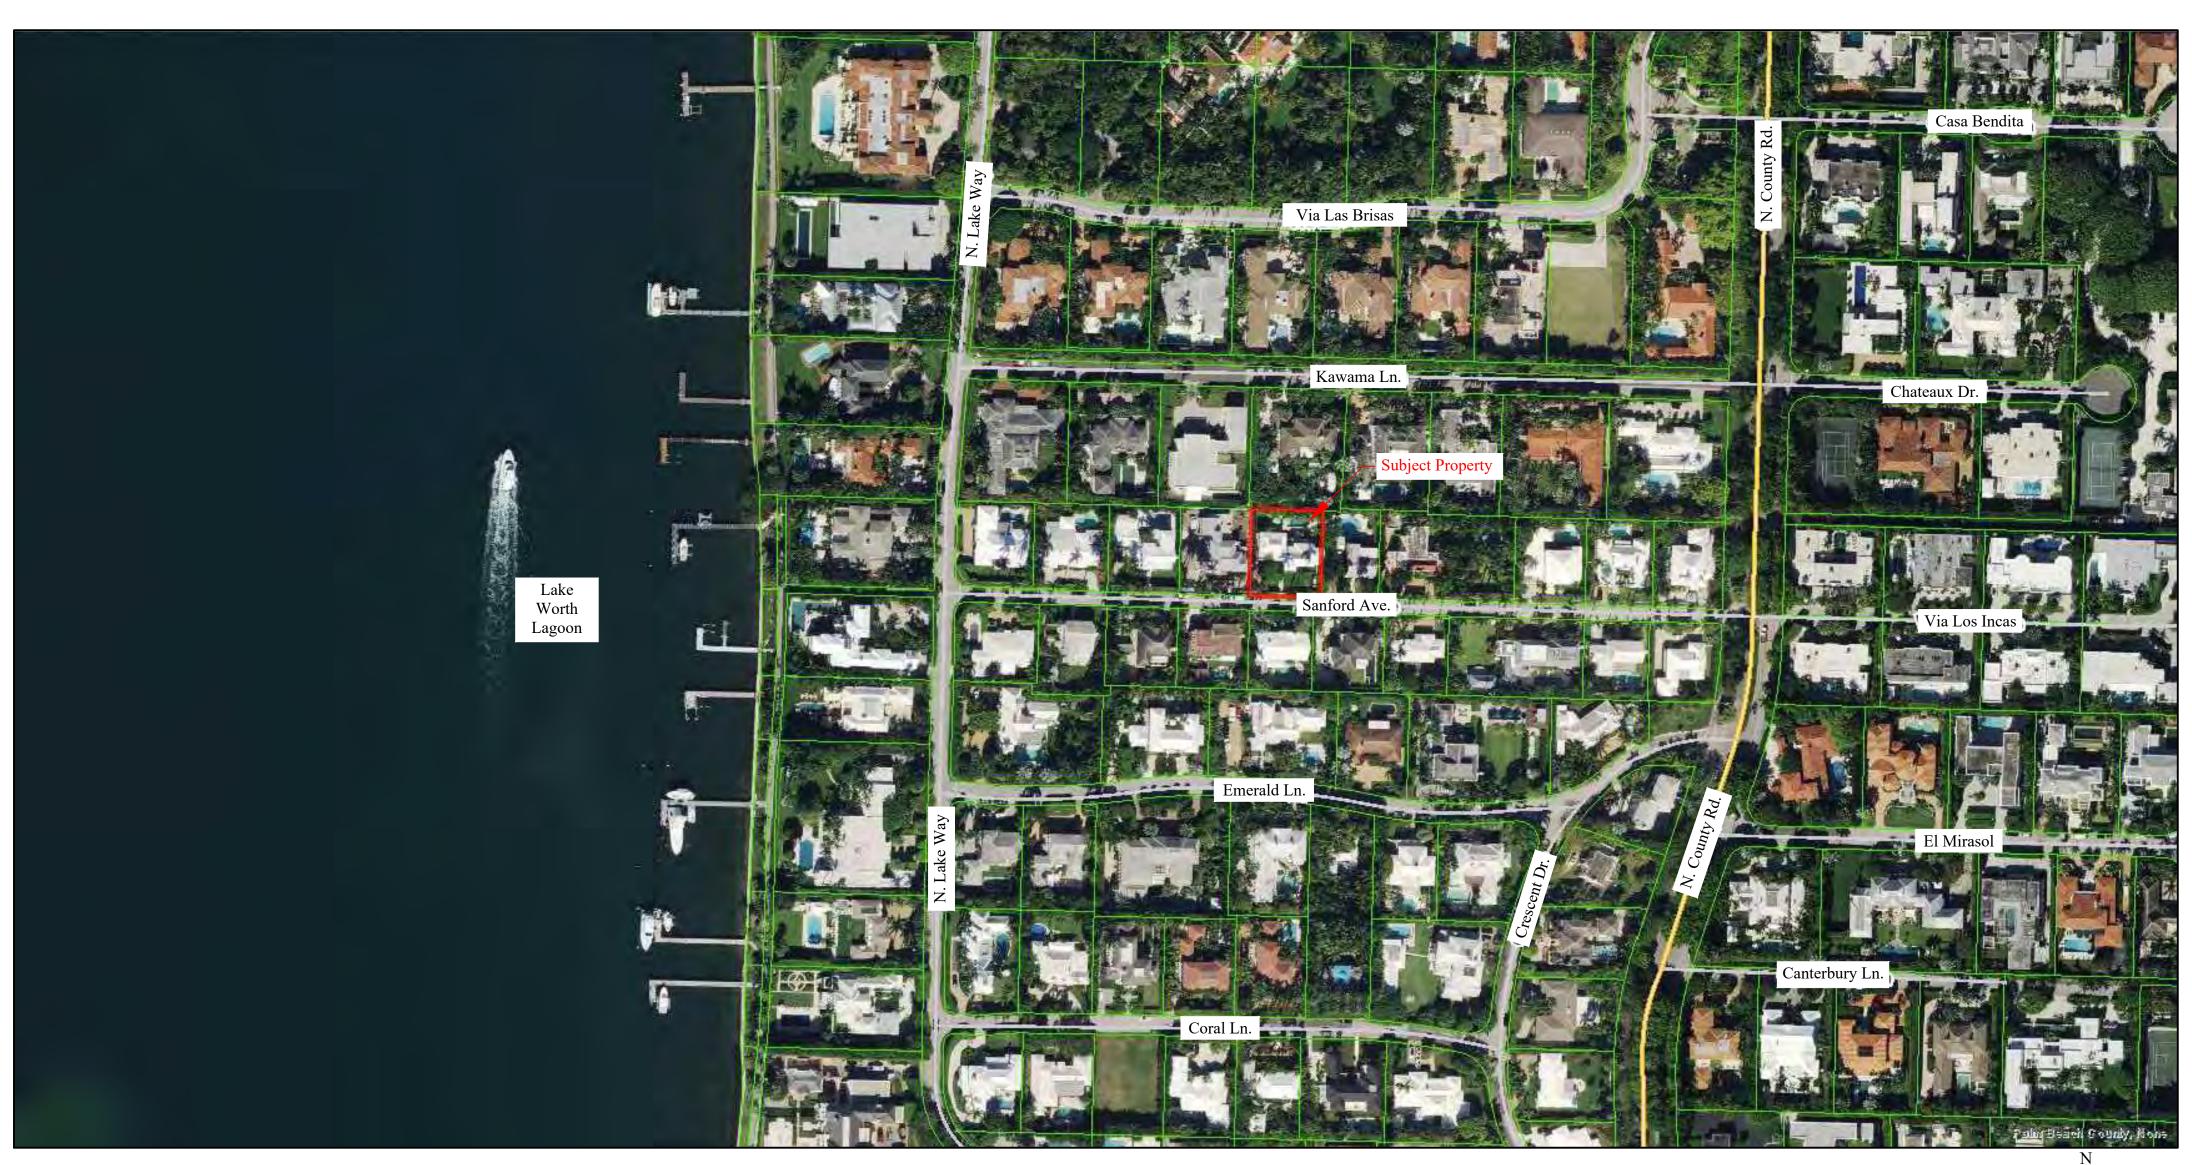

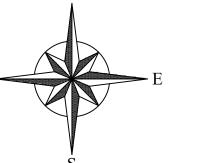

January 29, 2024

REVISIONS MODIFICATION DATE

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Jeffery W. Smith AR9772

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Building Calculations

Existing 1st Floor Conditioned Space 2,557 SF Existing 2nd Floor Conditioned Space


2,341 SF 400 SF

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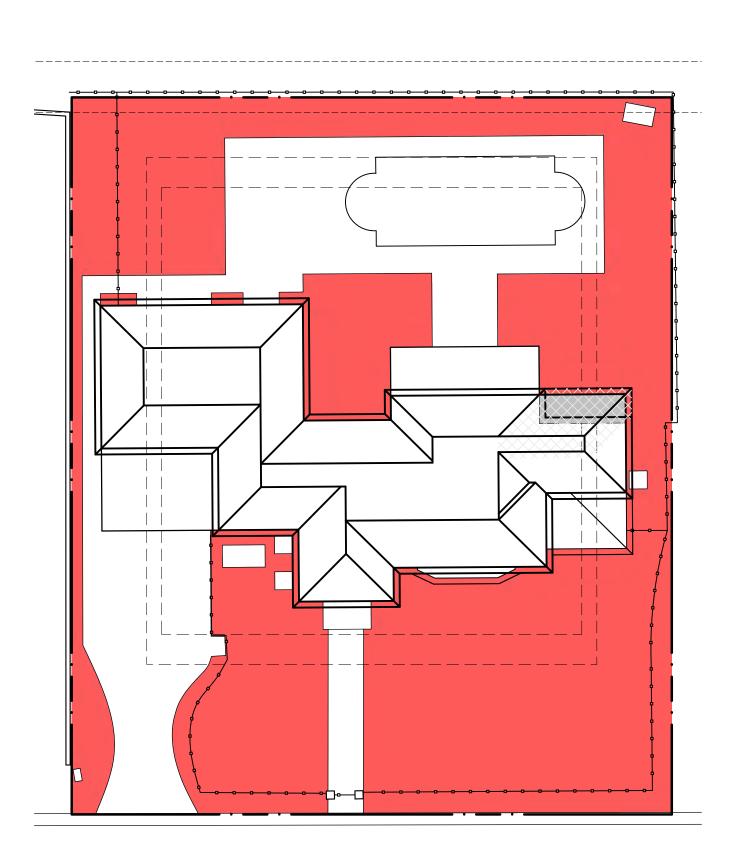
Please refer to TOPB Landscape Legend.



Maximum Lot Coverage = 30%

Lot Coverage
Scale:

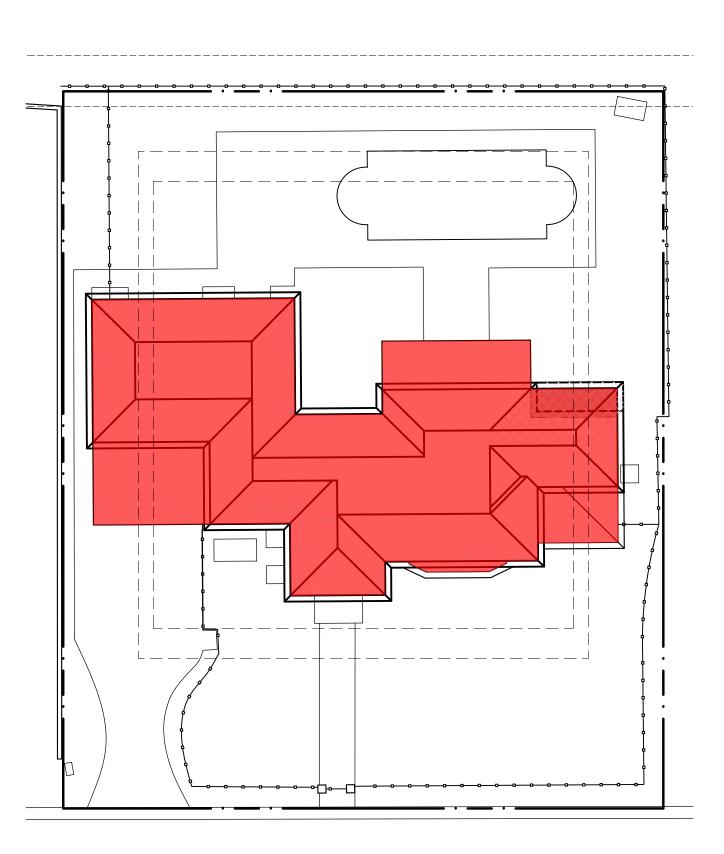
Site Area = 11,950 Sq. Ft. Covered Area = 3,026 Sq. Ft. = 25.3% Existing 24.7% = Increase of 0.6% Covered Area 1/16" = 1'-0"



Landscape Open Area

Scale: 1/16" = 1'-0"

> Minimum Landscape Open Area = 45% Site Area = 11,950 Sq. Ft. Open Landscape Area = 5,969 Sq. Ft. = 49.9% Existing 50.5% = Decrease of 0.6% Open Space

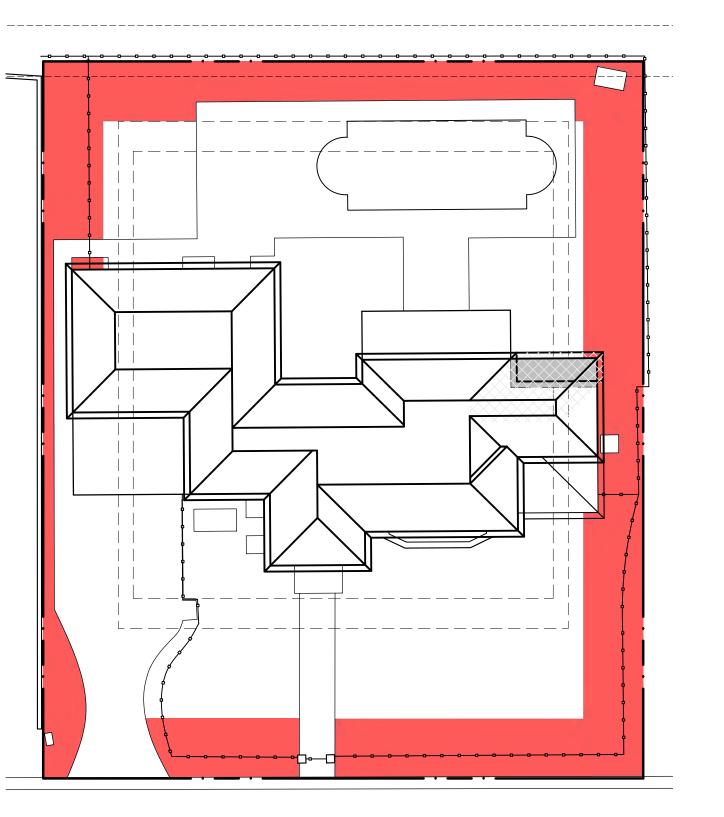

Maximum CCU = 3.98

Existing CCR = 3.78


New Addition = 69 Sq. Ft. x 18'-4" (Match Existing Top Plate and Finished Floor) = 1,265 Cubic Feet = .10 CCR

New Proposed CCR = 3.78 (Exg) + .10 (New) = 3.88 Total CCR

Perimeter Landscape Open Area

Minimum Perimeter Landscape Open Area = 50% Perimeter = 3,990 Sq. Ft. Open Landscape Area = 2,894.5 Sq. Ft. = 72.5% Existing 72.8% = Decrease of 0.3% Open Space

1/16" = 1'-0"

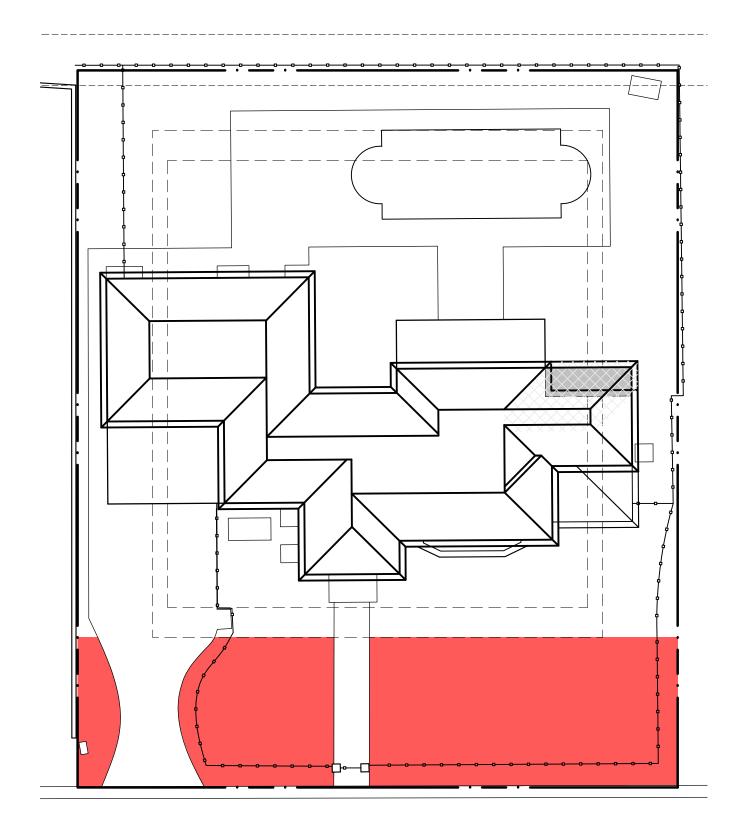

Front Yard Landscape Open Area

Minimum Front Yard Landscape Open Area = 40%

1/16" = 1'-0"

Front Yard = 2,500 Sq. Ft. Open Landscape Area = 2,012 Sq. Ft. = 80.4%

No Change

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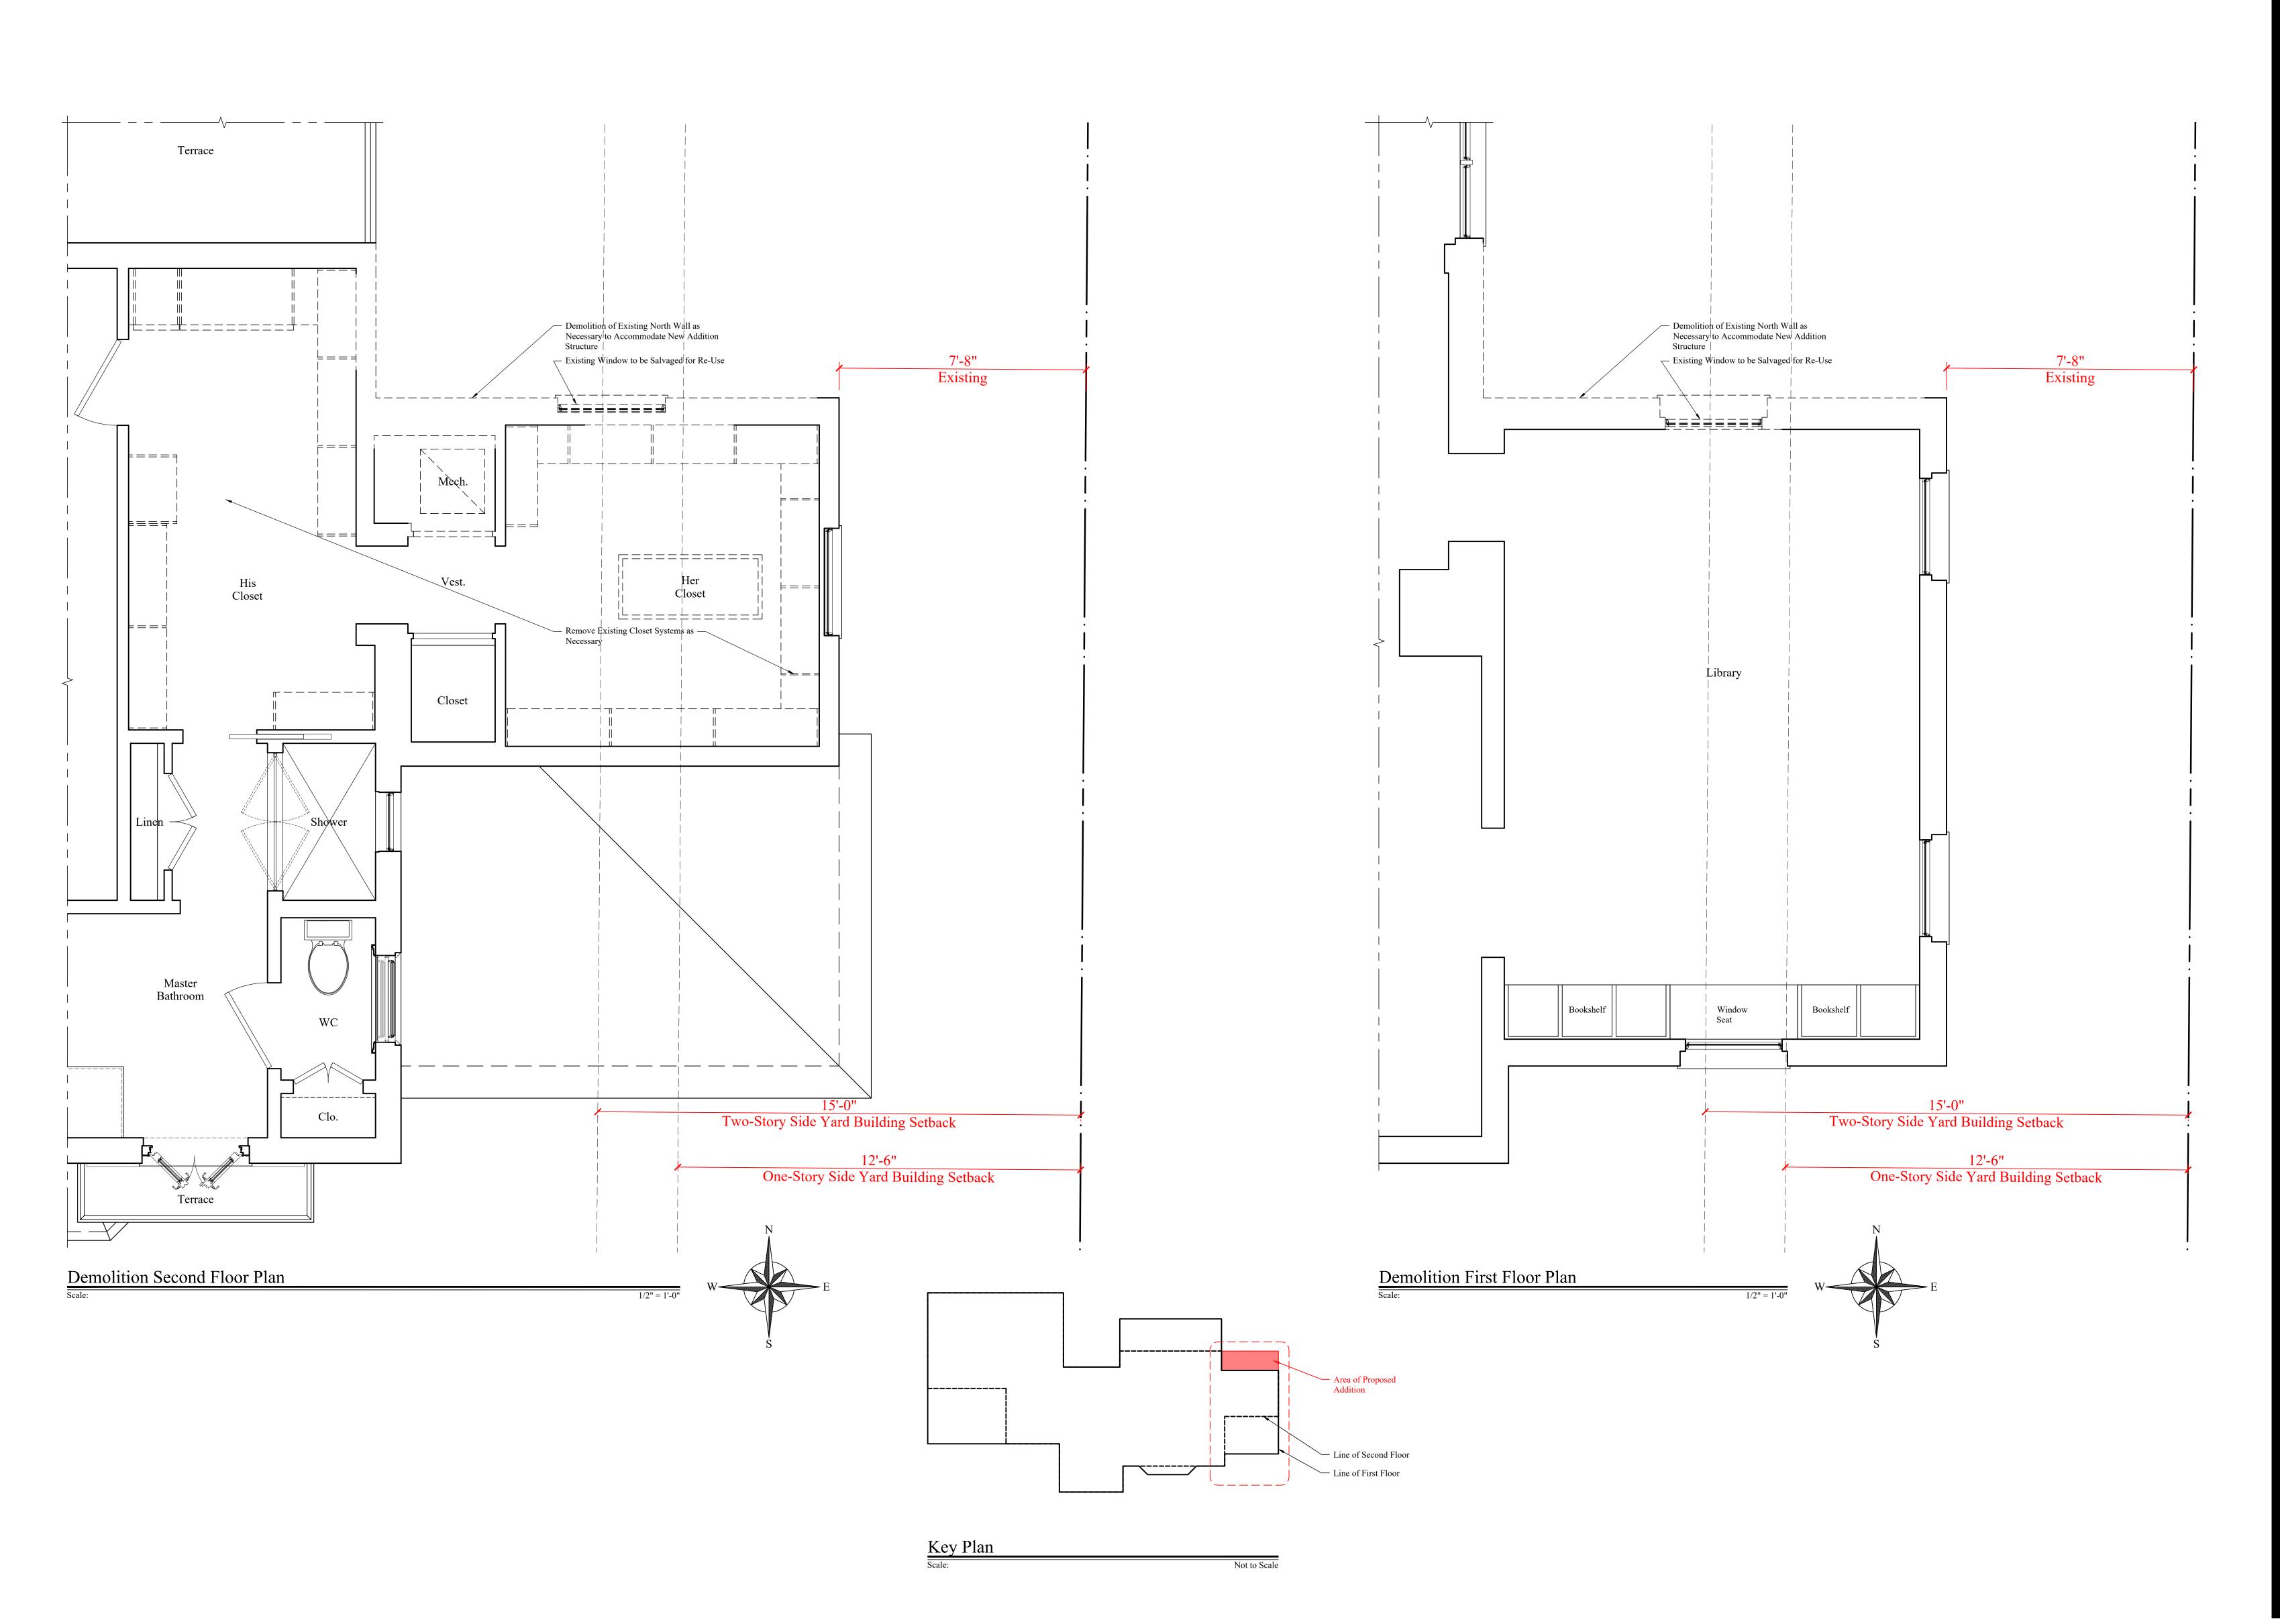
January 29, 2024

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Jeffery W. Smith AR9772

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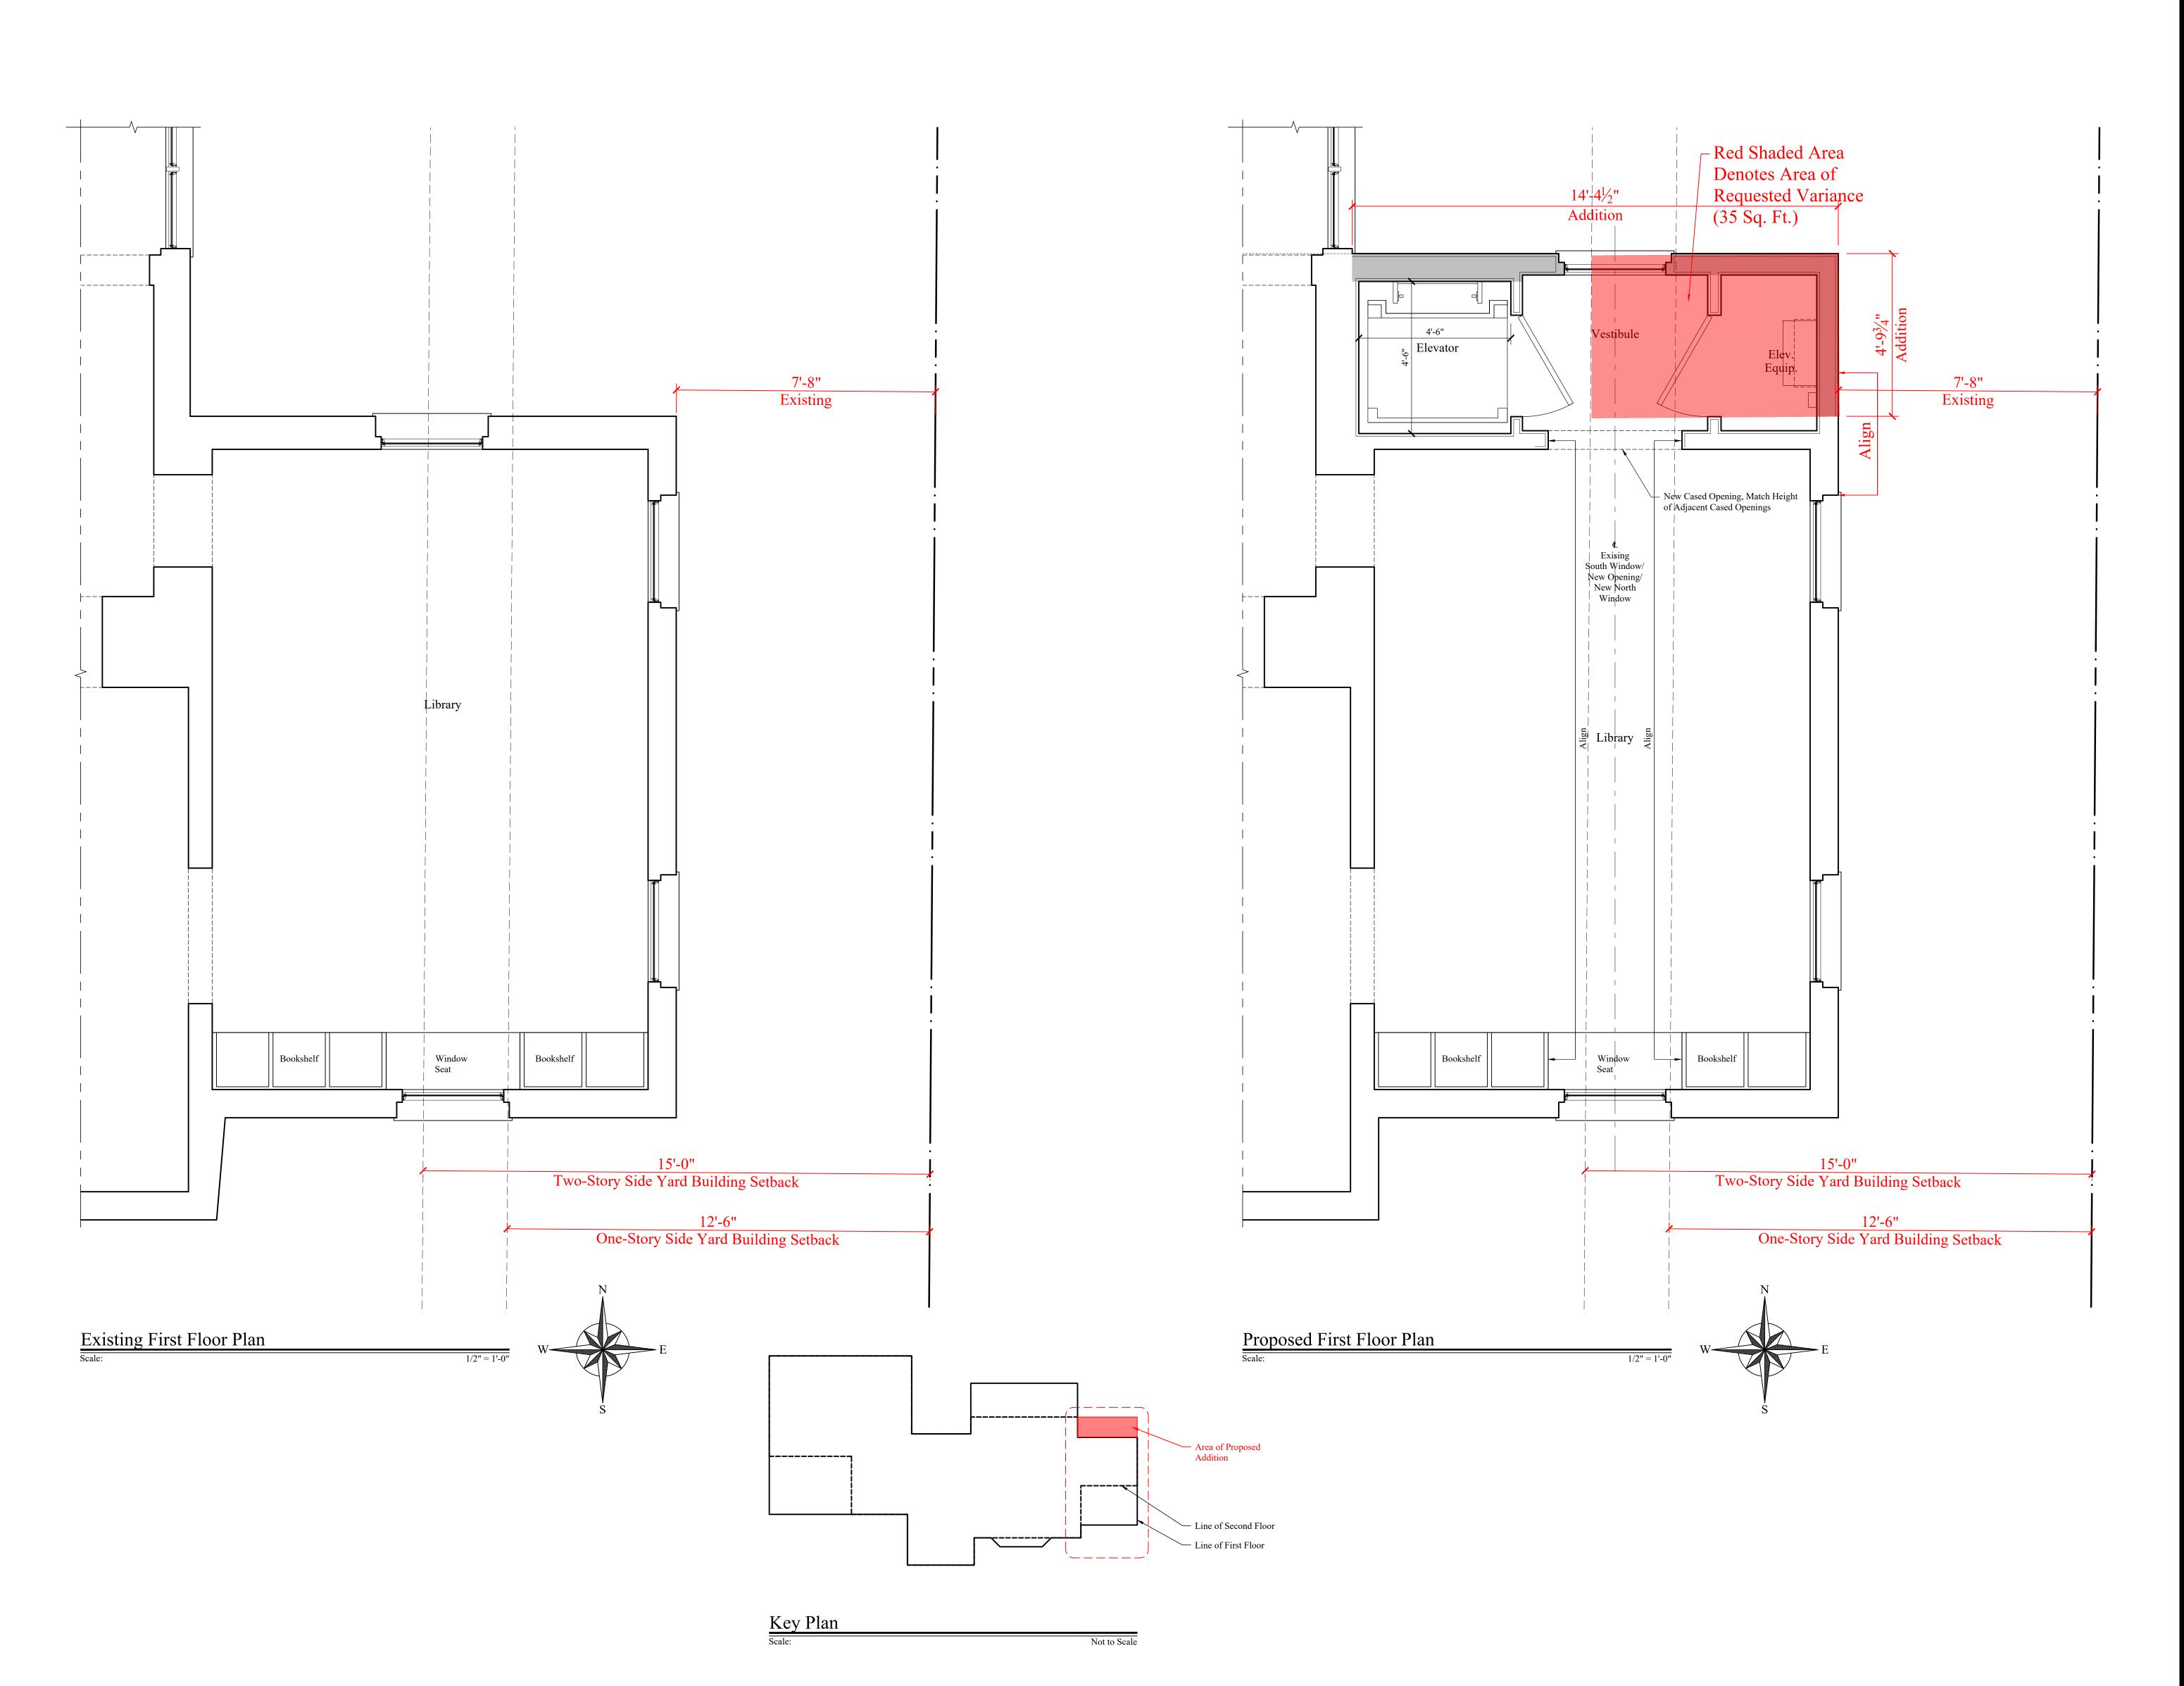
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January 29, 2024 REVISIONS

NO. MODIFICATION DATE

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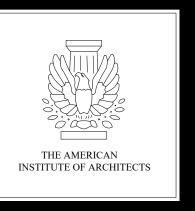
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January 29, 2024

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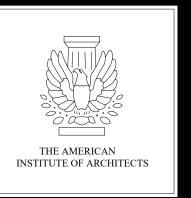
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January 29, 2024

REVISIONS

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I ARCHITECTURAL GR 205 PHIPPS PLAZA PALM BEACH, FL 33480 561-832-0202 SMITH



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A200

Proposed East Elevation

Scale:

Proposed Partial North Elevation

SMITH

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Jeffery W. Smith AR9772

SHEET NO.

Proposed East Elevation - Colored

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January 29, 2024

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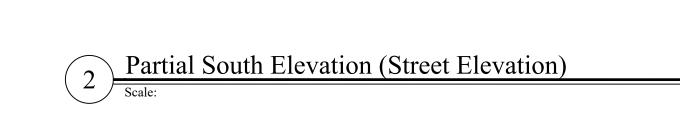
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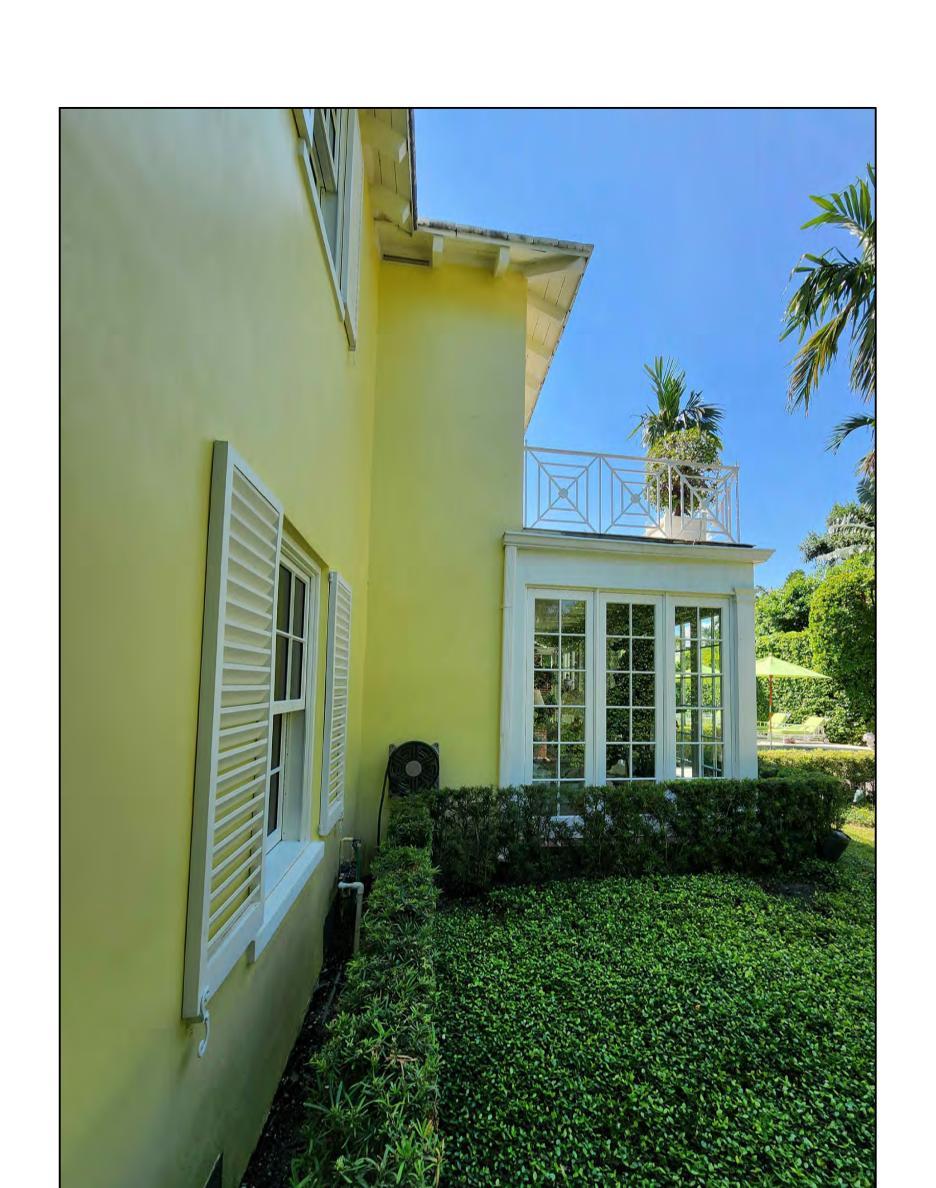
Jeffery W. Smith AR9772

SHEET NO.






Area of Proposed Addition



South Elevation (Street Elevation)

Scale:



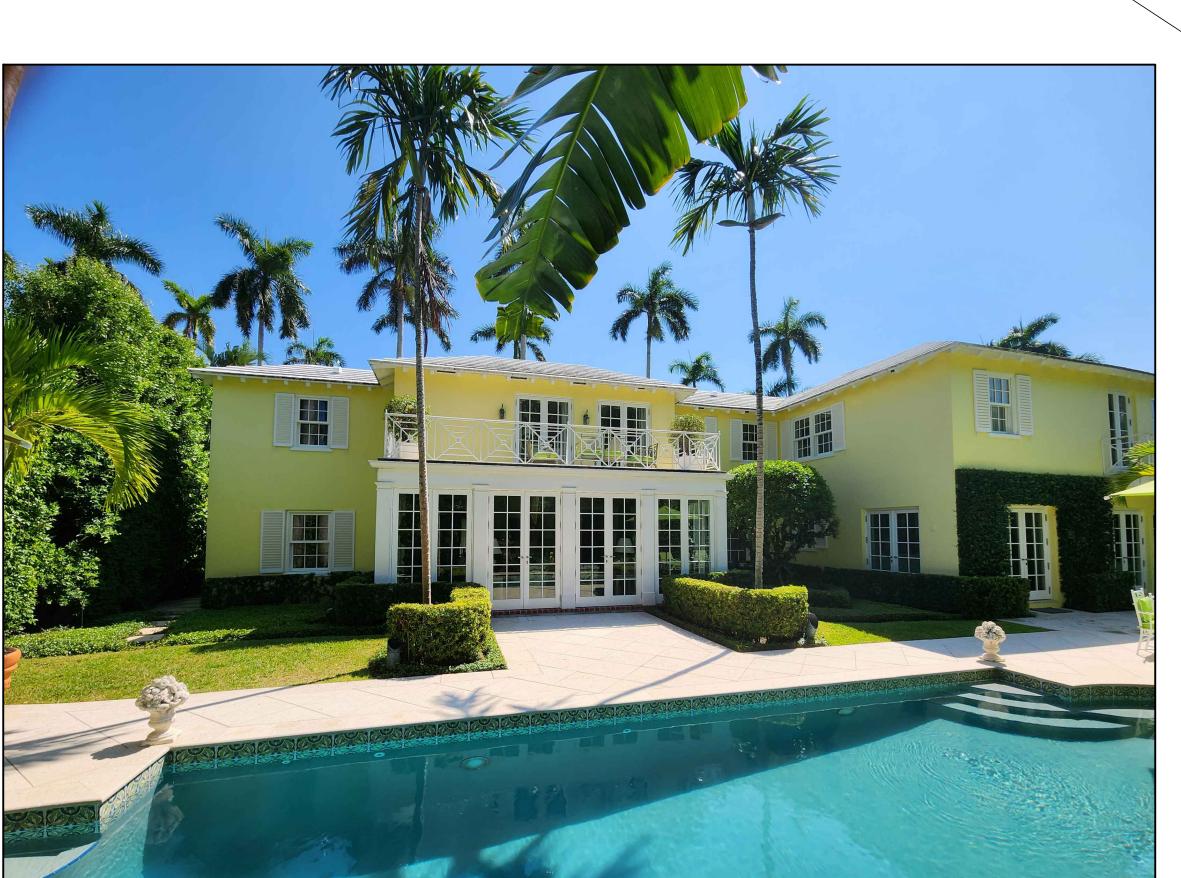


Partial East Elevation

Scale:

5 Partial North Elevation

Scale:

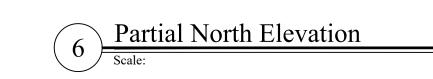

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Jeffery W. Smith AR9772

SHEET NO.

A203

Partial East Elevation

Scale:



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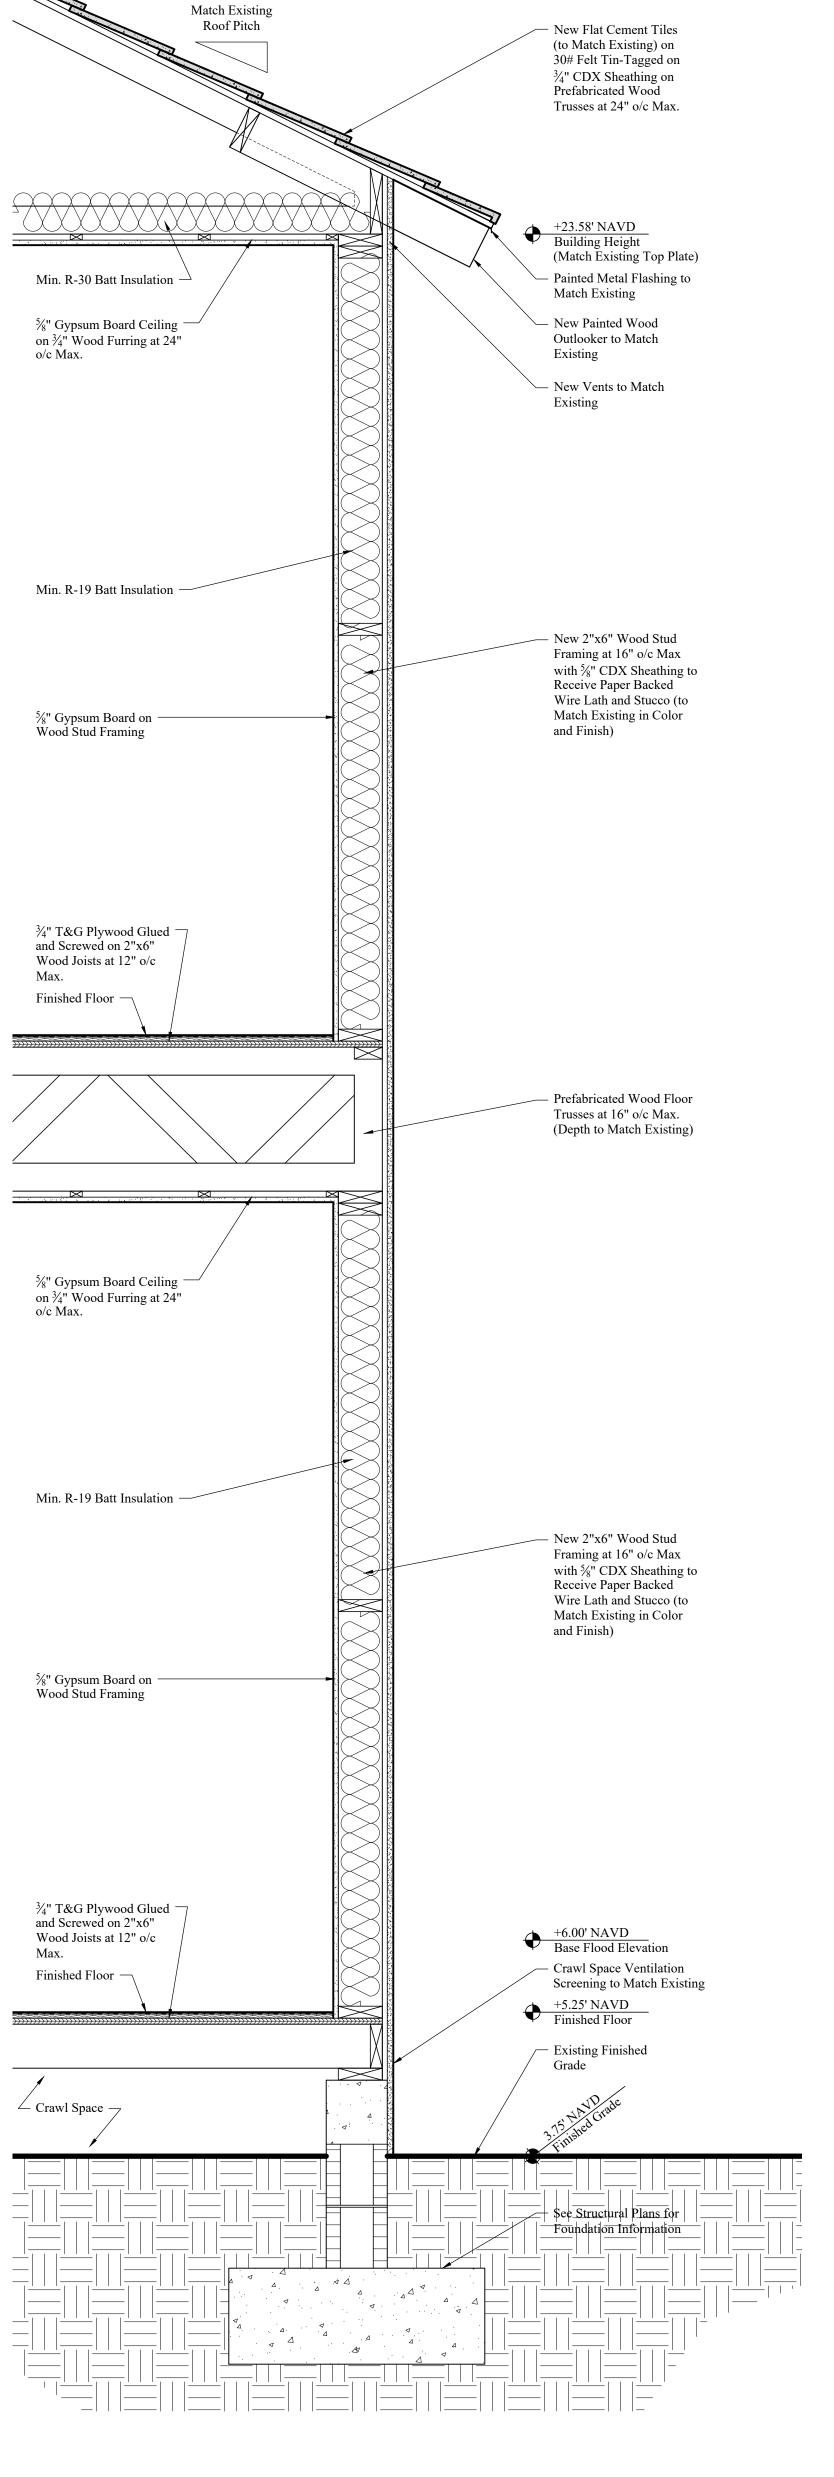
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A204

250

272

240





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January 29, 2024 REVISIONS

MODIFICATION DATE

INC. GROUP,

ARCHITECT SMITH


Jeffery and

AAC001849

Jeffery W. Smith AR9772

SHEET NO.




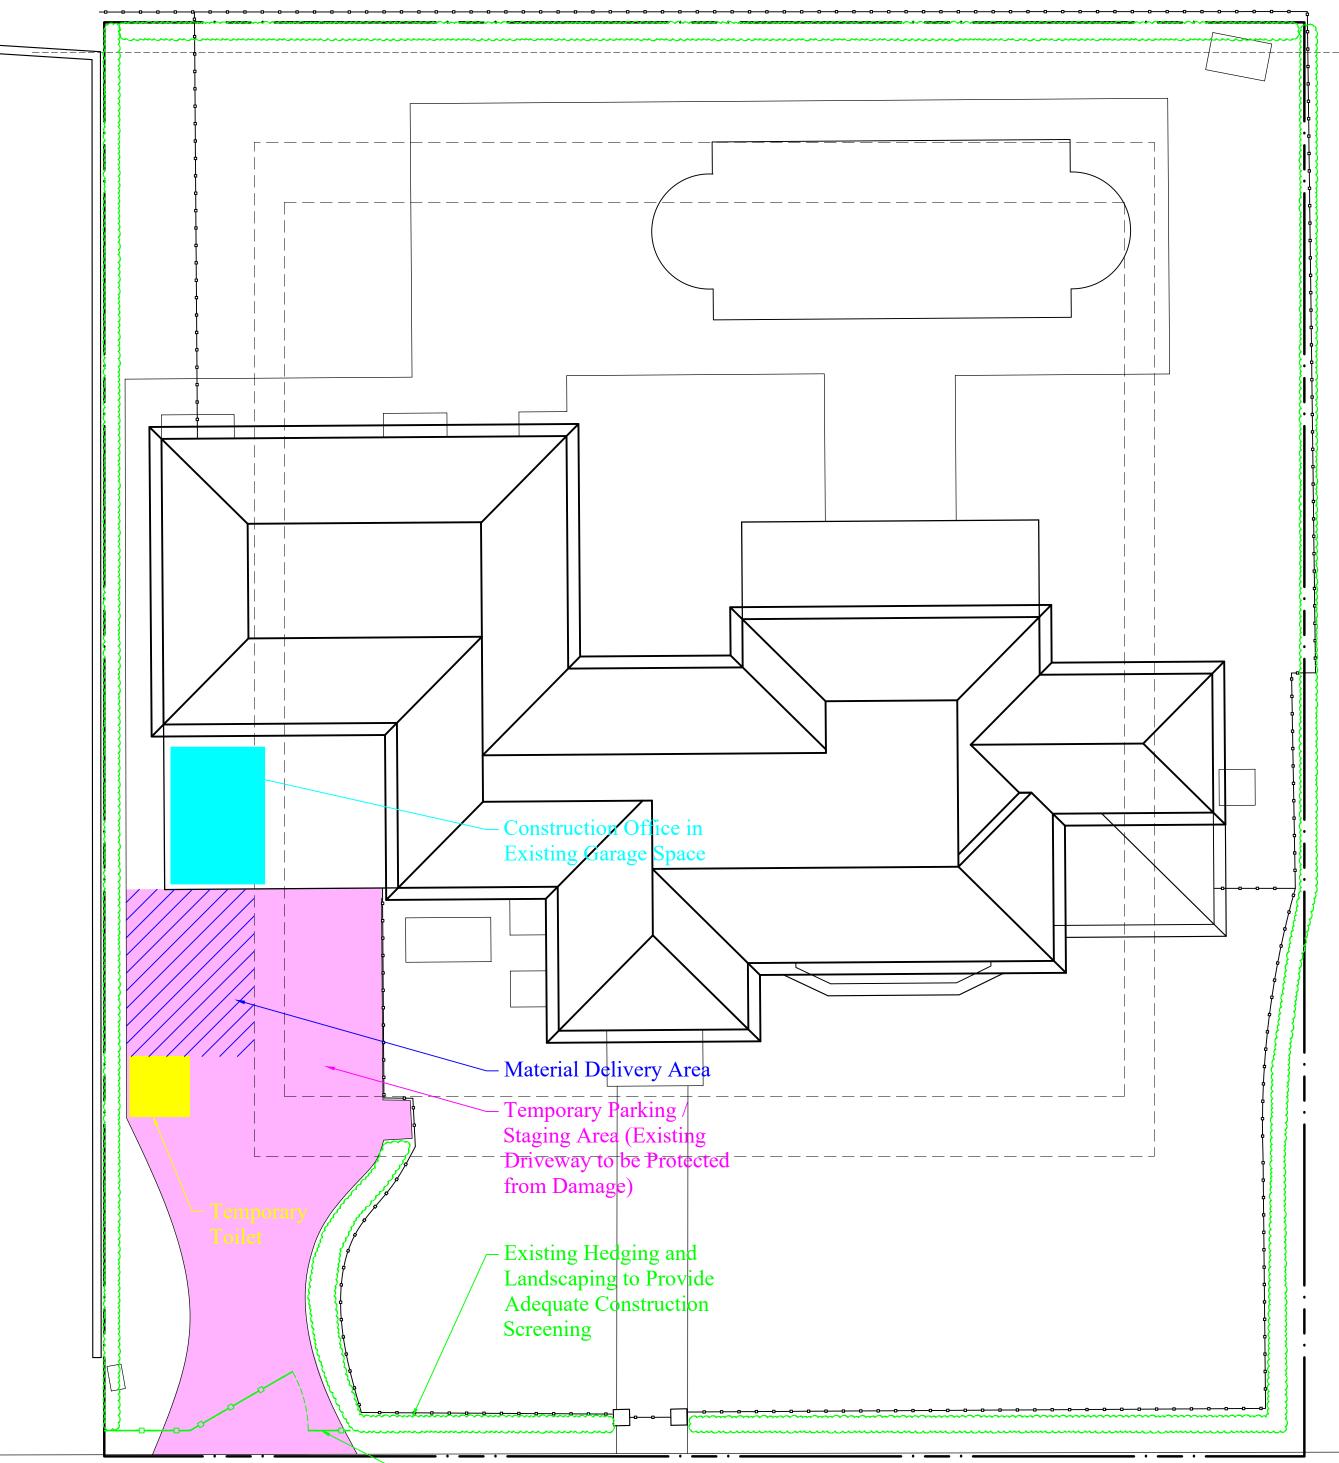

Temporary 6' High Chain Link Construction Gate and _ <u>6' High Fencing with 90%</u> Mesh on Outside

Construction Staging and Screening Plan

Scale:

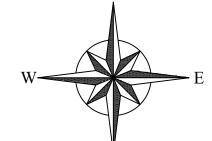

Truck Logistics Plan

Scale:

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January 29, 2024

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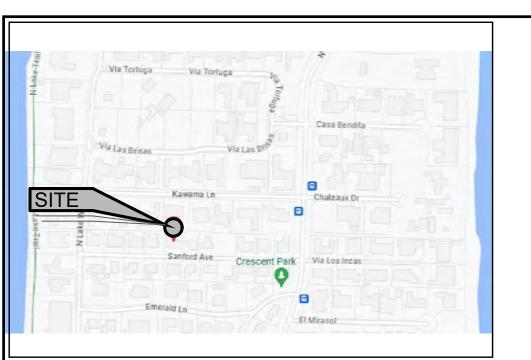
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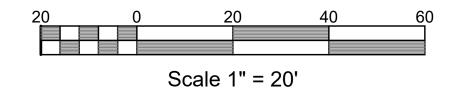
Jeffery W. Smith AR9772


SHEET NO.

CSP



LOCATION MAP N.T.S.



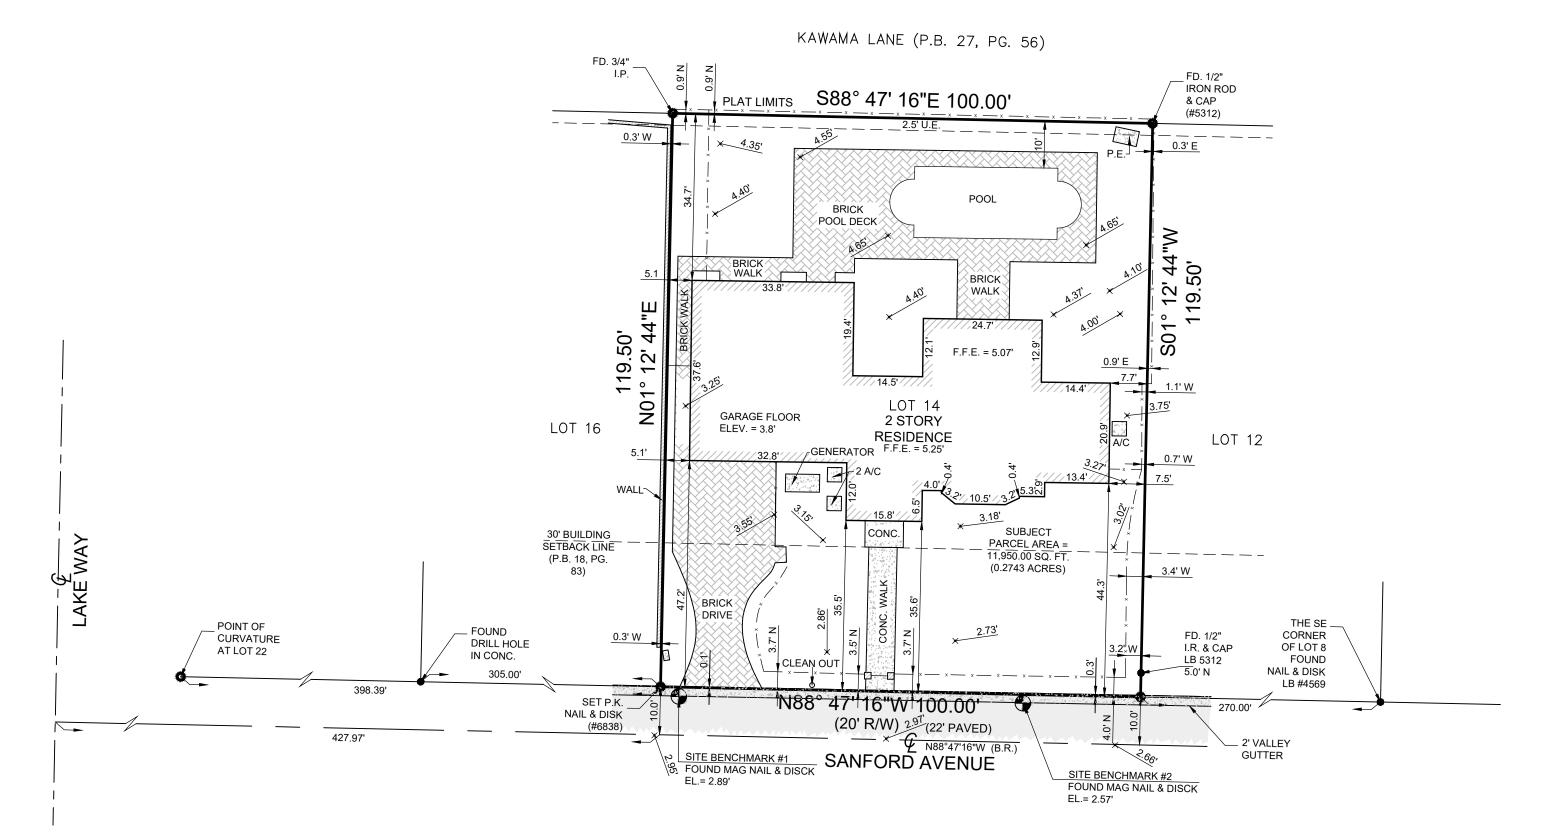

SURVEY NOTES:

- 1.) Lands shown hereon were prepared without the benefit of a title search for easements, rights of way, or other matters of record.
- 2.) Area of subject property = 11,950 square feet (0.2743 acres).
- 3.) Elevations shown hereon are based on North American Vertical Datum of 1988 (NAVD 88).
 - Originating benchmark = Leica Global Positioning System.
- b) 000 = existing elevation (NAVD 88 typical).
- No underground improvements located.
- Bearings shown hereon are State Plane Grid (NAD 83/90 ADJUSTMENT, FLORIDA EAST ZONE). Distances are plat and measured unless otherwise
- 6.) This firm's "Certificate of Authorization" number is "LB 6838".

LEGEND:

CALC. = CALCULATED (P) = PLAT PAVEMENT C.B.S. = CONCRETE BLOCK STRUCTURE R RADIUS P.O.C. = POINT OF INTERSECTION C.B.S. = CONCRETE BLOCK STRUCTURE R RADIUS P.O.C. = POINT OF COMMENCEMENT CONC. MON. = CONCRETE MONUMENT D. = CENTRAL "DELTA" ANGLE P.O.B. = POINT OF EDISINNING CONC. = CONCRETE LOCK STRUCTURE R RADIUS P.O.B. = POINT OF EDISTINATION FOR COMMENCEMENT CONC. = CONCRETE LOCK STRUCTURE RADIUS P.O.B. = POINT OF COMMENCEMENT CONCRETE MONUMENT D. = CENTRAL "DELTA" ANGLE P.O.B. = POINT OF COMMENCEMENT RW = RIGHT OF WAY E. = UTILITY EASEMENT N.G.V.D. = NATIONAL GEODETIC VERTICAL DATUM D. = DECOMENT D. = PAVER BRICK FLATWORK P.E. = POOL EQUIPMENT O.R.B. = OFFICIAL RECORD BOOK F.F.EL = FINISHED FLOOR ELEVATION P.B. = PLAT BOOK EL = LEVATION P.C. = POINT OF CURVATURE P.O. = POINT OF COMMENCEMENT RW = RADIUS ROUNT OF COMMENCEMENT E RESIDENT E ASPHALT PAVEMENT E CONCRETE FLATWORK WOOD FENCE WOOD POWER POLE WATER METER FIRE HYDRANT (B.R.) = BEARING REFERENCE P.T. = POINT OF COMMENCEMENT E CONCRETE FLATWORK E CONCRETE FLATWO								
CONC. MON. = CONCRETE MONUMENT OUR CONC. = CONCRETE MONUMENT D.E. = DRAINAGE EASEMENT U.E. = UTILITY EASEMENT P.E. = POLE QUIPMENT OUR CONCRETE MONUMENT O			(P)				-	= ASPHALT PAVEMENT
D.E. = DRAINAGE EASEMENT CH.B. = CHORD BEARING	CONC. MON.	= CONCRETE MONUMENT	Δ	= CENTRAL "DELTA" ANGLE	P.O.B. =	POINT OF BEGINNING	FRENGSSEF	= CONCRETE FLATWORK
D.E UTILITY EASEMENT N.G.V.D. = NATIONAL GEODETIC VERTICAL DATOM			L CH.B.	=	1 4/ 4 4			
F.F.EL. = FINISHED FLOOR ELEVATION P.B. = PLAT BOOK — = CENTERLINE WATER METER EL. = ELEVATION P.C. = POINT OF CURVATURE — = EASEMENT								
(B.R.) = BEARING REFERENCE P.T. = POINT OF TANGENCY = COVERED (D) = DEED P.R.C. = POINT OF REVERSE CURVATURE = OVERHEAD LINES = CATCH BASIN	F.F.EL.	= FINISHED FLOOR ELEVATION	P.B.	= PLAT BOOK		CENTERLINE	₩M	
(D) = DEED P.R.C. = POINT OF REVERSE CORVATORE ————————————————————————————————————							X	
	1	= DEED = MEASURED	P.R.C. P.C.C.	= POINT OF REVERSE CURVATURE = POINT OF COMPOUND CURVATURE			(SAN)	= CATCH BASIN = SANITARY MANHOLE

SCALE:	1" = 20'
DRAWN BY:	N.M.
FIELD WK:	J.W. / B.M.
DATE:	10/25/2023

MILLER LAND SURVEYING

1121 LAKE AVENUE
LAKE WORTH BEACH, FLORIDA 33460 PHONE: (561) 586-2669 - FAX: (561) 582-0151 www.millersurveying.com e-mail: orders@millersurveying.com

REF: W-48/		
PREV. 92 JOB NO'S.	2-1108 3-019-81	
JOB NO. Y231066		
M - 1382		

PROPERTY ADDRESS: 241 SANFORD AVE, PALM BEACH, FL 33480 FLOOD ZONE: AE (FIRM 120220-12099C0581 F 10/05/2017) BASE FLOOD ELEVATION = 6' (NAVD

CERTIFIED TO: JEFFERY SMITH

REVISIONS:

DESCRIPTION: Lot 14, Revised Plat of Walton Addition to the Town of Palm Beach, Florida, according to the plat thereof on file in the office of the Clerk of the Circuit Court in and for Palm Beach County, Florida, as in Plat Book 18, page

BOUNDARY SURVEY

This survey is not valid without embossed surveyor's seal and/or an authenticated electronic signature and authenticated electronic seal.

Registered Land Surveyor, Florida Certificate No. MICHAEL J. MILLER #4034

Y231066

CRD. FILE