

Cocoanut Row Elevation (existing)




Cocoanut Row and Peruvian Avenue Elevation (existing)



Cocoanut Row Elevation (existing)



Cocoanut Row Elevation (showing existing door / window surround detail)

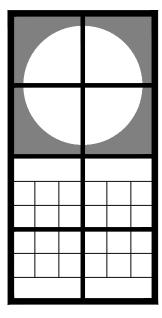

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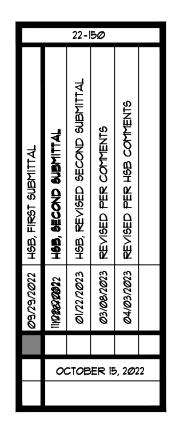
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Peruvian Avenue Elevation (existing)




East Entrance to Courtyard (existing)



Peruvian Avenue Elevation (existing)



Courtyard View, (looking west) (existing)

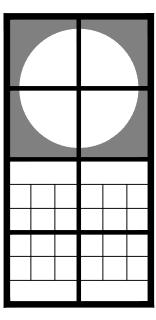

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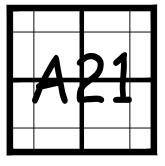
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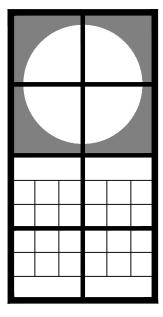




Courtyard View (existing, two story building)



Courtyard, (looking south) (existing)



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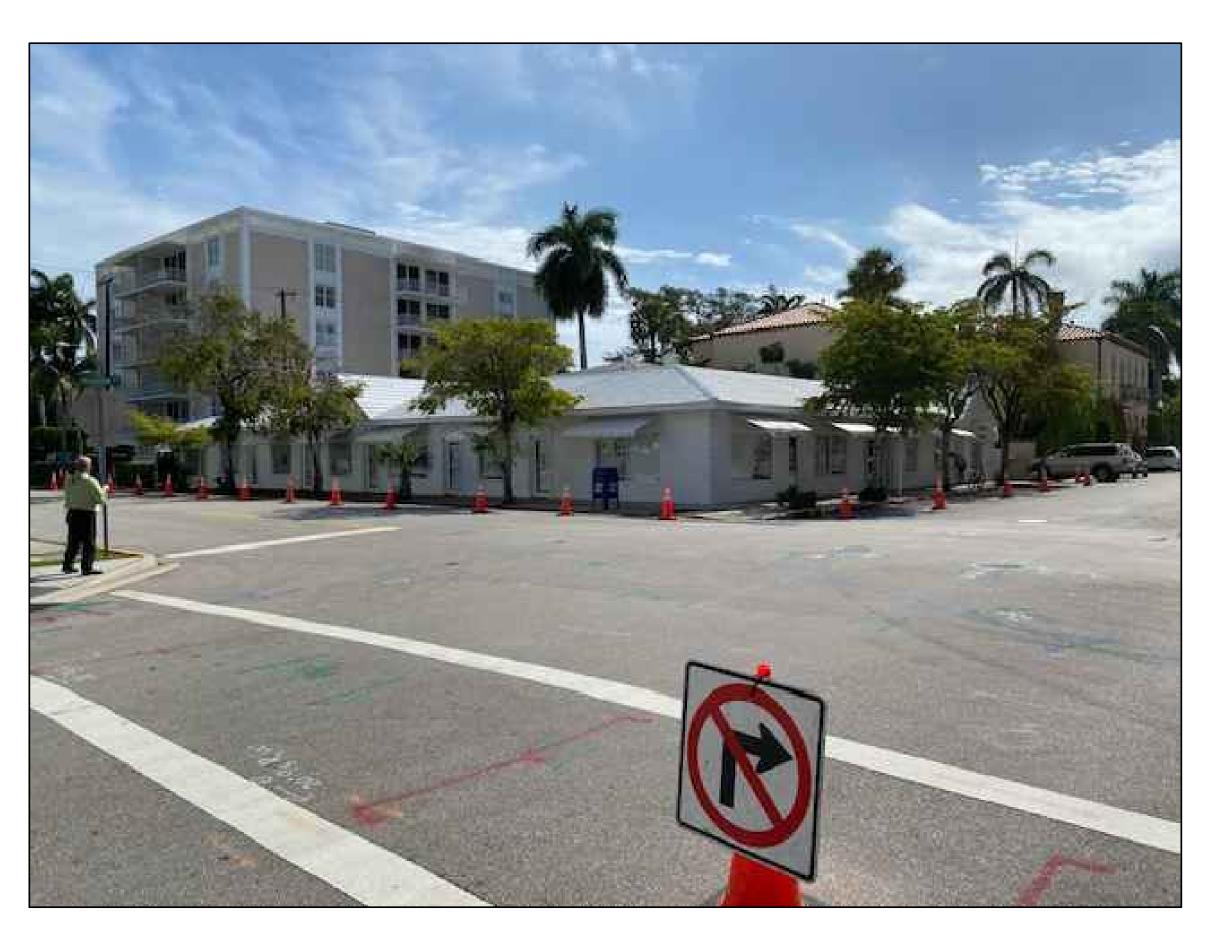
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Peruvian Avenue and Cocoanut Row (existing)



Cocoanut Row and Peruvian Avenue (existing)



Peruvian Avenue (existing)



<u>Cocoanut Row)</u> (existing)

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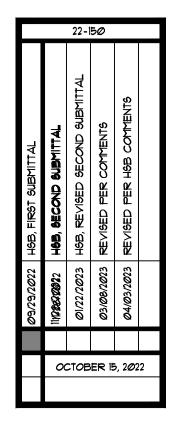
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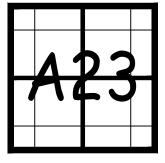
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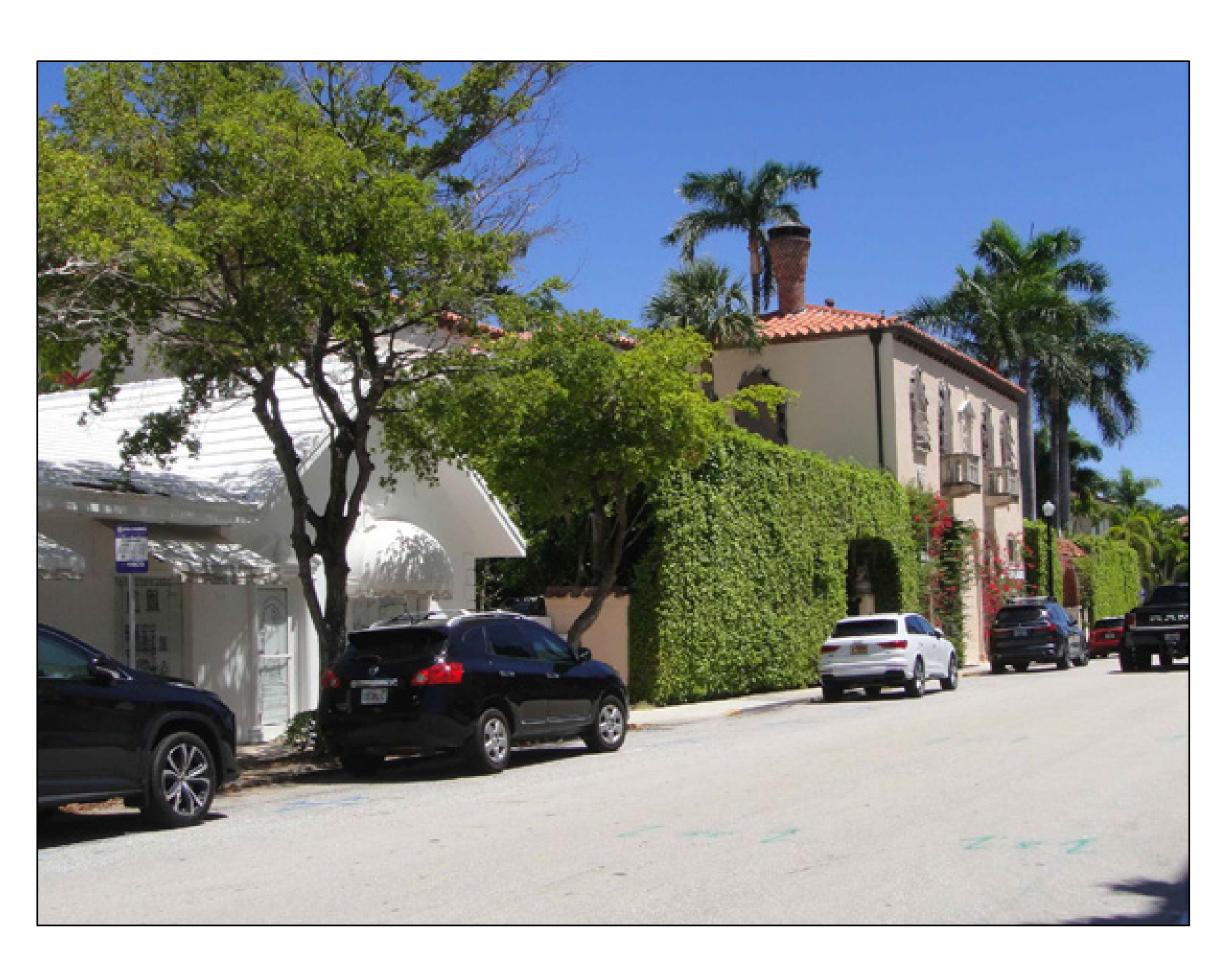


<u>353 Peruvian Avenue, (looking east)</u> (existing)




341 Peruvian Avenue (existing)

<u>Photograph Exhibit, (adjacent property)</u>



<u>353 Peruvian Avenue, (looking east)</u> (existing)

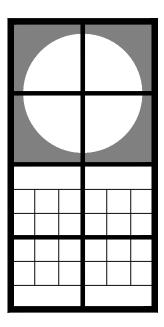

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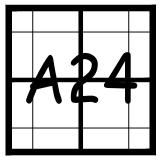
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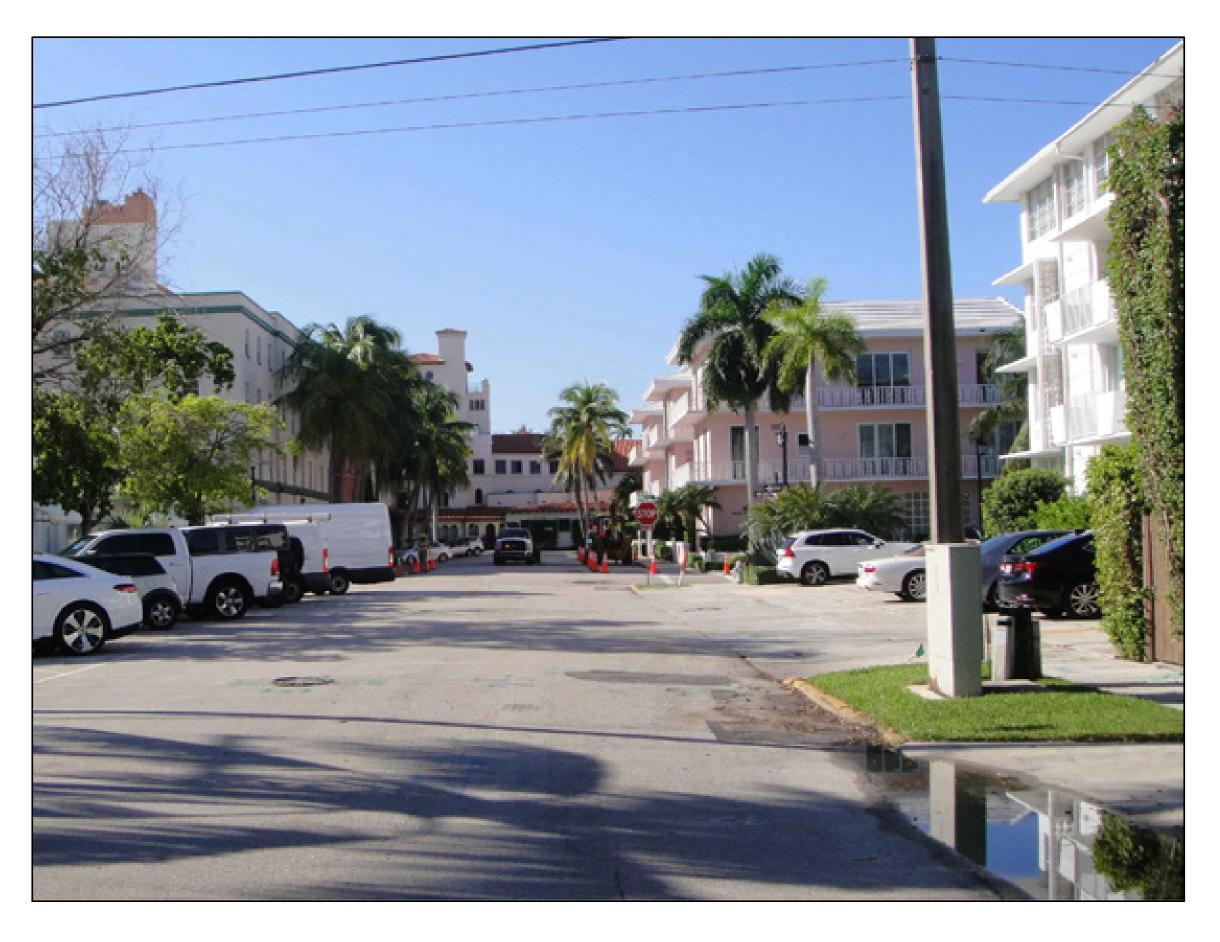


Cocoanut Row (looking north) (existing)



Peruvian Avenue, (looking east) (existing)


<u>Photograph Exhibit, (adjacent property)</u>



Cocoanut Row, (looking south) (existing)



Peruvian Avenue, (looking west) (existing)

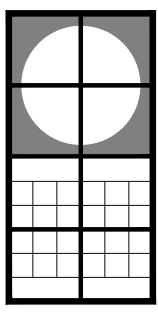

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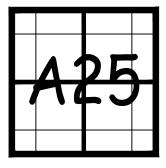
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Cocoanut Row (354 Chilean Avenue) (existing)




Peruvian Avenue and Cocoanut, (Joutheast corner) (existing)

<u>Photograph Exhibit, (adjacent property)</u>



Cocoanut Row (west of the subject property) (existing)

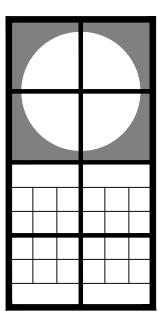

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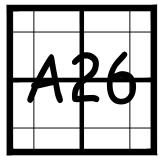
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09/29/2022	11/17262/200222	@1/22/2@23	@3/@8/1@13	@4/@3/2@23	
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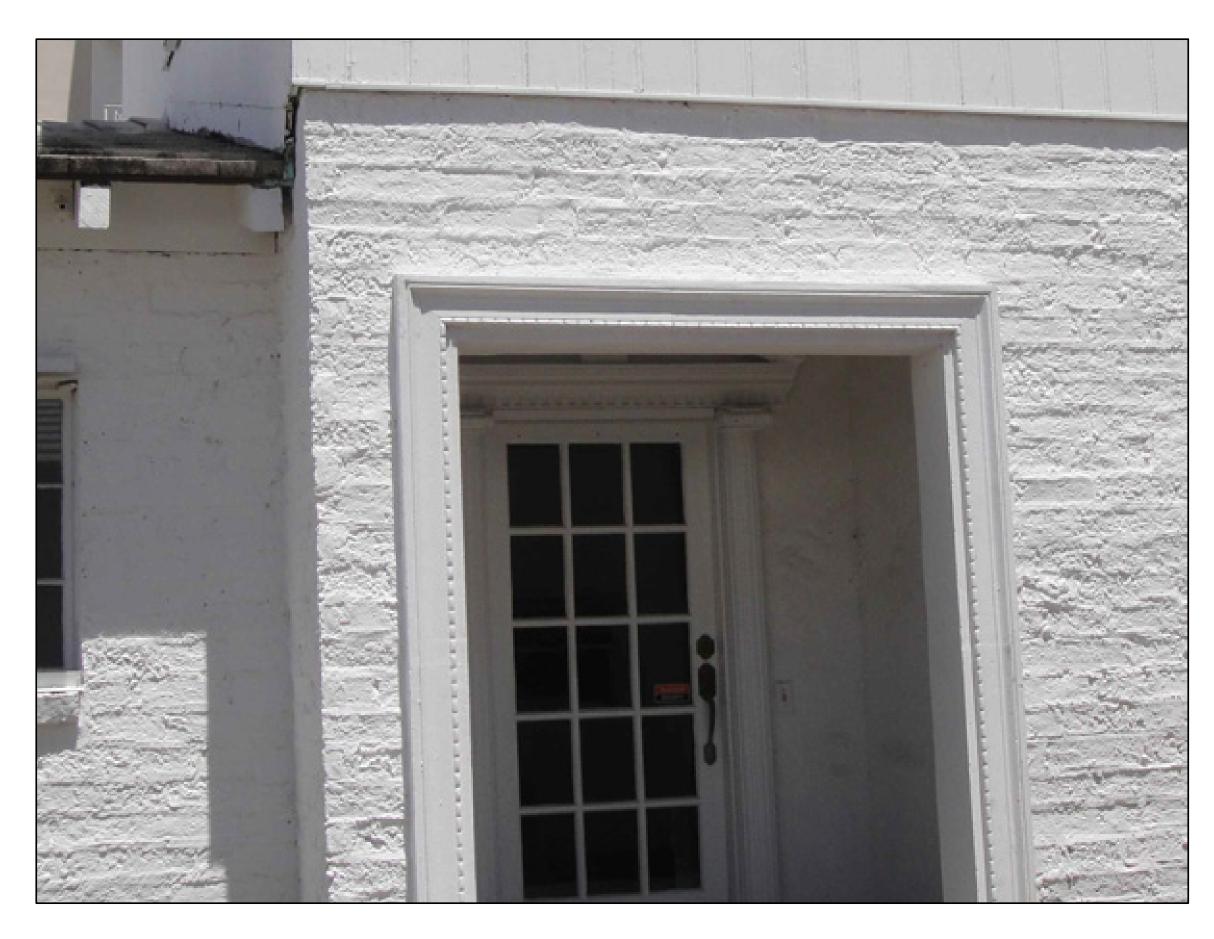


Existing Brick Detail



Existing / Proposed / tepped Plaster Moulding Detail (typical for all existing / new doors)


<u>Two ſtory Building (Architectural Details)</u>



Existing Entrance



Existing / Proposed Shutter Detail

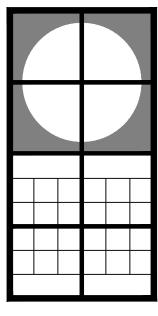

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353 Peruvian Avenue (Proposed Peruvian Avenue Front Elevation)



353 Peruvian Avenue (Proposed Cocoanut Row Front Elevation)



353 Peruvian Avenue, Two Story Building (Proposed Front Elevation)



353 Peruvian Avenue, Two Story Building, (Proposed Front Elevation)



353 Peruvian Avenue, Two Story Building

ng (Proposed Rear Elevation)


Super White (OC-152) **Benjamin Moore**

Exterior Paint Finish (Benjamin Moore)


White 4634-0000 Sunbrella

<u>Awning Fabric</u> (/unbrella)

<u>One and Two Story Buildings, (Materials and Details)</u>

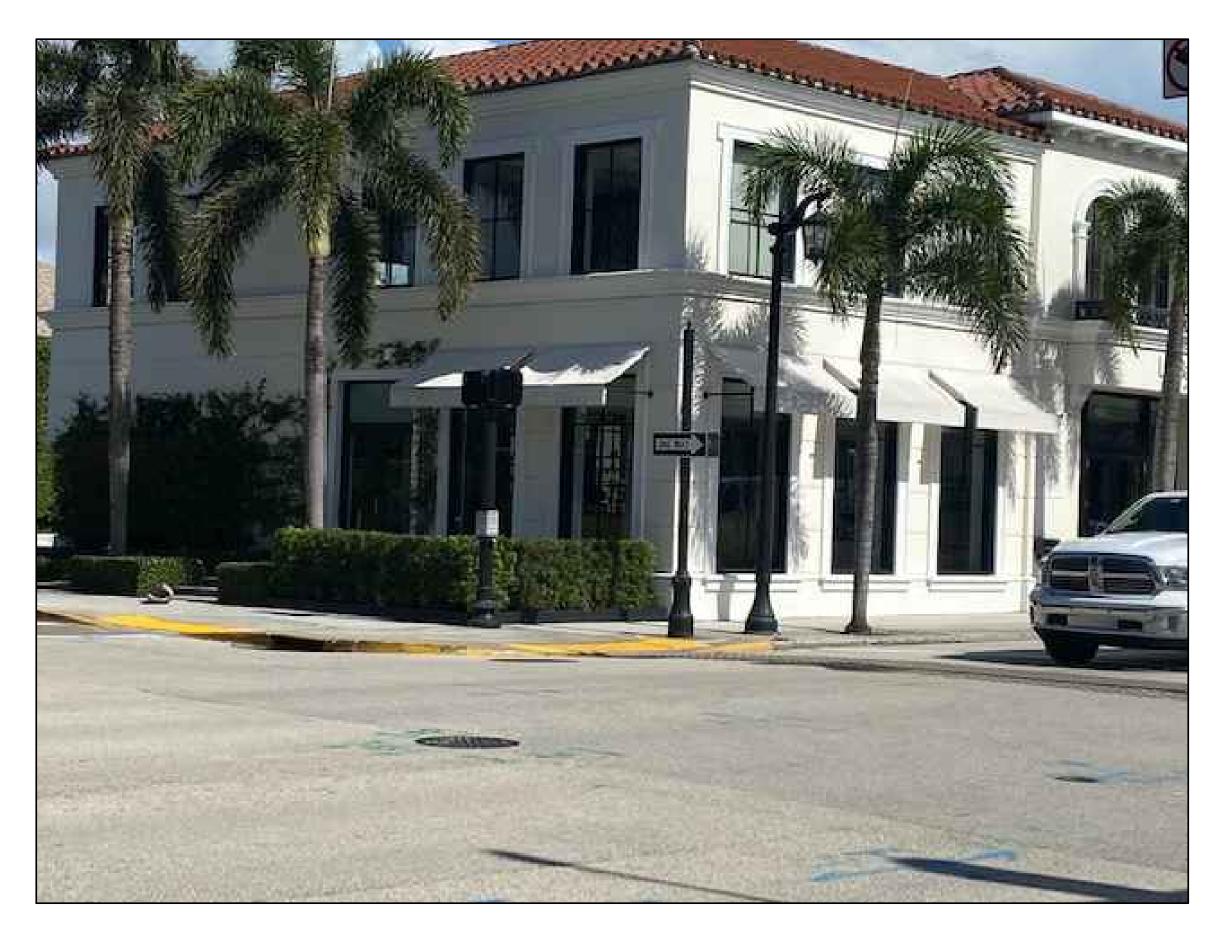

Proposed Awning Structure Detail white fabric on black frame, (Photo taken from 380 Jouth County Road)

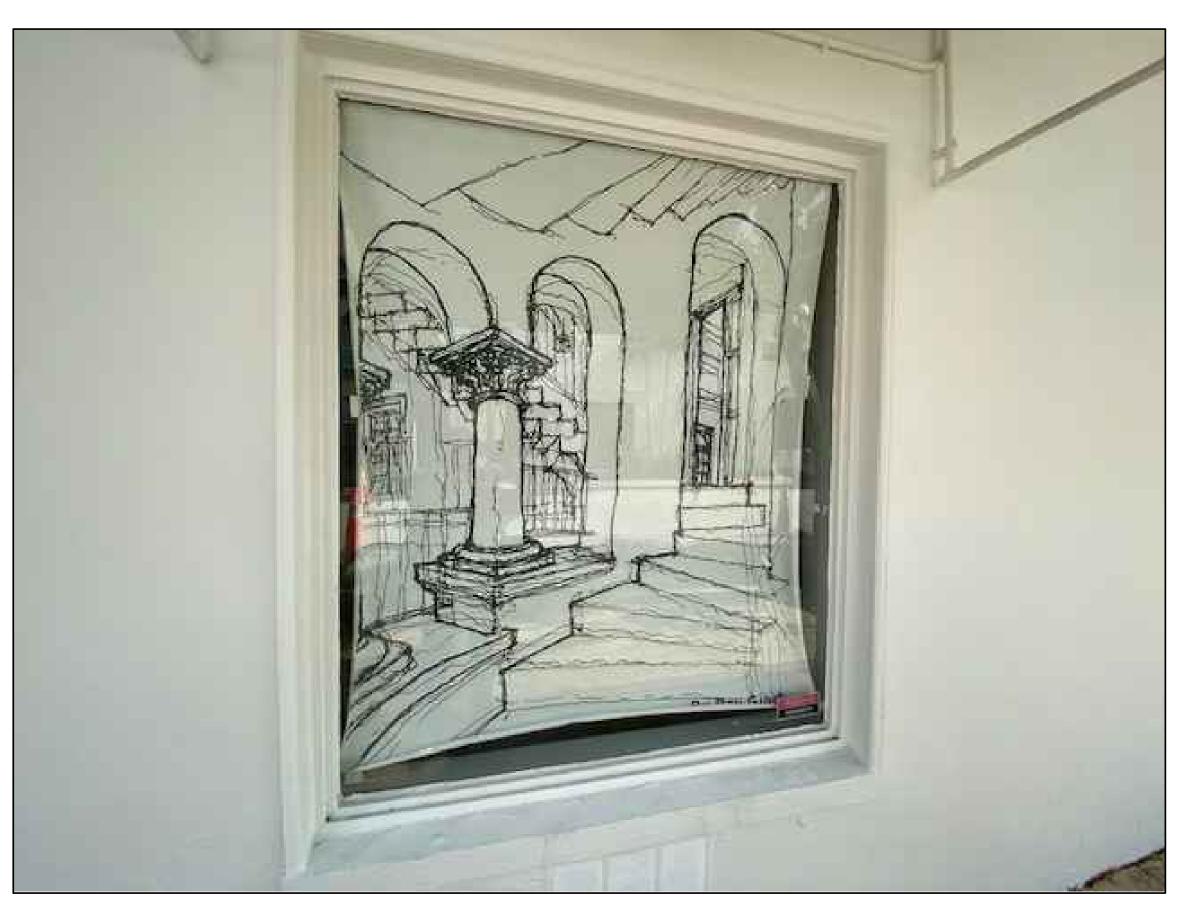

Existing / Proposed / torefront Window Moulding Detail (Typical for All Existing / New Storefront Windows)

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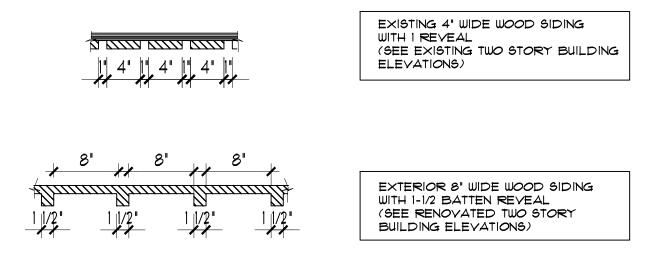
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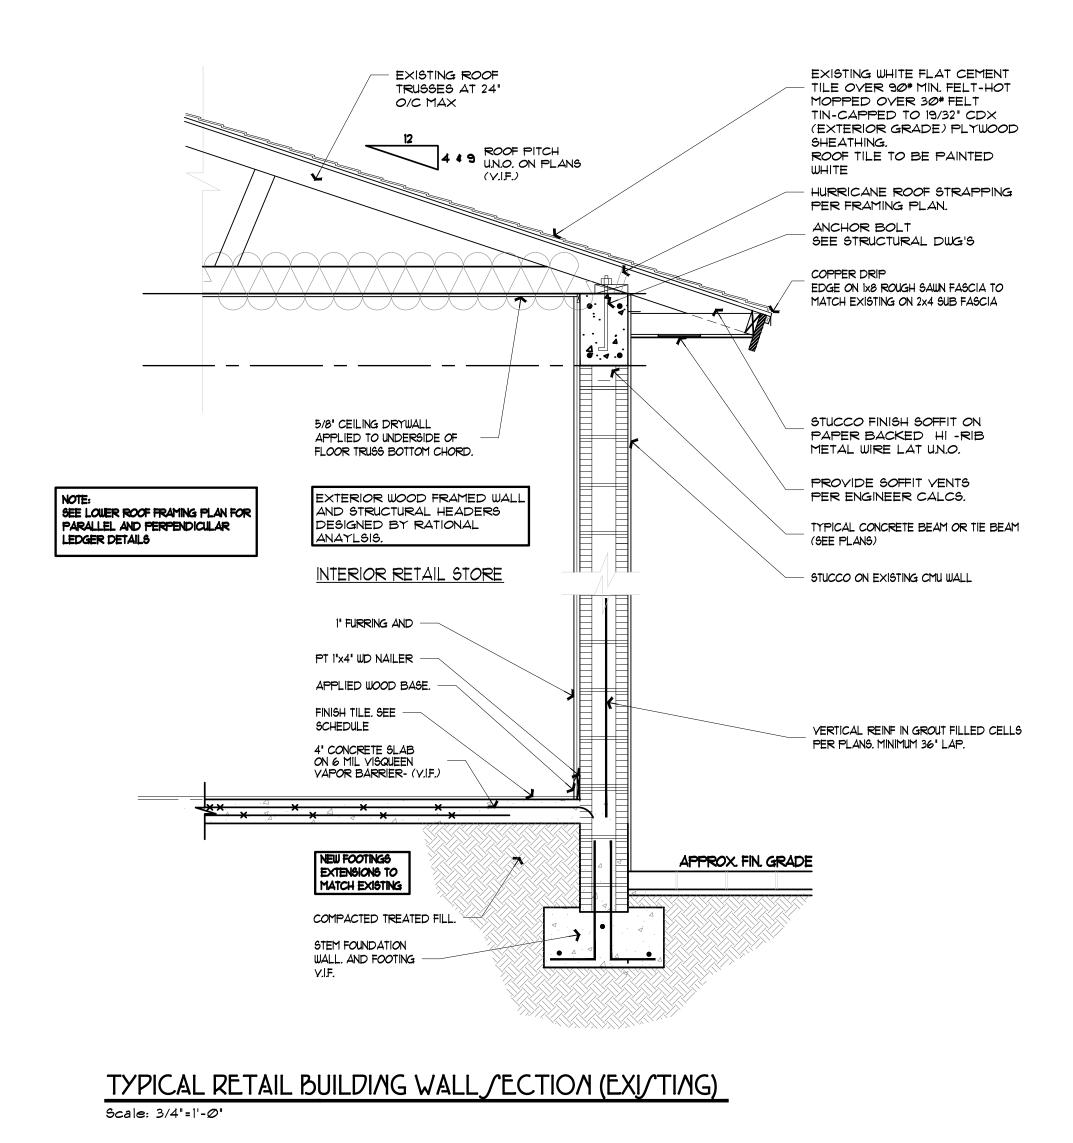
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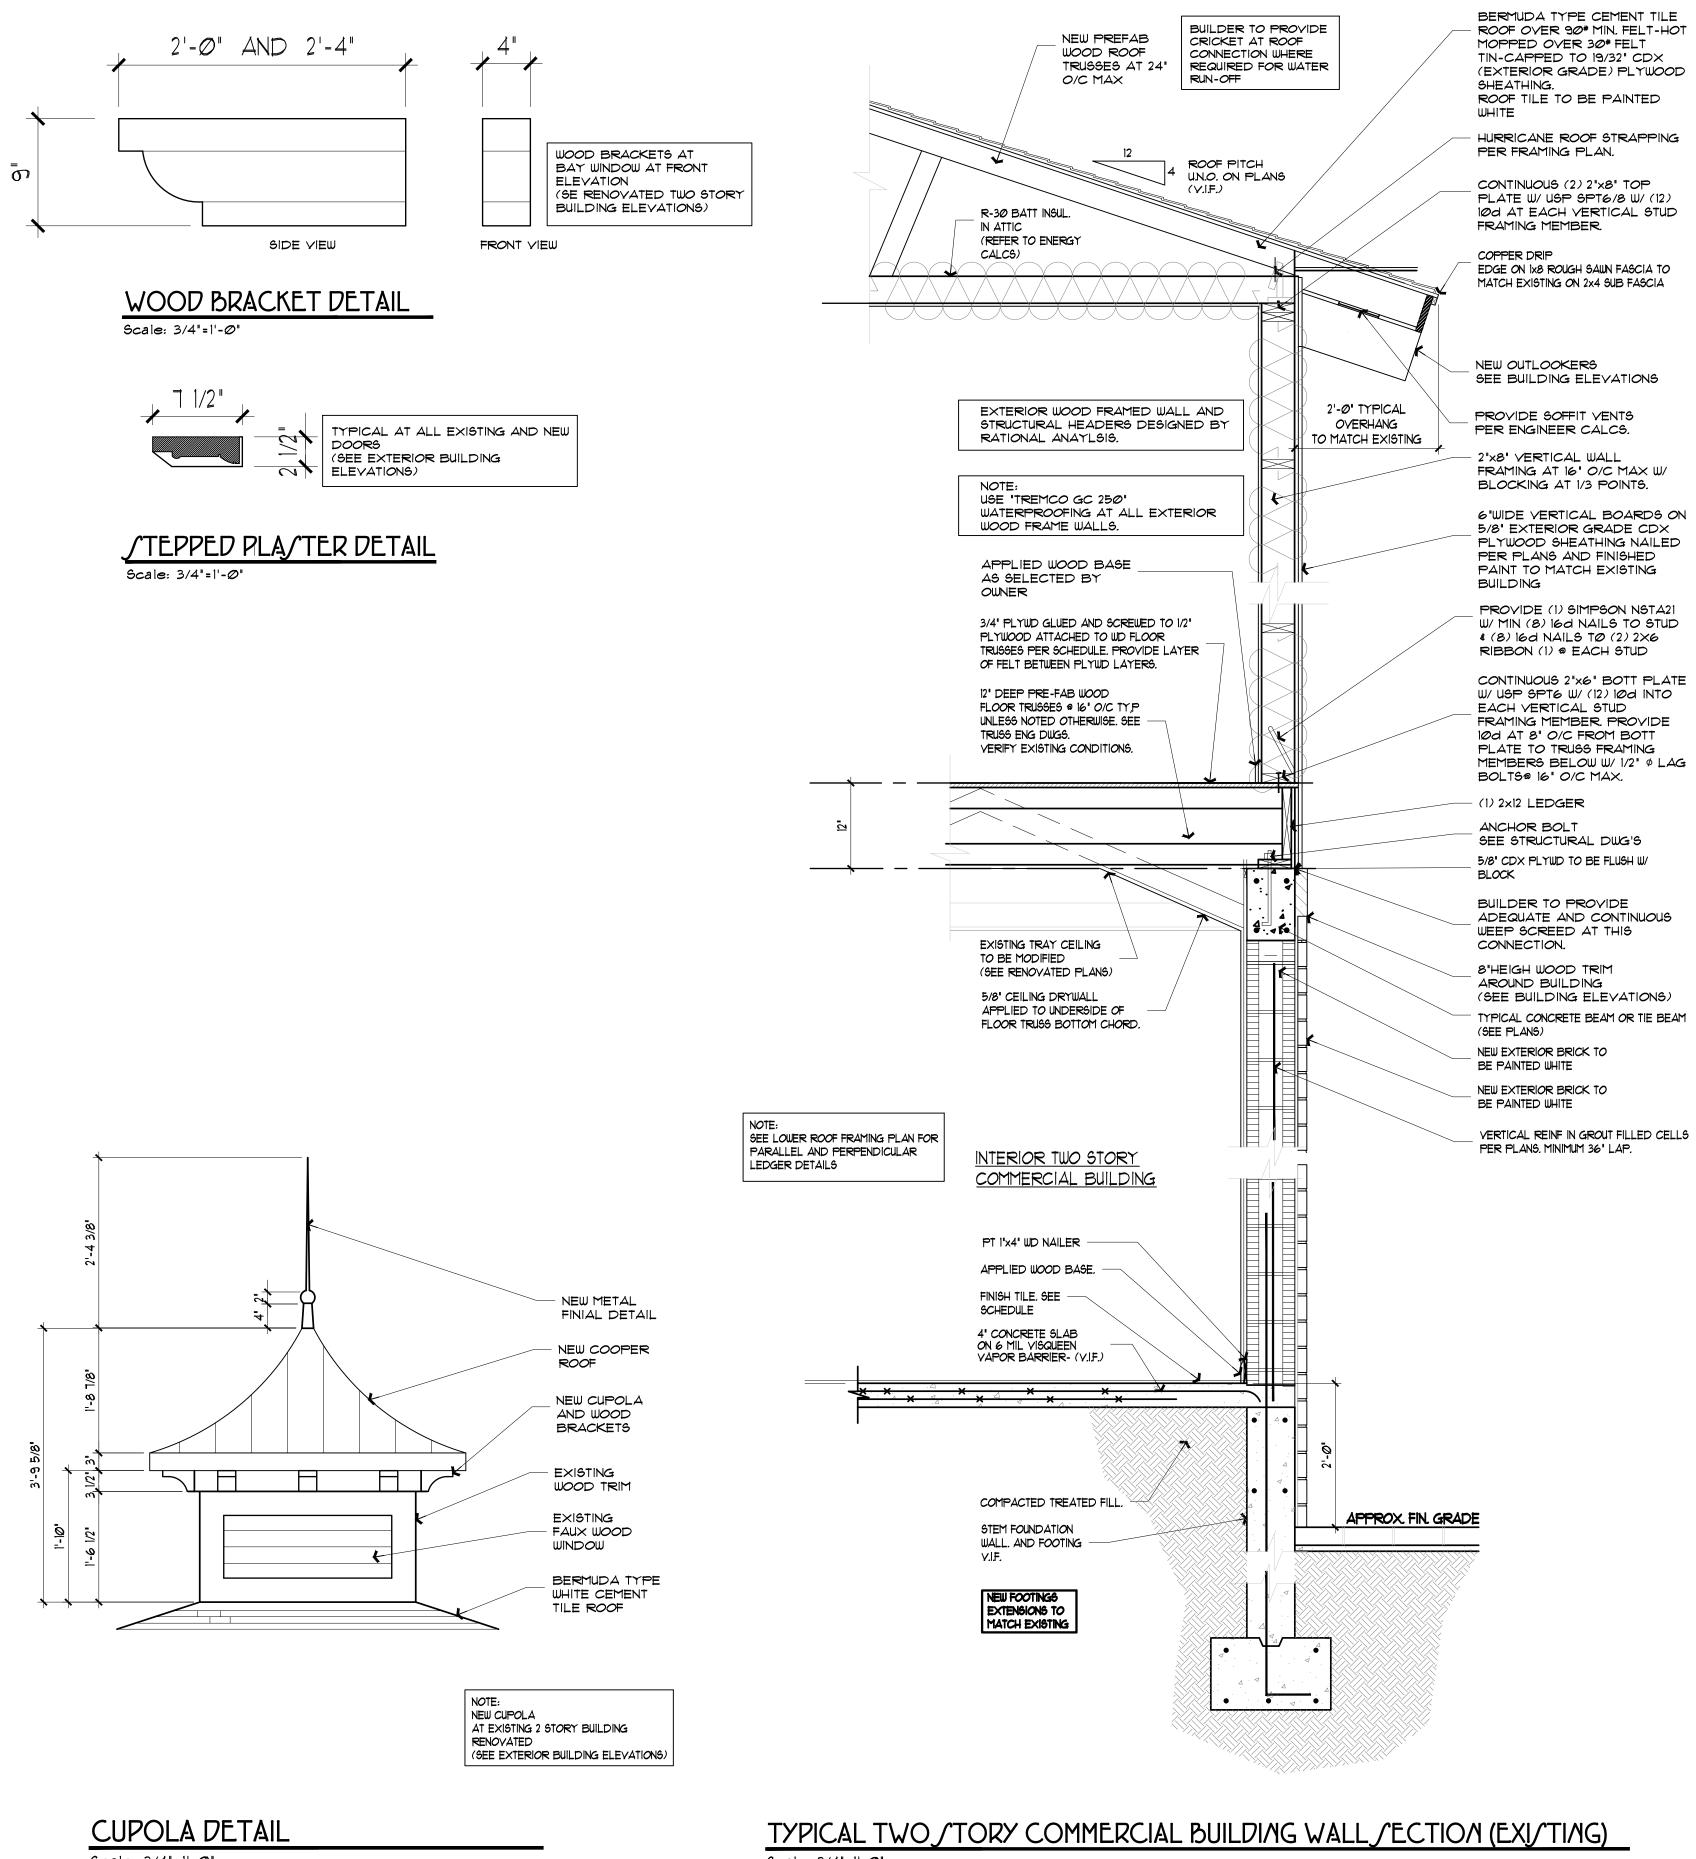
22-150 OCTOBER 15, 2022





PROPOSED WOOD SIDING DETAIL Scale: 3/4"=1'-Ø"






Scale: 3/4"=1'-Ø"

Scale: 3/4"=1'-Ø"

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	09/29/2022	11/28/2 <i>0</i> 22	Ø\/22/2@23	61001/80/20	@4/@3/2@23	
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Scope of Work

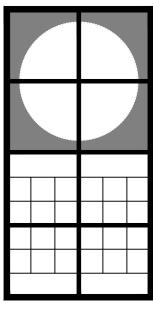Proposed Hardscape & Landscape Improvements New paving, addition of water features and new associated landscape.



353 Peruvian Avenue Palm Beach

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H/B-22-016 (ZON-22-154) Final *J*ubmittal Date of Presentation: 04.19.2023

Sheet Index

Cover Sheet Zoning Legend L1.0 – Existing Vegetation Inventory Plan L1.1 - Existing General Site Photos L1.2 - Existing General Site Photos L2.0 - Demolition & Vegetation Action Plan L3.0 - Construction / creening & / taging Plan L4.0 - Truck Logistics Plan L5.0 – Site Plan L5.0a - Site Details L5.1 – *fite Calculation / Lot Coverage Graphics* L6.0 – Landscape Plan L6.1 – Plant Schedule L6.2 – Rendered Landscape Plan L6.3 – Planting Details L7.0 – Landscape Lighting Plan Jurvey Civil Plan

Design Team/Consultants

Landscape Architects

ENVIRONMENT DESIGN GROUP 139 NORTH COUNTY ROAD SUITE 208 PALM BEACH, FL 33480 561.832.4600 WWW.ENVIRONMENTDESIGNGROUP.COM


Architect

JEROME BAUMOEHL ARCHITECT THE WORTH BUILDING 205 WORTH AVENUE, SUITE 317 PALM BEACH, FL 33480 561.689.2000 WWW.JEROMEBAUMOEHLARCHITECT.COM

Civil Engineer

GRUBER CONSULTING ENGINEERS 2475 MERCER AVENUE WEST PALM BEACH, FL 33401 561.312.2041

Vicinity/Location Map

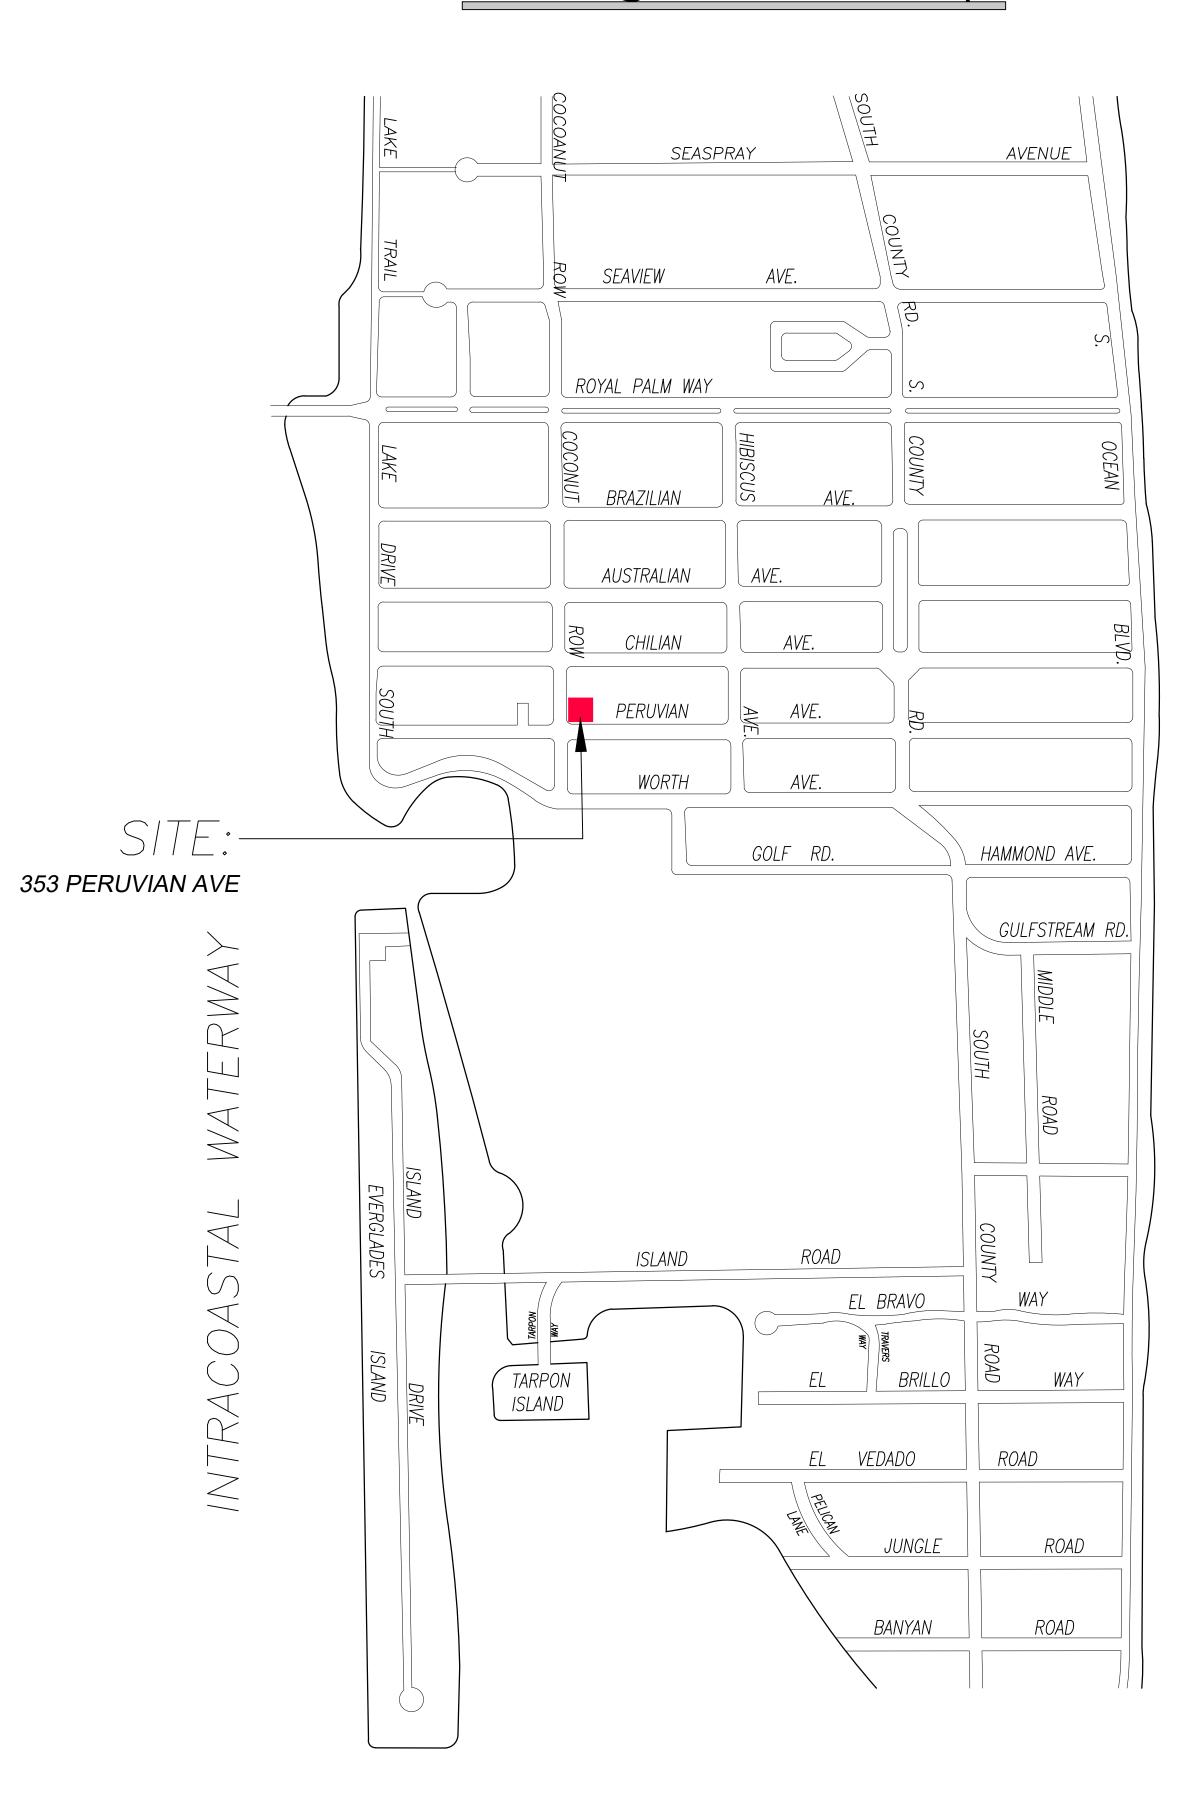





353 Peruvian Avenue Town of Palm Beach

Property Address:	353 Peruvian Ave	enue			
Zoning District:	CT/ - Commercial Town Serving				
∫tructure Type:	Multi-use				
	Required/Allowed	Existing	Existing		
Lot∫ize:	A/K	12,504 <i>/</i> F	12,504 <i>/</i> F		
Lot Depth:		125'	125'		
Lot Width:		100'	100'		
Lot Coverage:					
Front Yard Setback:					
∫ide Yard∫etback (1st∫tory):					
∫ide Yard∫etback (2nd∫tory):					
Rear Yard Setback:					
Angle of Vision:					
Building Height:					
Overall Building Height:					
Finish Floor Elevation (FFE) (NAVD):					
Zero Datum for Pt of Measurement:					
Base Flood Elevation (BFE) (MAVD)		MAVD	NAVD		
Landscape Open∫pace (LQ∕):	1,875.5 / F (15%)	840/F (6.7%)	2,088/F (16.7%)		
Perimeter LQ/:					
Front Yard LQ/:					
Native Plant Species Percentage:	e: Refer to Sheet L6.1 for Native Plant Species				

OCEAN ANTIC ATL,

Zoning Legend

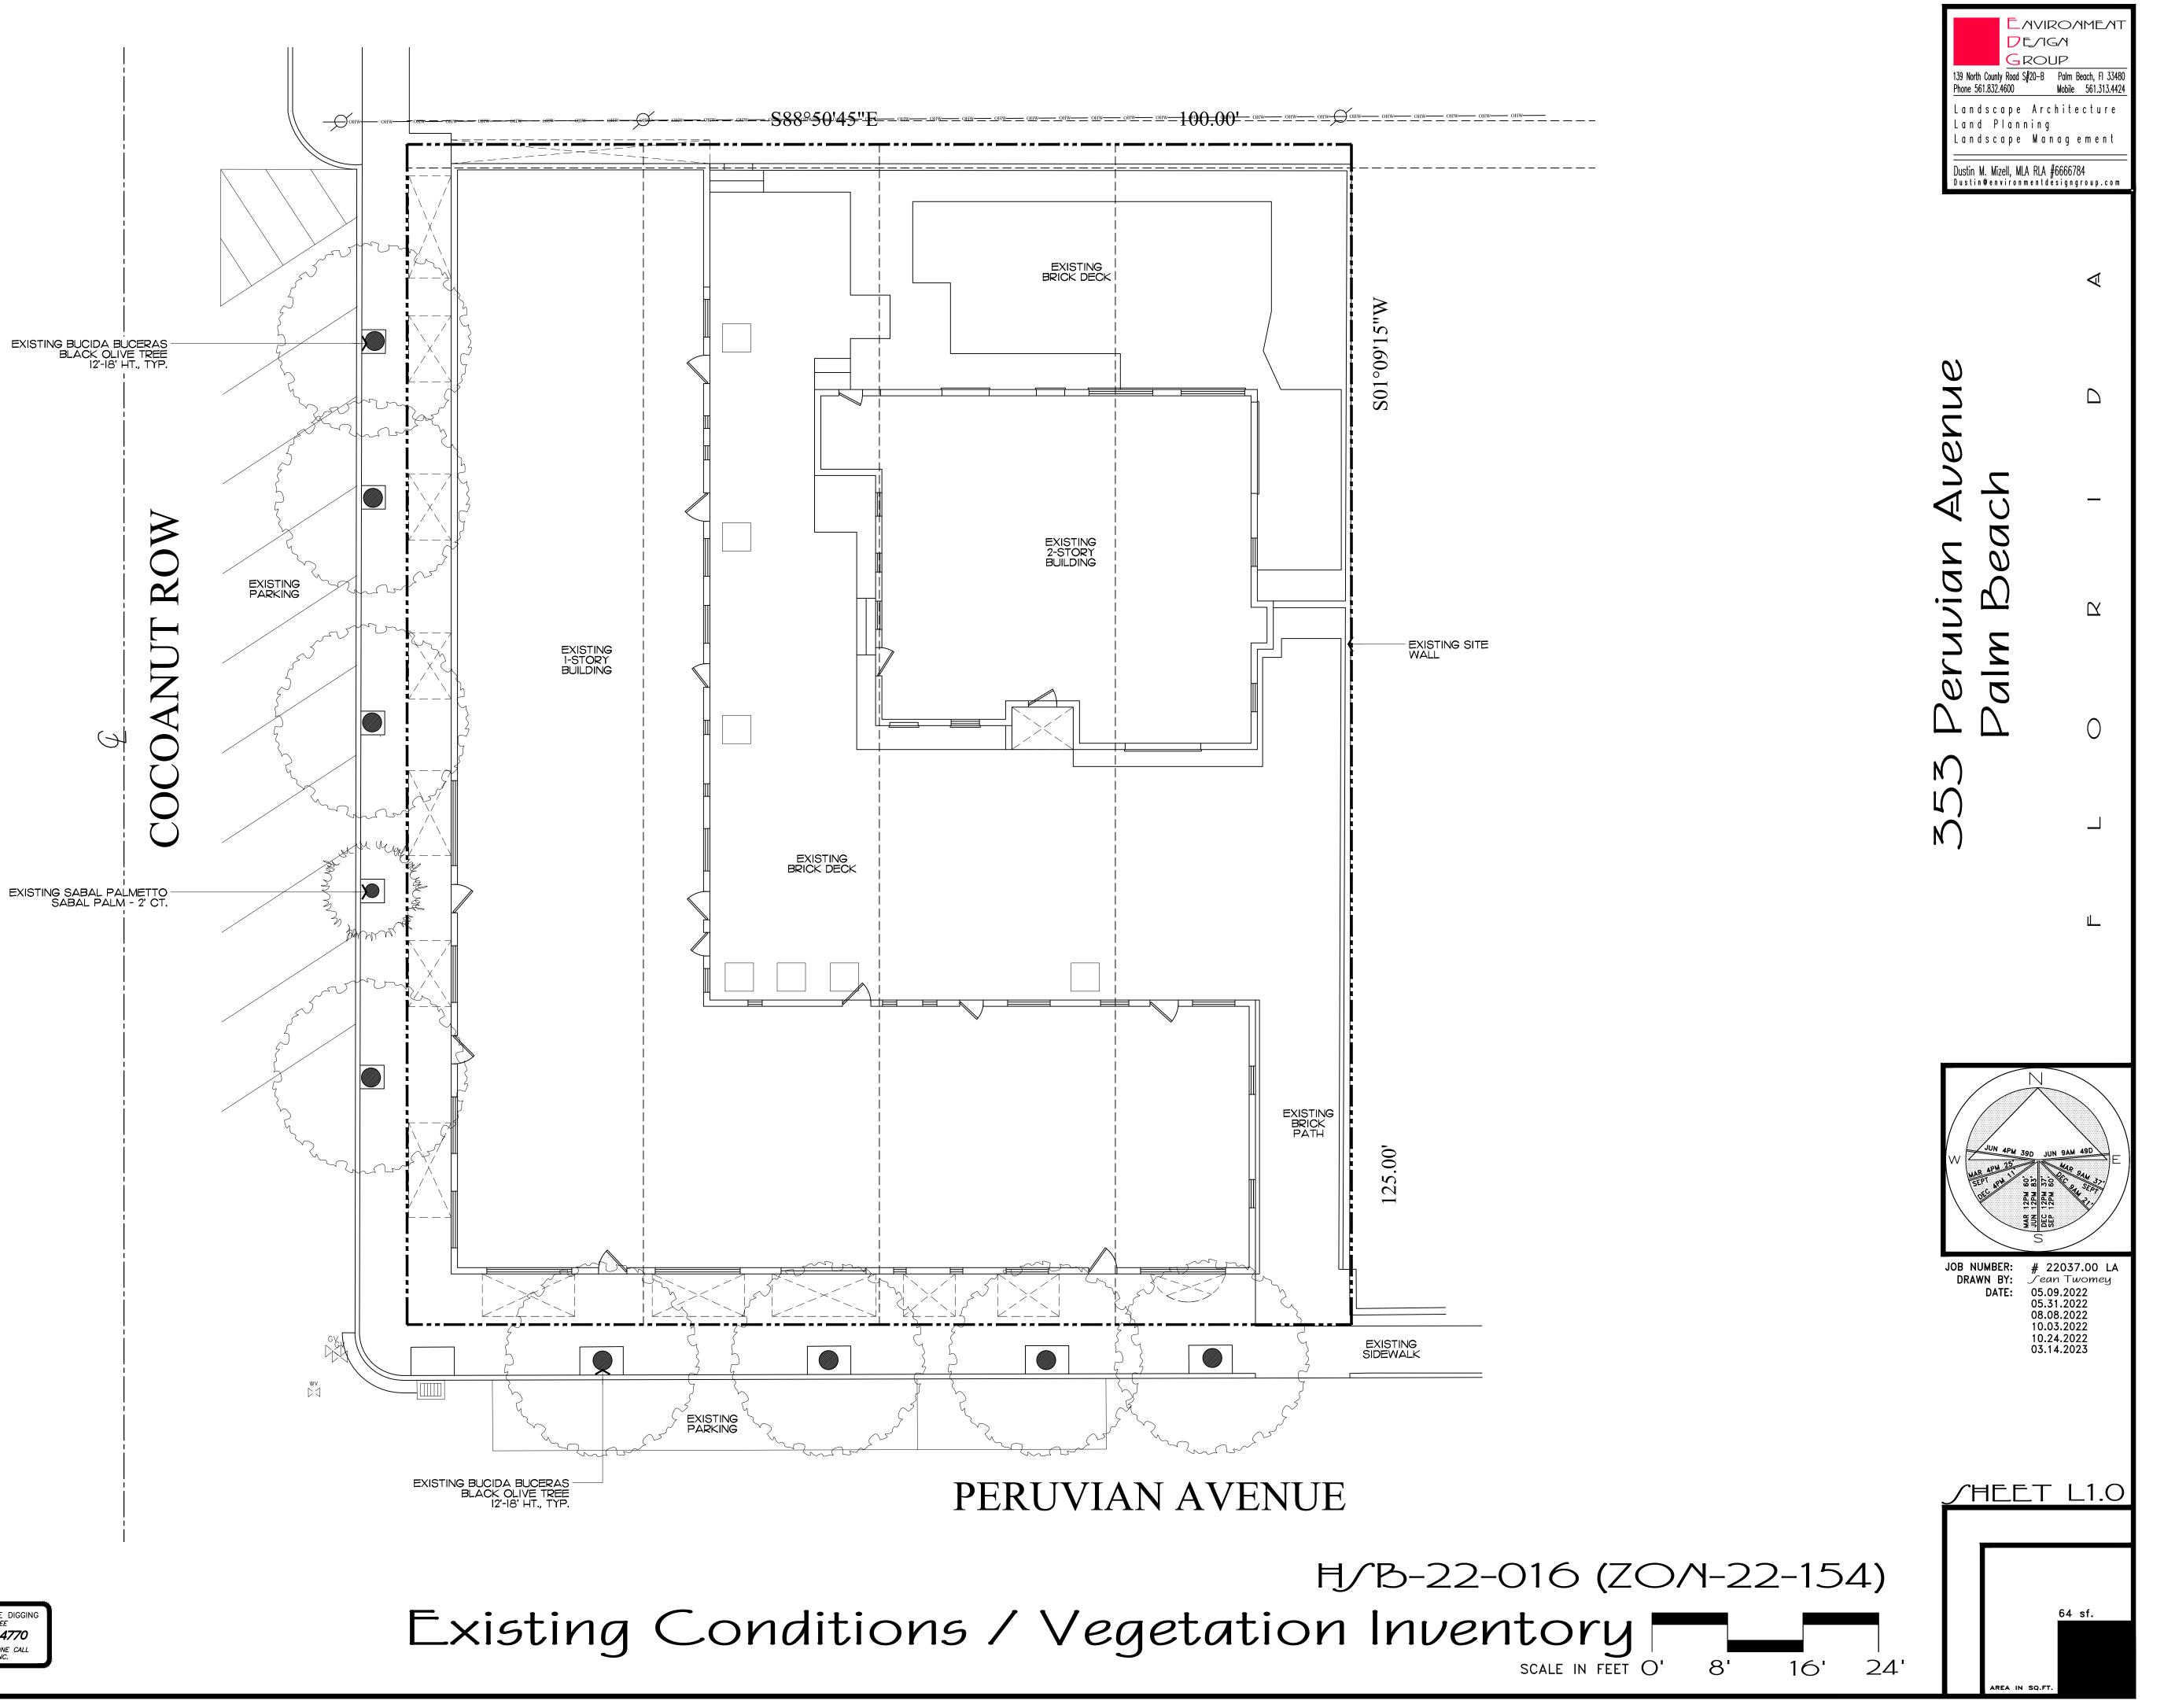

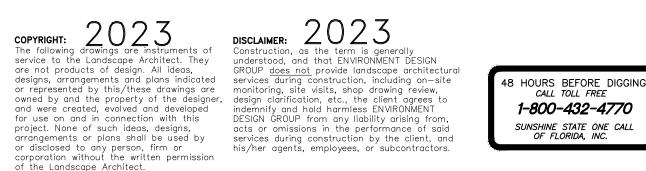





View Looking East on Peruvian Avenue





View Looking South on Cocoanut Row

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DE/IG/I GROUP


 139 North County Road S#20-B
 Palm Beach, FI 33480

 Phone 561.832.4600
 Mobile 561.313.4424

Landscape Architecture Land Planning Landscape Management


Dustin M. Mizell, MLA RLA #6666784 Dustin@environmentdesigngroup.com

Ħ/B-22-016 (ZO/N-22-154) Existing *f*ite Photos

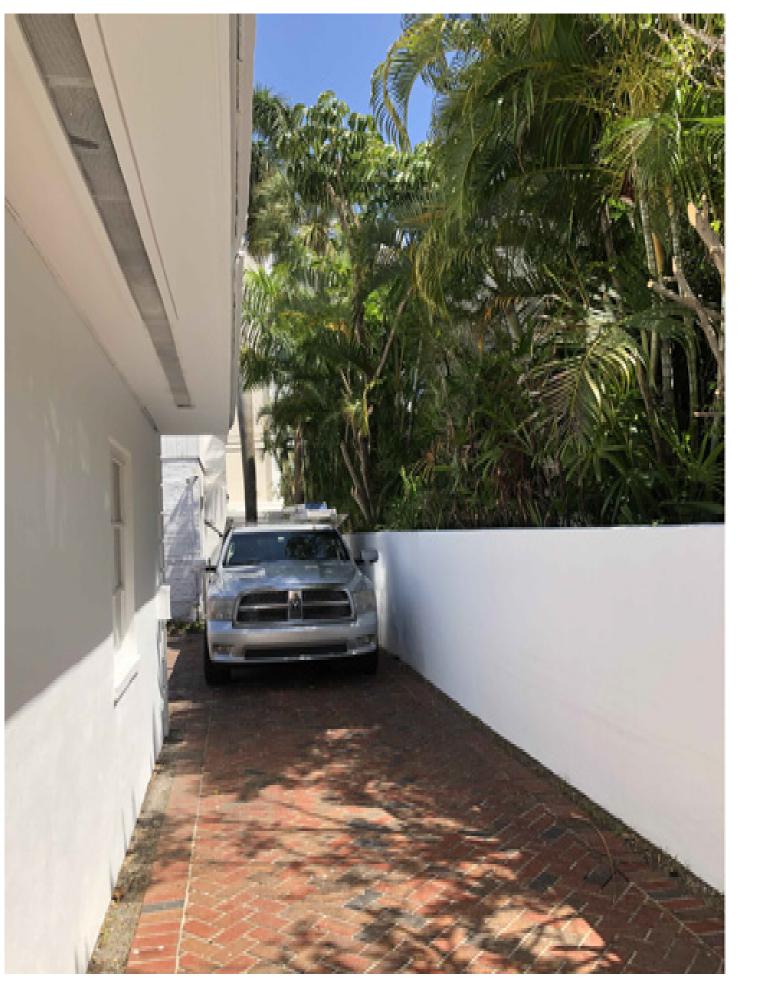

View Looking North to Existing Drive



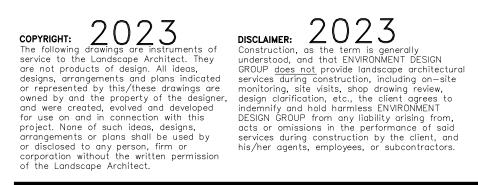








View Looking West to Existing Courtyard


View to Existing Two-/tory Building

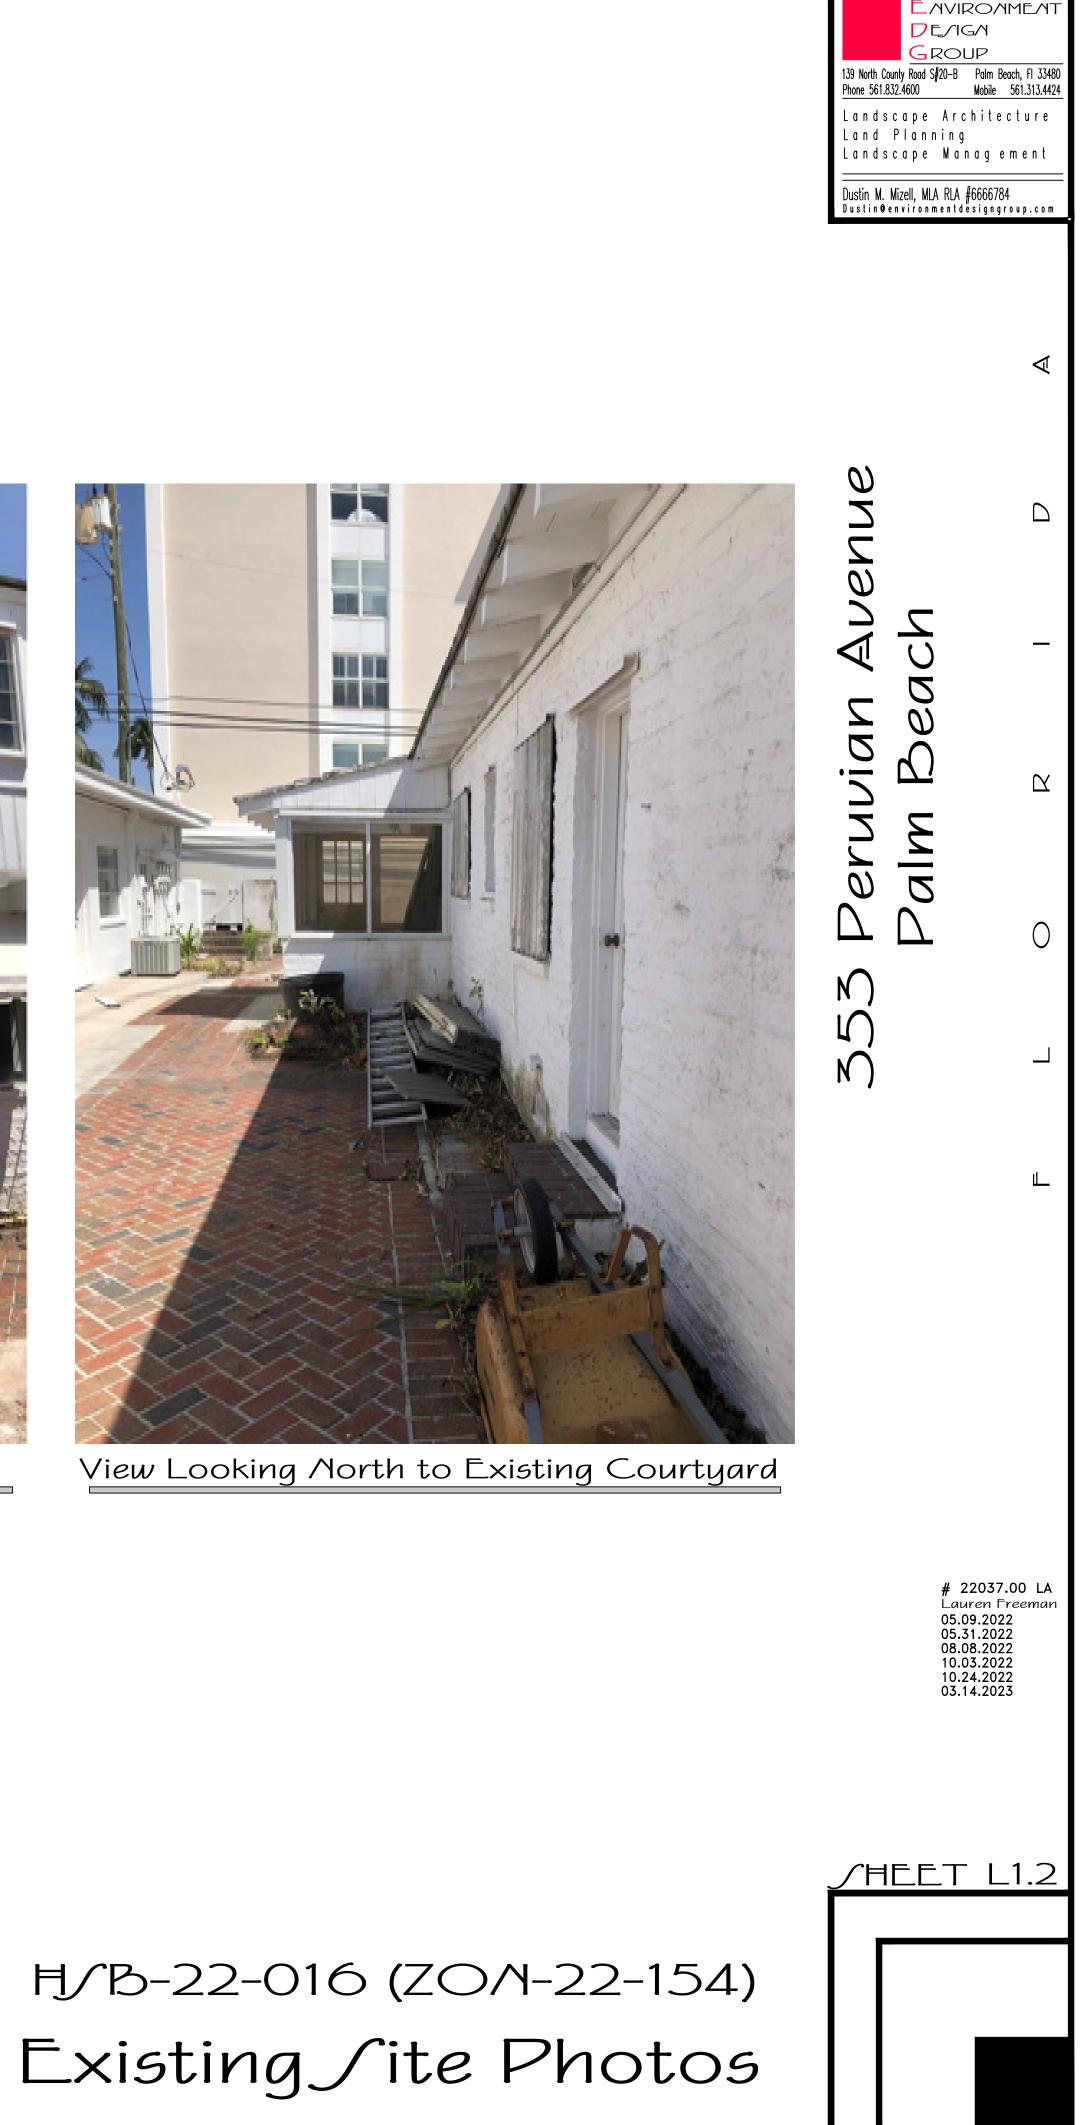


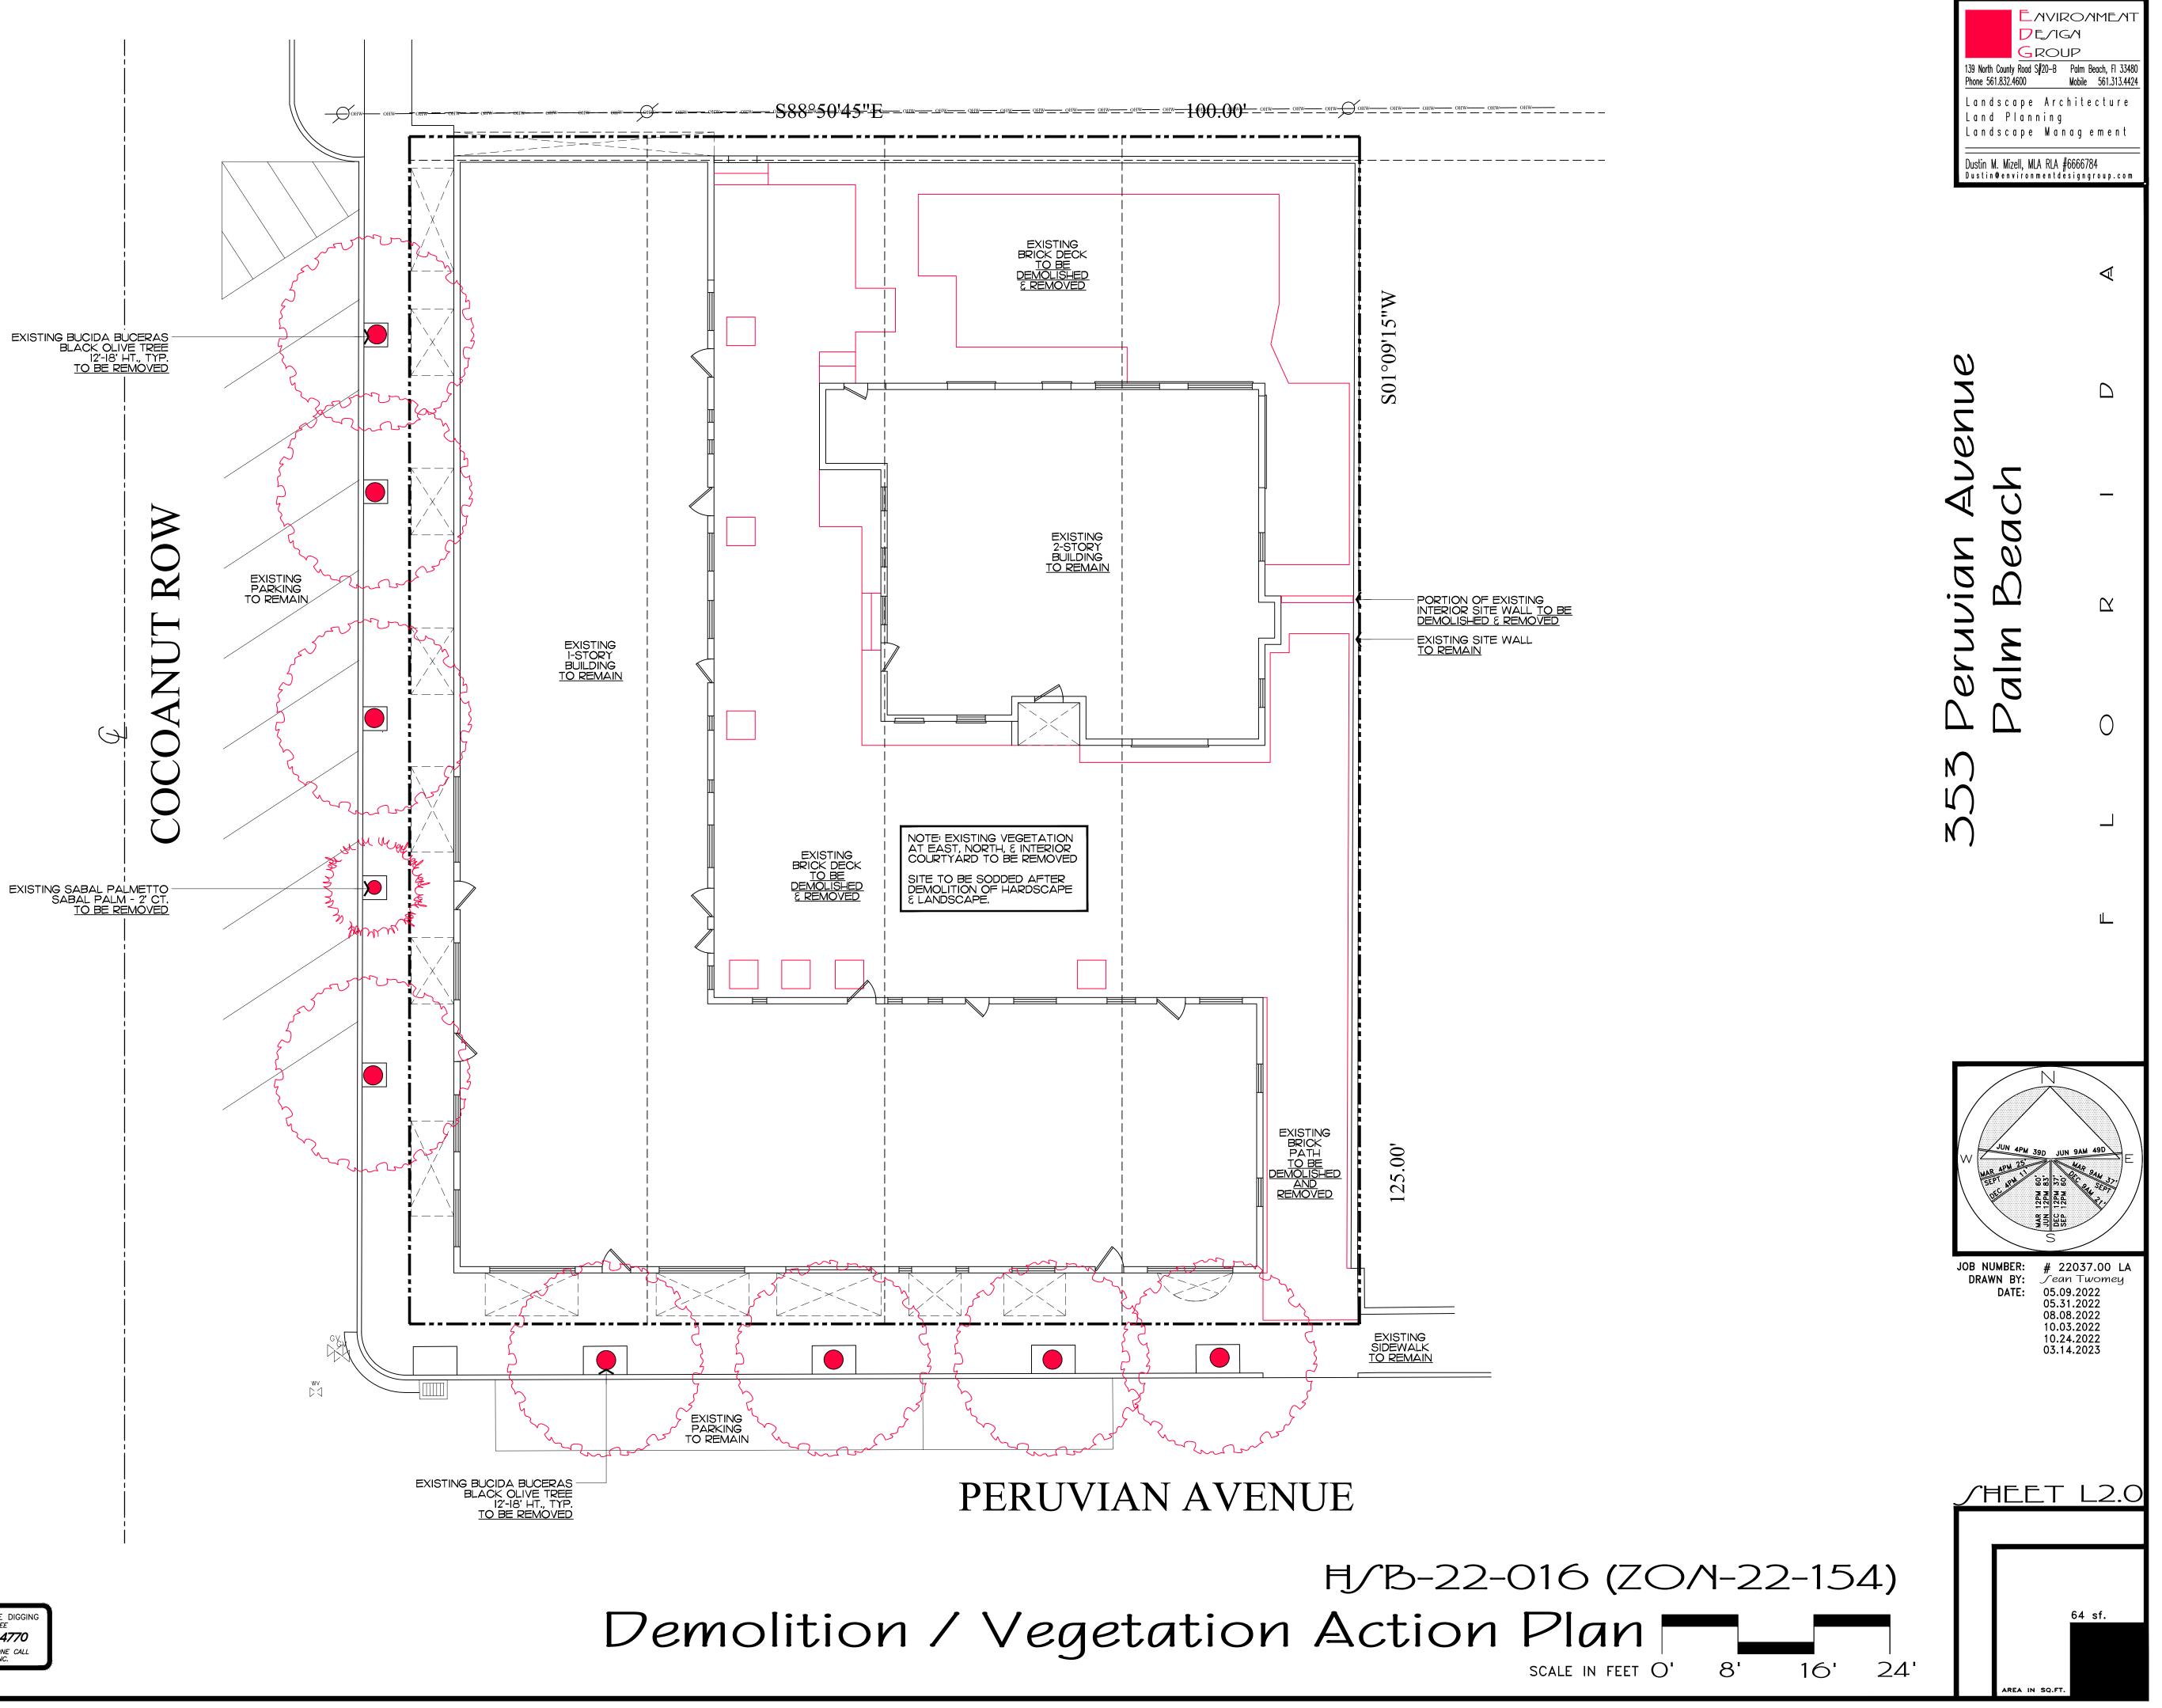

48 HOURS BEFORE DIGGING CALL TOLL FREE 1-800-432-4770 SUNSHINE STATE ONE CALL OF FLORIDA, INC. services during construction by the client, and his/her agents, employees, or subcontractors.

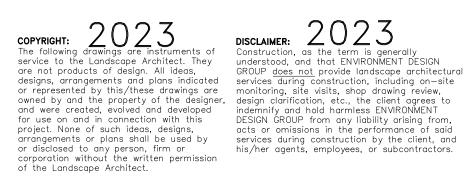


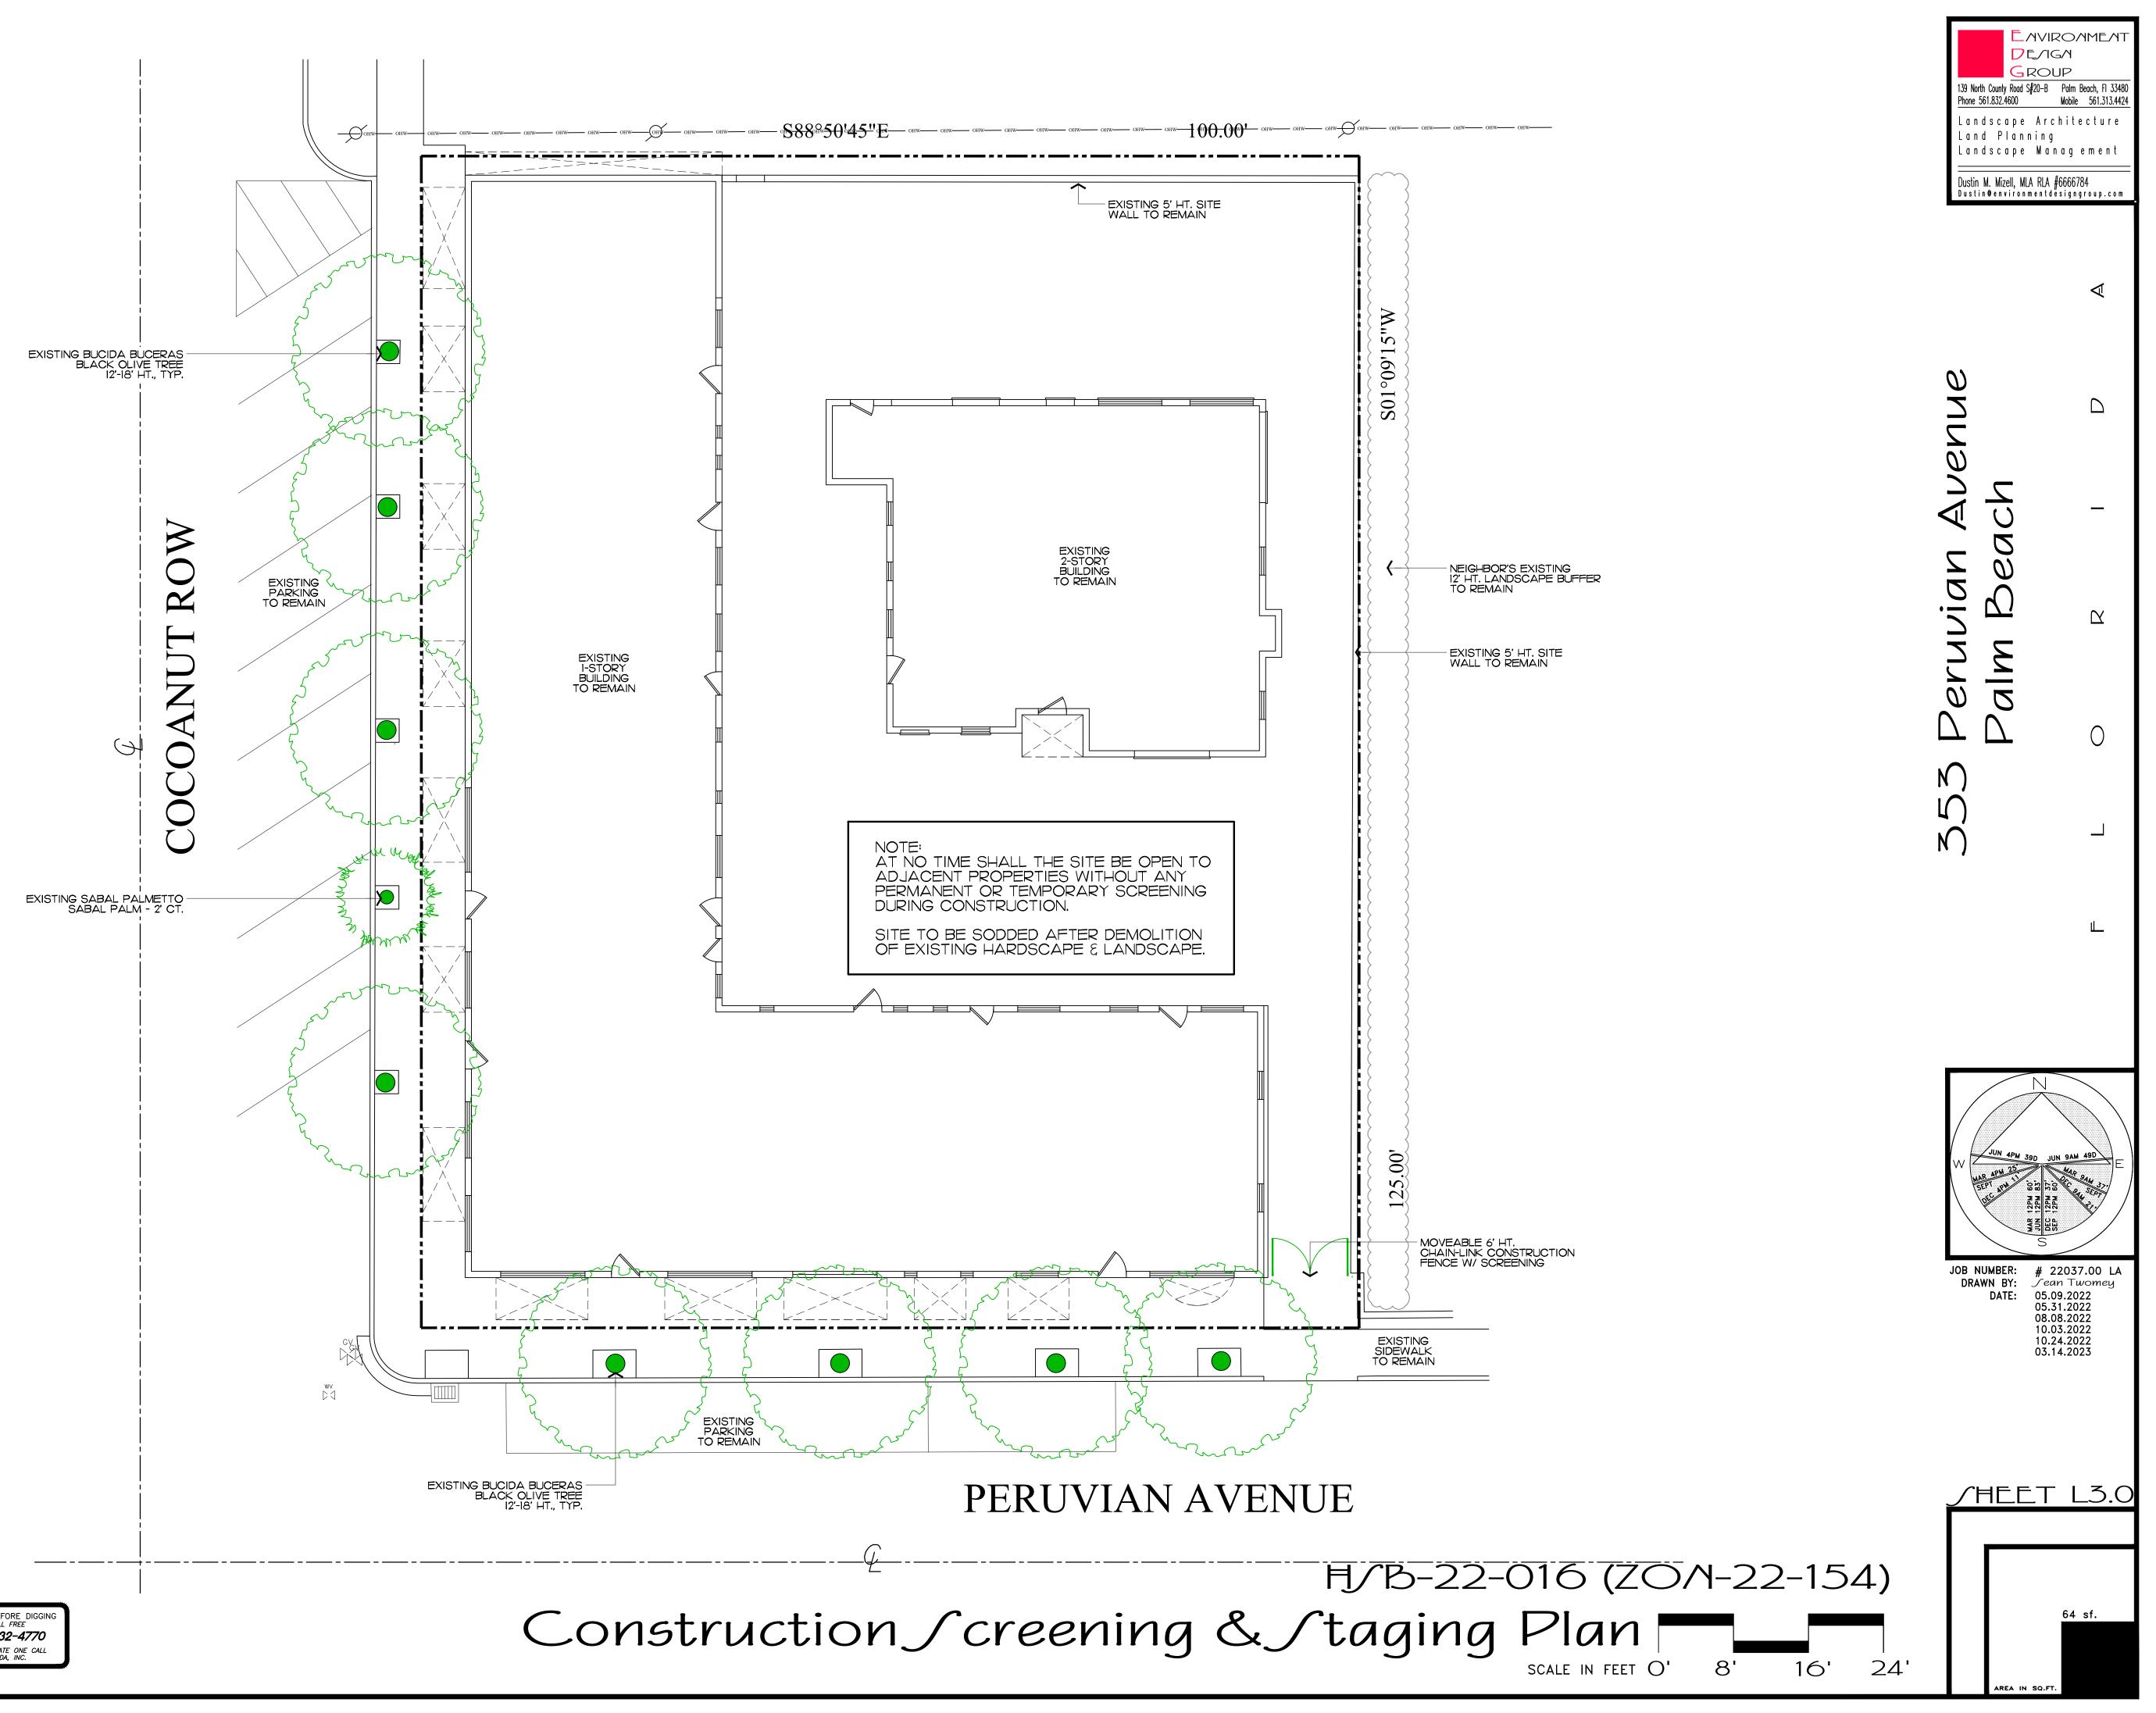

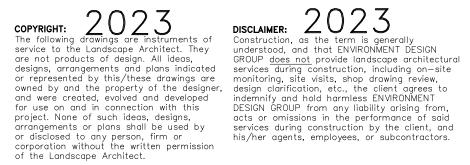







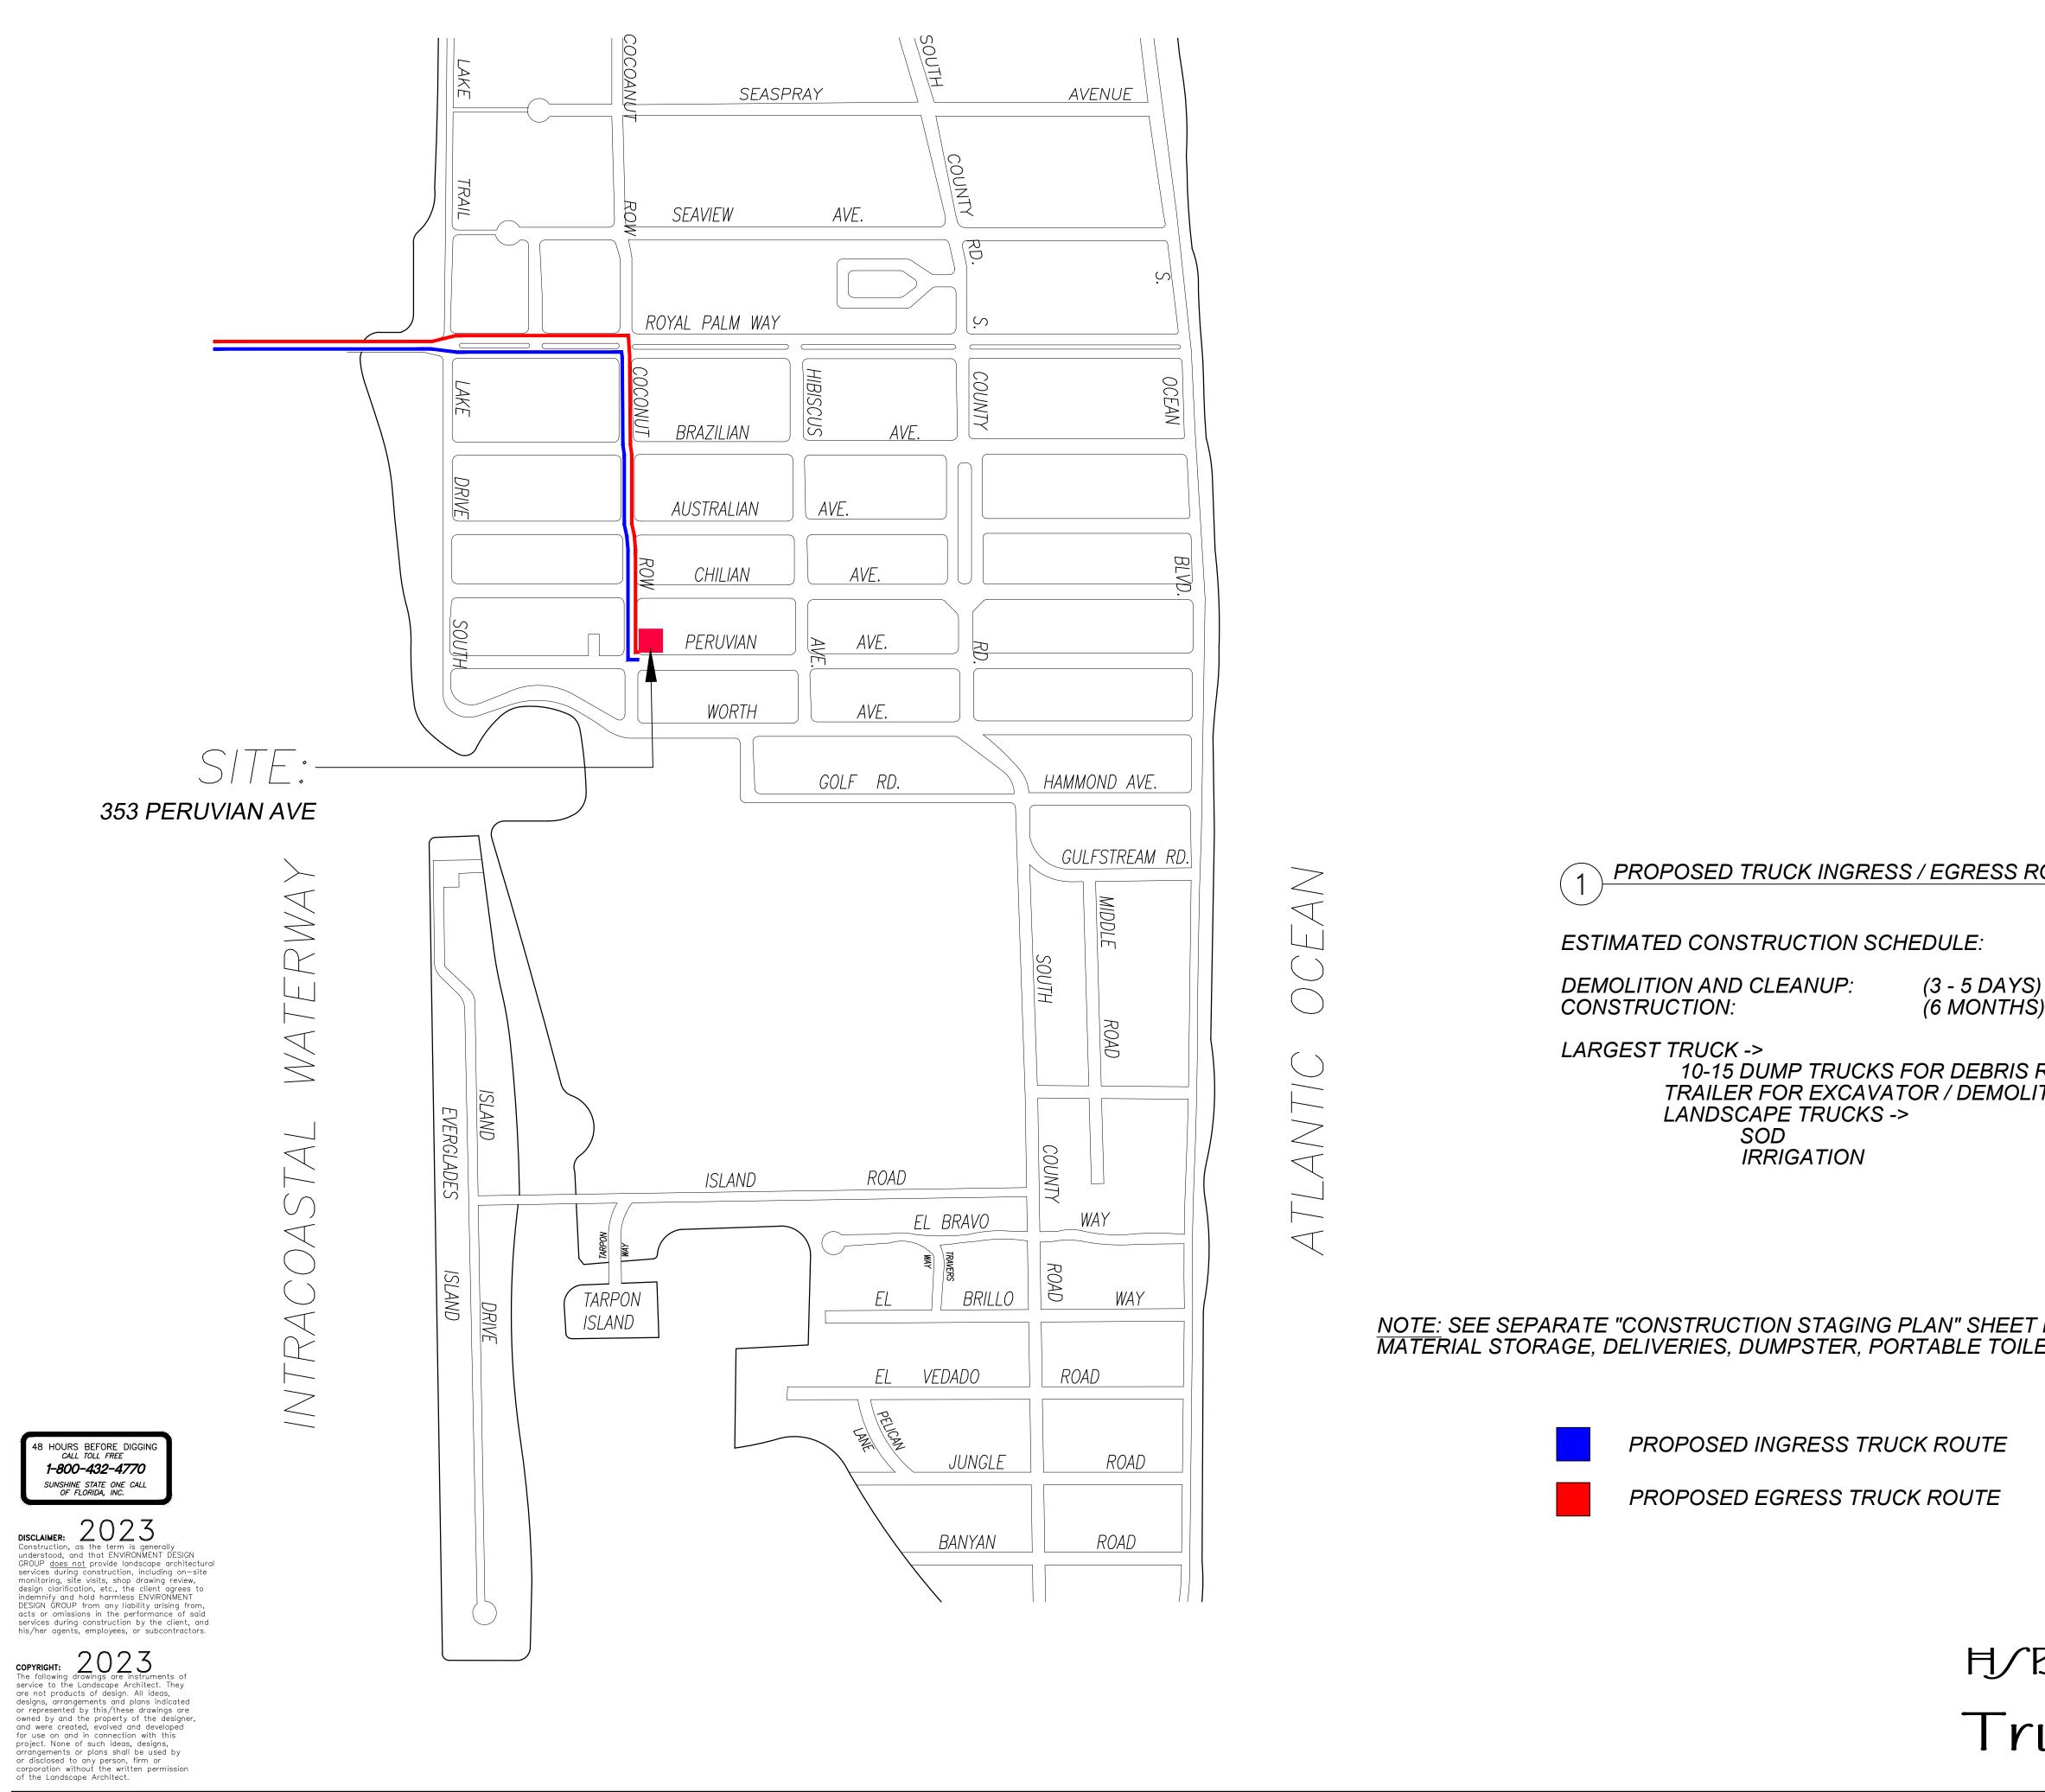


	DE∕IG. GROU 139 North County Road S∦20-B	P Palm Beach, FI 33480 Mobile 561.313.4424 itecture agement
ROUTES MAP	353 Peruvian Avenue Palm Beach	LORIO
) REMOVAL TION		Ļ
FOR INFORMATION ON LOCATIONS FOR PARKING, ETS, TIRE CLEANING AREA, SILT FENCE, ETC.	∫ear 05.09 05.31 08.08 10.03 10.24	L4.0
B-22-016 (ZOM-22-154) uck Logistics Plan		

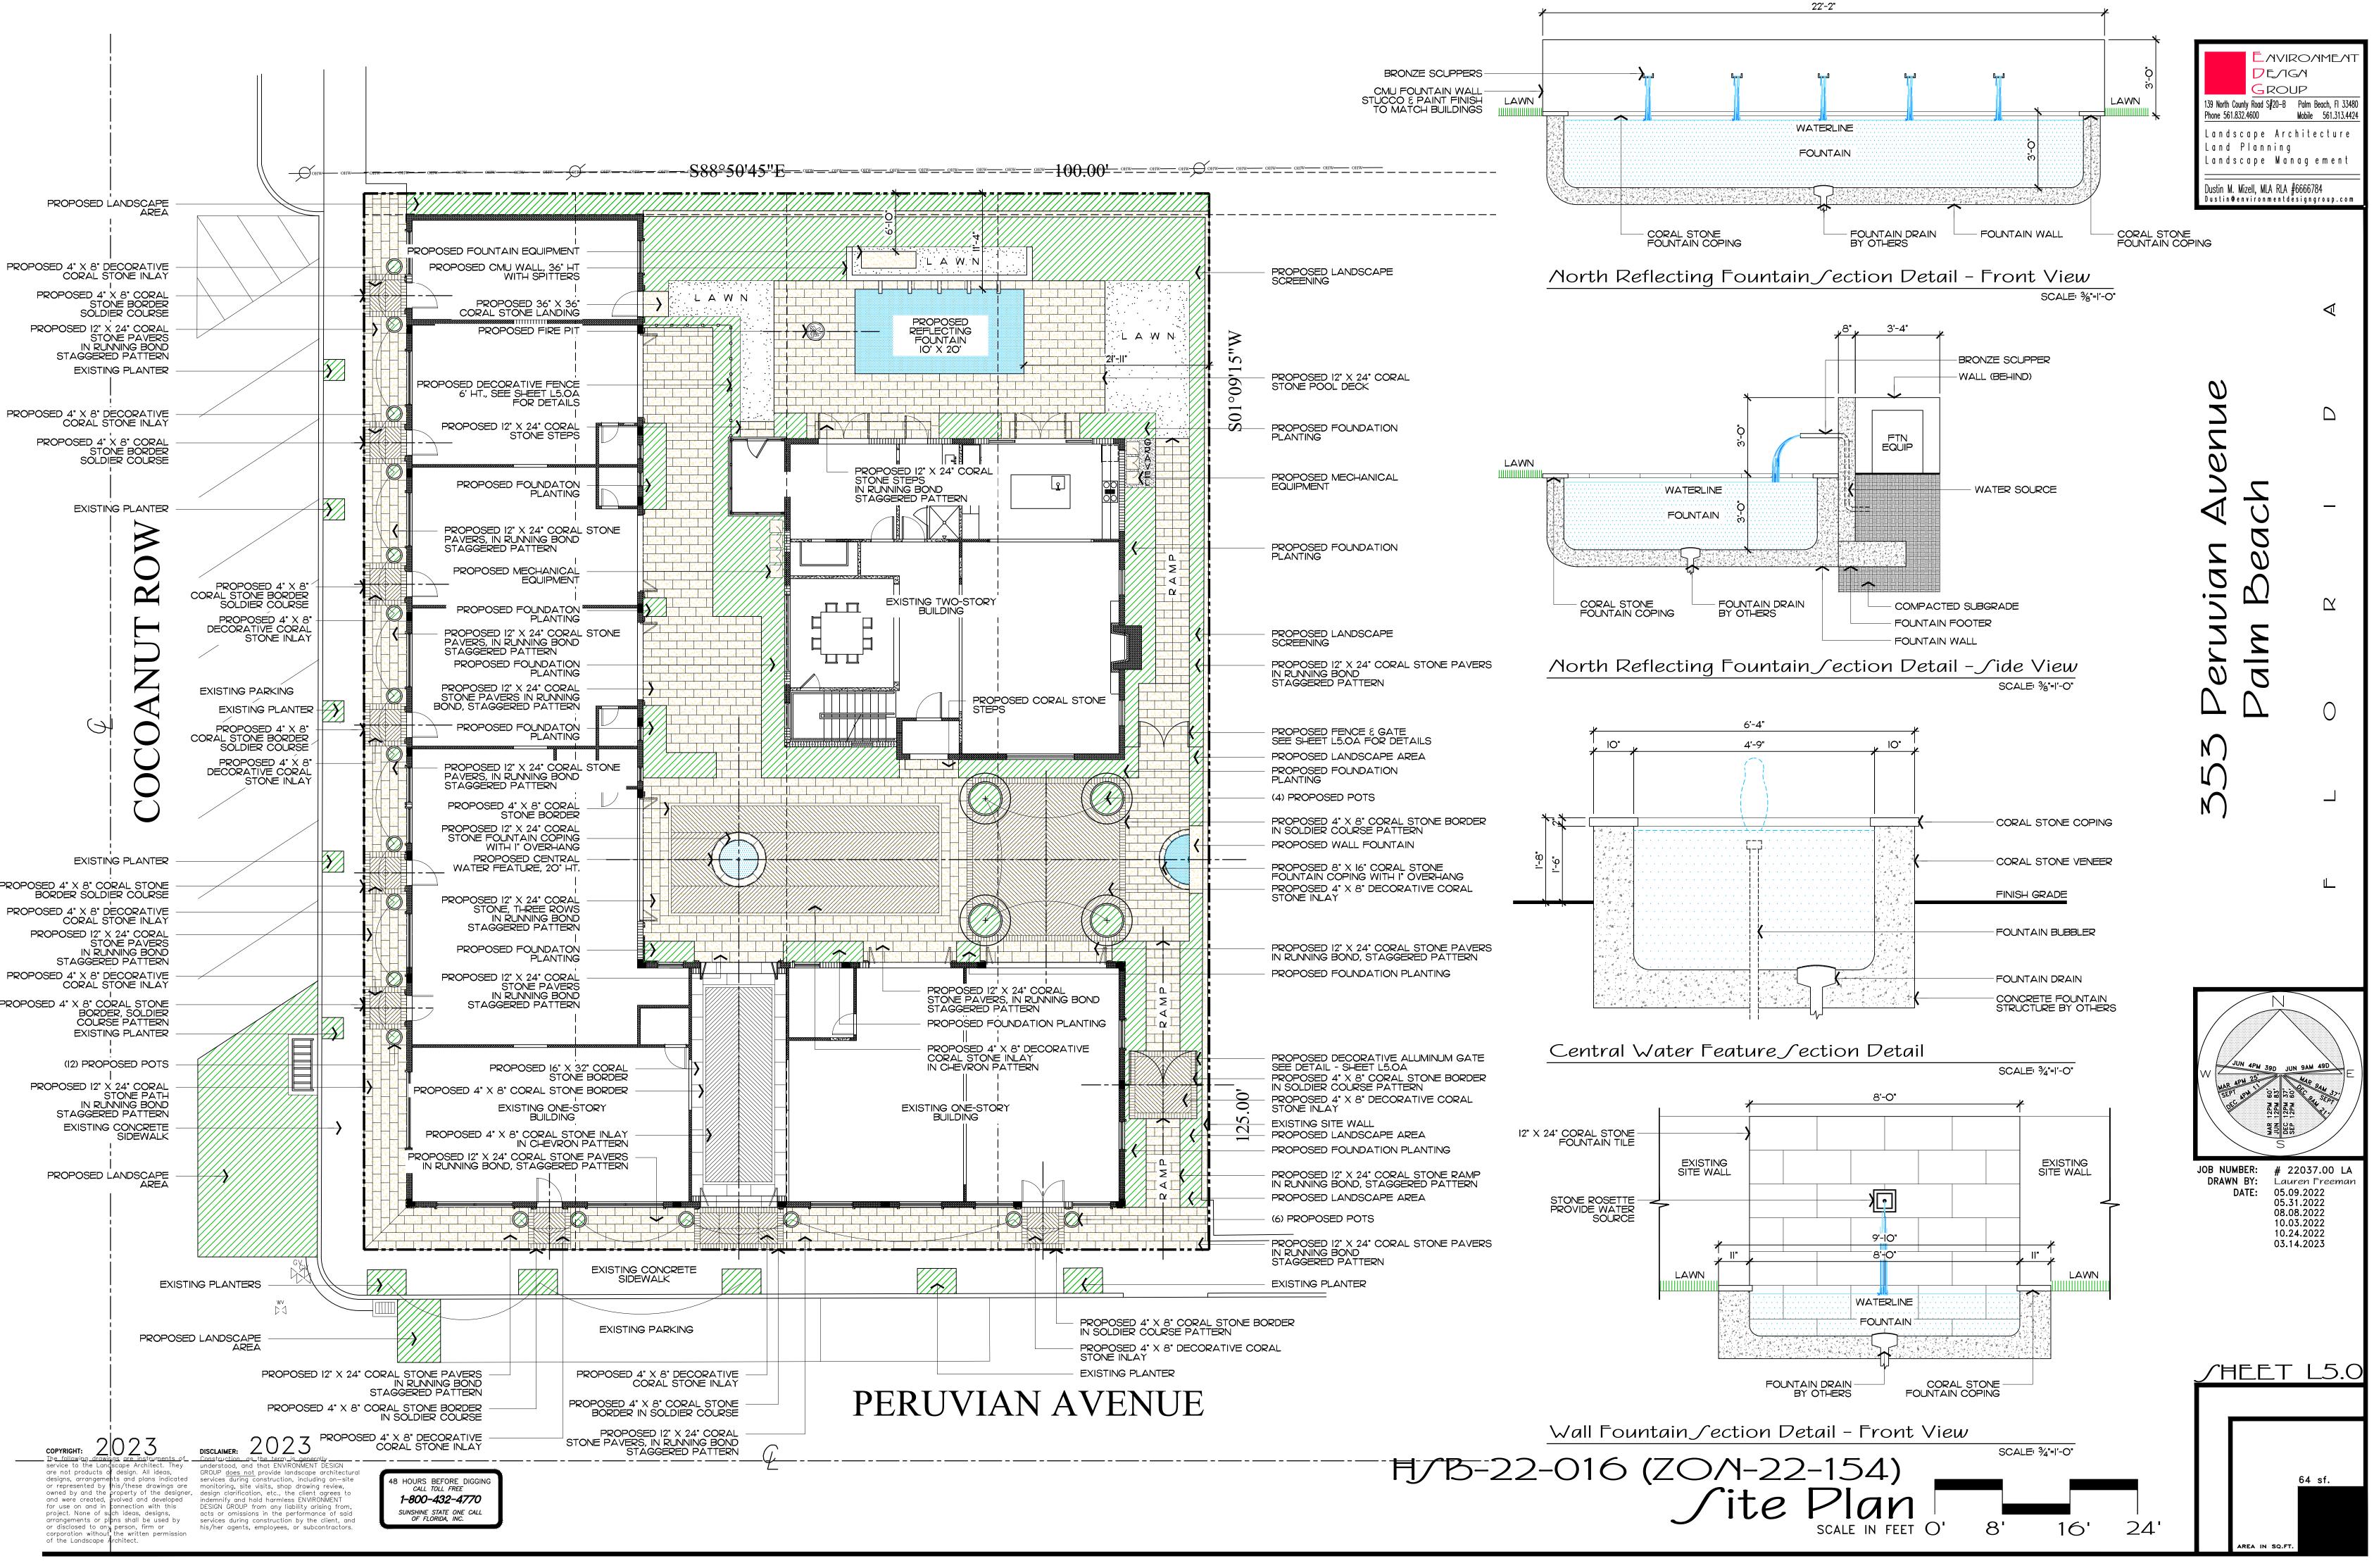


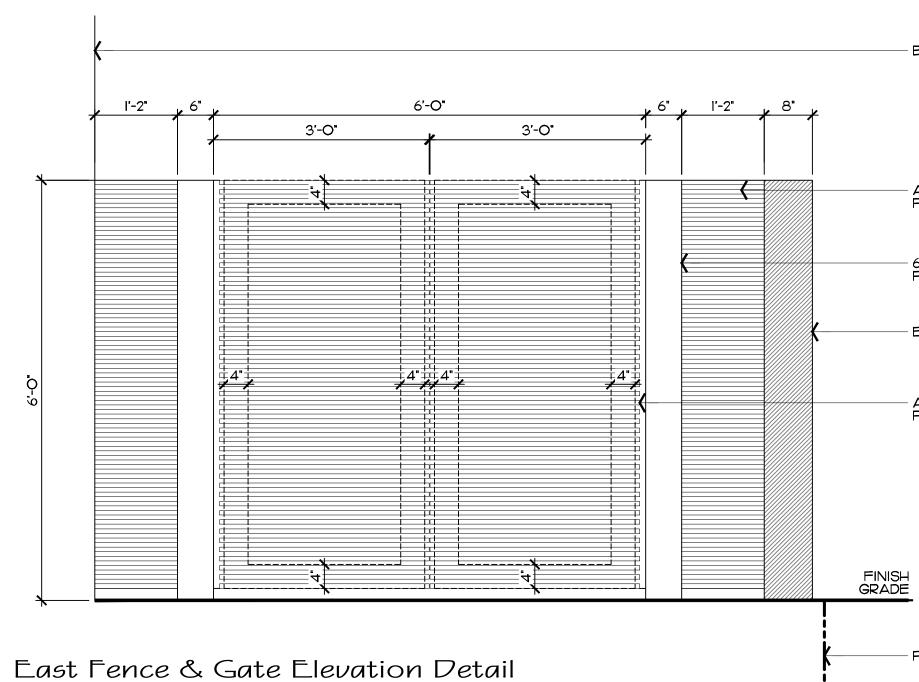

SCALE: 3⁄4"=1'-0"

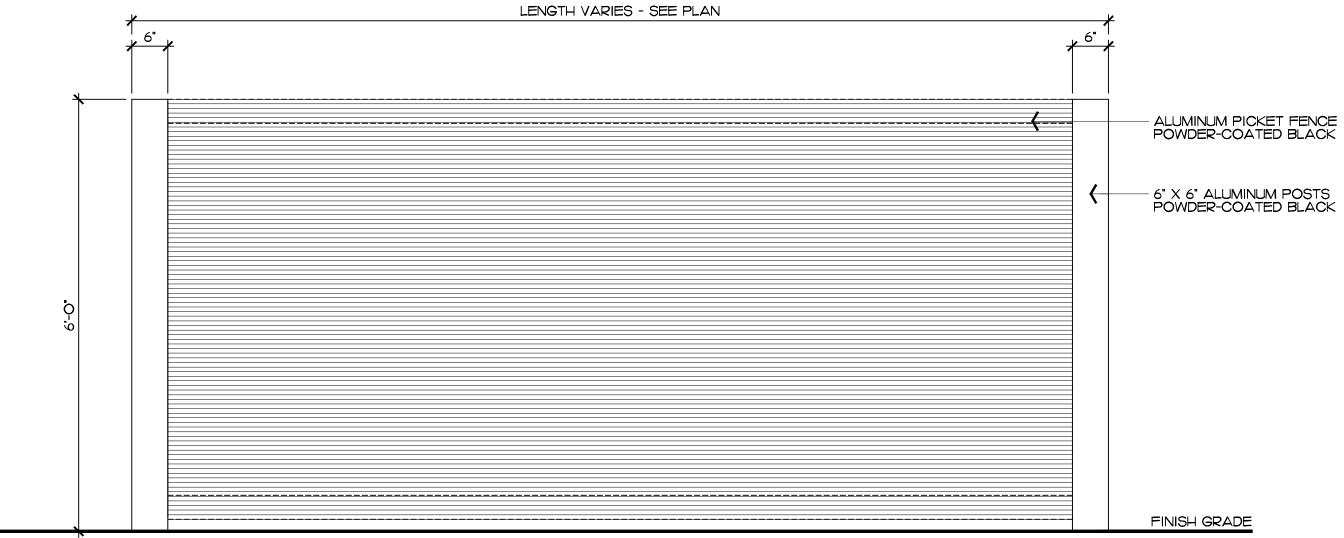

West Fence Elevation Detail - Front View

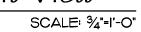



- BUILDING FACADE


- ALUMINUM PICKET FENCE POWDER-COATED BLACK

- 6" X 6" ALUMINUM FENCE POSTS POWDER-COATED BLACK


- EXISTING SITE WALL

- ALUMINUM PICKET GATE POWDER-COATED BLACK

- PROPERTY LINE

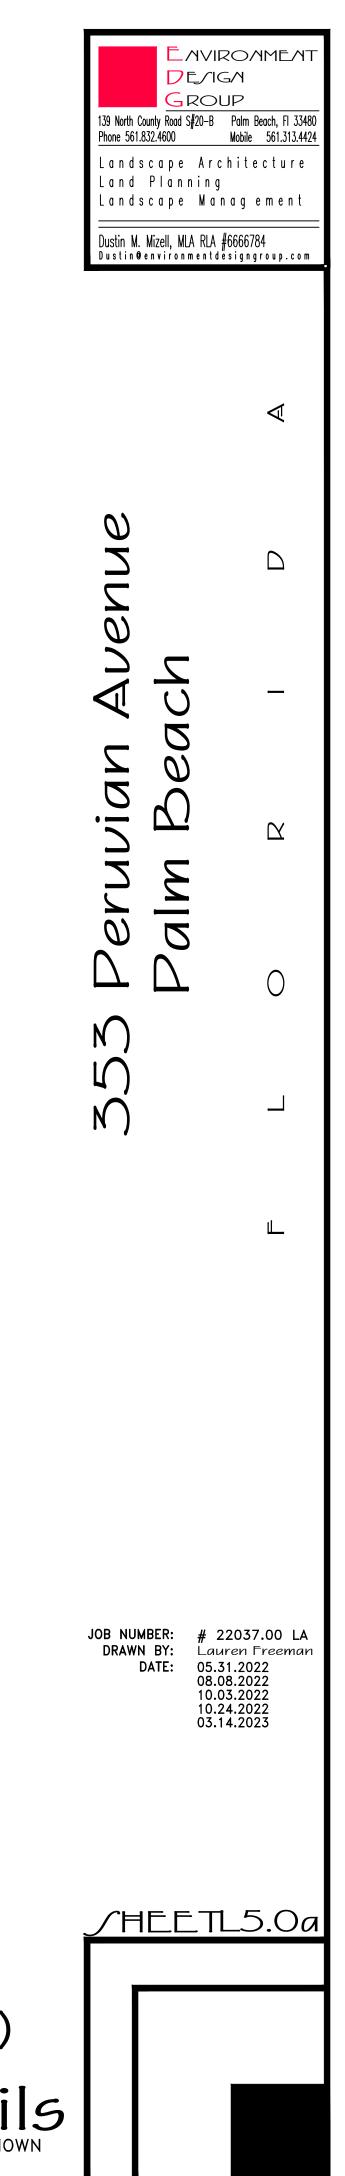

H/B-22-016 (ZOM-22-154) Scale IN FEET: AS SHOWN

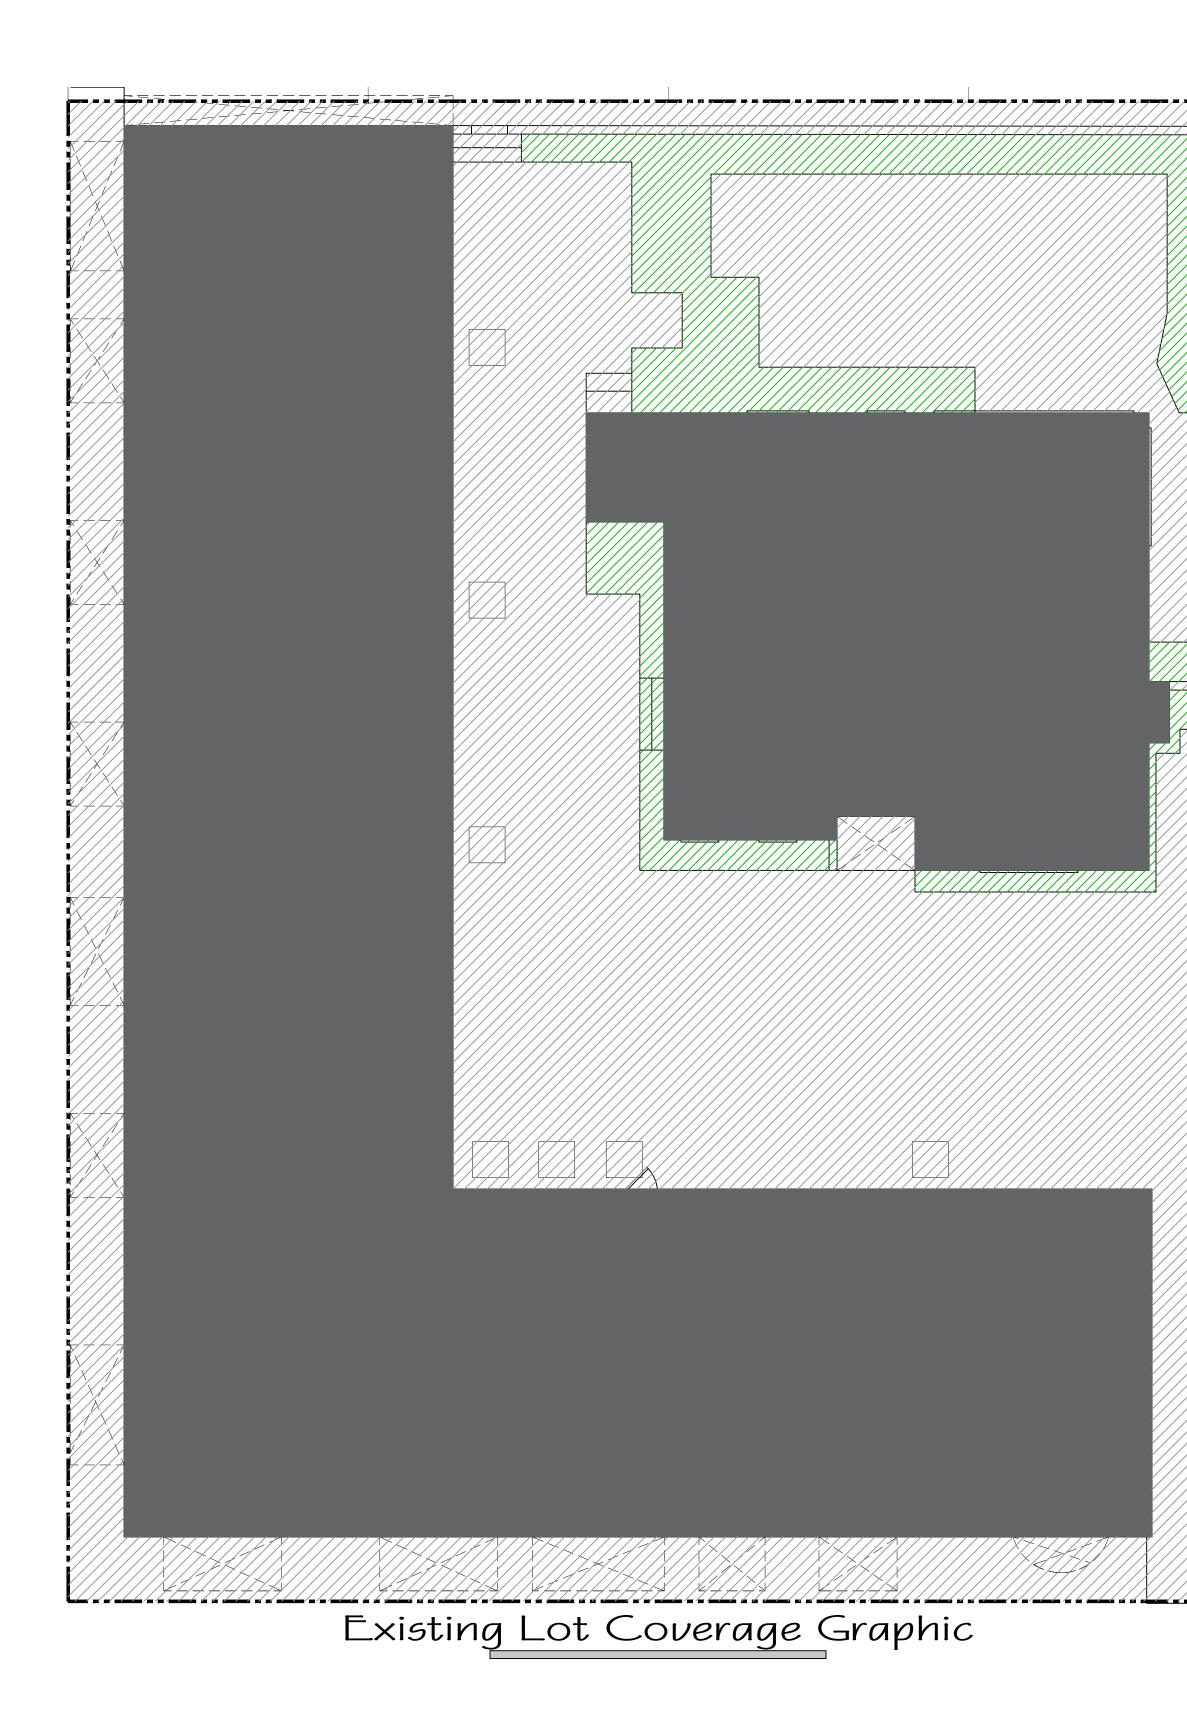



Legend





IMPERVIOUS AREA (HOUSE/STRUCTURE)


IMPERVIOUS AREA (HARDSCAPE)

PERVIOUS AREA / OPEN SPACE

DESCRIPTION	REQUIRED
LOT ZONE	
LOT AREA	4,000 S.F. MIN.
	4,000 3.1 . 101114.
OPEN / PERMEABLE SPACE	MINIMUM 15% 1,875.5 S.F.

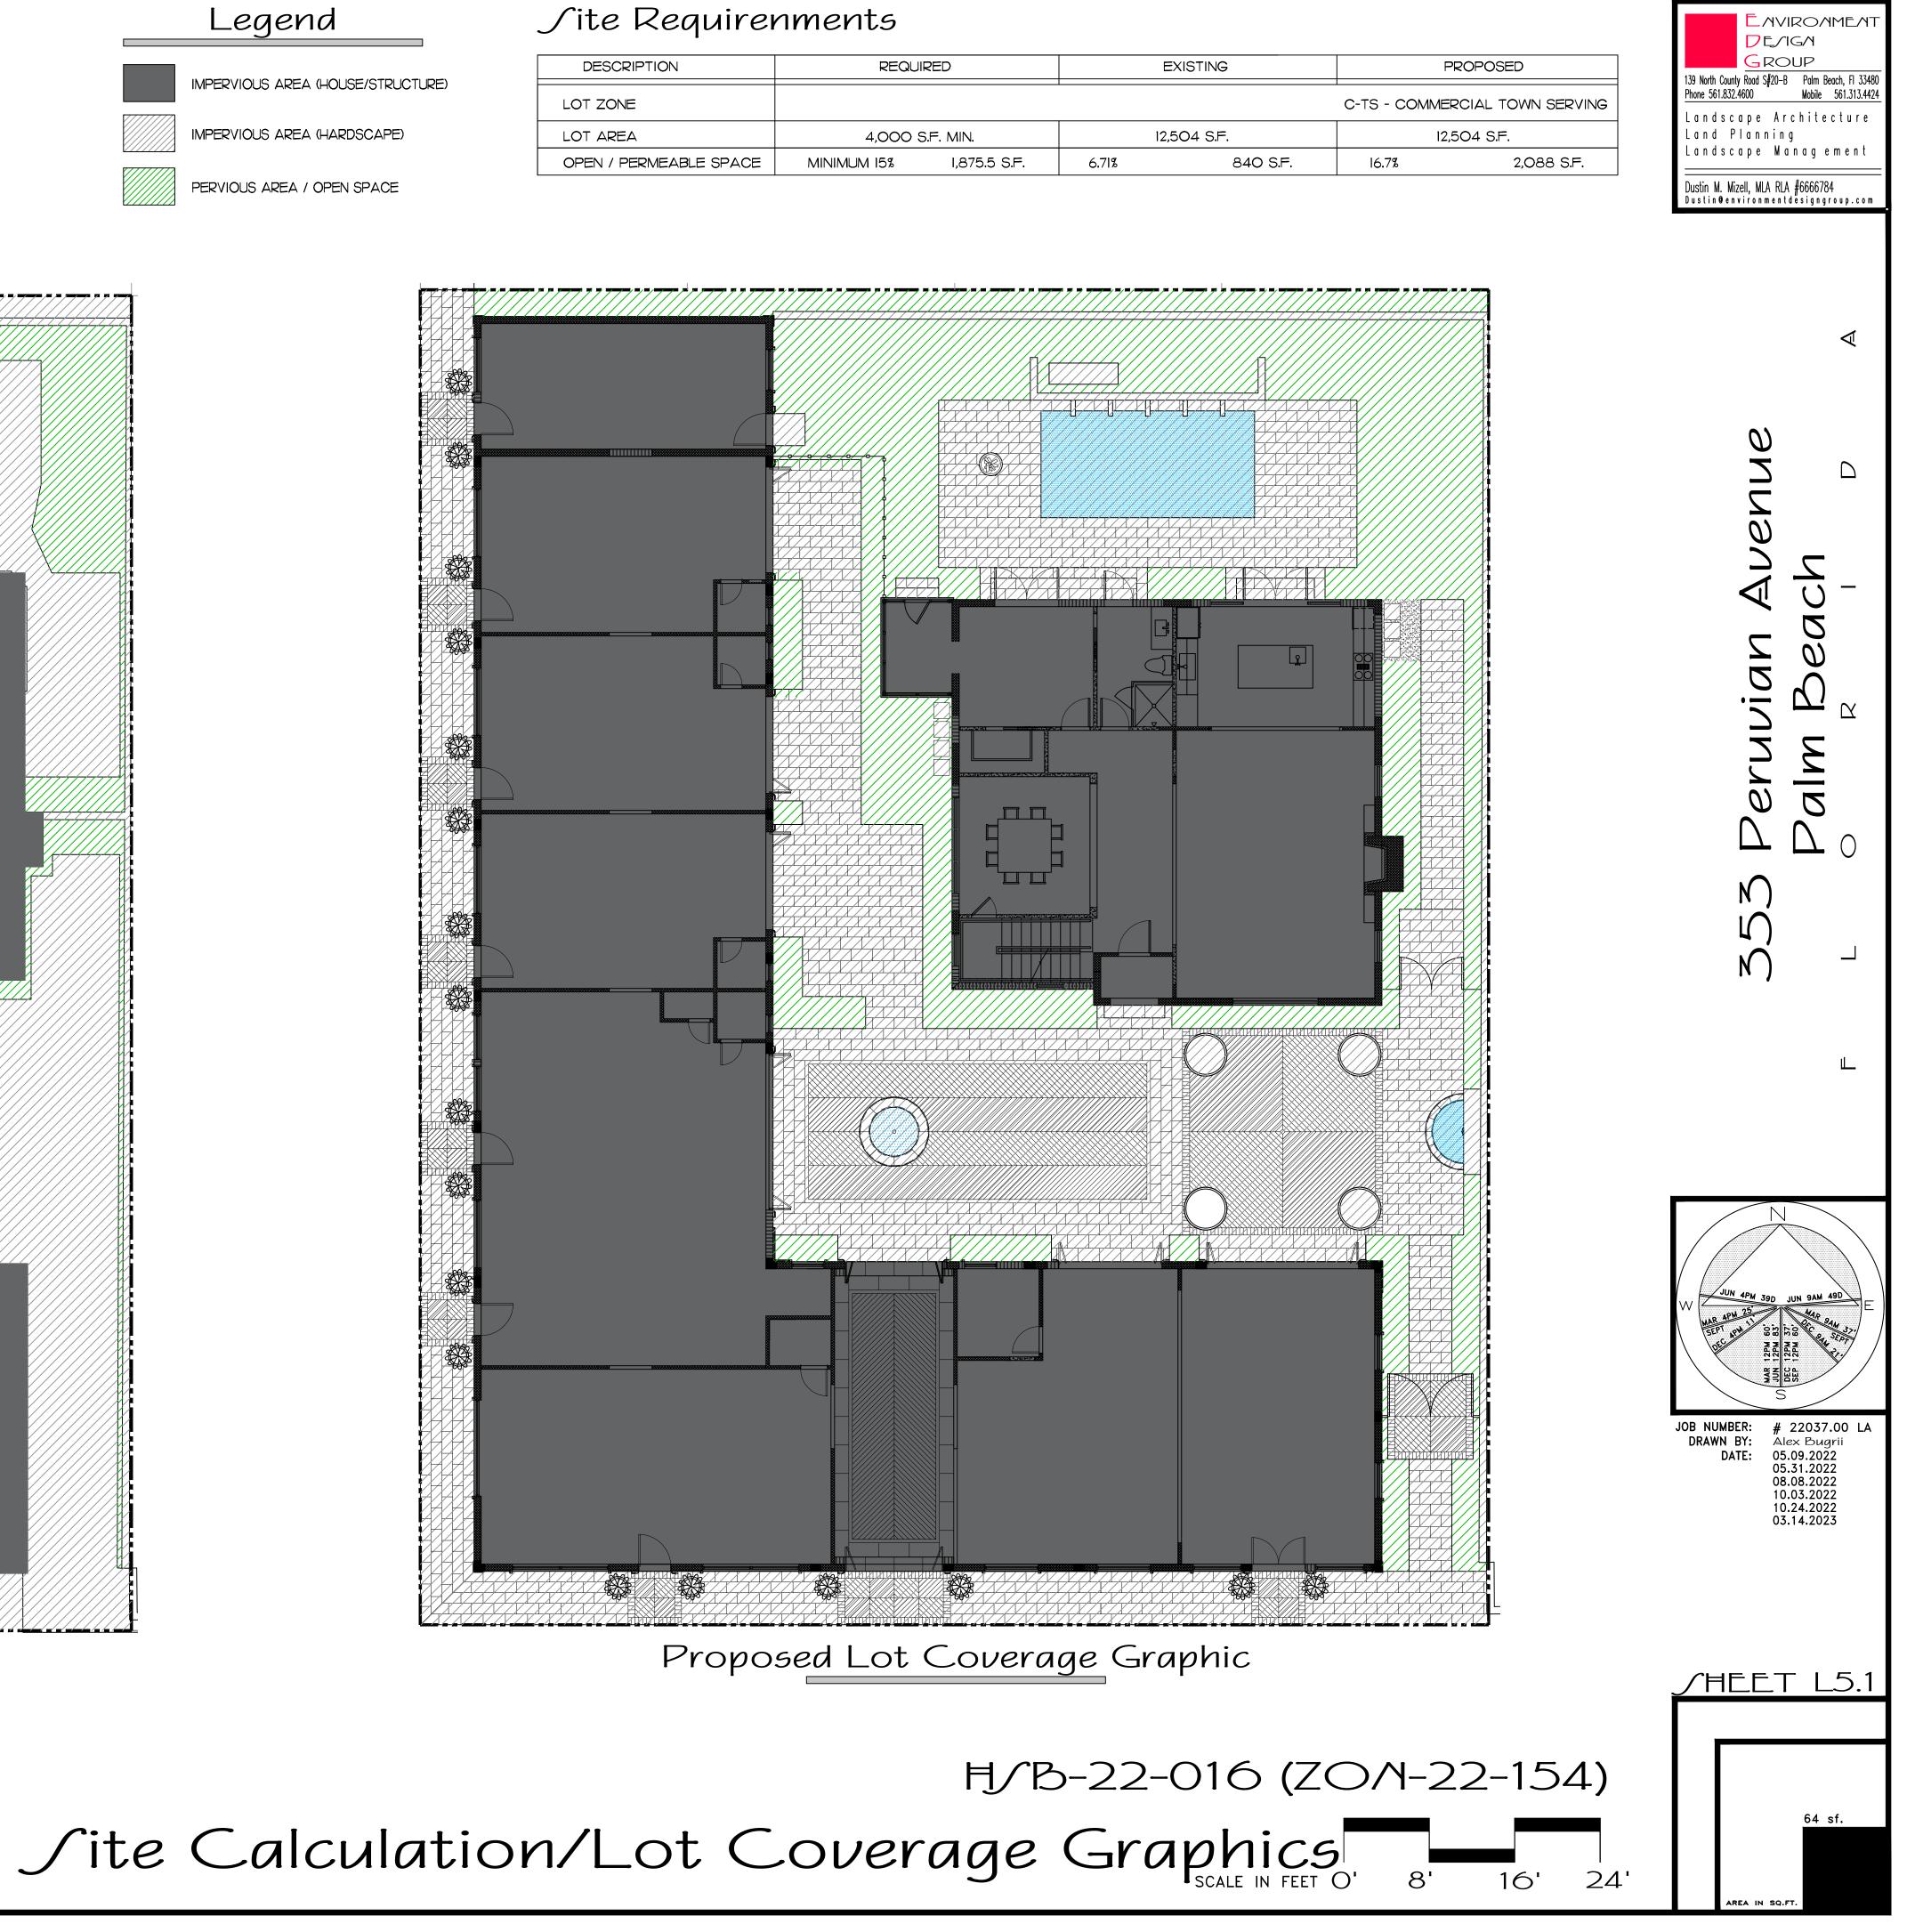

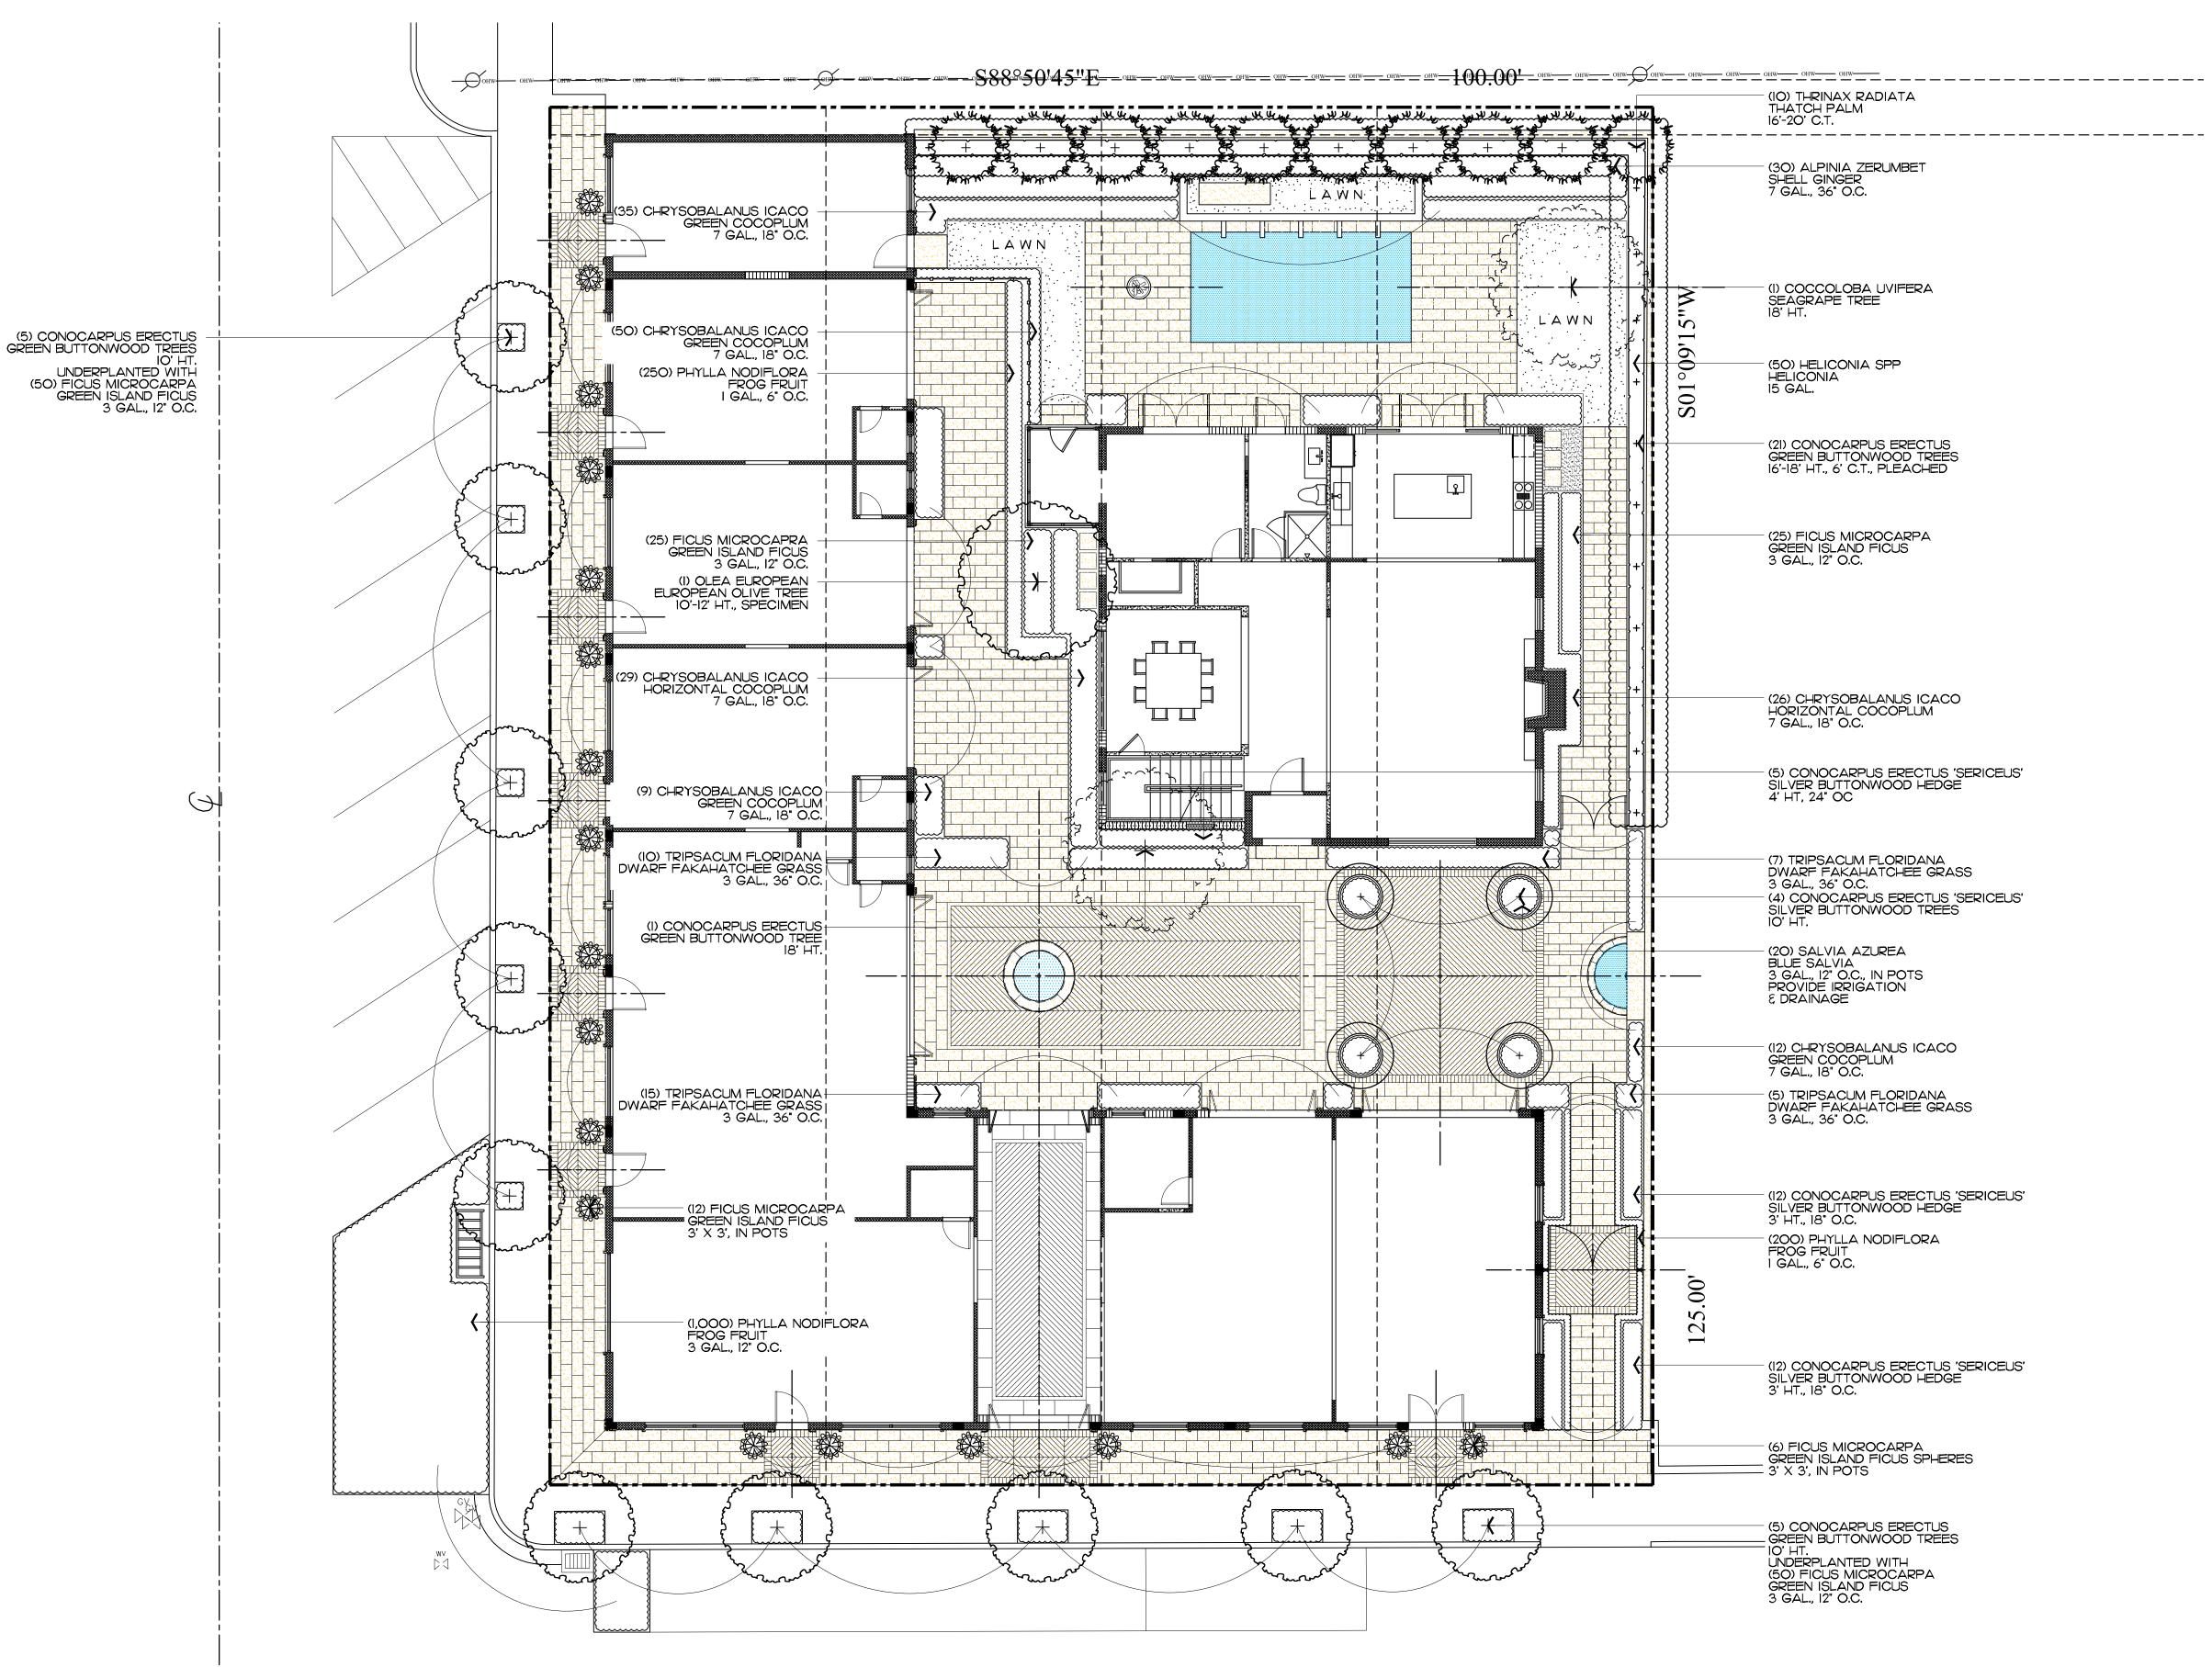

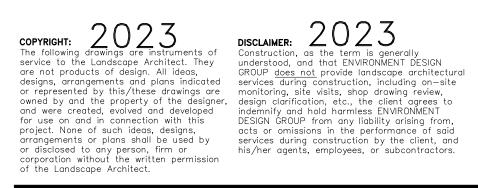





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(SOBALANUS ICACO COCOPLUM B" O.C.		
SACUM FLORIDANA =AKAHATCHEE GRASS 36" O.C.		
DCARPUS ERECTUS 'SERICEUS' BUTTONWOOD HEDGE " O.C.		
IYLLA NODIFLORA RUIT ' O.C.	JUN 4PM 39D JUN WAR 125 00 100 100 100 100 100 100 100 100 100	MAP PAN SI
OCARPUS ERECTUS 'SERICEUS' BUTTONWOOD HEDGE " O.C.	DRAWN BY: Цаи DATE: 05.0	2037.00 LA ren Freeman 9.2022 1.2022
5 MICROCARPA SLAND FICUS SPHERES N POTS	08.0 10.0	8.2022 3.2022 4.2022 4.2023
DCARPUS ERECTUS BUTTONWOOD TREES LANTED WITH US MICROCARPA SLAND FICUS 2" O.C.		
	<u>/HEET</u>	L6.0
B-22-016 (ZOM-22-154)		64 - 6
cape Plan	AREA IN SQ.FT.	64 sf.

ENVIRONMENT DE/IG/ 139 North County Road S#20–B Palm Beach, FI 3348 Phone 561.832.4600 Mobile 561.313.4424 Landscape Architecture Land Planning Landscape Management Dustin M. Mizell, MLA RLA #6666784 Dustin@environmentdesigngroup.com

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Trees

SYMBOL/KEY	PLANT NAME		QTY.	DESCRIPTION	NATIVE
	COCCOLOBA UVIFERA SEAGRAPE TREE		1	18' HT.	*
	CONOCARPUS ERECTUS GREEN BUTTONWOOD TREES		21 10	16'-18' HT., 6' C.T., PLEACHED 10' HT.	*
	CONOCARPUS ERECTUS GREEN BUTTONWOOD TREES		1	18' HT.	*
+	CONOCARPUS ERECTUS 'SERICEUS'		4	IO' HT., IN POTS	*
+	OLEA EUROPEA EUROPEAN OLIVE TREE		1	10'-12' HT., SPECIMEN	
		TOTAL: NATIVE SPECIES:	38 37 (97.4%)		

Palms

SYMBOL/KEY	PLANT NAME		QTY.	DESCRIPTION	NATIVE
3 + 2 - 2 - 2 - 2 - 2 - 2 - 2 - 2 - 2 - 2	THRINAX RADIATA THATCH PALM		10	16'-20' C.T.	*
		TOTAL: NATIVE SPECIES:	10 10 (100%)		

Shrubs

SYMBOL/KEY	PLANT NAME		QTY.	DESCRIPTION	NATIVE
	ALPINIA ZERUMBET SHELL GINGER		30	7 GAL., 36" O.C.	
	CHRYSOBALANUS HORIZONTAL CO		161	7 GAL., 18" O.C.	*
	CONOCARPUS ERECTUS 'SERICEUS' SILVER BUTTONWOOD HEDGE		24 5	3' HT., 18" O.C. 4' HT., 24" O.C.	*
	FICUS MICROCARPA GREEN ISLAND FICUS		18	3' X 3', SPHERE	
	HELICONIA SPP HELICONIA		50	15 GAL.	
	SALVIA AZUREA BLUE SALVIA		20	3 GAL., 12" O.C.	
	TRIPSACUM FLORIDANA DWARF FAKAHATCHEE GRASS		37	3 GAL., 18" O.C.	*
		TOTAL: NATIVE SPECIES:	345 227 (65.8%)		I



Grou	Groundcovers &		
SYMBOL/KEY	PLANT NAME	QTY.	DESC

SYMBOL/KEY	PLANT NAME	QTY.	DESCRIPTION	NATIVE
	FICUS MICROCARPA GREEN ISLAND FICUS	150	3 GAL., 12" O.C.	
	PHYLLA NODIFLORA FROG FRUIT	1,450	I GAL., 6" O.C.	*

TOTAL: NATIVE SPECIES:

Lawn & Mulch

AREA	PLANT NAME	QTY.	DESCRIPTION
LAWN	EMPIRE ZOYSIA LAWN	AS NEEDED	SOD PALLETS
MULCH	EUCALYPTUS MULCH	AS NEEDED	3" MIN. DEPTH

Native Landscape Legend


PROPERTY ADDRESS:	353 PERUVIAN AVENUE	
	REQUIRED	PROPOSED
LOT SIZE (SQ FT)	4,000 S.F. MIN.	12,504 S.F.
LANDSCAPE OPEN SPACE (LOS) (SQ FT AND %)	1,875.5 S.F. (15% MIN.)	2,088 S.F. (16.7%)
NATIVE TREES %	35%	97.4%
NATIVE PALMS %	35%	100%
NATIVE SHRUBS %	35%	65.8%
NATIVE VINES / GROUND COVER %	35%	90.6%

Ħ/B-22-016 (ZO/N-22-154)

1,600 1,450 (90.6%)

25 Description	NATIVE		JP Palm Beach, FI 33480 Mobile 561.313.4424 hitecture agement
3 GAL., 12" O.C.			
1 GAL., 6" O.C.	*		Ā
		JLØ	
		ach	_
DESCRIPTION		5 Peruvian Dalm Bee	
SOD PALLETS 3" MIN. DEPTH			
nd		N N N N]
POSED			<u>Ц</u>
00LD 04 S.F.			
S.F. (16.7%)			
4%			
0%			
8%			
.6%		DRAWN BY: Lau DATE: 05.0 05.3 08.0 10.0	2037.00 LA ren Freeman 9.2022 1.2022 8.2022 3.2022 4.2022 4.2023
		<u>_/HEET</u>	L6.1
-016 (ZO/N-2	2-154)		
Plant/cl			




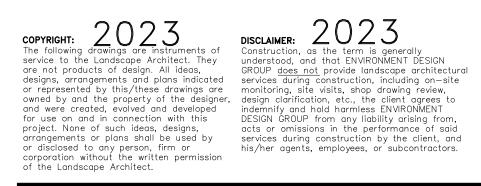








Rendered Landscape Plan Scale IN FEET O'

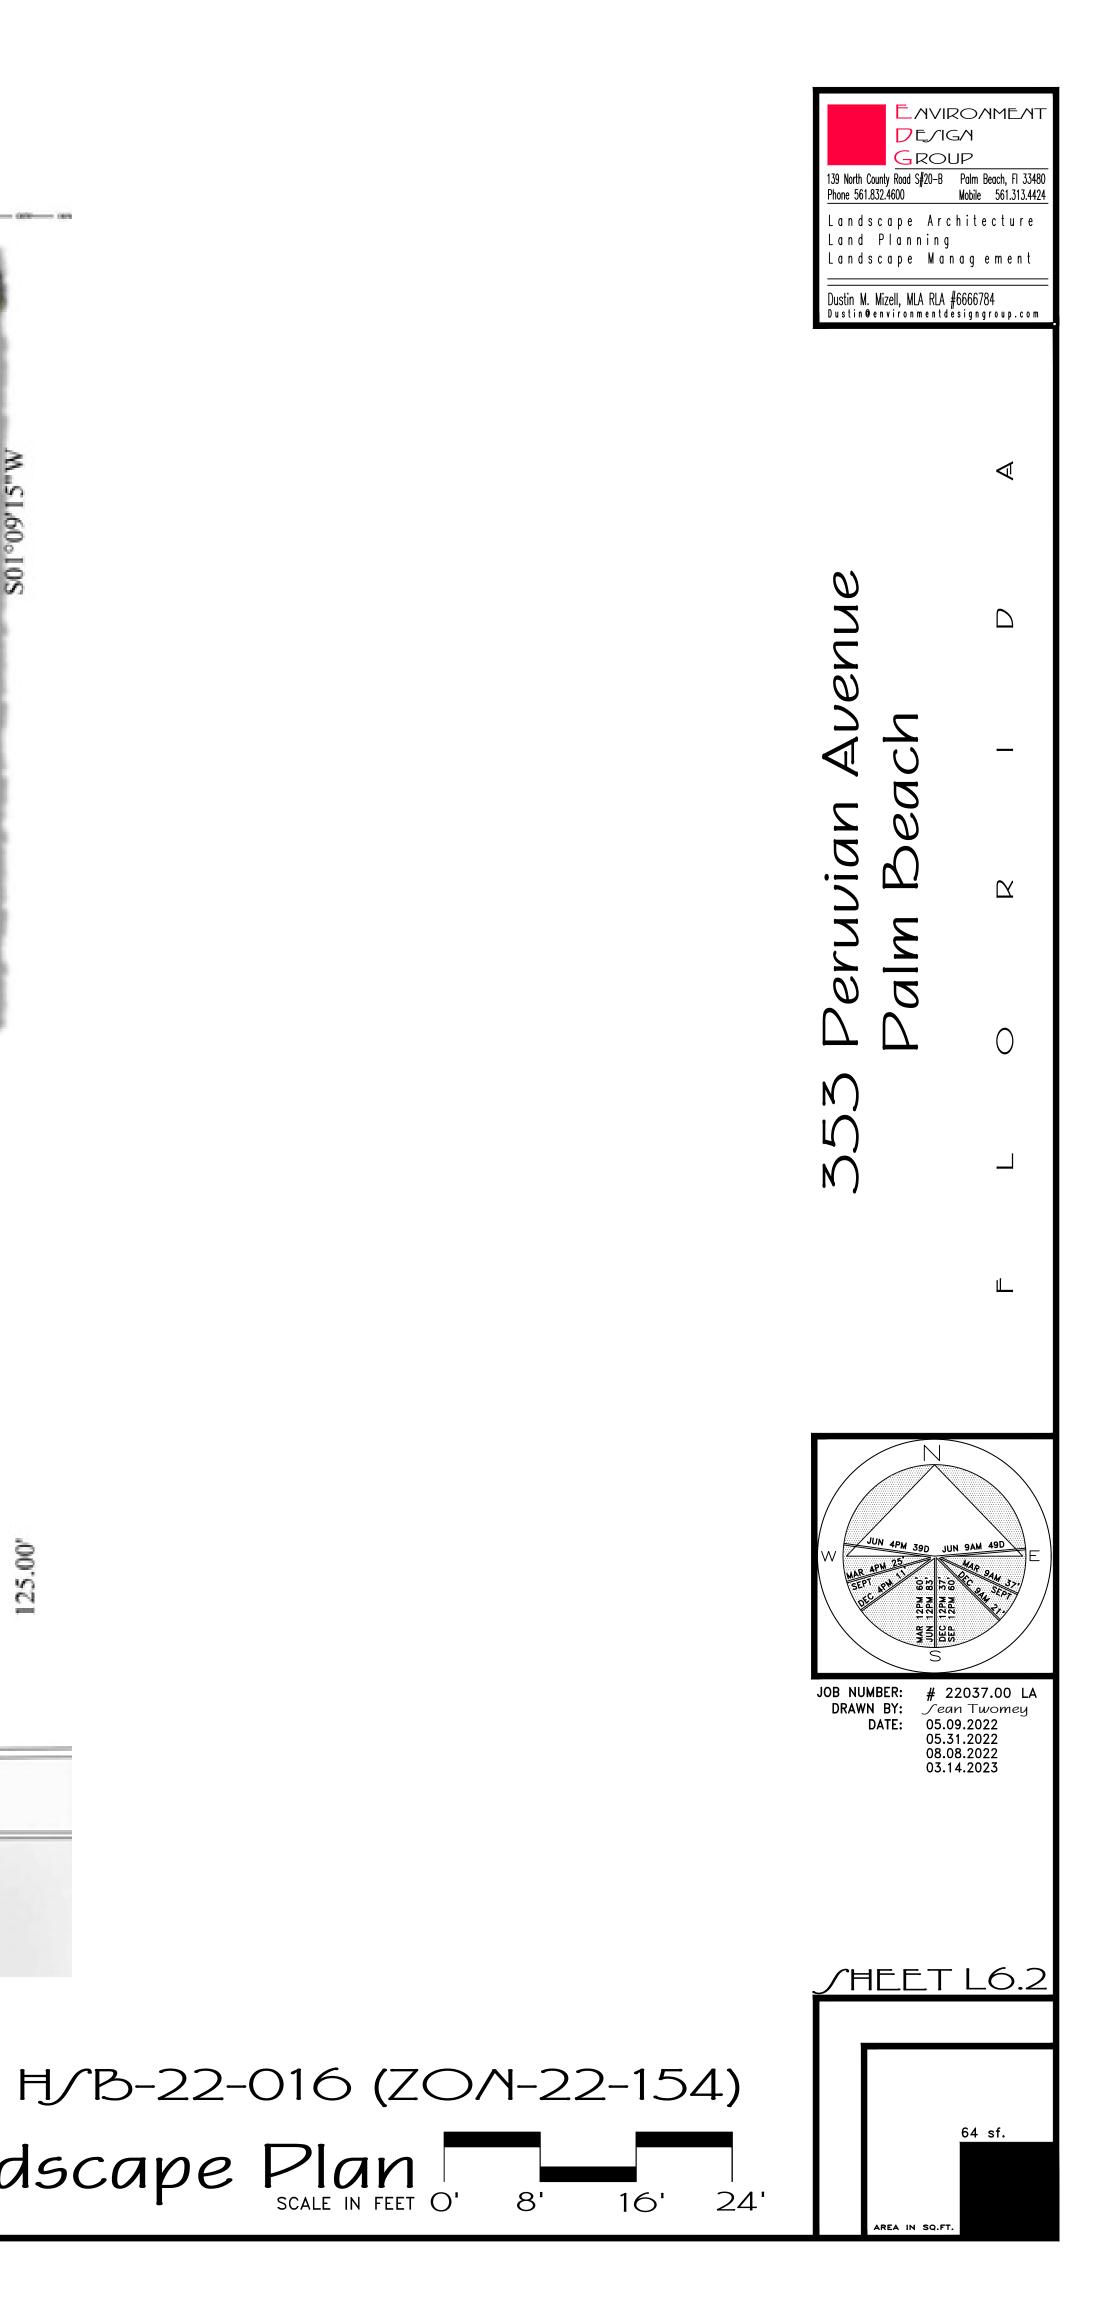

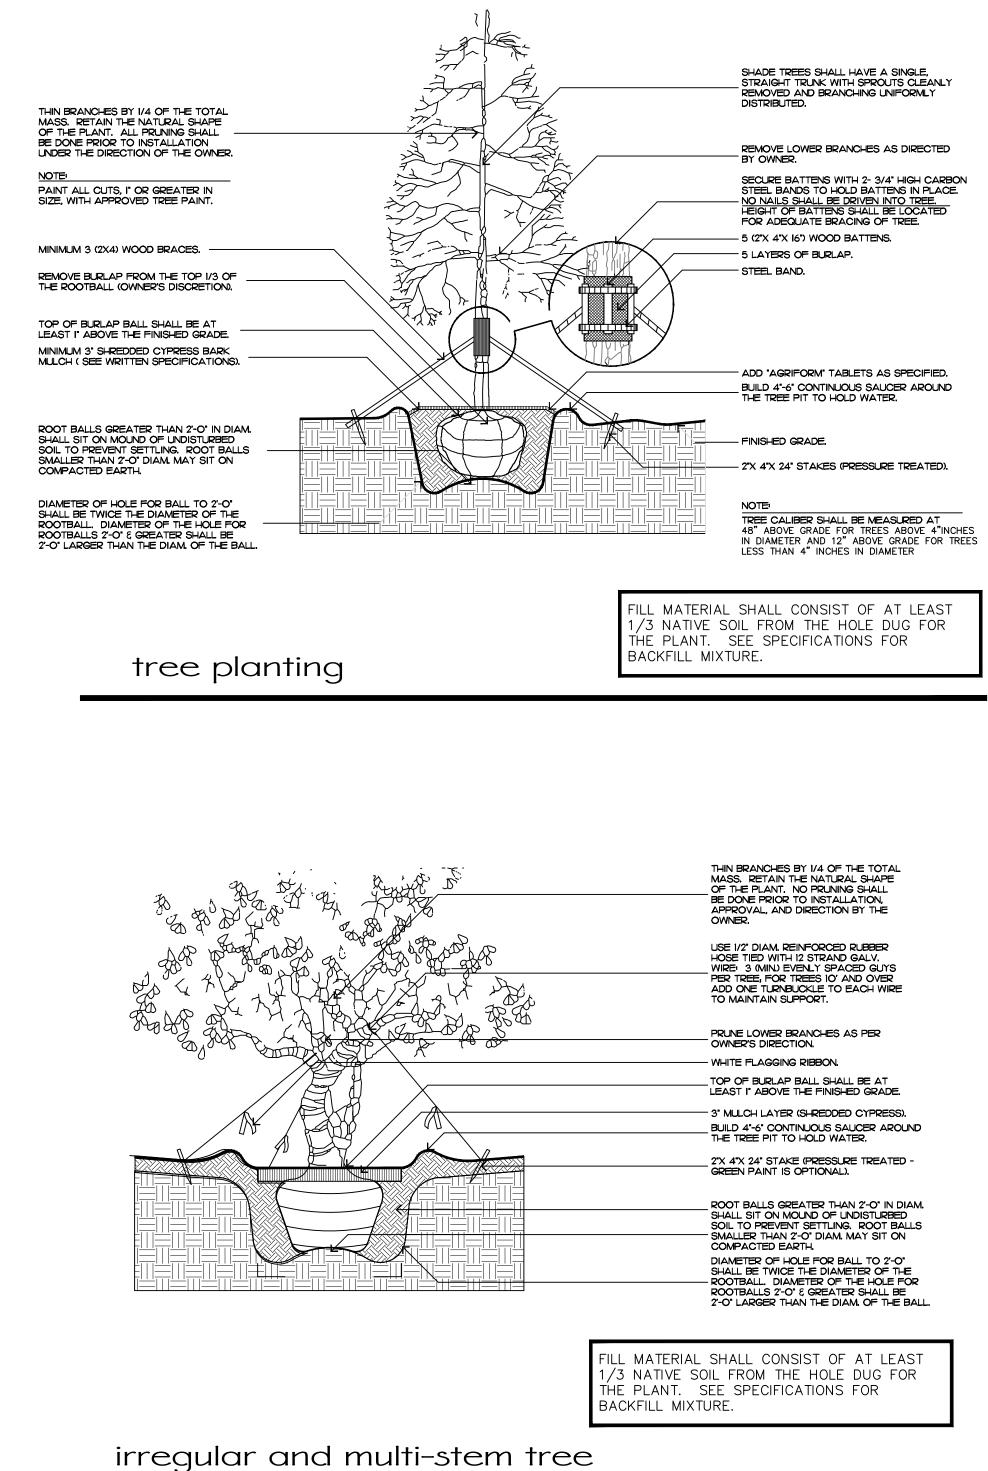

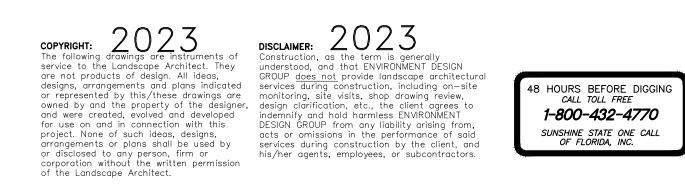

H/B-22-016 (ZON-22-154)Planting Details & Specifications

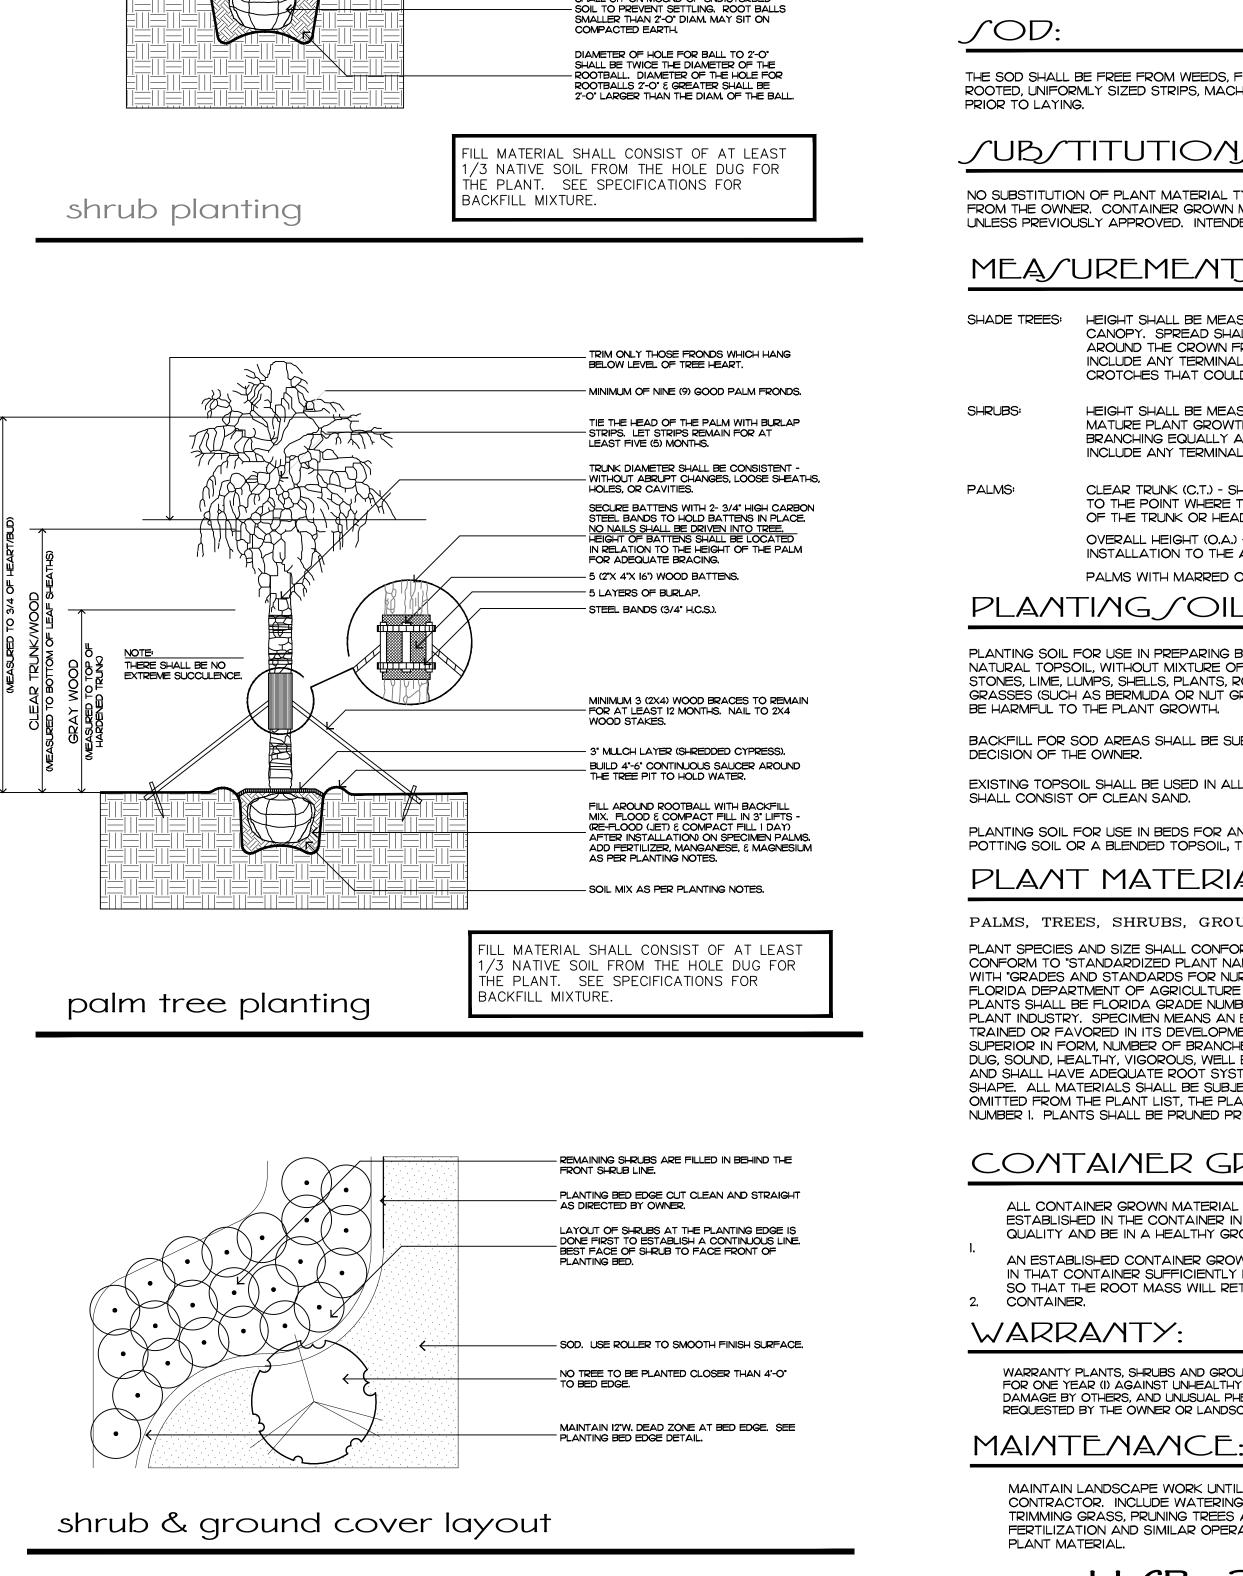

FERTILIZER SHALL BE APPLIED TO ALL SHRUBS (1/3 LB. PER 3 GAL. POT, 1/4 LB. PER 1 GAL. POT) AND GROUNDCOVER. THE SAME FERTILIZER MIXTURE SHALL BE USED ON SOD AT A RATE OF 15 LBS. PER 1000 SQUARE FEET. A FOURTEEN PERCENT (14%) NITROGEN, FOURTEEN PERCENT (14%) PHOSPHOROUS AND FOURTEEN PERCENT (14%) POTASSIUM IS REQUIRED ON ALL TREES AND SHRUBS OVER 5'-O" IN HEIGHT (1/2 LB. PER 5'-O" OF SPREAD). AGRIFORM TABLETS WITH TWENTY PERCENT (20%) NITROGEN, TEN PERCENT (10%) PHOSPHOROUS, FIVE PERCENT (5%) POTASSIUM IN 21 GRAM SIZES SHALL BE APPLIED ALONG WITH THE FERTILIZER PROCESS (I WITH I GAL. PLANTS, 2 WITH 3 GAL. PLANTS AND 2 TABLETS PER I" OF TREE TRUNK CALIPER), BACK FILL HALFWAY UP THE ROOT BALL, PLACE ABOUT ONE INCH (I") FROM ROOT TIPS. MAGNESIUM SULFATE SHALL BE APPLIED TO ALL PALMS AT INSTALLATION AT A RATE OF 1/2 LB. PER INCH OF TRUNK CALIPER. MANGANESE SHALL BE APPLIED AT THE SAME RATE.

MULCH:

IN PLANTING BEDS.

∫OD:

THE SOD SHALL BE FREE FROM WEEDS, FUNGUS, INSECTS AND DISEASES OF ANY KIND, CLEAN, STRONGLY ROOTED, UNIFORMLY SIZED STRIPS, MACHINE STRIPPED NOT MORE THAN TWENTY-FOUR (24) HOURS

JUB/TITUTION/:

NO SUBSTITUTION OF PLANT MATERIAL TYPES OR SIZES WILL BE ALLOWED WITHOUT WRITTEN AUTHORIZATION FROM THE OWNER. CONTAINER GROWN MATERIAL WILL NOT BE ACCEPTED AS SUBSTITUTE FOR BEB MATERIAL UNLESS PREVIOUSLY APPROVED. INTENDED SUBSTITUTIONS SHALL BE SPELLED OUT IN BID.

MEA/UREMENT/:

HEIGHT SHALL BE MEASURED FROM GROUND TO THE AVERAGE BRANCH HEIGHT OF CANOPY. SPREAD SHALL BE MEASURED TO THE END OF THE BRANCHING EQUALLY AROUND THE CROWN FROM THE CENTER OF THE TRUNK. MEASUREMENTS ARE NOT TO INCLUDE ANY TERMINAL GROWTH. SINGLE TRUNK TREES SHALL BE FREE OF "V" CROTCHES THAT COULD BE POINTS OF WEAK LIMB STRUCTURE OR DISEASE INFESTATION.

OF THE TRUNK OR HEAD. OVERALL HEIGHT (O.A.) - SHALL BE MEASURED FROM THE GROUND AT THE TIME OF INSTALLATION TO THE AVERAGE FROND HEIGHT. PALMS WITH MARRED OR BURNED TRUNKS WILL NOT BE ACCEPTED.

PLANTING / OIL AND BACKFILL:

FERTILIZER SHALL BE COMPLETELY ORGANIC, IT SHALL BE UNIFORM IN COMPOSITION, DRY AND FREE FLOWING. THIS FERTILIZER SHALL BE DELIVERED TO THE SITE IN THE ORIGINAL UNOPENED BAGS, EACH BEARING THE MANUFACTURER'S STATEMENT OF ANALYSIS, AND SHALL MEET THE FOLLOWING REQUIREMENTS: SIX PERCENT (6%) NITROGEN SIX PERCENT (6%) PHOSPHOROUS SIX PERCENT (6%) POTASSIUM

PRUNE SHRUBS AT OWNER'S DIRECTION.

PRUNE ALL SHRUBS TO ACHIEVE A

TOP OF BURLAP BALL SHALL BE AT LEAST I 1/2" ABOVE THE FIN. GRADE.

- 3" MULCH LAYER (SHREDDED CYPRESS).

THE TREE PIT TO HOLD WATER.

BUILD 4"-6" CONTINUOUS SAUCER AROUND

ROOT BALLS GREATER THAN 2'-O' IN DIAM. SHALL SIT ON MOUND OF UNDISTURBED

UNIFORM MASS

Planting Notes

COMMERCIAL FERTILIZER:

MULCH MATERIAL SHALL BE SHREDDED CYPRESS MULCH OR APPROVED EQUAL, MOISTENED AT THE TIME OF APPLICATION TO PREVENT WIND DISPLACEMENT. MULCH SHALL BE APPLIED TO A MINIMUM 3" DEPTH

HEIGHT SHALL BE MEASURED FROM THE GROUND TO THE AVERAGE POINT WHERE MATURE PLANT GROWTH STOPS. SPREAD SHALL BE MEASURED TO THE END OF BRANCHING EQUALLY AROUND THE SHRUB MASS. MEASUREMENT AREA NOT TO INCLUDE ANY TERMINAL GROWTH.

CLEAR TRUNK (C.T.) - SHALL BE MEASURED FROM THE GROUND AT TIME OF INSTALLATION TO THE POINT WHERE THE MATURE AGED TRUNK JOINS THE IMMATURE OR GREEN PORTION

PLANTING SOIL FOR USE IN PREPARING BACKFILL FOR PLANT PITS SHALL BE A FERTILE. FRIABLE AND NATURAL TOPSOIL, WITHOUT MIXTURE OF SUBSOIL MATERIALS, AND SHALL BE FREE FROM HEAVY CLAY STONES, LIME, LUMPS, SHELLS, PLANTS, ROOTS OR OTHER FOREIGN MATERIALS, WEEDS, OR NOXIOUS GRASSES (SUCH AS BERMUDA OR NUT GRASS). IT SHALL NOT CONTAIN TOXIC SUBSTANCES WHICH MAY

BACKFILL FOR SOD AREAS SHALL BE SUBJECT TO LESSER STANDARDS AT THE DISCRETION AND

EXISTING TOPSOIL SHALL BE USED IN ALL PLANT MATERIAL PITS EXCEPT SABAL PALMS WHERE THE SOIL

PLANTING SOIL FOR USE IN BEDS FOR ANNUALS AND/OR PERENNIALS SHALL CONTAIN ONE-THIRD (1/3) POTTING SOIL OR A BLENDED TOPSOIL, TILL INTO TOP 10" - 12" OF SOIL WITH A TIME-RELEASE FERTILIZER.

PLANT MATERIAL /:

PALMS, TREES, SHRUBS, GROUNDCOVERS AND VINES

PLANT SPECIES AND SIZE SHALL CONFORM TO THOSE INDICATED ON THE DRAWINGS. NOMENCLATURE SHALL CONFORM TO "STANDARDIZED PLANT NAMES", 1942 EDITION. ALL NURSERY STOCK SHALL BE IN ACCORDANCE WITH "GRADES AND STANDARDS FOR NURSERY PLANTS PARTS I & II", LATEST EDITION PUBLISHED BY THE FLORIDA DEPARTMENT OF AGRICULTURE AND CONSUMER SERVICES. UNLESS SPECIFIED OTHERWISE, ALL PLANTS SHALL BE FLORIDA GRADE NUMBER I OR BETTER AS DETERMINED BY THE FLORIDA DIVISION OF PLANT INDUSTRY. SPECIMEN MEANS AN EXCEPTIONALLY HEAVY, SYMMETRICAL TIGHTLY KNIT PLANT, SO TRAINED OR FAVORED IN ITS DEVELOPMENT THAT FIRST APPEARANCE IS UNQUESTIONABLE AND OUTSTANDINGLY SUPERIOR IN FORM, NUMBER OF BRANCHES, COMPACTNESS AND SYMMETRY. ALL PLANTS SHALL BE FRESHLY DUG, SOUND, HEALTHY, VIGOROUS, WELL BRANCHED AND FREE OF DISEASE AND INSECT EGGS AND LARVAE AND SHALL HAVE ADEQUATE ROOT SYSTEMS. TREES FOR PLANTING ROWS SHALL BE UNIFORM IN SIZE AND SHAPE. ALL MATERIALS SHALL BE SUBJECT TO APPROVAL BY THE OWNER. WHERE REQUIREMENTS ARE OMITTED FROM THE PLANT LIST, THE PLANTS FURNISHED SHALL BE NORMAL FOR THE VARIETY AND FLORIDA NUMBER I. PLANTS SHALL BE PRUNED PRIOR TO DELIVERY ONLY UPON THE APPROVAL OF THE OWNER.

CONTAINER GROWN STOCK:


ALL CONTAINER GROWN MATERIAL SHALL BE HEALTHY, VIGOROUS, WELL-ROOTED PLANTS AND ESTABLISHED IN THE CONTAINER IN WHICH THEY ARE SOLD. THE PLANTS SHALL HAVE TOPS OF GOOD QUALITY AND BE IN A HEALTHY GROWING CONDITION.

AN ESTABLISHED CONTAINER GROWN PLANT SHALL BE TRANSPLANTED INTO A CONTAINER AND GROWN IN THAT CONTAINER SUFFICIENTLY LONG ENOUGH FOR THE NEW FIBROUS ROOTS TO HAVE DEVELOPED SO THAT THE ROOT MASS WILL RETAIN ITS SHAPE AND HOLD TOGETHER WHEN REMOVED FROM THE

WARRANTY PLANTS, SHRUBS AND GROUNDCOVERS FOR A PERIOD OF NINETY (90) DAYS: TREES ξ PALMS FOR ONE YEAR (I) AGAINST UNHEALTHY CONDITION, EXCEPT AS MAY RESULT FROM NEGLECT BY OWNER, DAMAGE BY OTHERS, AND UNUSUAL PHENOMENA BEYOND INSTALLER'S CONTROL. REPLACE AT TIME REQUESTED BY THE OWNER OR LANDSCAPE ARCHITECT.

MAINTAIN LANDSCAPE WORK UNTIL THE LETTER OF SUBSTANTIAL COMPLETION BY THE GENERAL CONTRACTOR. INCLUDE WATERING, WEEDING, CULTIVATING, RESTORATION OF GRADE, MOWING AND TRIMMING GRASS, PRUNING TREES AND SHRUBS, PROTECTION FROM INSECTS AND DISEASES, FERTILIZATION AND SIMILAR OPERATIONS AS NEEDED TO ENSURE NORMAL GOOD HEALTH FOR LIVE

DE/IG GROU 139 North County Road S#20-B Phone 561.832.4600 Landscape Arch Land Planning Landscape Man	Landscape Architecture		
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Peruvian Ave Palm Beach	Ľ		
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JOB NUMBER: # 22037.00 LA DRAWN BY: Dustin Mizell DATE: 05.09.2022 05.31.2022 08.08.2022 10.03.2022 10.24.2022 03.14.2023			
<u>/HEET</u>	L6.3		

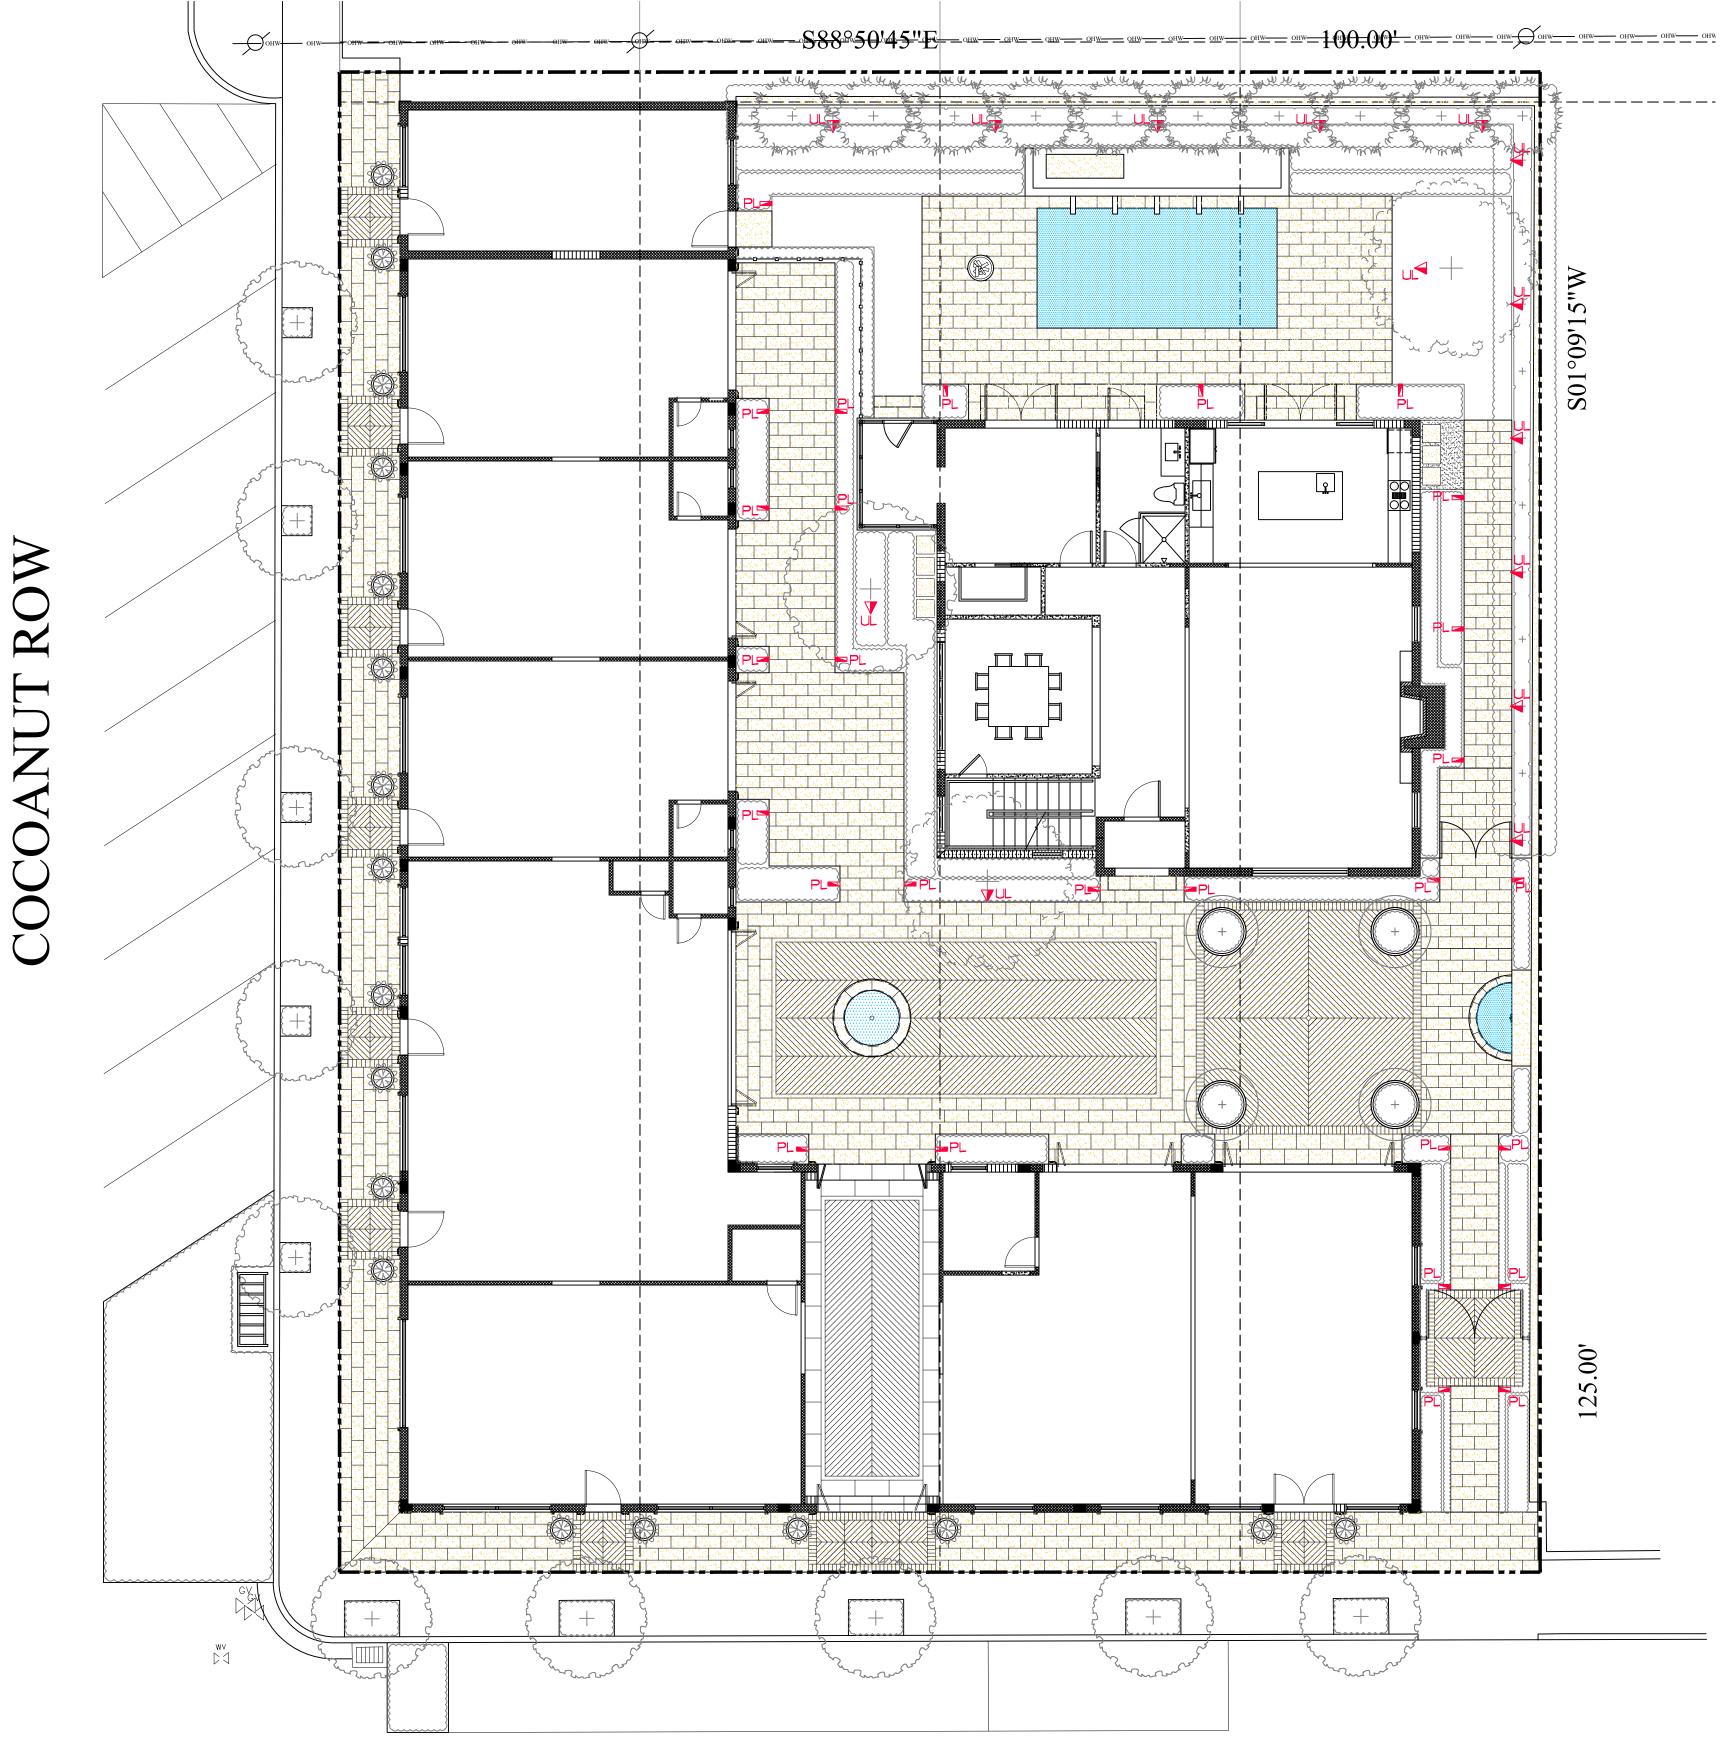





PL

<u>PATH LIGHT</u> - BEGA - GARDEN E BRONZE - 4.2 WATTS - LED 300 <u>UP LIGHT</u> - BEGA - GARDEN FL SPIKE - BRONZE - 3.0 WATTS -




PATH LIGHT

PERUVIAN AVENUE

Landscape Lighting Plan Scale IN FEET O'

	QTY.
BOLLARD OOK	28
-OOD LIGHT WITH EARTH - LED 3000K	14

UP LIGHT

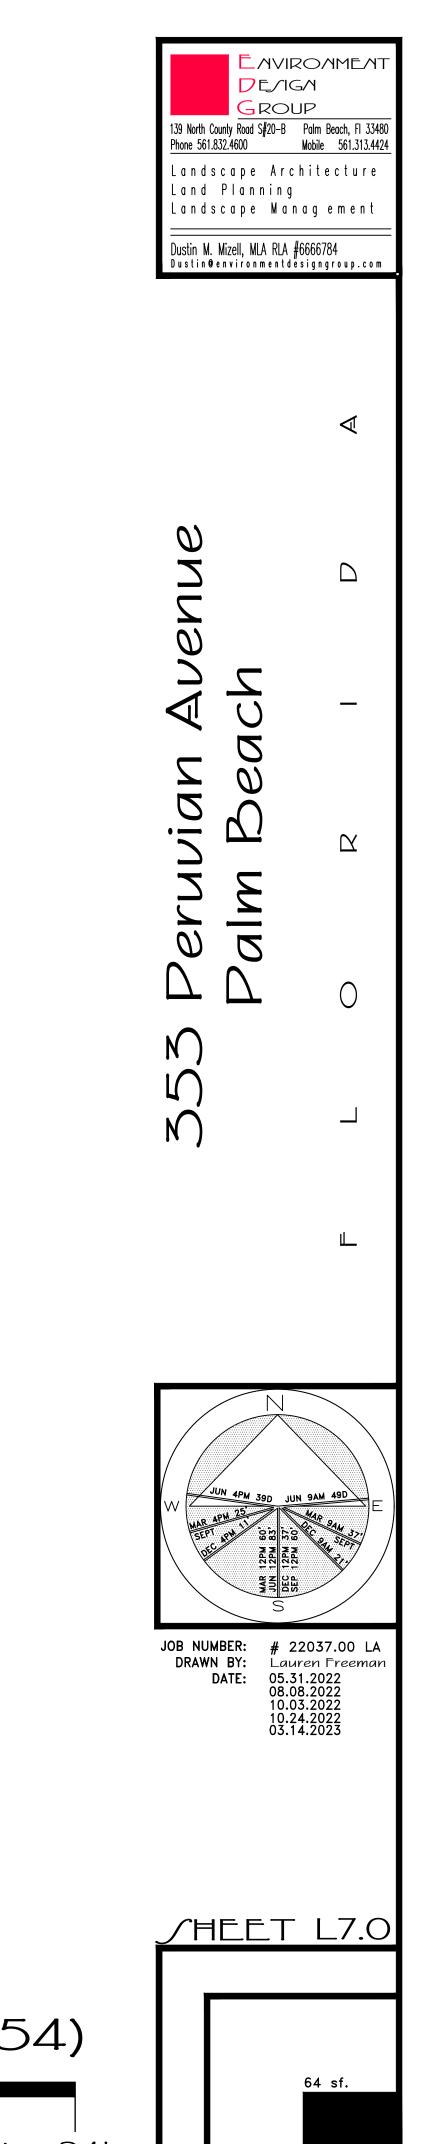

AREA IN SQ.FT.



