

HVAC PLANS

FLOOR FRAMING PLAN

ROOF FRAMING PLAN

EXIST. FRONT PORCH

TOTAL

140 S.F.

3360 S.F.

BUILDING TYPE

TYPE OF CONSTRUCTION:

LEVEL OF ALTERATION 2

TYPE VB

OCCUPANCY TYPE-R-3: RESIDENTIAL- 2 STORY

DEMOLITION NOTES

CONDITIONS AND REQUIREMENTS:
THE DEMOLITION CONTRACTOR SHALL OBTAIN ALL PERMITS REQUIRED FOR HAULING AND LEGALLY DISPOSING OF MATERIALS REMOVED IN MATERIALS REMOVED IN DEMOLITION WORK

- PROCEDURES: THE PROCEDURES PROPOSED FOR THE ACCOMPLISHMENT OF SALVAGE & DEMOLITION WORK SHALL PROVIDE FOR SAFE CONDUCT OF WORK CAREFUL REMOVAL AND DISPOSITION OF MATERIALS, PROTECTION OF PROPERTY, COORDINATION WITH WORK OF OTHERS IN PROGRESS, AND TIMELY DISCONNECTION OF UTILITY SERVICES. THE PROCEDURES SHALL INCLUDE A DETAILED DESCRIPTION OF METHODS AND EQUIPMENT TO BE USED FOR EACH OPERATION.
- PARTITION: REMOVE ALL EXISTING INTERIOR PARTITIONS AND RELATED UTILITIES AS INDICATED IN THE DEMOLITION PLAN.
- DUST CONTROL: THE AMOUNT OF DUST RESULTING FROM DEMOLITION SHALL BE CONTROLLED TO PREVENT THE SPREAD OF DUST TO AVOID CREATION OF A NUISANCE IN THE SURROUNDING AREA. USE OF WATER WILL NOT BE PERMITTED WHEN IT WILL RESULT IN, OR CREATE HAZARDOUS OR OBJECTIONABLE CONDITIONS SUCH AS FLOODING.
- PROTECTION OF EXISTING BUILDING: A. EXISTING BUILDING SHALL BE PROTECTED FROM DAMAGE. ANY PART DAMAGED BY THE CONTRACTOR SHALL BE REPAIRED TO MATCH EXISTING CONDITIONS AT CONTRACTOR'S EXPENSE.
- B. COVER ITEMS AS NECESSARY TO PROTECT FROM DUST.
- C. AT END OF EACH WORK DAY, CLOSE OFF AREAS FROM PUBLIC. D. DEMOLITION CONTRACTOR SHALL PROVIDE AND MAINTAIN NECESSARY BARRICADES TO PREVENT SPILLAGE ON ANY UNAUTHORIZED PERSONS FROM ACCIDENTALLY OR INTENTIONALLY ENTERING THE AREA OF WORK.
- . ENVIRONMENTAL PROTECTION: ALL WORK AND CONTRACT OPERATIONS SHALL COMPLY WITH ALL REQUIREMENTS OF STATE AND BROWARD COUNTY ENVIRONMENTAL PROTECTION REGULATIONS. WHEN IT WILL RESULT IN, OR CREATE HAZARDOUS OR OBJECTIONABLE CONDITIONS SUCH AS FLOODING.

DISPOSING OF MATERIAL A. TITLE TO MATERIALS:

AFTER NOTICE TO PROCEED.

TITLE TO ALL MATERIAL AND EQUIPMENT TO BE DEMOLISHED AND REMOVED EXCEPT ITEMS INDICATED TO BE TURNED OVER TO THE OWNER IS VESTED IN THE CONTRACTOR AT START OF PROJECT THE OWNER WILL NOT BE RESPONSIBLE FOR THE CONDITIONS, LOSS, OR DAMAGE TO SUCH PROPERTY

B. DEBRIS CONTROL: REMOVE AND TRANSPORT DEBRIS IN LEAK-FREE CONTAINERS IN A MANNER TO PREVENT SPILLAGE ON ANY PART OF EXISTING BUILDING, PARKING LOT AREAS, OR CITY STREETS.

C. REGULATIONS: COMPLY WITH COUNTY, MUNICIPALITY, AND CITY REGULATIONS REGARDING HAULING AND DISPOSAL OF DEBRIS. ALL SUCH MATERIAL SHALL BE DISPOSED OF OFF SITE IN A LEGAL DISPOSAL AREA.

PREPARATION:

A. PROVIDE ADEQUATE TEMPORARY SUPPORT AS NECESSARY TO ASSURE STRUCTURAL VALUE OR INTEGRITY OF AFFECTED PORTION OF PROJECT FROM DAMAGE. B. PROVIDE DEVICES AND METHODS TO PROTECT OTHER

C. PROVIDE PROTECTION FROM ELEMENTS FOR THAT PORTION OF THE PROJECT WHICH MAY BE EXPOSED BY CUTTING, PATCHING WORK, PAINTING, APPLY SHEEROCK, FUMES, DUST, & NOISE.

PERFORMANCE:

PORTIONS OF PROJECT FROM DAMAGE.

A. EXECUTE CUTTING AND DEMOLITION BY METHODS WHICH WILL PREVENT DAMAGE TO OTHER WORK, AND WHICH WILL PROVIDE PROPER SURFACES TO RECEIVE INSTALLATION OF REPAIRS. POOL DECK CUTTING W/. NO SLAB DAMAGE B. EXECUTE FITTING AND ADJUSTMENT OF PRODUCTS TO PROVIDE A FINISHED INSTALLATION TO COMPLY WITH SPECIFIED PRODUCTS, FUNCTION, TOLERANCE AND FINISHES. C. RESTORE WORK WHICH HAS BEEN CUT OR REMOVED. INSTALL NEW PRODUCTS TO PROVIDE COMPLETED WORK IN ACCORD WITH REQUIREMENTS THROUGH DOCUMENTS.

D. FIT WORK AIR—TIGHT TO PIPES, SLEEVES, DUCTS, CONDUIT AND OTHER PENETRATIONS THROUGH SURFACES. E. REFINISH ENTIRE SURFACES AS NECESSARY TO PROVIDE AN EVEN FINISH TO MATCH ADJACENT FINISHES.

SUBJECT TO COMPLIANCE WITH ALL CODES AND ORDINANCES IN EFFECT IN THE TOWN OF PALM BEACH, FLORIDA

SCOPE OF WORK

INTERIOR DEMO OF ALL DRYWALL ,MECHANICAL AND ELECTRIC REMOVE ROOF FRAMING SHOWN O A7 & REPLACE W/TRUSSES REMOVE ALL BATHROOM AND KITCHEN FIXTURES

REMOVE WINDOWS AND DOORS SHOWN ON PLAN

RECEIVED FEB 0 2 2016

TOWN OF PALM BEACH PZB DEPT

WIND SPËED = 170 MPH EXPOSURE D

REVIEWED APR 0 4/2016

BUILDING CATEGORY- II Kd=0.85 FOR MWFRS WITH LOAD FACTORS MEAN ROOF HEIGHT IS 25'-0"

DESIGN CRITERIA

ALL STRUCTURAL ELEMENTS, EXPOSED TO WIND, HAVE BEEN DESIGNED PER THE GUIDELINES OF THE ASCE 7-10 BUILDING CODE WITH THE FOLLOWING DESIGN VALUES: FBC 2014

IMPORTANCE FACTOR = 1.00

PERMITB'1652289

CARL G. FORBES

REVISIONS BY


DRAWN BY: CARLOS VILACA 300 RIOMAR DRIVE PORT SAINT LUCIE FLA PHONE: 561- 445- 9661 EMAIL: carlosvilaca2@gmail.c


1-27-16

 $1/4^{\circ} = 1-0^{\circ}$

911-360 **SEASPRAY**

SHEET

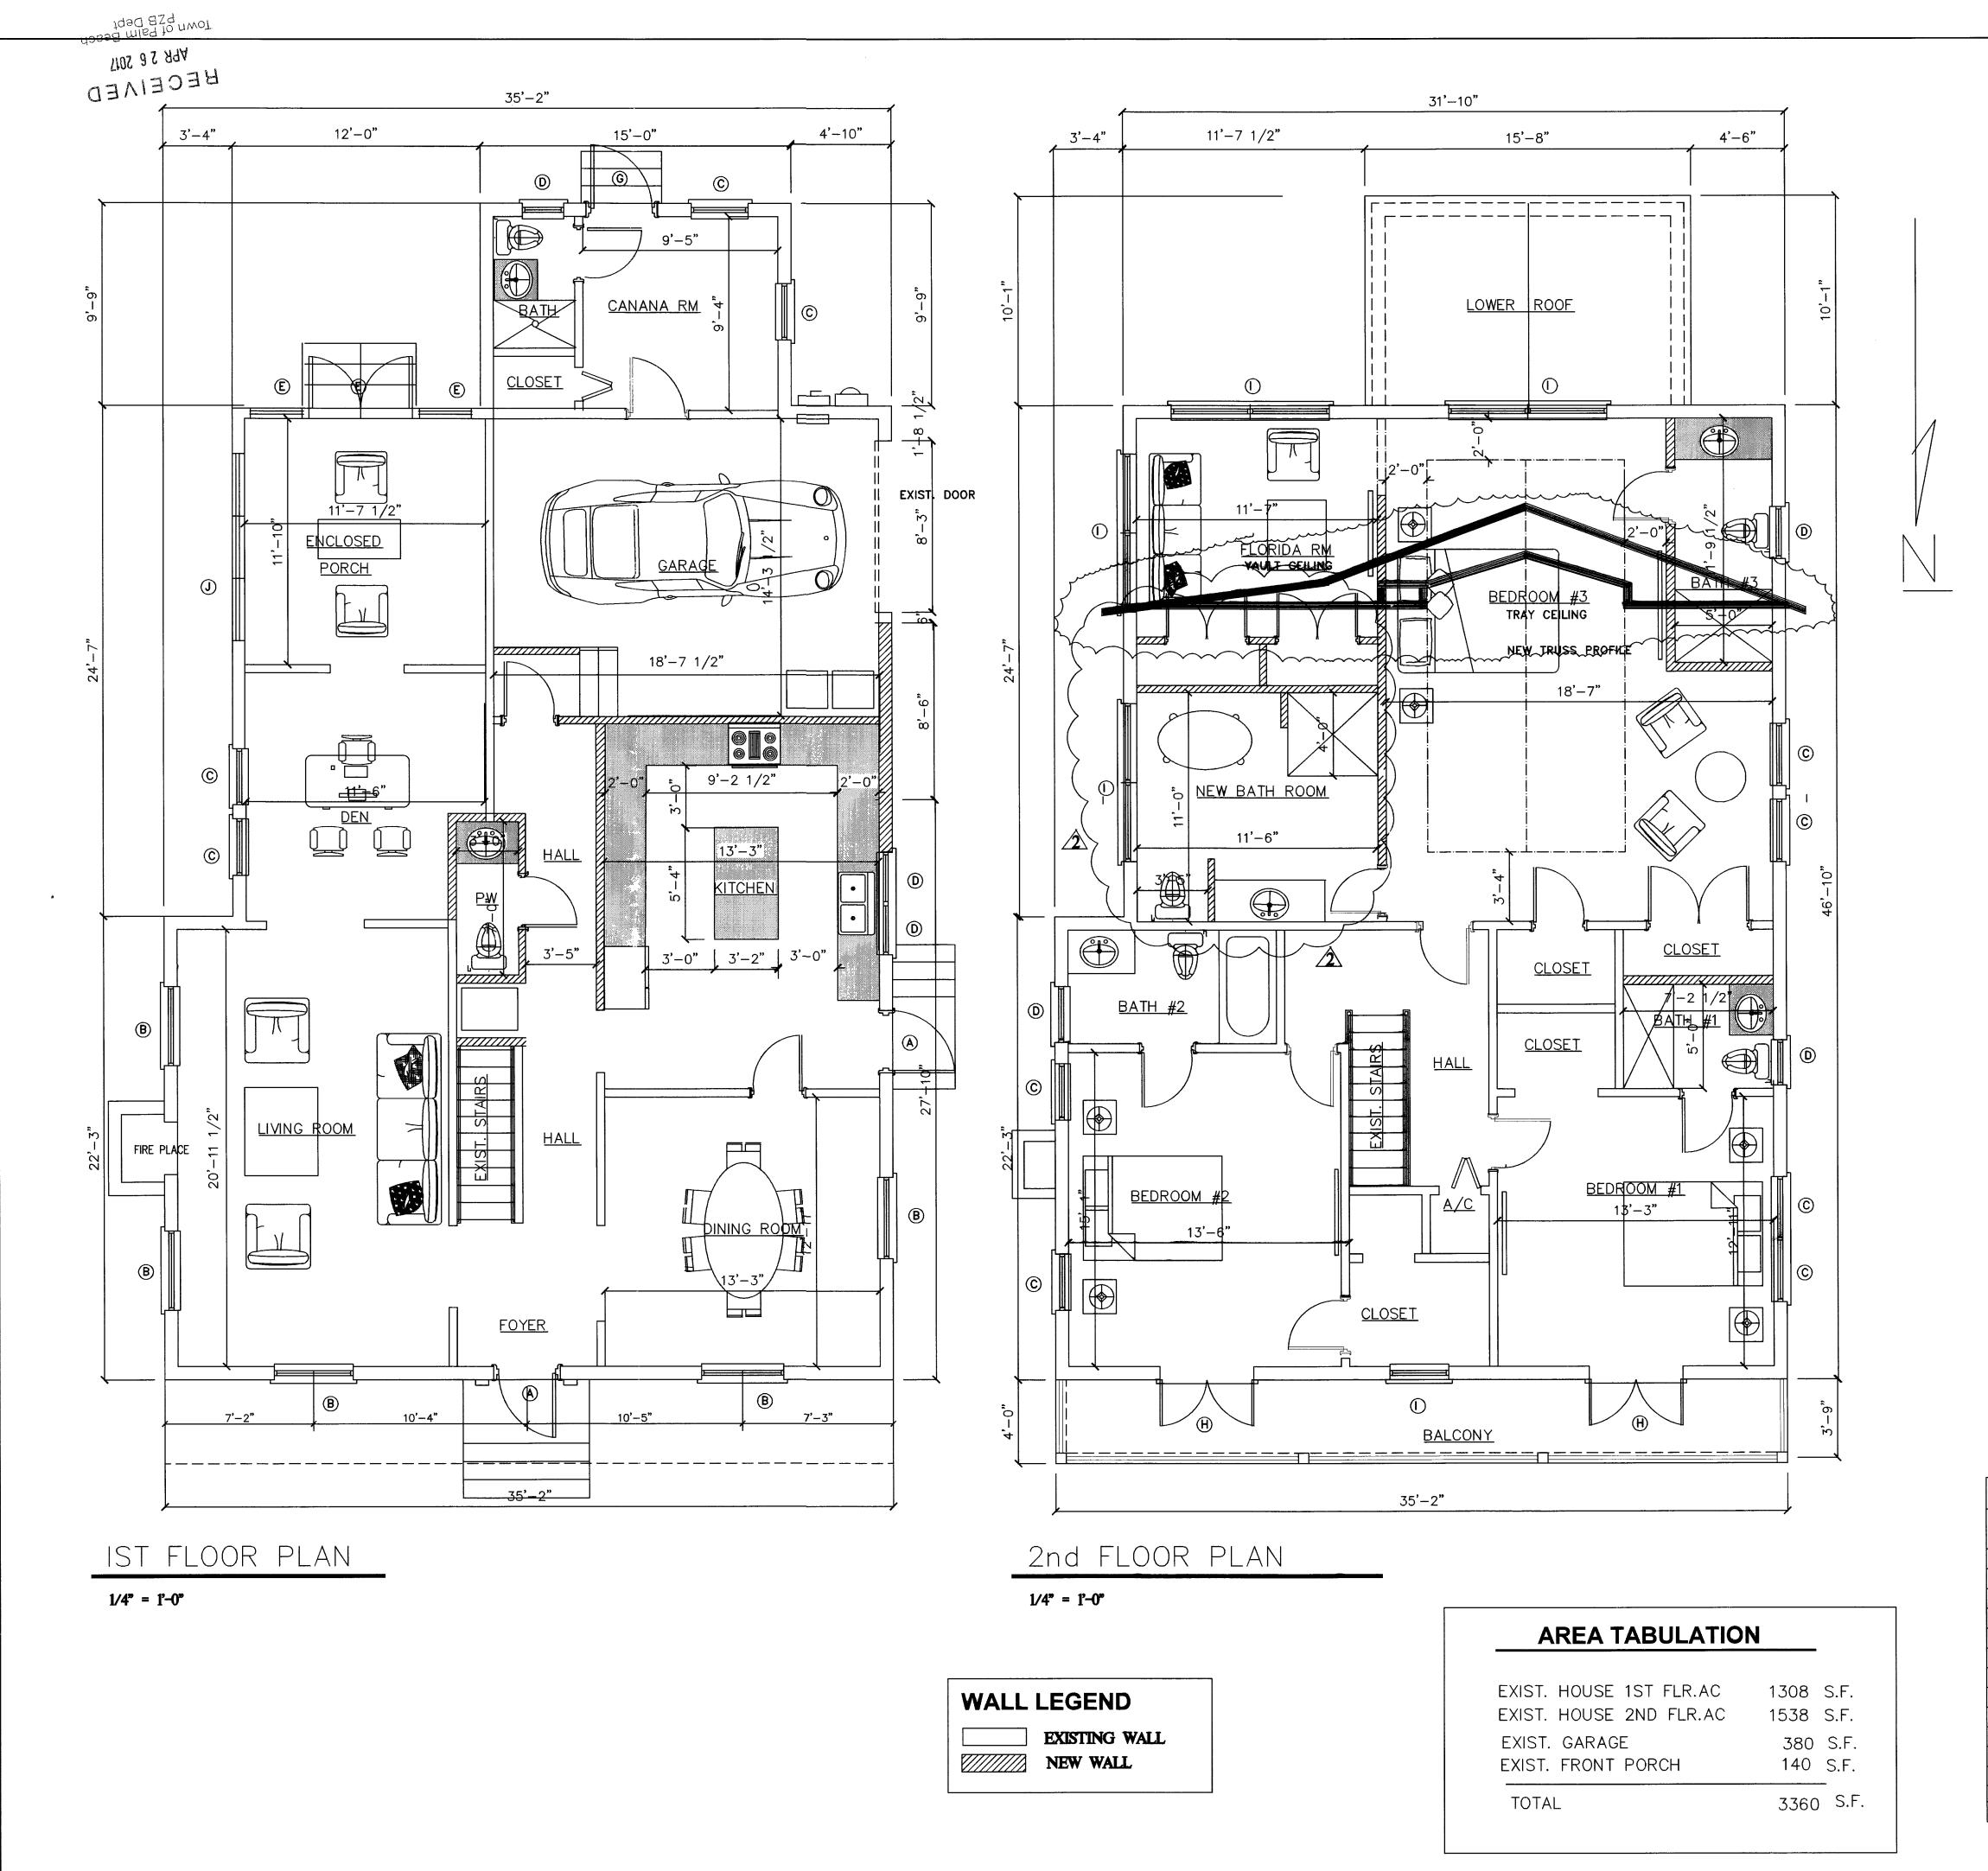

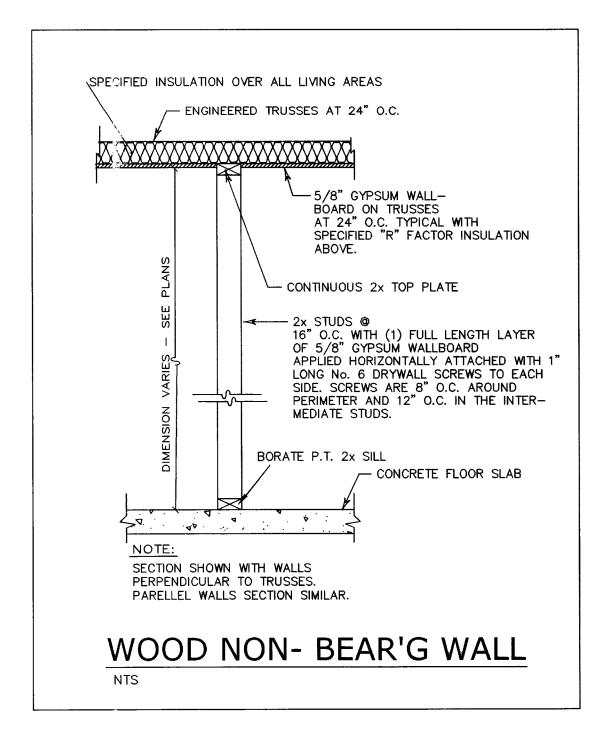

GENERAL NOTES

THE CONTRACTOR SHALL COORDINATE ALL OF THE WORK OF ALL TRADES. THE CCNTRACTOR SHALL REVIEW THE DRAWINGS IN THEIR ENTIRETY BEFORE STARTING WORK AND SHALL ACCEPT FULL RESPONSIBILITY FOR ANY ERRORS OR OMISSIONS NOT REPORTED IMMEDIATELY IN WRITING TO THE ENGINEER. BACKCHARGES WILL NOT BE ACCEPTED.

DO NOT SCALE DRAWINGS SUBMIT A MINIMUM OF THREE (3) COPIES OF SHOP DRAWINGS FOR FLOOR AND ROOF SYSTEMS FOR REVIEW AND APPROVAL BY THE ENGINEER'S PRIOR

THESE PLANS, AS DRAWN AND NOTED, COMPLY WITH THE BUILDING ENVELOPE ENERGY REQUIREMENTS OF THE FLORIDA ENERGY CODE FOR BUILDING CONSTRUCTION INCORPORATED AS CHAPTER 13 OF THE FLORIDA BUILDING CODE.

THE CC TRACTOR SHALL FAMILIARIZE HIMSELF WITH THE GOVERNING CODE IN ITS ENTIRETY. THE CONTRACTOR IS RESPONSIBLE FOR ADEQUATE BRACING OF STRUCTURAL OR NCH-STRUCTURAL MEMBERS DURING CONSTRUCTION. THE WINDOW AND DOOR SUPPLIER, AND CABINET SUPPLIER SHALL

PROVIDE SHOP DRAWINGS TO THE CONTRACTOR. ALL WINDOWS AND DOORS SHALL BE CAULKED AND WEATHER STRIPPED. PROVIDE METAL THRESHOLD AT ALL EXTERIOR DOORS AND AT DOOR BETWEEN GARAGE AND LIVING AREA. PROVIDE NOMINAL 1 X 3 P.T. FIRESTOPPING HORIZONTAL AT CEILING &

WALL INTERSECTIONS. WINDOW UNITS SHALL DISPLAY LABELS SHOWING COMPLIANCE WITH THE FLORIDA ENERGY EFFICIENCY CODE FOR BUILDING CONSTRUCTION. GLAZING IN SWING DOORS AND FIXED AND SLIDING PANELS OF SLIDING

GLASS DOORS SHALL BE TEMPERED GLAZING IN DOORS AND WALLS OF ENCLOSURES FOR TUBS AND SHOWERS OR MIRRORS LOCATED WITHIN 36" HORIZONTALLY AND 60" VERTICALLY FROM THE WALKING SURFACE SHALL BE TEMPERED

GLAZING IN SIDELITES LOCATED WITHIN 48" OF THE DOOR AND WHOSE BOTTOM EDGE IS LESS THAN 60" ABOVE THE FLOOR SHALL BE TEMPERED.

ALL BATHROOM FLOORS AND WALLS SHALL BE OF APPROVED IMPERVIOUS

EGRESS WINDOWS SHALL PROVIDE A CLEAR OPENING OF NOT LESS THAN 20" IN WIDTH AND 24" IN HEIGHT AND 5.7 SQ. FT. IN AREA MINIMUM. THE SILL HEIGHT SHALL NOT BE MORE THAN 44" ABOVE THE FLOOR LATCHING DEVICES TO BE LESS THAN 54"

ALL WORK MUST CONFORM TO THE 5TH EDITION (2014)

FLORIDA BUILDING CODE

REVIEWED

Fig Dept

B-17-63584

		V	VINDOW /	DOOR	SCHEDULE		
NO.	DESCRIPTION						ŖESSURES
	W	Н	TYPE	MAT.	GLASS	POS	NEV
A	36"	80"	DOOR	FIBERGLASS	IMPACT RESISTANT	+39	-42
B	48"	63"	SINGLE HUNG	ALUMINUM	IMPACT RESISTANT	+45	
©	37"	63"	SINGLE HUNG EGRESS	ALUMINUM	IMPACT RESISTANT	+44	-47
(D)	24"	50"	SINGLE HUNG	ALUMINUM	IMPACT RESISTANT	+47	_51
E	5'	80"	FRENCH DOORS	ALUMINUM	IMPACT RESISTANT	+41	-44
Ē	60"	80"	DBL. 30" FRENCH DOORS	ALUMINUM	IMPACT RESISTANT	+45	-49
©	30"	80"	FRENCH DOOR	ALUMINUM	IMPACT RESISTANT	+43	-46
Θ	54"	80"	DBL. 27 FRENCH DOORS	ALUMINUM	IMPACT RESISTANT	+48	-50
0	100"	63"	2-50" SINGLE HUNG	ALUMINUM	IMPACT RESISTANT	+43	-46
(5)	108"	63	3 PANEL HOR. ROLLER	ALUMINUM	IMPACT RESISTANT	+39	-42
						-	

VERIFY WINDOW/DOORS SIZES WITH FIELD MEASUREMENTS
RECEIVED OFFICE COPY SUBJECT TO COMPLIANCE WITH APR 2 6 2017 ALL CODES AND ORDINANCES

IN EFFECT IN THE TOWN OF


PALM BEACH, FLORIDA


REVISIONS BY REAR GABLE CV 3-14-16 ADDED BATH RM CV 4-19-17


CARL G. FORBES


CARLOS VILACA 300 RIOMAR DRIVE PORT SAINT LUCIE FLA PHONE: 561- 445- 9661 EMAIL: carlosvilaca2@gmail.com 1-27-16


 $1/4^{\circ} = 1'-0^{\circ}$ 911-360 SEASPRAY

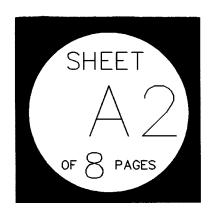


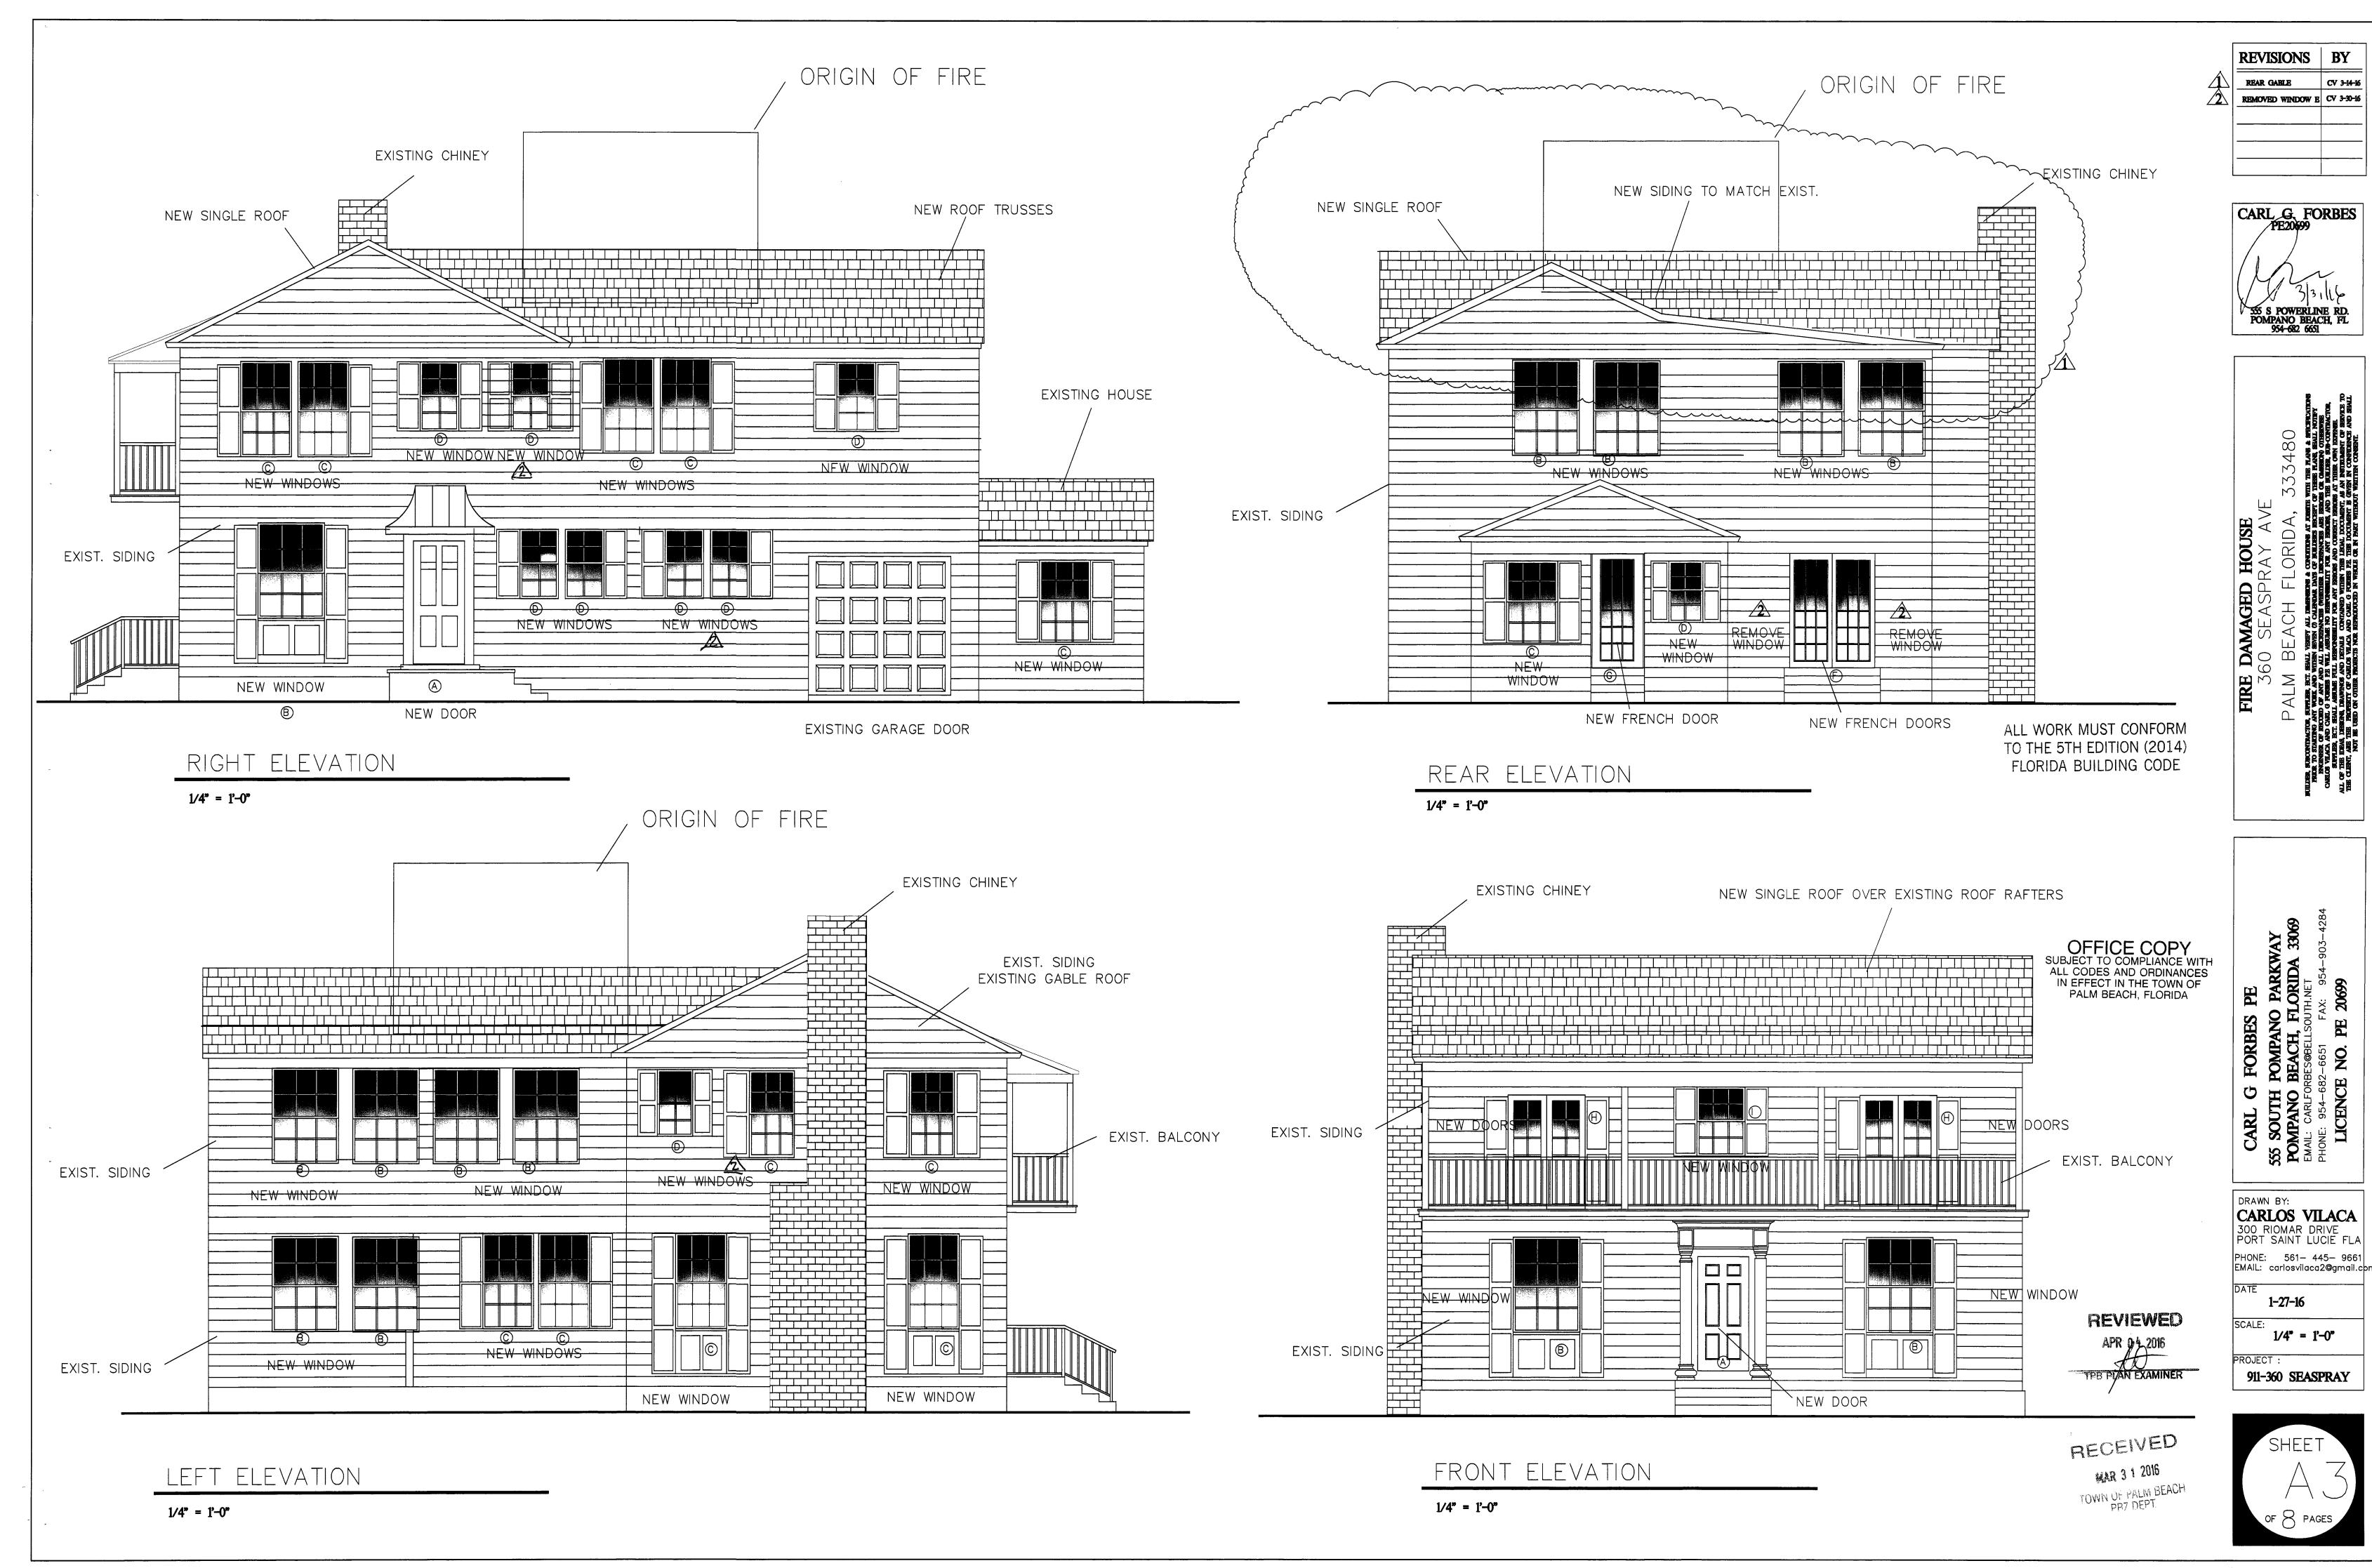


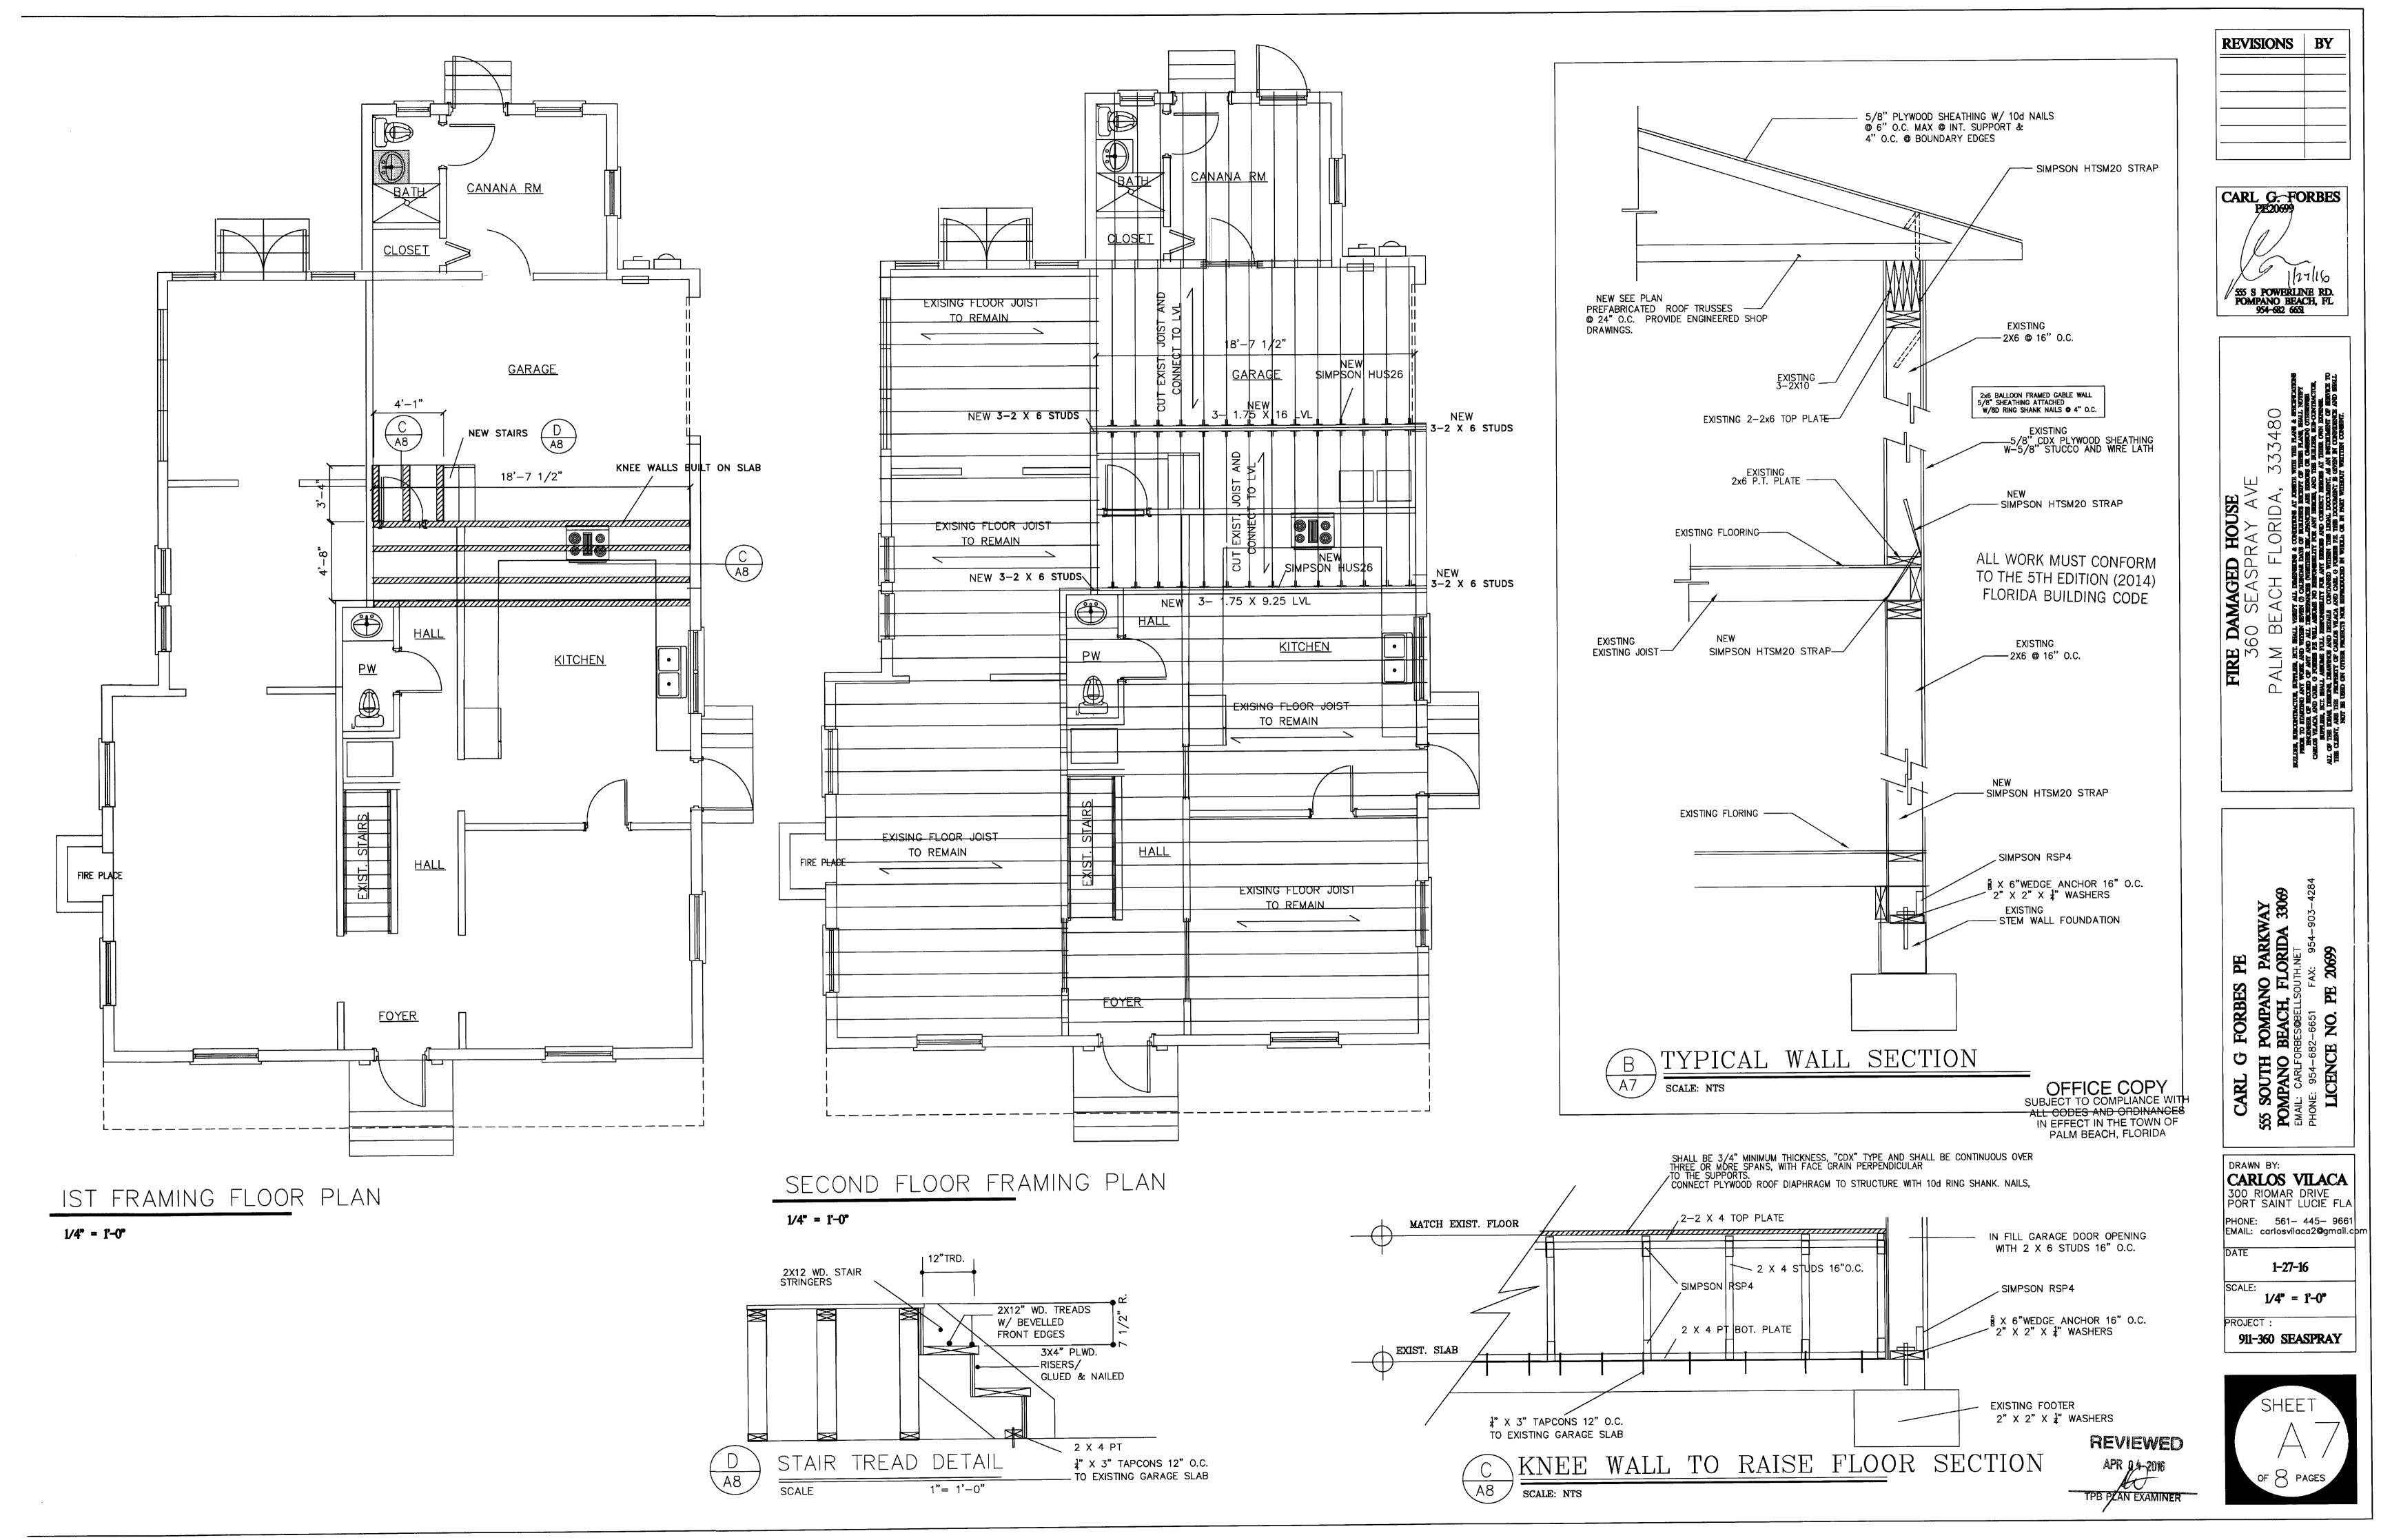


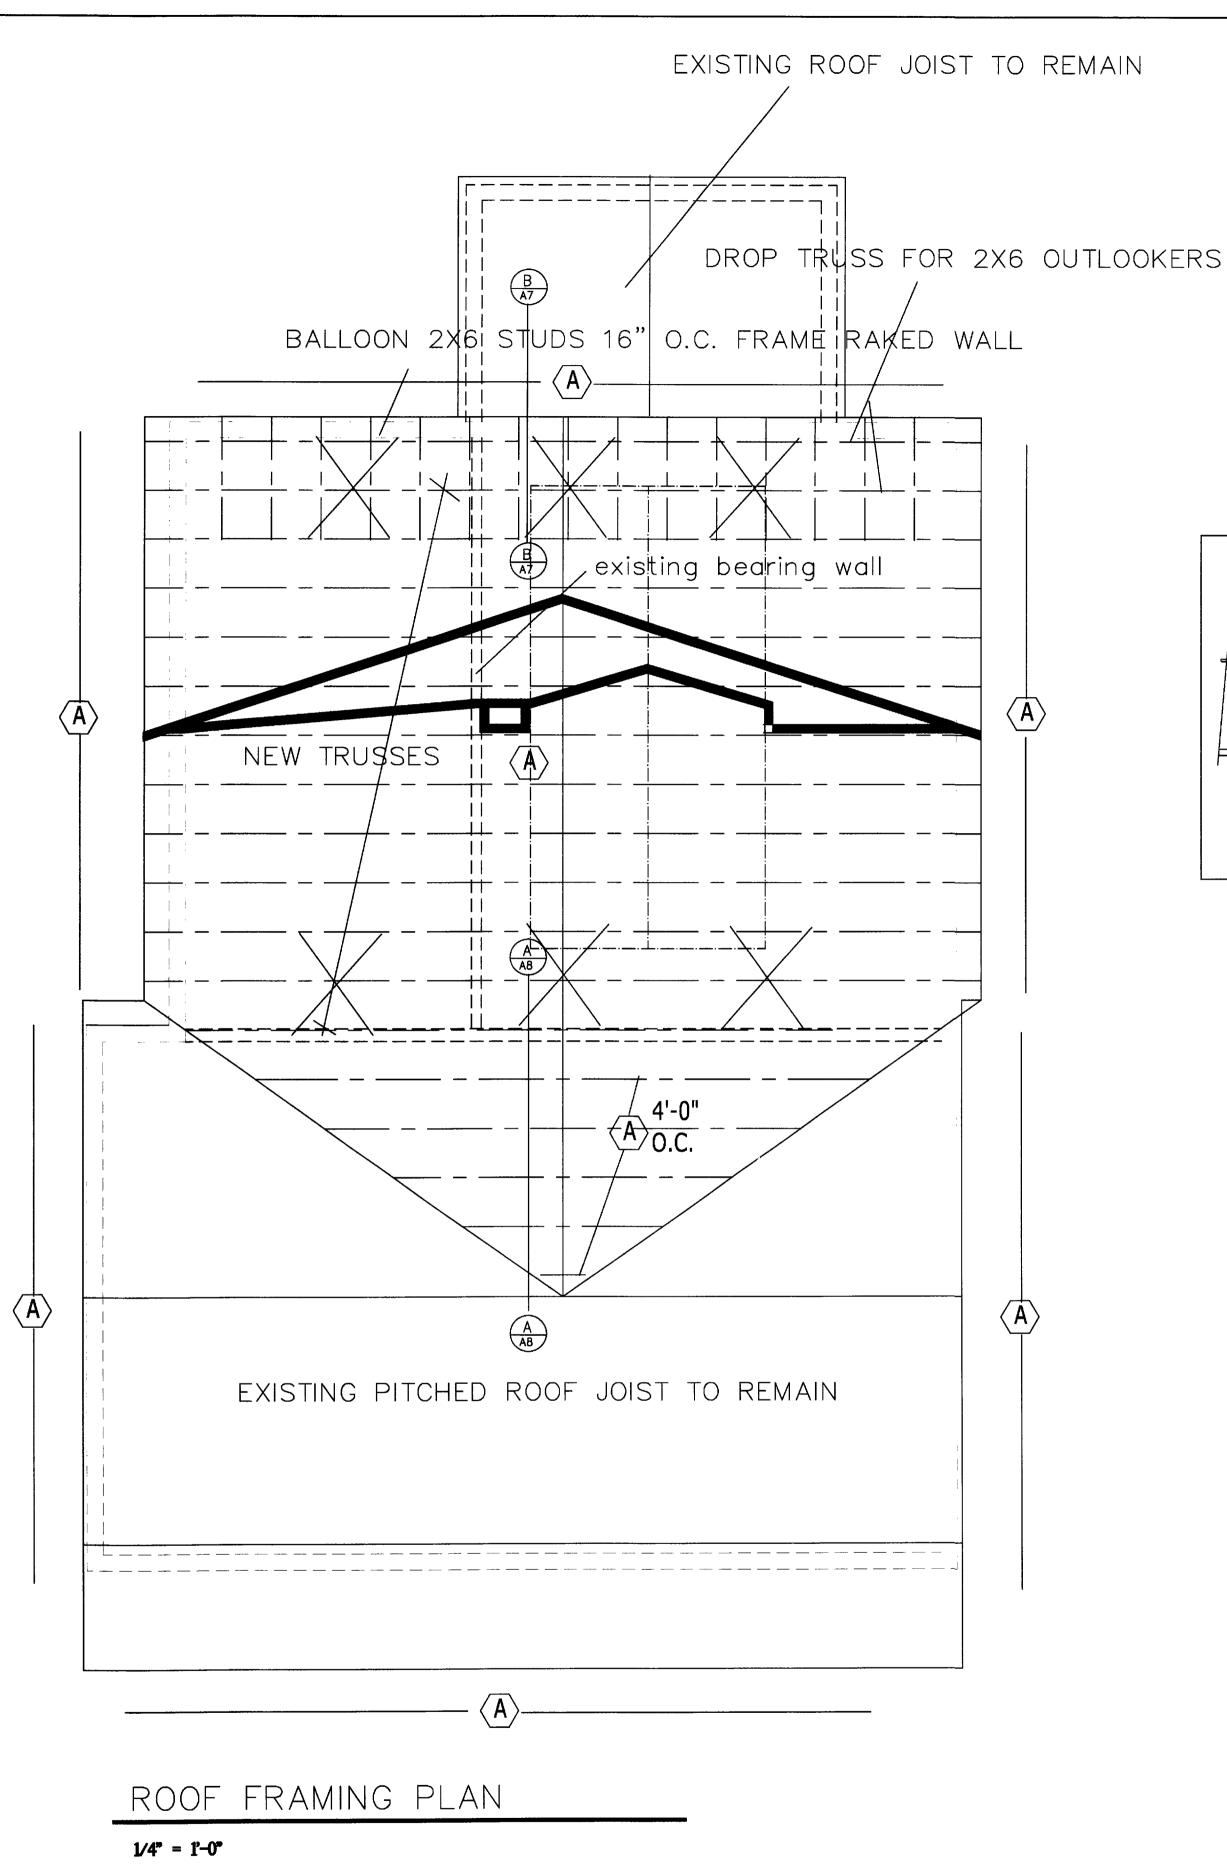


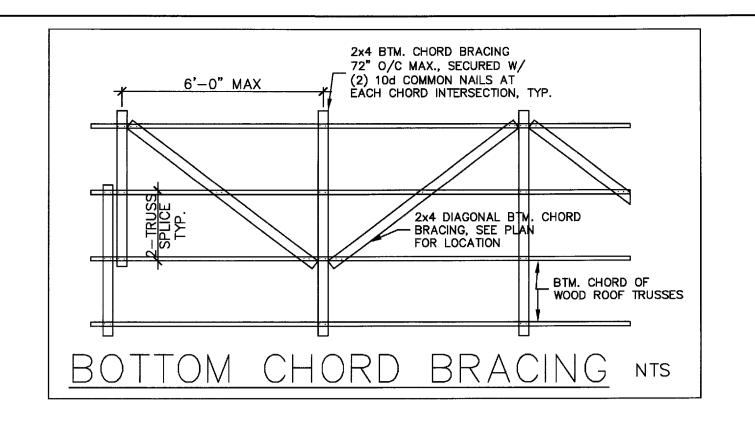


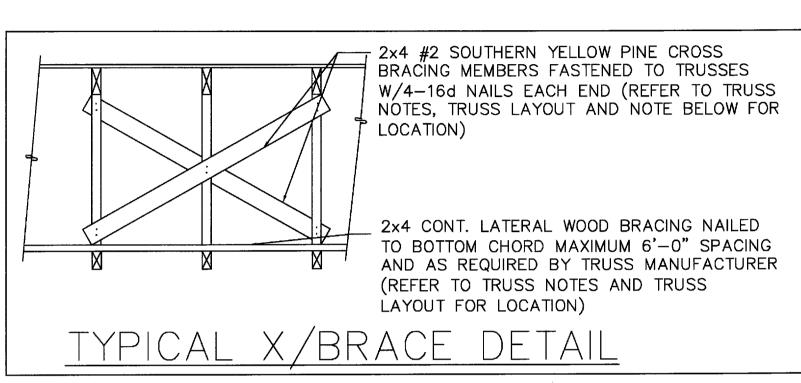

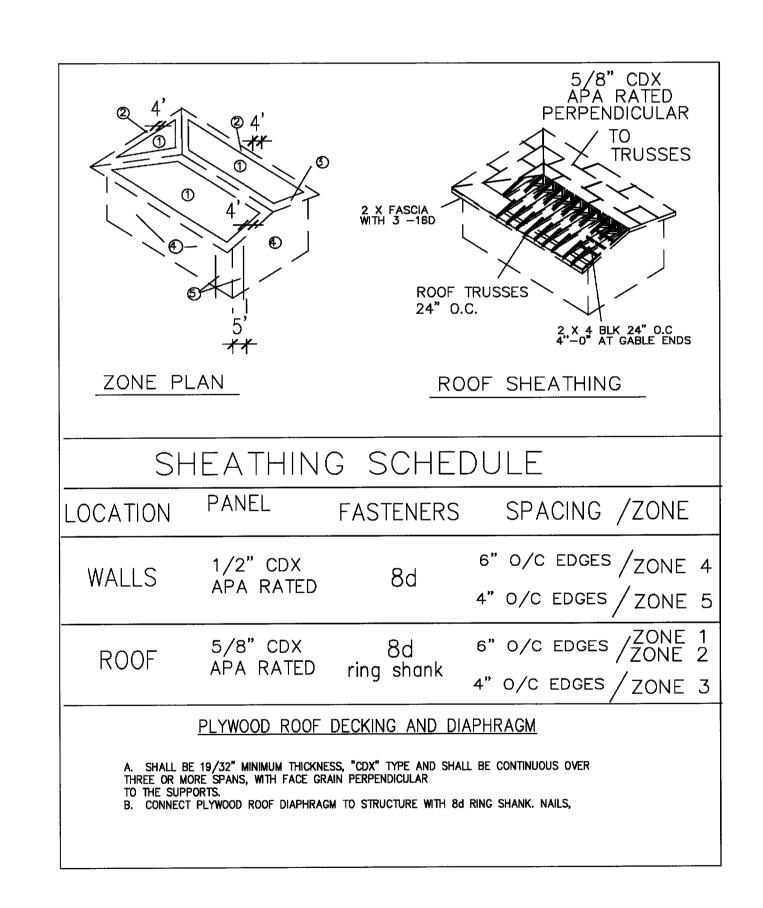


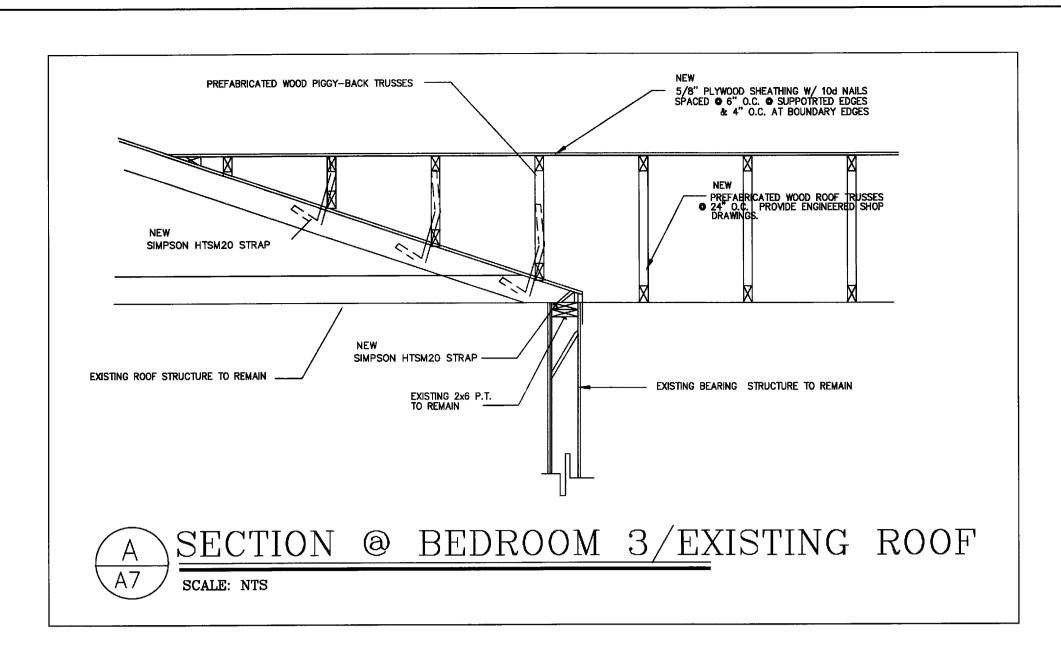

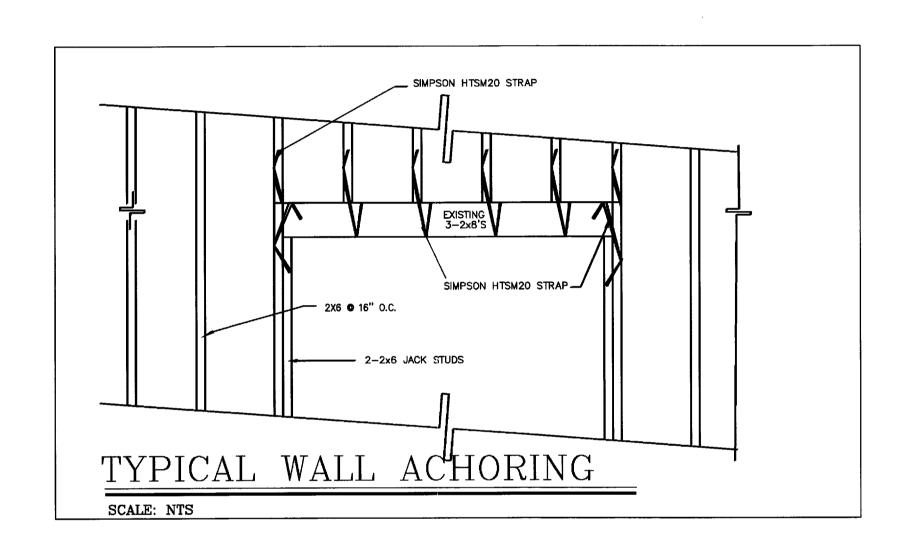

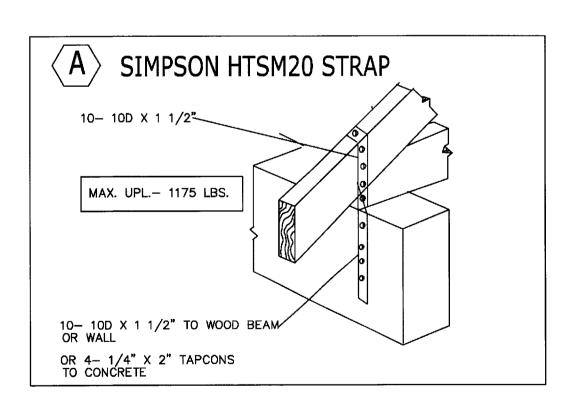

ALL WORK MUST CONFORM TO THE 5TH EDITION (2014) FLORIDA BUILDING CODE

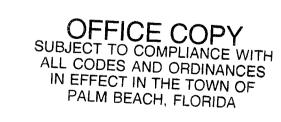

CARLOS VILACA
300 RIOMAR DRIVE
PORT SAINT LUCIE FLA PHONE: 561— 445— 9661 EMAIL: carlosvilaca2@gmail.cpr 1-27-16 $1/4^{\circ} = 1'-0^{\circ}$

CARL G I

555 SOUTH P
POMPANO B
EMAIL: CARLFORB


REVISIONS BY

CARL G. FORBES

555 S POWERLINE RD. POMPANO BEACH, FL 954-682 6651


911-360 **SEASPRAY**

REVIEWED

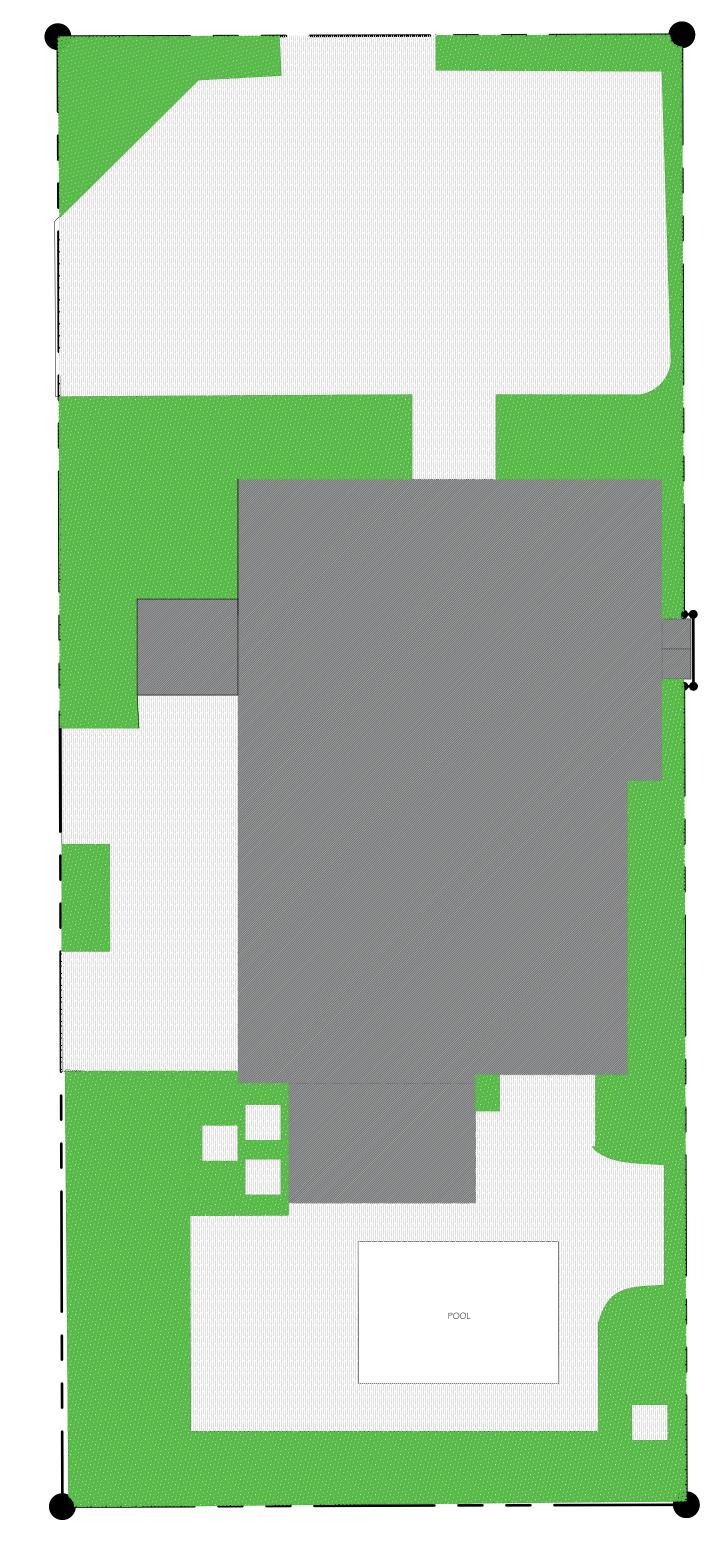


EXISTING:

LOT COVERAGE	1,809.89 SQ. FT.	(28.39%)
OPEN SPACE	1,988.00 SQ. FT.	(31.20%)
HARDSCAPE	2,005.11 SQ. FT.	(31.45%)
TOTAL	6,375.00 SQ. FT.	(100.00%)

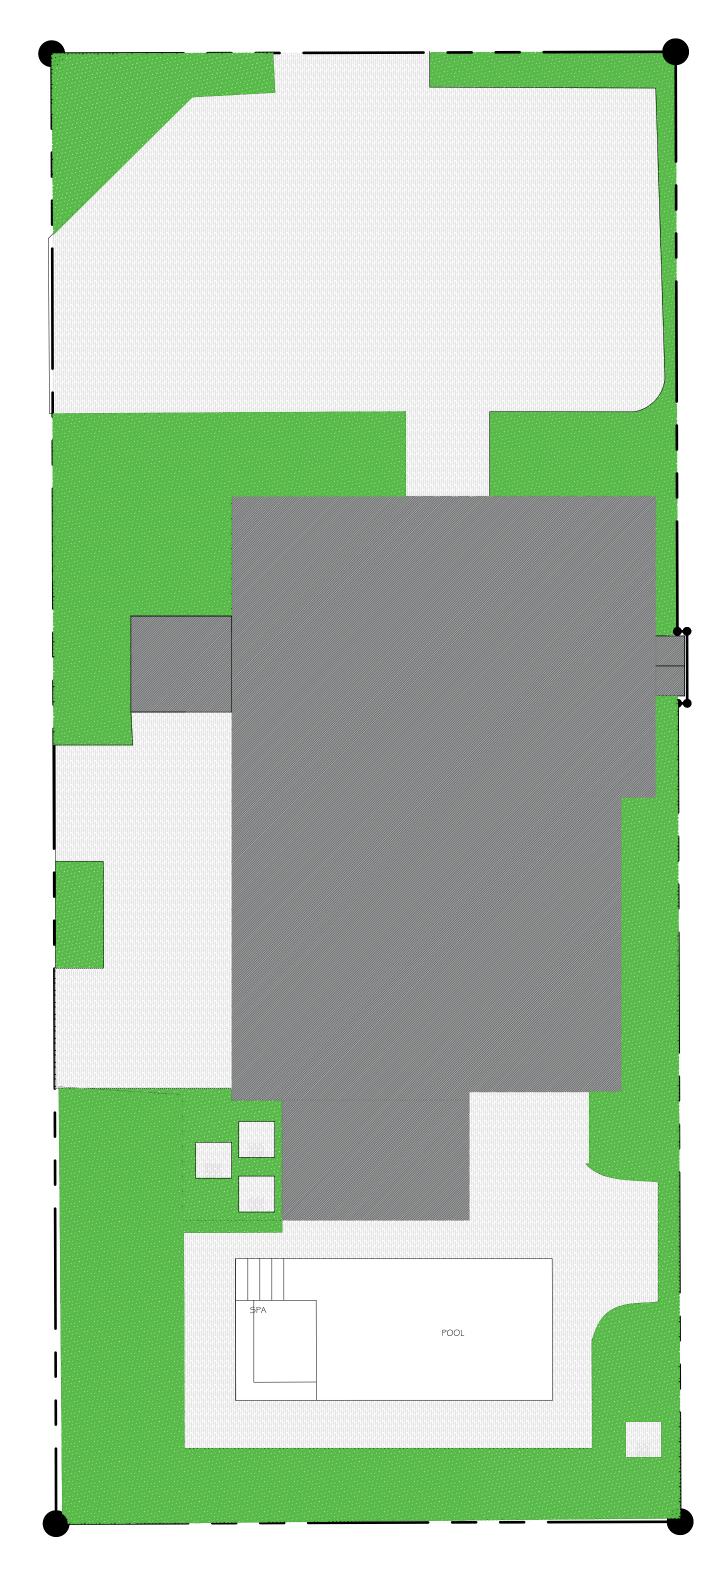

PROPOSED:

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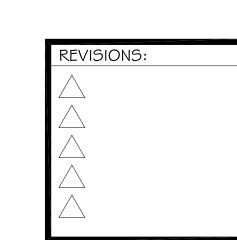
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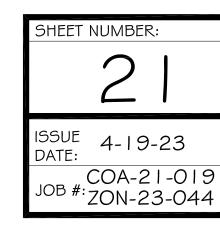
MRS. JUSTIN BESIKOF

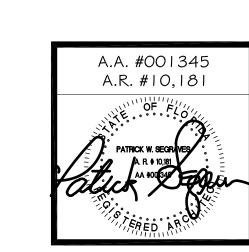
60 SEASPRAY AVENUE

1 BEACH, FLORIDA 33480







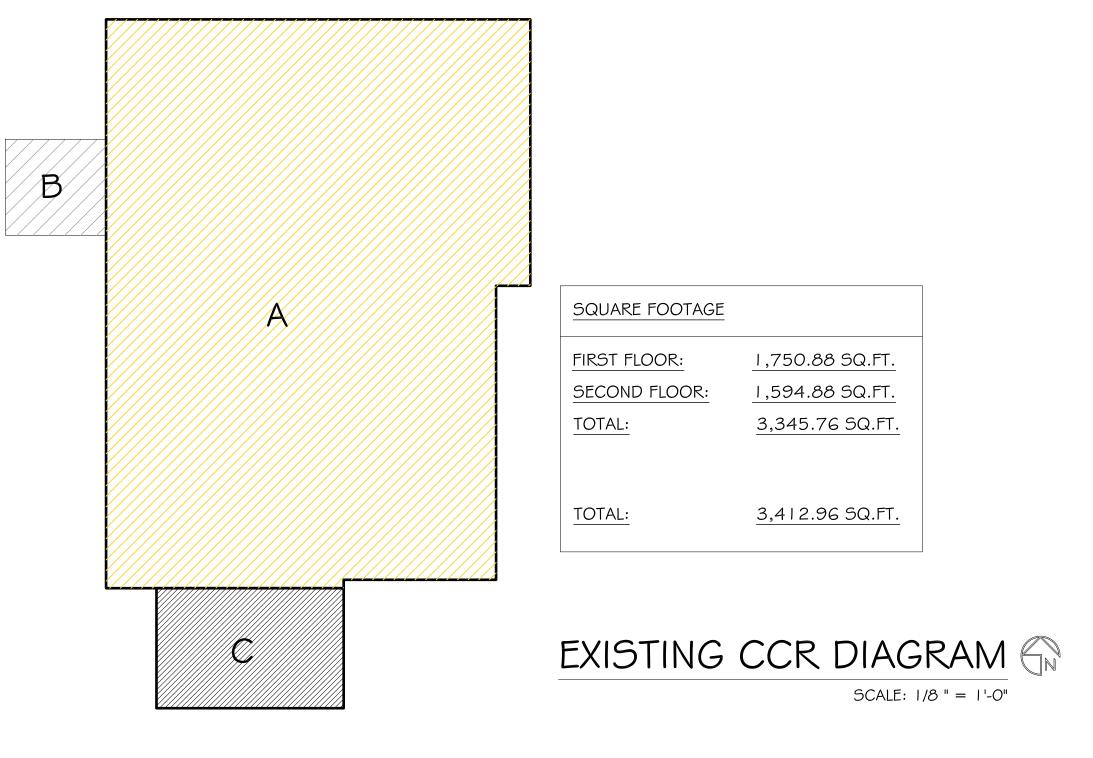

CUBIC CONTENT RATIO(CCR)

MAIN HOME

A - 1,586.69 SQ. FT. @ 18.17' = 28,830.16 CU. FT. (TWO STORY STRUCTURE) C - 156.00 SQ. FT. @ 8.00' = 1,248.00 CU. FT. (ONE STORY STRUCTURE) B - 67.20 SQ. FT. @ 0.00' = 0,000.00 CU. FT. (ONE STORY STRUCTURE)

TOTAL CUBIC FEET = 30,078.16 CU. FT. / 6,375 SQ. FT. = 4.72 CCR

4.00 + [(10,000-6,375.00)/10,000] = 4.36 CCR MAX ALLOWABLE CCR: MAX ALLOWABLE CUBIC FEET: 4.36 X 6,375.00 = 27,810.94 CU. FT.

27,810.94 CU. FT. MAX - 30,078.16 CU. FT. = (-)2,267.22 CU. FT. OVERAGE

A

SQUARE FOOTAGE FIRST FLOOR: 1,662.08 SQ.FT. 1,594.88 SQ.FT. SECOND FLOOR: 3,256.96 SQ.FT. LOGGIA: _156.00 SQ.FT. TOTAL: 3,412.96 SQ.FT.

PROPOSED CCR DIAGRAM

SCALE: 1/8 " = 1'-0"

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TOTAL CUBIC FEET = 29,434.96 CU. FT. / 6,375 SQ. FT. = 4.62 CCR


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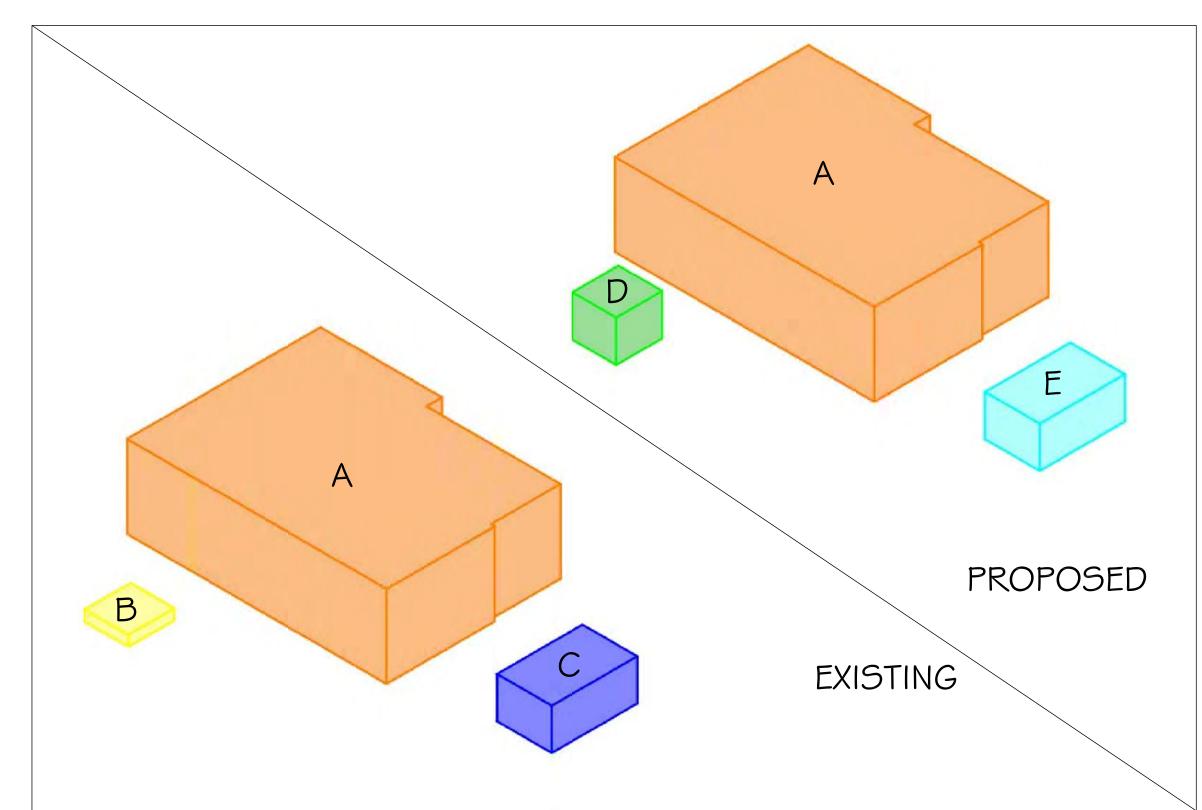
27,810.94 CU. FT. MAX - 29,434.96 CU. FT. = (-)1,624.02 CU. FT. OVERAGE

E - 156.00 SQ. FT. @ 9.00' = 1,404.00 CU. FT. (REAR LOGGIA)

5% OF HOUSE CU.FT. (27.810.94 CU. FT.) = 1,390.55 CU. FT. MAX 1,390.55 CU. FT. MAX - 1,404.00 CU. FT. = (-)13.45 CU. FT. OVERAGE

(-)1,624.02 CU.FT. HOUSE OVERAGE + (-)13.45 CU.FT. LOGGIA OVERAGE = (-)1,637.47 CU.FT. OVERAGE




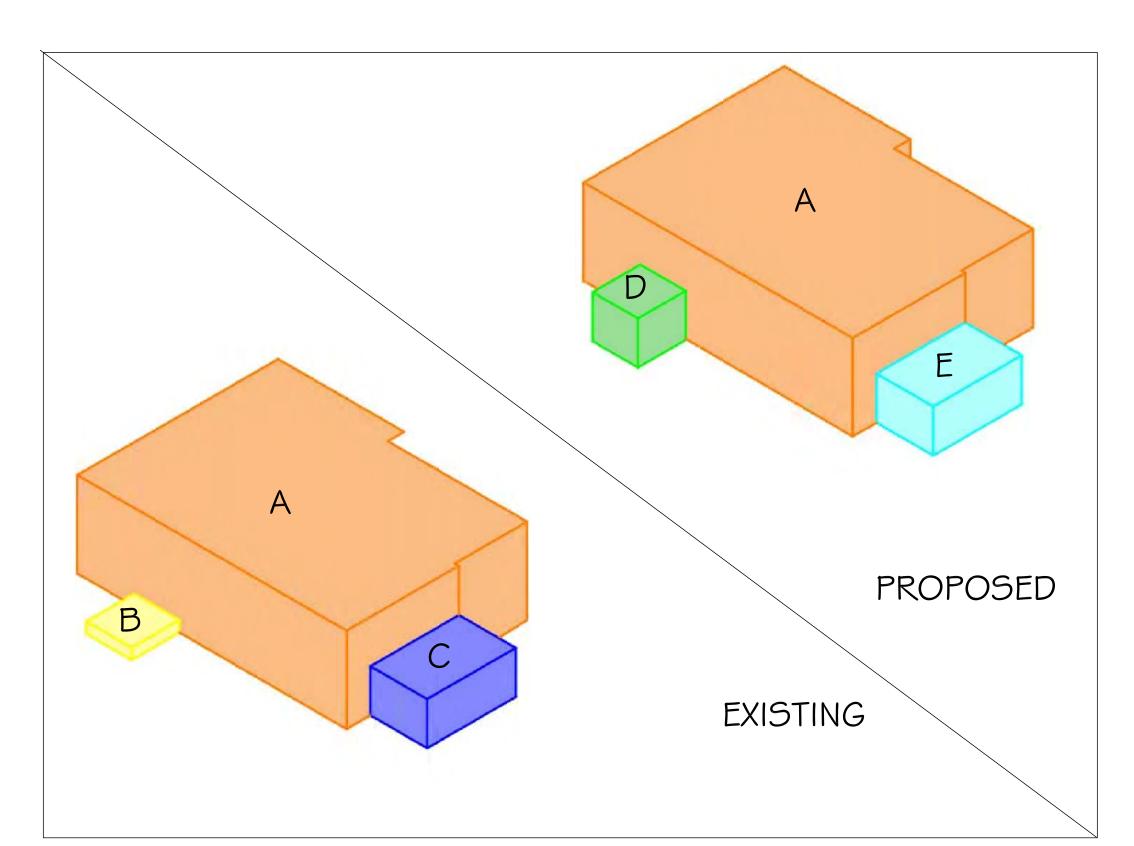


3D CCR DIAGRAMS

EXPLODED 3D CCR DIAGRAMS

SCALE: NTS

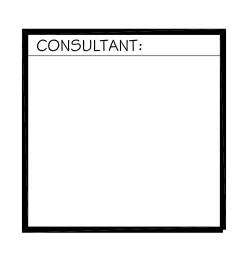


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a. Variance #1: Sec. 134—1576(a): A variance to allow a west street side yard setback for an addition at 6.46' in lieu of the 25' minimum required.

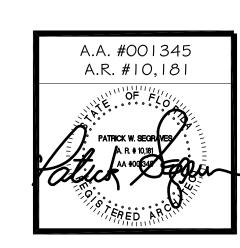b. Variance #2: Sec. 134—2179(b): A variance to have 0 garage parking spaces in lieu of the 1 garage parking space required.

c. Variance #3: Sec. 134—893(13): A variance for a Cubic Content amount of (PROVIDE) in lieu of the 4.72 existing and the 4.36 allowed.



CUBIC CONTENT RATIO(CCR)

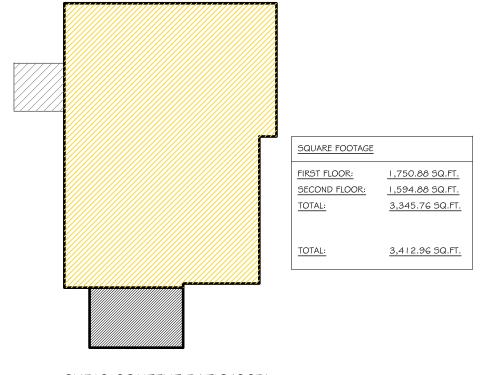
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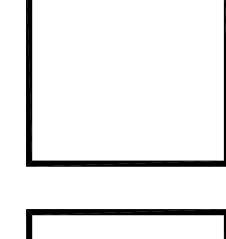
d. Variance #4: Sec. 134—1757: A variance to allow a swimming pool in the required street side setback without the required 6 foot wall required for screening.



VIEW FROM INSIDE PROPERTY






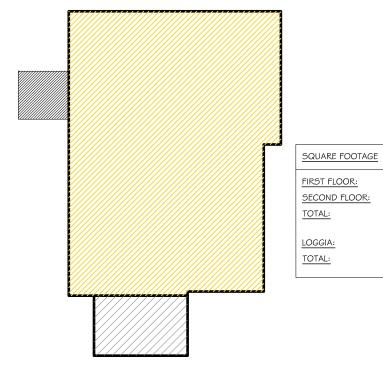



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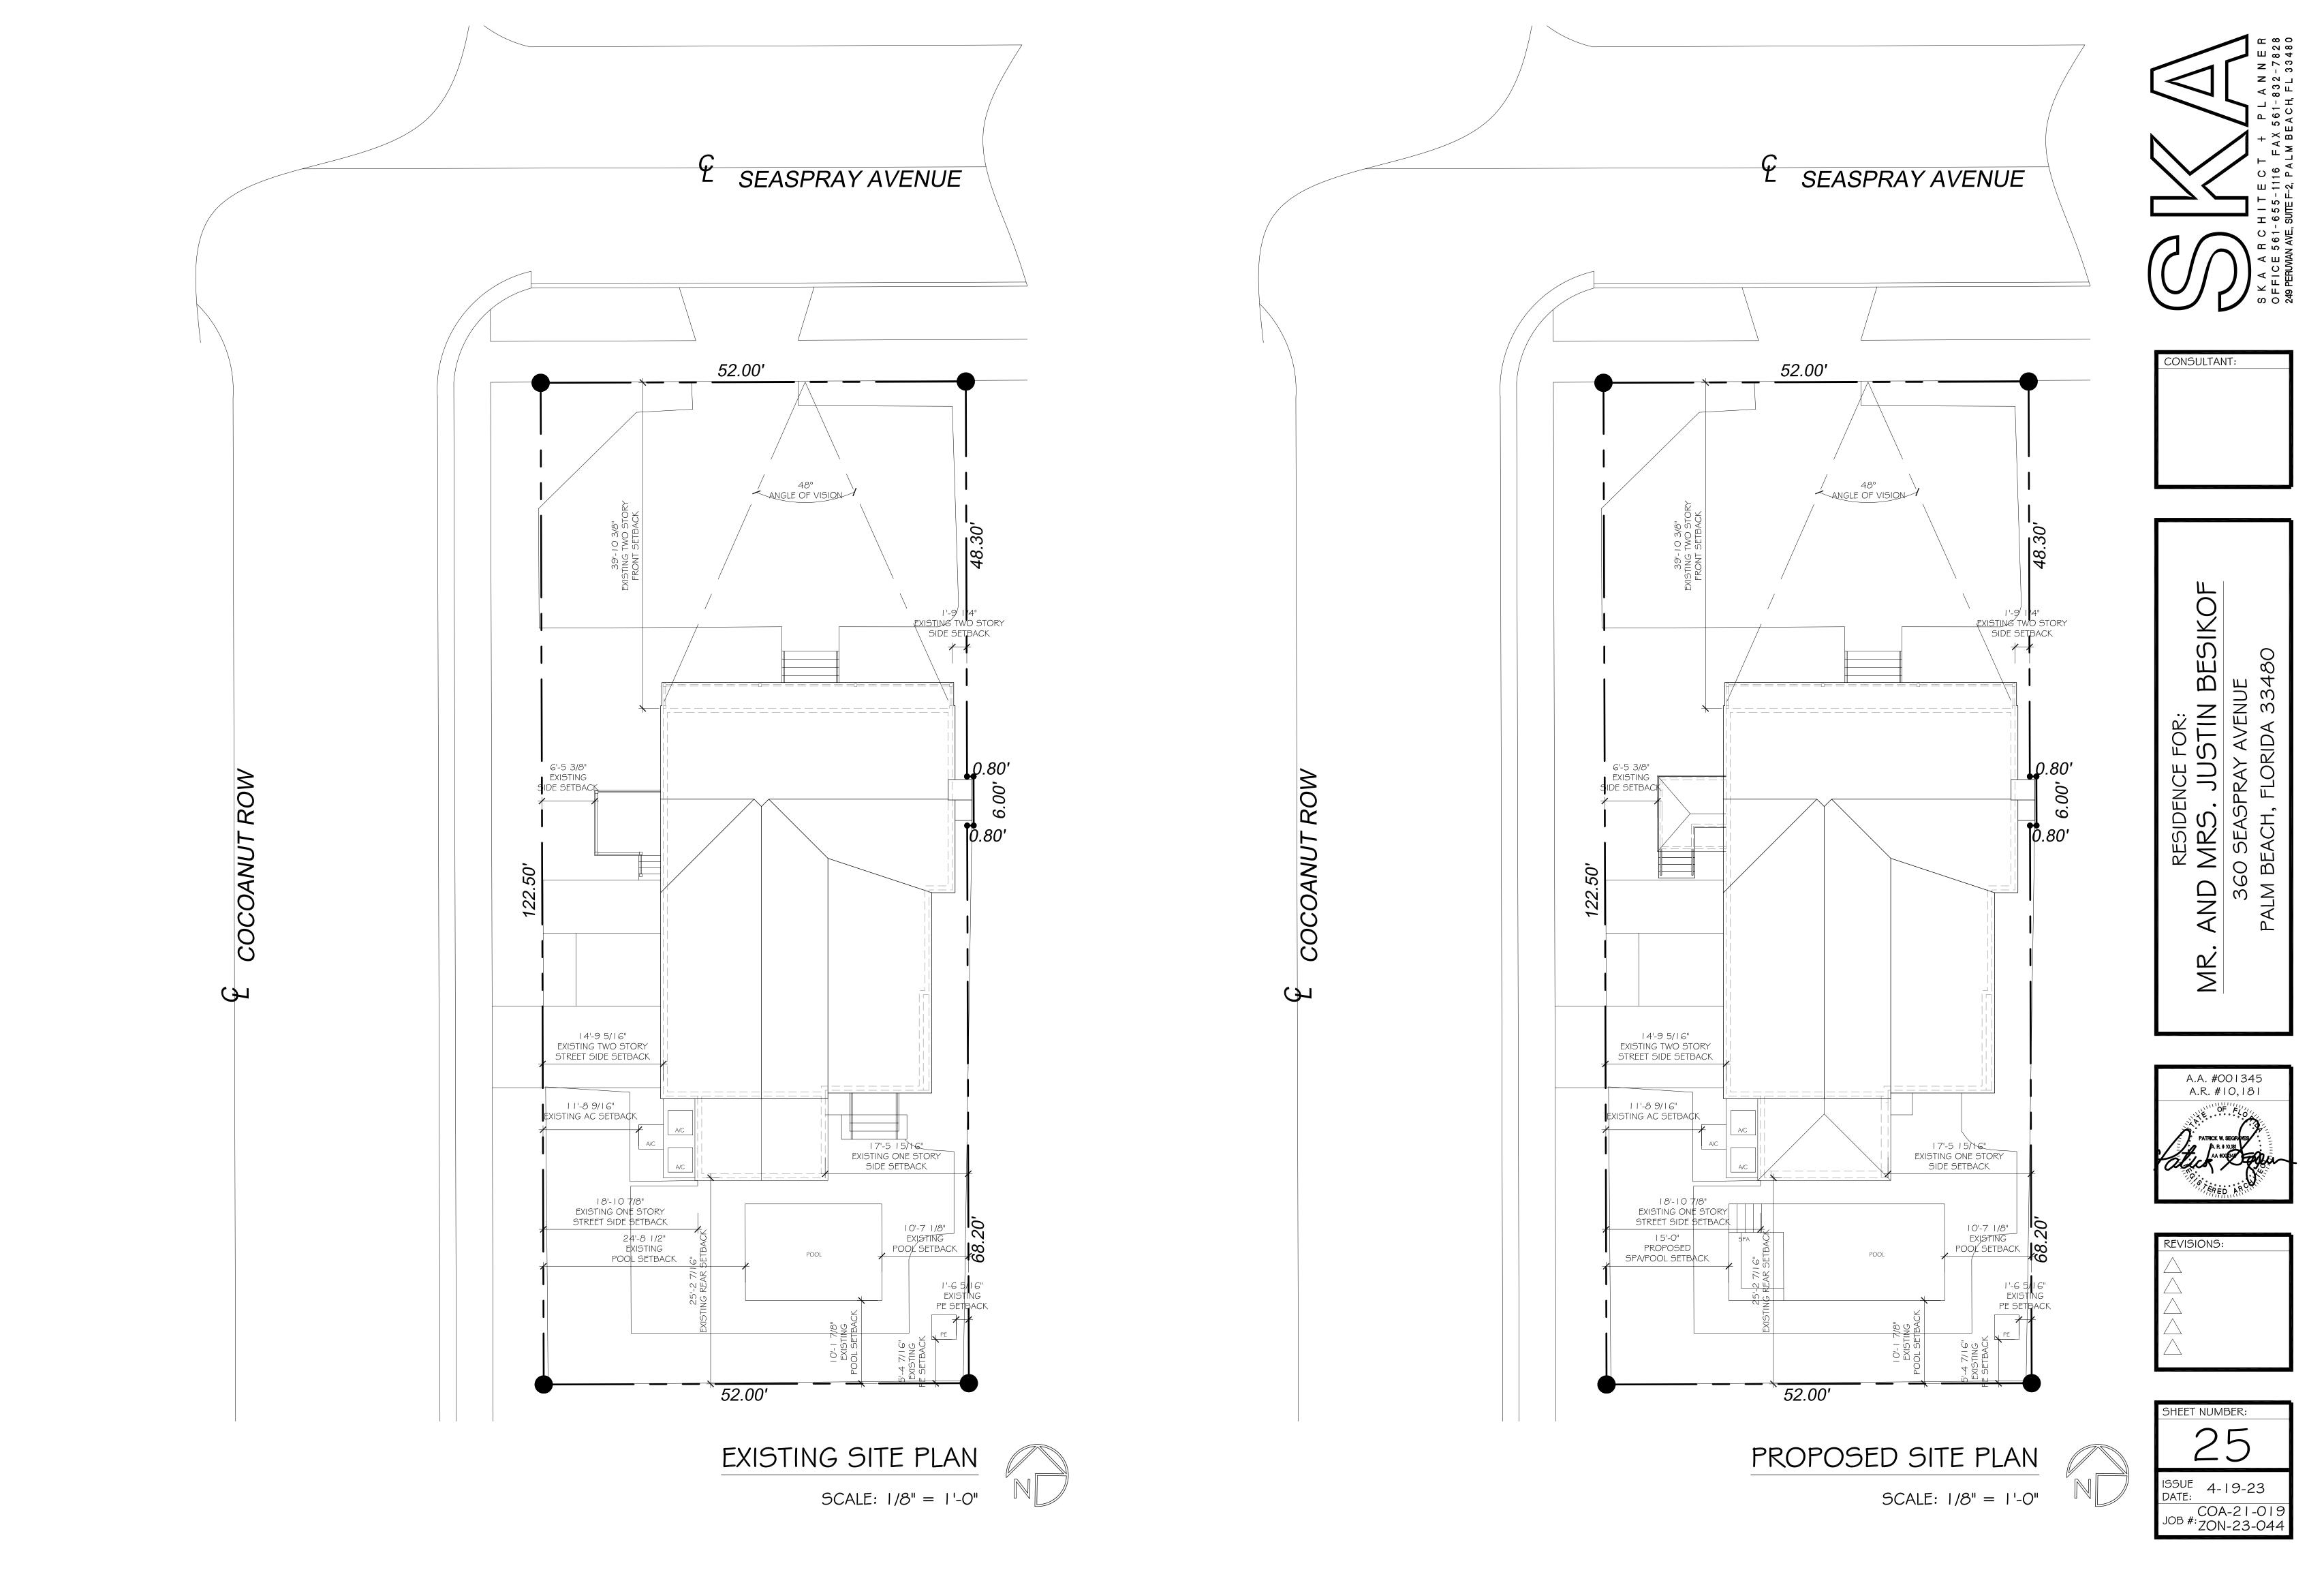
MR. AND MRS. JUSTIN BESIKOF


360 SEASPRAY AVENUE



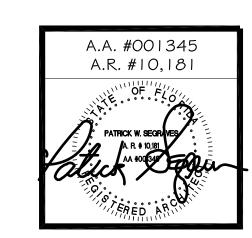


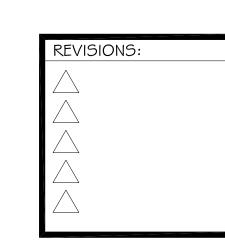

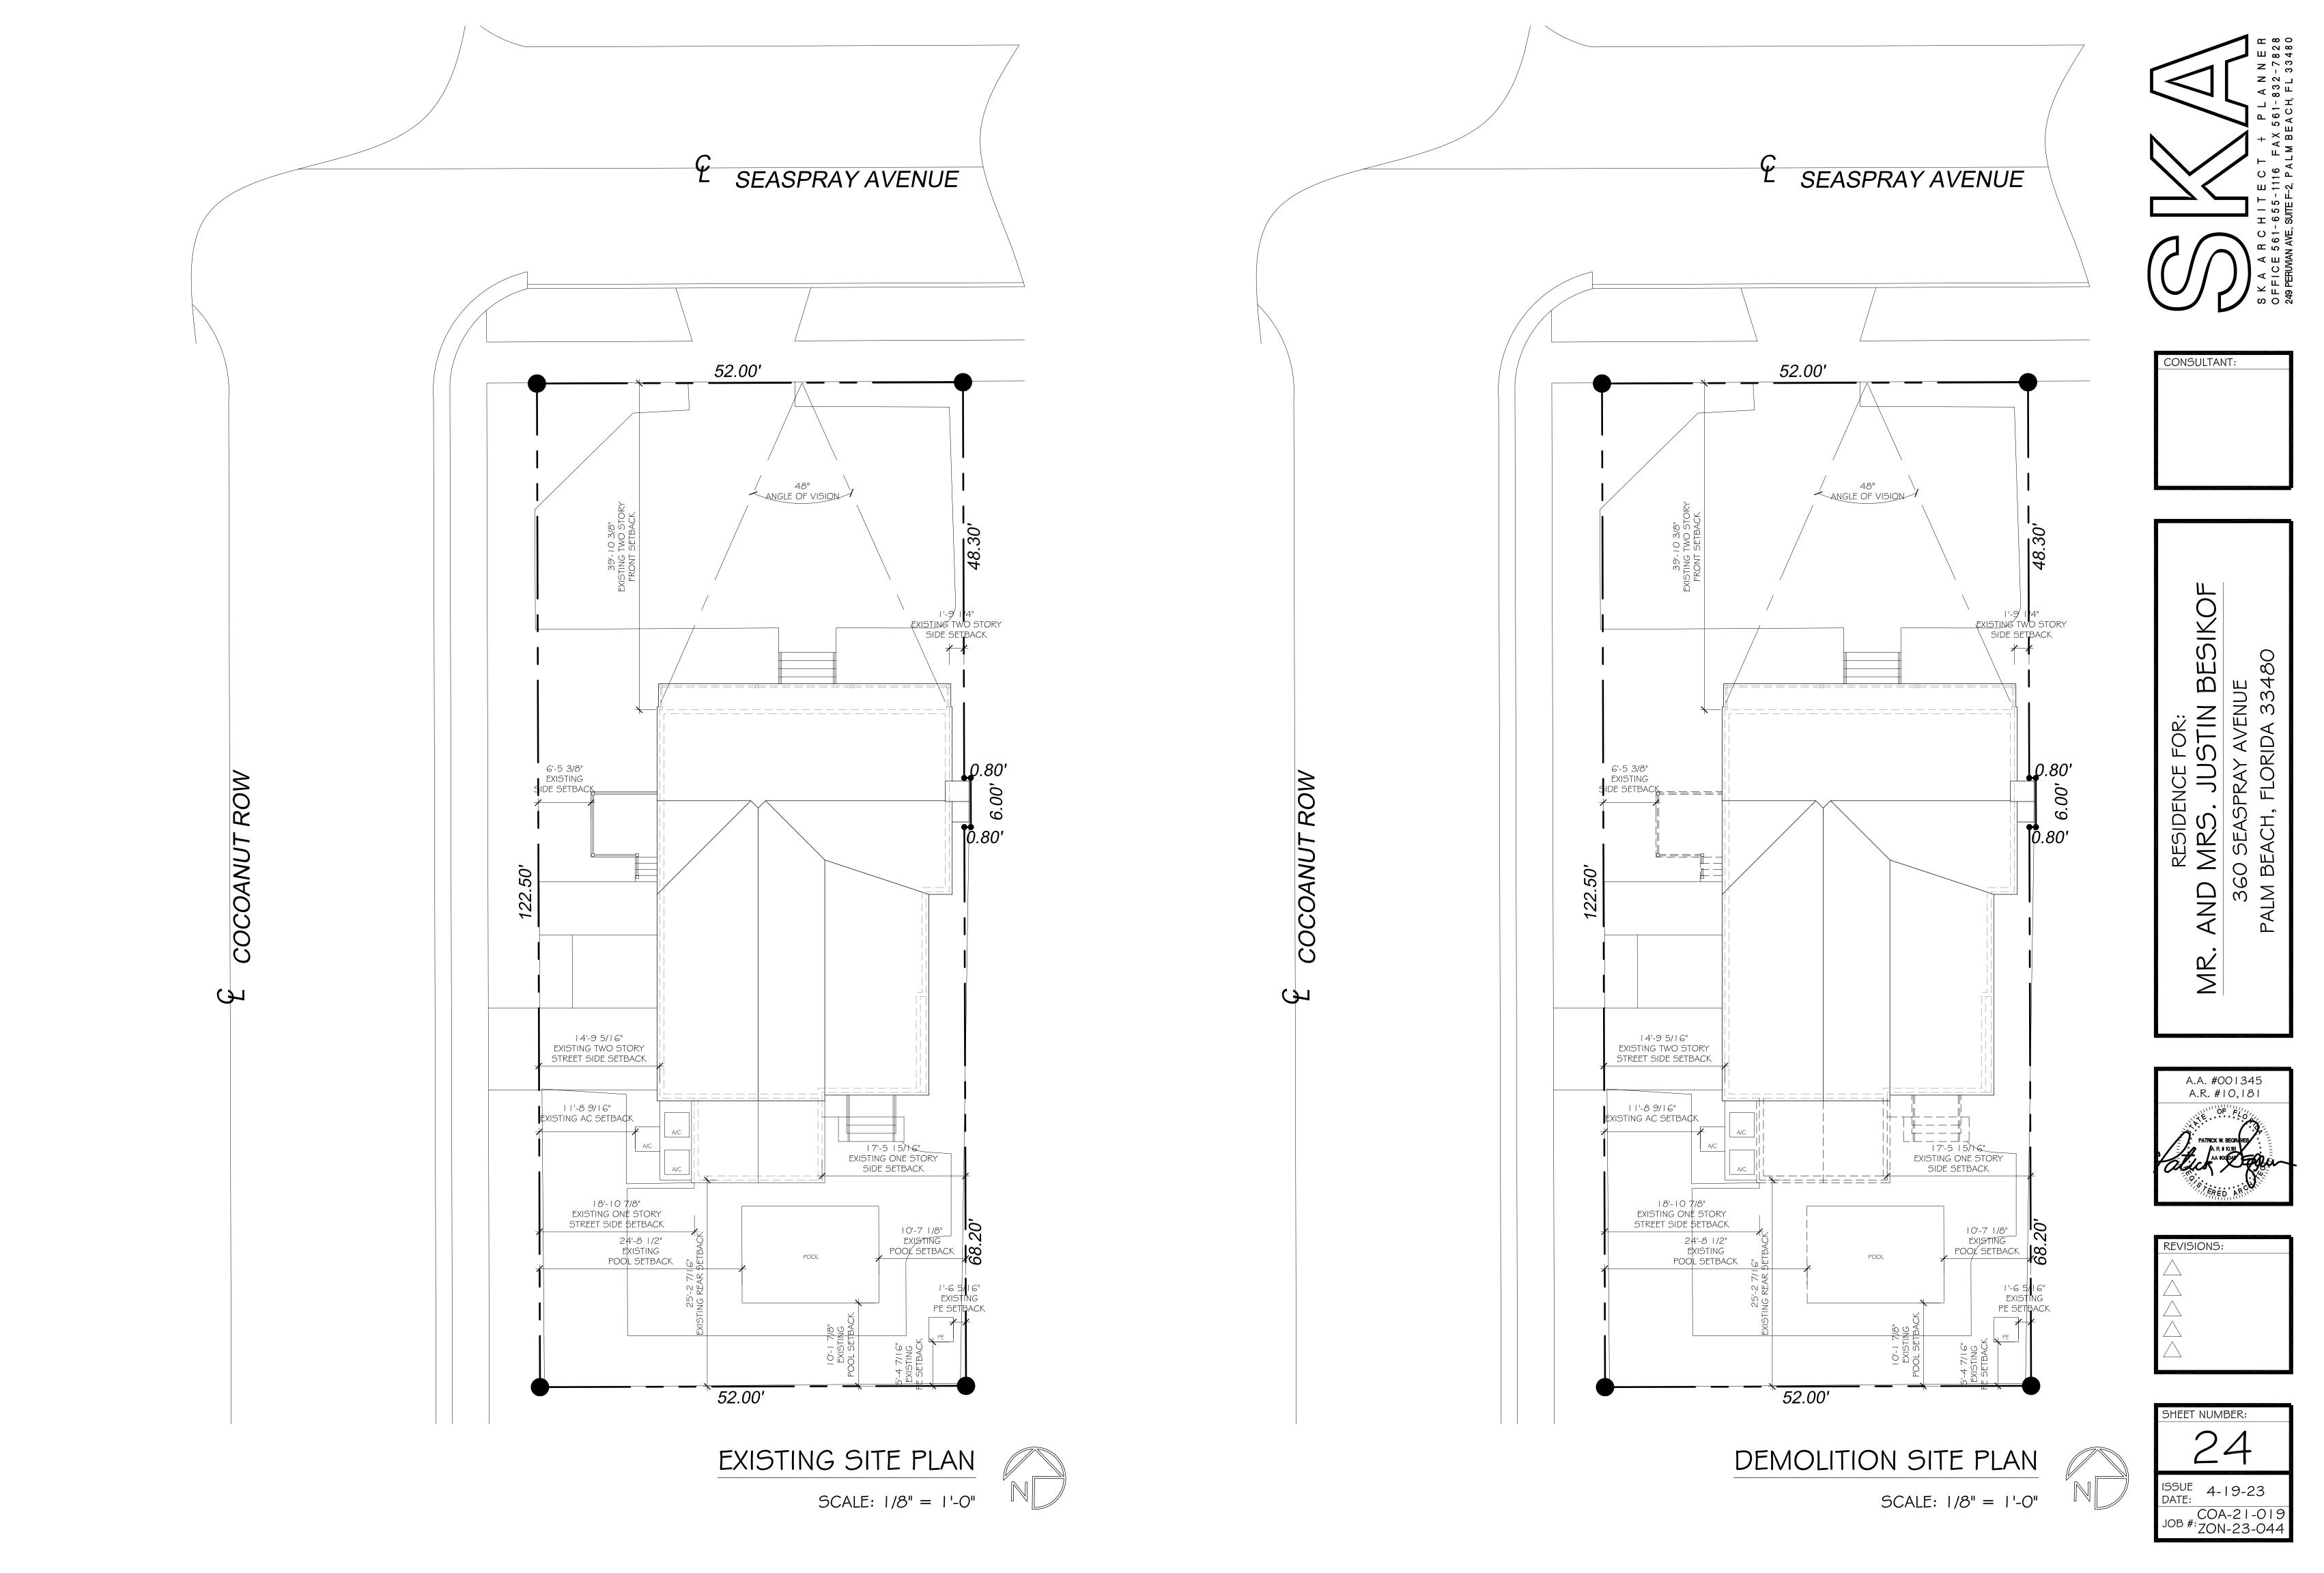

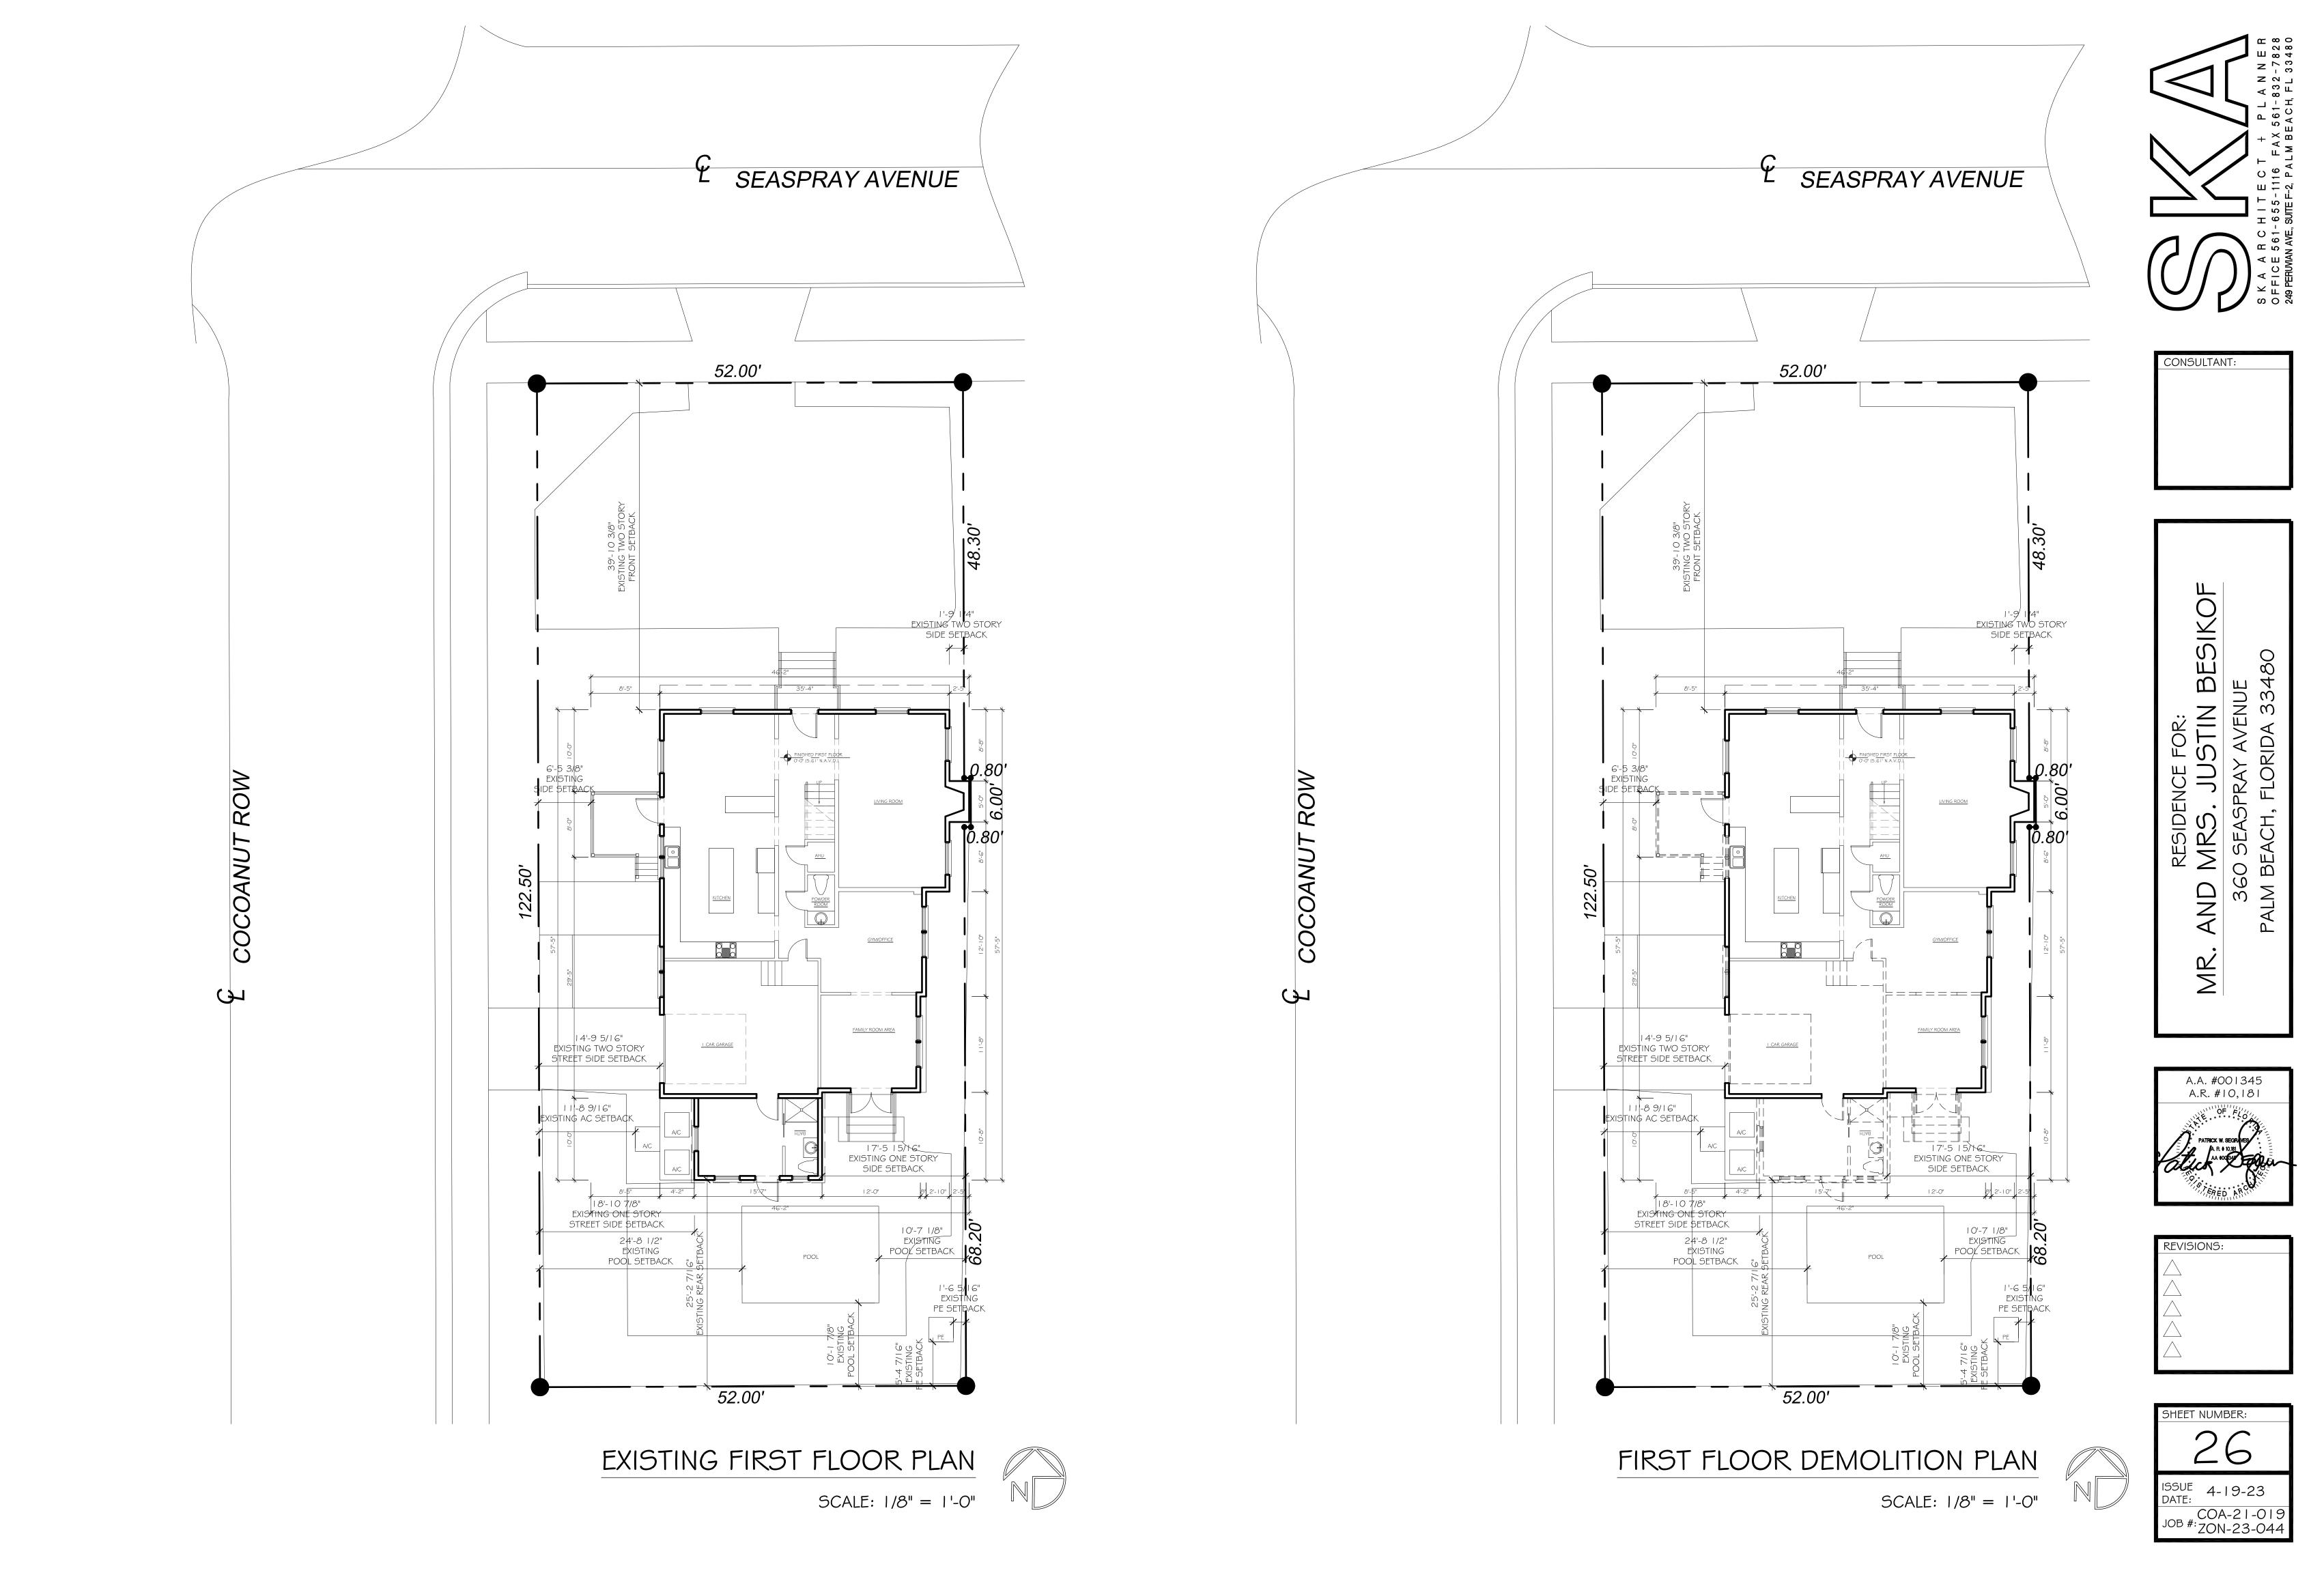




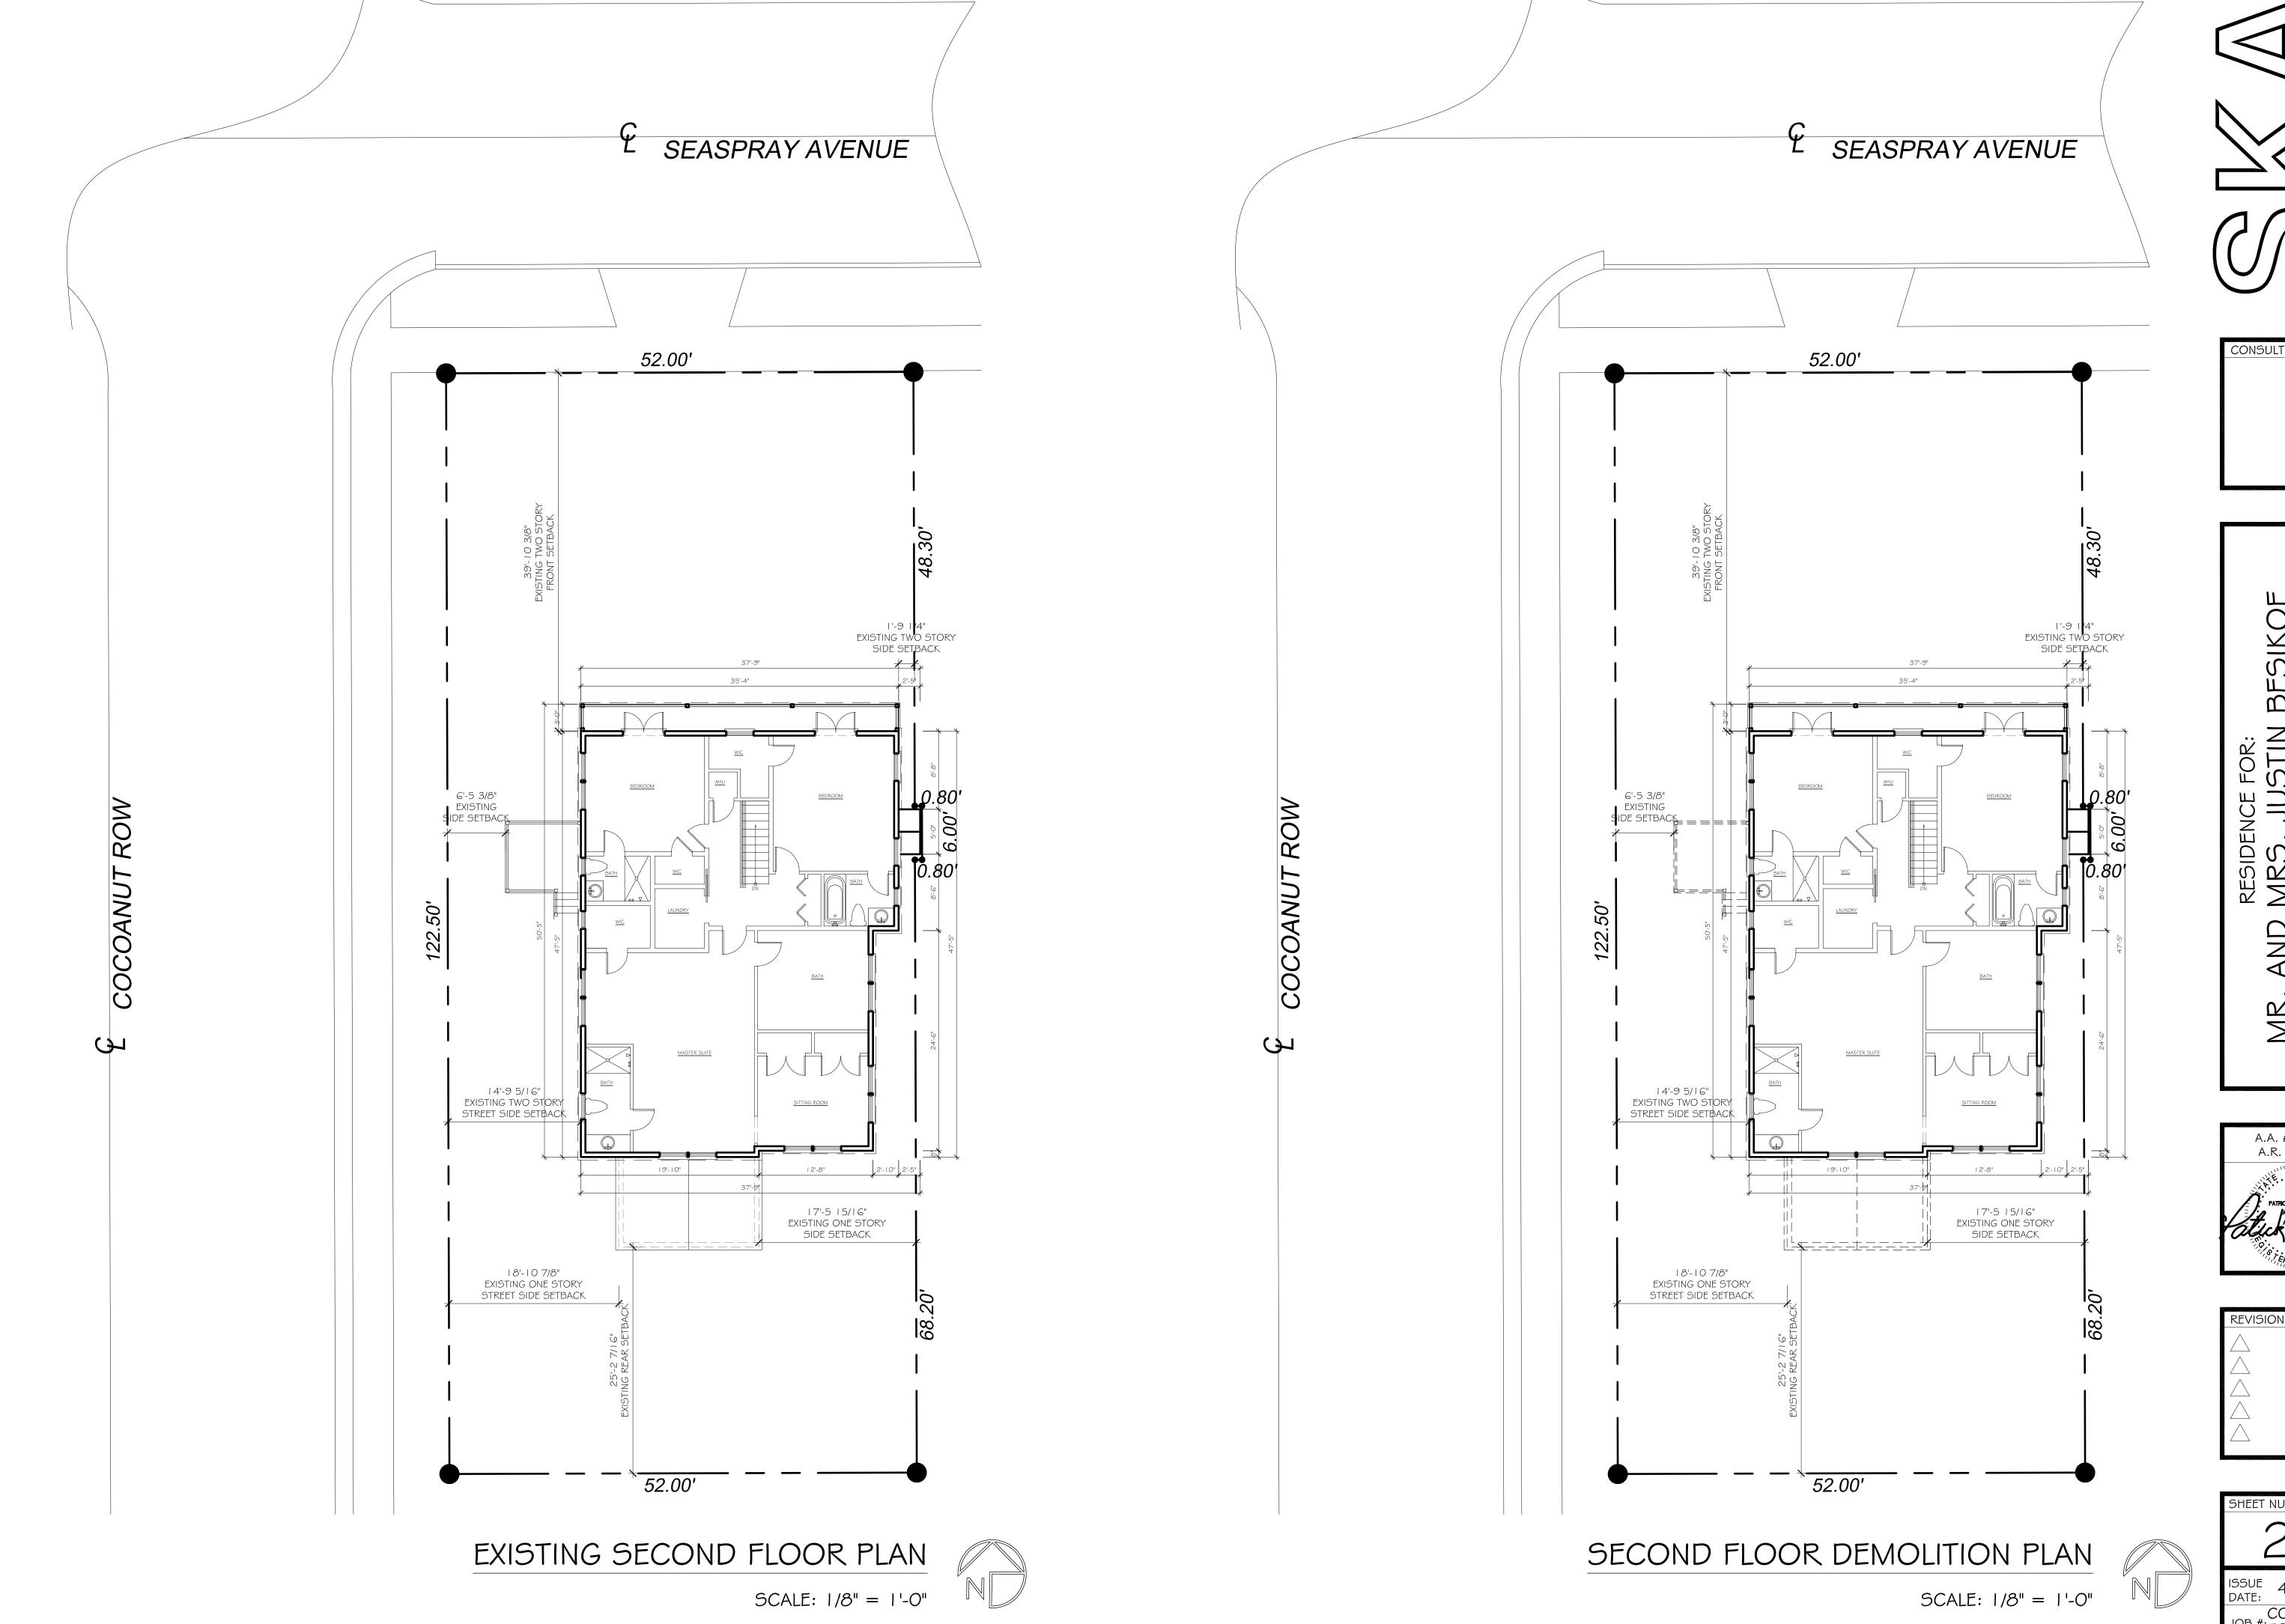

S K A A R C H I T E C T + P L A N N E R
OFFICE 561-655-1116 F A X 561-832-7828
249 PERUMAN AVE, SUITE F-2, P A L M B E A C H, F L 33480

CONSULTANT:

AND MRS. JUSTIN BESIK 360 SEASPRAY AVENUE

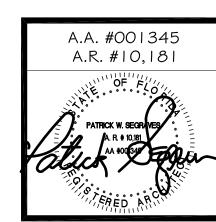

REVISIONS:


SHEET NUMBER:

28

ISSUE 4-19-23
DATE:

COA-21-019
JOB #: ZON-23-044




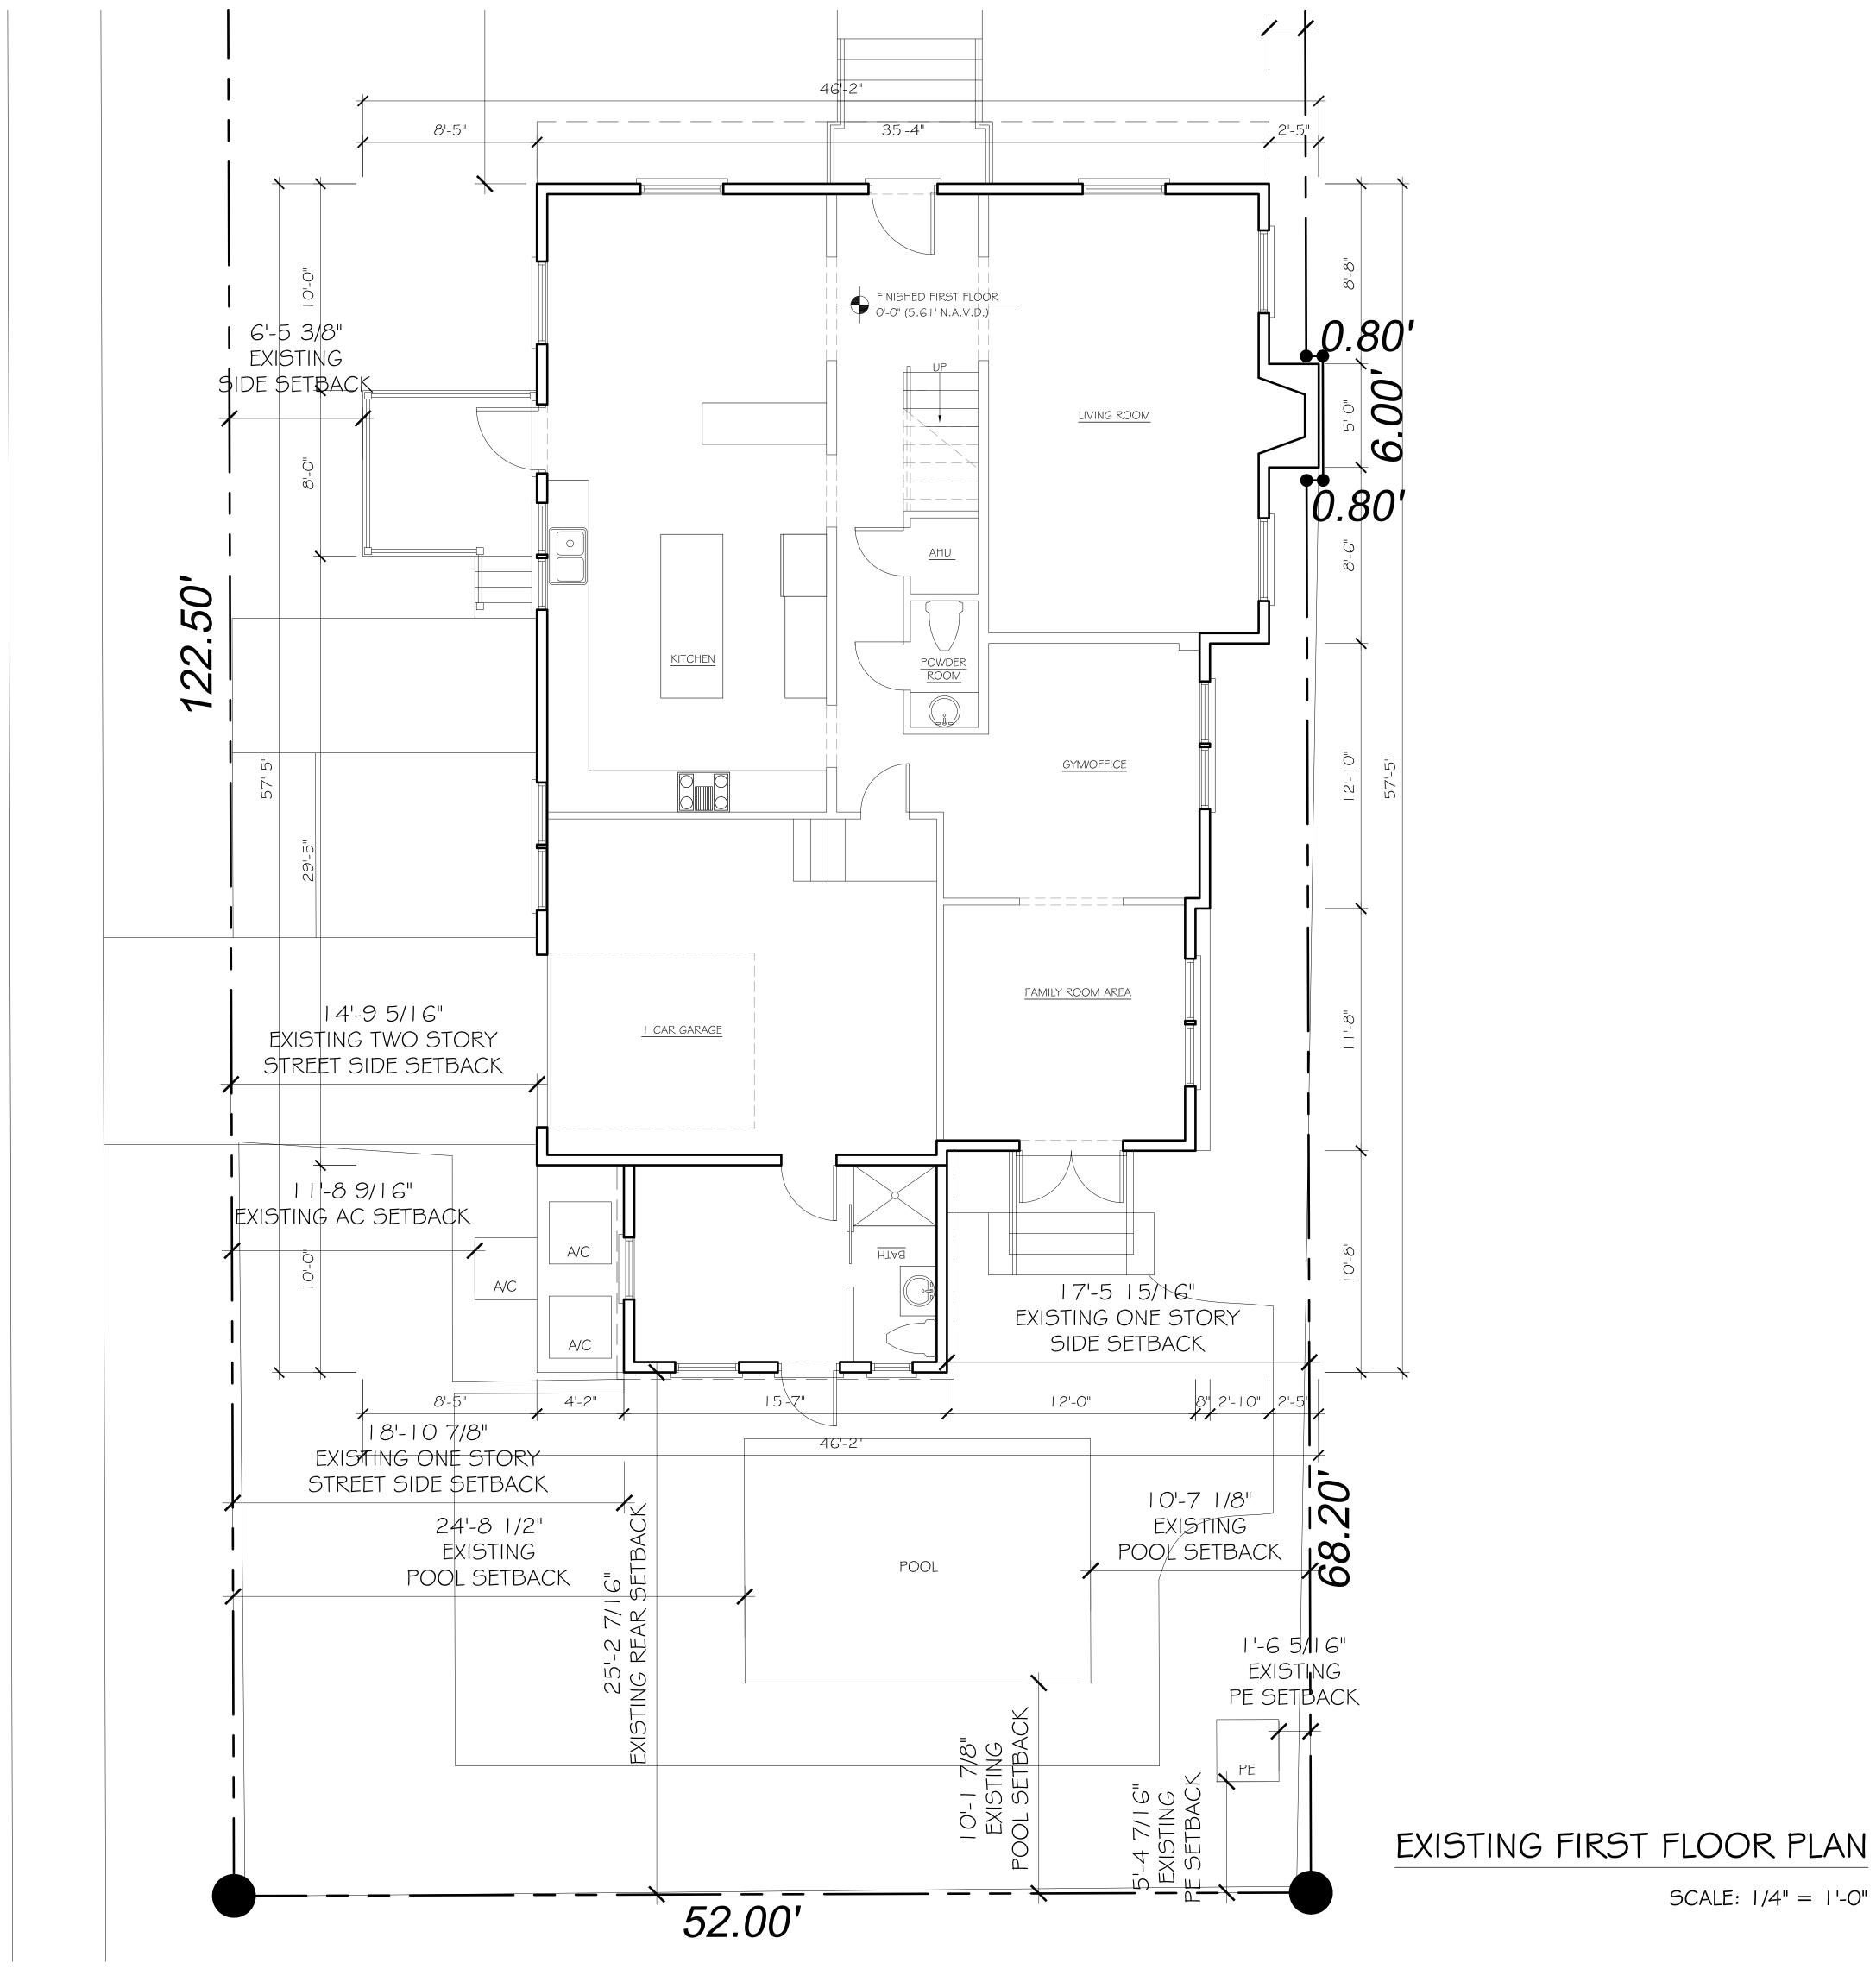




RESIDENCE FOR: AND MRS. JUSTIN BESIKOF M R




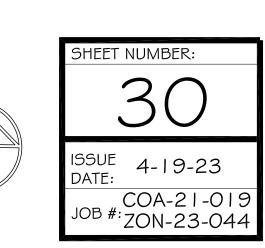

SCALE: 1/4" = 1'-0"

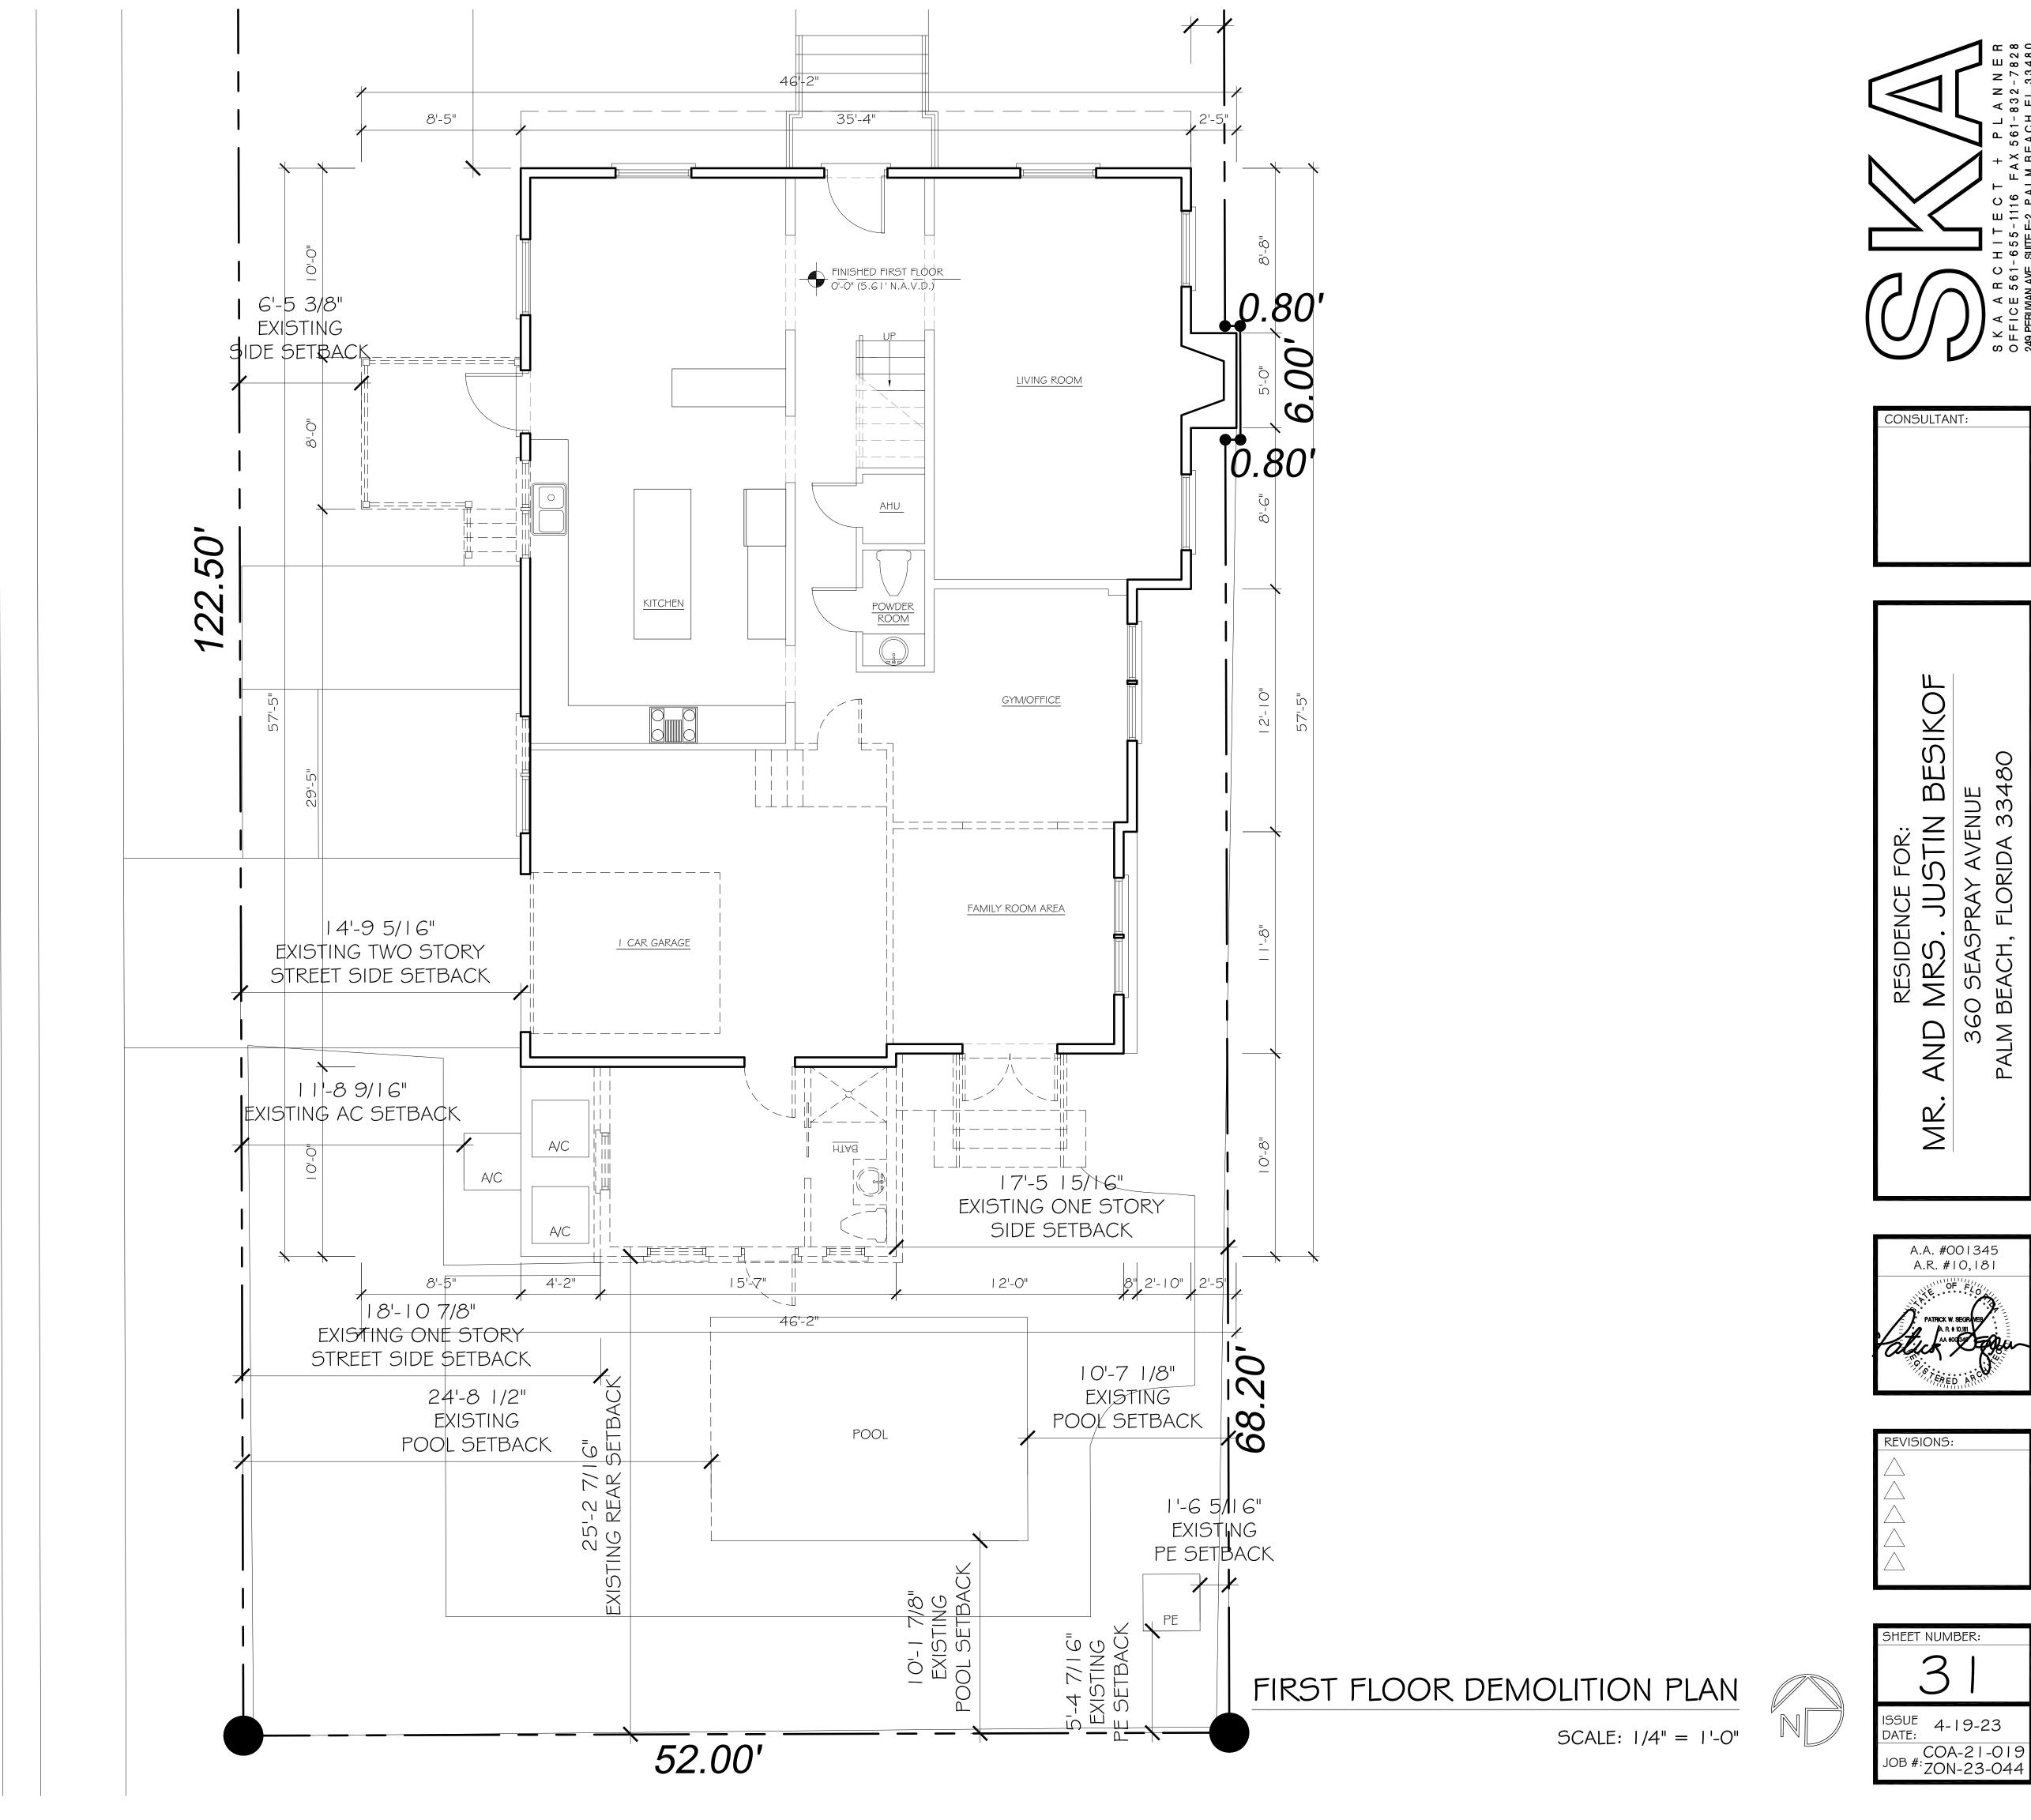

M R

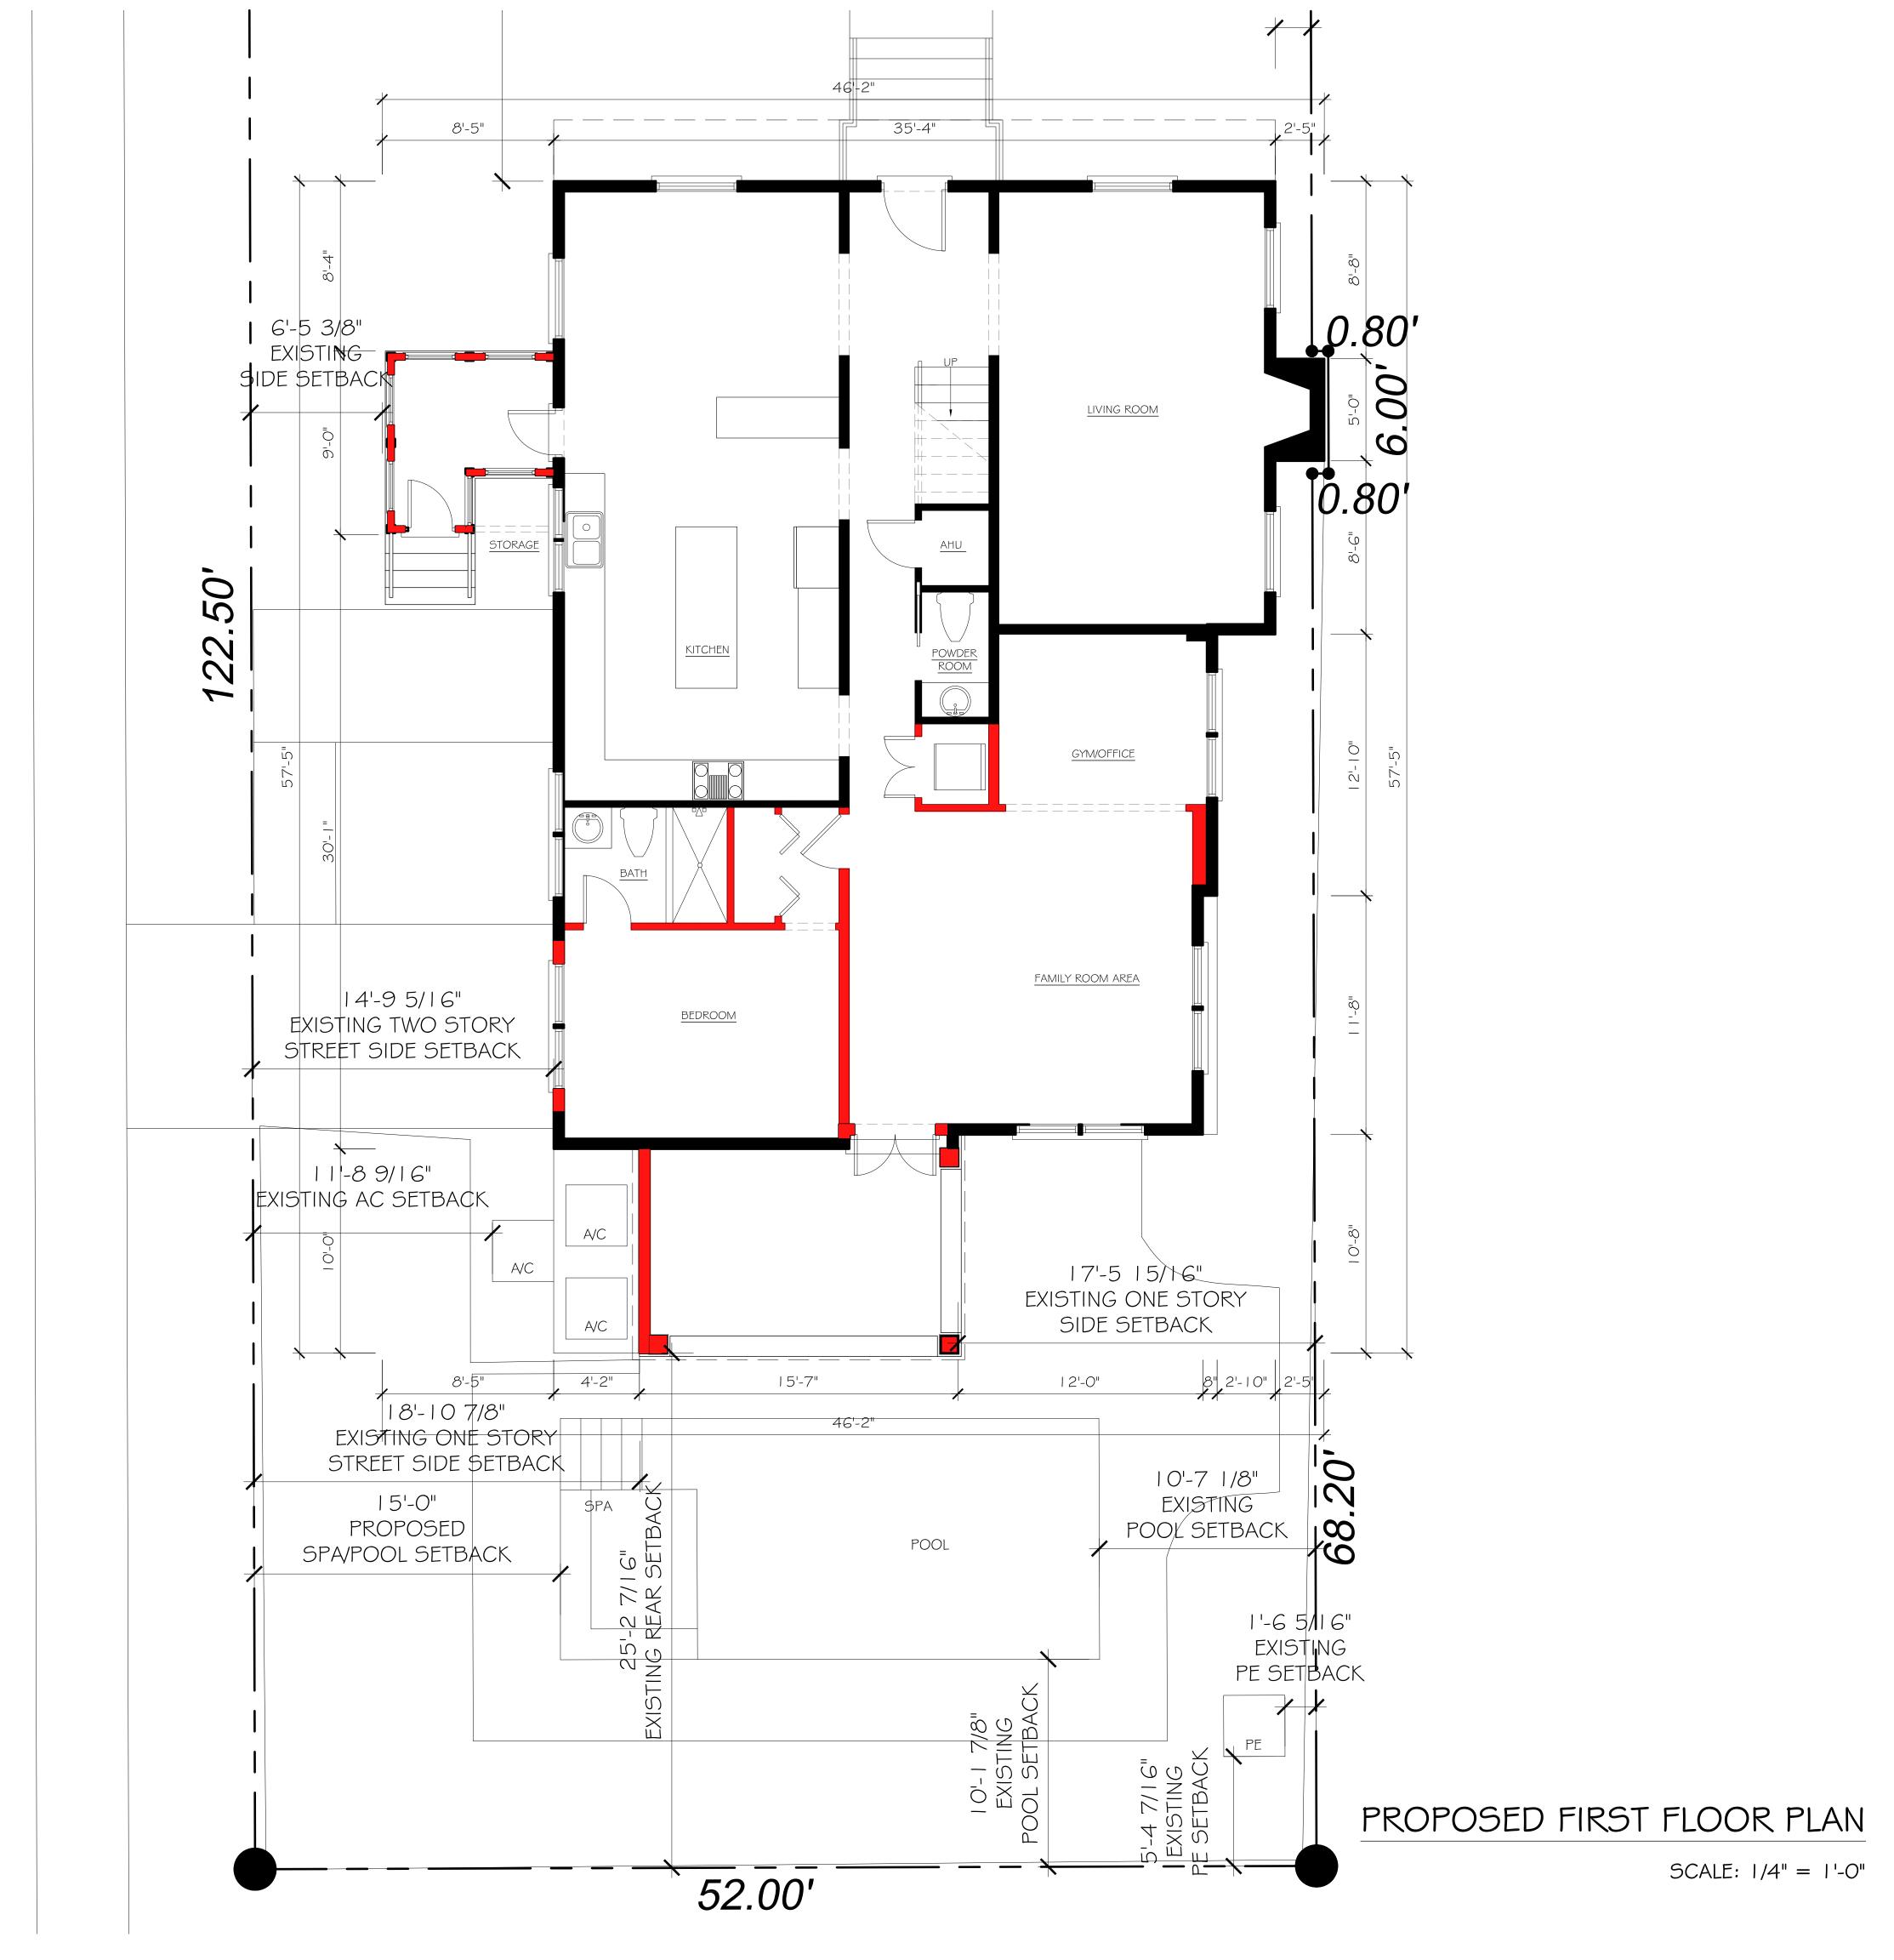


EXISTING

NEW


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OFFICE 561-655-1116 F A X 561-832-7828
249 PERUMAN AVE, SUITE F-2, P A L M B E A C H, F L 33480


CONSULTANT:

MR. AND MRS. JUSTIN BESIKOF
360 SEASPRAY AVENUE
PALM BEACH, FLORIDA 33480

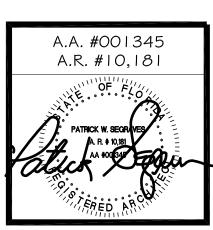


REVISIONS:

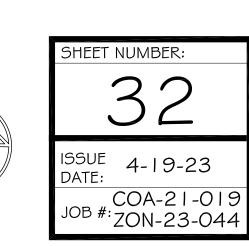

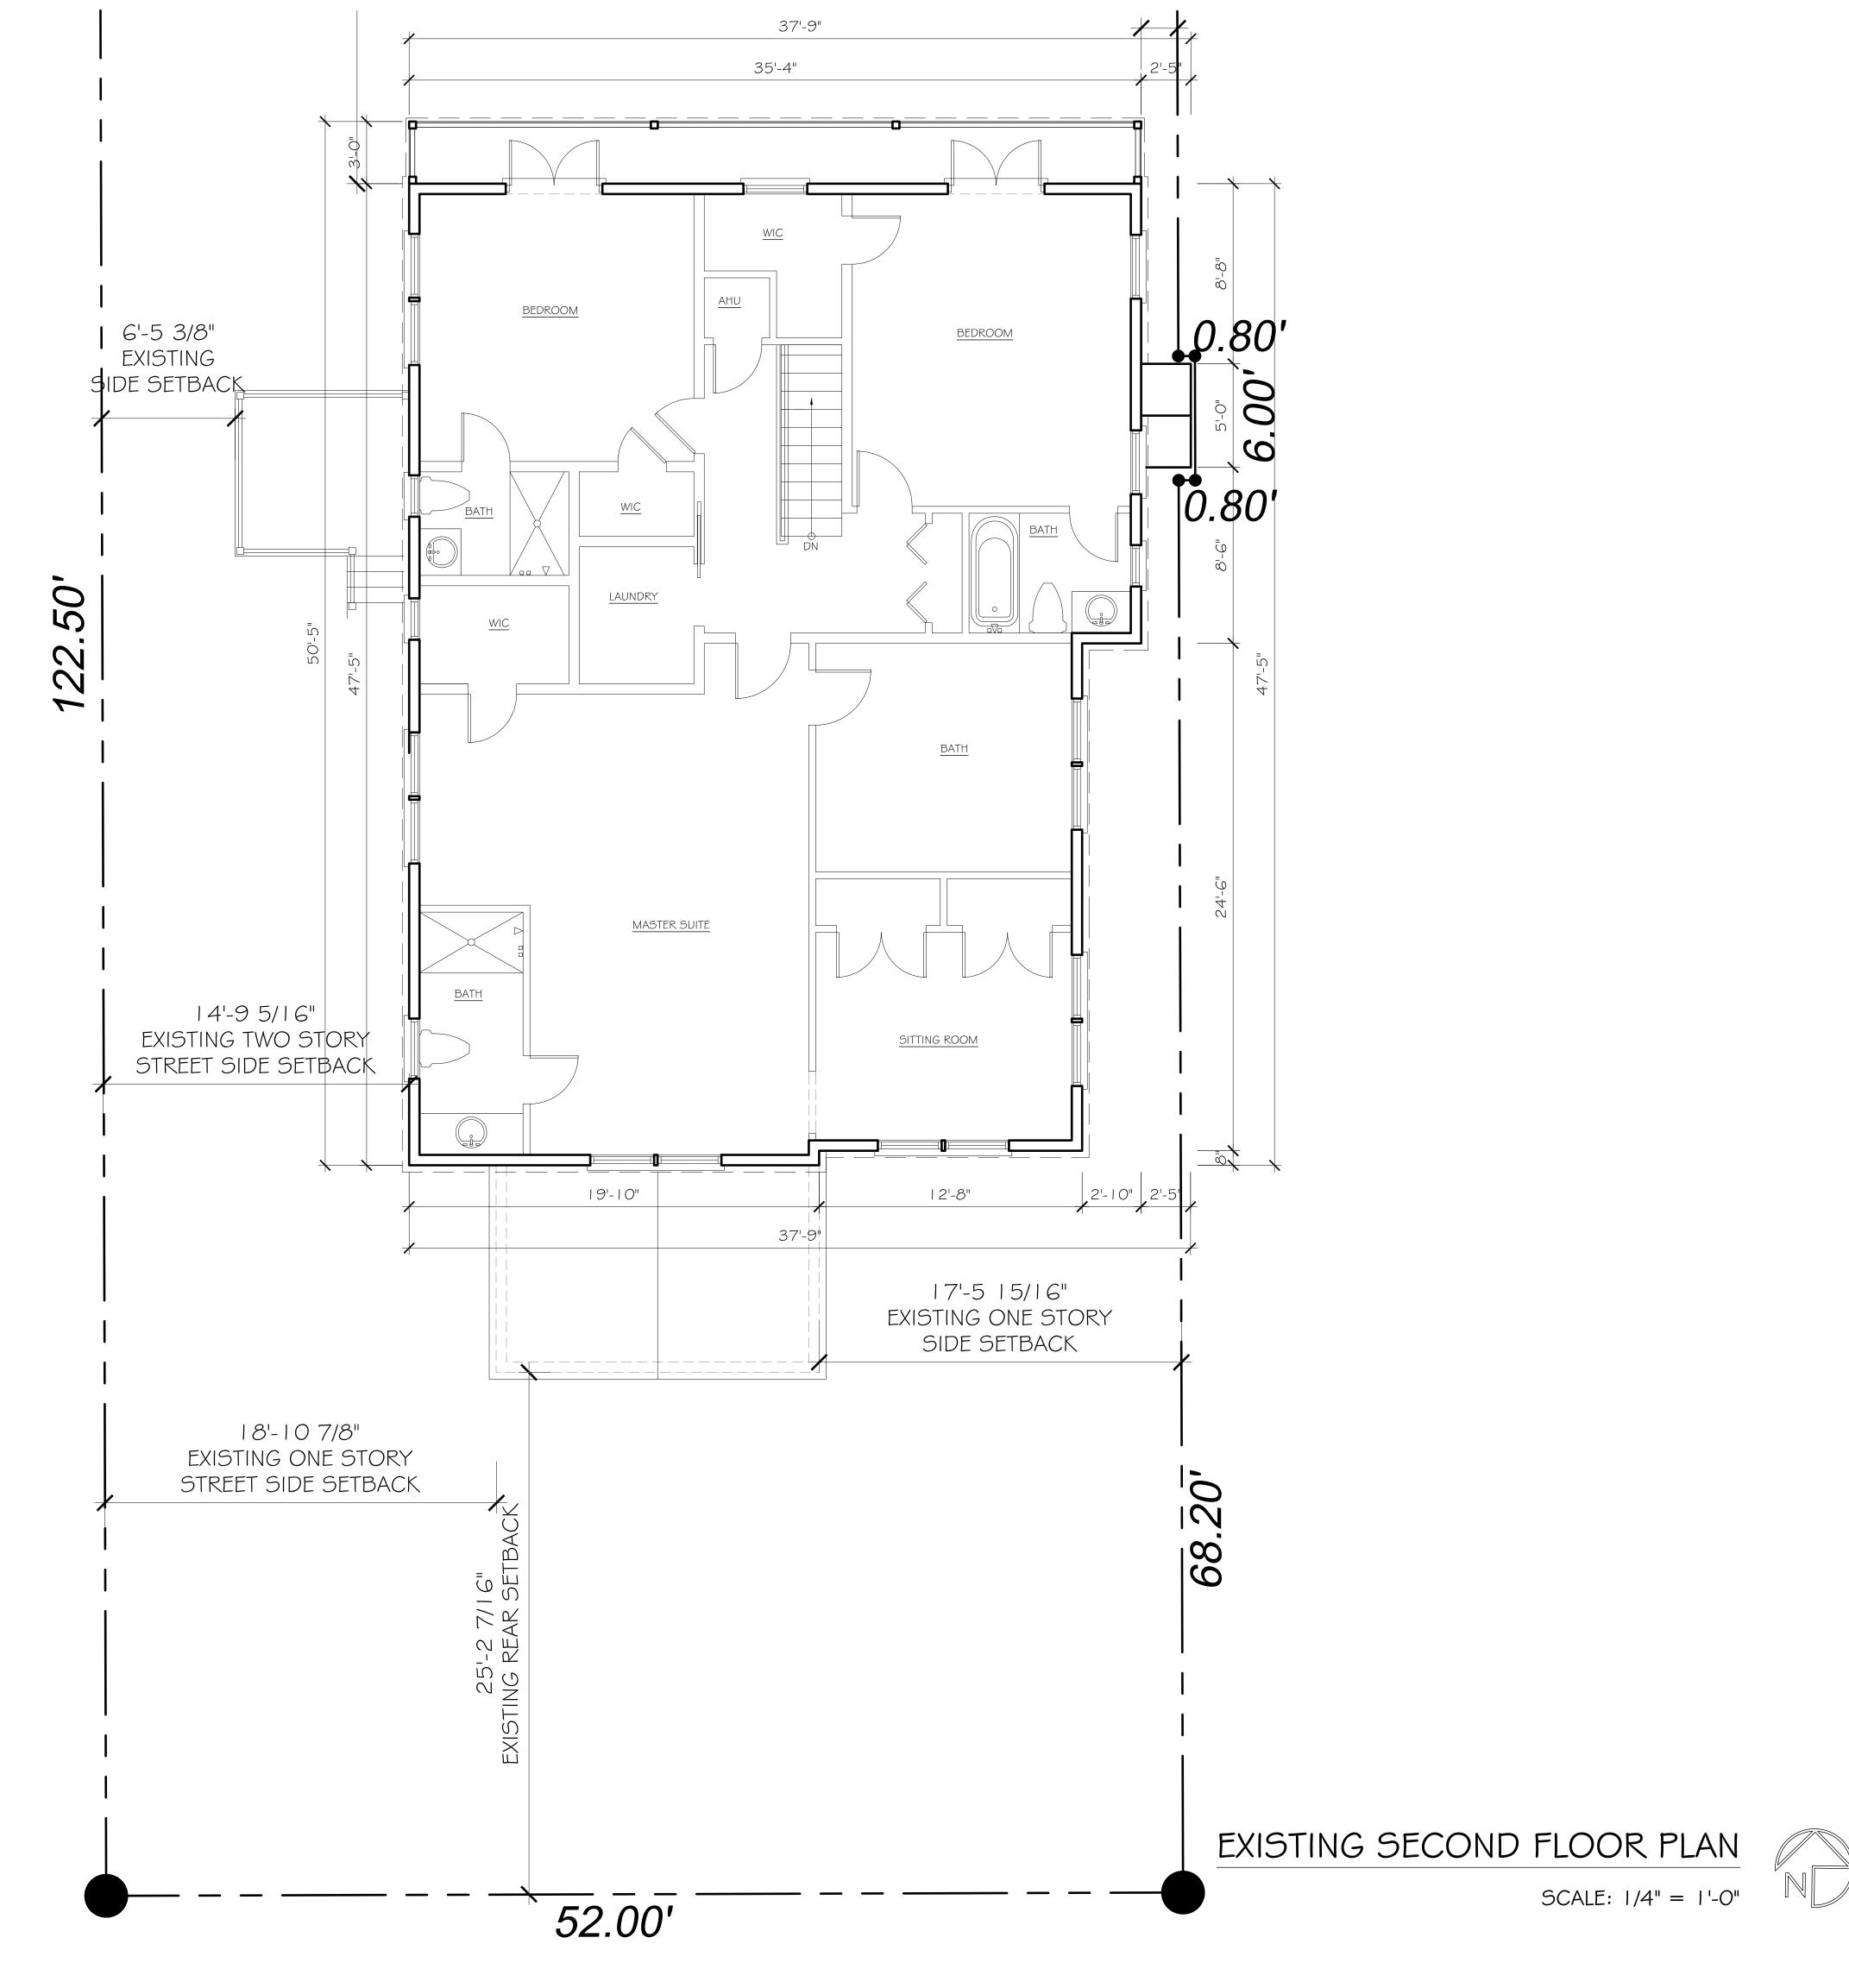





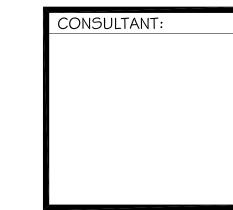


MR. AND MRS. JUSTIN BESIK 360 SEASPRAY AVENUE PALM BEACH, FLORIDA 33480




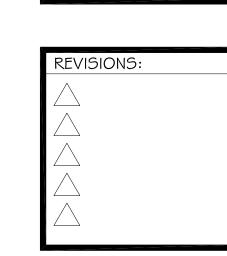

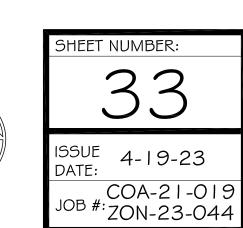

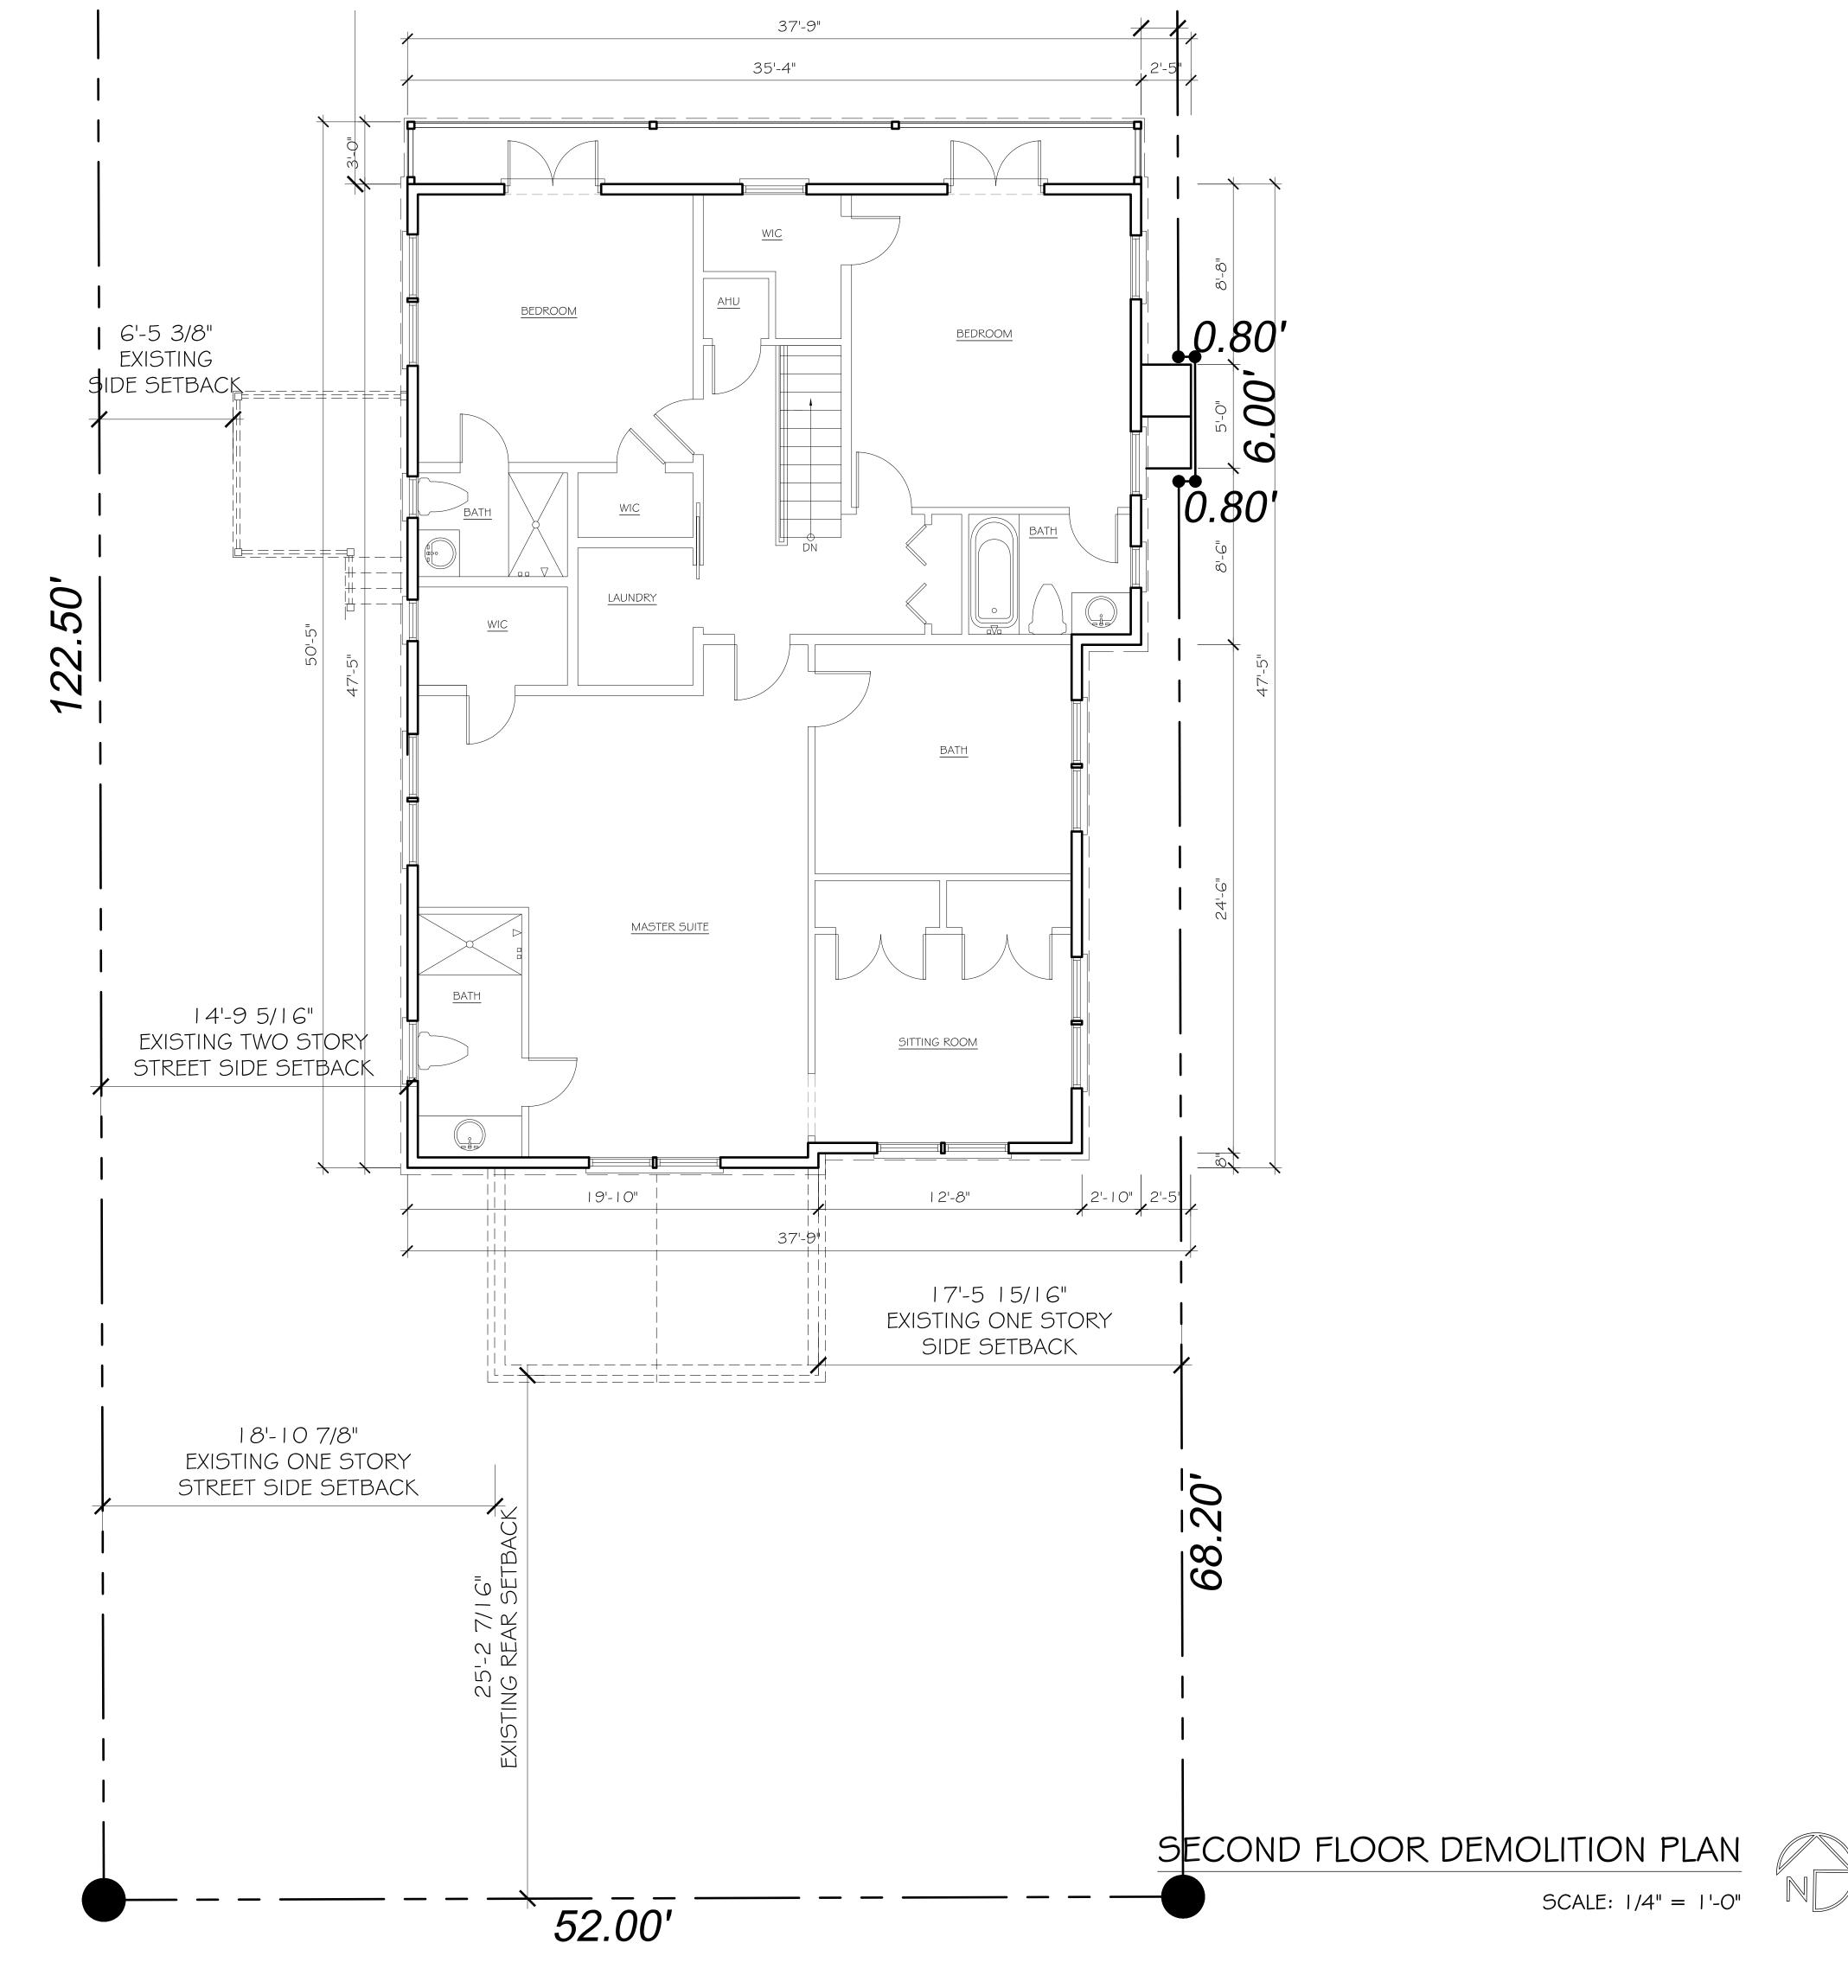



S K A A R C H I T E C T + P L A N N E R
OFFICE 561-655-1116 F A X 561-832-7828
249 PERUMAN AVE, SUITE F-2, P A L M B E A C H, F L 33480

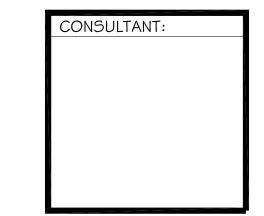


MR. AND MRS. JUSTIN BESIKC 360 SEASPRAY AVENUE PALM BEACH, FLORIDA 33480



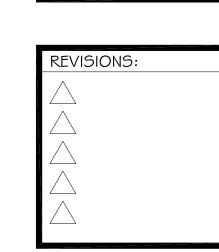

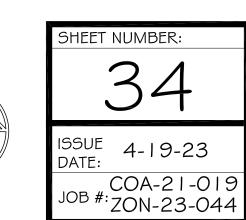


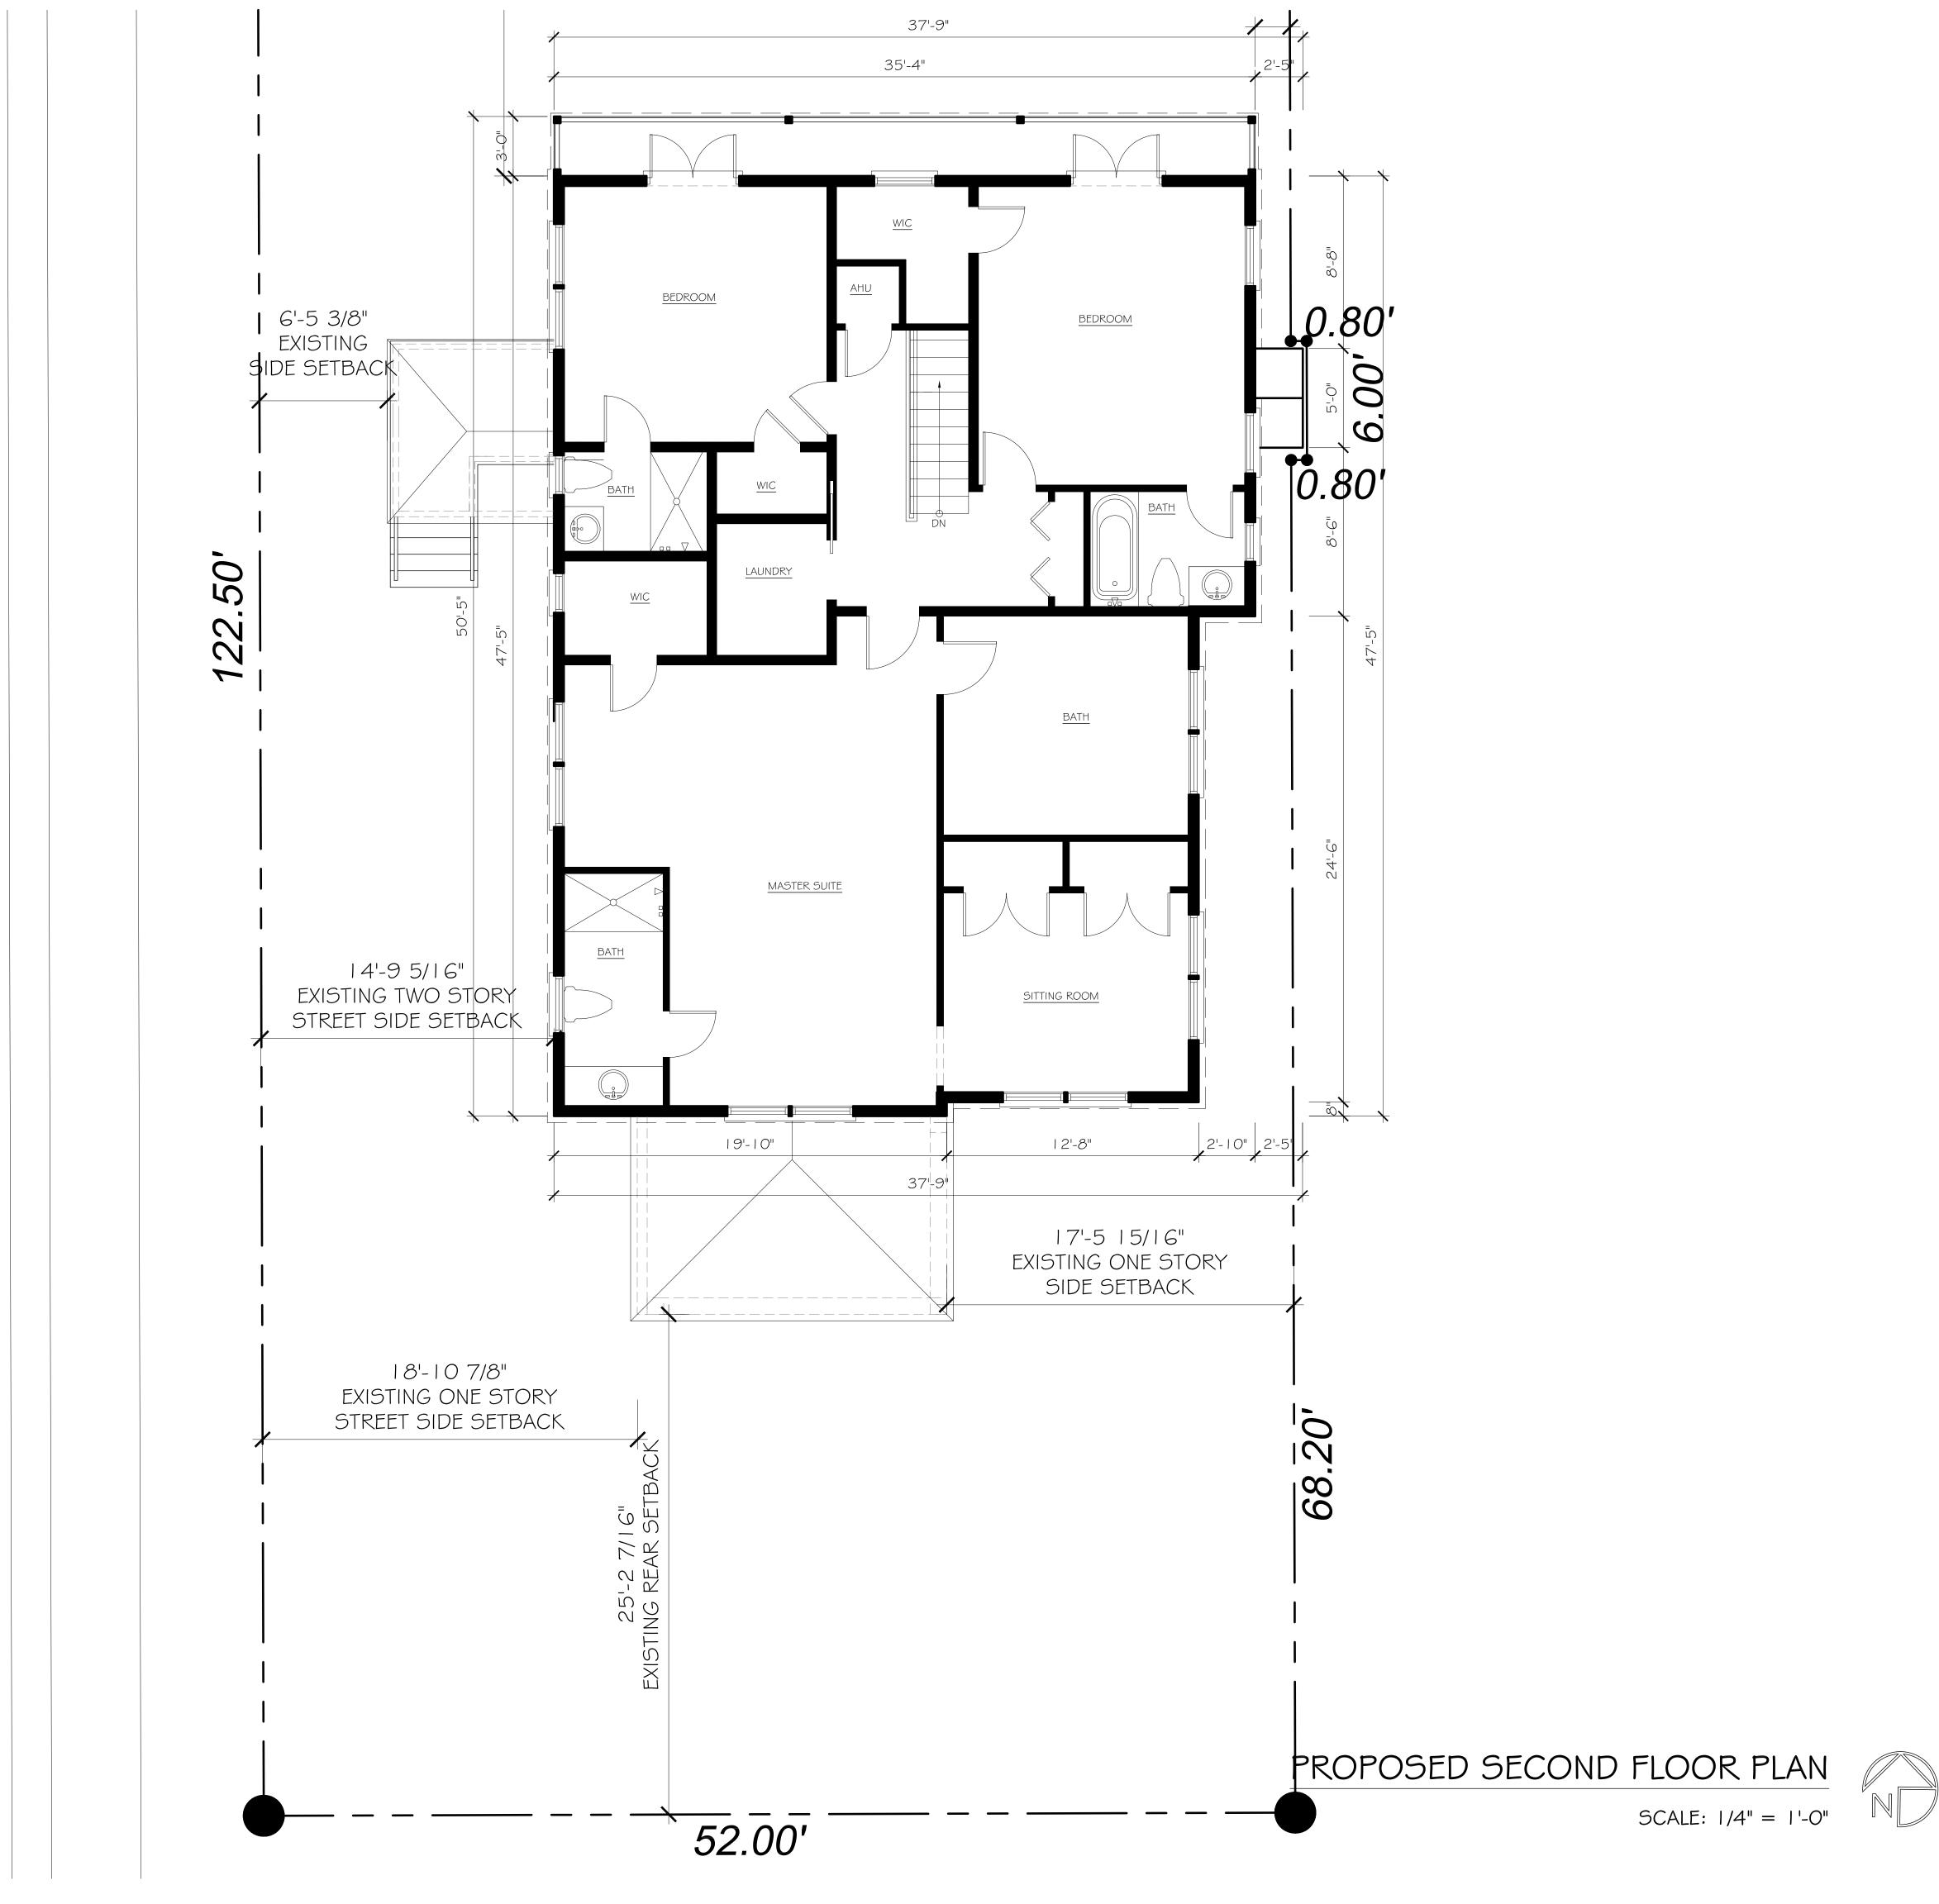


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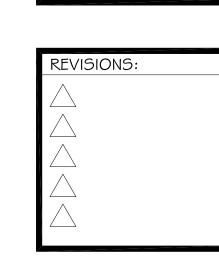
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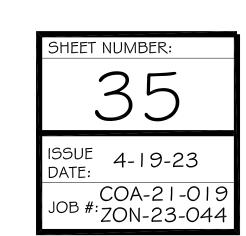
S K A A R C H I T E C T + P L A N N E R
OFFICE 561-655-1116 FAX 561-832-7828
249 PERUVIAN AVE., SUITE F-2, P A L M BE A C H, F L 33480



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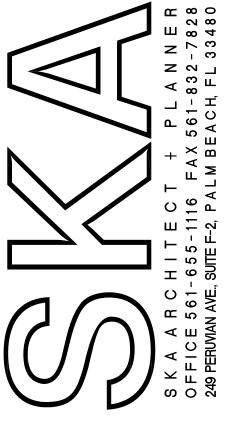
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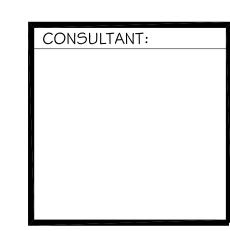
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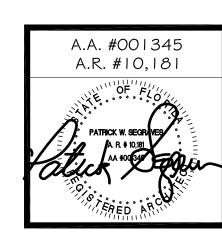
PROPOSED NORTH ELEVATION

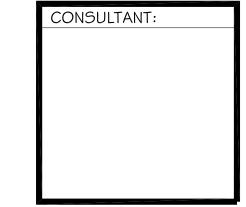
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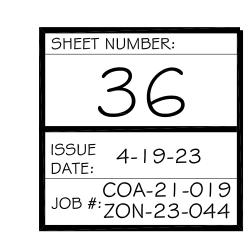


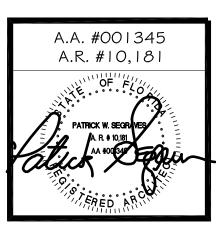

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360 SEASPRAY AVENUE
PAIM BFACH, FLORIDA 33480






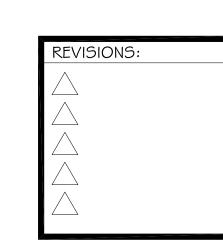




EXISTING SOUTH ELEVATION


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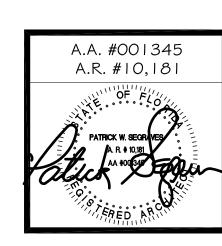
PROPOSED SOUTH ELEVATION

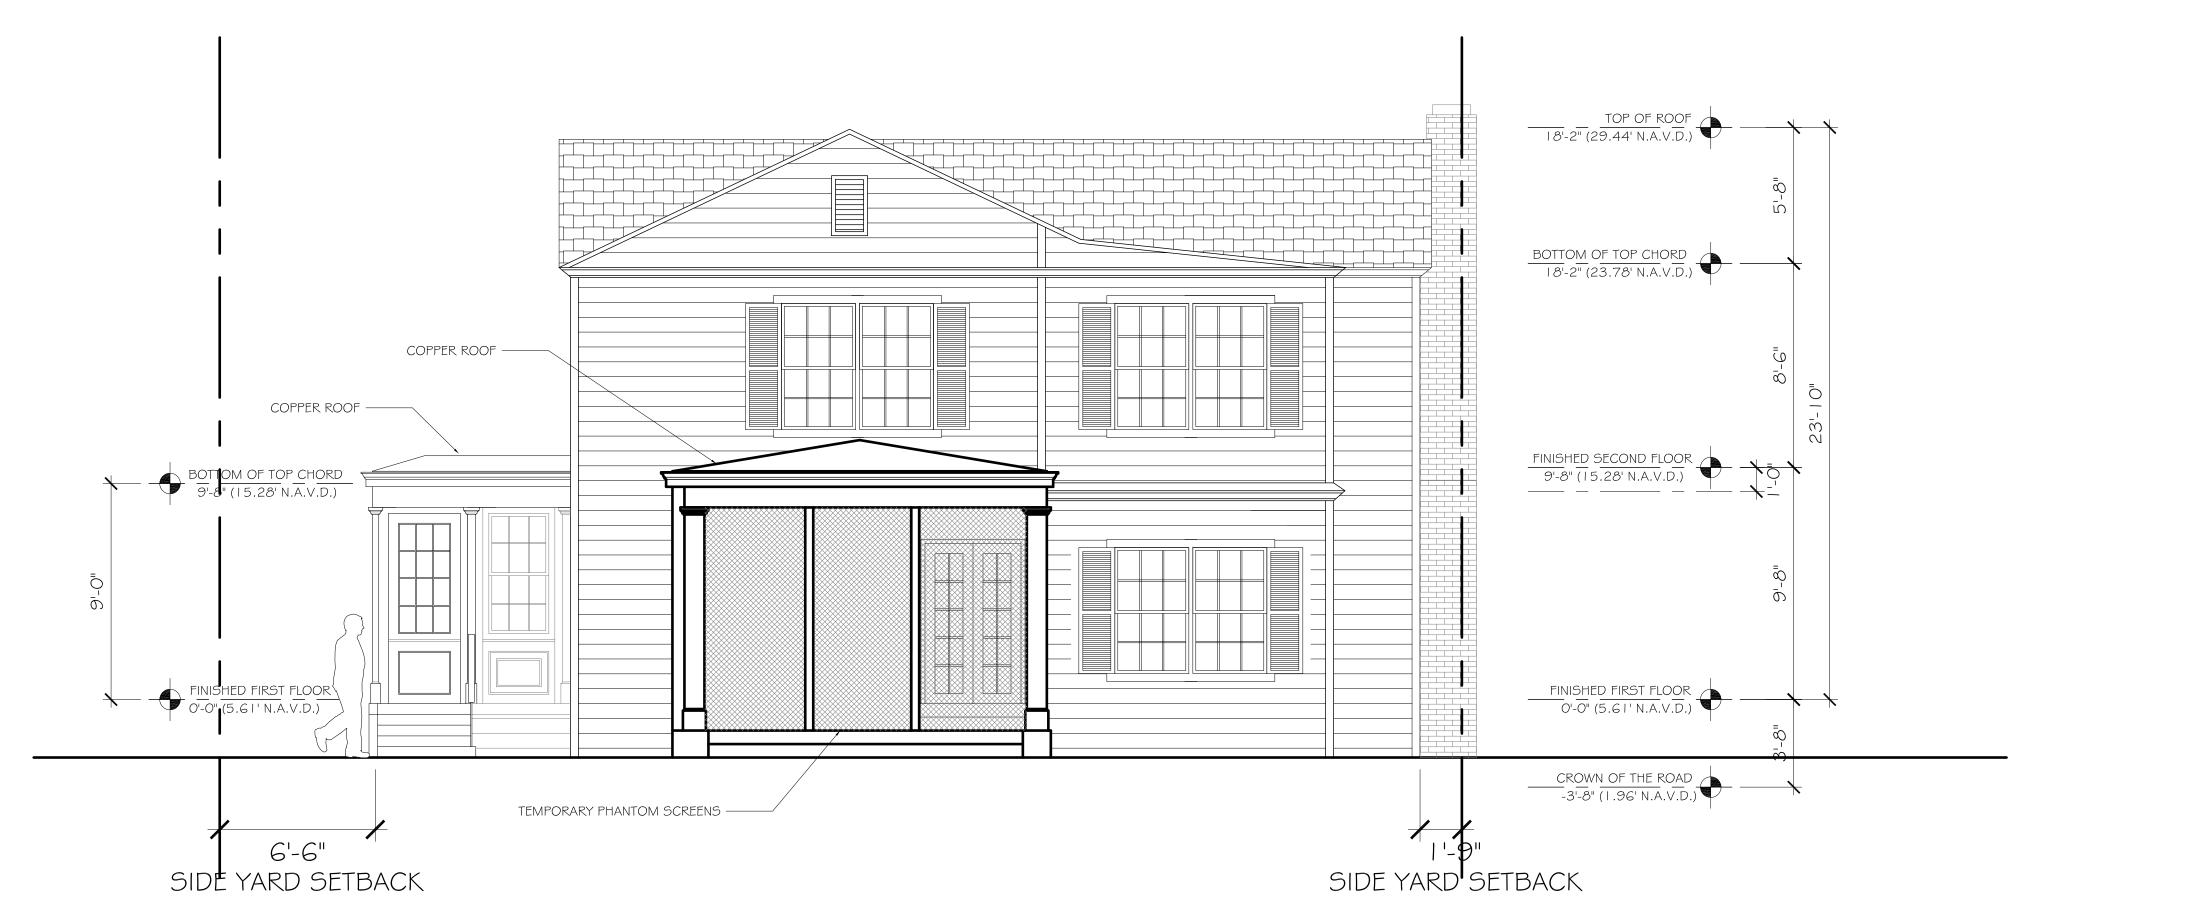
SCALE: 1/4" = 1'-0"



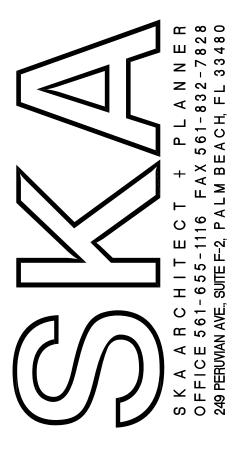

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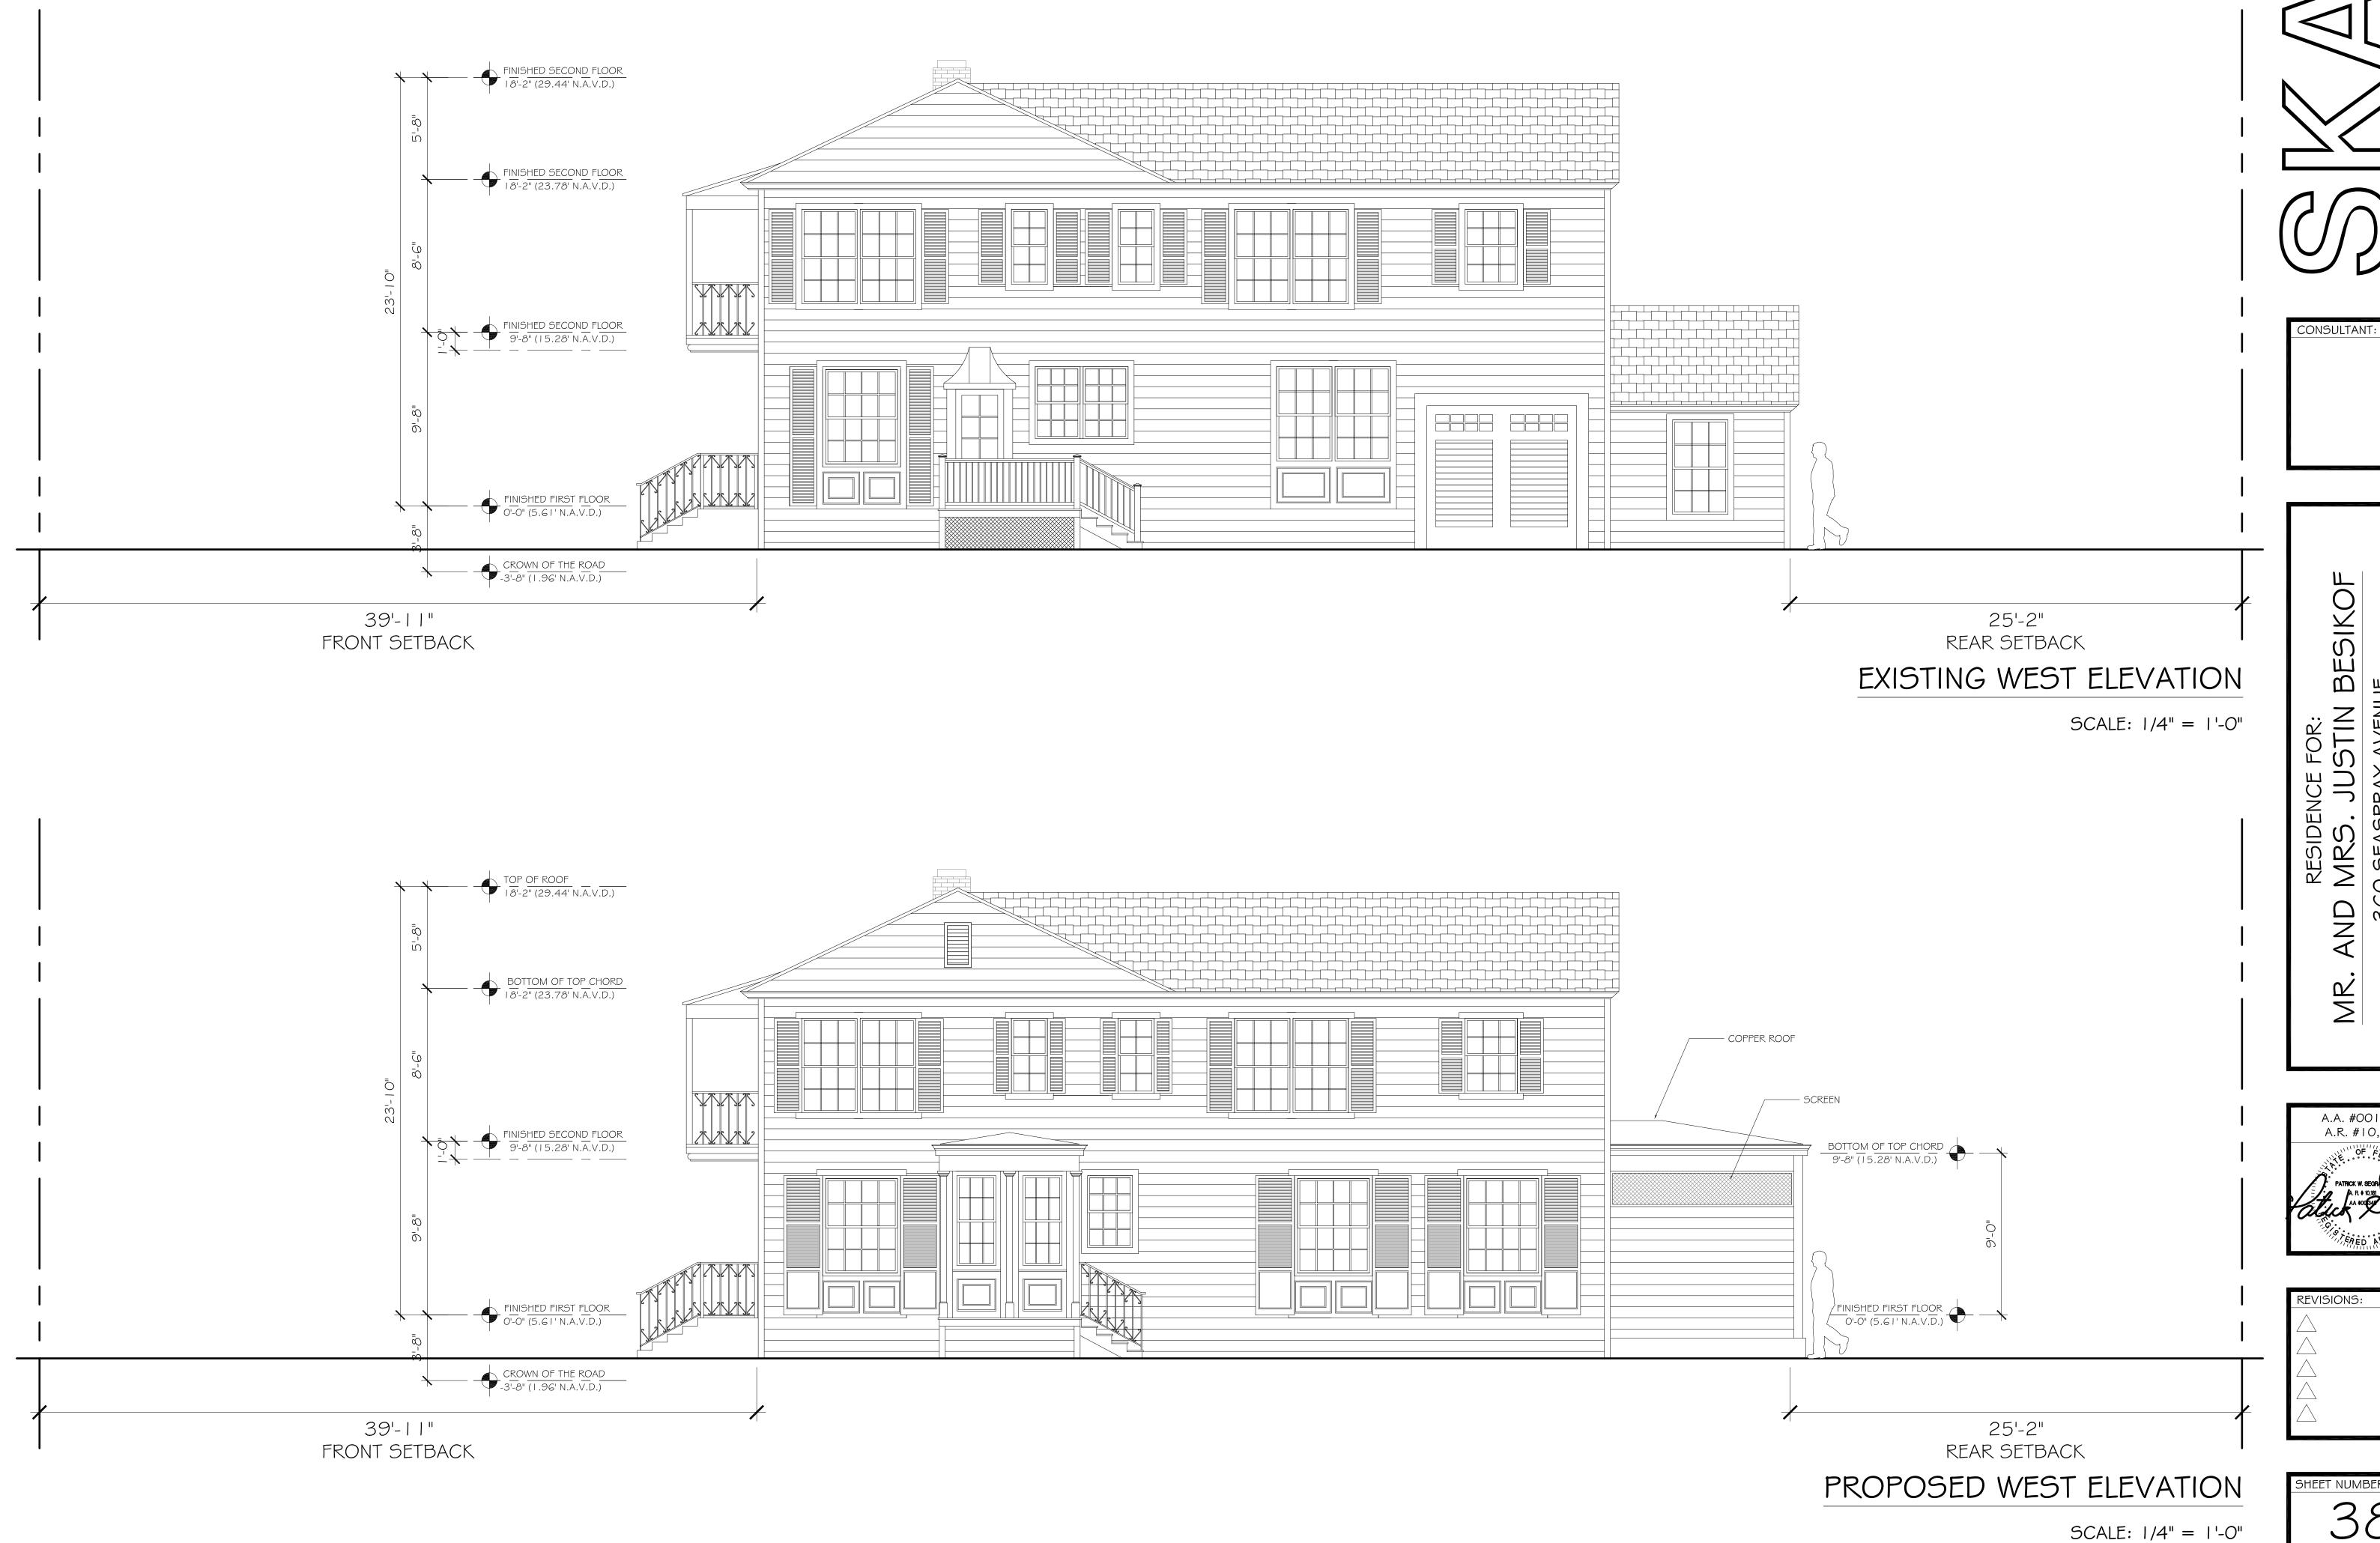


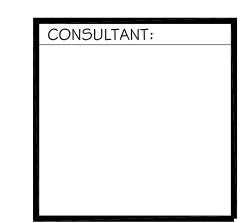

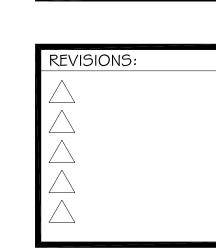SHEET NUMBER:

37

ISSUE 4-19-23
DATE:
COA-21-019
JOB #: ZON-23-044



ASPRAY AVENUE H, FLORIDA 33480


A.A. #001345 A.R. #10,181

SHEET NUMBER: 38 ISSUE 4-19-23 DATE: COA-21-019 JOB #:ZON-23-044




PROPOSED EAST ELEVATION

SCALE: 1/4" = 1'-0"

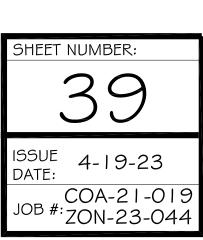

REAR DEMO ELEVATION


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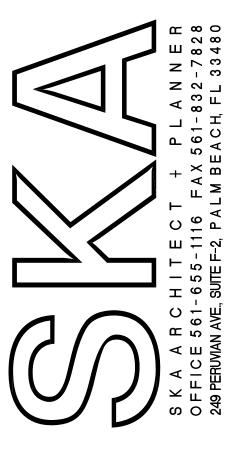


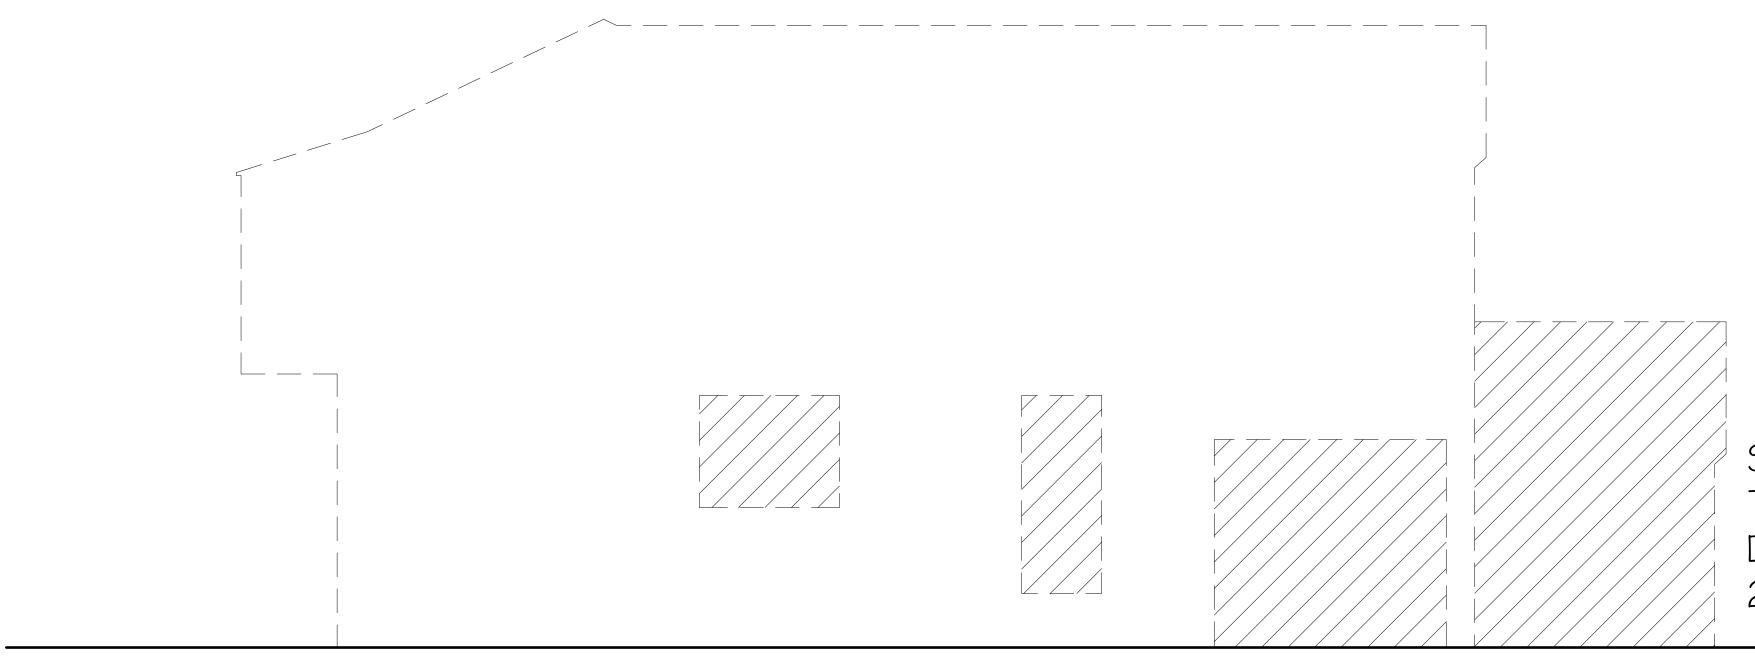
SIDE ELEVATION
TOTAL AREA - 1,380.00 SF
DEMO AREA - 277.00 SF
20.07% DEMO AREA

SIDE DEMO ELEVATION

SCALE: 1/4" = 1'-0"




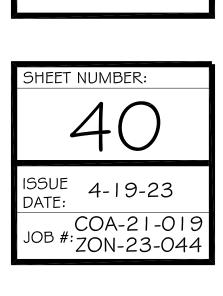

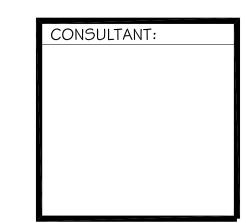

MR. AND MRS. JUSTIN BESIKOF
360 SEASPRAY AVENUE
PALM BEACH, FLORIDA 33480




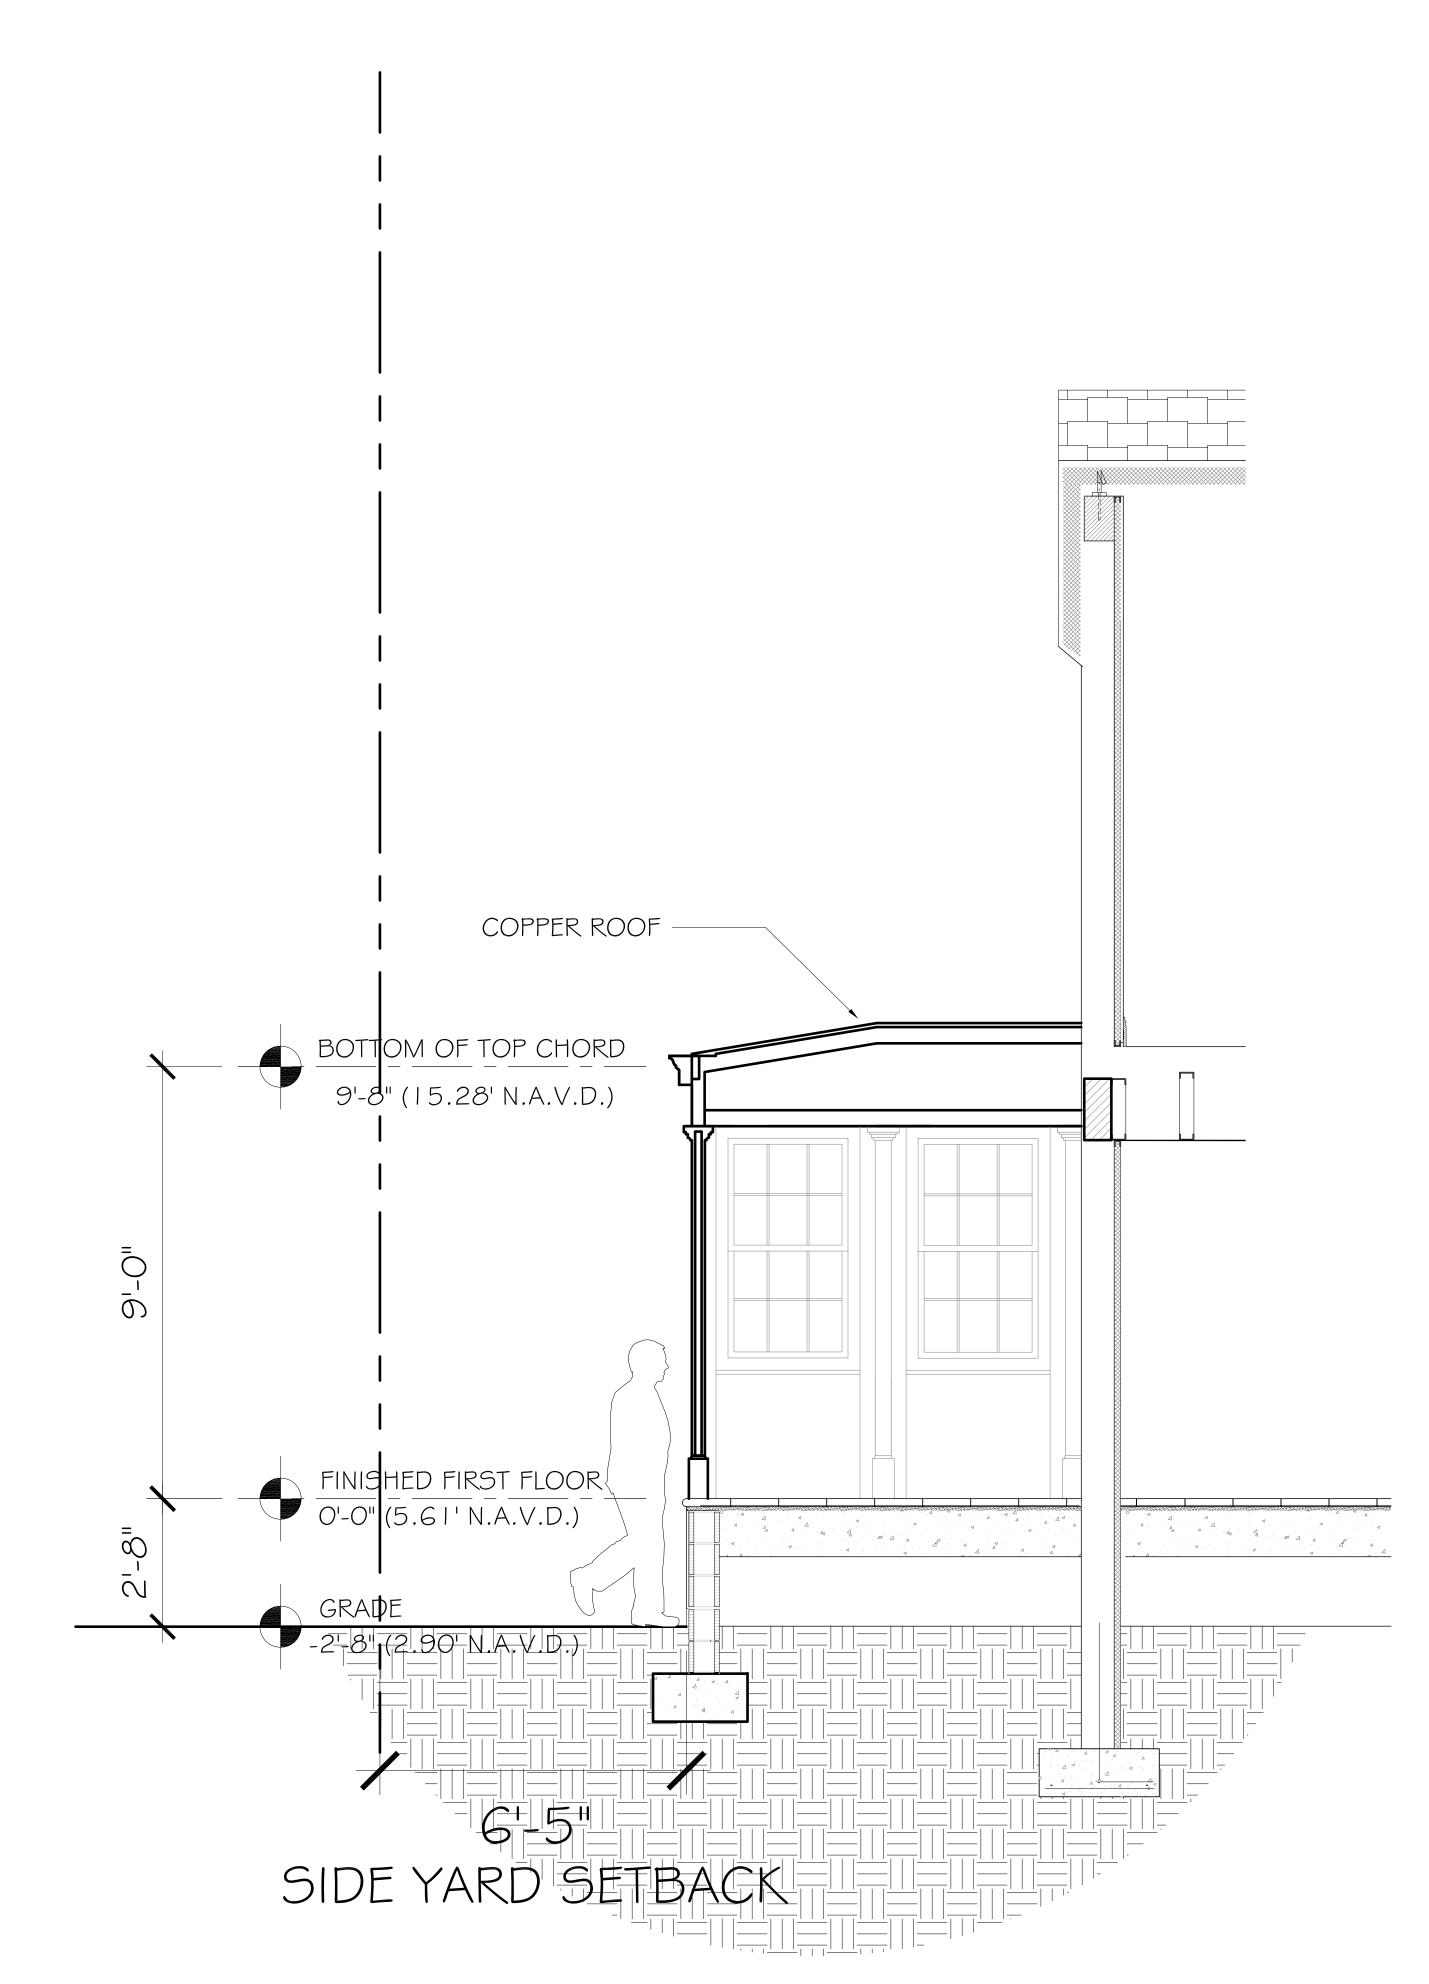




CONSULTANT:

AND MRS. JUSTIN BESIKOF
360 SEASPRAY AVENUE
PALM BEACH, FLORIDA 33480

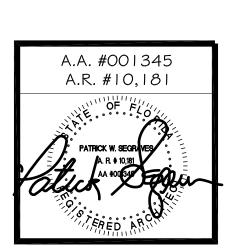

M.


REVISIONS:

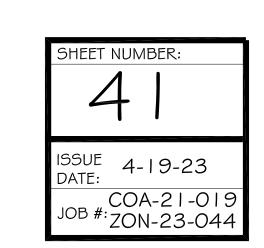

SECTION DETAIL


SCALE: 1/2" = 1'-0"



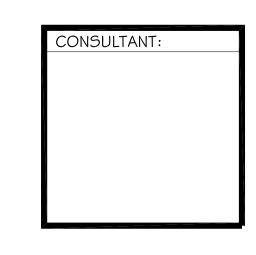

RESIDENCE FOR: AND MRS. JUSTIN BESIKOF 360 SEASPRAY AVENUE PALM BEACH, FLORIDA 33480 Z R



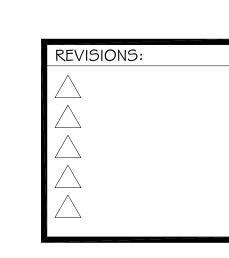

DETAILS

ISSUE 4-19-23 DATE: COA-21-019 JOB #: ZON-23-044

SCALE: 1/2" = 1'-0"



NOTE: SEE SEPARATE "CONSTRUCTION STAGING PLAN" SHEET FOR INFORMATION ON LOCATIONS FOR PARKING, MATERIAL STORAGE, DELIVERIES, DUMPSTER, PORTABLE TOILETS, TIRE CLEANING AREA, SILT FENCE, ETC.

TRUCK ROUTE USES FLAGLER MEMORIAL BRIDGE, TO ROYAL POINCIANNA WAY, TO N COUNTY RD


PROPOSED INGRESS TRUCK ROUTE


PROPOSED EGRESS TRUCK ROUTE

- 30' MAX LENGTH OF VEHICLE TO BE UTILIZED.


- RIGHT OF WAY PERMIT MAY BE REQUIRED IF LARGER TRUCKS NEEDED

- APPROXIMATELY 10 TRUCKS ON SITE DURING CONSTRUCTION

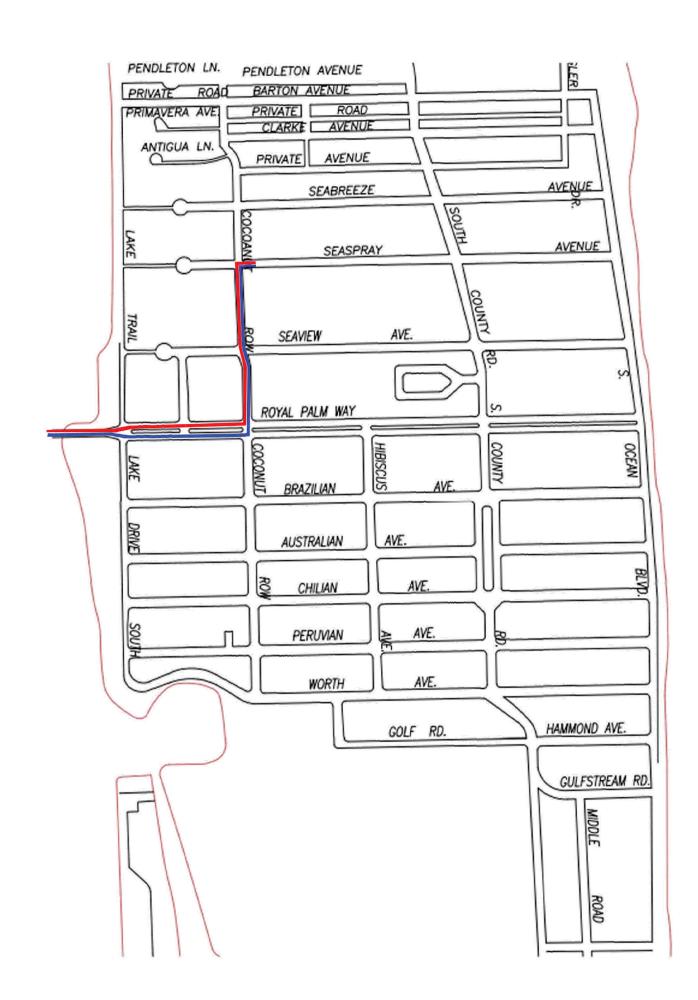


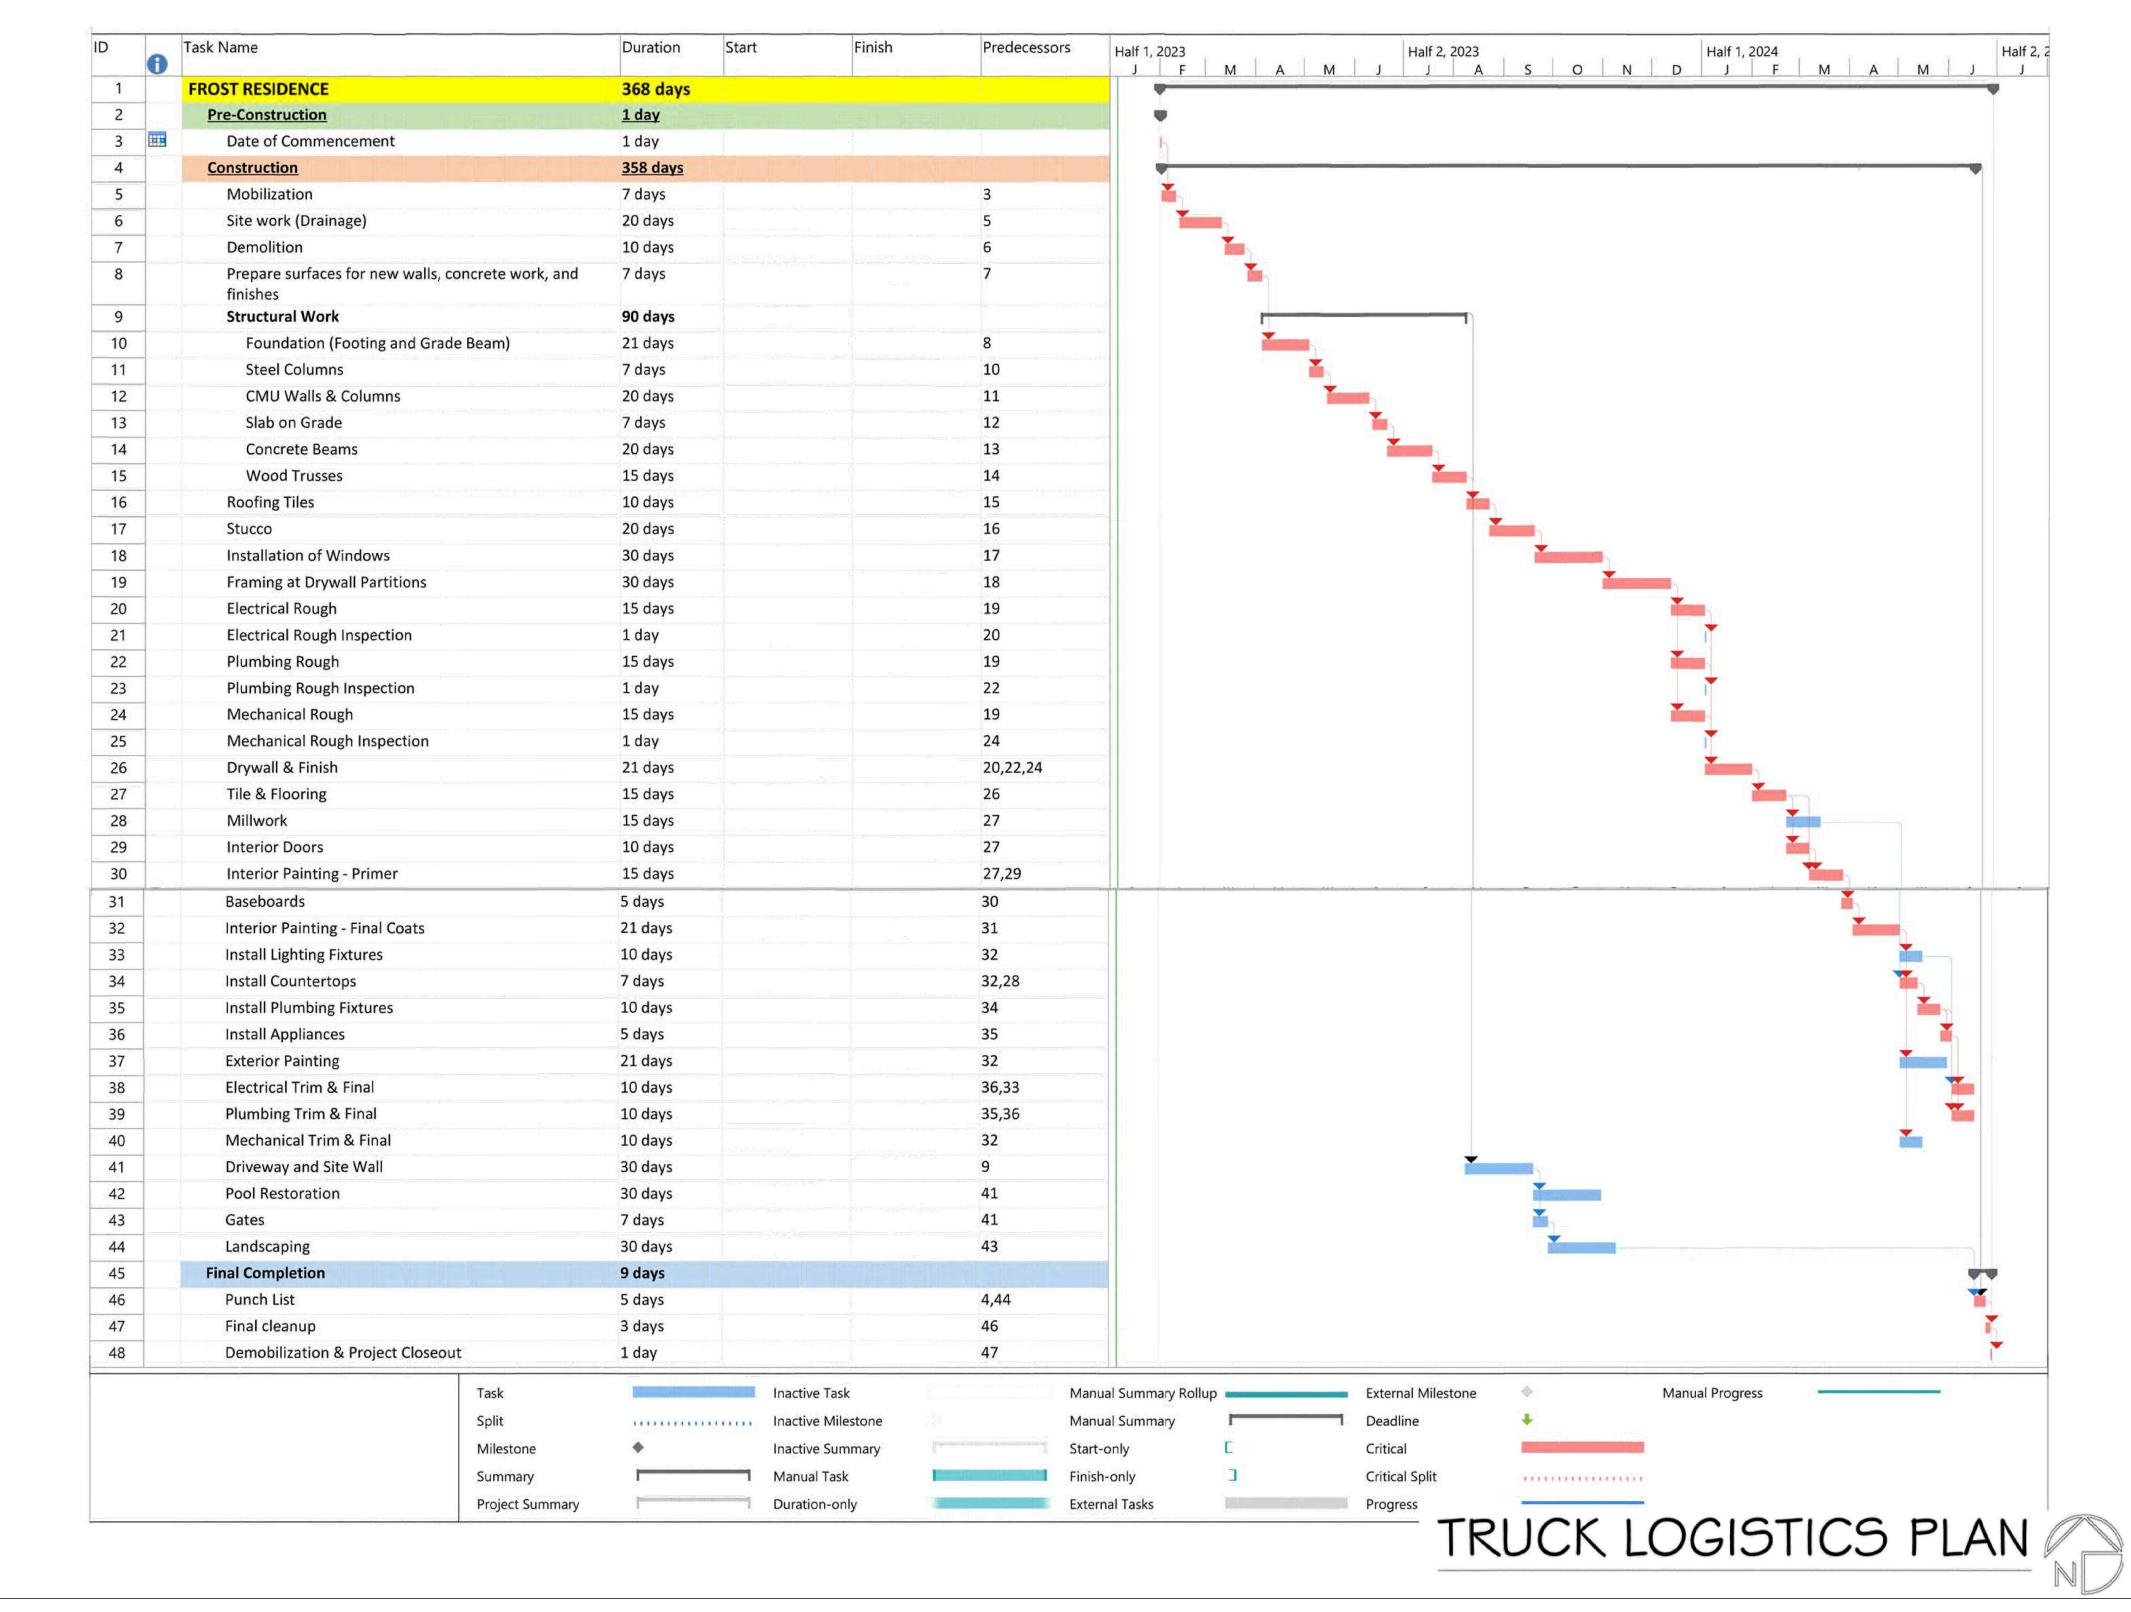





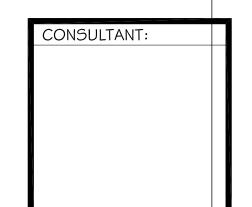


MR. AND MRS. JUSTIN BESIKOF
360 SEASPRAY AVENUE

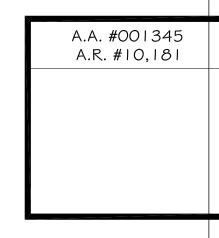

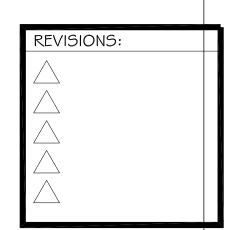

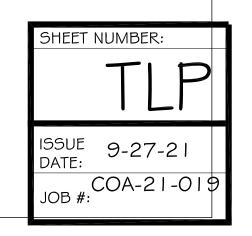

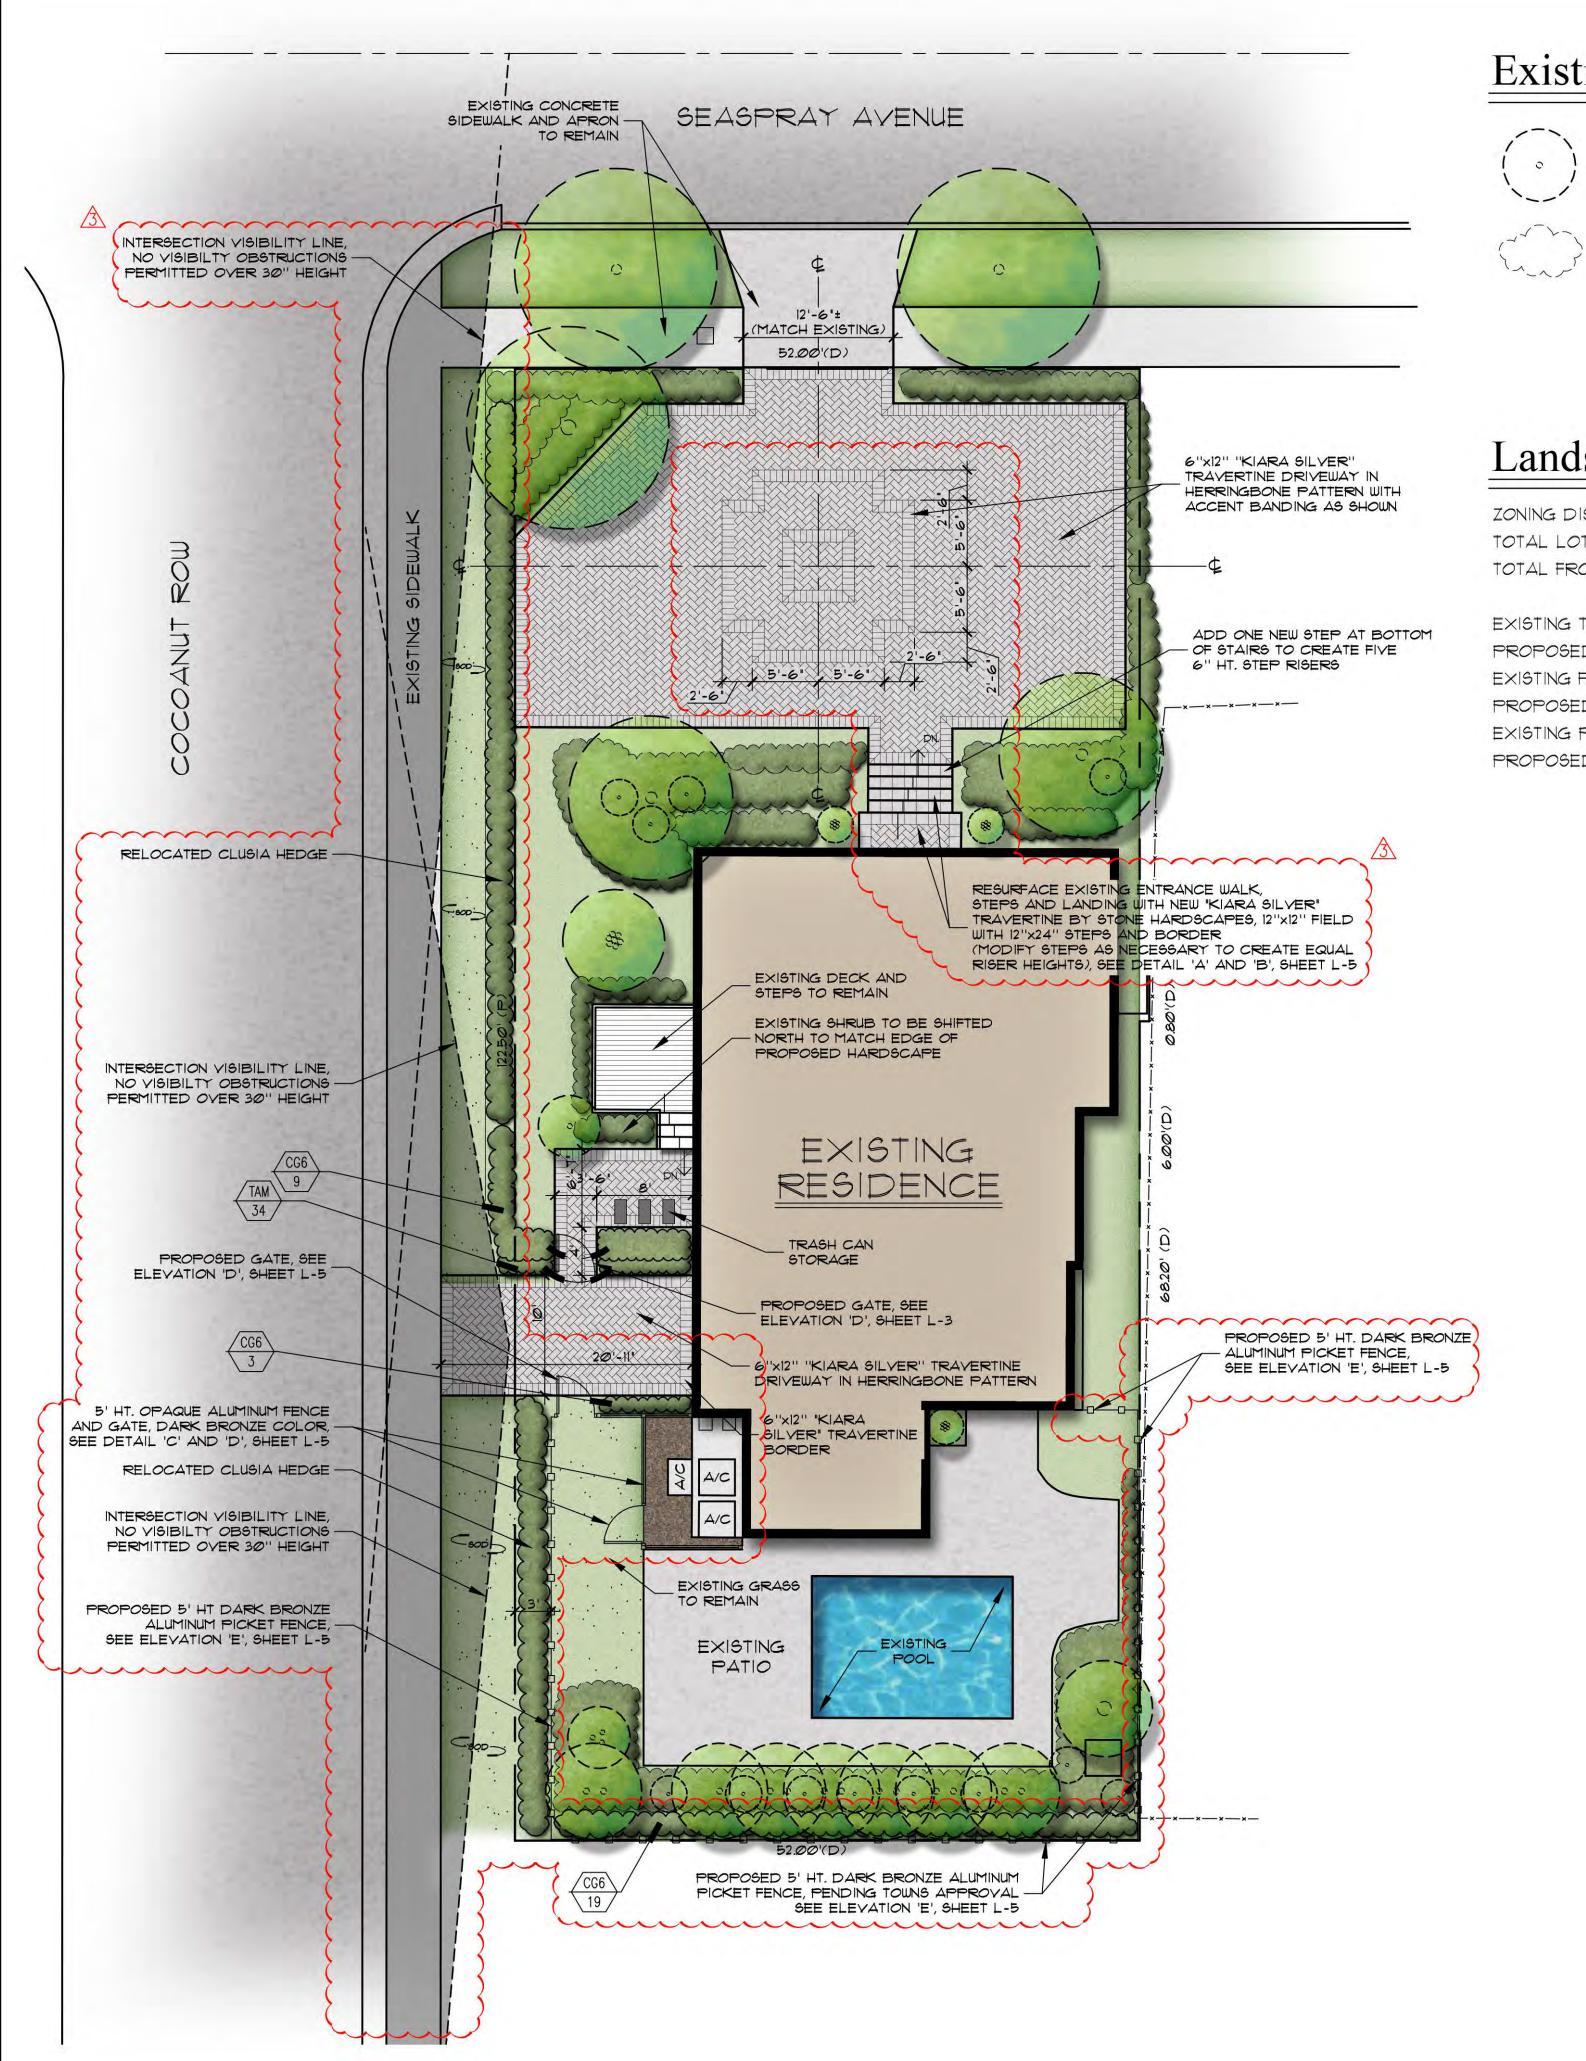

Existing Plant Symbol Key



Existing tree/palm to remain

Existing vegetation to remain

Plant List

SYM QTY NAME ACCENTS / SHRUBS / GROUNDCOVER / VINES

CG6 31 Clusia guttifera / Small Leaf Clusia 6' x 4', full to base 34 Trachelospermum asiaticum 'Minima' / Jasmine 'Minima'

Native Plant Data

EXISTING FLORIDA NATIVE PLANT CONDITIONS TO REMAIN

Landscape Open Space Data

ZONING DISTRICT: RB TOTAL LOT AREA: 6,375 SQ. FT. TOTAL FRONT YARD AREA: 1,300 SQ. FT.

EXISTING TOTAL LANDSCAPED OPEN SPACE: PROPOSED TOTAL LANDSCAPED OPEN SPACE: EXISTING FRONT YARD LANDSCAPED OPEN SPACE: PROPOSED FRONT YARD LANDSCAPED OPEN SPACE: EXISTING PERIMETER LANDSCAPED OPEN SPACE: PROPOSED PERIMETER LANDSCAPED OPEN SPACE:

REQUIRED

45% (2,869 SQ. FT.) 45% (2,869 SQ. FT.) 40% (520 SQ. FT.) 40% (520 SQ. FT.)

50% OF TOTAL REQUIRED OPEN SPACE (1,435 SQ. FT.) 50% OF TOTAL REQUIRED OPEN SPACE (1,4355 SQ. FT.) PROVIDED

30.9% (1,970 SQ. FT.) 31.2% (1,988 SQ. FT.) 38.3% (199 SQ. FT.) 38.3% (199 SQ. FT.)

57.3% OF TOTAL REQUIRED OPEN SPACE (1,645 SQ. FT.) 57.8% OF TOTAL REQUIRED OPEN SPACE (1,659 SQ. FT.)

Currently Proposed
Hardscape/ Landscape Plan

PARKER • YANNETT

design group, inc.

LANDSCAPE ARCHITECTURE PLANNING • GRAPHICS 4425 Military Trail, Suite 202

Telephone:(561) 747-5069 Fax: (561) 747-2041

Email: mail@pydg.com

License #LC-0001347

Jupiter, Florida 33458

DATE: Ø4.14.21 DRAWN BY: SW/KC JOB NO.: 21-082

FILENAME: 360 Seaspray REVISIONS:

SCALE: 1/8"=1'-0"

6.16.21 Staff Review 7.13.21 Staff Review 10.8.21 First Submittal 11.01.21 Final Submittal 🐧

