RECEIVED By Antonette Fabrizi at 8:53 am, Apr 07, 2023

## 363 Cocoanut Row, Palm Beach, FL 33480

## **SCOPE OF WORK**

THE PROPOSED WORK INCLUDES THE RENOVATION OF THE EXISTING 4-STORY 32,758 SQUARE FOOT HOTEL. THE SCOPE OF WORK INCLUDES THE COMPLETE EXTERIOR AND INTERIOR RENOVATION INCLUDING THE REDUCTION OF ROOMS FROM 57 KEYS TO 41, THE RECONSTRUCTION OF HISTORIC DOOR AND WINDOW LOCATIONS AND ASSOCIATED HARDSCAPE/LANDSCAPE. THERE ARE NO PROPOSED MODIFICATIONS TO THE NUMBER OF **EXISTING PARKING SPACES.** 



285 BANYAN BLVD WEST PALM BEACH, FLORIDA 33401

ph: 561.684.6844 • spinaorourke.com

FL Lic. # AA26002399

TINO ZERVUDACHI & ASSOCIES ARCHITECTURE INTERIEURE ET DECORATION



SHEET NAME	
COVER	COVER
00101	
AC-0.1.0	VICINITY LOCATION MAP
AC-0.2.0	SUBJECT PROPERTY IMAGES
AC-0.2.1	SUBJECT PROPERTY IMAGES
AC-0.2.2	SUBJECT PROPERTY IMAGES
AC-0.2.3	SUBJECT PROPERTY IMAGES
AC-0.2.4	SUBJECT PROPERTY IMAGES
AC-0.2.5	SUBJECT PROPERTY IMAGES
AC-0.3.0	ADJACENT PROPERTY IMAGES
AC-0.3.1	ADJACENT PROPERTY IMAGES
AC-0.3.2	ADJACENT PROPERTY IMAGES
AC-0.3.3	ADJACENT PROPERTY IMAGES
AC-0.3.4	ADJACENT PROPERTY IMAGES
AC-1.0.0	ZONING LEGEND
AC-1.1.0	EXISTING OVERALL SITE PLAN
AC-1.1.1	PROPOSED OVERALL SITE PLAN
AC-1.2.0	ZONING DIAGRAMS
AC-1.2.1	VARIANCE DIAGRAMS
AC-1.3.0	HISTORIC REFERENCE IMAGES
AC-1.3.1	HISTORIC REFERENCE IMAGES
AC-1.3.2	HISTORIC REFERENCE IMAGES
AC-2.1.0	EXISTING FLOOR PLAN - GROUND FLOOR
AC-2.1.1	DEMOLITION FLOOR PLAN - GROUND FLOOR
AC-2.1.2	PROPOSED FLOOR PLAN - GROUND FLOOR
AC-2.2.0	EXISTING FLOOR PLAN - SECOND FLOOR
AC-2.2.1	DEMOLITION FLOOR PLAN - SECOND FLOOR
AC-2.2.1 AC-2.2.2	PROPOSED FLOOR PLAN - SECOND FLOOR
AC-2.2.2 AC-2.3.0	EXISTING FLOOR PLAN - THIRD FLOOR
AC-2.3.0 AC-2.3.1	DEMOLITION FLOOR PLAN - THIRD FLOOR
AC-2.3.2	PROPOSED FLOOR PLAN - THIRD FLOOR
AC-2.4.0	EXISTING FLOOR PLAN - FOURTH FLOOR & ROOF PLAN
AC-2.4.1	DEMOLITION FLOOR PLAN - FOURTH FLOOR & ROOF PLAN
AC-2.4.2	PROPOSED FLOOR PLAN - FOURTH FLOOR & ROOF PLAN
AC-3.1.0 AC-3.1.1	EXISTING HIGH ROOF PLAN
AC-3.1.1 AC-3.1.2	DEMOLITION HIGH ROOF PLAN
	PROPOSED HIGH ROOF PLAN
AC-4.1.0	OVERALL DEMOLITION ELEVATIONS
AC-4.1.1 AC-4.1.2	OVERALL DEMOLITION ELEVATIONS  DEMOLITION ELEVATION DIAGRAMS
AC-4.2.1 AC-4.2.2	EXISTING & PROPOSED WEST ELEVATION  COLORED WEST ELEVATIONS
AC-4.3.1 AC-4.3.2	EXISTING & PROPOSED NORTH ELEVATION
AC-4.4.1	COLORED NORTH ELEVATIONS  EXISTING & PROPOSED EAST ELEVATION
AC-4.4.2	COLORED EAST ELEVATIONS
AC-4.5.1	EXISTING & PROPOSED SOUTH ELEVATION
AC-4.5.1 AC-4.5.2	COLORED SOUTH ELEVATIONS
AC-4.6.1	EXISTING & PROPOSED COURTYARD ELEVATIONS
AC-4.6.2	COLORED COURTYARD ELEVATIONS
AC-4.0.2 AC-4.7.1	
	EXTERIOR RENDERINGS
AC-4.7.2	EXTERIOR RENDERINGS
AC-4.7.3	EXTERIOR RENDERINGS
AC-4.7.4	EXTERIOR RENDERINGS
AC-4.7.5	EXTERIOR RENDERINGS
AC-4.7.6	EXTERIOR RENDERINGS
AC-4.7.7	EXTERIOR RENDERINGS
AC-4.7.8	EXTERIOR RENDERINGS
AC-5.1.0	BUILDING & YARD SECTION DIAGRAM
AC-5.1.1	BUILDING & YARD SECTION DIAGRAM
AC-6.1.0	EXTERIOR MATERIAL & FINISH SHEET
AC-6.2.0	EXTERIOR DETAILS - TYPICAL
AC-6.2.1	EXTERIOR DETAILS - VALET CANOPY
AC-6.3.0	EXTERIOR DOOR & WINDOW DETAILS
AC-6.4.0	EXTERIOR WALL AND GATE PLAN AND DETAILS
AC-6.5.0	EXTERIOR SIGNAGE PLAN AND DETAILS
AC-7.1.0	EXISTING SEATING PLAN
AC-7.1.1	PROPOSED SEATING PLAN
	The section of the se
L1.1	EXISTING GENERAL SITE PHOTOS
L1.1 L2.0	EXISTING GENERAL SITE PHOTOS  EXISTING VEGETATION INVENTORY & ACTION PLAN
L2.0	EXISTING VEGETATION INVENTORY & ACTION PLAN
L2.0 L4.0	EXISTING VEGETATION INVENTORY & ACTION PLAN CONSTRUCTION SCREENING PLAN
L2.0 L4.0 L5.0	EXISTING VEGETATION INVENTORY & ACTION PLAN CONSTRUCTION SCREENING PLAN CONSTRUCTION STAGING PLAN
L2.0 L4.0 L5.0 L6.0	EXISTING VEGETATION INVENTORY & ACTION PLAN  CONSTRUCTION SCREENING PLAN  CONSTRUCTION STAGING PLAN  TRUCK LOGISTICS PLAN
L2.0 L4.0 L5.0 L6.0 L7.1	EXISTING VEGETATION INVENTORY & ACTION PLAN  CONSTRUCTION SCREENING PLAN  CONSTRUCTION STAGING PLAN  TRUCK LOGISTICS PLAN  EXISTING VS PROPOSED SITE DATA
L2.0 L4.0 L5.0 L6.0 L7.1 L8.0	EXISTING VEGETATION INVENTORY & ACTION PLAN CONSTRUCTION SCREENING PLAN CONSTRUCTION STAGING PLAN TRUCK LOGISTICS PLAN EXISTING VS PROPOSED SITE DATA LANDSCAPE PLAN
L2.0 L4.0 L5.0 L6.0 L7.1 L8.0 L8.2	EXISTING VEGETATION INVENTORY & ACTION PLAN  CONSTRUCTION SCREENING PLAN  CONSTRUCTION STAGING PLAN  TRUCK LOGISTICS PLAN  EXISTING VS PROPOSED SITE DATA  LANDSCAPE PLAN  PLANT SCHEDULE

## REVISED LANDMARKS 04-06-2023

LPC# COA-23-002 (JANUARY 2023)

ZONING# ZON-23-019 (FEBRUARY 2023)

**Landscape Architect EDG** 

139 NORTH COUNTY ROAD, SUITE 20-B, PALM BEACH, FL 33480

**Civil Engineer** S&W

2581 METROCENTRE BLVD., SUITE 3, WEST PALM BEACH, FL 33407

EXCLUSIVE USE OF SPINA OROURKE + PARTNERS, INC. AND MAY NOT BE DUPLICATED, REPRODUCED OR USED IN

WRITTEN CONSENT OF SPINA OROURKE + PARTNERS, INC. ALL RIGHTS RESERVED

Project no: 22028 Date: 12.23.2022 Drawn by: Author

Project Manager: Checker

SINCE THE JANUARY LPC MEETING, THE PROJECT HAS RECEIVED APPROVAL FROM TOWN COUNCIL OF ALL VARIANCES, SITE PLAN APPROVAL & SPECIAL EXCEPTIONS

AT JANUARY LPC MEETING, THE PROJECT & VARIANCES WERE APPROVED PENDING REVIEW OF THE FOLLOWING ITEMS:

EXTERIOR LIGHTING

MECHANICAL SCREEN WALLS

ADDITIONALLY, DURING TOWN COUNCIL REVIEW, MODIFICATIONS WERE MADE TO THE FOLLOWING ITEMS:

POOL LOUNGE FENESTRATION



## LIGHTING GENERAL NOTES BIDDING FF&E & DECORATIVE LIGHTING **KEY LEGEND** SHEET INDEX **GENERAL NOTES** LT-000 THESE DRAWINGS PROVIDE THE INTENT OF THE LIGHTING DESIGN ONLY. 1. INCLUDE WITH BID ADDITIVE AND DEDUCTIVE UNIT PRICES FOR EACH 1. ALL LIGHTING DESIGNATED AS "DECORATIVE" OR "FF&E" ARE TO BE **COVER SHEET** (##)XX FIXTURE TAG: FIXTURE TYPE, PRICES TO INCLUDE: LOCATIONS INDICATED ON DRAWINGS ARE RECOMMENDED LOCATIONS FOR DESIGNED OR SPECIFIED BY THE INTERIOR DESIGNER AND FURNISHED AS (XX) LETTERS DENOTE FIXTURE TYPE. (##) `Z:## OPTIMAL LIGHT DISTRIBUTION. FINAL LOCATIONS MUST BE COORDINATED PART OF THE FF&E OR INTERIORS PACKAGE UNLESS OTHERWISE LIGHTING GENERAL NOTES LT-001 1.1. ITEMIZED LABOR AND MATERIAL REQUIRED TO PERFORM WORK. PRECEDING NUMBERS DENOTE QUANTITY OR WITH OTHER TRADES AND INCORPORATED INTO ARCHITECTURAL AND/OR INDICATED. ELECTRICAL ENGINEER TO REFER TO INTERIOR DESIGNER LENGTH. (##) BOTTOM NUMBER INDICATES ELECTRICAL DRAWINGS. SPECIFICATIONS FOR FINAL WATTAGE LOADS. EXTERIOR LIGHT FIXTURE SCHEDULE LT-400 1.2. ANY REQUIRED ENGINEERING, LAYOUT, CLEANUP, TESTING, AND CONTROL ZONE. STARTUP. 2. THE GENERAL CONTRACTOR AND ELECTRICAL CONTRACTOR ARE EXTERIOR GF LIGHTING LAYOUT LT-401 RESPONSIBLE FOR REVIEWING THE INFORMATION ON ALL DRAWINGS AND XX(C#) TRACK MOUNTED FIXTURE TAG: 1.3. UNIT PRICES SHALL INCLUDE SELECTED MANUFACTURER FOR EACH SPECIFICATIONS FOR INCLUDING ALL WORK SHOWN AS PART OF THEIR BIDS. (XX) LETTERS DENOTE FIXTURE TYPE. FIXTURE TYPE. EXTERIOR ROOF LIGHTING LAYOUT LT-402 (C#) DENOTES CIRCUIT NUMBER. 3. ANY DISCREPANCIES, OMISSIONS, OR UNCERTAINTIES CONCERNING THESE BIDS THAT DO NOT INCLUDE UNIT PRICING SHALL BE REJECTED AS DRAWINGS SHALL BE BROUGHT TO THE ATTENTION OF LUCIFORMA FOR LT-403 EXTERIOR WEST FACADE LIGHTING INCOMPLETE. LIGHTING TRACK TAG: (##)XX CLARIFICATION PRIOR TO THE SUBMISSION OF BIDS. (XX) LETTERS DENOTE FIXTURE TYPE. (##) Z: ##(C#) **EXTERIOR NORTH FACADE LIGHTING** LT-404 PRECEDING NUMBERS DENOTE QUANTITY OR 4. THE GENERAL CONTRACTOR AND ELECTRICAL CONTRACTOR SHALL PROVIDE SUBMITTALS EXTERIOR LIGHTING LENGTH. (##) BOTTOM NUMBER INDICATES WORK NOT SPECIFICALLY SHOWN OR SPECIFIED, YET REQUIRED TO ENSURE LT-405 EXTERIOR LIGHTING DETAILS CONTROL ZONE / (C#) DENOTES CIRCUIT PROPER AND COMPLETE OPERATIONS OF ALL SYSTEMS, SATISFY THE DESIGN NUMBER RELATED TO CONTROL ZONE. INTENT, AND COMPLY WITH ALL APPLICABLE CODES AND REGULATIONS. 1. LIGHTING FIXTURES DRAWN ON PLANS ARE FOR DESIGN INTENT ONLY AND SUBMITTALS FOR ALL SPECIFIED LIGHT FIXTURES SHALL BE APPROVED BY EXTERIOR GROUND FLOOR PHOTOMETRICS LT-406 ARE NOT INTENDED TO SHOW PRECISE MOUNTING LOCATIONS. ELECTRICAL LUCIFORMA PRIOR TO ORDERING OR PERFORMING ANY ROUGH-IN WORK. 5. THE GENERAL CONTRACTOR WILL NOTIFY LUCIFORMA OF ANY PROVISION OF (##)EL-XX **EXISTING FIXTURE TAG:** CONTRACTOR SHALL COORDINATE ALL FINAL FIXTURE LOCATIONS ON-SITE THIS DOCUMENTATION THAT IS IN CONFLICT WITH LOCAL OR NATIONAL CODES (EX) LETTERS DENOTE EXISTING FIXTURE. 2. APPROVED SUBMITTALS SUPERSEDE ALL ORIGINAL SPECIFICATION WITH LIGHTING DESIGNER AND ARCHITECT BASED ON FINAL LANDSCAPE Z: ## AND AN ADDENDUM SHALL BE ISSUED TO CORRECT THE DOCUMENTATION. (XX) LETTERS DENOTE FIXTURE TYPE. AND HARDSCAPE PLANS AND SITE CONDITIONS. DOCUMENTS. PRECEDING NUMBERS DENOTE QUANTITY OR 6. ALL DIMENSIONS INDICATED ARE TO FINISH FACE OF MATERIALS UNLESS 2. GENERAL CONTRACTOR TO FURNISH AND INSTALL STONE PAVER OR CMU REQUESTS FOR APPROVAL OF LIGHT FIXTURE SUBSTITUTION MUST BE LENGTH. (##) BOTTOM NUMBER INDICATES OTHERWISE NOTED. ACCOMPANIED BY THE FOLLOWING AT LEAST (5) BUSINESS DAYS IN BLOCK TO SECURE GROUND MOUNTED FIXTURES IN LOOSE SOIL AS CONTROL ZONE. ADVANCE OF THE BID SUBMITTAL DUE DATE: DIRECTED BY LIGHTING CONSULTANT. 7. LIGHTING DETAIL DRAWINGS SHALL TAKE PRECEDENT OVER LIGHTING PLAN (##)XX FIXTURE ON CIRCUIT BREAKER TAG: AND ELEVATION DRAWINGS. LIGHTING DETAIL DRAWINGS SHOW CRITICAL 3.1. SPECIFICATION DATA SHEET COMPLETE WITH MANUFACTURER NAME. 3. EXTERIOR TRANSFORMERS MUST BE WEATHER/MOISTURE PROOF, OR (XX) LETTERS DENOTE TYPE. PRECEDING DIMENSIONS FOR DESIGN INTENT ONLY. CB:## CONTACT INFORMATION, AND SPECIFIED MODEL AND PART NUMBERS. HOUSED IN WEATHERPROOF ENCLOSURES. EXTERIOR TRANSFORMERS NUMBERS DENOTE QUANTITY OR LENGTH. MUST BE LOCATED IN LOCATIONS HIDDEN FROM IMMEDIATE VIEW WITHIN 8. THE GENERAL CONTRACTOR SHALL FIELD VERIFY ALL CONDITIONS AND (##) BOTTOM NUMBER INDICATES CIRCUIT 3.2. A WORKING SAMPLE OF SPECIFIED PRODUCT AND PROPOSED THE LANDSCAPE. ELECTRICAL CONTRACTOR TO COORDINATE AND VERIFY DIMENSIONS AND NOTIFY LUCIFORMA OF ANY DISCREPANCIES BETWEEN BREAKER GROUP. ALTERNATE. TRANSFORMER LOCATIONS WITH ARCHITECT AND GENERAL CONTRACTOR FIELD CONDITIONS AND LIGHTING AND/OR ARCHITECTURAL DRAWINGS AS IT AND MODIFY WIRING METHODS AS REQUIRED PER FINAL APPROVED 3.3. CALCULATIONS REQUIRED FOR EGRESS OR OTHER KEY AREAS WHERE PERTAINS TO LIGHTING PRIOR TO COMMENCING WORK. REMOTE TRANSFORMER: MOUNTING LOCATIONS. REFER TO FIXTURE MANUFACTURER FIXTURE IS TO BE LOCATED. FIXTURE REQUIRES REMOTE TRANSFORMER. 9. THE GENERAL CONTRACTOR SHALL NOTIFY LUCIFORMA OF ANY CONFLICTS SPECIFICATIONS FOR MAXIMUM DISTANCE RECOMMENDATIONS AND FINAL QUANTITY AND LOCATIONS TBD BY E.C. WIRING/INSTALLATION INSTRUCTIONS. WITH STRUCTURE, PLENUMS, HVAC, OR COMPONENTS FROM OTHER TRADES PRIOR TO THE ORDERING OF EQUIPMENT **INSTALLATION & MAINTENANCE** WALLBOX SWITCH: 4. THE GENERAL CONTRACTOR SHALL FURNISH AND INSTALL ADEQUATE (XX) CORRESPONDS TO NUMBER IN ZONE 10. LIGHTING IN ELECTRICAL, MECHANICAL, IDF, TELECOM, OR OTHER B.O.H DRAINAGE AROUND ALL DIRECT BURIAL TRANSFORMERS AND RECESSED SCHEDULE. (#) CORRESPONDS TO NUMBER EQUIPMENT ROOMS ARE SHOWN FOR QUANTITY ONLY. ACTUAL FIXTURE IN-GRADE LIGHTING FIXTURES. 1. THE ELECTRICAL CONTRACTOR SHALL CONFIRM TRANSFORMER SIZES AND OF CONNECTED SWITCHES. LOCATIONS TO BE DETERMINED AFTER COORDINATING WITH WORK OF ALL CAPACITIES BASED ON DIMENSIONS SHOWN ON DRAWINGS AND AS VERIFIED 5. THE GENERAL CONTRACTOR, ELECTRICAL CONTRACTOR, AND LIGHTING (EX. "3"= 3-WAY SWITCH). OTHER TRADES. FIXTURES TO BE LOCATED SO THAT MAINTENANCE AND IN THE FIELD. SUPPLIER SHALL ENSURE THAT ALL UNDERWATER/SUBMERGED FIXTURES LIGHT OUTPUT ARE NOT OBSTRUCTED. UNDERGO A FULL DIMMING AND CONTROL TEST TO CONFIRM THAT A FULLY WALLBOX DIMMER: 2. ELECTRICAL CONTRACTOR TO LOCATE ALL REMOTE TRANSFORMERS (LOW 11. THE GENERAL CONTRACTOR MUST POWER ON AND DIM LIGHT FIXTURES TO FUNCTIONAL UNDERWATER LIGHTING SYSTEM PERFORMS AS EXPECTED BY (XX) CORRESPONDS TO NUMBER IN ZONE VOLTAGE TRANSFORMERS, BALLASTS, POWER SUPPLIES ETC. ) IN SAFE, DRY, LIGHTING DESIGNER PRIOR TO FINAL FIXTURE SUBMERSION. (THIS SCHEDULE. (#) CORRESPONDS TO NUMBER VERIFY FIXTURE FUNCTIONALITY PRIOR TO INSTALLATION. VENTILATED, AND ACCESSIBLE LOCATION CONCEALED FROM VIEW. PRE-SUBMERSION TEST WILL PREVENT ADDITIONAL TIME AND LABOR THAT OF CONNECTED SWITCHES. 12. ALL LIGHT FIXTURES SHALL BE LISTED BY A RECOGNIZED TESTING 3. ELECTRICAL CONTRACTOR MUST LOCATE REMOTE WITHIN PROXIMITY TO MAY BE REQUIRED TO UNINSTALL FIXTURES FROM AN UNDERWATER (EX. "D3"= 3-WAY DIMMER). LABORATORY AS COMPLIANT WITH THE CONDITION TO WHICH THEY ARE LIGHT FIXTURE AS RECOMMENDED BY MANUFACTURER. A VOLTAGE DROP CONDITION IN THE EVENT THAT ACCESS/REPAIR OR MAINTENANCE IS BEING INSTALLED. EXCEEDING 5% SHALL RESULT IN THE RE-INSTALLATION OF THE REQUIRED.) WALLBOX SENSOR SWITCH: COC## TRANSFORMER AND WIRING AT NO ADDITIONAL COST. (XX) CORRESPONDS TO NUMBER IN ZONE 13. THE GENERAL CONTRACTOR SHALL VERIFY ALL CEILING TYPES AND 6. THE ELECTRICAL CONTRACTOR IS RESPONSIBLE FOR CONFIRMING THE SCHEDULE. (#) CORRESPONDS TO NUMBER MOUNTING CONDITIONS, COORDINATE WITH THE ARCHITECTURAL DRAWINGS LINEAR LEDS WITH ADHESIVE BACKING SHALL NEVER BE ATTACHED USING LENGTH OF TIME SUBMERSIBLE FIXTURES MAY BE POWERED IN A DRY OF CONNECTED SWITCHES. PRIOR TO ORDERING LIGHT FIXTURES. GENERAL CONTRACTOR IS FULL SOLELY ADHESIVE. MOUNTING COMPONENTS SUCH AS CLIPS. BRACKETS. ENVIRONMENT WITHOUT WATER REQUIRED TO DISSIPATE HEAT (EX. "OC3"= 3-WAY SWITCH/DIMMER). RESPONSIBLE FOR PROVIDING ALL MOUNTING HARDWARE FOR THE SAFE SCREWS AS SPECIFIED BY LIGHTING DESIGNER AND/OR RECOMMENDED BY ACCUMULATION. MOUNTING OF LIGHT FIXTURES AT NO EXTRA COST TO THE OWNER. FIXTURE MANUFACTURER SHALL BE USED IN THESE INSTANCES. ALL LINEAR FIXTURES JAMB SWITCH: WEIGHTS MUST BE CONFIRMED WITH THE MANUFACTURER. MUST BE INSTALLED IN STRAIGHT LINEAR RUNS AS INDICATED ON DRAWINGS. (XX) CORRESPONDS TO NUMBER IN ZONE ANY WAVINESS IN LINEAR MOUNTING WILL REQUIRE REINSTALLATION OF SCHEDULE. 14. LIGHT FIXTURE TRIMS, COLLARS, FLANGES, OR OTHER COMPONENTS LINEAR FIXTURES IN STRAIGHT RUNS AT NO ADDITIONAL COST. AIM & ADJUST REQUIREMENTS MOUNTED FLUSH TO CEILING THAT ARE SPECIFIED AS PAINTED TO MATCH MASTER SWITCH: CEILING FINISHES MUST BE PAINTED AND DRIED PRIOR TO INSTALLATION TO GENERAL CONTRACTOR TO FURNISH ALL NECESSARY COMPONENTS, ENSURE COMPONENTS DO NOT STICK TO CEILING. (XX) CORRESPONDS TO NUMBER IN ZONE AIM AND ADJUST WILL TAKE PLACE AFTER ALL PROJECT AMENITIES HAVE CONNECTIONS, ACCESSORIES, ETC. REQUIRED FOR FIXTURE TO FUNCTION SCHEDULE. AS INTENDED BY LIGHTING DESIGNER. BEEN INSTALLED AND LIGHTING CONTROL SYSTEM IS FULLY OPERATIONAL. 15. GENERAL CONTRACTOR TO FURNISH AND INSTALL ALL EQUIPMENT AND AMENITIES INCLUDE BUT ARE NOT LIMITED TO: ARTWORK, GRAPHICS, COMPONENTS INCLUDING LENSES, BLOCKING, PAINT TREATMENTS, AND 6. GENERAL CONTRACTOR TO COORDINATE COMPATIBILITY BETWEEN DIMMING SPARE ZONE: SIGNAGE, FURNITURE, MILLWORK, WINDOW TREATMENTS, AND PLANTINGS. OTHER ITEMS IDENTIFIED IN LIGHTING PLANS, DETAILS, AND SPECIFICATIONS. Z: XX CONTROL DEVICE AND LIGHT FIXTURE WITH LIGHTING MANUFACTURER SPARE CIRCUIT FOR FUTURE USE OR THE GENERAL CONTRACTOR MUST NOTIFY LUCIFORMA AND ARCHITECT A PRIOR TO PURCHASE AND INSTALLATION. EQUIPMENT SPECIFIED BY OTHERS. E.C. TO SPARE/ 16. ELECTRICAL CONTRACTOR TO INSTALL ALL SPECIFIED LIGHT FIXTURE MINIMUM OF (2) WEEKS PRIOR TO AIM AND ADJUST. (3) WEEKS NOTICE WILL DETERMINE FINAL LOCATION AND DENOTE ACCESSORIES (I.E.: LOUVERS, LENSES, FILTERS, ETC.) PRIOR TO AIM AND 7. ELECTRICAL CONTRACTOR TO COORDINATE LOCATIONS OF BE REQUIRED FOR PROJECTS REQUIRING MORE THAN (2) HOURS OF TRAVEL **EXACT LOCATION ON AS-BUILT DRAWINGS.** ADJUST VISIT. DIMMED/SWITCHED RECEPTACLES, LIGHTING CONTROL STATIONS, AND ANY FROM NEW YORK CITY. OTHER LIGHTING CONTROL INTERFACES WITH ARCHITECT PRIOR TO **CONTROL KEYPAD:** 17. ANY REQUIRED CALCULATIONS FOR CODE COMPLIANCE MUST BE CONFIRMED 3. ELECTRICAL CONTRACTOR TO PROVIDE LABOR AND EQUIPMENT FOR THE ELECTRICAL ROUGH-IN. FINAL LOCATIONS TBD BY E.C. WITH BY ELECTRICAL ENGINEER (OR OTHER PARTY SPECIFIED BY OWNER). ADJUSTMENT OF ALL LIGHT FIXTURES AT THE DIRECTION OF THE LIGHTING /**K##**\ ARCHITECT. NUMBER CORRESPONDS TO RECEPTACLES SHALL BE CLEARLY MARKED ON INSIDE SURFACE OF COVER DESIGNER. ADJUSTMENTS MAY INCLUDE RELAMPING FIXTURES, CHANGING 18. THE ELECTRICAL CONTRACTOR'S BID SHALL INCLUDE LABOR ALLOWANCES ZONE SCHEDULE. PLATE WITH CONTROL ZONE NUMBER AS SPECIFIED ON LUCIFORMA ZONE FIXTURE ACCESSORIES AND LENSES, RELOCATING LIGHT FIXTURES WITH FOR AIM AND ADJUST LABOR AS PER LIGHTING DESIGNER AGREEMENT. AS SCHEDULE ALONG WITH DIMMER NUMBER FROM CONTROL SYSTEM LAYOUT FLEXIBLE MOUNTINGS. WELL AS REPAIRS AND REPLACEMENTS OF LIGHT FIXTURES AND THEIR **TOUCHSCREEN:** COMPONENTS AS REQUIRED. 9. AESTHETIC AND FACTORY LABELLING OF SWITCHES AND ALL OTHER FINAL LOCATIONS TBD BY E.C. WITH AS AIM AND ADJUST IS COMPLETED, ELECTRICAL CONTRACTOR IS /T##\ ARCHITECT. NUMBER CORRESPONDS TO LIGHTING CONTROL INTERFACES SHALL BE VERIFIED WITH OWNER AND RESPONSIBLE FOR TIGHTENING AND LOCKING ALL ADJUSTABLE 19. ALL WARRANTY REPAIRS SHALL BE PERFORMED BY QUALIFIED PERSONNEL ARCHITECT PRIOR TO ORDERING. GENERAL CONTRACTOR SHALL SUBMIT ZONE SCHEDULE. COMPONENTS. EMPLOYED OR AUTHORIZED BY THE MANUFACTURER AND SHALL NOT BE CUT SHEETS OF PROPOSED SWITCHES AND RECEPTACLES TO ARCHITECT SUBCONTRACTED OR ASSIGNED WITHOUT THE WRITTEN CONSENT OF THE OCCUPANCY, VACANCY OR MOTION SENSOR: AND LUCIFORMA FOR APPROVAL PRIOR TO ORDERING. WHEN POSSIBLE, AIM AND ADJUST SHALL TAKE PLACE DURING TYPICAL (s)OWNER. IN NO CASE SHALL THE MANUFACTURER BE RELIEVED OF FIXTURE CONTROLLED BY OCCUPANCY, WORKING HOURS. FOR SPACES WITH SIGNIFICANT DAYLIGHT IMPACT, AIM RESPONSIBILITY FOR THE PERFORMANCE OF WARRANTY REPAIRS. 10. MANUFACTURER LABELS AND STICKERS SHALL FACE AWAY FROM PUBLIC VACANCY OR MOTION SENSOR. FINAL AND ADJUST SHALL TAKE PLACE AFTER DUSK AT THE DIRECTION OF QUANTITY AND LOCATIONS TBD BY E.E. LUCIFORMA. 20. THE ELECTRICAL CONTRACTOR'S BID SHALL INCLUDE LABOR ALLOWANCES FOR CONTROL SYSTEM COMMISSIONING AS INDICATED IN CONTROL SYSTEM 11. LIGHT FIXTURE AND COMPONENT SPECIFICATIONS MAY BE SUBJECT TO THE ELECTRICAL CONTRACTOR SHALL PROVIDE LADDERS, LIFTS, POWER **DAYLIGHT SENSOR:** BILL OF MATERIALS. $\bigcirc$ CHANGE BETWEEN THE TIME OF INITIAL SPECIFICATION AND PROCUREMENT CORDS. HAND TOOLS. HEAT RESISTANT GLOVES. AND ANY OTHER SUPPLIES FIXTURE CONTROLLED BY DAYLIGHT DUE TO RAPID ONGOING IMPROVEMENTS TO LED AND LIGHTING NECESSARY FOR THE AIMING AND ADJUSTING OF LIGHT FIXTURES. 21. ALL EMERGENCY LIGHTING IS TO BE SPECIFIED AND CONFIRMED BY SENSOR. FINAL QUANTITY AND LOCATIONS TECHNOLOGY. ELECTRICAL ENGINEER. IF ARCHITECTURAL LIGHTING FIXTURES ARE TBD BY E.E. INCORPORATED INTO EMERGENCY CIRCUITS. IT IS THE RESPONSIBILITY OF 12. SENSOR QUANTITIES AND LOCATIONS ARE TO BE COORDINATED BY THE ELECTRICAL ENGINEER TO DETERMINE IF ADDITIONAL EMERGENCY "RA" - DUPLEX WALL RECEPTACLE ELECTRICAL ENGINEER AND ELECTRICAL CONTRACTOR TO VERIFY PROPER LIGHTING WILL BE REQUIRED. OPERATION AND CODE COMPLIANCE. 22. LUMINARIES SHALL NOT BE USED AS WORK LIGHTS DURING CONSTRUCTION 13. GENERAL CONTRACTOR TO PROVIDE ADDITIONAL MATERIALS MATCHING "RB" - DUPLEX FLOOR RECEPTACLE AND SHALL BE FULLY OPERATIONAL AT THE TIME OF ACCEPTANCE BY OWNER PRODUCTS INSTALLED FOR ATTIC STOCK. MATERIALS SHALL BE PACKAGED OR TENANT. WITH PROTECTIVE COVERING FOR STORAGE AND CLEARLY LABELLED FOR IDENTIFICATION. "RC" - DUPLEX CEILING RECEPTACLE 23. THE GENERAL CONTRACTOR SHALL ALLOW SUFFICIENT ORDERING TIME FOR PROCUREMENT OF LIGHT FIXTURES. DESIGNER SHALL BE NOTIFIED OF ANY PRODUCT SUBSTITUTIONS AS A RESULT OF LEAD TIMES PRIOR TO ORDERING **REVISION** ALTERNATE PRODUCT. FAILURE TO ORDER LIGHT FIXTURES WITH ADEQUATE /##` LEAD TIMES TO MEET THE INSTALLATION SCHEDULE DOES NOT RELIEVE THE GENERAL CONTRACTOR OF RESPONSIBILITY TO PROVIDE THE SPECIFIED LIGHT FIXTURE AIM DIRECTION PRODUCT WITHOUT COMPENSATION TO THE OWNER. 24. SHOULD A MANUFACTURER FAIL TO DELIVER A PRODUCT THAT HAS BEEN ORDERED WITHIN REASONABLE LEAD-TIME, CONTRACTOR SHALL NOTIFY J-BOX LUCIFORMA WITH A PROPOSED ALTERNATE LIGHT FIXTURE. LUCIFORMA SHALL MAINTAIN FINAL AUTHORITY FOR AUTHORIZATION OF ANY SUBSTITUTION. DAYLIGHT ZONE

PALM BEACH, FLORIDA **LIGHTING DESIGNER** LUCIFORMA 1216 Broadway, 2nd Floor #1024 New York, NY 10001 p: +1 646.883.4151 e: studio@luciforma.com www.luciforma.com **INTERIOR DESIGNER** MLINARIC, HENRY & ZERVUDACHI London SW1W 8JA, UK p: +44 (0) 20 7730 9072 **ARCHITECT** SPINA OROURKE 285 Banyan Blvd West Palm Beach Florida 33401 p: 561.684.6844 REVISIONS NO. DATE ISSUE NAME ISSUE: LPC SUBMISSION DATE: 03-31-2023 SCALE: N/A SHEET NAME LIGHTING

**GENERAL NOTES** 

OUECT SPECIFIED ABOVE AND MAY NOT BE USED OR REUSED, IN-HOLE OR IN PART, EXCEPT IN CONNECTION WITH THIS PROJECT, THOUT THE PRIOR WRITTEN CONSENT OF LUCIFORMA.

SHEET NUMBER

LT-001

THE VINETA HOTEL

TYPE	SYMBOL	<u>IMAGE</u>	FIXTURE DESCRIPTION	LIGHT SOURCE CCT	FIXTURE WATTAGE	VOLTAGE / CURRENT	LOCATION
Z-BA	<b>©</b>		EXTERIOR RATED, DIMMABLE DOWNLIGHT WITH MEDIUM FLOOD OPTIC TO PROVIDE GENERAL LIGHTING. FIXTURE TO BE OUTFITTED WITH HONEYCOMB LOUVER TO SHIELD LIGHT SOURCE AND MINIMIZE GLARE.	INTEGRAL LED 3000K	13 W	120 V	GROUND FLOOR STREET SIDE & POOL SIDE ENTRY VESTIBULE CEILINGS
Z-CA	o		EXTERIOR RATED, DIMMABLE, CEILING BEAM MOUNTED, DOWNLIGHT WITH MEDIUM FLOOD OPTIC TO PROVIDE GENERAL LIGHTING. FIXTURE TO BE OUTFITTED WITH SNOOT (NOT SHOWN) AND HONEYCOMB LOUVER TO SHIELD LIGHT SOURCE AND MINIMIZE GLARE.	INTEGRAL LED 3000K	5 W	24V	GROUND FLOOR COURTYARD CEILING BEAMS
Z-FA	o		EXTERIOR RATED, DIMMABLE IN-GRADE UPLIGHT FIXTURE WITH ELLIPTICAL OPTIC TO PROVIDE WALL ACCENT UPLIGHTING. FIXTURE TO BE OUTFITTED WITH ANTI-GLARE LOUVER TO SHIELD LIGHT SOURCE AND MINIMIZE GLARE.	INTEGRAL LED 3000K	2 W	24V	GROUND FLOOR STREET SIDE ENTRY VESTIBULE FLOORS
Z-FB	o		EXTERIOR RATED, DIMMABLE IN-GRADE UPLIGHT FIXTURE WITH NARROW OPTIC TO PROVIDE MAIN ENTRY ENGAGED COLUMN ACCENT UPLIGHTING. FIXTURE TO BE OUTFITTED WITH ANTI-GLARE LOUVER TO SHIELD LIGHT SOURCE AND MINIMIZE GLARE.	INTEGRAL LED 3000K	2 W	24V	GROUND FLOOR MAIN ENTRY PAVEMENT
Z-GA	o		EXTERIOR RATED, DIMMABLE, STAKE MOUNTED, ADJUSTABLE UPLIGHT FIXTURE WITH NARROW OPTIC TO PROVIDE PLANT UPLIGHTING. FIXTURE TO BE OUTFITTED WITH SNOOT (NOT SHOWN) AND HONEYCOMB LOUVER TO SHIELD LIGHT SOURCE AND MINIMIZE GLARE.	INTEGRAL LED 3000K	2.6 W	24V	GROUND FLOOR COURTYARD AND SWIMMING POOL PLANTERS
Z-GB	o		EXTERIOR RATED, DIMMABLE, STAKE MOUNTED, ADJUSTABLE UPLIGHT FIXTURE WITH MEDIUM FLOOD OPTIC TO PROVIDE PLANT ACCENT LIGHTING. FIXTURE TO BE OUTFITTED WITH SNOOT (NOT SHOWN) AND HONEYCOMB LOUVER TO SHIELD LIGHT SOURCE AND MINIMIZE GLARE.	INTEGRAL LED 3000K	2.6 W	24V	GROUND FLOOR COURTYARD AND SWIMMING POOL PLANTERS
Z-HA	8		EXTERIOR RATED, DIMMABLE, STAKE MOUNTED, ADJUSTABLE PATH LIGHT FIXTURE WITH MEDIUM FLOOD OPTIC TO PROVIDE PATH LIGHTING. FIXTURE TO BE OUTFITTED WITH SNOOT (NOT SHOWN) TO SHIELD LIGHT SOURCE AND MINIMIZE GLARE.	INTEGRAL LED 3000K	2.6 W	24V	GROUND FLOOR SWIMMING POOL PLANTERS
Z-LA		9	EXTERIOR RATED, DIMMABLE, SURFACE MOUNTED, LINEAR LIGHT FIXTURE WITH DIFFUSE LENS TO PROVIDE UPLIGHT GLOW.	INTEGRAL LED 3000K	3 W/FT	24V	GROUND FLOOR STREET ENTRANC DOOR TRANSOM
Z-WA	8		EXTERIOR RATED, DIMMABLE, WALL MOUNTED, UPLIGHT FIXTURE WITH NARROW OPTIC TO PROVIDE ENGAGED COLUMN ACCENT UPLIGHTING. FIXTURE TO BE OUTFITTED WITH SNOOT (NOT SHOWN) AND HONEYCOMB LOUVER TO SHIELD LIGHT SOURCE AND MINIMIZE GLARE.	INTEGRAL LED 3000K	2.6 W	24V	GROUND FLOOR WEST FACADE ENGAGED COLUMNS
Z-WB			EXTERIOR RATED, DIMMABLE, WALL MOUNTED, STEP LIGHT TO PROVIDE PATH LIGHTING.	INTEGRAL LED 3000K	2.6 W	700 mA	POOL SIDE STAIRCASE
Z-WC	ठ		EXTERIOR RATED, DIMMABLE, WALL MOUNTED, UPLIGHT FIXTURE WITH WIDE FLOOD OPTIC TO PROVIDE UPLIGHTING.	INTEGRAL LED 3000K	5 W	24V	WEST FACADE STAIRWELLS & ROOF TOWER

EXTERIOR DECORATIVE LIGHT FIXTURE SCHEDULE							
Z-PA	<b>+</b>		EXTERIOR RATED, DECORATIVE PENDANT.	LED BULB 2700K	16 W	120V	GROUND FLOOR POOL TRELLIS BEAMS
Z-SA	$\overline{\oplus}$		EXTERIOR RATED, DECORATIVE SCONCE.	LED BULB 2700K	12 W	120V	GROUND FLOOR WEST FACADE
Z-SB	$\overline{\oplus}$		EXTERIOR RATED, DECORATIVE SCONCE.	LED BULB 2700K	9 W	120V	GROUND FLOOR NORTH FACADE
Z-SC	$\overline{\oplus}$		EXTERIOR RATED, DECORATIVE SCONCE.	LED BULB 2700K	9 W	120V	GROUND FLOOR COURTYARD WALLS
Z-SD	$\overline{\oplus}$		EXTERIOR RATED, DECORATIVE SCONCE.	LED BULB 2700K	9 W	120V	GROUND FLOOR POOL WALLS AND TRELLIS COLUMNS

FINISHES TO BE DETERMINED

THE VINETA HOTEL
PALM BEACH, FLORIDA

LIGHTING DESIGNER

LUCIFORMA
1216 Broadway, 2nd Floor #1024
New York, NY 10001
p: +1 646.883.4151
e: studio@luciforma.com
www.luciforma.com

INTERIOR DESIGNER

MLINARIC, HENRY & ZERVUDACHI
38 Bourne St
London SW1W 8JA, UK
p: +44 (0) 20 7730 9072

ARCHITECT

SPINA OROURKE
285 Banyan Blvd
West Palm Beach Florida 33401
p: 561.684.6844

NO. DATE ISSUE NAME

ISSUE: LPC SUBMISSION

DATE: 03-31-2023


SCALE: N/A


SHEET NAME

EXTERIOR LIGHT FIXTURE SCHEDULE

SHEET NUMBER

LT-400

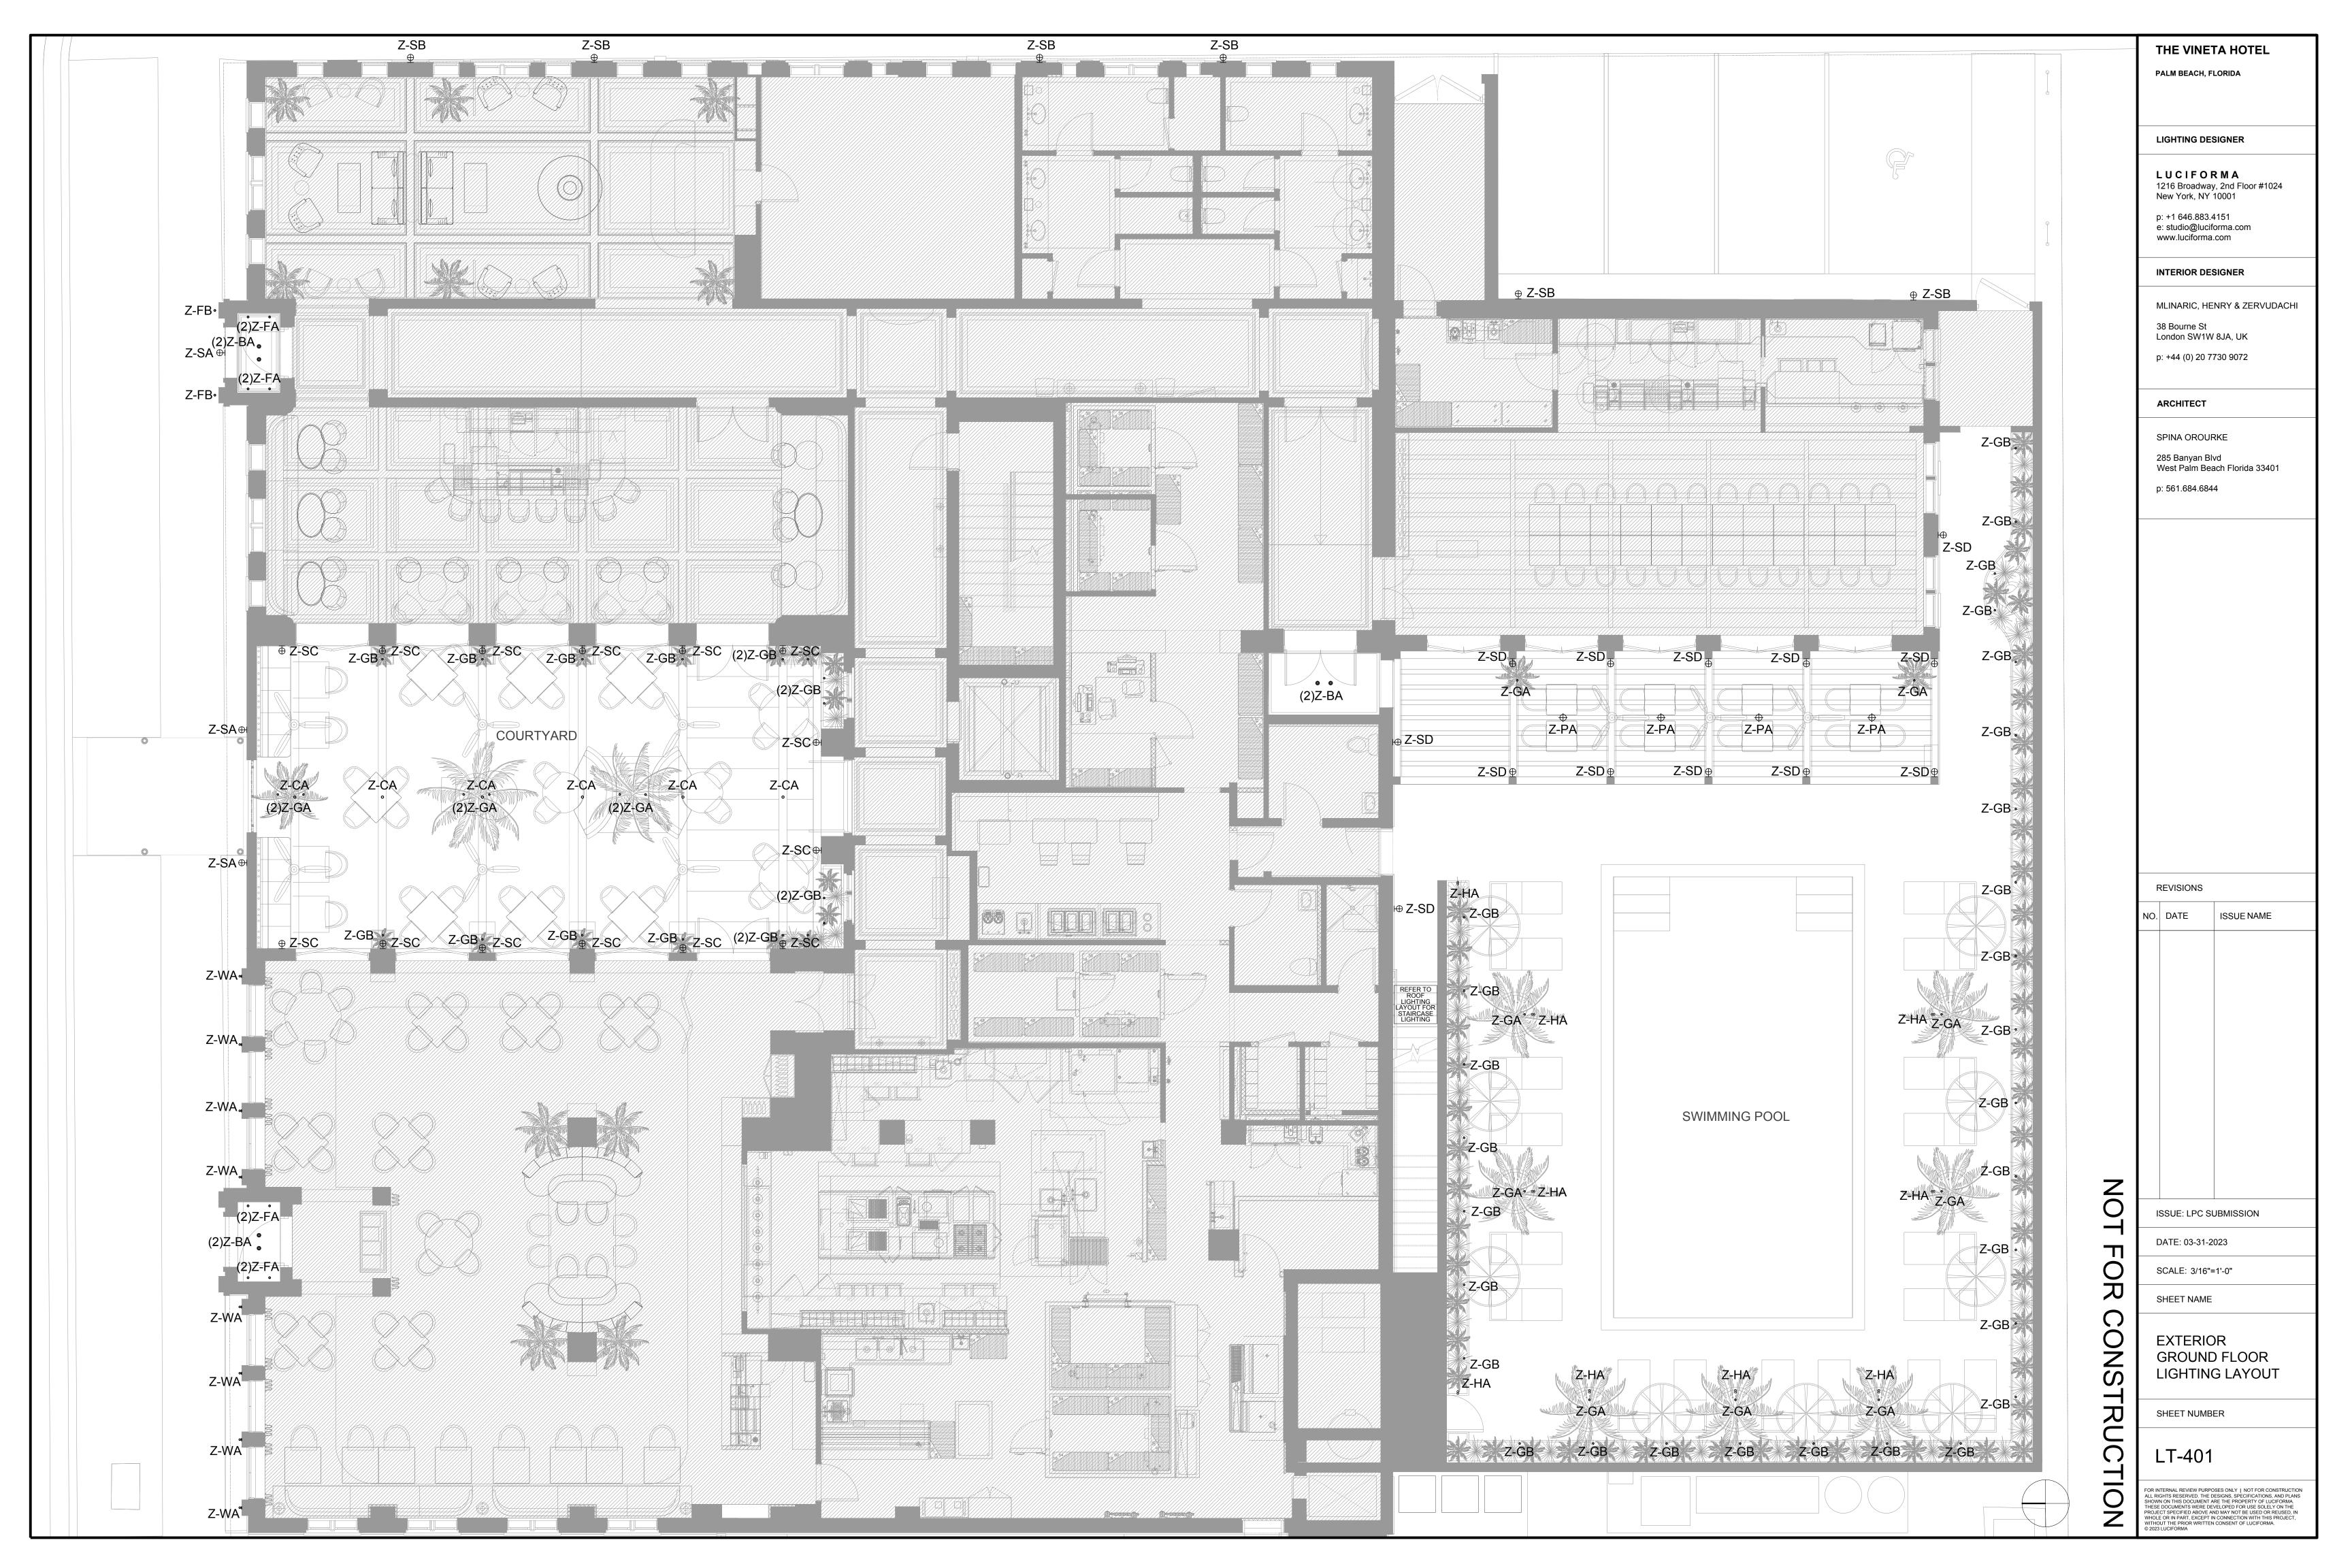

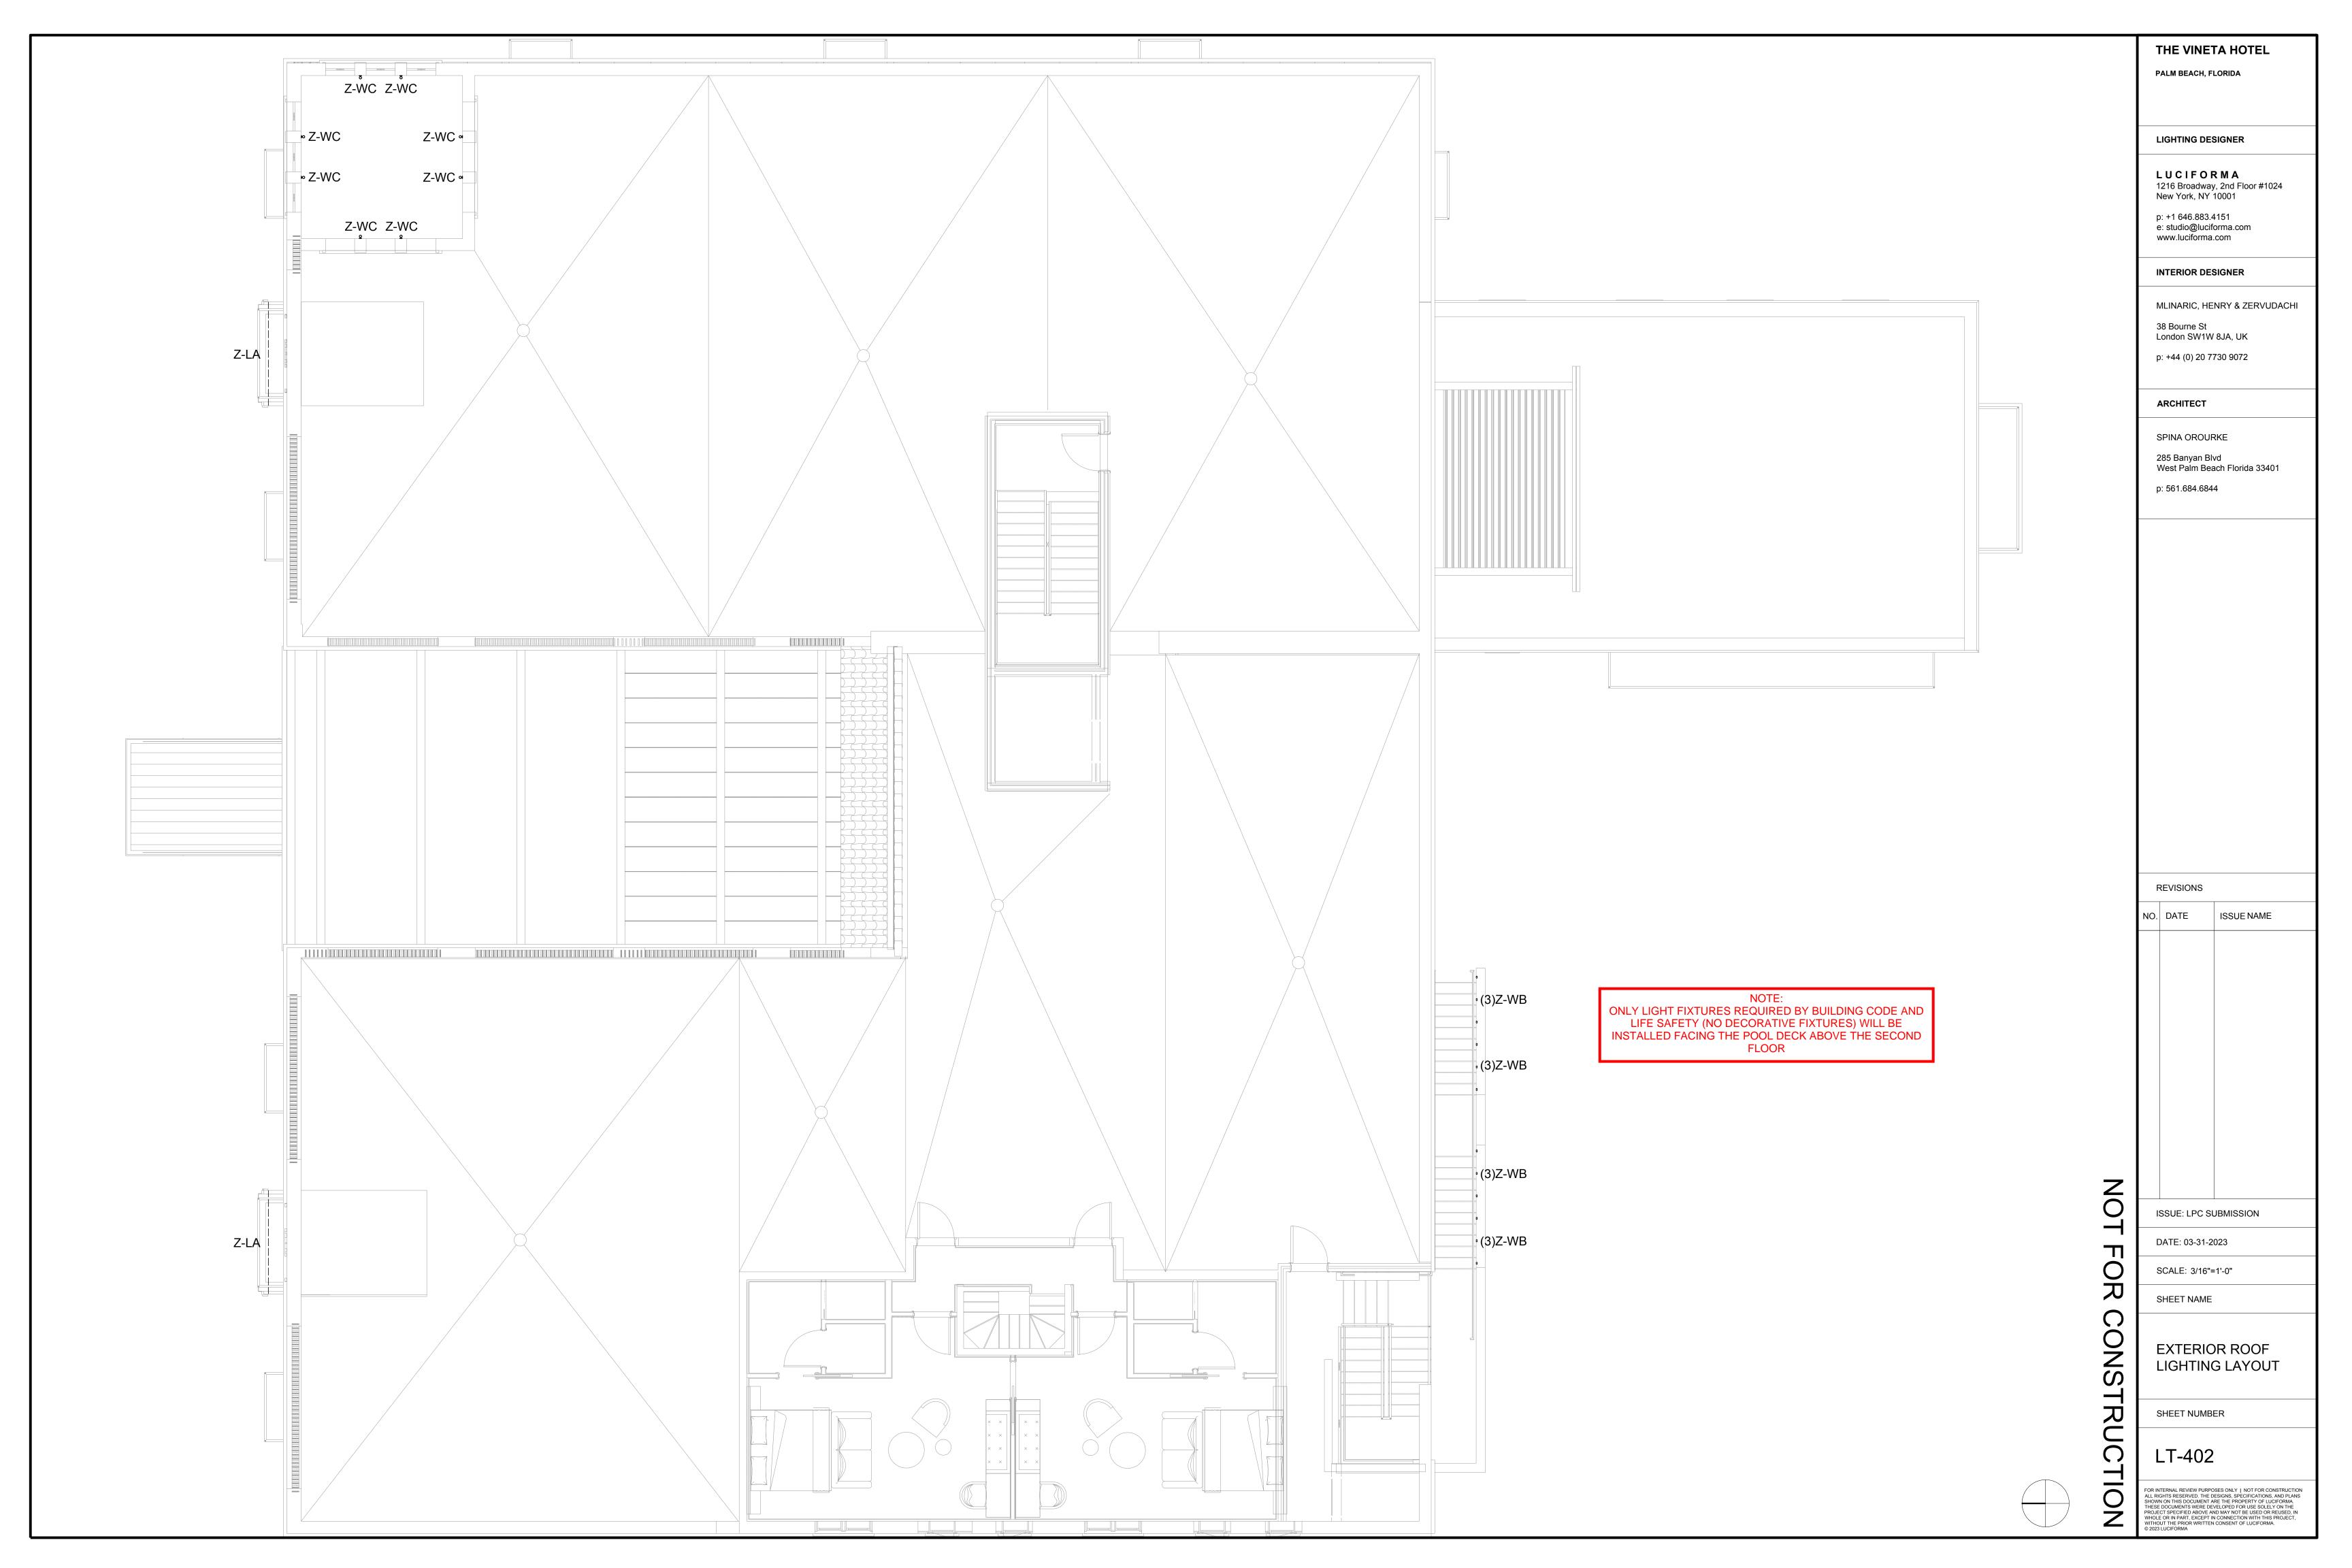



PALM BEACH, FLORIDA

LIGHTING DESIGNER

LUCIFORMA
1216 Broadway, 2nd Floor #1024
New York, NY 10001

p: +1 646.883.4151 e: studio@luciforma.com www.luciforma.com

INTERIOR DESIGNER

MLINARIC, HENRY & ZERVUDACHI

38 Bourne St London SW1W 8JA, UK

p: +44 (0) 20 7730 9072

ARCHITECT

SPINA OROURKE 285 Banyan Blvd West Palm Beach Florida 33401

p: 561.684.6844

REVISIONS

NO.	DATE	ISSUE NAME		
ISSUE: LPC SUBMISSION				

ISSUE: LPC SUBMISSION

DATE: 03-31-2023

SCALE: 3/16"=1'-0"

SHEET NAME

EXTERIOR WEST FACADE LIGHTING

SHEET NUMBER

LT-403



PALM BEACH, FLORIDA

LIGHTING DESIGNER

LUCIFORMA
1216 Broadway, 2nd Floor #1024
New York, NY 10001

p: +1 646.883.4151 e: studio@luciforma.com www.luciforma.com

INTERIOR DESIGNER

MLINARIC, HENRY & ZERVUDACHI

38 Bourne St London SW1W 8JA, UK

p: +44 (0) 20 7730 9072

ARCHITECT

SPINA OROURKE

285 Banyan Blvd

West Palm Beach Florida 33401

p: 561.684.6844

REVISIONS

NO. DATE ISSUENAME

ISSUE: LPC SUBMISSION

DATE: 03-31-2023

SCALE: 3/16"=1'-0"

SHEET NAME

EXTERIOR NORTH FACADE LIGHTING

SHEET NUMBER

LT-404



PALM BEACH, FLORIDA

LIGHTING DESIGNER

LUCIFORMA
1216 Broadway, 2nd Floor #1024
New York, NY 10001

p: +1 646.883.4151 e: studio@luciforma.com www.luciforma.com

INTERIOR DESIGNER

MLINARIC, HENRY & ZERVUDACHI
38 Bourne St

London SW1W 8JA, UK p: +44 (0) 20 7730 9072

ARCHITECT

SPINA OROURKE

285 Banyan Blvd
West Palm Beach Florida 33401

p: 561.684.6844

REVISIONS

NO. DATE ISSUENAME

ISSUE: LPC SUBMISSION

DATE: 03-31-2023

SCALE: 3/16"=1'-0"


SHEET NAME

EXTERIOR NORTH FACADE LIGHTING

SHEET NUMBER

LT-404

CONSTRUC

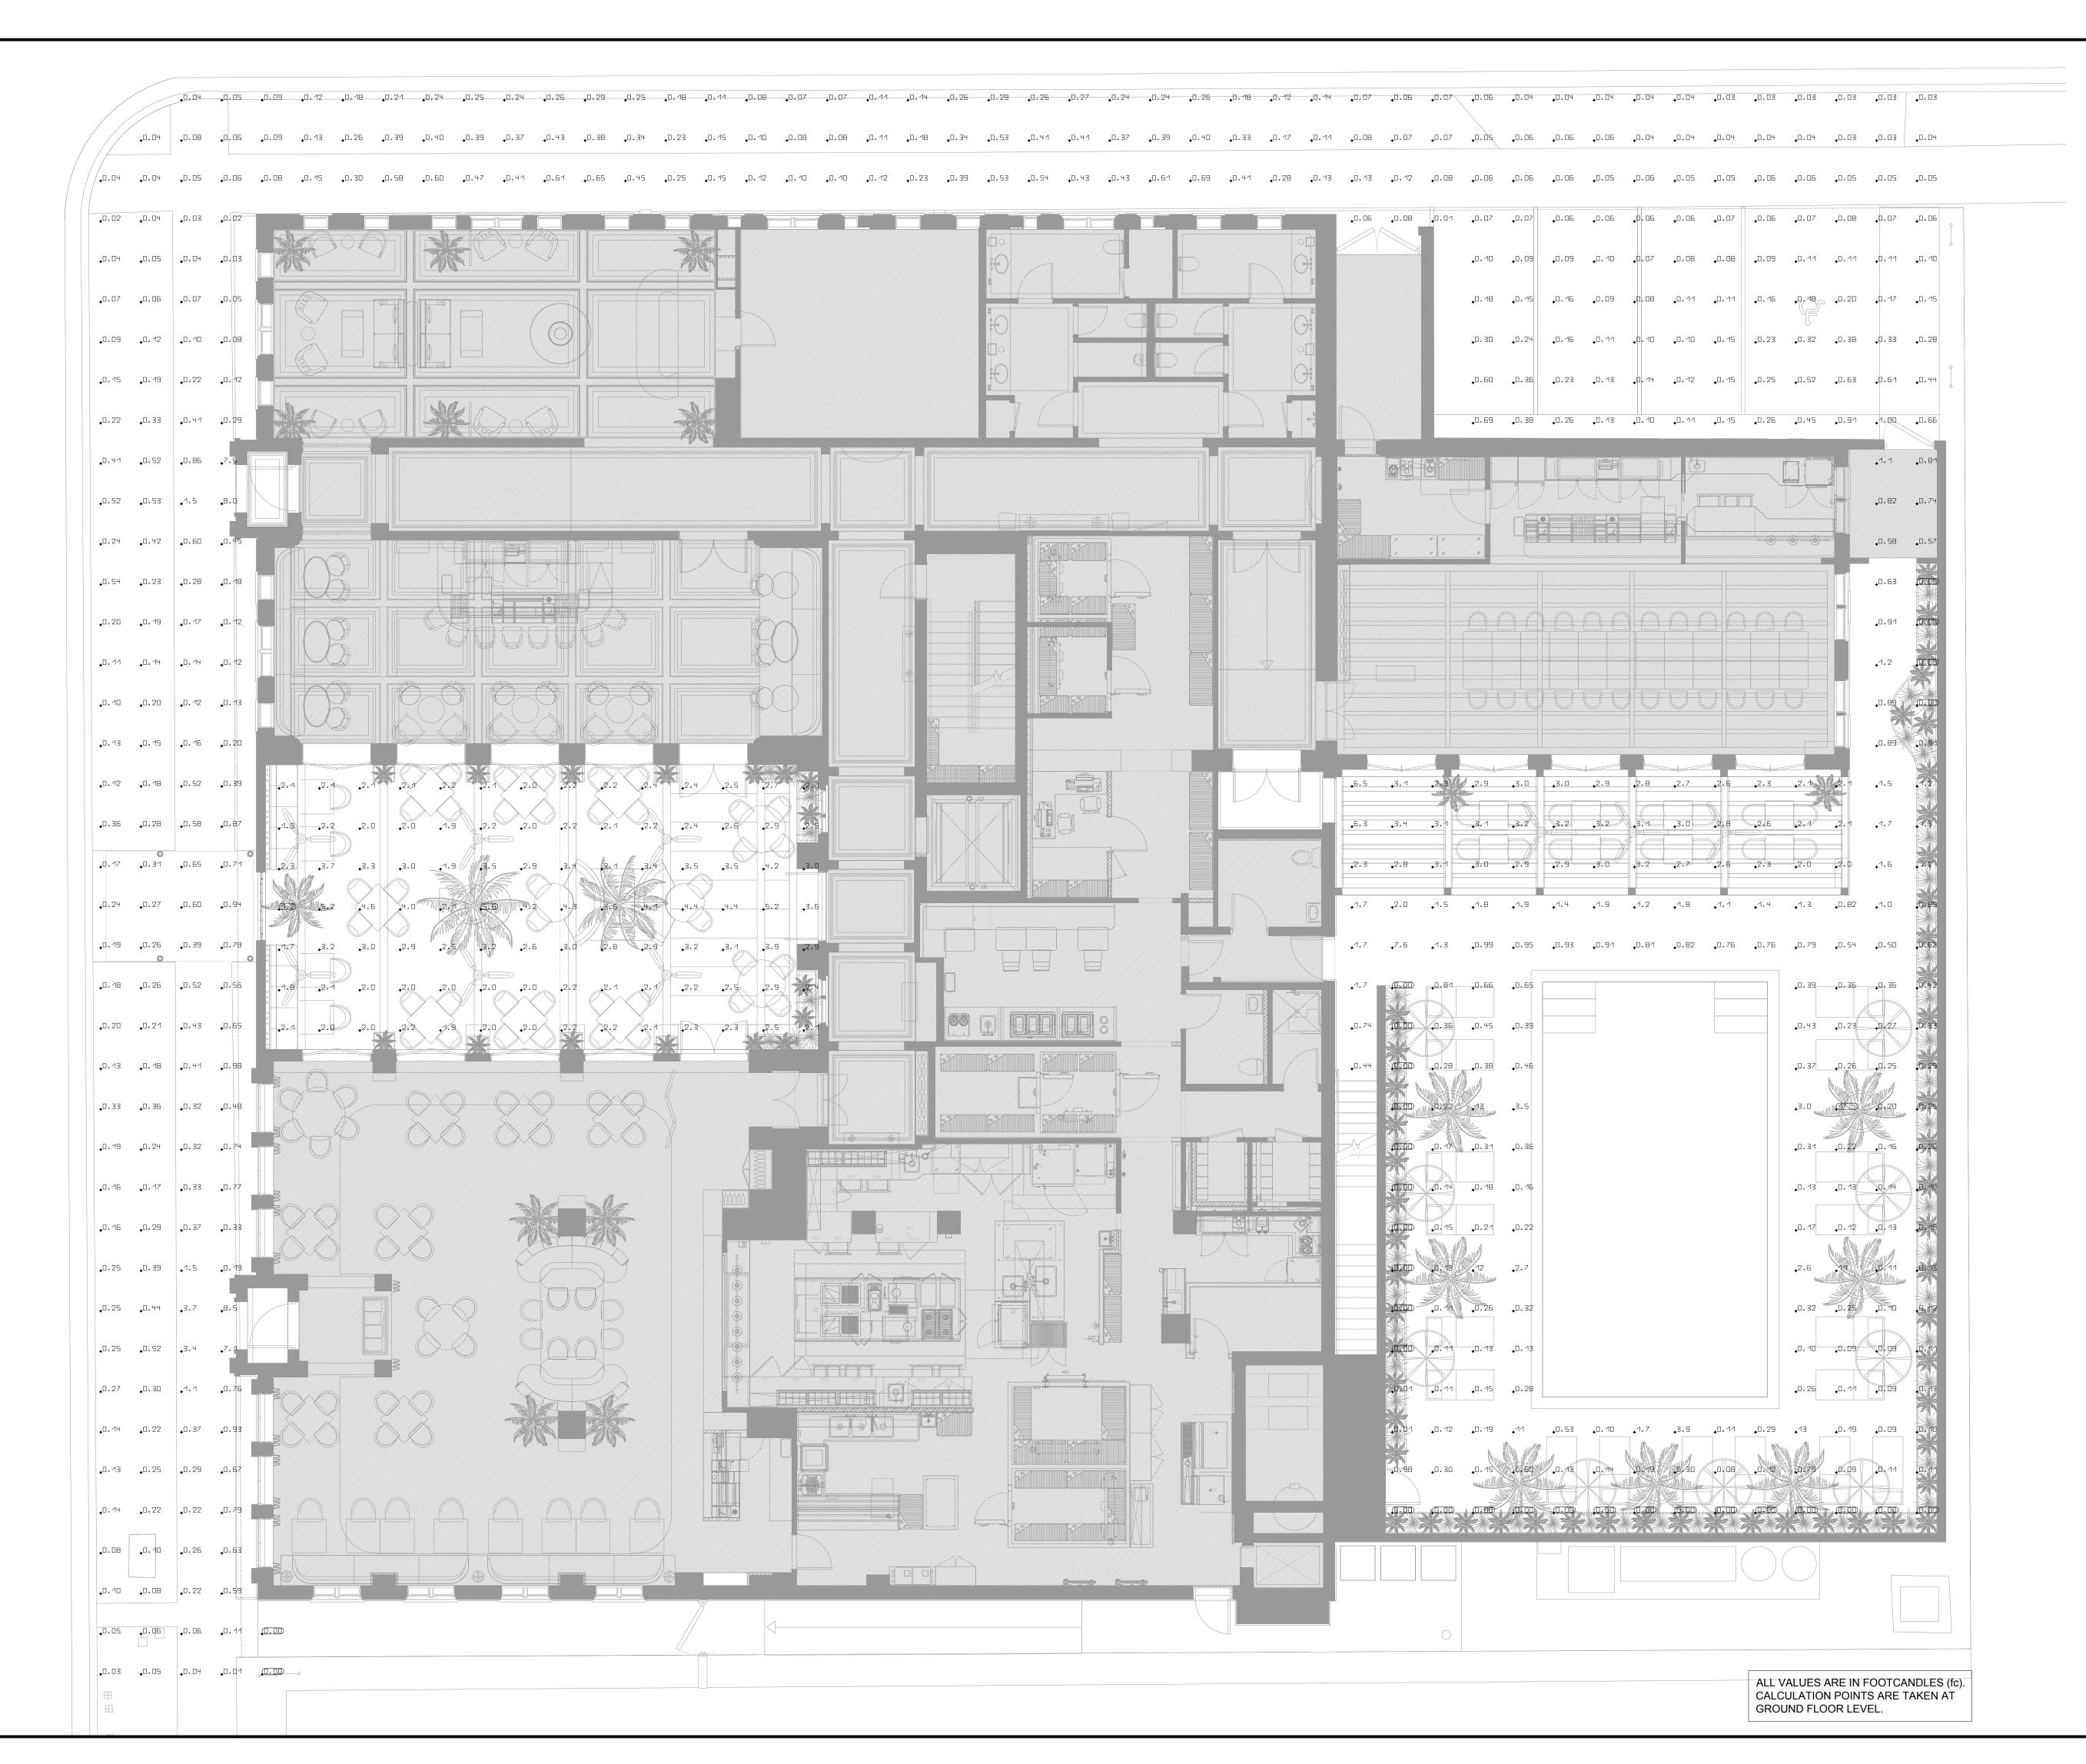

PALM BEACH, FLORIDA

LIGHTING DESIGNER

LUCIFORMA
1216 Broadway, 2nd Floor #1024
New York, NY 10001

p: +1 646.883.4151 e: studio@luciforma.com www.luciforma.com

INTERIOR DESIGNER

MLINARIC, HENRY & ZERVUDACHI

London SW1W 8JA, UK p: +44 (0) 20 7730 9072

ARCHITECT

p: 561.684.6844

38 Bourne St

SPINA OROURKE

285 Banyan Blvd
West Palm Beach Florida 33401

REVISIONS

NO. DATE ISSUENAME

ISSUE: LPC SUBMISSION

DATE: 03-31-2023

SCALE: 3/20"=1'-0"

SHEET NAME

EXTERIOR
GROUND FLOOR
PHOTOMETRICS

SHEET NUMBER

LT-406

C-4 7



View from NW Corner - Proposed

THESE DRAWINGS ARE FOR THE
EXCLUSIVE USE OF SPINA OROURKE +
PARTNERS, INC. AND MAY NOT BE
DUPLICATED, REPRODUCED OR USED IN
ANY MANNER WITHOUT THE EXPRESS
WRITTEN CONSENT OF SPINA OROURKE
+ PARTNERS, INC. ALL RIGHTS RESERVED

Project no: 22028 Date: 12.23.2022 Drawn by: Author Project Manager: Checker



Project no: 22028
Date: 12.23.2022
Drawn by: Author
Project Manager: Checker





Project no: 22028
Date: 12.23.2022
Drawn by: Author
Project Manager: Checker

THESE DRAWINGS ARE FOR THE
EXCLUSIVE USE OF SPINA OROURKE +
PARTNERS, INC. AND MAY NOT BE
DUPLICATED, REPRODUCED OR USED IN
ANY MANNER WITHOUT THE EXPRESS
WRITTEN CONSENT OF SPINA OROURKE
+ PARTNERS, INC. ALL RIGHTS RESERVED



EXISTING 54" HIGH UNSCREENED EQUIPMENT





EXISTING 103" HIGH

EXISTING 147" HIGH

EXISTING 54" HI UNSCREENED EQUIPMENT

UNSCREENED EQUIPMENT


UNSCREENED EQUIPMENT

EXISTING 54" HIGH

The Committee of the Co


UNSCREENED EQUIPMENT

FL 33480

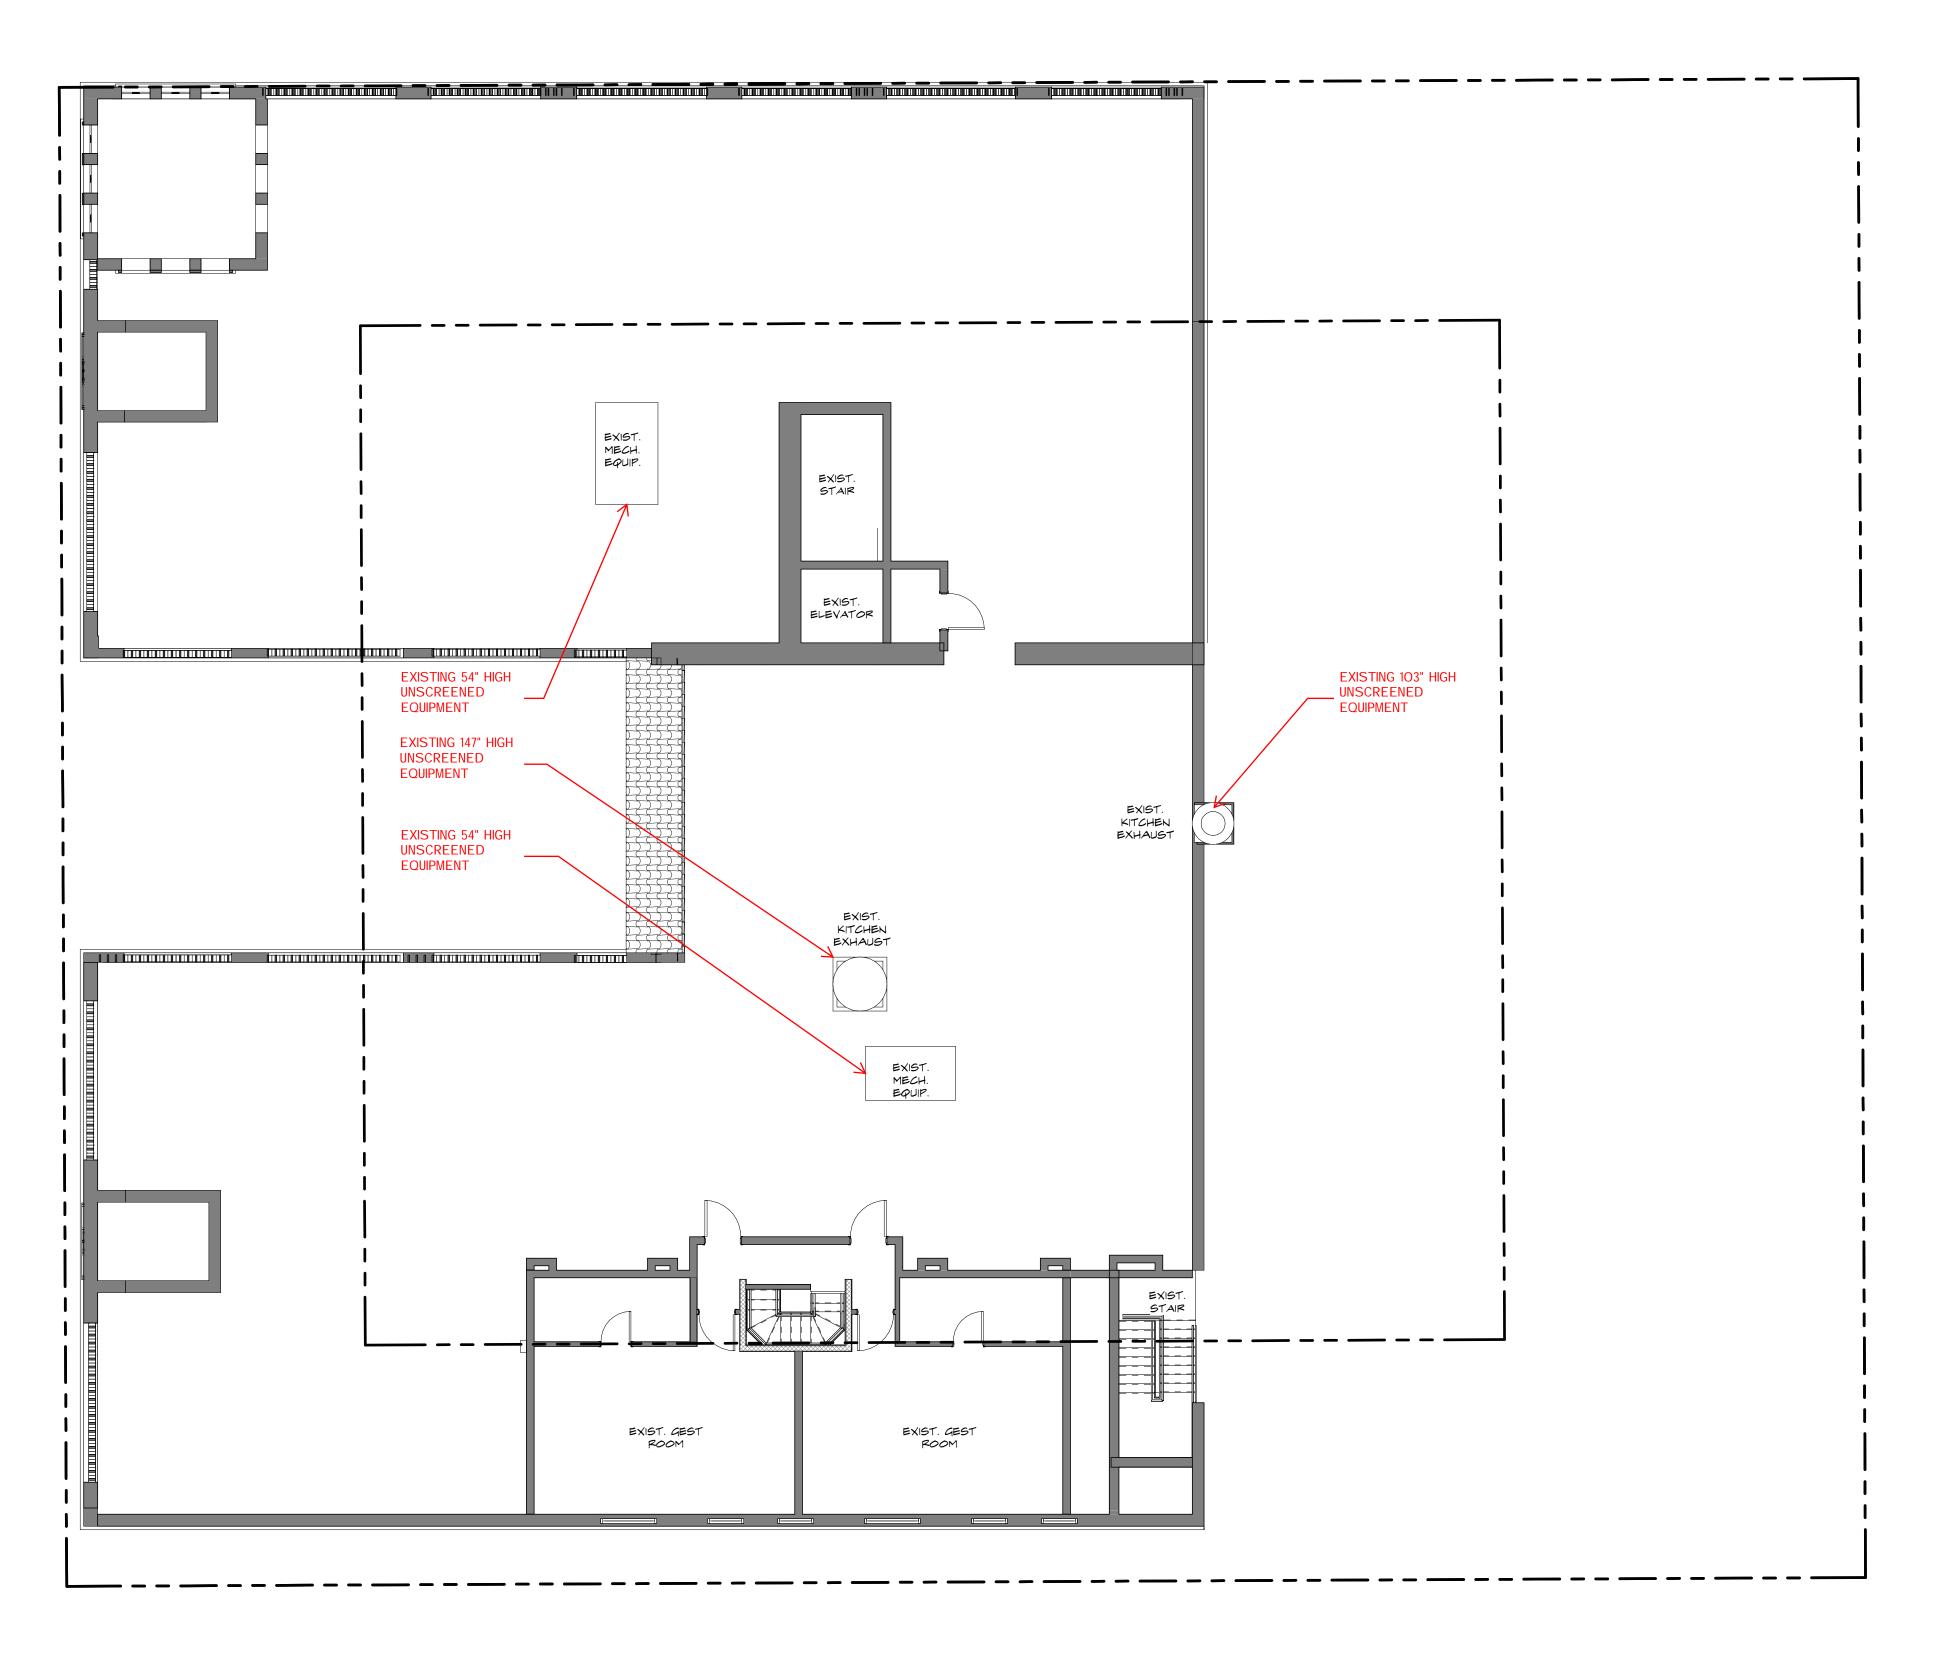

Existing Fourth Floor & Roof Plan

SCALE: 1/8" = 1'-0"

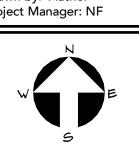


AC-2.4.2 CONSTRUCTION DOCUMENTS


PROPOSED

ROOM KEY COUNT


SECOND FLOOR THIRD FLOOR FOURTH FLOOR

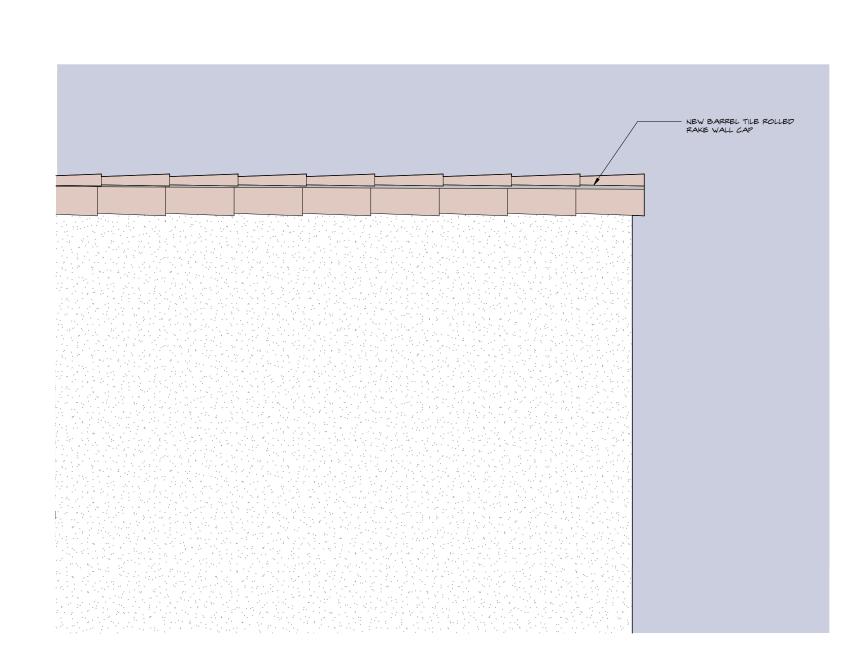

**Elevation Detail** 

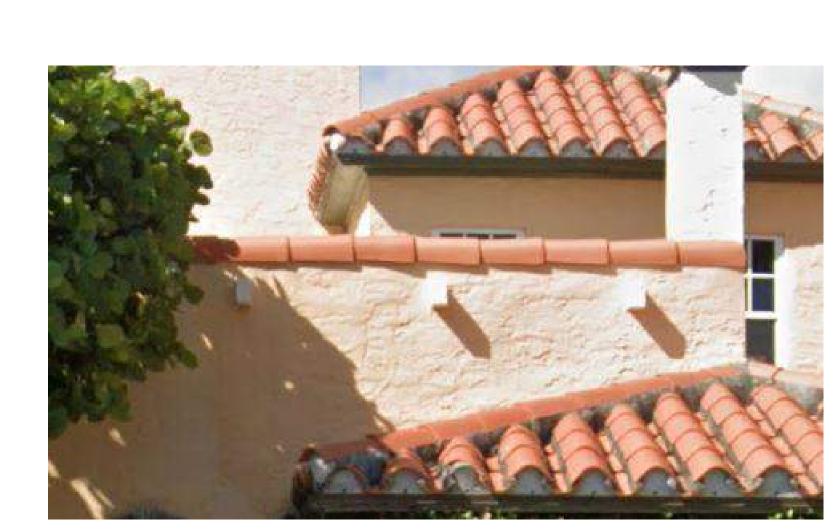

Example Image

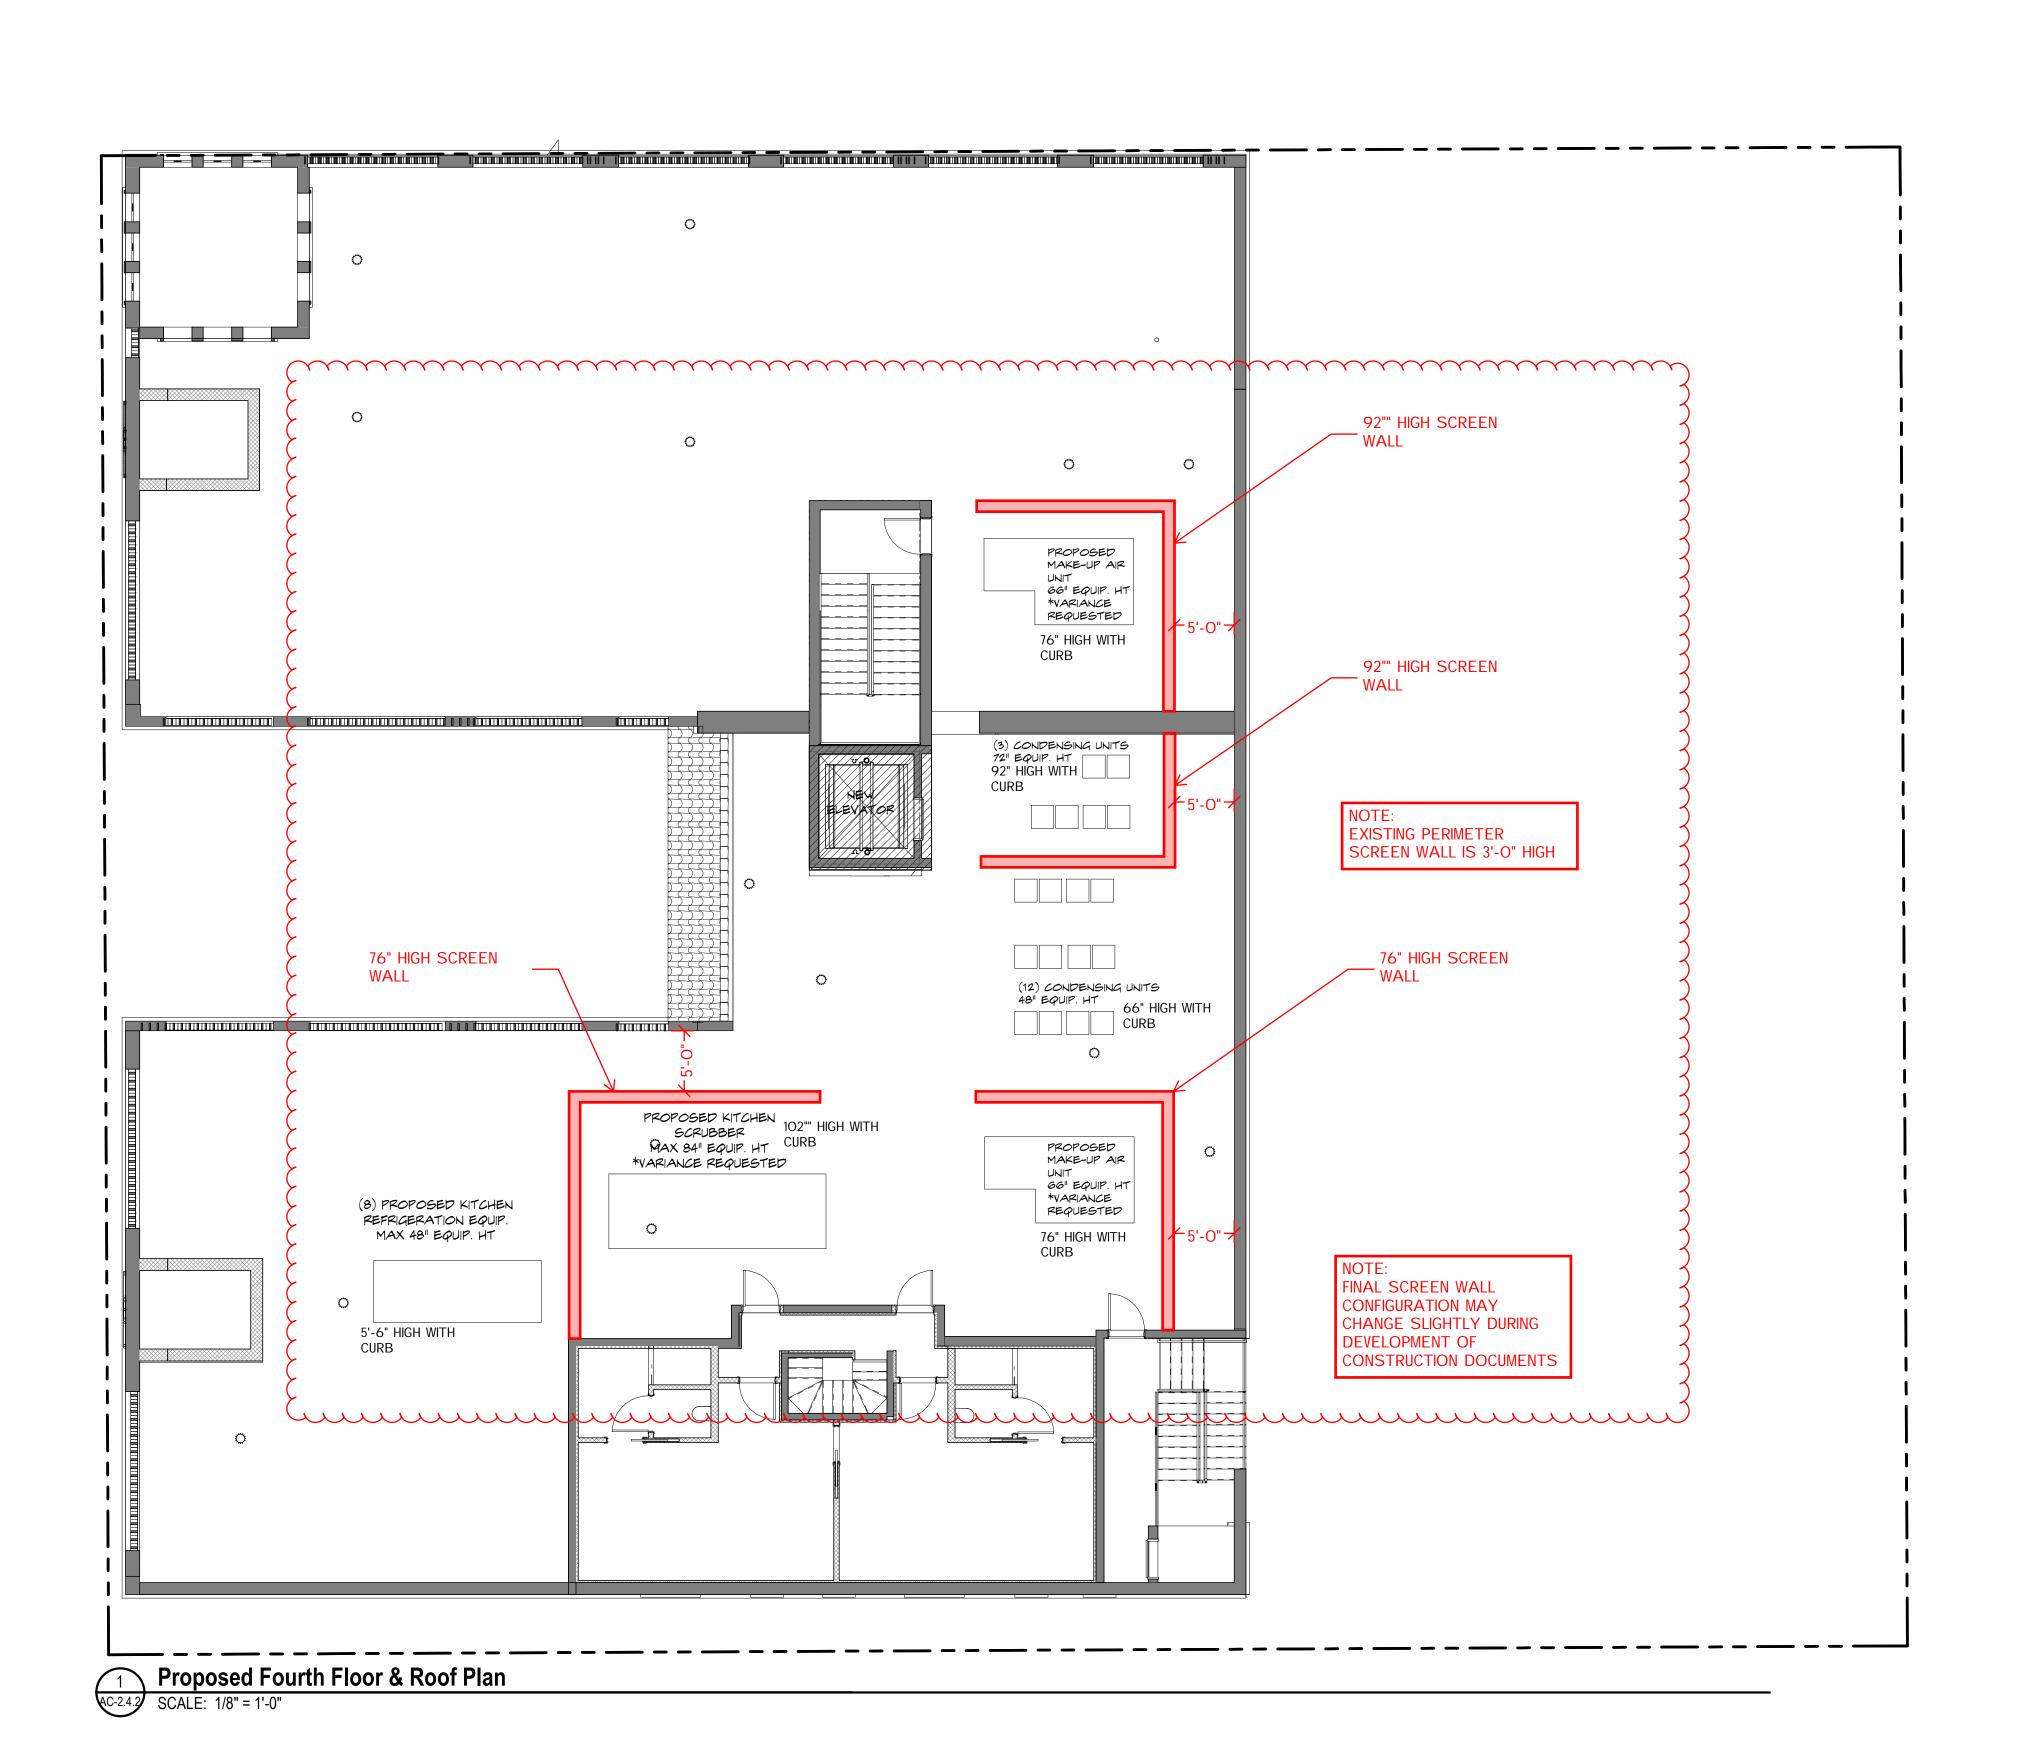





Row, RENOVATION OF The Vineta


33480


363 THESE DRAWINGS ARE FOR THE EXCLUSIVE USE OF SPINA OROURKE + PARTNERS, INC. AND MAY NOT BE DUPLICATED, REPRODUCED OR USED IN WRITTEN CONSENT OF SPINA OROURKE + PARTNERS, INC. ALL RIGHTS RESERVED


Revisions:

Project no: 22028 Date: 10.24.2022 Drawn by: Author Project Manager: Checker

\* AC-4.2.1

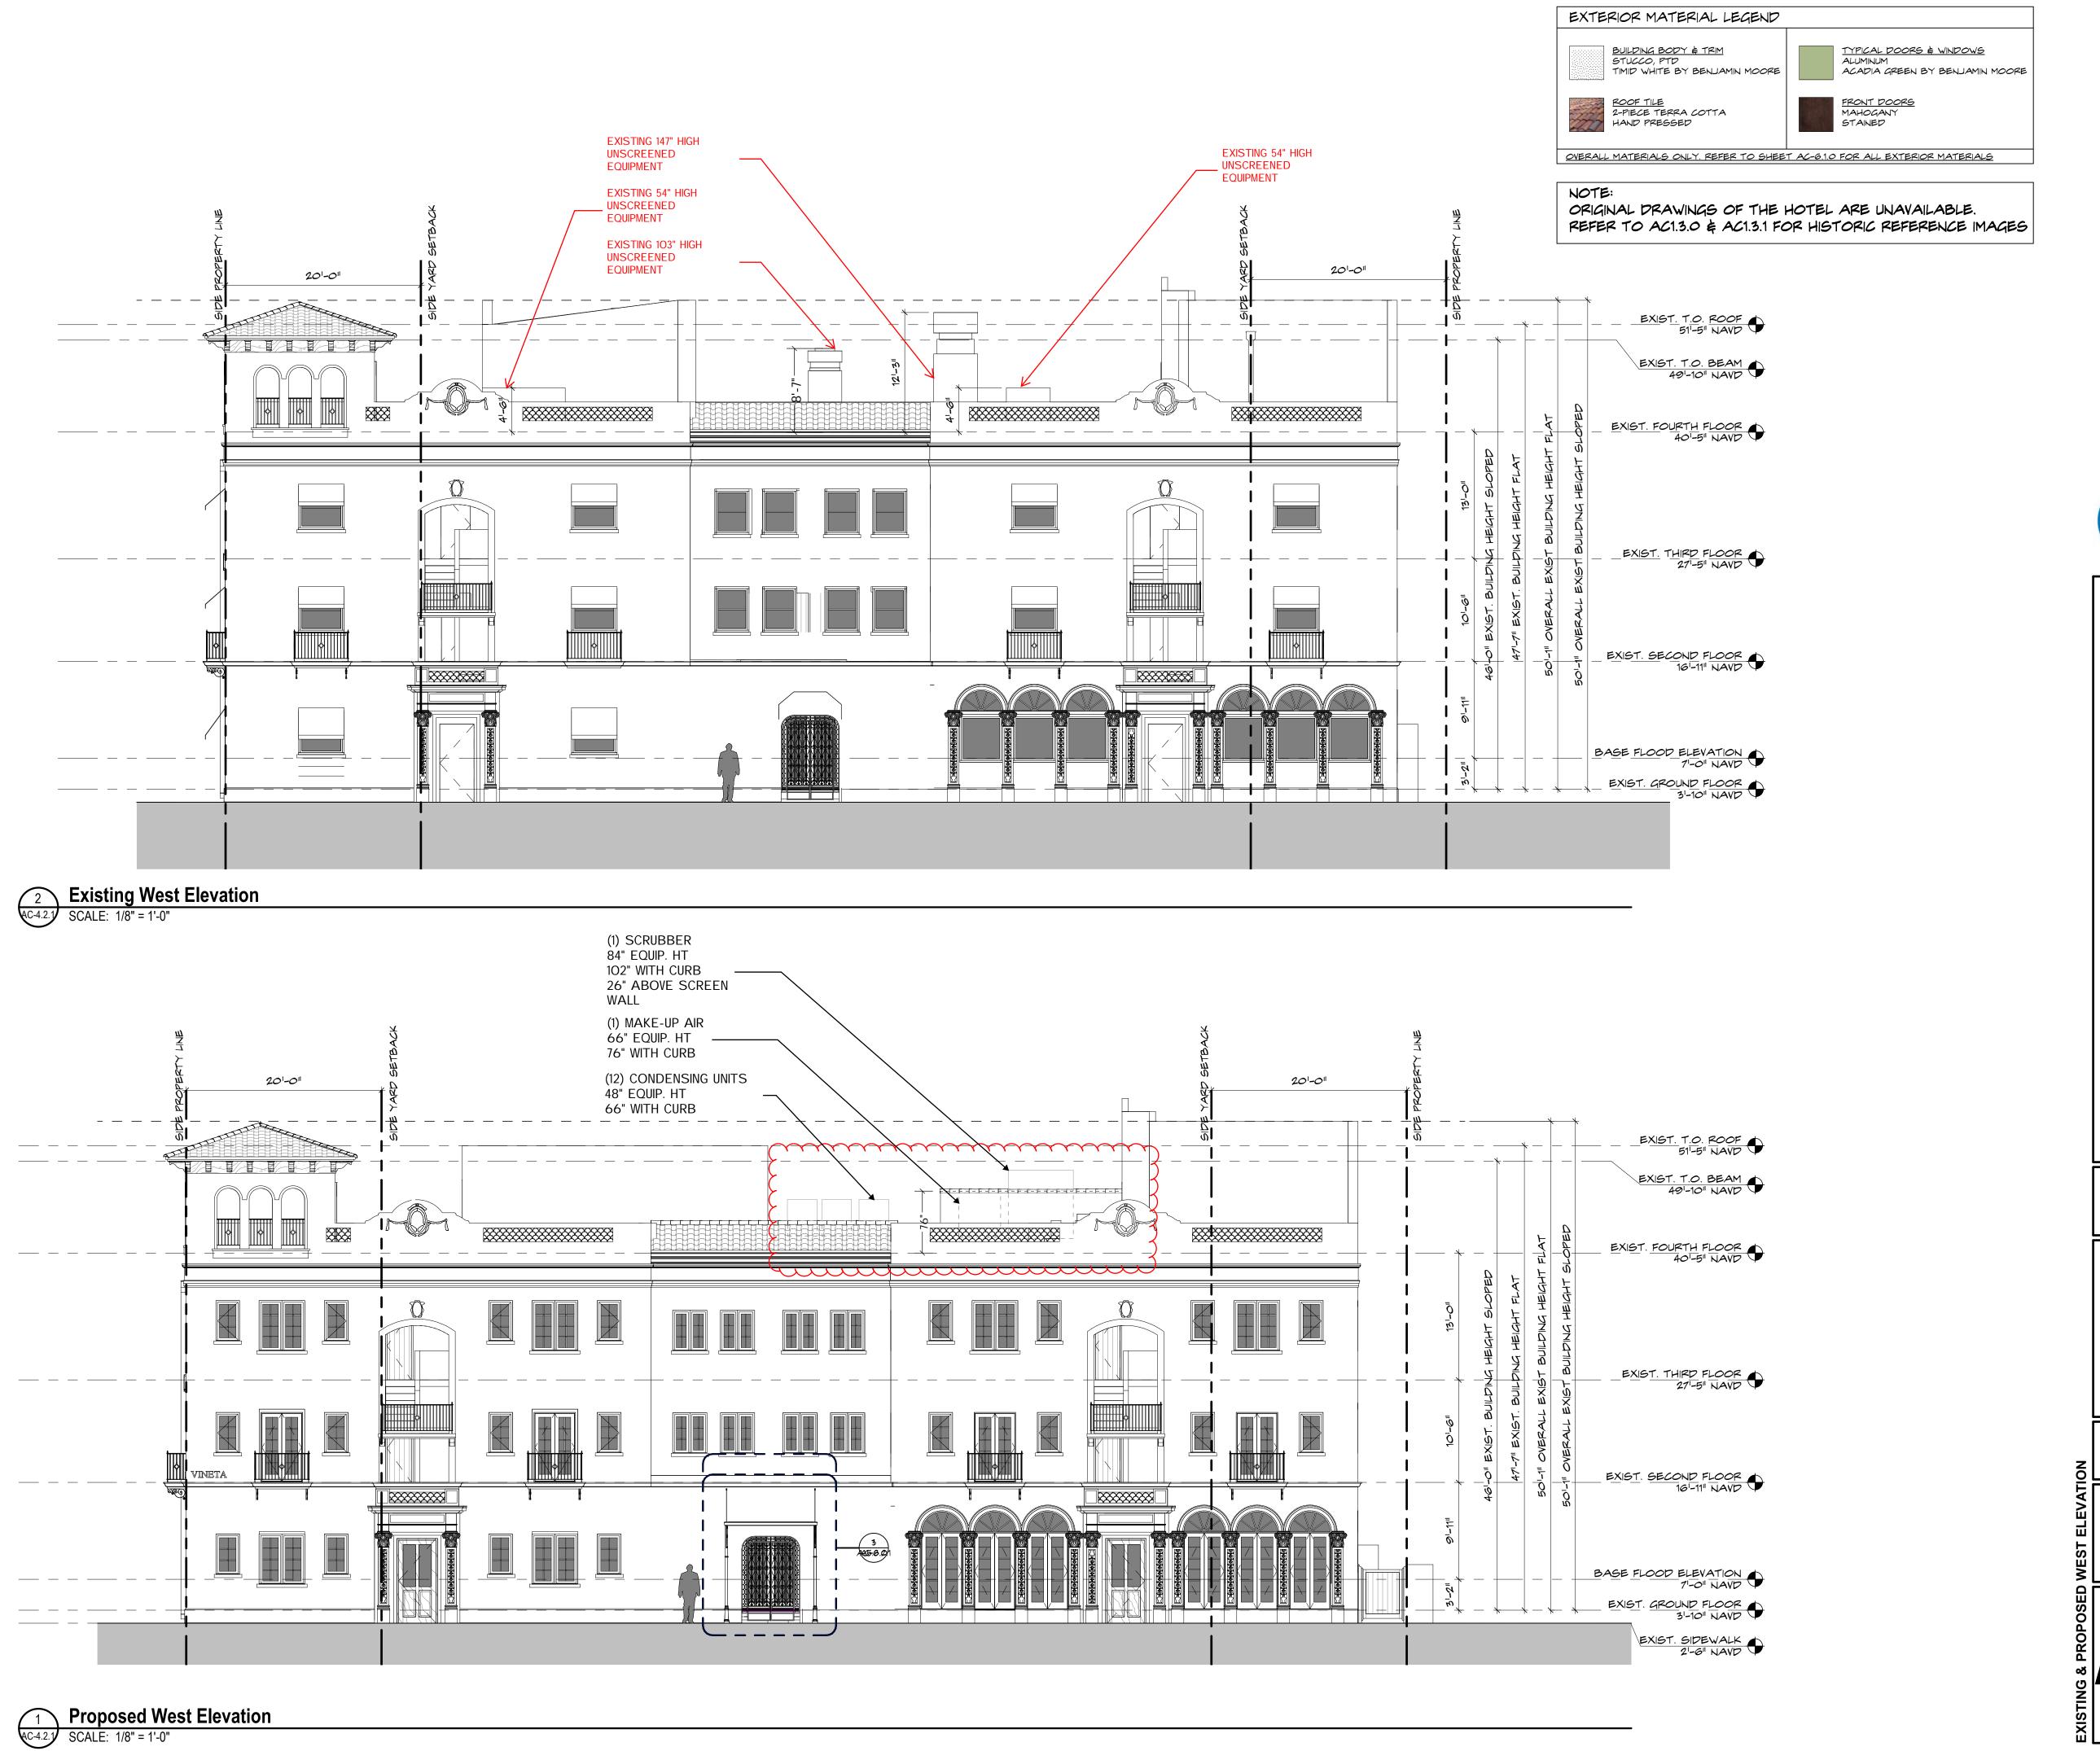

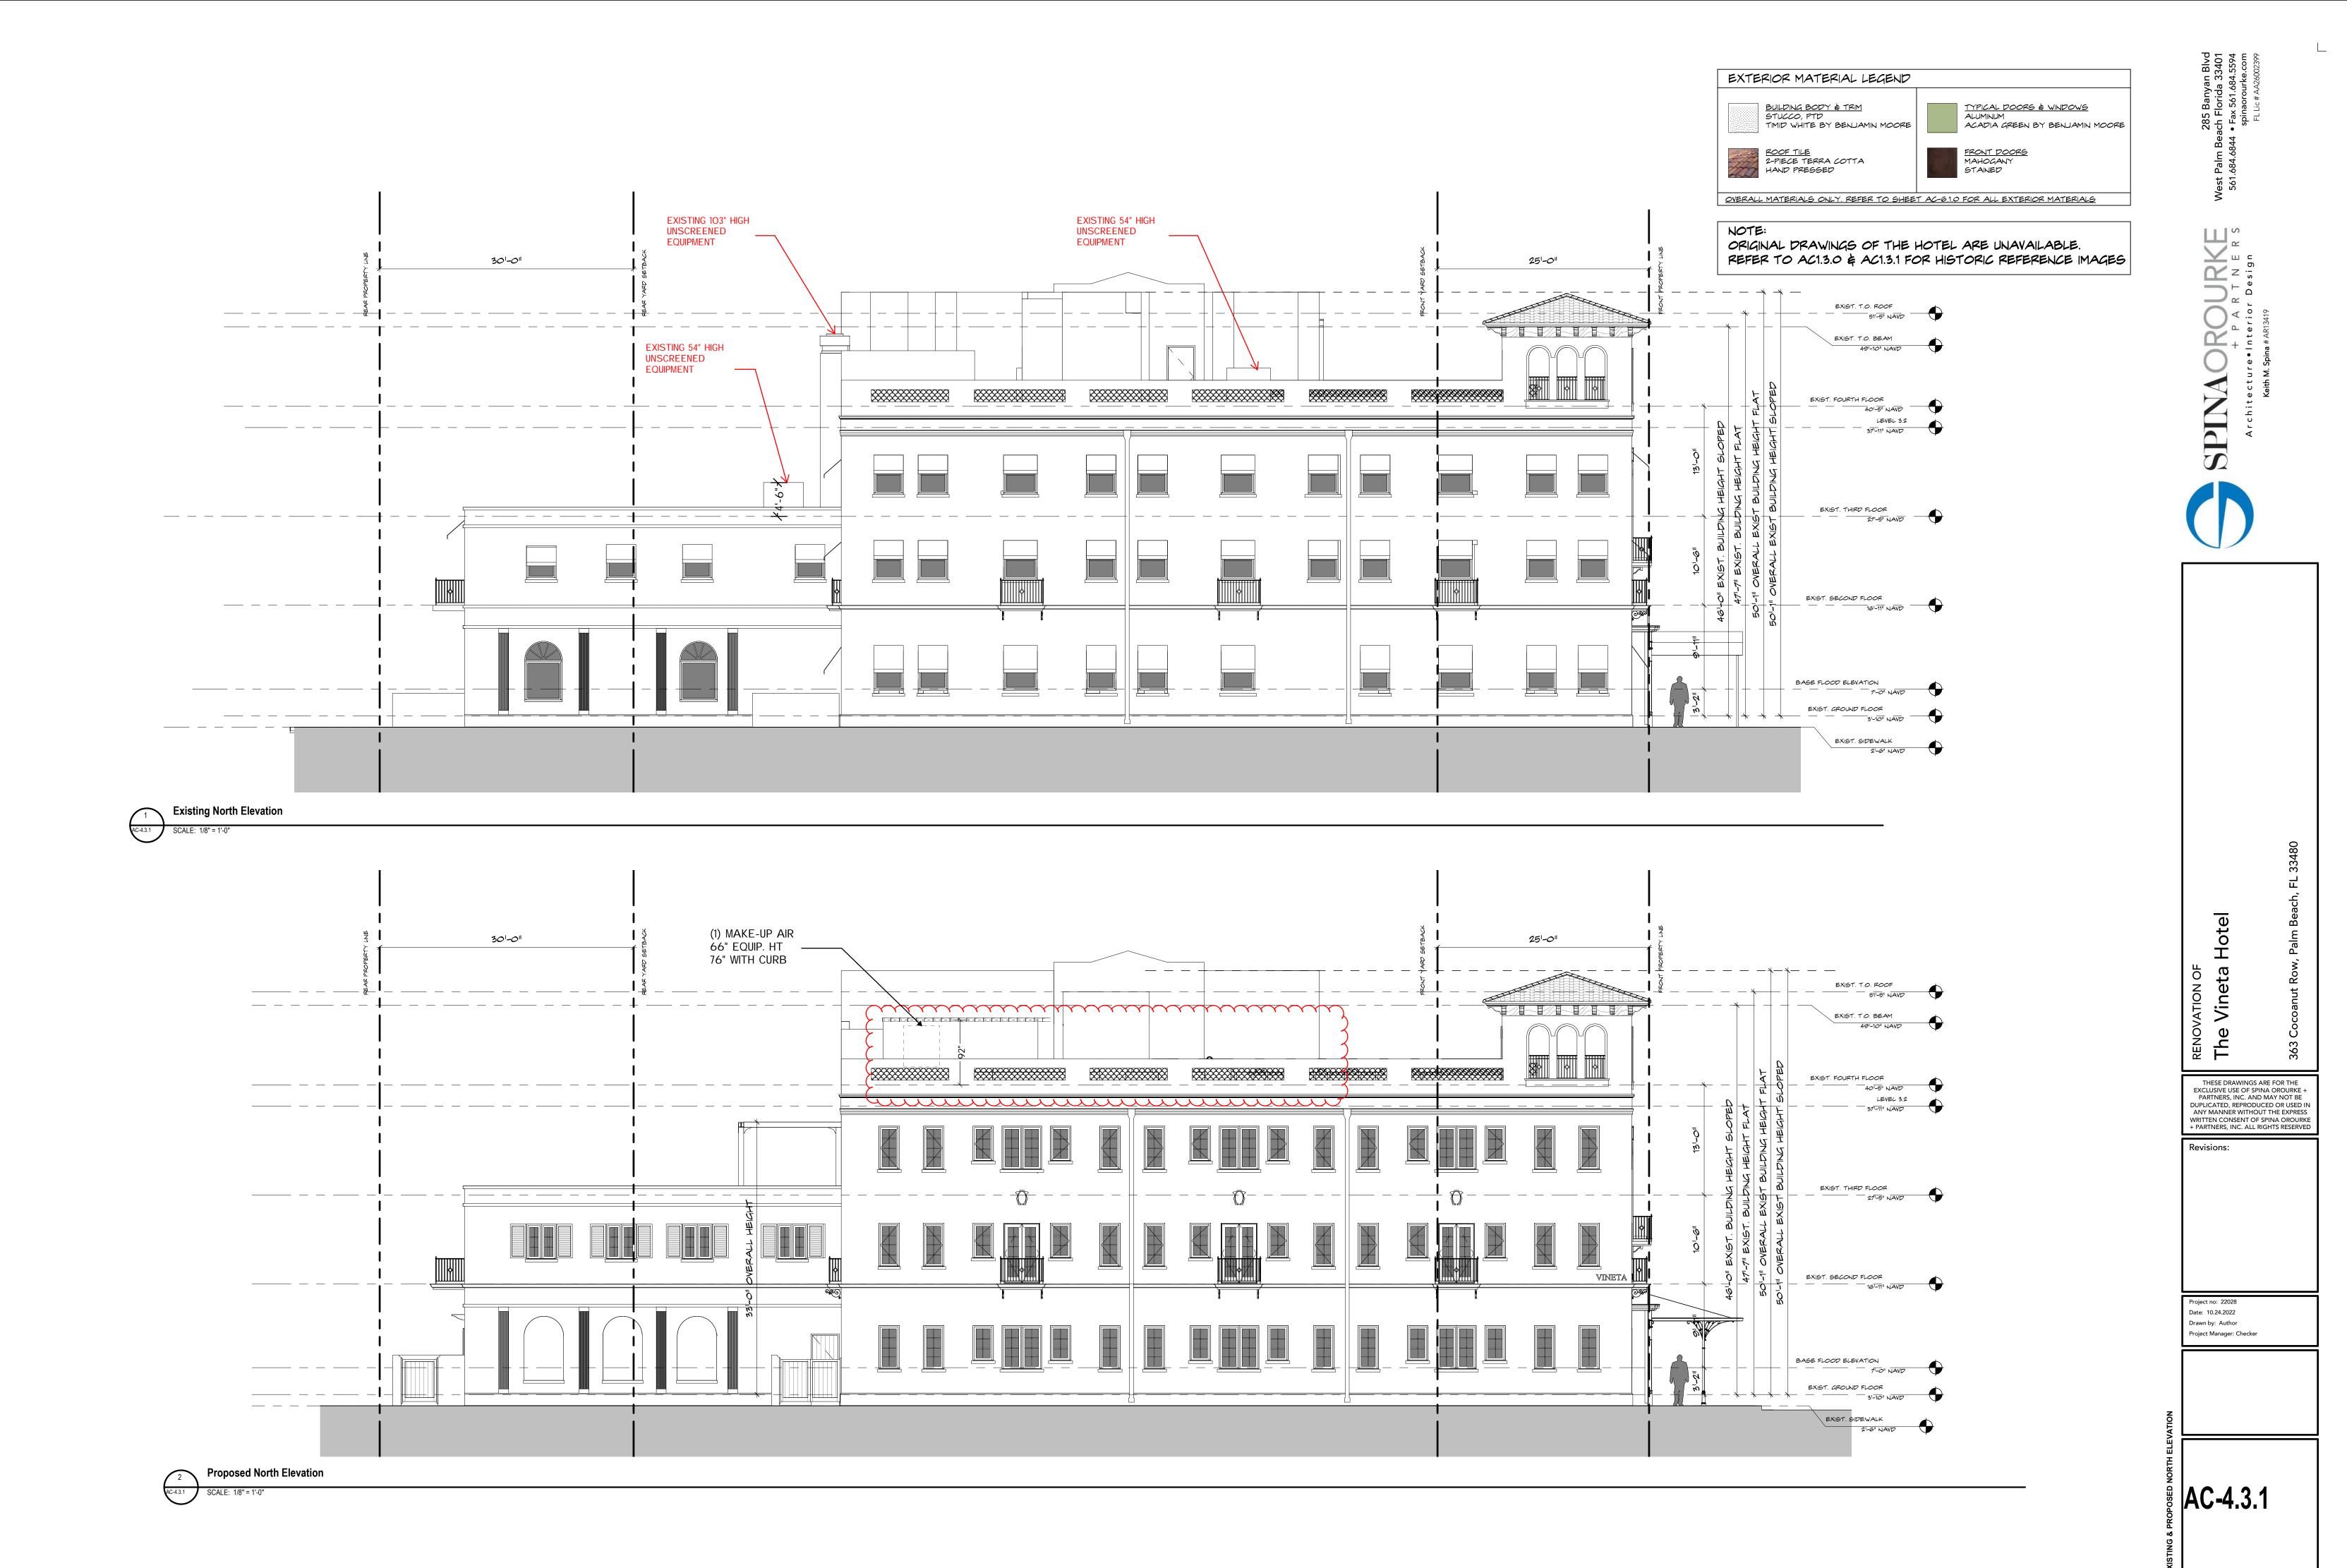

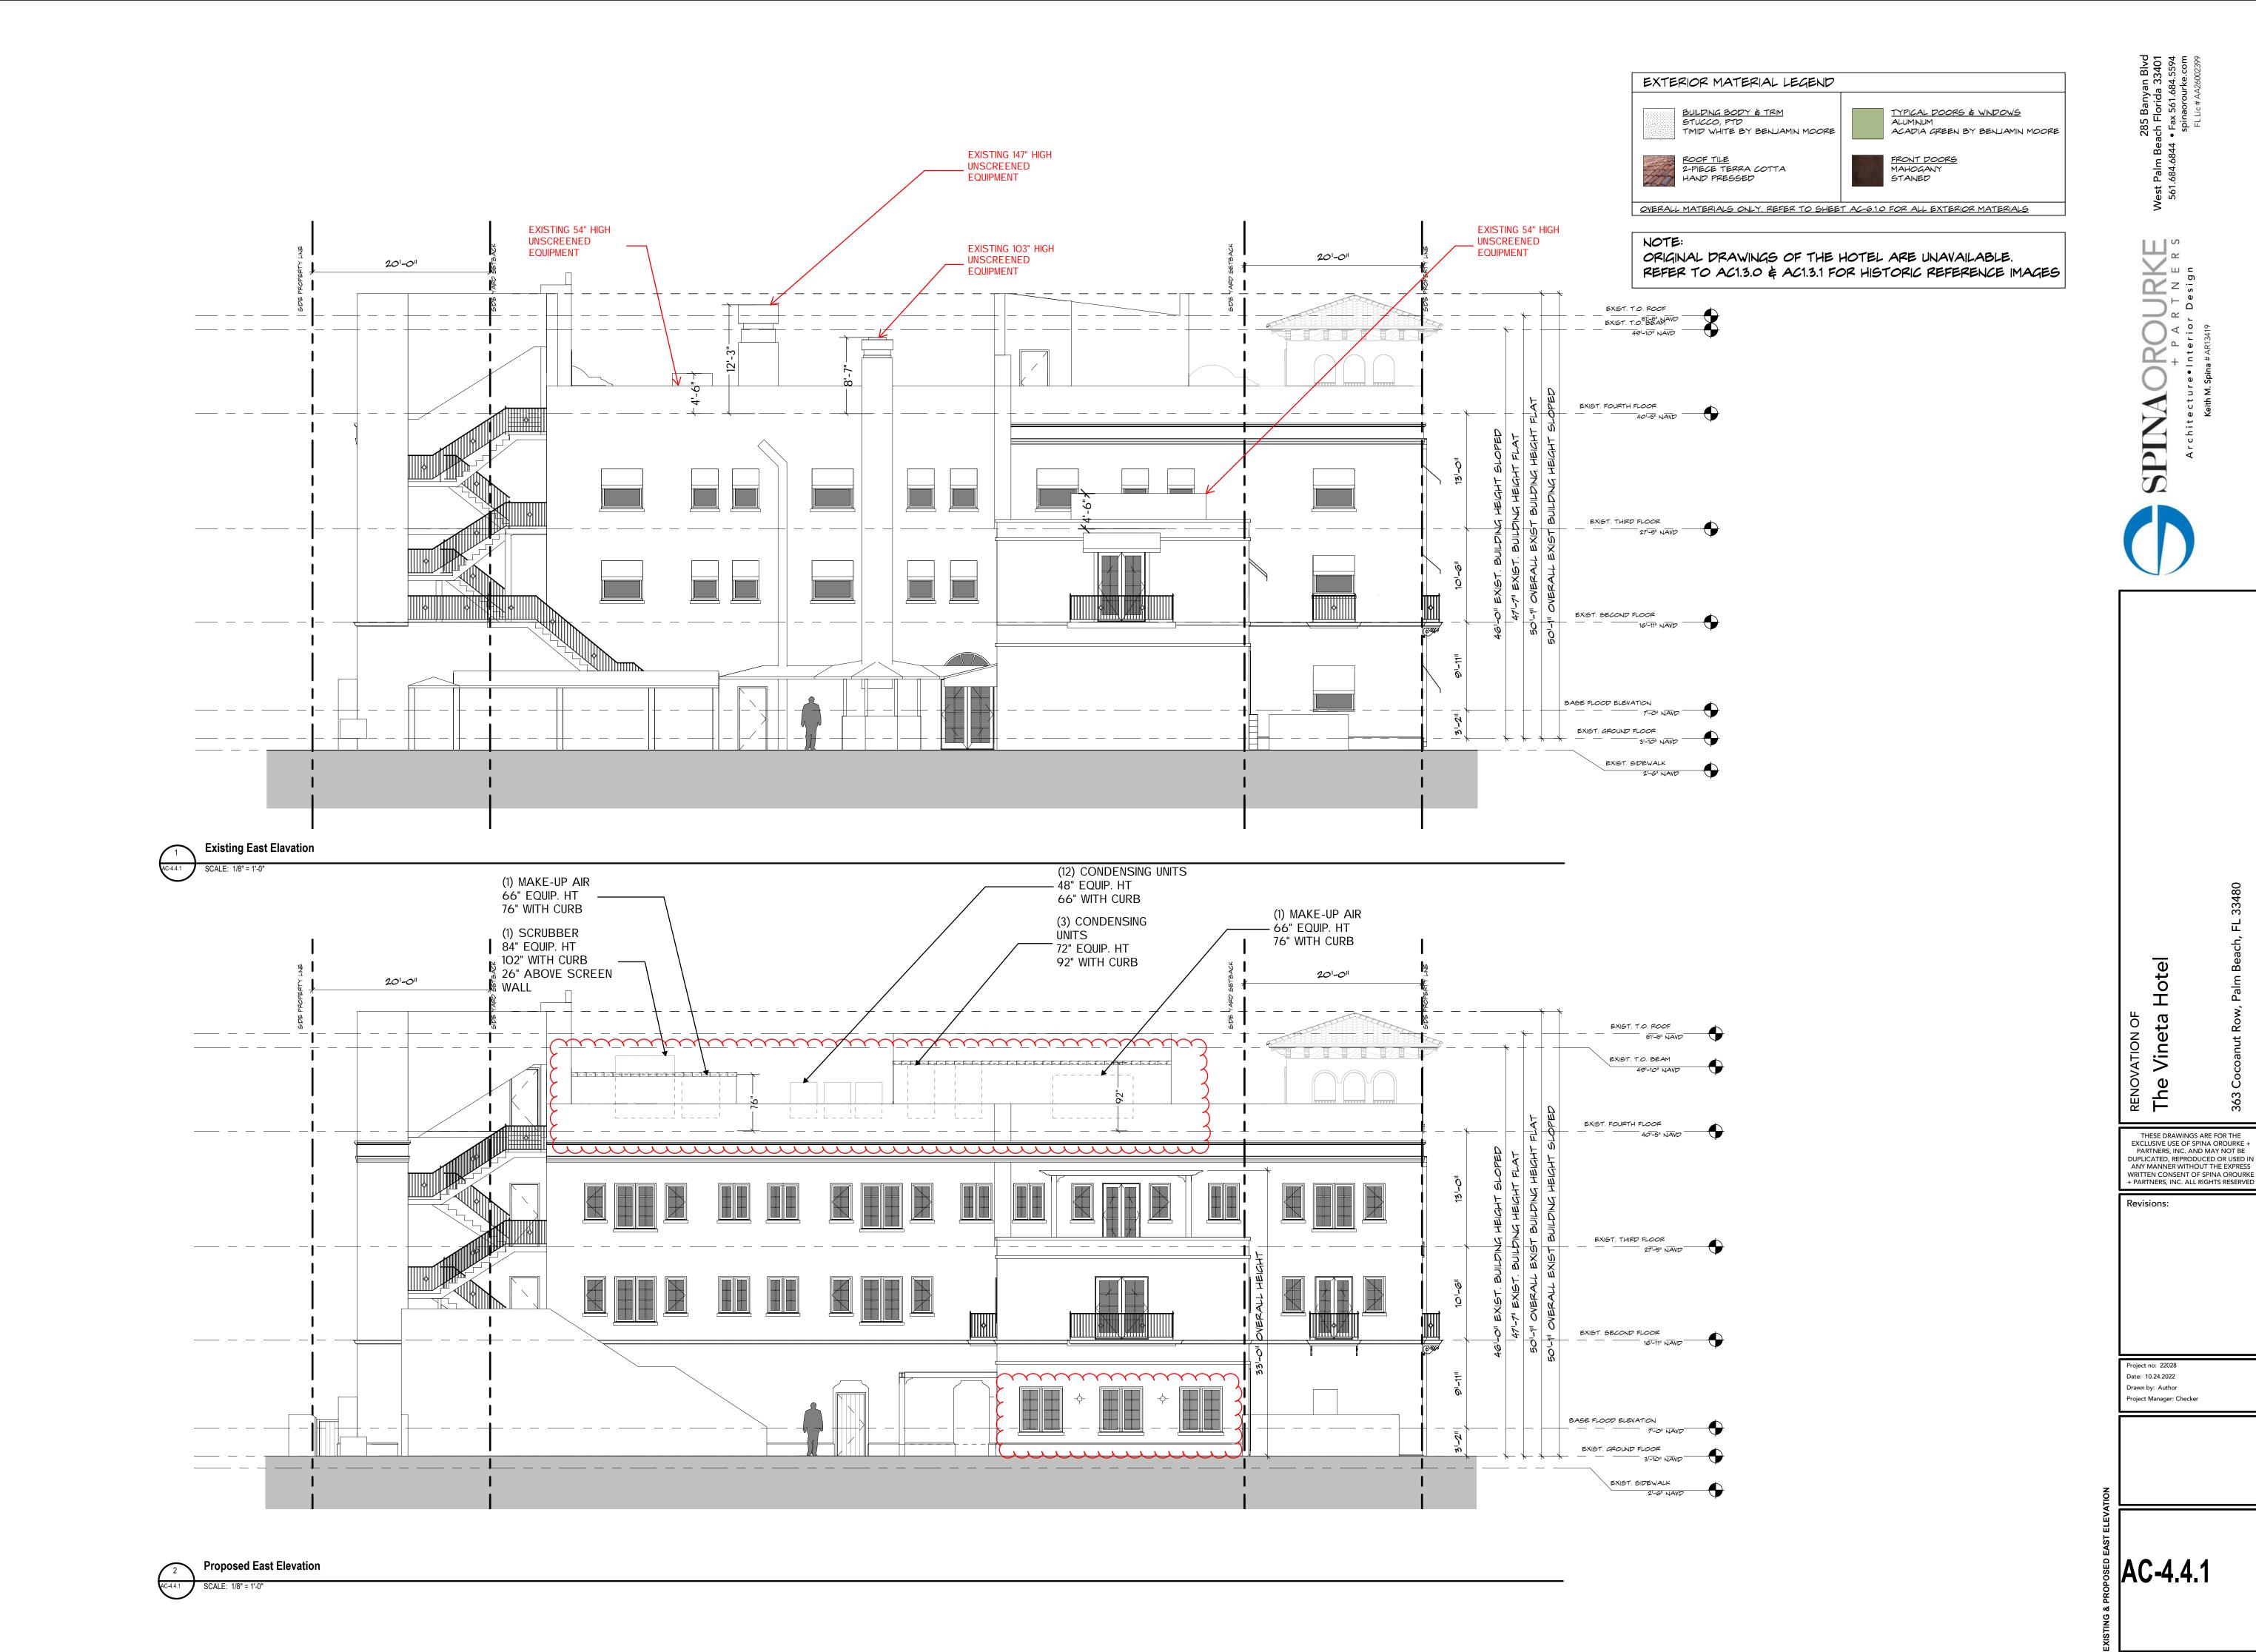



A-1.0

FL 33480 RENOVATION OF The Vineta

363 Cocoanut Row,

THESE DRAWINGS ARE FOR THE
EXCLUSIVE USE OF SPINA OROURKE +
PARTNERS, INC. AND MAY NOT BE
DUPLICATED, REPRODUCED OR USED IN
ANY MANNER WITHOUT THE EXPRESS
WRITTEN CONSENT OF SPINA OROURKE
+ PARTNERS, INC. ALL RIGHTS RESERVED

Revisions:

000000


PREVIOUSLY APPROVED FLOOR PLAN - NANAWALL



PREVIOUSLY APPROVED SOUTH ELEVATION - NANAWALL



PREVIOUSLY APPROVED EAST ELEVATION - SINGLE WINDOWS

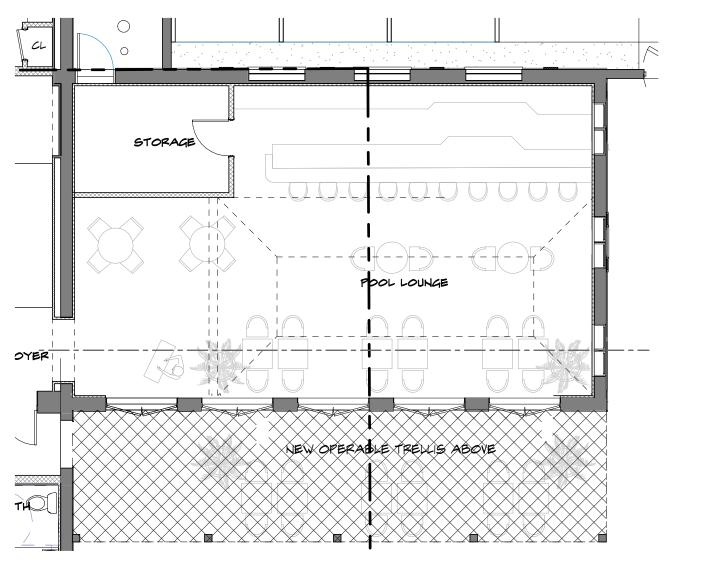

PROPOSED FLOOR PLAN - (5) FRENCH DOORS



PROPOSED SOUTH ELEVATION - (5) FRENCH DOORS



PROPOSED EAST ELEVATION - DOUBLE WINDOWS

