
RECEIVED By yfigueroa at 2:31 pm, Mar 07, 2023

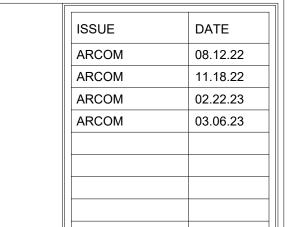


GREGORY BONNER, AIA

AA 26003271

DRAWN BY	RR
SCALE	AS NOTED
PLOT DATE	02.17.22
JOB NO.	240OLE

SOUTH ELEVATION RENDERING

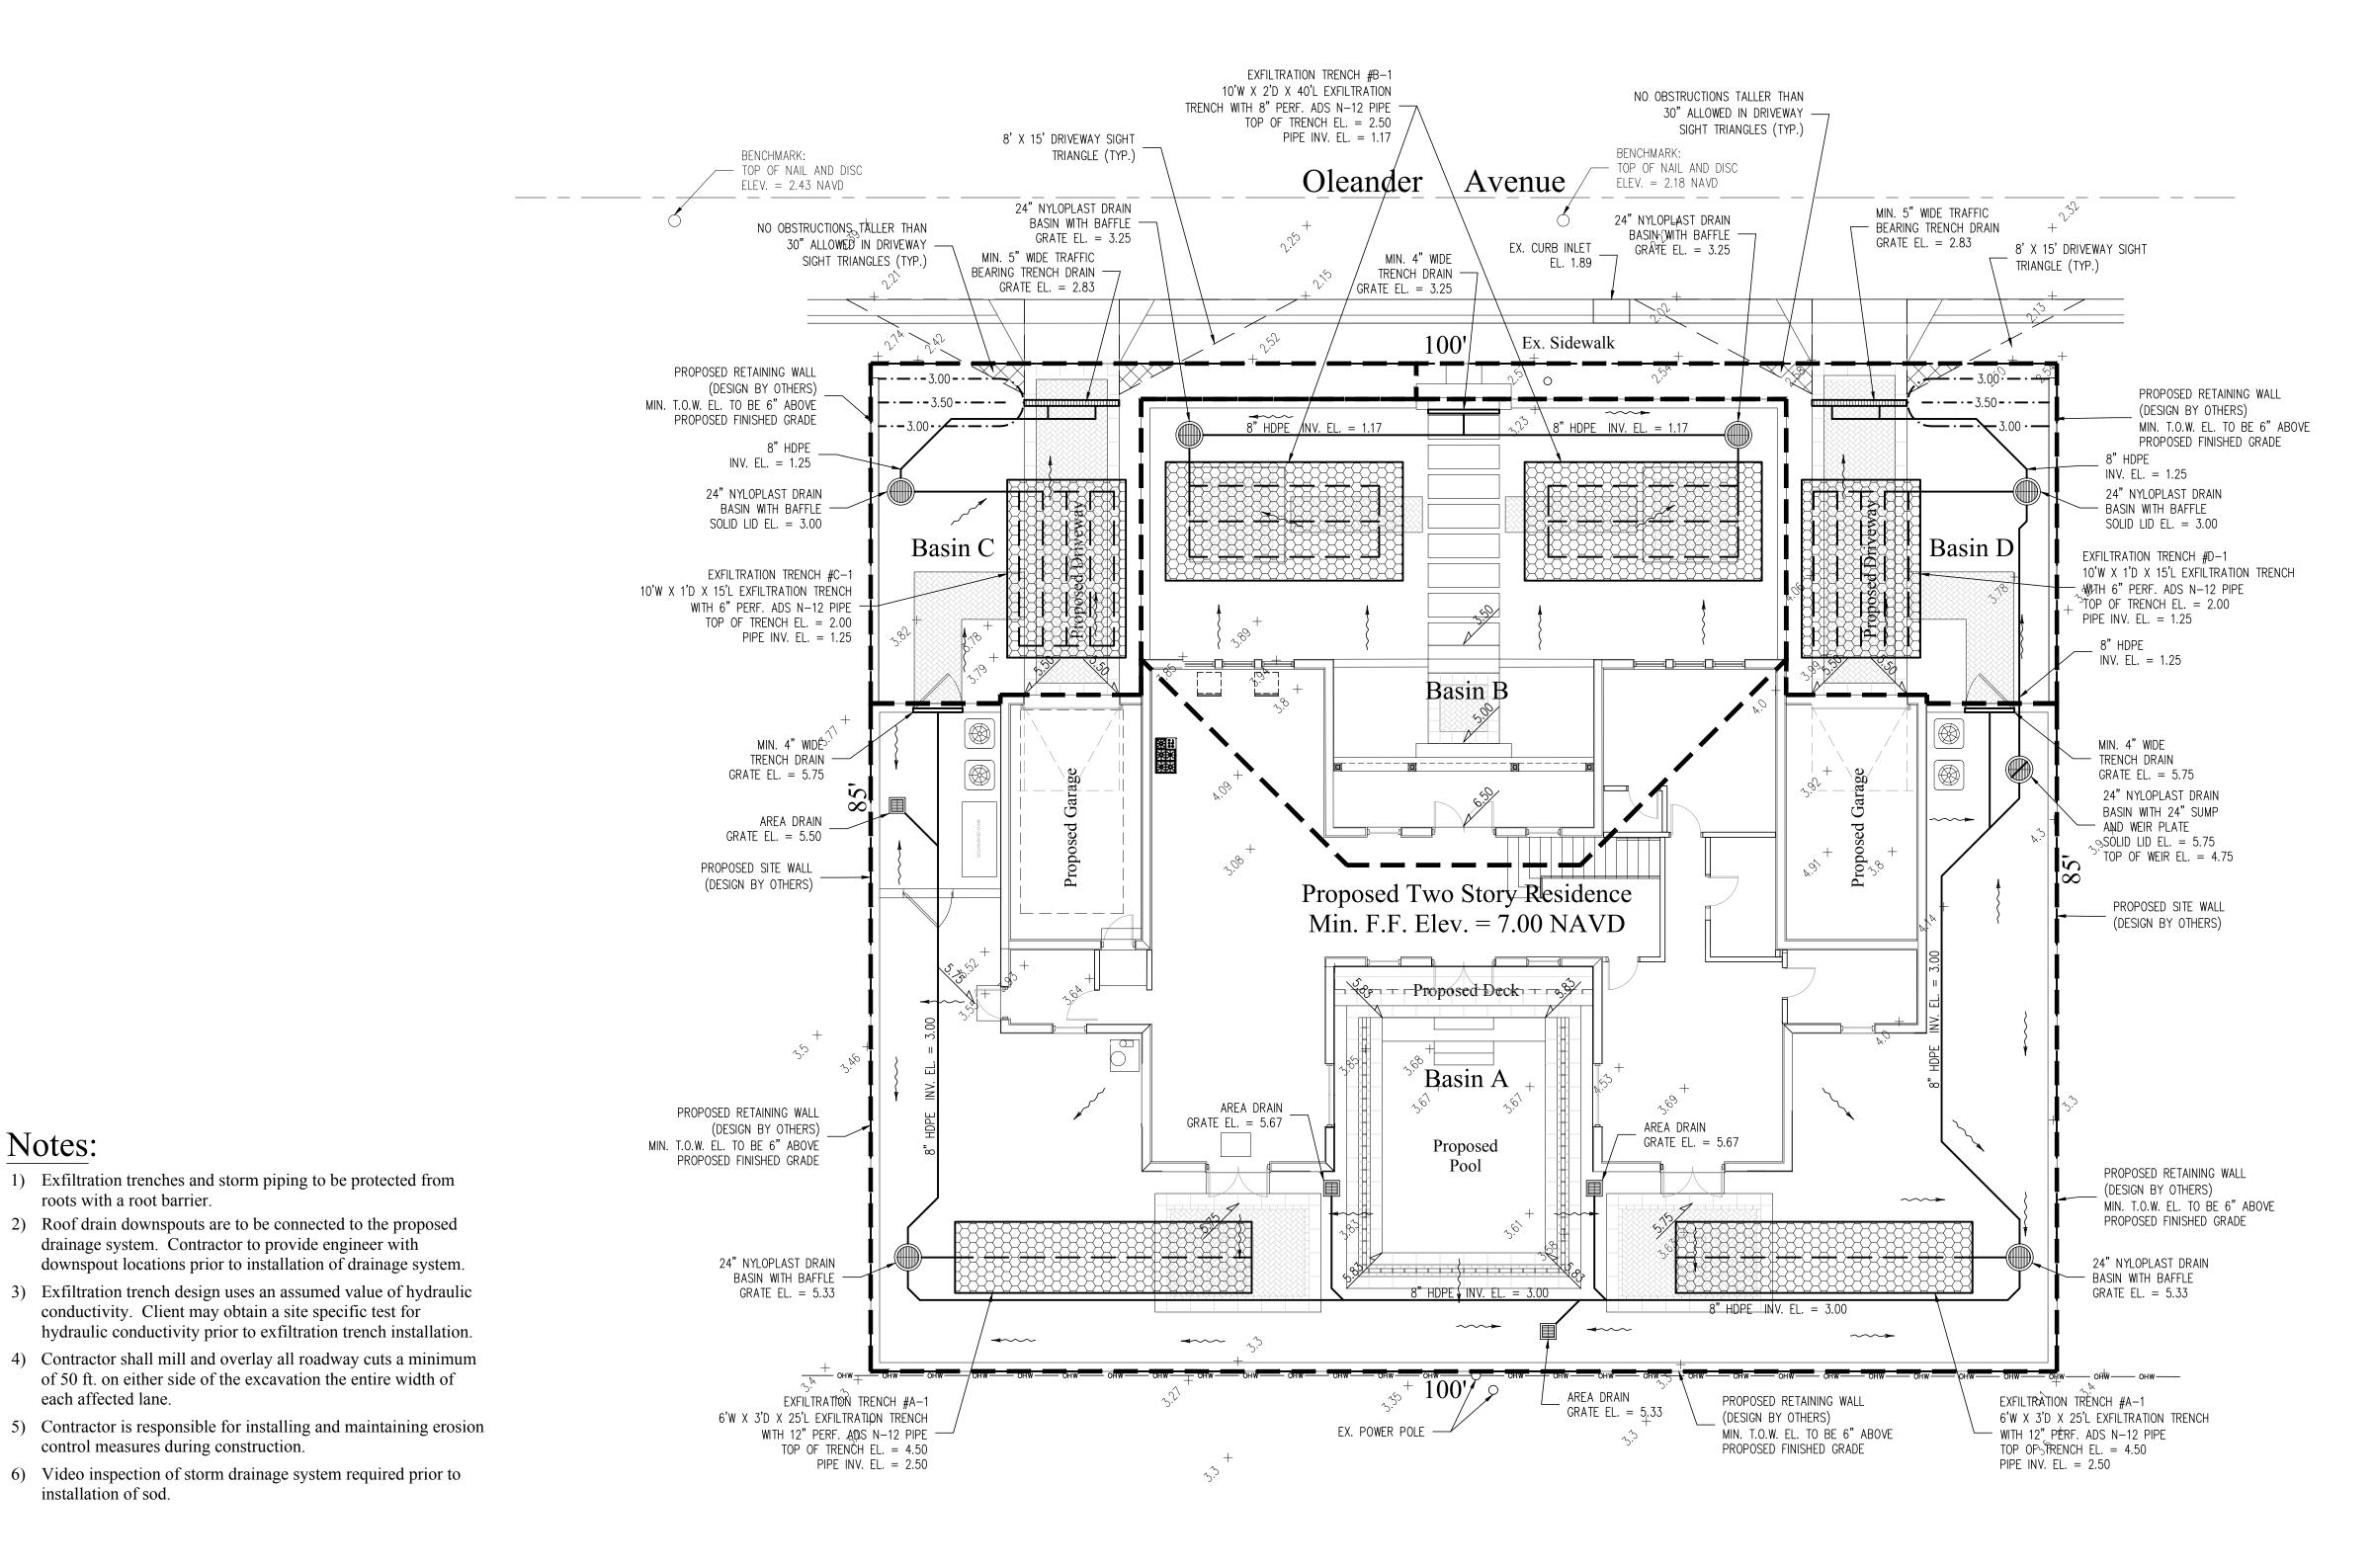

STORMWATER RETENTION CALCULATIONS (Basin A)

A. SITE INFORMATION

Notes:

roots with a root barrier.

each affected lane.

installation of sod.

control measures during construction.

Total Property Area = 8,500 sq.ft.

Drainage Basin Area = 5,209 sq.ft.

Drainage Basin Impervious Surface Area = 2,802 sq.ft.

Drainage Basin Pervious Surface Area = 2,407 sq.ft.

B. ESTIMATED STORMWATER RETENTION VOLUME

The retention volume is estimated using the Rational Method (Q=CiA)

C = 1.0 (impervious surface)

C = 0.2 (pervious surface)

Impervious Surface Runoff Volume: 1.0 x 2 in/hr x 2,802 sq.ft. x 1 ft./12 in. = 467 cu.ft.

 $0.2 \times 2 \text{ in/hr} \times 2,407 \text{ sq.ft.} \times 1 \text{ ft./}12 \text{ in.} = 81 \text{ cu.ft.}$

Total Volume to be Retained = 548 cu.ft.

C. PROPOSED EXFILTRATION TRENCH SIZING

Exfiltration Trench #A-1

= Total Length of Trench Provided = 50 ft W = Trench Width = 6 ft = 0.00005 cfs/sq.ft./ft. of head Hydraulic Conductivity = 3.25 ft

Depth to Water Table = 3.00 ftUn-Saturated Trench Depth Saturated Trench Depth = 0.00 ft

= 726 cu.ft. Volume Treated

STORMWATER RETENTION CALCULATIONS (Basin B)

A. SITE INFORMATION

Total Property Area = 8,500 sq.ft.

Drainage Basin Area = 1,836 sq.ft.

Drainage Basin Impervious Surface Area = 1,038 sq.ft.

Drainage Basin Pervious Surface Area = 798 sq.ft.

B. ESTIMATED STORMWATER RETENTION VOLUME

The retention volume is estimated using the Rational Method (Q=CiA)

C = 1.0 (impervious surface) C = 0.2 (pervious surface)

Impervious Surface Runoff Volume: $1.0 \times 2 \text{ in/hr} \times 1,038 \text{ sq.ft.} \times 1 \text{ ft./12 in.} = 173 \text{ cu.ft.}$

Pervious Runoff Volume: $0.2 \times 2 \text{ in/hr} \times 798 \text{ sq.ft.} \times 1 \text{ ft./}12 \text{ in.} = 27 \text{ cu.ft.}$

Volume Treated

Total Volume to be Retained = 200 cu.ft.

C. PROPOSED EXFILTRATION TRENCH SIZING

Exfiltration Trench #B-1 L = Total Length of Trench Provided = 40 ft W = Trench Width = 10 ft

Hydraulic Conductivity = 0.00005 cfs/sq.ft./ft. of head H2 = Depth to Water Table = 1.75 ftUn-Saturated Trench Depth = 1.00 ftSaturated Trench Depth = 1.00 ft

= 372 cu.ft.

STORMWATER RETENTION CALCULATIONS (Basin C)

A. SITE INFORMATION Total Property Area = 8,500 sq.ft.

Drainage Basin Area = 715 sq.ft.

Drainage Basin Impervious Surface Area = 284 sq.ft.

Drainage Basin Pervious Surface Area = 431 sq.ft.

B. ESTIMATED STORMWATER RETENTION VOLUME The retention volume is estimated using the Rational Method (Q=CiA)

C = 1.0 (impervious surface) C = 0.2 (pervious surface)

i = 2 in/hrImpervious Surface Runoff Volume:

 $1.0 \times 2 \text{ in/hr} \times 284 \text{ sq.ft.} \times 1 \text{ ft./12 in.} = 48 \text{ cu.ft.}$

Pervious Runoff Volume: $0.2 \times 2 \text{ in/hr} \times 431 \text{ sq.ft.} \times 1 \text{ ft./}12 \text{ in.} = 15 \text{ cu.ft.}$

Total Volume to be Retained = 63 cu.ft.

Saturated Trench Depth

C. PROPOSED EXFILTRATION TRENCH SIZING

Exfiltration Trench #C-1 W = Trench Width

Volume Treated

L = Total Length of Trench Provided = 15 ft = 10 ft Hydraulic Conductivity = 0.00005 cfs/sq.ft./ft. of head H2 = Depth to Water Table = 1.33 ftDU = Un-Saturated Trench Depth = 0.50 ft

= 0.50 ft

= 80 cu.ft.

B. ESTIMATED STORMWATER RETENTION VOLUME

The retention volume is estimated using the Rational Method (Q=CiA)

Impervious Surface Runoff Volume:

Pervious Runoff Volume:

L = Total Length of Trench Provided = 15 ft

STORMWATER RETENTION CALCULATIONS (Basin D)

A. SITE INFORMATION

Total Property Area = 8,500 sq.ft.

Drainage Basin Area = 740 sq.ft.

Drainage Basin Impervious Surface Area = 281 sq.ft.

Drainage Basin Pervious Surface Area = 459 sq.ft.

C = 1.0 (impervious surface) C = 0.2 (pervious surface)

i = 2 in/hr

 $1.0^{\circ} \times 2 \text{ in/hr} \times 281 \text{ sq.ft.} \times 1 \text{ ft./12 in.} = 47 \text{ cu.ft.}$

 $0.2 \times 2 \text{ in/hr} \times 459 \text{ sq.ft.} \times 1 \text{ ft./}12 \text{ in.} = 16 \text{ cu.ft.}$

Total Volume to be Retained = 63 cu.ft.

C. PROPOSED EXFILTRATION TRENCH SIZING

Exfiltration Trench #C-1

W = Trench Width = 10 ft

K = Hydraulic Conductivity = 0.00005 cfs/sq.ft./ft. of head H2 = Depth to Water Table = 1.33 ftDU = Un-Saturated Trench Depth = 0.50 ft = 0.50 ftDS = Saturated Trench Depth

= 80 cu.ft. V = Volume Treated

48 HOURS BEFORE DIGGING CALL 1-800-432-4770 SUNSHINE STATE ONE CALL OF FLORIDA, INC. Contractor is responsible for obtaining location of existing utilities prior to commencement of construction activities

Location Map

N.T.S.

Legend

FLOW DIRECTION

0 4 8

AREA DRAIN

WITH BAFFLE

EXISTING ELEVATION PER

WALLACE SURVEYING CORP. (NAVD-88)

PROPOSED ELEVATION (NAVD-88)

---7.00--- PROPOSED ELEVATION CONTOUR (NAVD-88)


24" NYLOPLAST DRAIN BASIN


Scale: 1/8" = 1'-0"

EXFILTRATION TRENCH





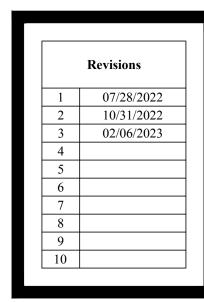

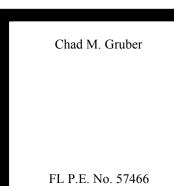

This item has been electronically signed and sealed by Chad M. Gruber on the date adjacent to the seal using a SHA authentication code. Printed copies of this document are not considered signed and sealed and the SHA authentication code must be verified on any electronic copies.

07/28/22 UPDATE PLAN BACKGROUND; REVISE

10/31/22 UPDATE PLAN BACKGROUND; REVISE

02/06/23 UPDATE PLAN BACKGROUND; REVISE

REVISE CALCULATIONS


PROPOSED GRADING AND DRAINAGE

PROPOSED GRADING AND DRAINAGE


PROPOSED GRADING AND DRAINAGE;

Plan Background from Hardscape Plan by Environment Design Group Received 1/30/23

ARC-22-126 ZON-22-088 © 2023 Gruber Consulting Engineers, Inc.

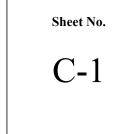


esider

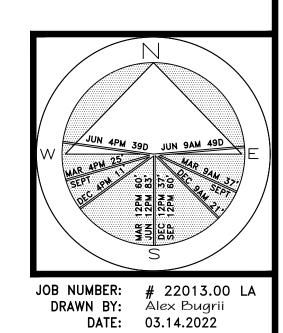

✓ĦEET L1.0 ZOM-22-088 ARCOM# ARC-22-126

OLEANDER AVE.

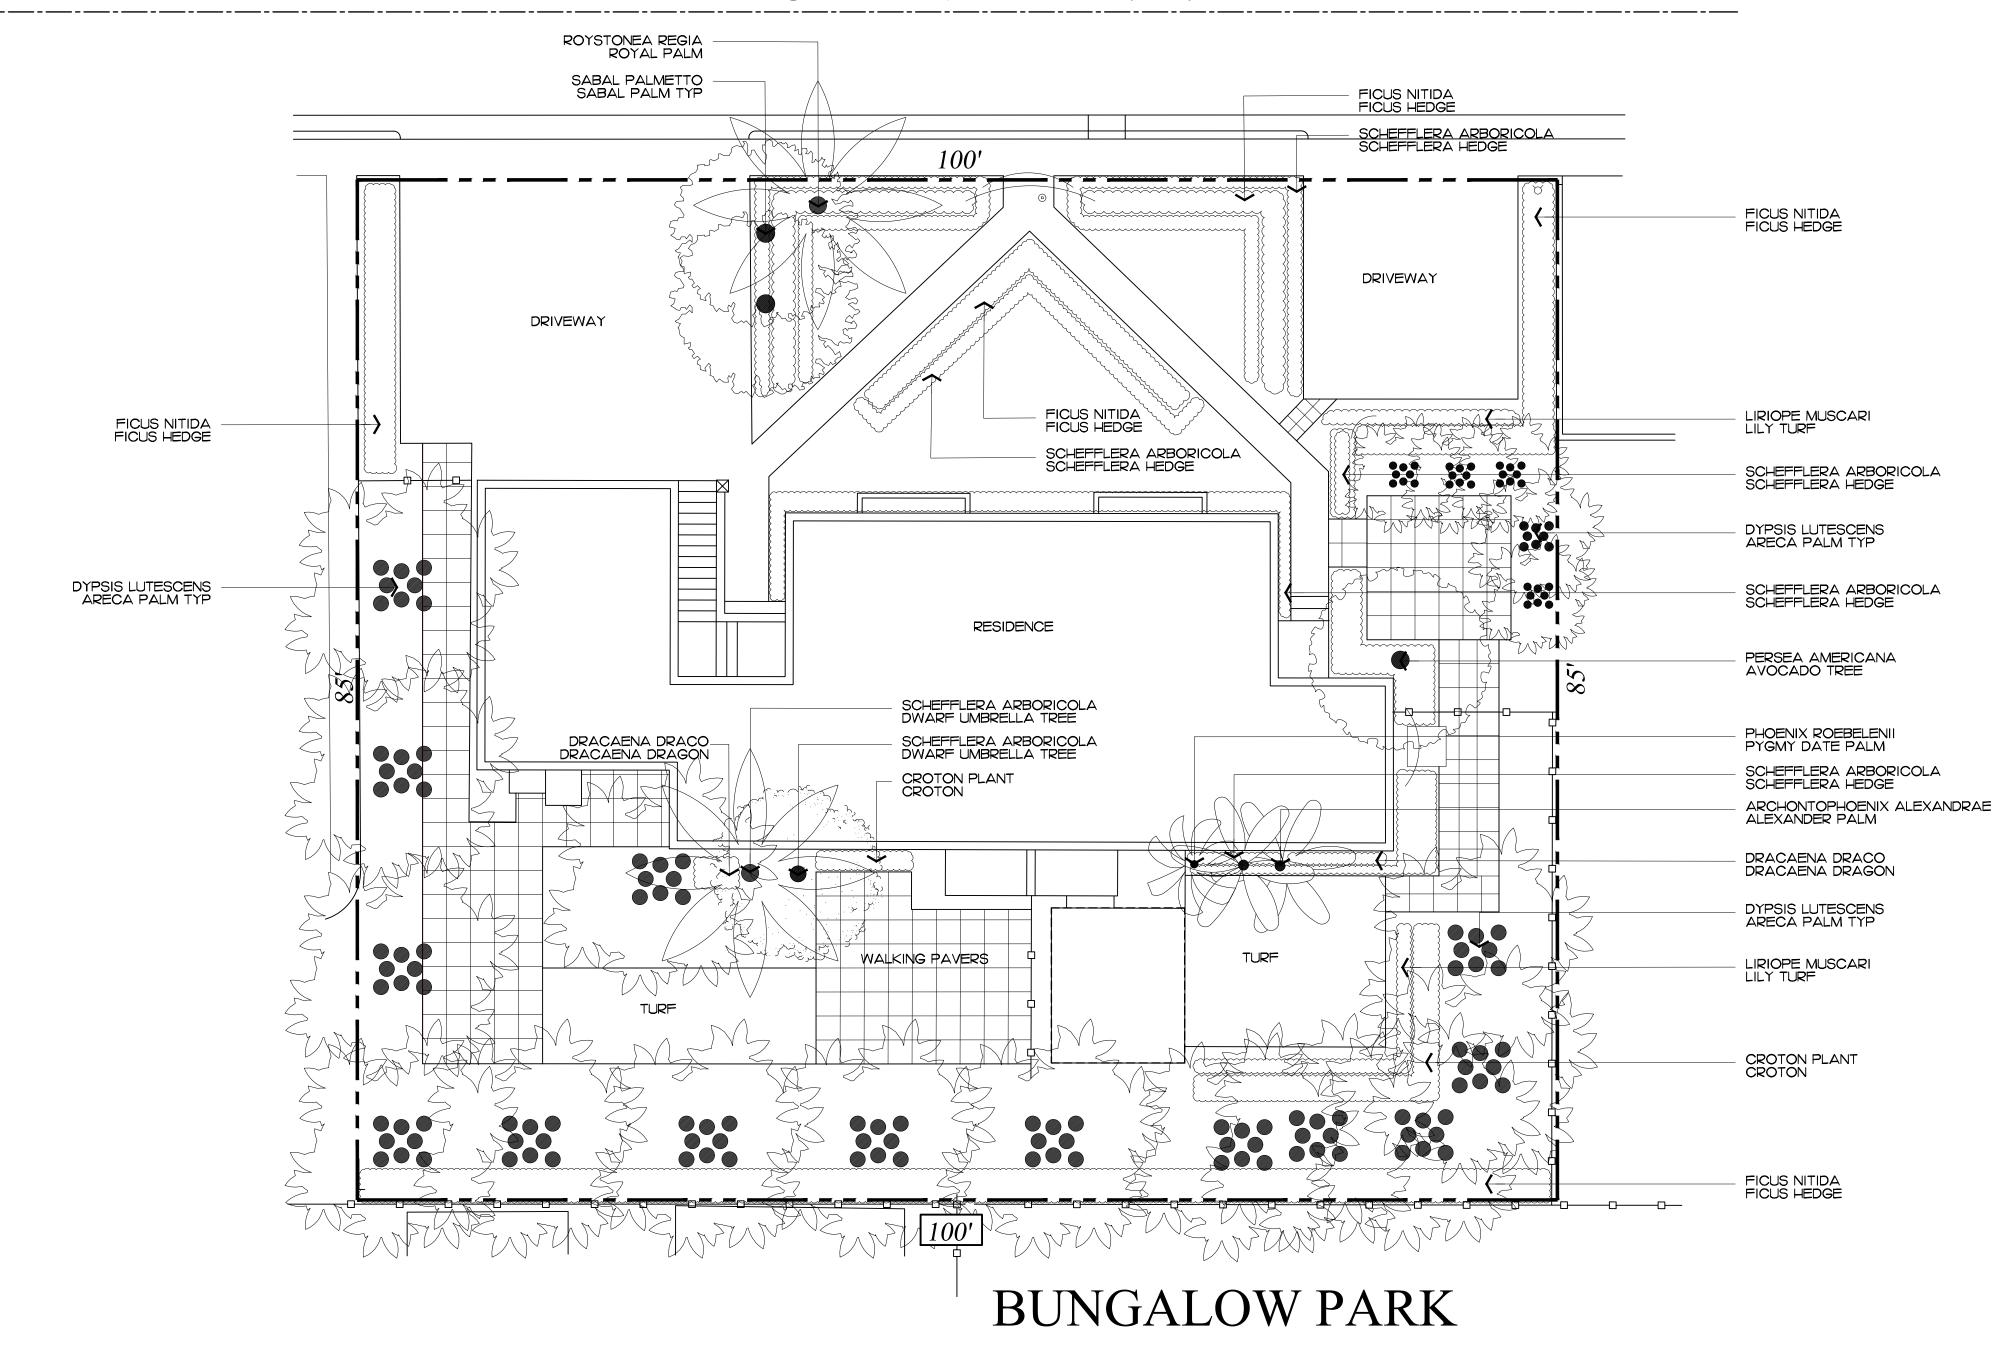

COPYRIGHT:

The following drawings are instruments of service to the Landscape Architect. They are not products of design. All ideas, designs, arrangements and plans indicated or represented by this/these drawings are owned by and the property of the designer, and were created, evolved and developed for use on and in connection with this project. None of such ideas, designs, arrangements or plans shall be used by or disclosed to any person, firm or services during construction by the client, and his/her agents, employees, or subcontractors. or disclosed to any person, firm or corporation without the written permission of the Landscape Architect.

48 HOURS BEFORE DIGGING

CALL TOLL FREE 1-800-432-4770 SUNSHINE STATE ONE CALL OF FLORIDA, INC.

Existing Vegetation Plan Scale IN FEET O'

• S vat


•

JOB NUMBER: # 22013.00 LA
DRAWN BY: Alex Bugrii
DATE: 04.20.2022

/HEET L2.0

ZOM-22-088 ARCOM# ARC-22-126 Demolition and Vegetation Action Plan Scale IN FEET O'


OLEANDER AVE.

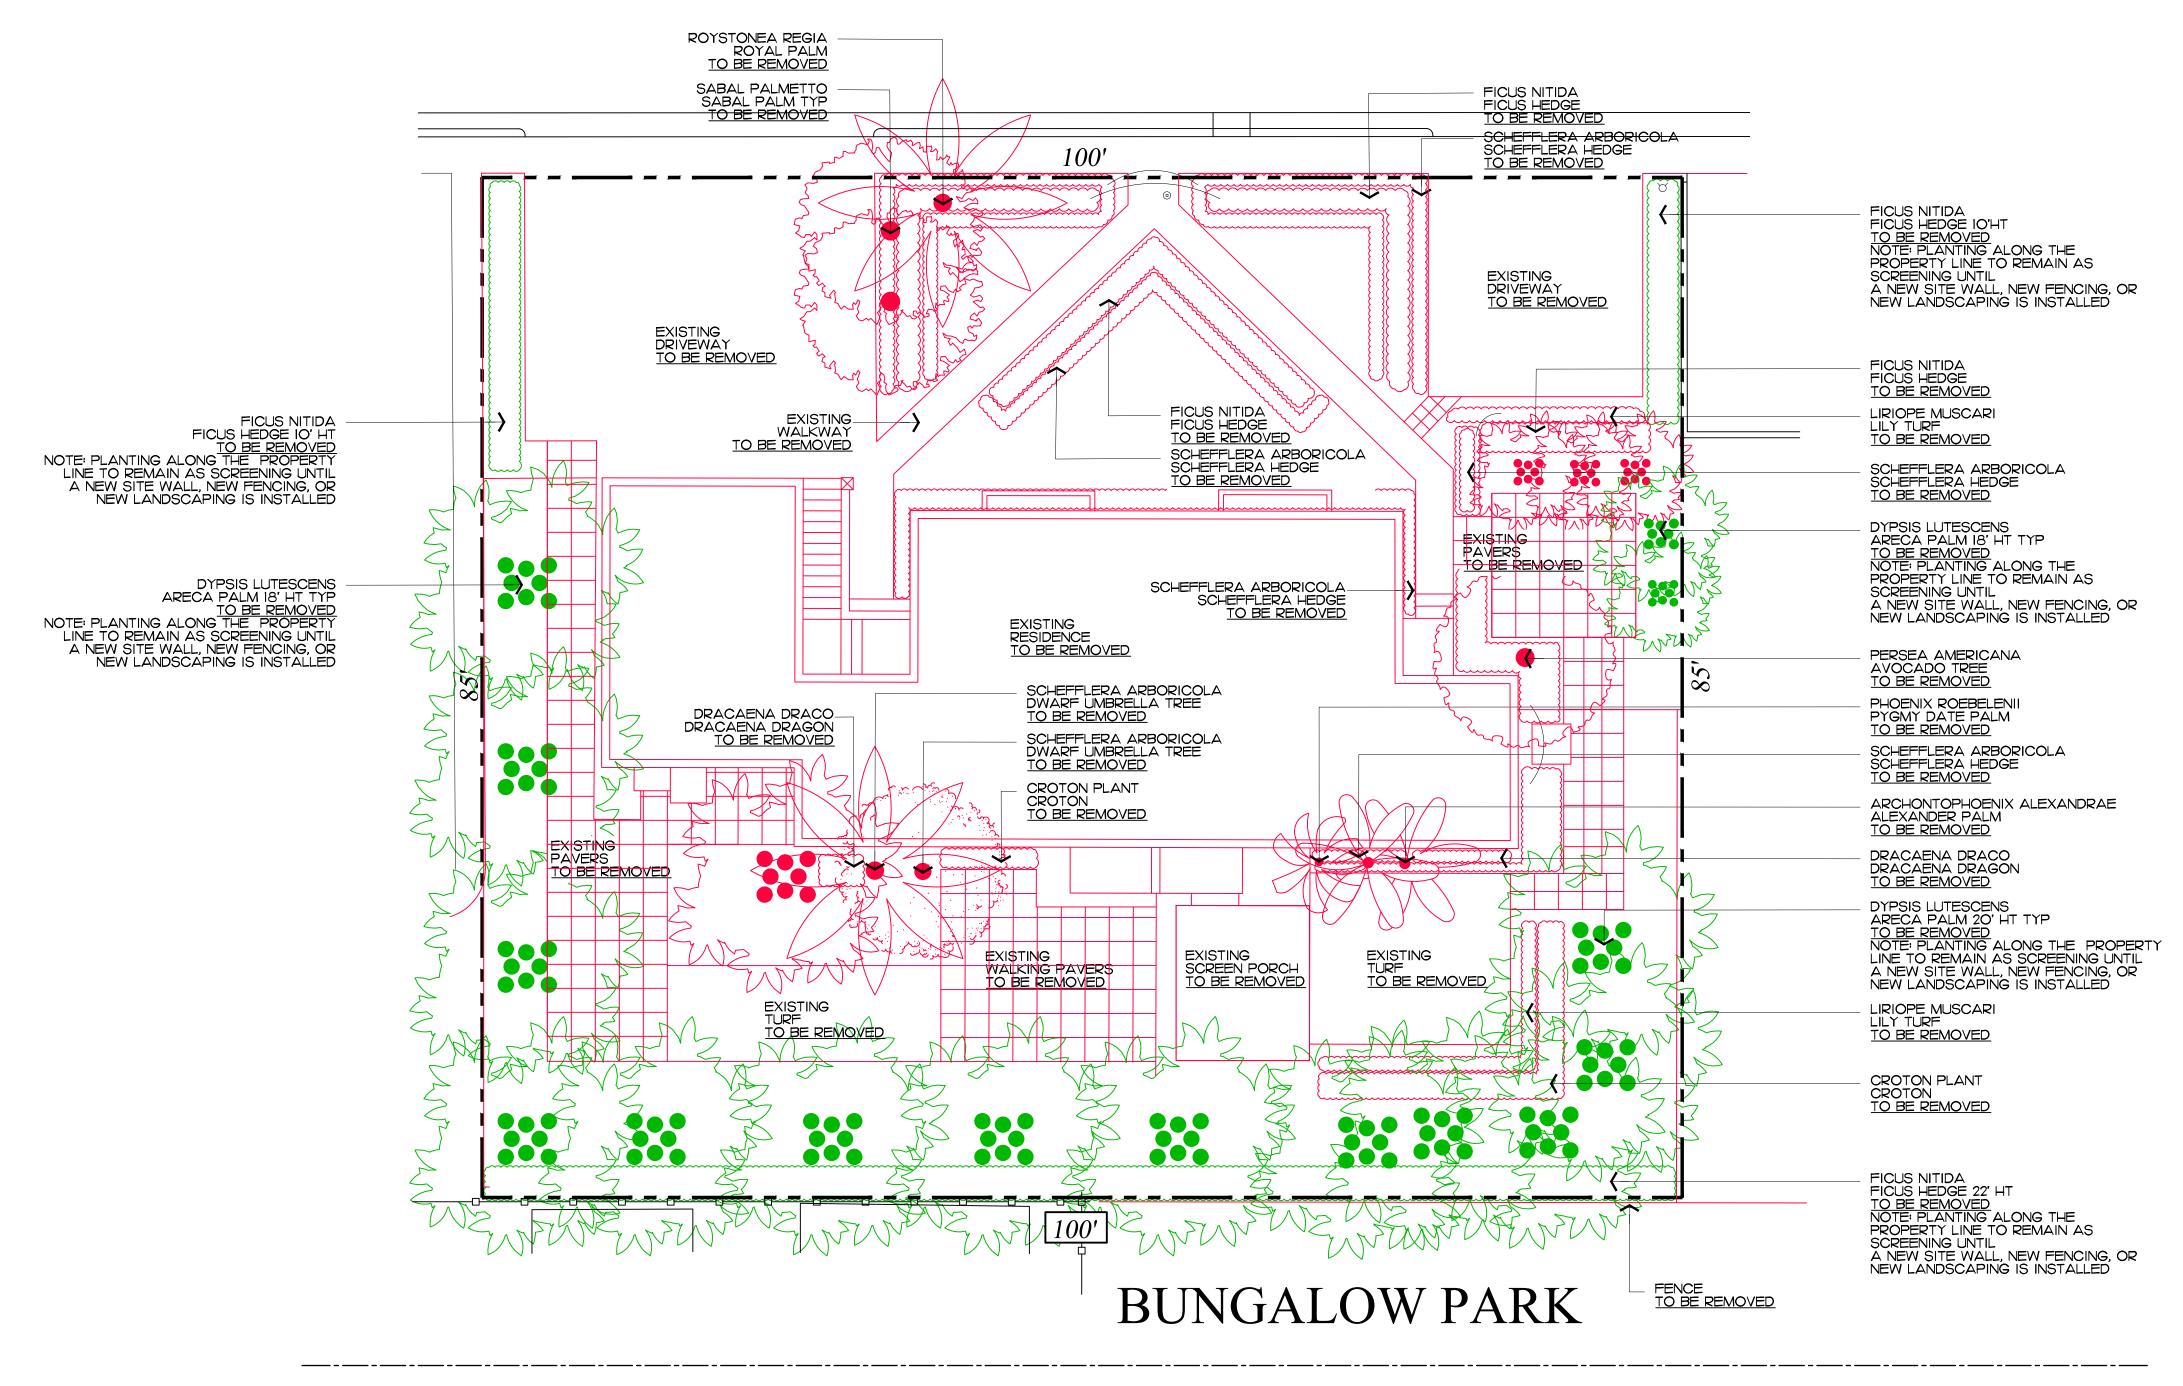

are not products of design. All ideas, designs, arrangements and plans indicated or represented by this/these drawings are owned by and the property of the designer, and were created, evolved and developed understood, and that ENVIRONMENT DESIGN GROUP does not provide landscape architectural services during construction, including on—site monitoring, site visits, shop drawing review, design clarification, etc., the client agrees to indemnify and hold harmless ENVIRONMENT for use on and in connection with this project. None of such ideas, designs, DESIGN GROUP from any liability arising from, acts or omissions in the performance of said services during construction by the client, and his/her agents, employees, or subcontractors. or disclosed to any person, firm or corporation without the written permission of the Landscape Architect.

48 HOURS BEFORE DIGGING CALL TOLL FREE 1-800-432-4770 SUNSHINE STATE ONE CALL OF FLORIDA, INC.

OLEANDER AVE.

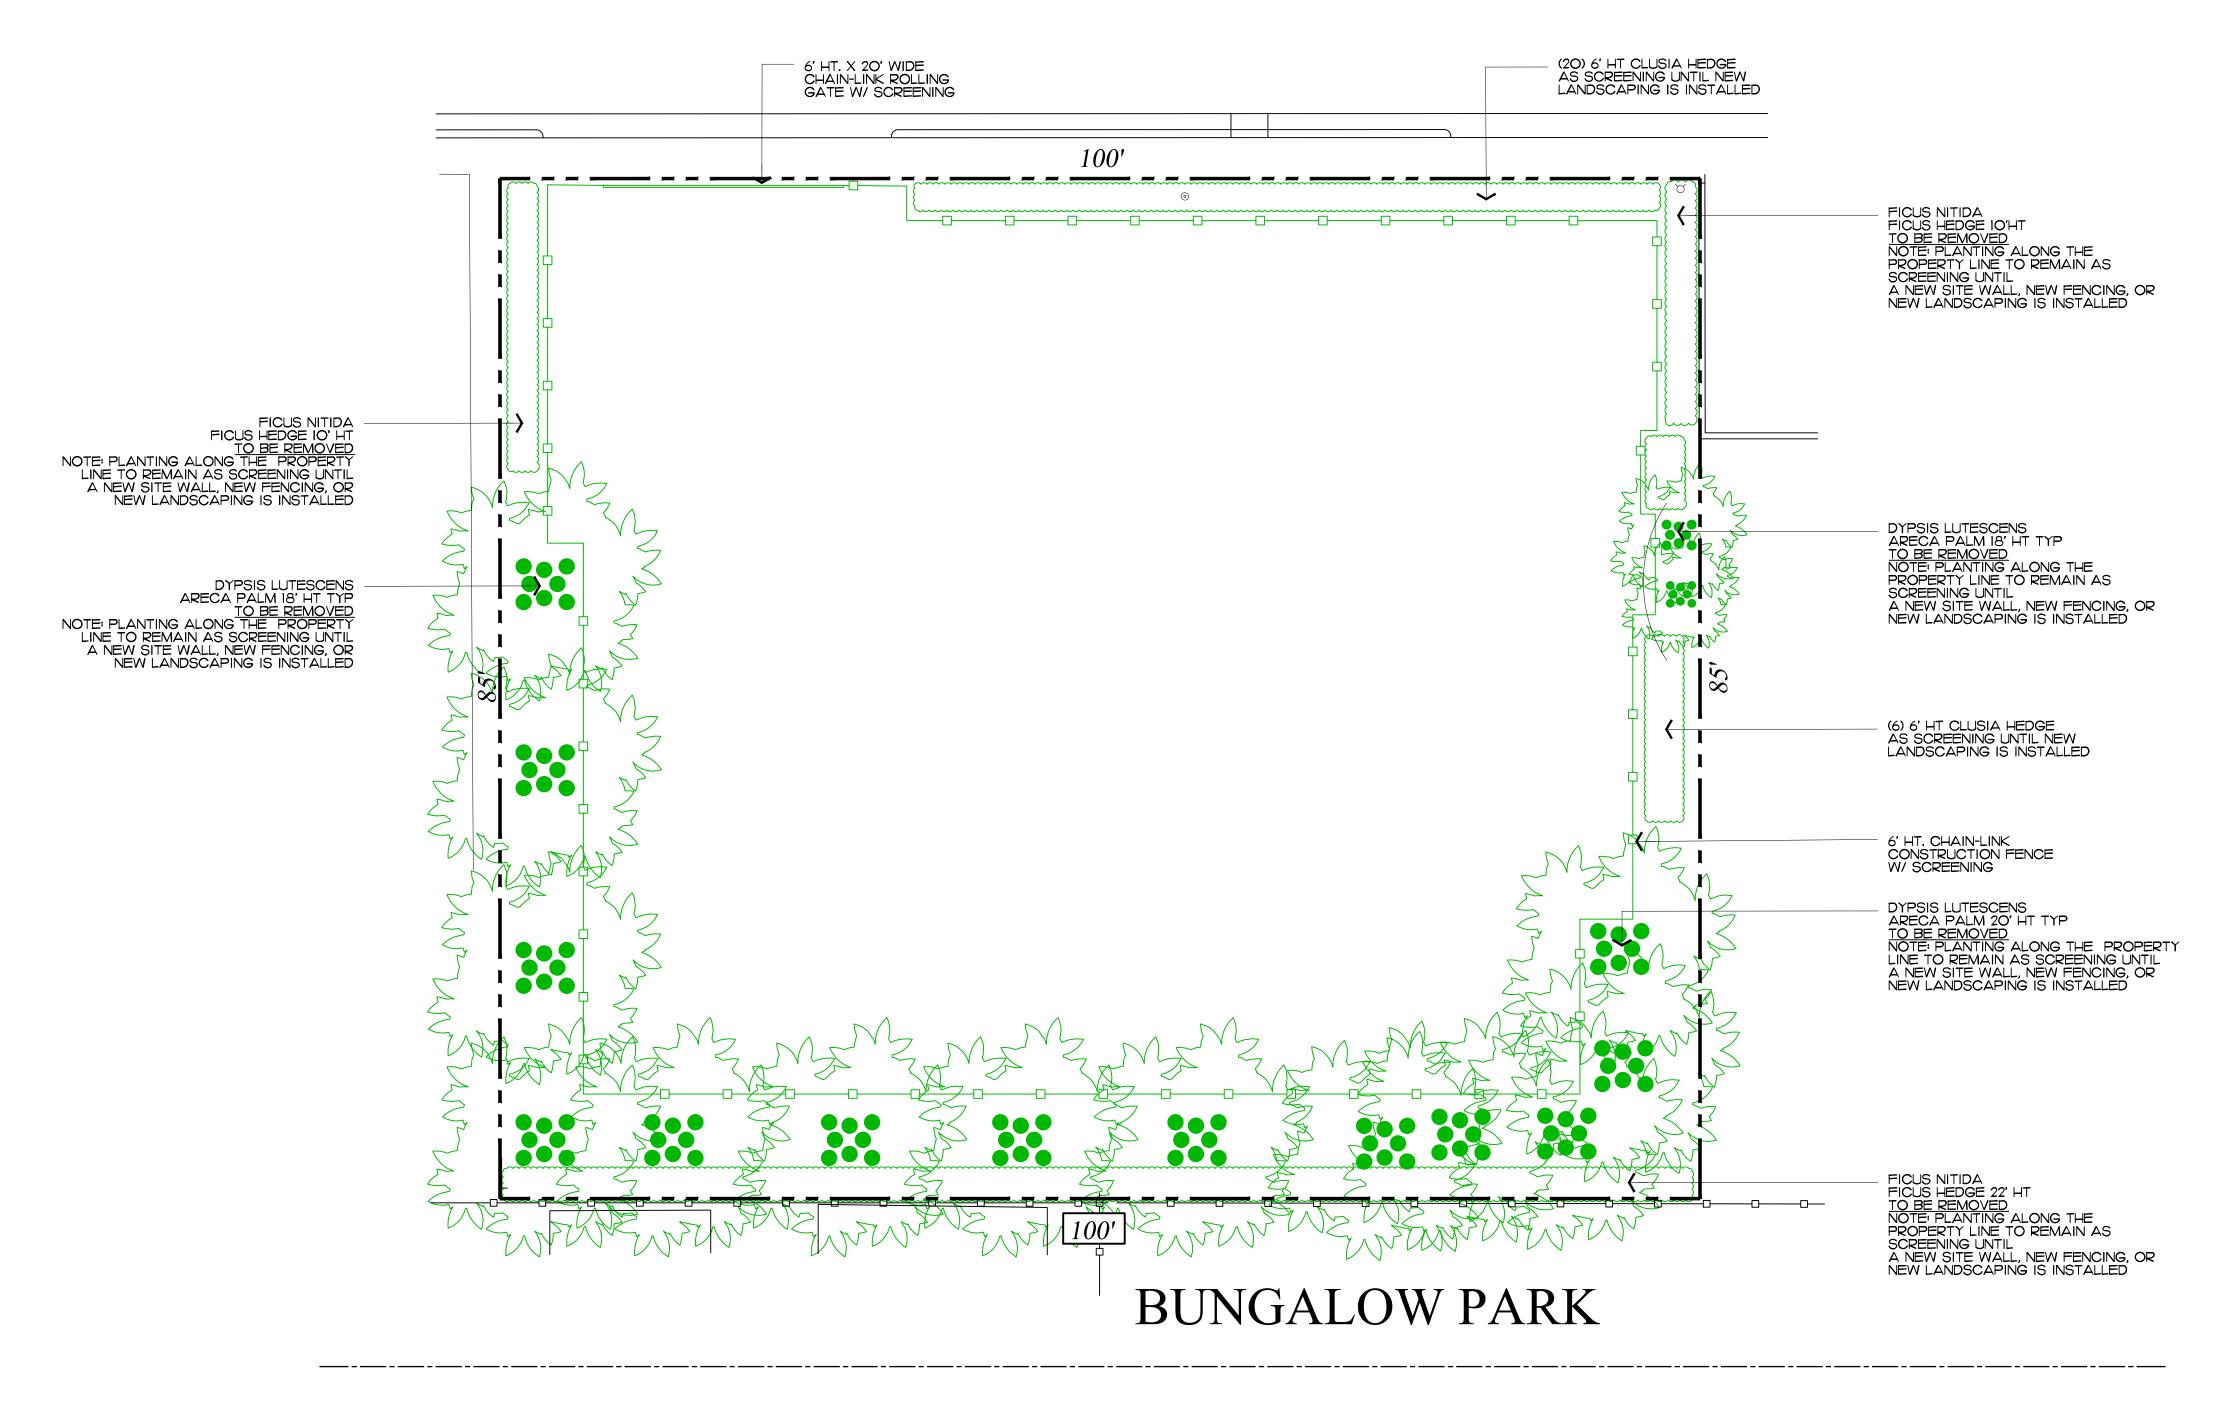


INTERIOR TREES AND PALMS WILL BE REMOVED WHEN NECESSARY FOR SITE UTILIZATION AND CONSTRUCTION DEVELOPMENT. A CONSTRUCTION SCREEN WILL BE ADDED IN THESE AREAS UNTIL SITE WALLS, NEW FENCING, OR NEW LANDSCAPING IS INSTALLED. AT NO TIME SHALL THE SITE BE OPEN TO ADJACENT PROPERTIES WITHOUT ANY PERMANENT OR TEMPORARY SCREENING DURING CONSTRUCTION.

Construction Screening Plan Scale IN FEET O'

DE/IGN ROUP 139 North County Road S#20-B Palm Beach, FI 3348 Phone 561.832.4600 " Mobile 561.313.4424 Landscape Architecture Land Planning Landscape Management Dustin M. Mizell, MLA RLA #6666784 Dustin@environmentdesigngroup.com

> esid ivat

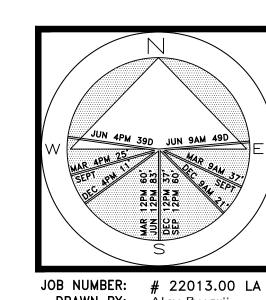

JOB NUMBER: # 22013.00 LA
DRAWN BY: Alex Bugrii
DATE: 04.20.2021

The following drawings are instruments of service to the Landscape Architect. They are not products of design. All ideas, designs, arrangements and plans indicated or represented by this/these drawings are owned by and the property of the designer, and were created, evolved and developed for use on and in connection with this project. None of such ideas, designs, arrangements or plans shall be used by or disclosed to any person, firm or corporation without the written permission the Landscape Architect. or disclosed to any person, firm or corporation without the written permission of the Landscape Architect.

48 HOURS BEFORE DIGGING CALL TOLL FREE 1-800-432-4770 SUNSHINE STATE ONE CALL OF FLORIDA, INC.

/HEET L3.0 ZOM-22-088 ARCOM# ARC-22-126





Existing Morth Buffer

Existing South Buffer



DE/IG/I Landscape Architecture Land Planning Landscape Management Dustin M. Mizell, MLA RLA #6666784 Dustin@environmentdesigngroup.com


Existing West Buffer



JOB NUMBER: # 22013.00 LA
DRAWN BY: Alex Bugrii
DATE: 04.20.2022

Existing Southeast Buffer

Existing East Buffer

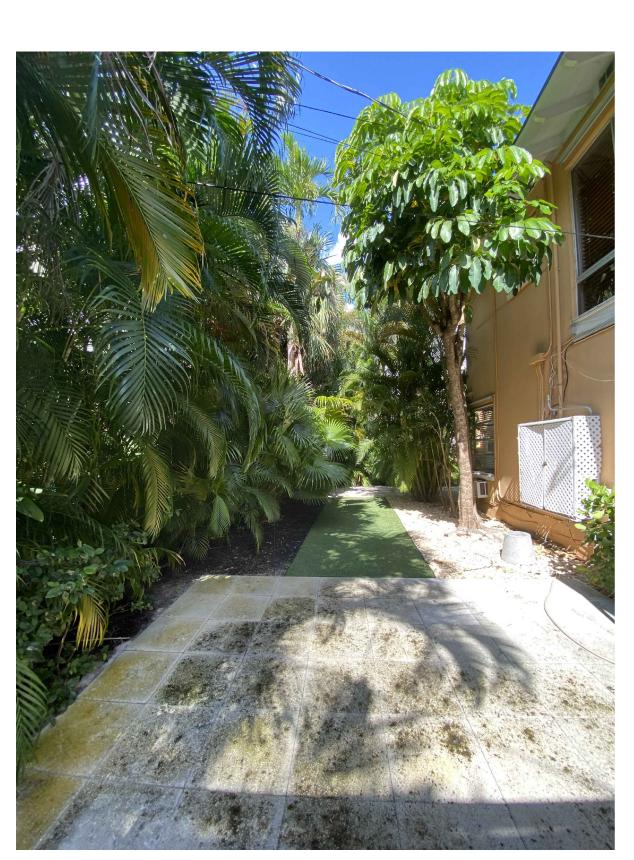

Existing South Buffer

COPYRIGHT:

The following drawings are instruments of service to the Landscape Architect. They are not products of design. All ideas, designs, arrangements and plans indicated or represented by this/these drawings are owned by and the property of the designer, and were created, evolved and developed for use on and in connection with this project. None of such ideas, designs, arrangements or plans shall be used by or disclosed to any person, firm or corporation without the written permission of the Landscape Architect.


DISCLAIMER:

Construction, as the term is generally understood, and that ENVIRONMENT DESIGN GROUP does not provide landscape architectural services during construction, including on—site monitoring, site visits, shop drawing review, design clarification, etc., the client agrees to indemnify and hold harmless ENVIRONMENT DESIGN GROUP from any liability arising from, acts or omissions in the performance of said services during construction by the client, and his/her agents, employees, or subcontractors.

48 HOURS BEFORE DIGGING CALL TOLL FREE 1-800-432-4770

∕HEET L4.0 ZOM-22-088 ARCOM# ARC-22-126 Existing Landscape Buffer Images

OLEANDER AVE.

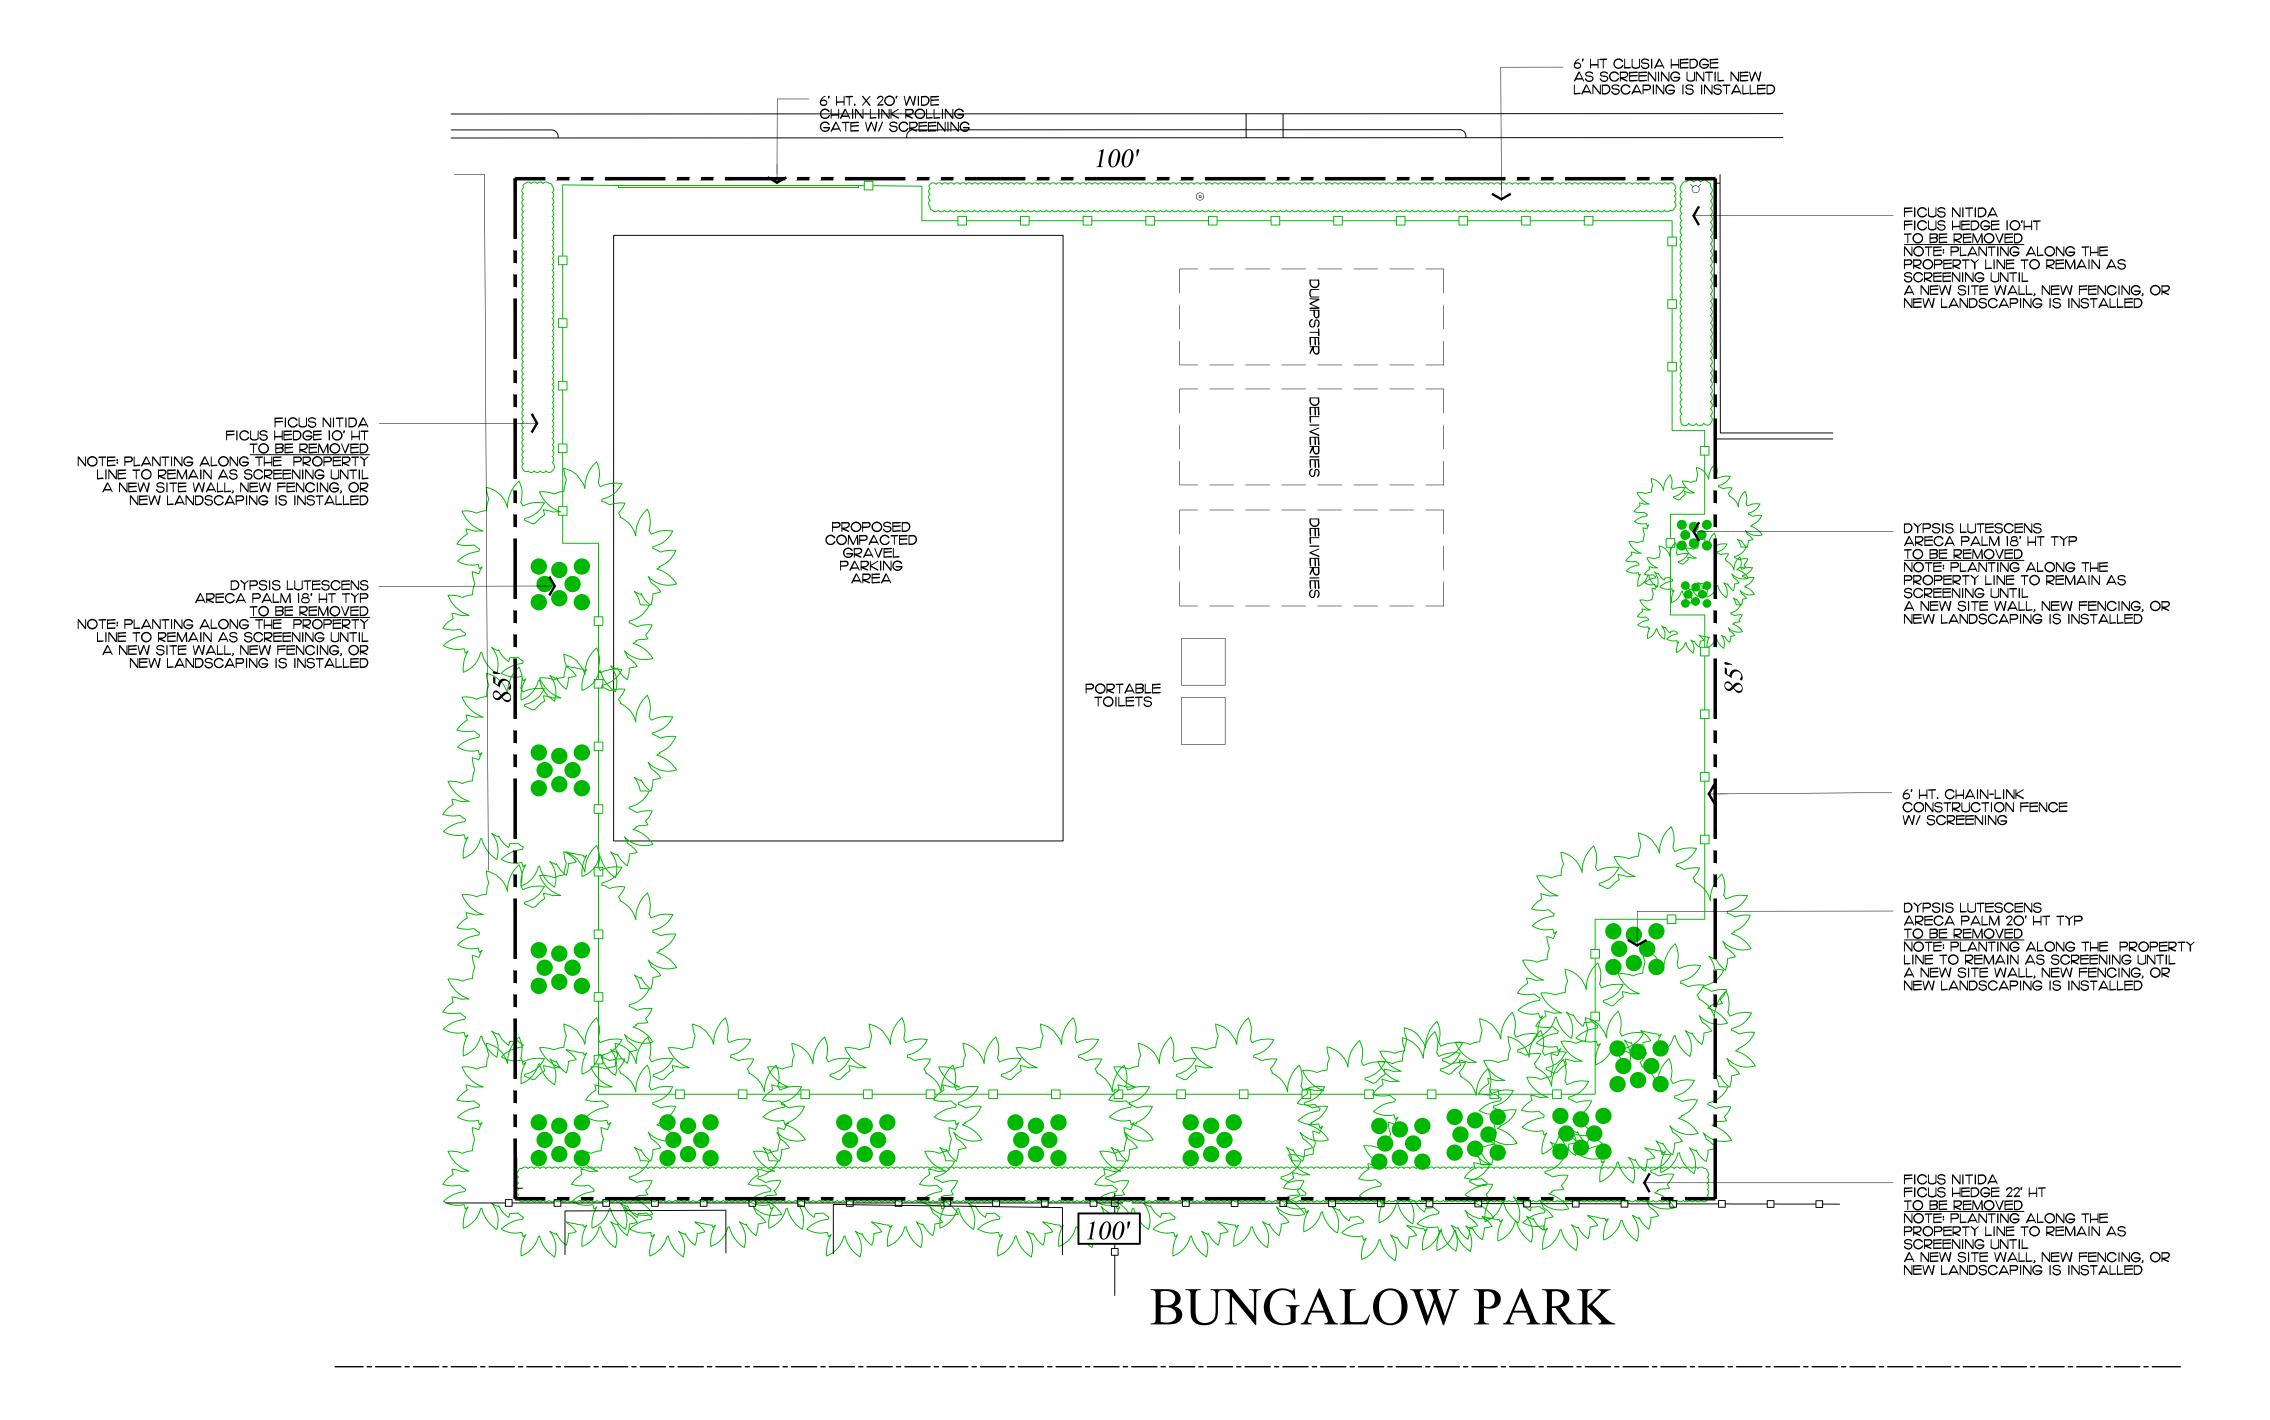


INTERIOR TREES AND PALMS WILL BE REMOVED WHEN NECESSARY FOR SITE UTILIZATION AND CONSTRUCTION DEVELOPMENT. A CONSTRUCTION SCREEN WILL BE ADDED IN THESE AREAS UNTIL SITE WALLS, NEW FENCING, OR NEW LANDSCAPING IS INSTALLED. AT NO TIME SHALL THE SITE BE OPEN TO ADJACENT PROPERTIES WITHOUT ANY PERMANENT OR TEMPORARY SCREENING DURING CONSTRUCTION.

ZOM-22-088 ARCOM# ARC-22-126 Construction Staging Plan Scale IN FEET (

_ NVIRONMENT DE/IGN ROUP 139 North County Road S#20-B Palm Beach, Fl 33481 Phone 561.832.4600 Mobile 561.313.4424 Landscape Architecture Land Planning Landscape Management Dustin M. Mizell, MLA RLA #6666784 Dustin@environmentdesigngroup.com

> Resid vat

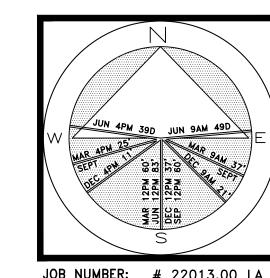


JOB NUMBER: # 22013.00 LA
DRAWN BY: Alex Bugrii
DATE: 04.20.2022

/HEET L5.0

arrangements or plans shall be used by

service to the Landscape Architect. They are not products of design. All ideas, designs, arrangements and plans indicated or represented by this/these drawings are owned by and the property of the designer, and were created, evolved and developed for use on and in connection with this project. None of such ideas, designs, arrangements or plans shall be used by services during construction by the client, and his/her agents, employees, or subcontractors. or disclosed to any person, firm or corporation without the written permission of the Landscape Architect.

48 HOURS BEFORE DIGGING CALL TOLL FREE 1-800-432-4770

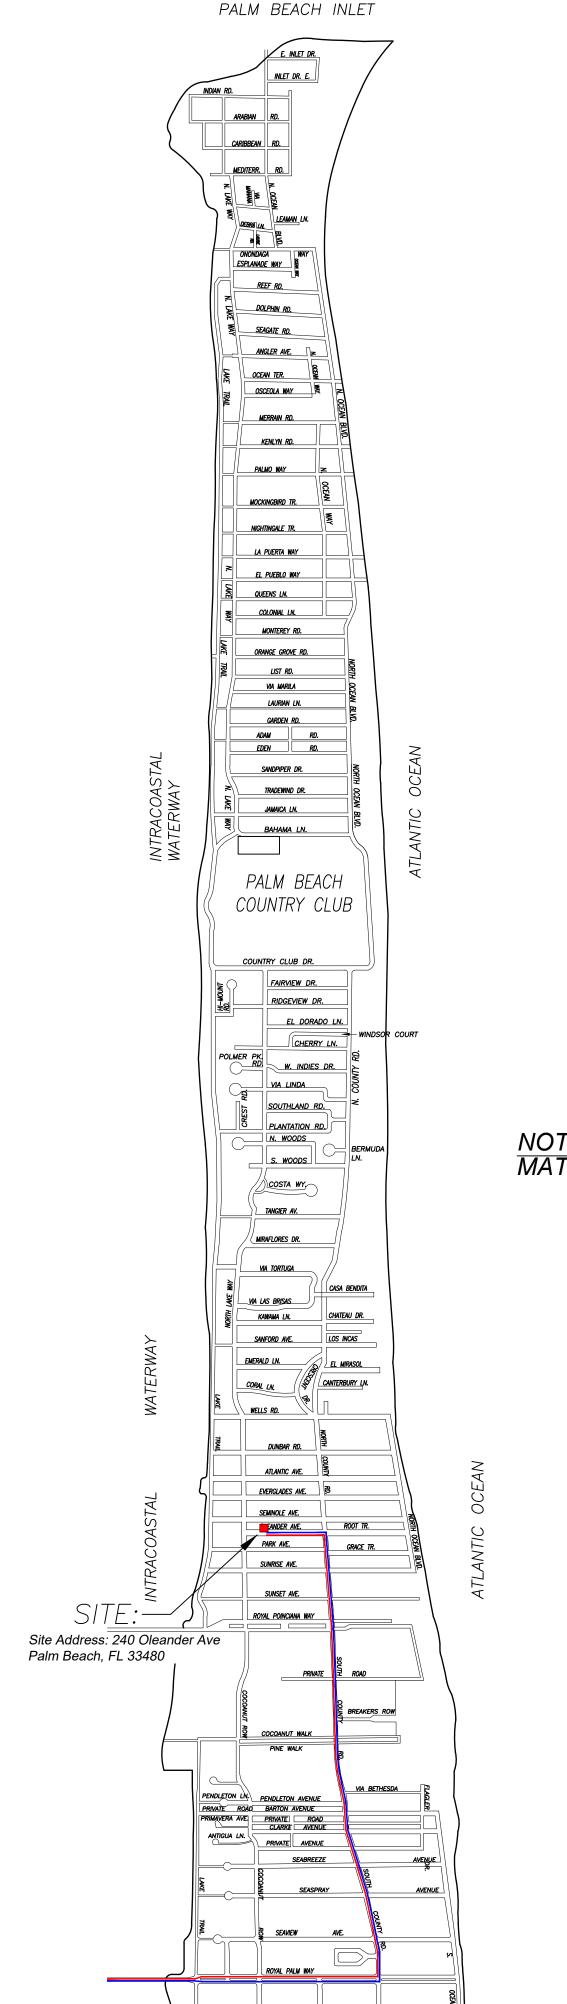

BRAZILIAN

AUSTRALIAN AVE.

PROPOSED TRUCK INGRESS / EGRESS ROUTES MAP

SCHEDULE:

MONTH 1: DEMOLITION AND CLEANUP (3 - 5 DAYS)

LARGEST TRUCK ->

10-15 DUMP TRUCKS FOR DEBRIS REMOVAL TRAILER FOR EXCAVATOR / DEMOLITION LANDSCAPE TRUCKS -> SOD

IRRIGATION

CONCEPTUAL CONSTRUCTION SCHEDULE FEB 6TH 2023 - ARCOM MEETING MAR 15TH 2023 - TOWN COUNCIL <u>JUL-AUG 2023 - SUBMIT FOR PERMIT</u> 1 MONTH -SEP 2023 - MOBILIZATION & DEMOLITION OF EXISTING STRUCTURES 2 MONTHS - SITE/BUILDING PREPARATION 1.5 MONTHS FOUNDATION 2.5 MONTHS - BLOCK DELIVERIES & CONC. POURS 1 MONTH - ROOF TRUSS DELIVERY AND SET TRUSSES 1.5 MONTHS - WINDOW/DOOR DELIVERIES A INSTALLATION .5 MONTH - DRY-IN 1.5 MONTHS INTERIOR FRAMING 2 MONTHS - ROUGH-IN .5 MONTH - DRY WALL 6 MONTHS - FINISHES LANDSCAPE & HARDSCAPE 2 MONTHS INSTALLATION 2 MONTHS - FINAL INSPECTIONS - PROPOSED TOTAL CONSTRUCTION +/-24 MONTHS FOLLOWING BUILDING PERMIT

NOTE: SEE SEPARATE "CONSTRUCTION STAGING PLAN" SHEET FOR INFORMATION ON LOCATIONS FOR PARKING, MATERIAL STORAGE, DELIVERIES, DUMPSTER, PORTABLE TOILETS, TIRE CLEANING AREA, SILT FENCE, ETC.

PROPOSED INGRESS TRUCK ROUTE

PROPOSED EGRESS TRUCK ROUTE

JOB NUMBER: # 22013.00 LA
DRAWN BY: Alex Bugrii
DATE: 04.20.2022

JHEET L6.0

ZOM-22-088

Truck Logistics Plan

ARCOM# ARC-22-126

esid 7 ivat

DE/IGN ROUP

139 North County Road S#20-B Palm Beach, Fl 3348 Phone 561.832.4600 " Mobile 561.313.4424

Landscape Architecture


Landscape Management

Dustin M. Mizell, MLA RLA #6666784 Dustin@environmentdesigngroup.com

Land Planning

The following drawings are instruments of service to the Landscape Architect. They are not products of design. All ideas, designs, arrangements and plans indicated or represented by this/these drawings are owned by and the property of the designer, and were created, evolved and developed for use on and in connection with this project. None of such ideas, designs, arrangements or plans shall be used by or disclosed to any person, firm or corporation without the written permission. or disclosed to any person, firm or corporation without the written permission of the Landscape Architect.

48 HOURS BEFORE DIGGING
CALL TOLL FREE 1-800-432-4770 SUNSHINE STATE ONE CALL OF FLORIDA, INC.

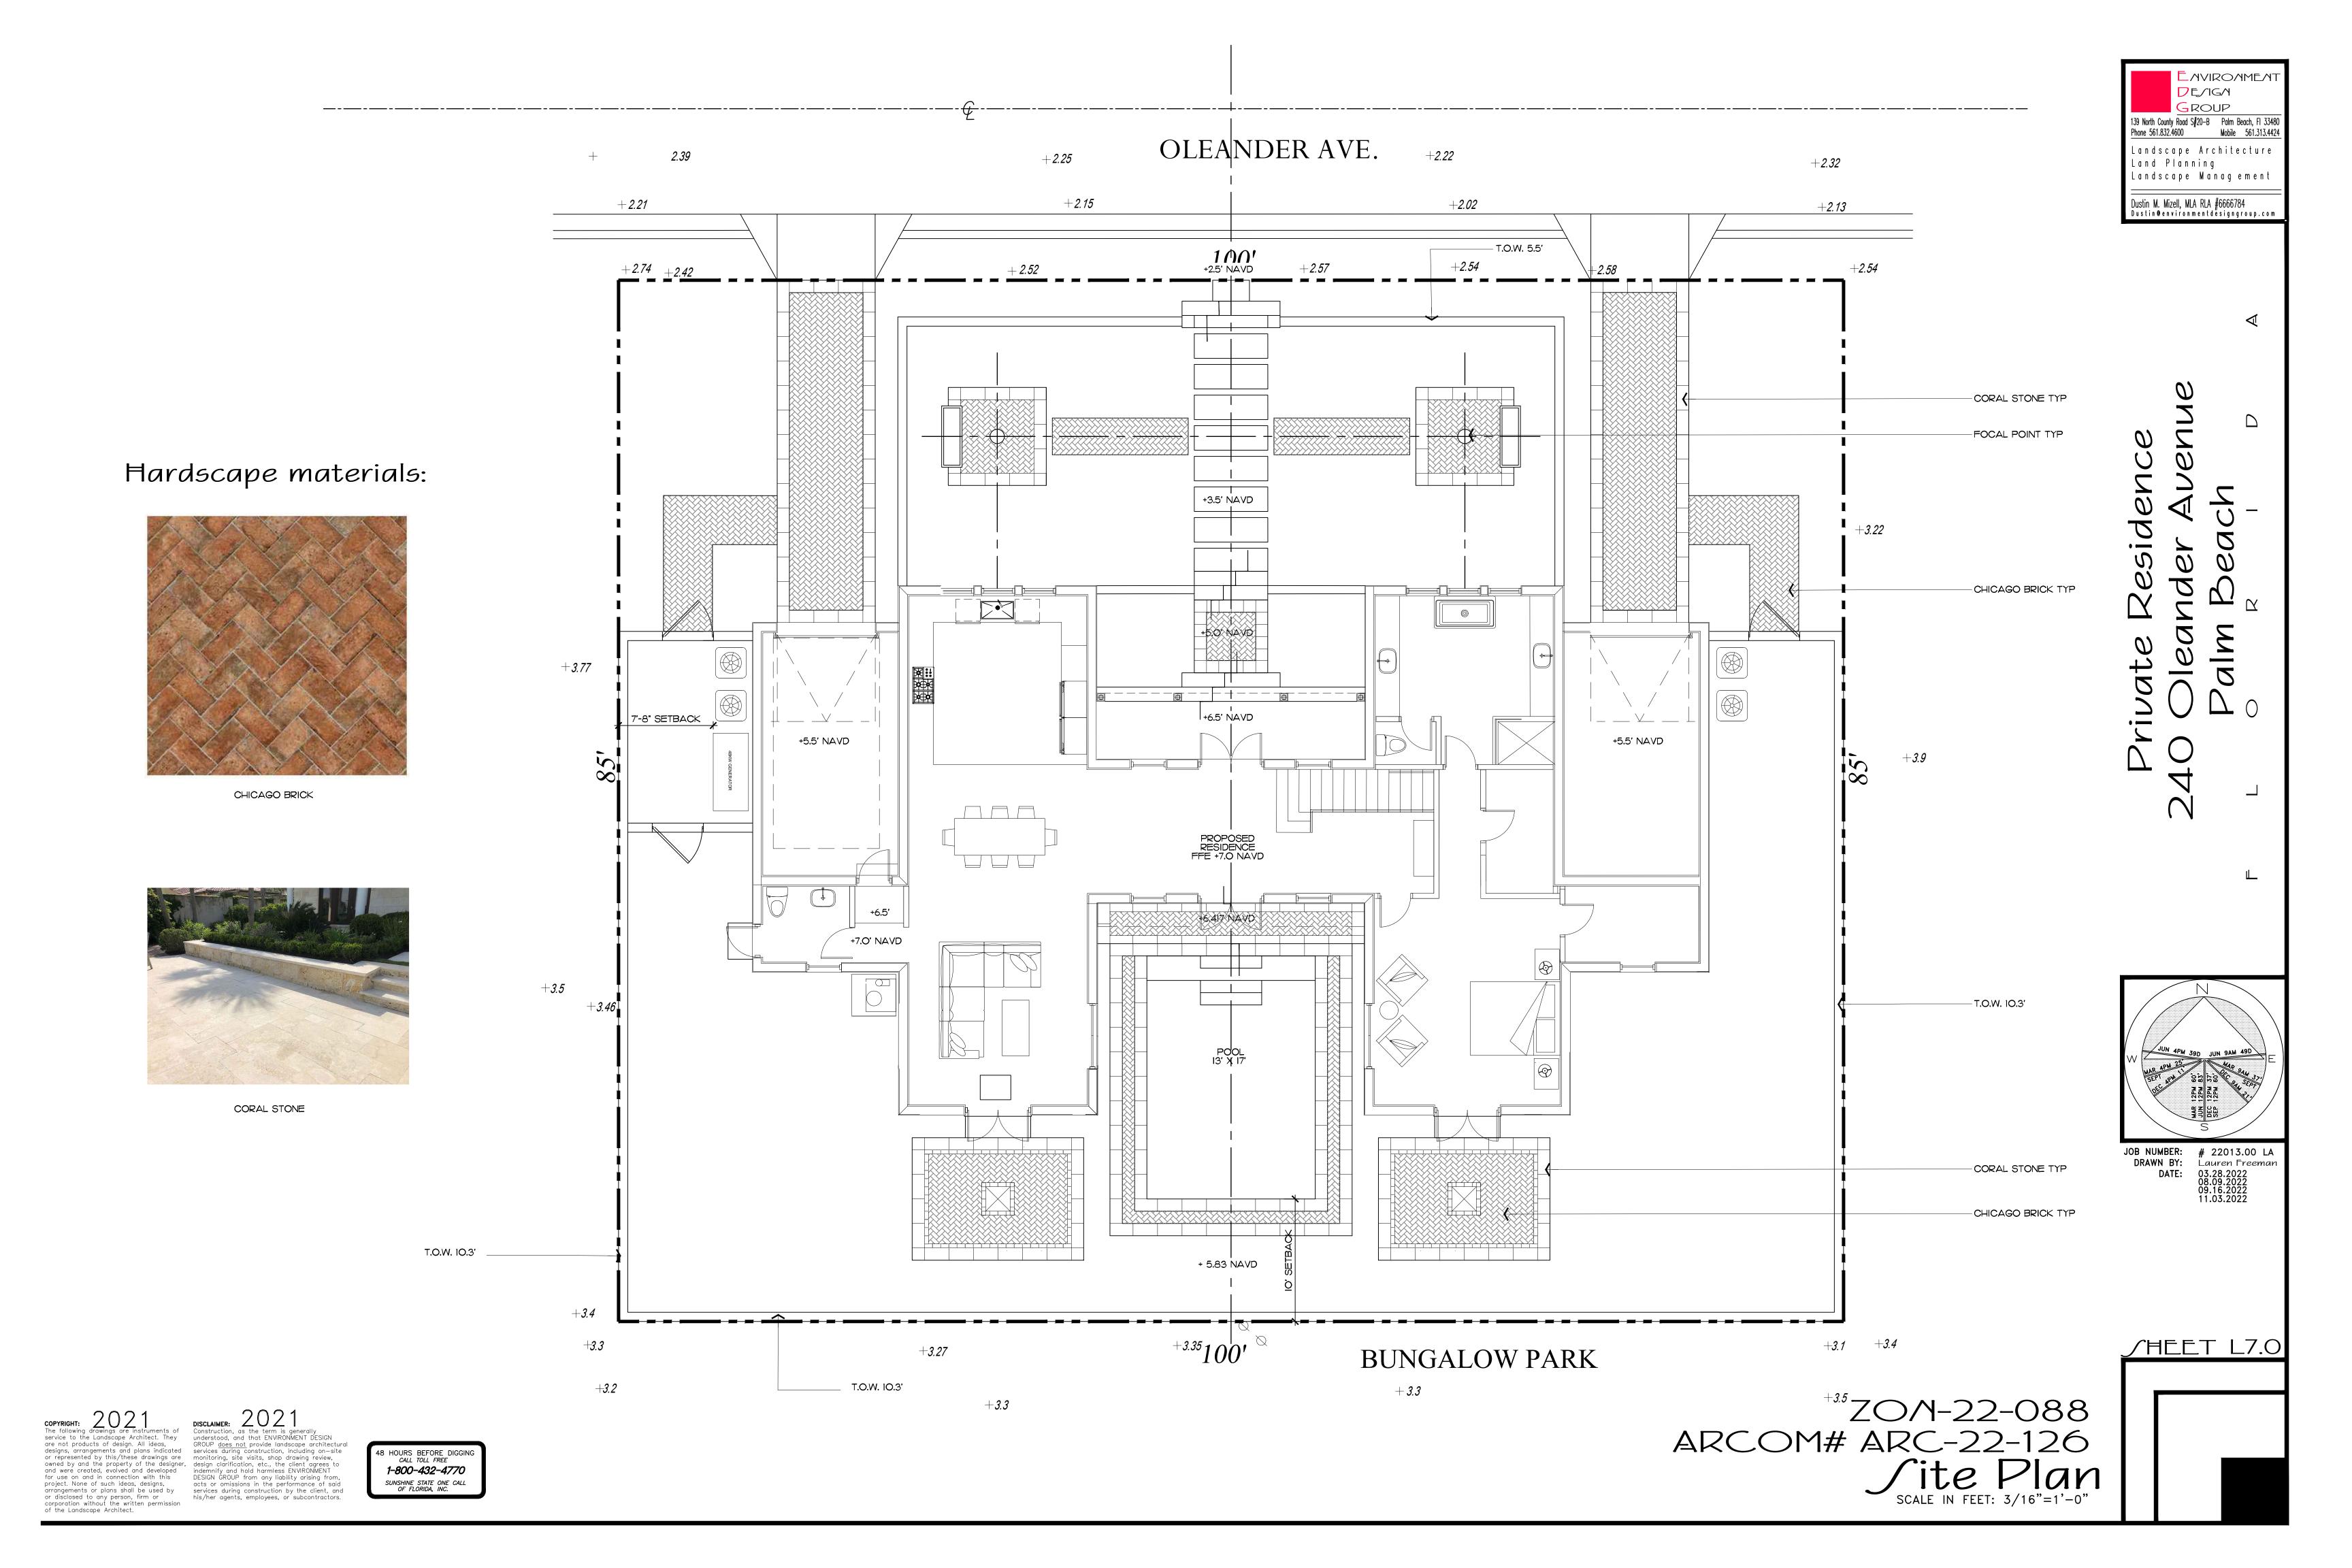

Legend IMPERVIOUS AREA (HOUSE/STRUCTURE) IMPERVIOUS AREA (HARDSCAPE) PERVIOUS AREA / OPEN SPACE PERVIOUS AREA / WATER FEATURE

OLEANDER AVE. +2.22

Proposed Site Data

+2.32

+*3.22*

DESCRIPTION	REQUIRED		PROPOSED	
LOT ZONE			R-C - LOW DENSITY RESIDENTIA	
LOT AREA	IO,000 S.F. MINIMUM		8,500 S.F.	
OPEN / PERMEABLE SPACE	MINIMUM 45%	3,825 S.F.	48.30%	4,106 S.F.
FRONT YARD LANDSCAPE	MINIMUM 40% OF FRONT YARD	1,000 S.F.	63%	1,575 S.F.
PERIMETER LANDSCAPE WITHIN IO' OF PROPERTY LINE	MINIMUM 50% OF REQ'D OPEN SPACE	1,912 S.F.	71.18%	2,723 S.F.

DE/IG/I GROUP 139 North County Road S#20-B Palm Beach, FI 33480 Phone 561.832.4600 Mobile 561.313.4424 Landscape Architecture Land Planning Landscape Management Dustin M. Mizell, MLA RLA #6666784 Dustin@environmentdesigngroup.com

Residen

JOB NUMBER: # 22013.00 LA
DRAWN BY: Alex Bugrii

DATE: 03.28.2022
08.10.2022
10.26.2022
11.03.2022

/HEET L7.1

ZOM-22-088 ARCOM# ARC-22-126

COPYRIGHT:

The following drawings are instruments of service to the Landscape Architect. They are not products of design. All ideas, designs, arrangements and plans indicated or represented by this/these drawings are owned by and the property of the designer, and were created, evolved and developed for use on and in connection with this project. None of such ideas, designs, arrangements or plans shall be used by or disclosed to any person, firm or services during construction by the client, and his/her agents, employees, or subcontractors. or disclosed to any person, firm or corporation without the written permission of the Landscape Architect.

48 HOURS BEFORE DIGGING CALL TOLL FREE 1-800-432-4770


+2.74 +2.42

+3.77

Site Calculation/Lot Coverage Graphics

BUNGALOW PARK

Proposed Lot Coverage Graphic

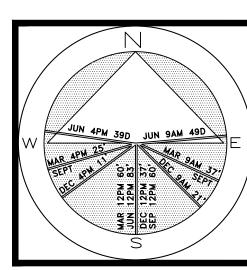

✓HEET L7.2

COPYRIGHT:


The following drawings are instruments of service to the Landscape Architect. They are not products of design. All ideas, designs, arrangements and plans indicated or represented by this/these drawings are owned by and the property of the designer, and were created, evolved and developed for use on and in connection with this project. None of such ideas, designs, arrangements or plans shall be used by or disclosed to any person, firm or corporation without the written permission of the Landscape Architect.

DISCLAIMER:

Construction, as the term is generally understood, and that ENVIRONMENT DESIGN GROUP does not provide landscape architectural services during construction, including on—site monitoring, site visits, shop drawing review, design clarification, etc., the client agrees to indemnify and hold harmless ENVIRONMENT DESIGN GROUP from any liability arising from, acts or omissions in the performance of said services during construction by the client, and his/her agents, employees, or subcontractors.

48 HOURS BEFORE DIGGING
CALL TOLL FREE
1-800-432-4770

ZOM-22-088 ARCOM# ARC-22-126 Rendered Landscape Plan Scale IN FEET: 3/16"=1'-0"

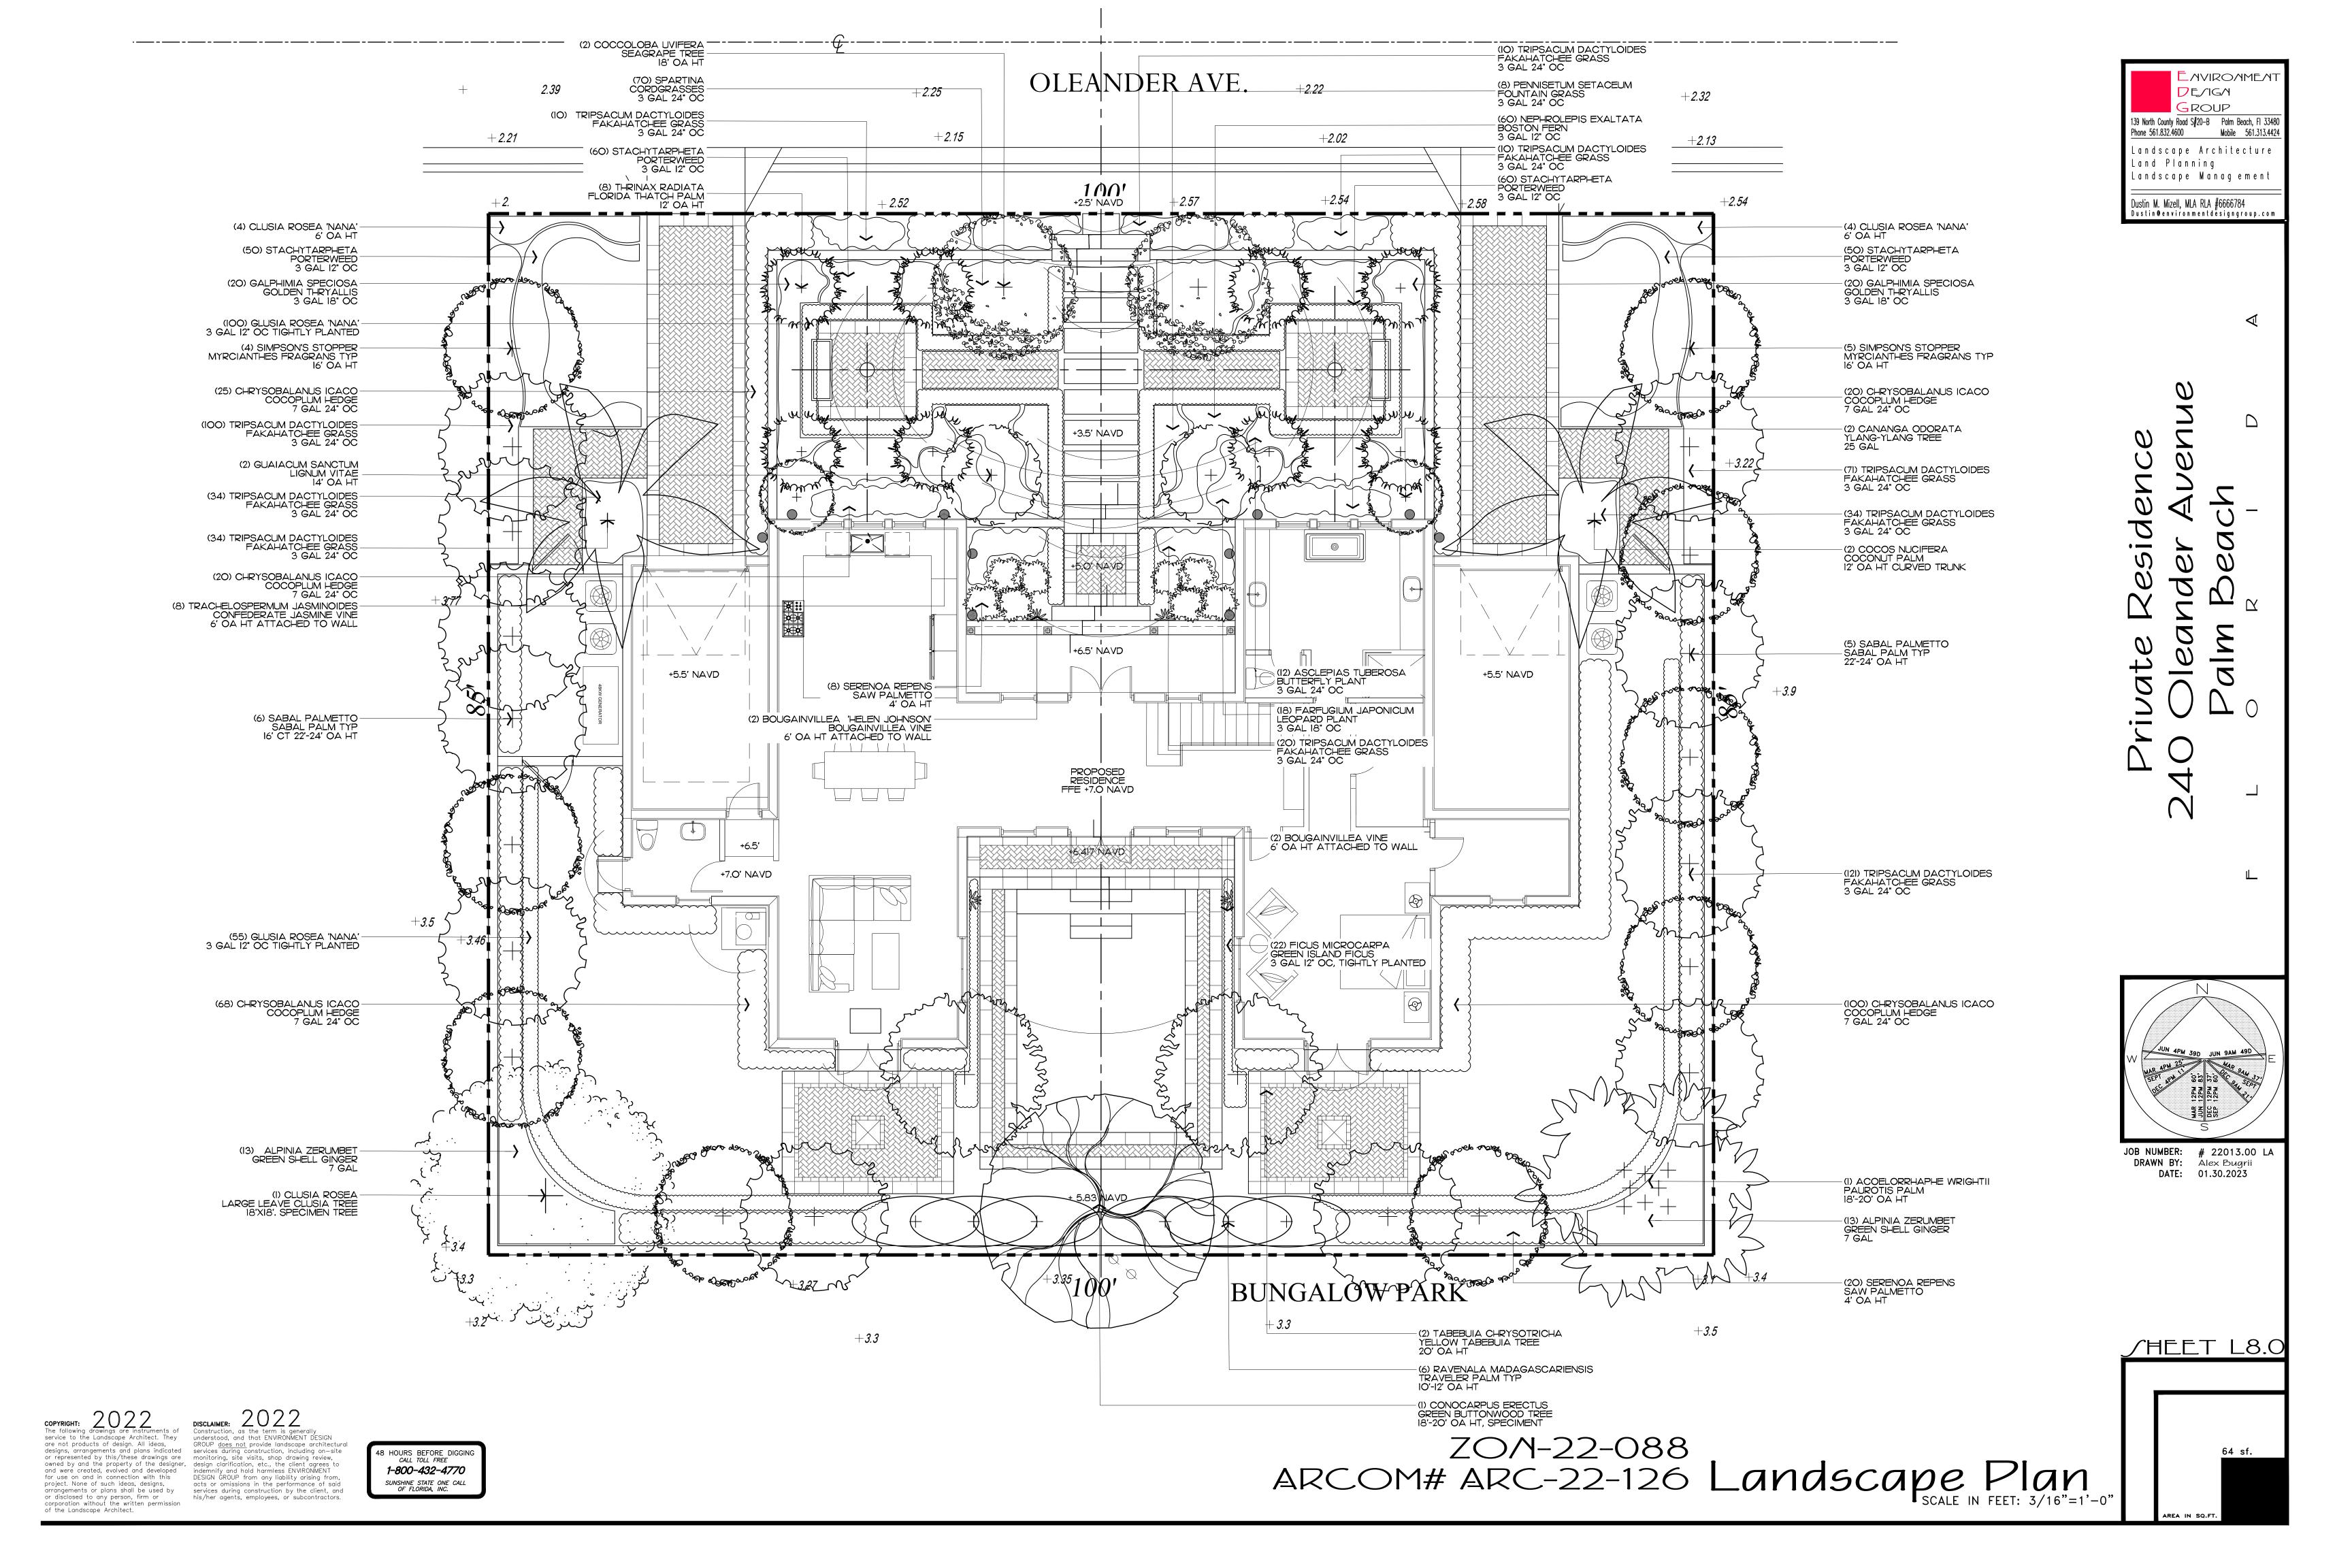

Trees

SYMBOL/KEY	PLANT NAME	QTY.	DESCRIPTION	NATIVE
+	COCCOLOBA UVIFERA SEAGRAPE TREE	2	18' OA HT, MATCHING	YES
+	SIMPSONS STOPPER MYRCIANTHES FRAGRANS	10	16' OA HT	YES
\odot	CANANGA ODORATA YLANG-YLANG TREE	2	25 GAL	NO
+ +	TABEBUIA CHRYSOTRICHA YELLOW TABEBUIA	2	20' OA HT	NO
	CONOCARPUS ERECTUS GREEN BUTTONWOOD TREE	1	18'-20' OA HT	YES
+	CLUSIA ROSEA LARGE LEAVE CLUSIA	1	18'X18' SPECIMENT	YES
+ 3	GUAIACUM SANCTUM LIGNUM VITAE	2	14' OA HT	NO

Vines & Groundcovers

SYMBOL/KEY	PLANT NAME	QTY.	DESCRIPTION	NATIVE
	BOUGAINVILLEA SPP BOUGAINVILLEA VINES	4	6' OA HT ATTACHED TO WALL	NO
	TRACHELOSPERMUM JASMINOIDES CONFEDERATE JASMINE VINE	8	6' OA HT ATTACHED TO WALL	NO
	CLUSIA ROSEA 'NANA' FROG FRUIT	I55	3 GAL 12" OC	YES

15 (71.42%)

Shrubs

SYMBOL/KEY	PLANT NAME		QTY.	DESCRIPTION	NATIVE
	SPARTINA CORDGRASS		70	3 GAL., 24" OC	YES
	TRIPSACUM DACTYL FAKAHATCHEE GRA		516	3 GAL 24" OC	YES
	STACHYTARPHETA PORTERWEED		IIO	3 GAL 12" OC	NO
	PENNISETUM SETAC FOUNTAIN GRASS		8	3 GAL 24" OC	NO
	NEPHROLEPIS EXAL BOSTON FERN	TATA	60	3 GAL 12 OC	YES
	GALPHIMIA SPECIOSA GOLDEN THRYALLIS		40	3 GAL 18" OC	NO
	CHRYSOBALANUS ICACO COCOPLUM HEDGE		233	7 GAL 24" OC	YES
	CLUSIA ROSEA 'NANA' CLUSIA ROSEA		8	6' OA HT	YES
	RAVENALA MADAGASCARIENSIS TRAVELER PALM		6	18'-20' OA HT	NO
	ASCLEPIAS TUBEROSA BUTTERFLY PLANT		12	3 GAL 24" OC	NO
	FARFUGIUM JAPONICUM LEOPARD PLANT		18	3 GAL 24" OC	NO
	FICUS MICROCARPA GREEN ISLAND FICUS		22	3 GAL 12" OC TIGHTLY PLANTED	NO
		TOTAL: NATIVE SPECIES:	1103 887 (80.41%)		

Palms

SYMBOL/KEY	PLANT NAME		QTY.	DESCRIPTION	NATIVE
**************************************	SABAL PALMETTO SABAL PALM		10	16' CT 22'-24' OA HT	YES
+ E	THRINAX RADIATA FLORIDA THATCH	H PALM	8	16'-18' CURVED TRUNK	YES
En man	SERENOA REPENS SAW PALMETTO		26	4' OA HT	YES
+ E	ACOELORRHAPHE EVERGLADES PAI			18'-20' OA HT	YES
	COCOS NUCIFERA COCONUT PALM		2	12' OA HT	NO
•		TOTAL: NATIVE SPECIES:	47 45 (95.74%)		

Lawn & Mulch

AREA	PLANT NAME	QTY.	DESCRIPTION
LAWN	DIAMOND ZOYSIA LAWN	AS NEEDED	SOD PALLETS
MULCH	EUCALYPTUS MULCH	AS NEEDED	3" MIN. DEPTH


Native Landscape Legend

240 OLEANDER AVENI	JE	
REQUIRED	PROPOSED	
10,000 SF	8,500 SF	
3,825 SF (45%)	4,106 SF (48.30%)	
1,912 SF (50%)	2,723 SF (71.18%)	
1,000 SF (40%)	1,575 SF (63%)	
35%	71.42%	
35%	95.74%	
35%	80.41%	
35%	92.81%	
	REQUIRED 10,000 SF 3,825 SF (45%) 1,912 SF (50%) 1,000 SF (40%) 35% 35%	


DE/IGN Landscape Management Dustin M. Mizell, MLA RLA #6666784 Dustin@environmentdesigngroup.com


/HEET L8.2


ZOM-22-088 ARCOM# ARC-22-126 Plant Schedule

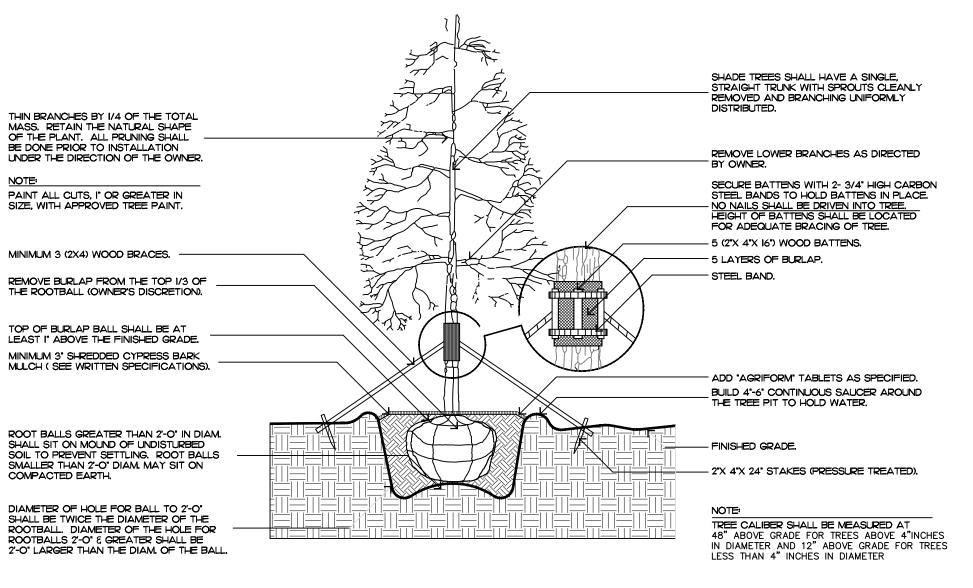


MATERIAL SHALL CONSIST OF AT LEAST /3 NATIVE SOIL FROM THE HOLE DUG FOR THE PLANT. SEE SPECIFICATIONS FOR BACKFILL MIXTURE. tree planting

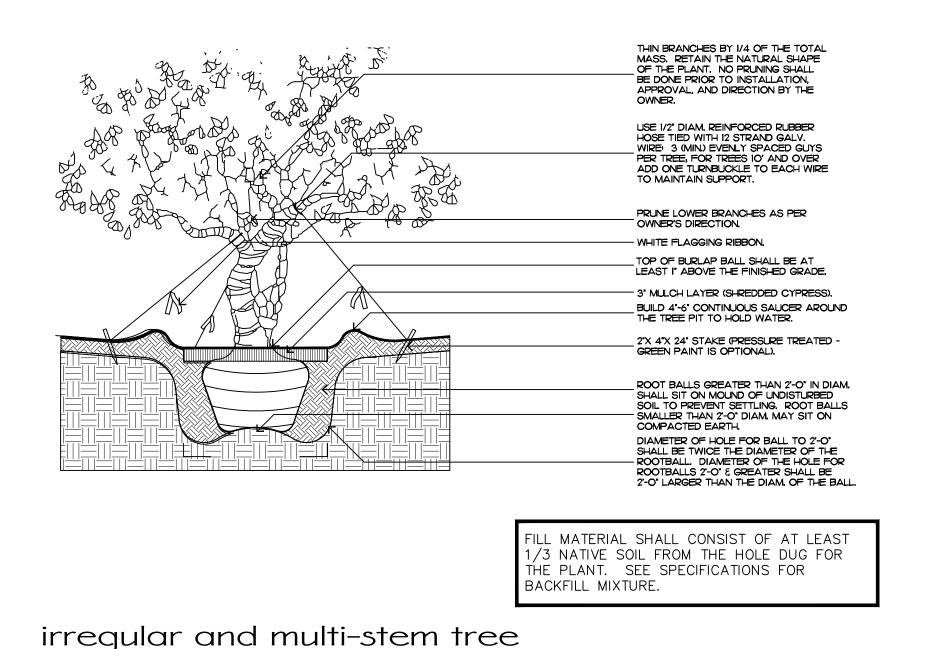

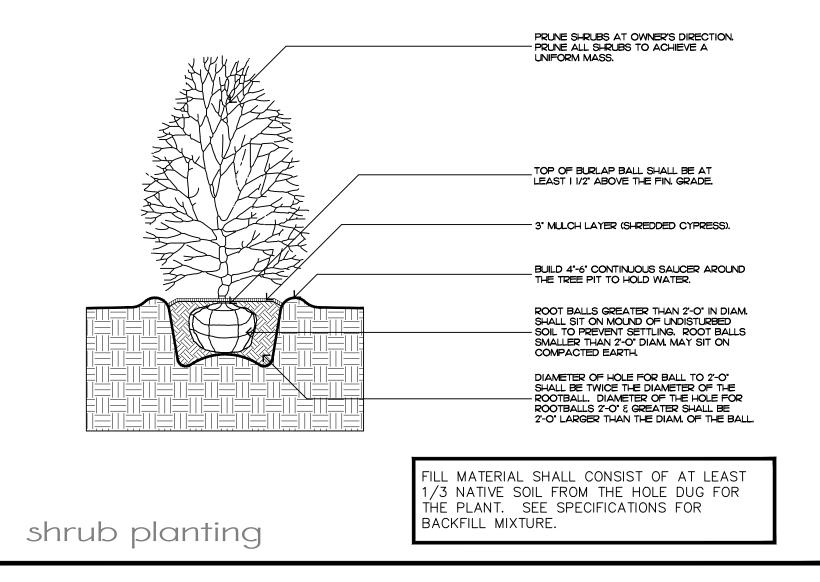

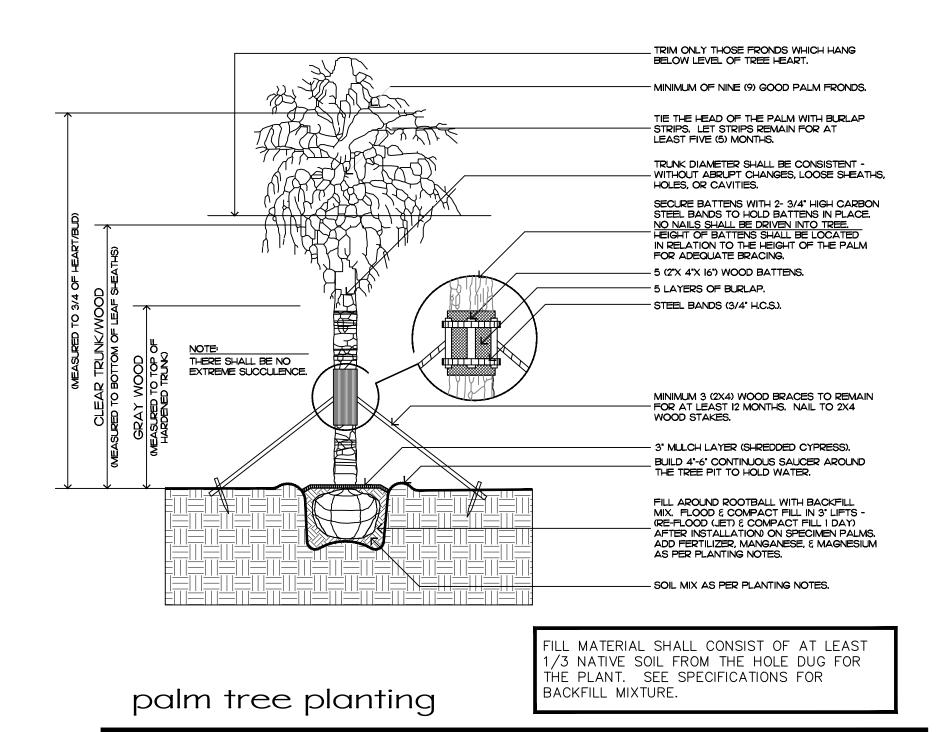

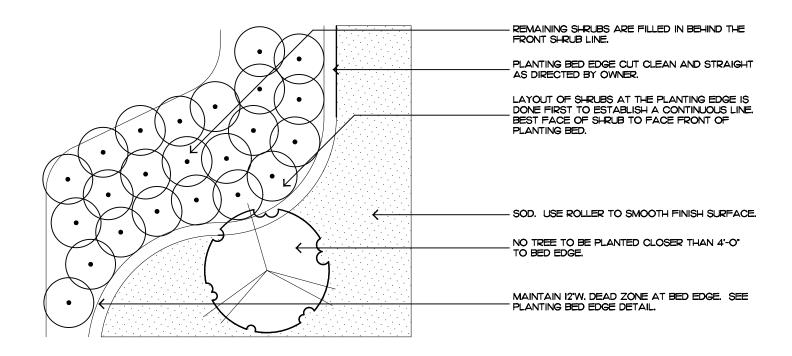

shrub & ground cover layout

Planting Motes

COMMERCIAL FERTILIZER:

FERTILIZER SHALL BE COMPLETELY ORGANIC, IT SHALL BE UNIFORM IN COMPOSITION, DRY AND FREE FLOWING. THIS FERTILIZER SHALL BE DELIVERED TO THE SITE IN THE ORIGINAL UNOPENED BAGS, EACH BEARING THE MANUFACTURER'S STATEMENT OF ANALYSIS, AND SHALL MEET THE FOLLOWING REQUIREMENTS:

SIX PERCENT (6%) PHOSPHOROUS

SIX PERCENT (6%) POTASSIUM

FERTILIZER SHALL BE APPLIED TO ALL SHRUBS (1/3 LB. PER 3 GAL. POT, 1/4 LB. PER 1 GAL. POT) AND GROUNDCOVER. THE SAME FERTILIZER MIXTURE SHALL BE USED ON SOD AT A RATE OF 15 LBS. PER 1000 SQUARE FEET. A FOURTEEN PERCENT (14%) NITROGEN, FOURTEEN PERCENT (14%) PHOSPHOROUS AND FOURTEEN PERCENT (14%) POTASSIUM IS REQUIRED ON ALL TREES AND SHRUBS OVER 5'-O' IN HEIGHT (1/2 LB. PER 5'-O" OF SPREAD). AGRIFORM TABLETS WITH TWENTY PERCENT (20%) NITROGEN, TEN PERCENT (10%) PHOSPHOROUS, FIVE PERCENT (5%) POTASSIUM IN 21 GRAM SIZES SHALL BE APPLIED ALONG WITH THE FERTILIZER PROCESS (I WITH I GAL. PLANTS, 2 WITH 3 GAL. PLANTS AND 2 TABLETS PER I' OF TREE TRUNK CALIPER). BACK FILL HALFWAY UP THE ROOT BALL, PLACE ABOUT ONE INCH (I') FROM ROOT TIPS. MAGNESIUM SULFATE SHALL BE APPLIED TO ALL PALMS AT INSTALLATION AT A RATE OF 1/2 LB. PER INCH OF TRUNK CALIPER. MANGANESE SHALL BE APPLIED AT THE SAME RATE.

MULCH:

MULCH MATERIAL SHALL BE SHREDDED CYPRESS MULCH OR APPROVED EQUAL, MOISTENED AT THE TIME OF APPLICATION TO PREVENT WIND DISPLACEMENT. MULCH SHALL BE APPLIED TO A MINIMUM 3" DEPTH

/OD:

THE SOD SHALL BE FREE FROM WEEDS, FUNGUS, INSECTS AND DISEASES OF ANY KIND, CLEAN, STRONGLY ROOTED, UNIFORMLY SIZED STRIPS, MACHINE STRIPPED NOT MORE THAN TWENTY-FOUR (24) HOURS

JUB/TITUTION/:

NO SUBSTITUTION OF PLANT MATERIAL TYPES OR SIZES WILL BE ALLOWED WITHOUT WRITTEN AUTHORIZATION FROM THE OWNER. CONTAINER GROWN MATERIAL WILL NOT BE ACCEPTED AS SUBSTITUTE FOR BEB MATERIAL UNLESS PREVIOUSLY APPROVED. INTENDED SUBSTITUTIONS SHALL BE SPELLED OUT IN BID.

MEA/UREMENT/:

HEIGHT SHALL BE MEASURED FROM GROUND TO THE AVERAGE BRANCH HEIGHT OF CANOPY. SPREAD SHALL BE MEASURED TO THE END OF THE BRANCHING EQUALLY AROUND THE CROWN FROM THE CENTER OF THE TRUNK. MEASUREMENTS ARE NOT TO INCLUDE ANY TERMINAL GROWTH. SINGLE TRUNK TREES SHALL BE FREE OF "V" CROTCHES THAT COULD BE POINTS OF WEAK LIMB STRUCTURE OR DISEASE INFESTATION.

HEIGHT SHALL BE MEASURED FROM THE GROUND TO THE AVERAGE POINT WHERE MATURE PLANT GROWTH STOPS. SPREAD SHALL BE MEASURED TO THE END OF

BRANCHING EQUALLY AROUND THE SHRUB MASS. MEASUREMENT AREA NOT TO INCLUDE ANY TERMINAL GROWTH.

CLEAR TRUNK (C.T.) - SHALL BE MEASURED FROM THE GROUND AT TIME OF INSTALLATION TO THE POINT WHERE THE MATURE AGED TRUNK JOINS THE IMMATURE OR GREEN PORTION

OVERALL HEIGHT (O.A.) - SHALL BE MEASURED FROM THE GROUND AT THE TIME OF

INSTALLATION TO THE AVERAGE FROND HEIGHT.

PALMS WITH MARRED OR BURNED TRUNKS WILL NOT BE ACCEPTED.

PLANTING JOIL AND BACKFILL:

PLANTING SOIL FOR USE IN PREPARING BACKFILL FOR PLANT PITS SHALL BE A FERTILE, FRIABLE AND NATURAL TOPSOIL, WITHOUT MIXTURE OF SUBSOIL MATERIALS, AND SHALL BE FREE FROM HEAVY CLAY STONES, LIME, LUMPS, SHELLS, PLANTS, ROOTS OR OTHER FOREIGN MATERIALS, WEEDS, OR NOXIOUS GRASSES (SUCH AS BERMUDA OR NUT GRASS). IT SHALL NOT CONTAIN TOXIC SUBSTANCES WHICH MAY BE HARMFUL TO THE PLANT GROWTH.

BACKFILL FOR SOD AREAS SHALL BE SUBJECT TO LESSER STANDARDS AT THE DISCRETION AND DECISION OF THE OWNER.

EXISTING TOPSOIL SHALL BE USED IN ALL PLANT MATERIAL PITS EXCEPT SABAL PALMS WHERE THE SOIL SHALL CONSIST OF CLEAN SAND.

PLANTING SOIL FOR USE IN BEDS FOR ANNUALS AND/OR PERENNIALS SHALL CONTAIN ONE-THIRD (1/3) POTTING SOIL OR A BLENDED TOPSOIL, TILL INTO TOP 10" - 12" OF SOIL WITH A TIME-RELEASE FERTILIZER.

PLANT MATERIAL/:

PALMS, TREES, SHRUBS, GROUNDCOVERS AND VINES

PLANT SPECIES AND SIZE SHALL CONFORM TO THOSE INDICATED ON THE DRAWINGS. NOMENCLATURE SHALL CONFORM TO "STANDARDIZED PLANT NAMES", 1942 EDITION. ALL NURSERY STOCK SHALL BE IN ACCORDANCE WITH "GRADES AND STANDARDS FOR NURSERY PLANTS PARTS I & II", LATEST EDITION PUBLISHED BY THE FLORIDA DEPARTMENT OF AGRICULTURE AND CONSUMER SERVICES. UNLESS SPECIFIED OTHERWISE, ALL PLANTS SHALL BE FLORIDA GRADE NUMBER I OR BETTER AS DETERMINED BY THE FLORIDA DIVISION OF PLANT INDUSTRY, SPECIMEN MEANS AN EXCEPTIONALLY HEAVY, SYMMETRICAL TIGHTLY KNIT PLANT, SO TRAINED OR FAVORED IN ITS DEVELOPMENT THAT FIRST APPEARANCE IS UNQUESTIONABLE AND OUTSTANDINGLY SUPERIOR IN FORM, NUMBER OF BRANCHES, COMPACTNESS AND SYMMETRY. ALL PLANTS SHALL BE FRESHLY DUG, SOUND, HEALTHY, VIGOROUS, WELL BRANCHED AND FREE OF DISEASE AND INSECT EGGS AND LARVAE AND SHALL HAVE ADEQUATE ROOT SYSTEMS. TREES FOR PLANTING ROWS SHALL BE UNIFORM IN SIZE AND SHAPE. ALL MATERIALS SHALL BE SUBJECT TO APPROVAL BY THE OWNER. WHERE REQUIREMENTS ARE OMITTED FROM THE PLANT LIST, THE PLANTS FURNISHED SHALL BE NORMAL FOR THE VARIETY AND FLORIDA NUMBER I. PLANTS SHALL BE PRUNED PRIOR TO DELIVERY ONLY UPON THE APPROVAL OF THE OWNER.

CONTAINER GROWN / TOCK:

ALL CONTAINER GROWN MATERIAL SHALL BE HEALTHY, VIGOROUS, WELL-ROOTED PLANTS AND ESTABLISHED IN THE CONTAINER IN WHICH THEY ARE SOLD. THE PLANTS SHALL HAVE TOPS OF GOOD QUALITY AND BE IN A HEALTHY GROWING CONDITION.

AN ESTABLISHED CONTAINER GROWN PLANT SHALL BE TRANSPLANTED INTO A CONTAINER AND GROWN IN THAT CONTAINER SUFFICIENTLY LONG ENOUGH FOR THE NEW FIBROUS ROOTS TO HAVE DEVELOPED SO THAT THE ROOT MASS WILL RETAIN ITS SHAPE AND HOLD TOGETHER WHEN REMOVED FROM THE

WARRANTY:

WARRANTY PLANTS, SHRUBS AND GROUNDCOVERS FOR A PERIOD OF NINETY (90) DAYS: TREES & PALMS FOR ONE YEAR (1) AGAINST UNHEALTHY CONDITION, EXCEPT AS MAY RESULT FROM NEGLECT BY OWNER, DAMAGE BY OTHERS, AND UNUSUAL PHENOMENA BEYOND INSTALLER'S CONTROL. REPLACE AT TIME REQUESTED BY THE OWNER OR LANDSCAPE ARCHITECT.

MAINTENANCE:

MAINTAIN LANDSCAPE WORK UNTIL THE LETTER OF SUBSTANTIAL COMPLETION BY THE GENERAL CONTRACTOR. INCLUDE WATERING, WEEDING, CULTIVATING, RESTORATION OF GRADE, MOWING AND TRIMMING GRASS, PRUNING TREES AND SHRUBS, PROTECTION FROM INSECTS AND DISEASES, FERTILIZATION AND SIMILAR OPERATIONS AS NEEDED TO ENSURE NORMAL GOOD HEALTH FOR LIVE PLANT MATERIAL.

Mobile 561.313.442

DE/IG/I

139 North County Road S#20-B Palm Beach, Fl 3348

Landscape Architecture

Landscape Management

Dustin@environmentdesigngroup.com

Dustin M. Mizell, MLA RLA #6666784

Phone 561.832.4600

Land Planning

ROUP

JOB NUMBER: # 22013.00 LA DRAWN BY: Dustin Mizell DATE: 08.10.2022

/HEET L8.3

ZOM-22-088 ARCOM# ARC-22-126

arrangements or plans shall be used by or disclosed to any person, firm or corporation without the written permission

are not products of design. All ideas, designs, arrangements and plans indicated or represented by this/these drawings are

GROUP does not provide landscape architectural services during construction, including on—site monitoring, site visits, shop drawing review, owned by and the property of the designer, and were created, evolved and developed indemnify and hold harmless ENVIRONMENT for use on and in connection with this project. None of such ideas, designs, acts or omissions in the performance of said his/her agents, employees, or subcontractors.

48 HOURS BEFORE DIGGING CALL TOLL FREE 1-800-432-4770 SUNSHINE STATE ONE CALL OF FLORIDA, INC.

Planting Details & Specifications

Lighting Schedule

SYMBOL	DESCRIPTION	QTY
▲ UL	<u>UPLIGHT</u> - AURORALIGHT - HSLI6-R TELLURIDE BRASS - 9 WATTS - LED 2700K	39
O WL	<u>WELL LIGHT</u> - AURORALIGHT - LWL5 LIGHTHAUS BRASS FINISH - 9 WATTS - LED 2700K	3
PL	<u>PATH LIGHT</u> - AURORALIGHT - LPL8 - CORONA BRASS FINISH - 4.5 WATTS - LED 2700K	6








UP LIGHT



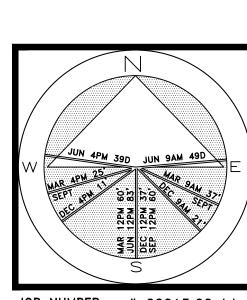

∕HEET L9.0

ZO/1# 22-088 ARCOM# ARC-22-126 Landscape Lighting Plan Scale IN FEET O'

COPYRIGHT:

The following drawings are instruments of service to the Landscape Architect. They are not products of design. All ideas, designs, arrangements and plans indicated or represented by this/these drawings are owned by and the property of the designer, and were created, evolved and developed for use on and in connection with this project. None of such ideas, designs, arrangements or plans shall be used by or disclosed to any person, firm or corporation without the written permission of the Landscape Architect.

DISCLAIMER:

Construction, as the term is generally understood, and that ENVIRONMENT DESIGN GROUP does not provide landscape architectural services during construction, including on—site monitoring, site visits, shop drawing review, design clarification, etc., the client agrees to indemnify and hold harmless ENVIRONMENT DESIGN GROUP from any liability arising from, acts or omissions in the performance of said services during construction by the client, and his/her agents, employees, or subcontractors.

48 HOURS BEFORE DIGGING CALL TOLL FREE 1-800-432-4770 SUNSHINE STATE ONE CALL OF FLORIDA, INC.

Dustin M. Mizell, MLA RLA #6666784 Dustin@environmentdesigngroup.com

DE/IG/I ROUP

Landscape Architecture Land Planning

Landscape Management



✓HEET L10 ZON-22-088

ARCOM# ARC-22-126

Jection Diagrams

SCALE IN FEET O'

COPYRIGHT:

The following drawings are instruments of service to the Landscape Architect. They are not products of design. All ideas, designs, arrangements and plans indicated or represented by this/these drawings are owned by and the property of the designer, and were created, evolved and developed for use on and in connection with this project. None of such ideas, designs, arrangements or plans shall be used by or disclosed to any person, firm or corporation without the written permission of the Landscape Architect.

DISCLAIMER:

Construction, as the term is generally understood, and that ENVIRONMENT DESIGN GROUP does not provide landscape architectural services during construction, including on—site monitoring, site visits, shop drawing review, design clarification, etc., the client agrees to indemnify and hold harmless ENVIRONMENT DESIGN GROUP from any liability arising from, acts or omissions in the performance of said services during construction by the client, and his/her agents, employees, or subcontractors.

48 HOURS BEFORE DIGGING CALL TOLL FREE
1-800-432-4770 SUNSHINE STATE ONE CALL OF FLORIDA, INC.


DE/IG/I ROUP

139 North County Road S#20-B Palm Beach, FI 33480 Phone 561.832.4600 Mobile 561.313.4424

Landscape Architecture Land Planning Landscape Management

Dustin M. Mizell, MLA RLA #6666784 Dustin@environmentdesigngroup.com

JOB NUMBER: # 22013.00 LA Grace Walton James Aparicio 02.06.23

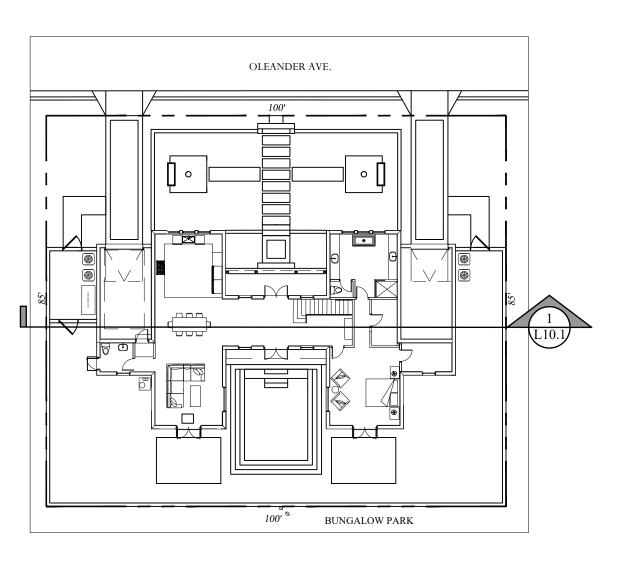

∫ite Plan SCALE: N.T.S.



East - West Site Section SCALE: 1/4"=1'-0"

COPYRIGHT:

The following drawings are instruments of service to the Landscape Architect. They are not products of design. All ideas, designs, arrangements and plans indicated or represented by this/these drawings are owned by and the property of the designer, and were created, evolved and developed for use on and in connection with this project. None of such ideas, designs, arrangements or plans shall be used by or disclosed to any person, firm or corporation without the written permission of the Landscape Architect.

DISCLAIMER:

Construction, as the term is generally understood, and that ENVIRONMENT DESIGN GROUP does not provide landscape architectural services during construction, including on—site monitoring, site visits, shop drawing review, design clarification, etc., the client agrees to indemnify and hold harmless ENVIRONMENT DESIGN GROUP from any liability arising from, acts or omissions in the performance of said services during construction by the client, and his/her agents, employees, or subcontractors.

48 HOURS BEFORE DIGGING CALL TOLL FREE
1-800-432-4770 SUNSHINE STATE ONE CALL OF FLORIDA, INC.

ZON-22-088

ARCOM# ARC-22-126

Jection Diagrams


SCALE IN FEET O'

DE/IG/I ROUP 139 North County Road S#20-B Palm Beach, FI 33480 Phone 561.832.4600 Mobile 561.313.4424 Landscape Architecture Land Planning Landscape Management Dustin M. Mizell, MLA RLA #6666784 Dustin@environmentdesigngroup.com

JOB NUMBER: # 22013.00 LA


Grace Walton James Aparicio 02.06.23

✓HEET L10.1

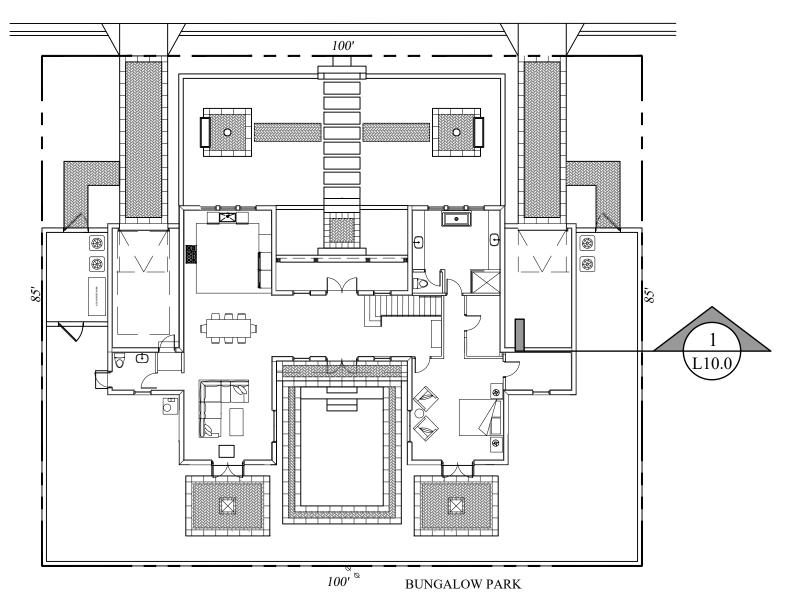


√ite Plan

SCALE: 1/16" = 1'

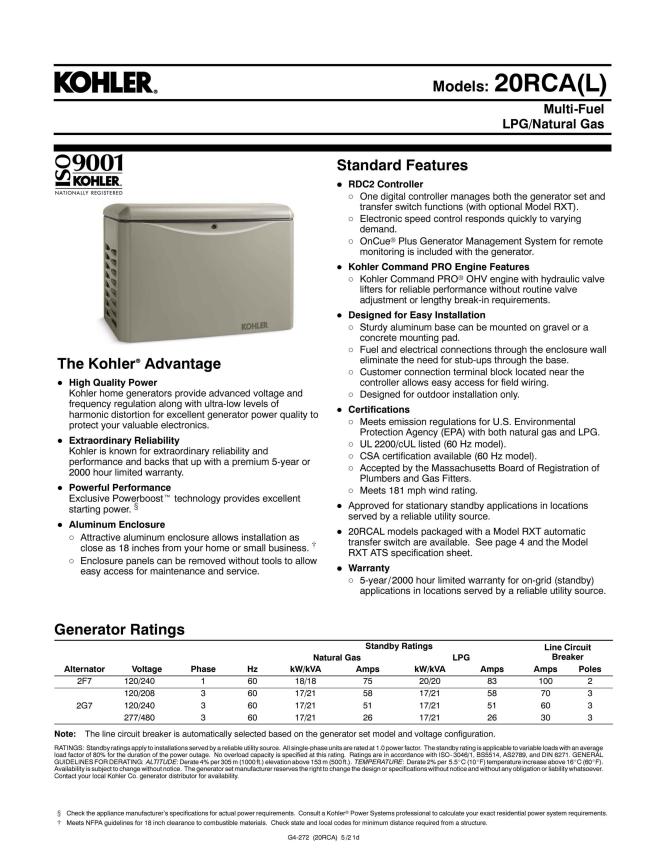

Generac 27 KW Generator

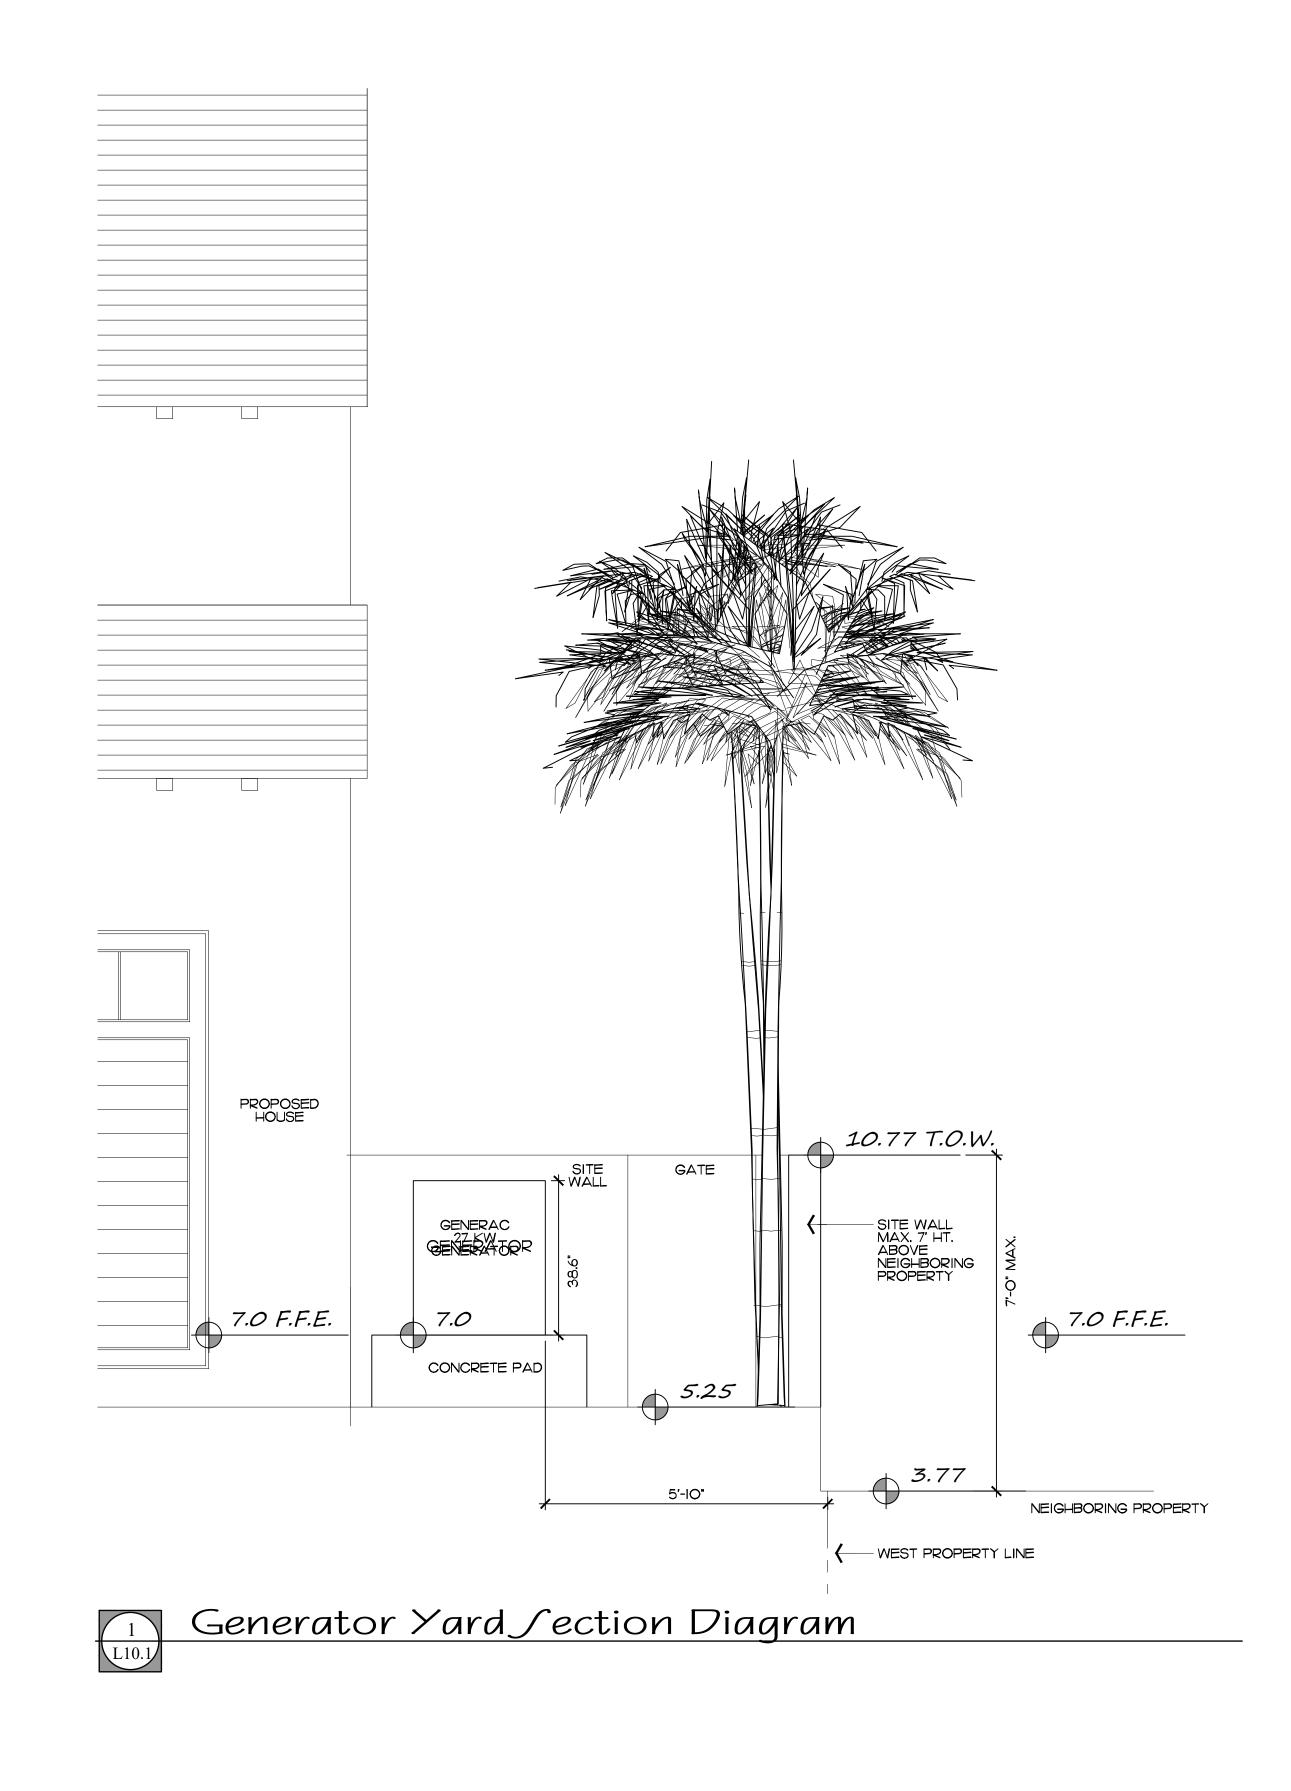

Landscape Architecture Land Planning

Landscape Management

Dustin M. Mizell, MLA RLA #6666784 Dustin@environmentdesigngroup.com

JOB NUMBER: # 22013.00 LA

DRAWN BY: Sean Twomey

DATE: 05.31.2022

08.10.2022

JHEET L10.1

ZOM-22-088 ARCOM# ARC-22-126 Equipment Yard Section Diagram Scale IN FEET O'

The following drawings are instruments of service to the Landscape Architect. They are not products of design. All ideas, designs, arrangements and plans indicated or represented by this/these drawings are owned by and the property of the designer, and were created, evolved and developed for use on and in connection with this project. None of such ideas, designs, arrangements or plans shall be used by or disclosed to any person, firm or corporation without the written permission.

DISCLAIMER:


Construction, as the term is generally understood, and that ENVIRONMENT DESIGN GROUP does not provide landscape architectural services during construction, including on—site monitoring, site visits, shop drawing review, design clarification, etc., the client agrees to indemnify and hold harmless ENVIRONMENT DESIGN GROUP from any liability arising from, acts or omissions in the performance of its/her are instruction. or disclosed to any person, firm or corporation without the written permission of the Landscape Architect.

48 HOURS BEFORE DIGGING

CALL TOLL FREE 1-800-432-4770 SUNSHINE STATE ONE CALL OF FLORIDA, INC.



Morth / Front Elevation

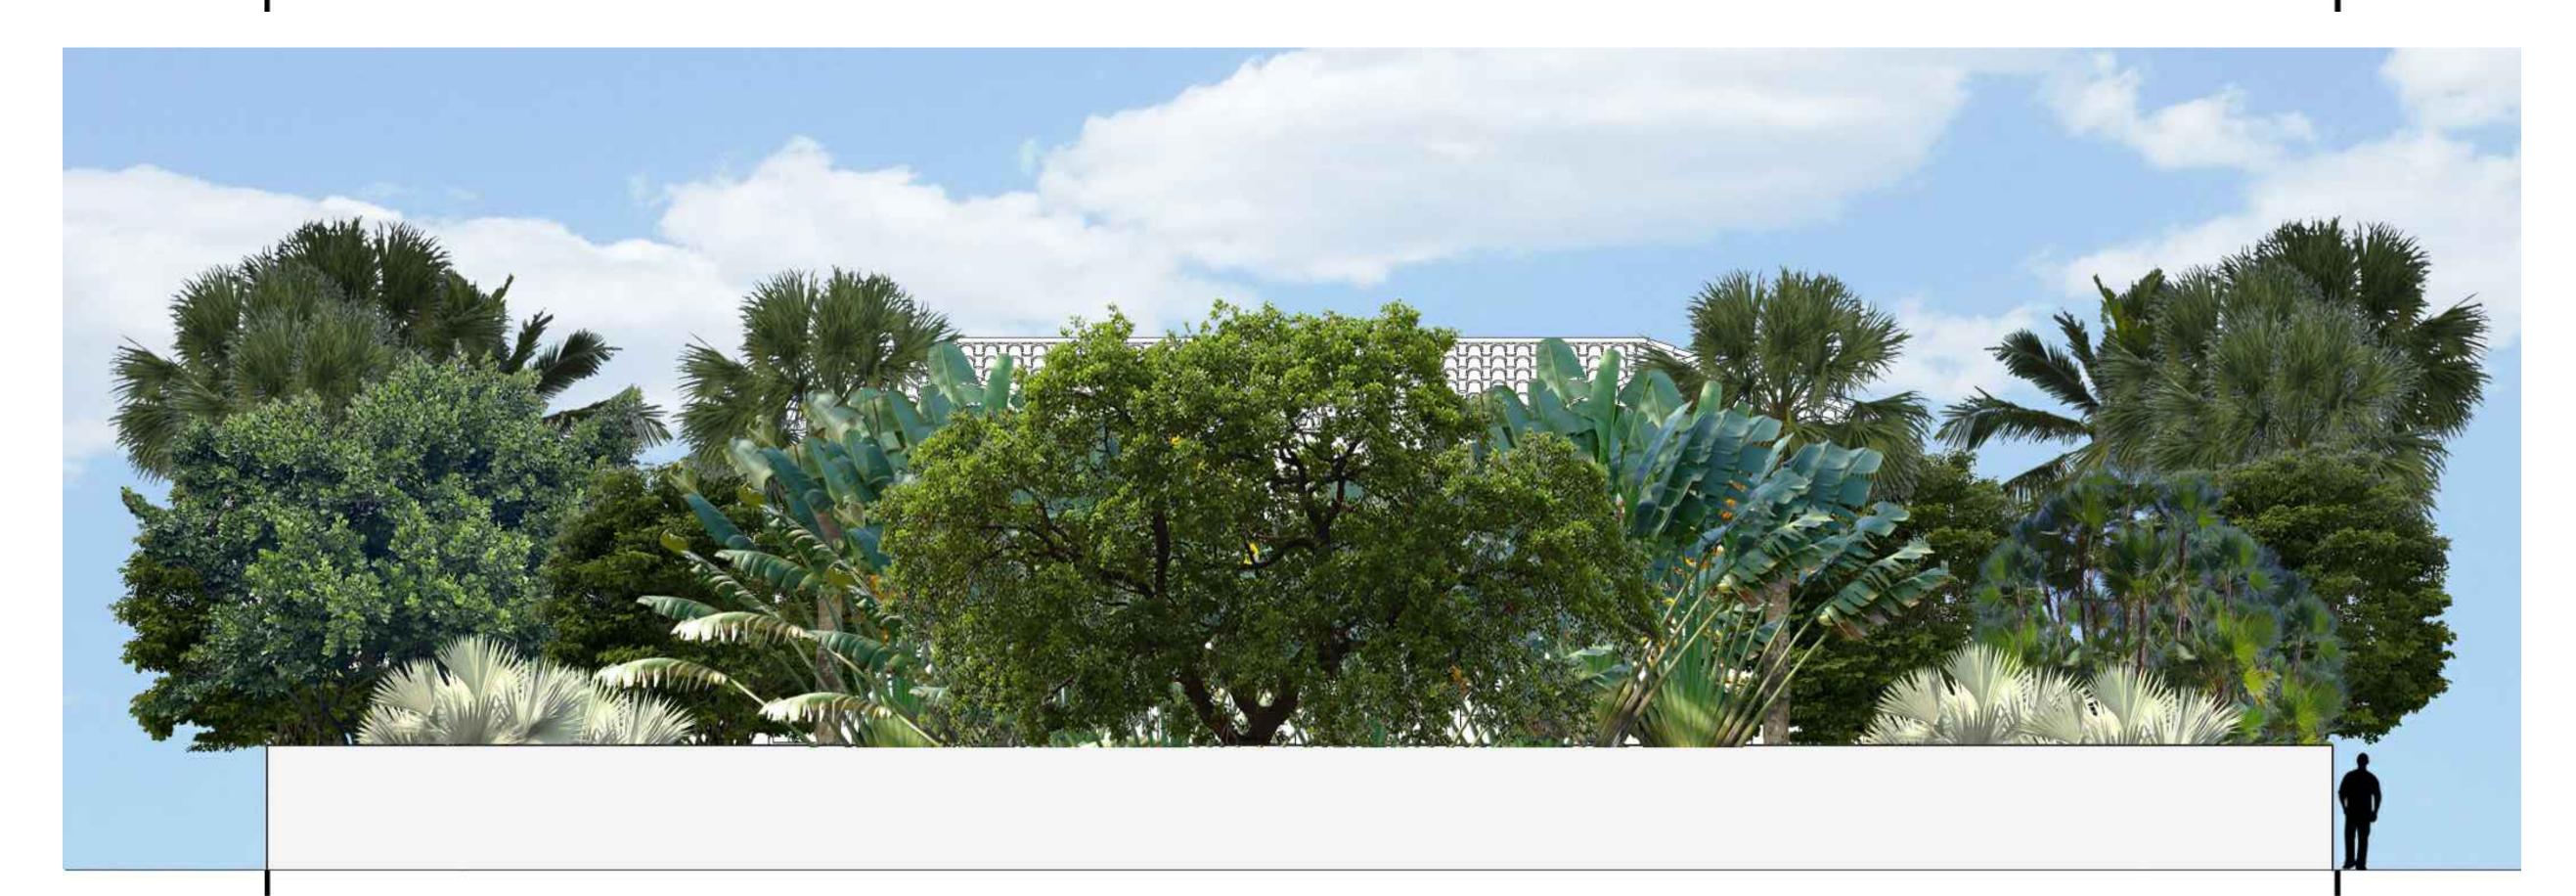

South / Rear Elevation

service to the Landscape Architect. They are not products of design. All ideas, designs, arrangements and plans indicated or represented by this/these drawings are owned by and the property of the designer, and were created, evolved and developed for use on and in connection with this project. None of such ideas, designs, arrangements or plans shall be used by or disclosed to any person, firm or corporation without the written permission of the Landscape Architect. They understood, and that ENVIRONMENT provide landscape architectural services during construction, including on—site monitoring, site visits, shop drawing review, design clarification, etc., the client agrees to indemnify and hold harmless ENVIRONMENT DESIGN GROUP does not provide landscape architectural services during construction, including on—site monitoring, site visits, shop drawing review, design clarification, etc., the client agrees to indemnify and hold harmless ENVIRONMENT DESIGN GROUP from any liability arising from, acts or omissions in the performance of said services during construction including on—site monitoring, site visits, shop drawing review, design clarification, etc., the client agrees to indemnify and hold harmless ENVIRONMENT DESIGN GROUP does not provide landscape architectural services during construction, including on—site monitoring, site visits, shop drawing review, design clarification, etc., the client agrees to indemnify and hold harmless ENVIRONMENT DESIGN GROUP from any liability arising from, acts or omissions in the performance of said services during construction, including on—site monitoring, site visits, shop drawing review, design clarification, etc., the client agrees to indemnify and hold harmless ENVIRONMENT DESIGN GROUP from any liability arising from, acts or omissions in the performance of said services during construction, including on—site monitoring, site visits, shop drawing review, design clarification, etc., the client agrees to indemnify and hold harmless ENVIRONMENT

48 HOURS BEFORE DIGGING CALL TOLL FREE 1-800-432-4770

ZON-22-088 ARCOM# ARC-22-126 Front / Rear Landscape Elevations
SCALE IN FEET: 3/16"=1"-0"

Landscape Architecture Land Planning Landscape Management

Dustin M. Mizell, MLA RLA #6666784 Dustin@environmentdesigngroup.com

/HEETL11.0





West Elevation

COPYRIGHT:

The following drawings are instruments of service to the Landscape Architect. They are not products of design. All ideas, designs, arrangements and plans indicated or represented by this/these drawings are owned by and the property of the designer, and were created, evolved and developed for use on and in connection with this project. None of such ideas, designs, arrangements or plans shall be used by or disclosed to any person, firm or corporation without the written permission of the Landscape Architect.

48 HOURS BEFORE DIGGING CALL TOLL FREE 1-800-432-4770

LON-22-088 ARCOM# ARC-22-126 Scale IN FEET: 3/16"=1"-0"

DE/IG/I

139 North County Road S#20-B Palm Beach, FI 33480 Phone 561.832.4600 Mobile 561.313.4424

Landscape Architecture Land Planning Landscape Management

Dustin M. Mizell, MLA RLA #6666784
Dustin@environmentdesigngroup.com

/HEETL11.1