

Existing West Buffer



Existing West Buffer



Existing South Buffer



Existing South Buffer



Existing South Buffer



Existing South Buffer

ARC -23-026 ZON -23-034 Existing Site Photos

DE/IG/I Landscape Architecture Land Planning Landscape Management Dustin M. Mizell, MLA RLA #6666784 Dustin@environmentdesigngroup.com

JOB NUMBER: # 22250.00 LA
DRAWN BY: Adam Mills
DATE: 01.05.2023
01.23.2023

✓HEET L1.0

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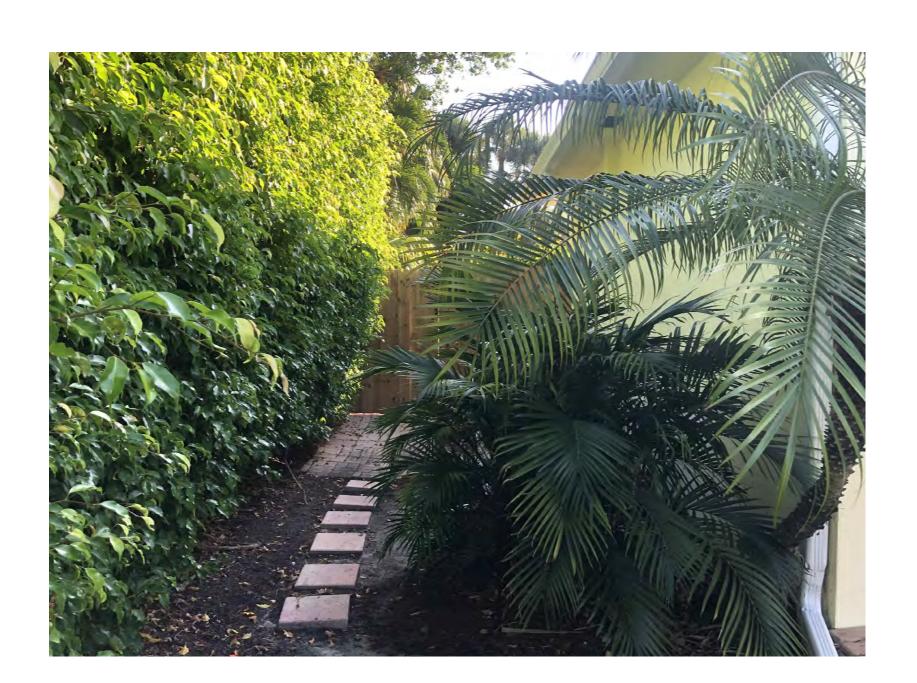
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DISCLAIMER:

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48 HOURS BEFORE DIGGING
CALL TOLL FREE
1-800-432-4770



Existing East Buffer




Existing Morth Buffer




Existing Pool Area



Existing Pool Area

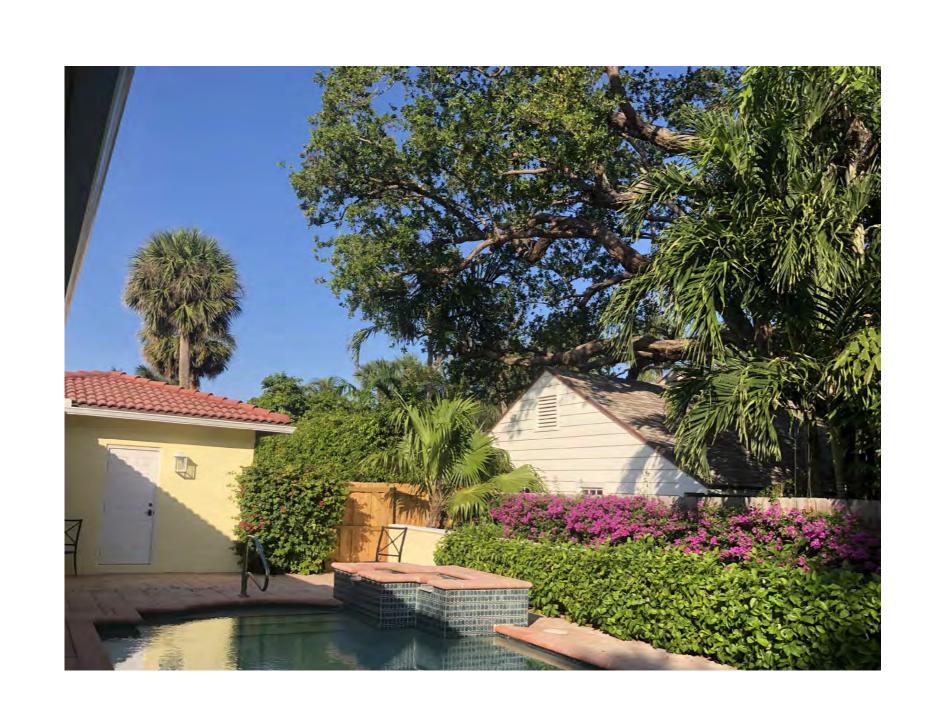


Existing Pool Area

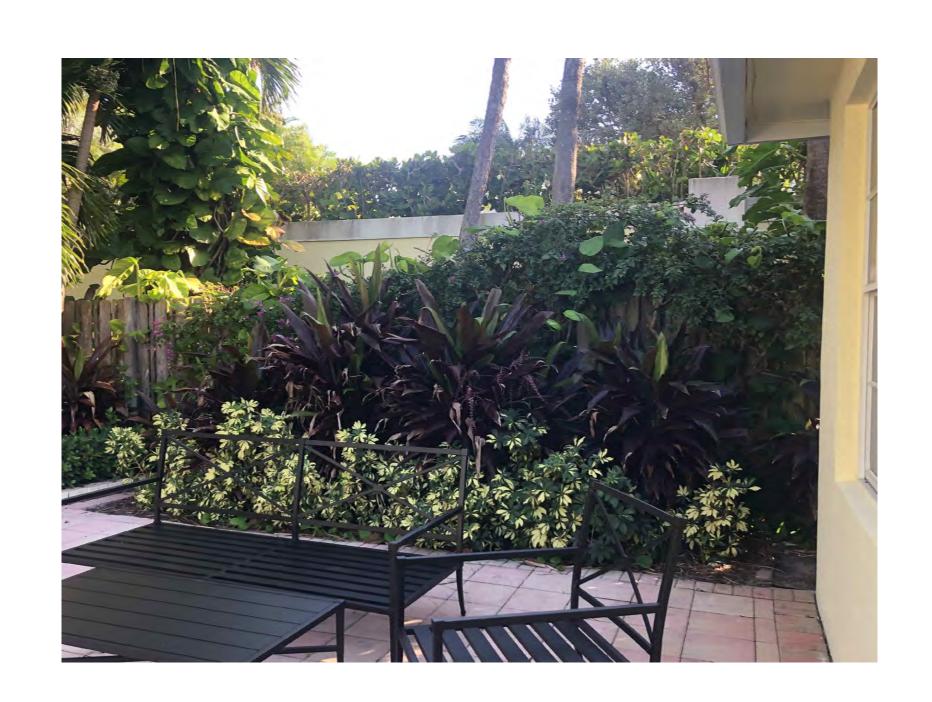

Existing East Buffer

ARC -23-026 ZON -23-034 Existing site Photos

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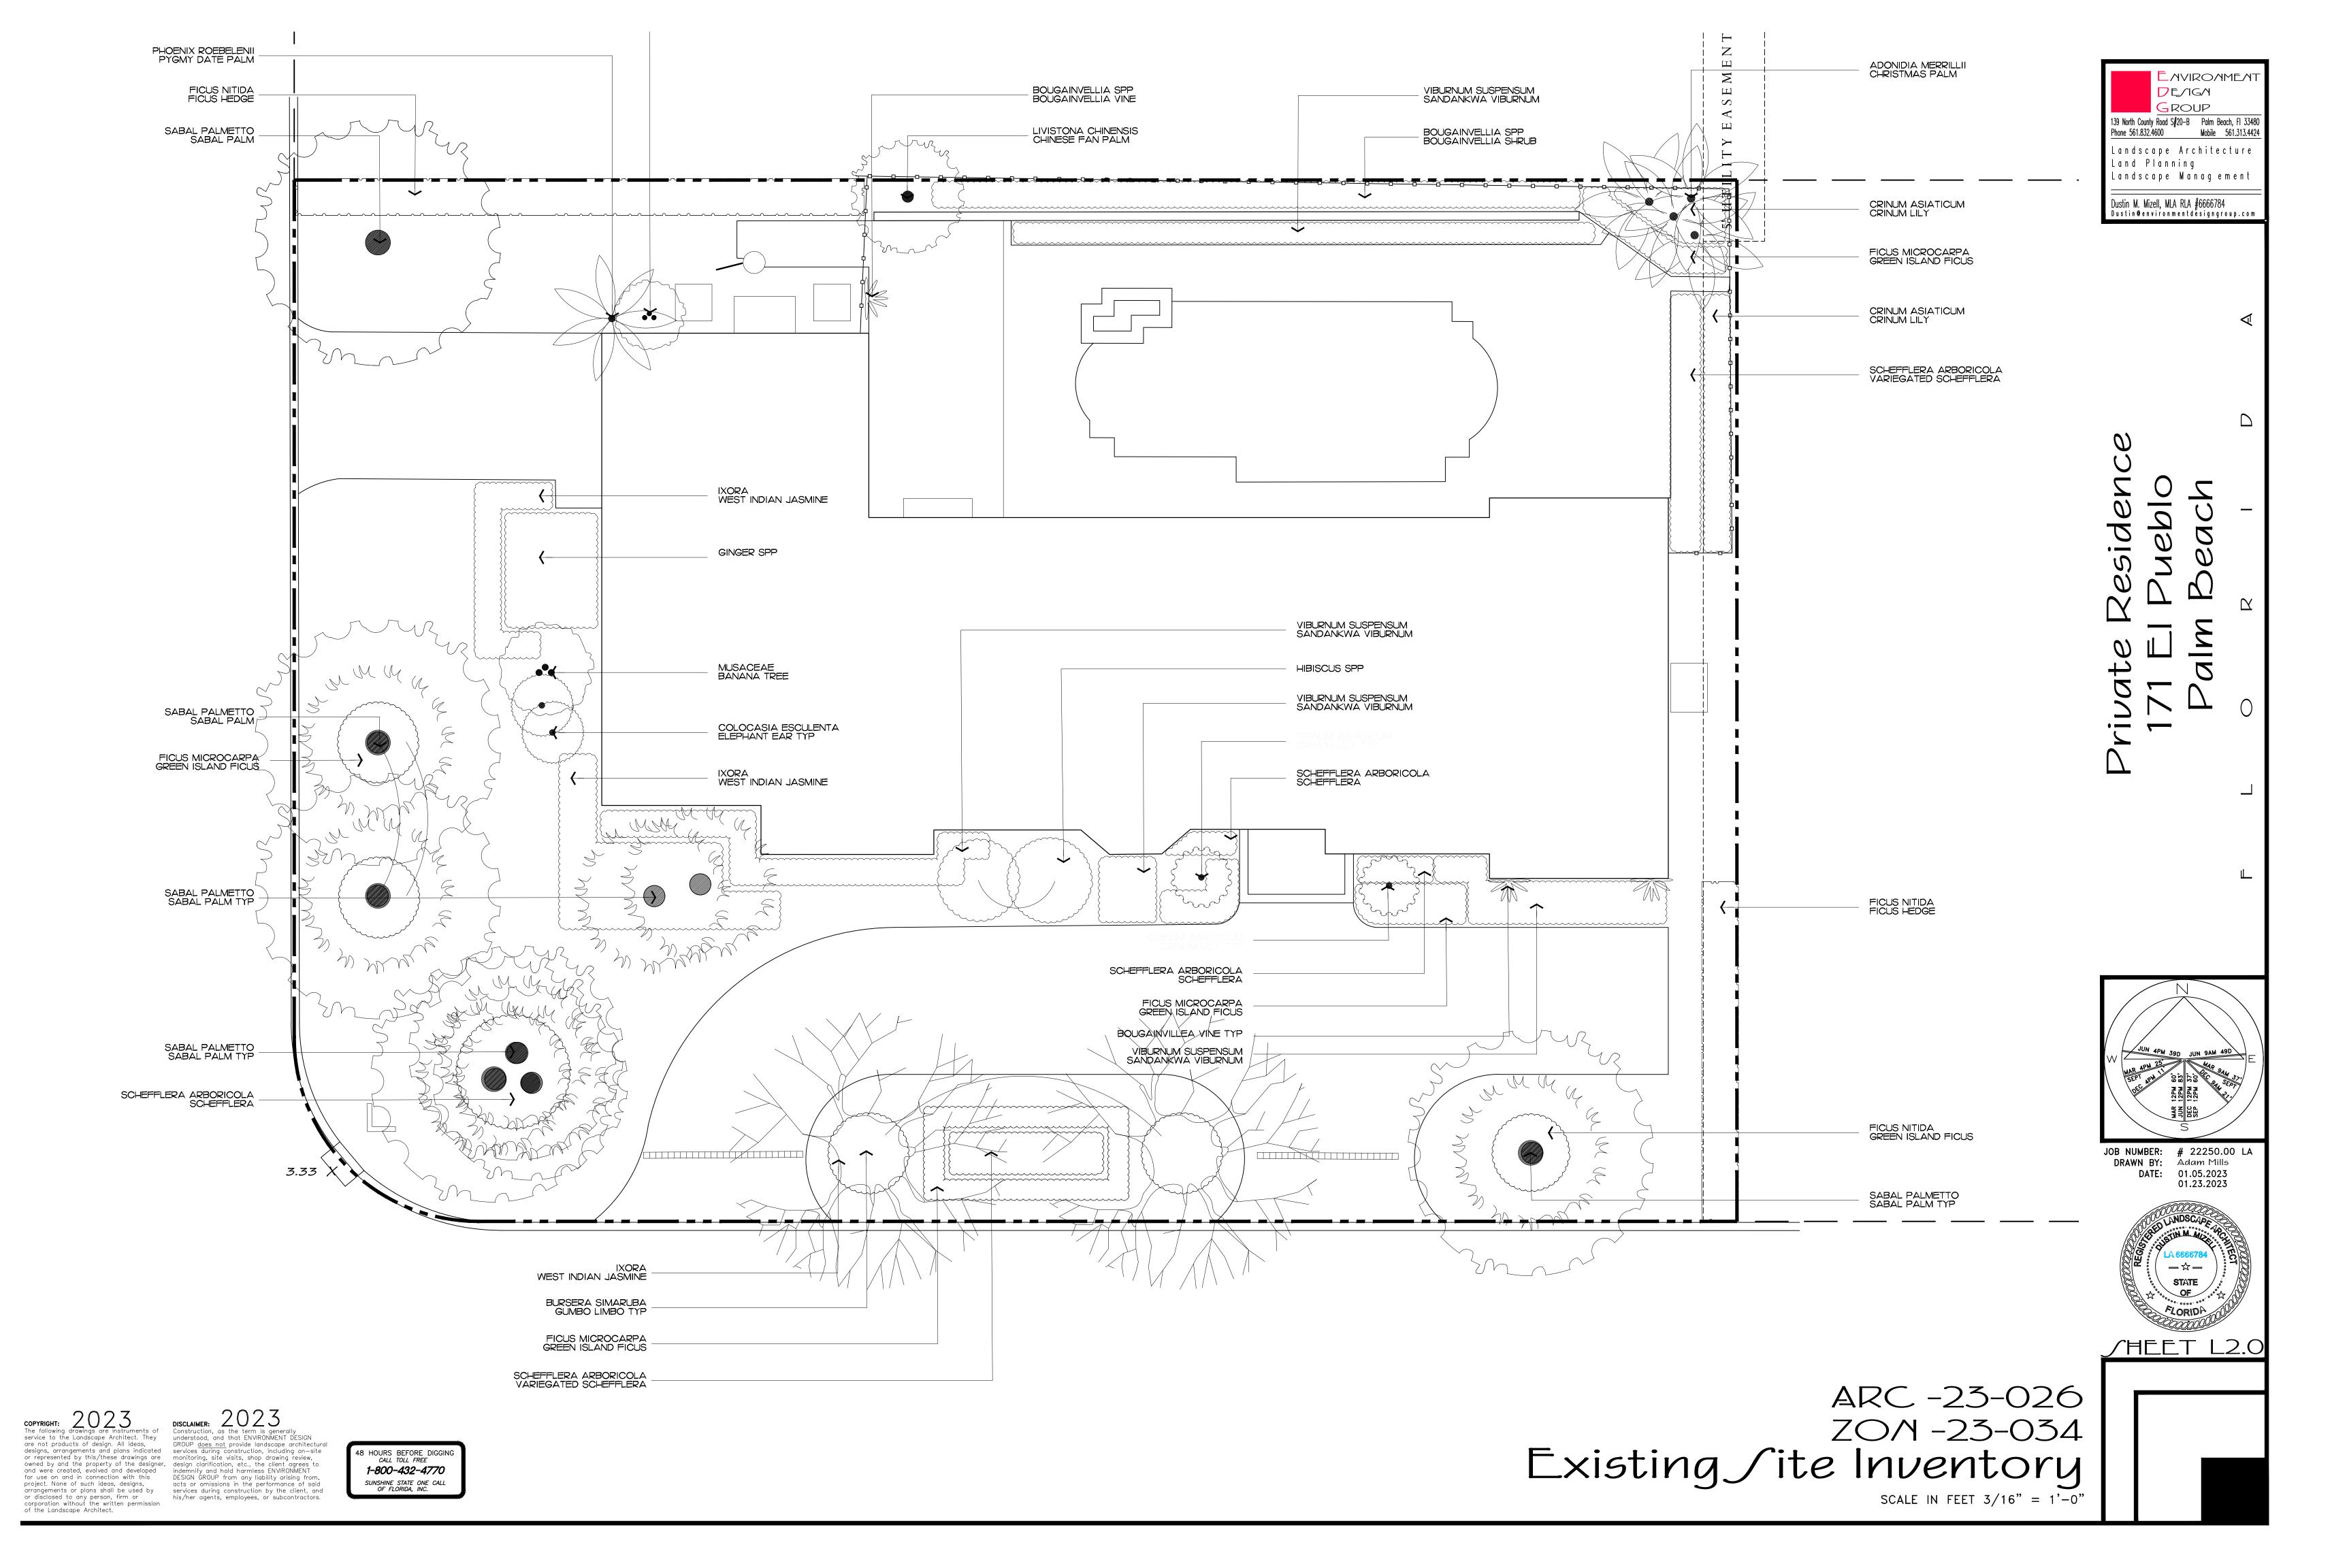
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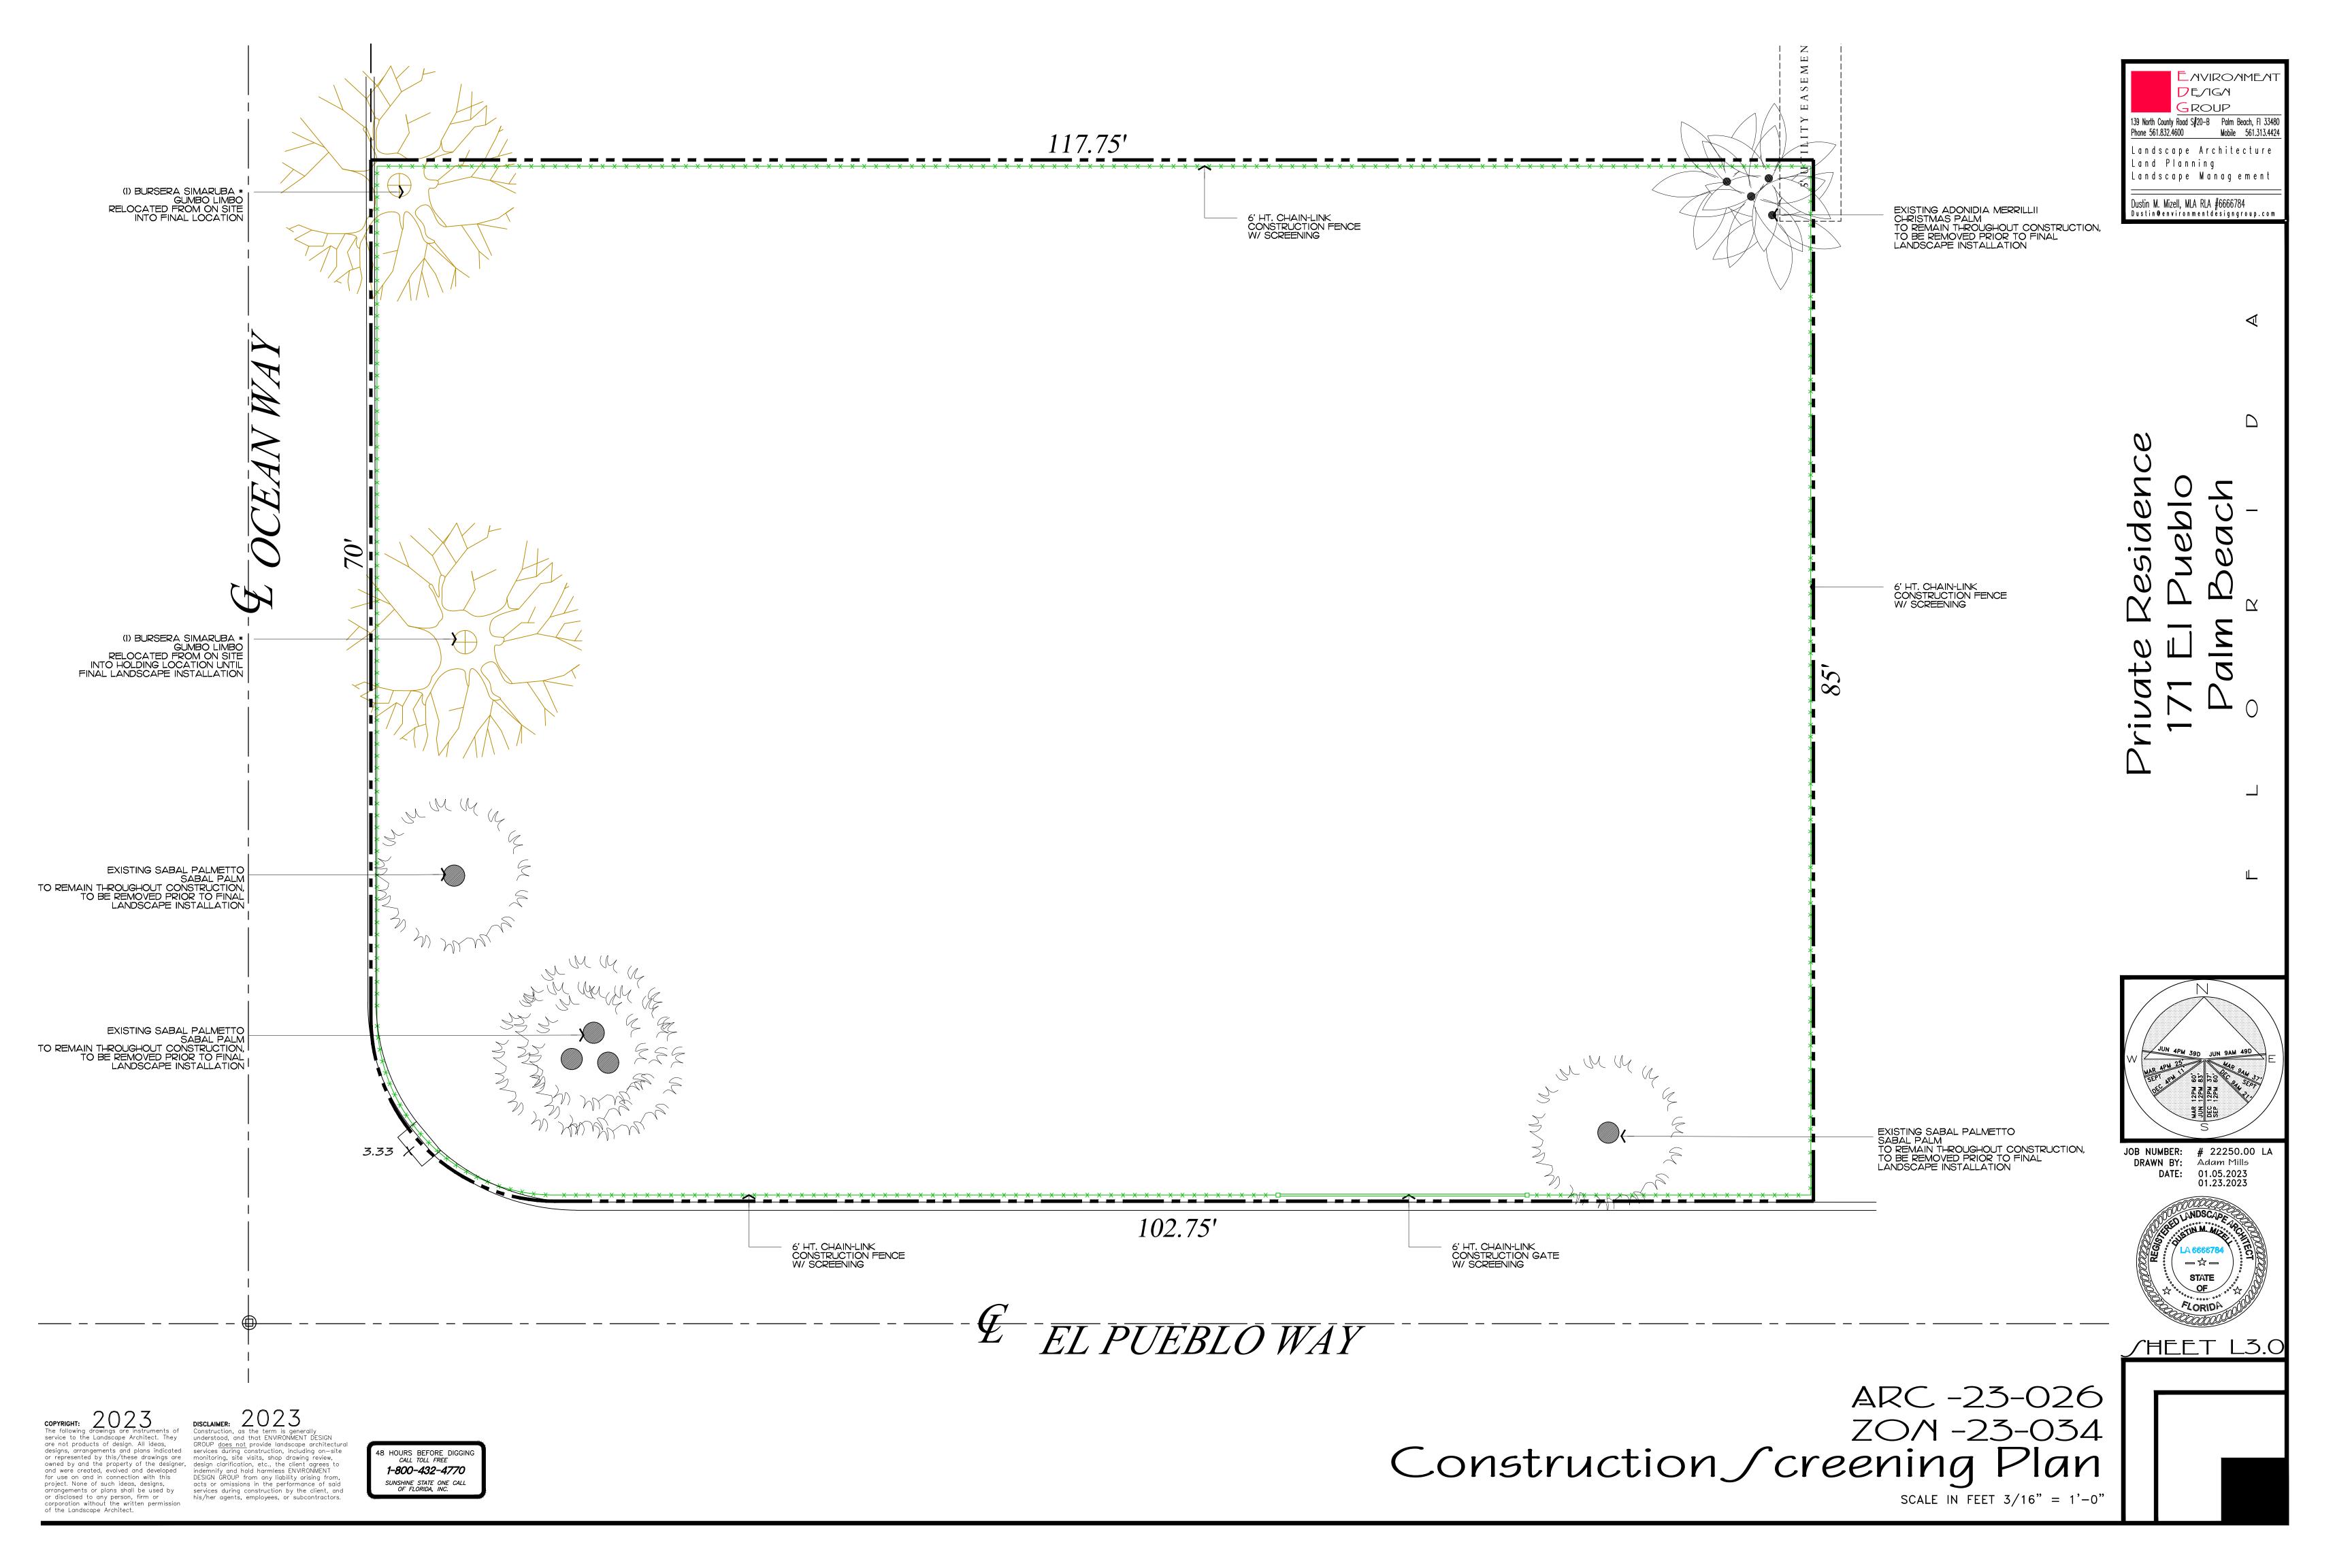
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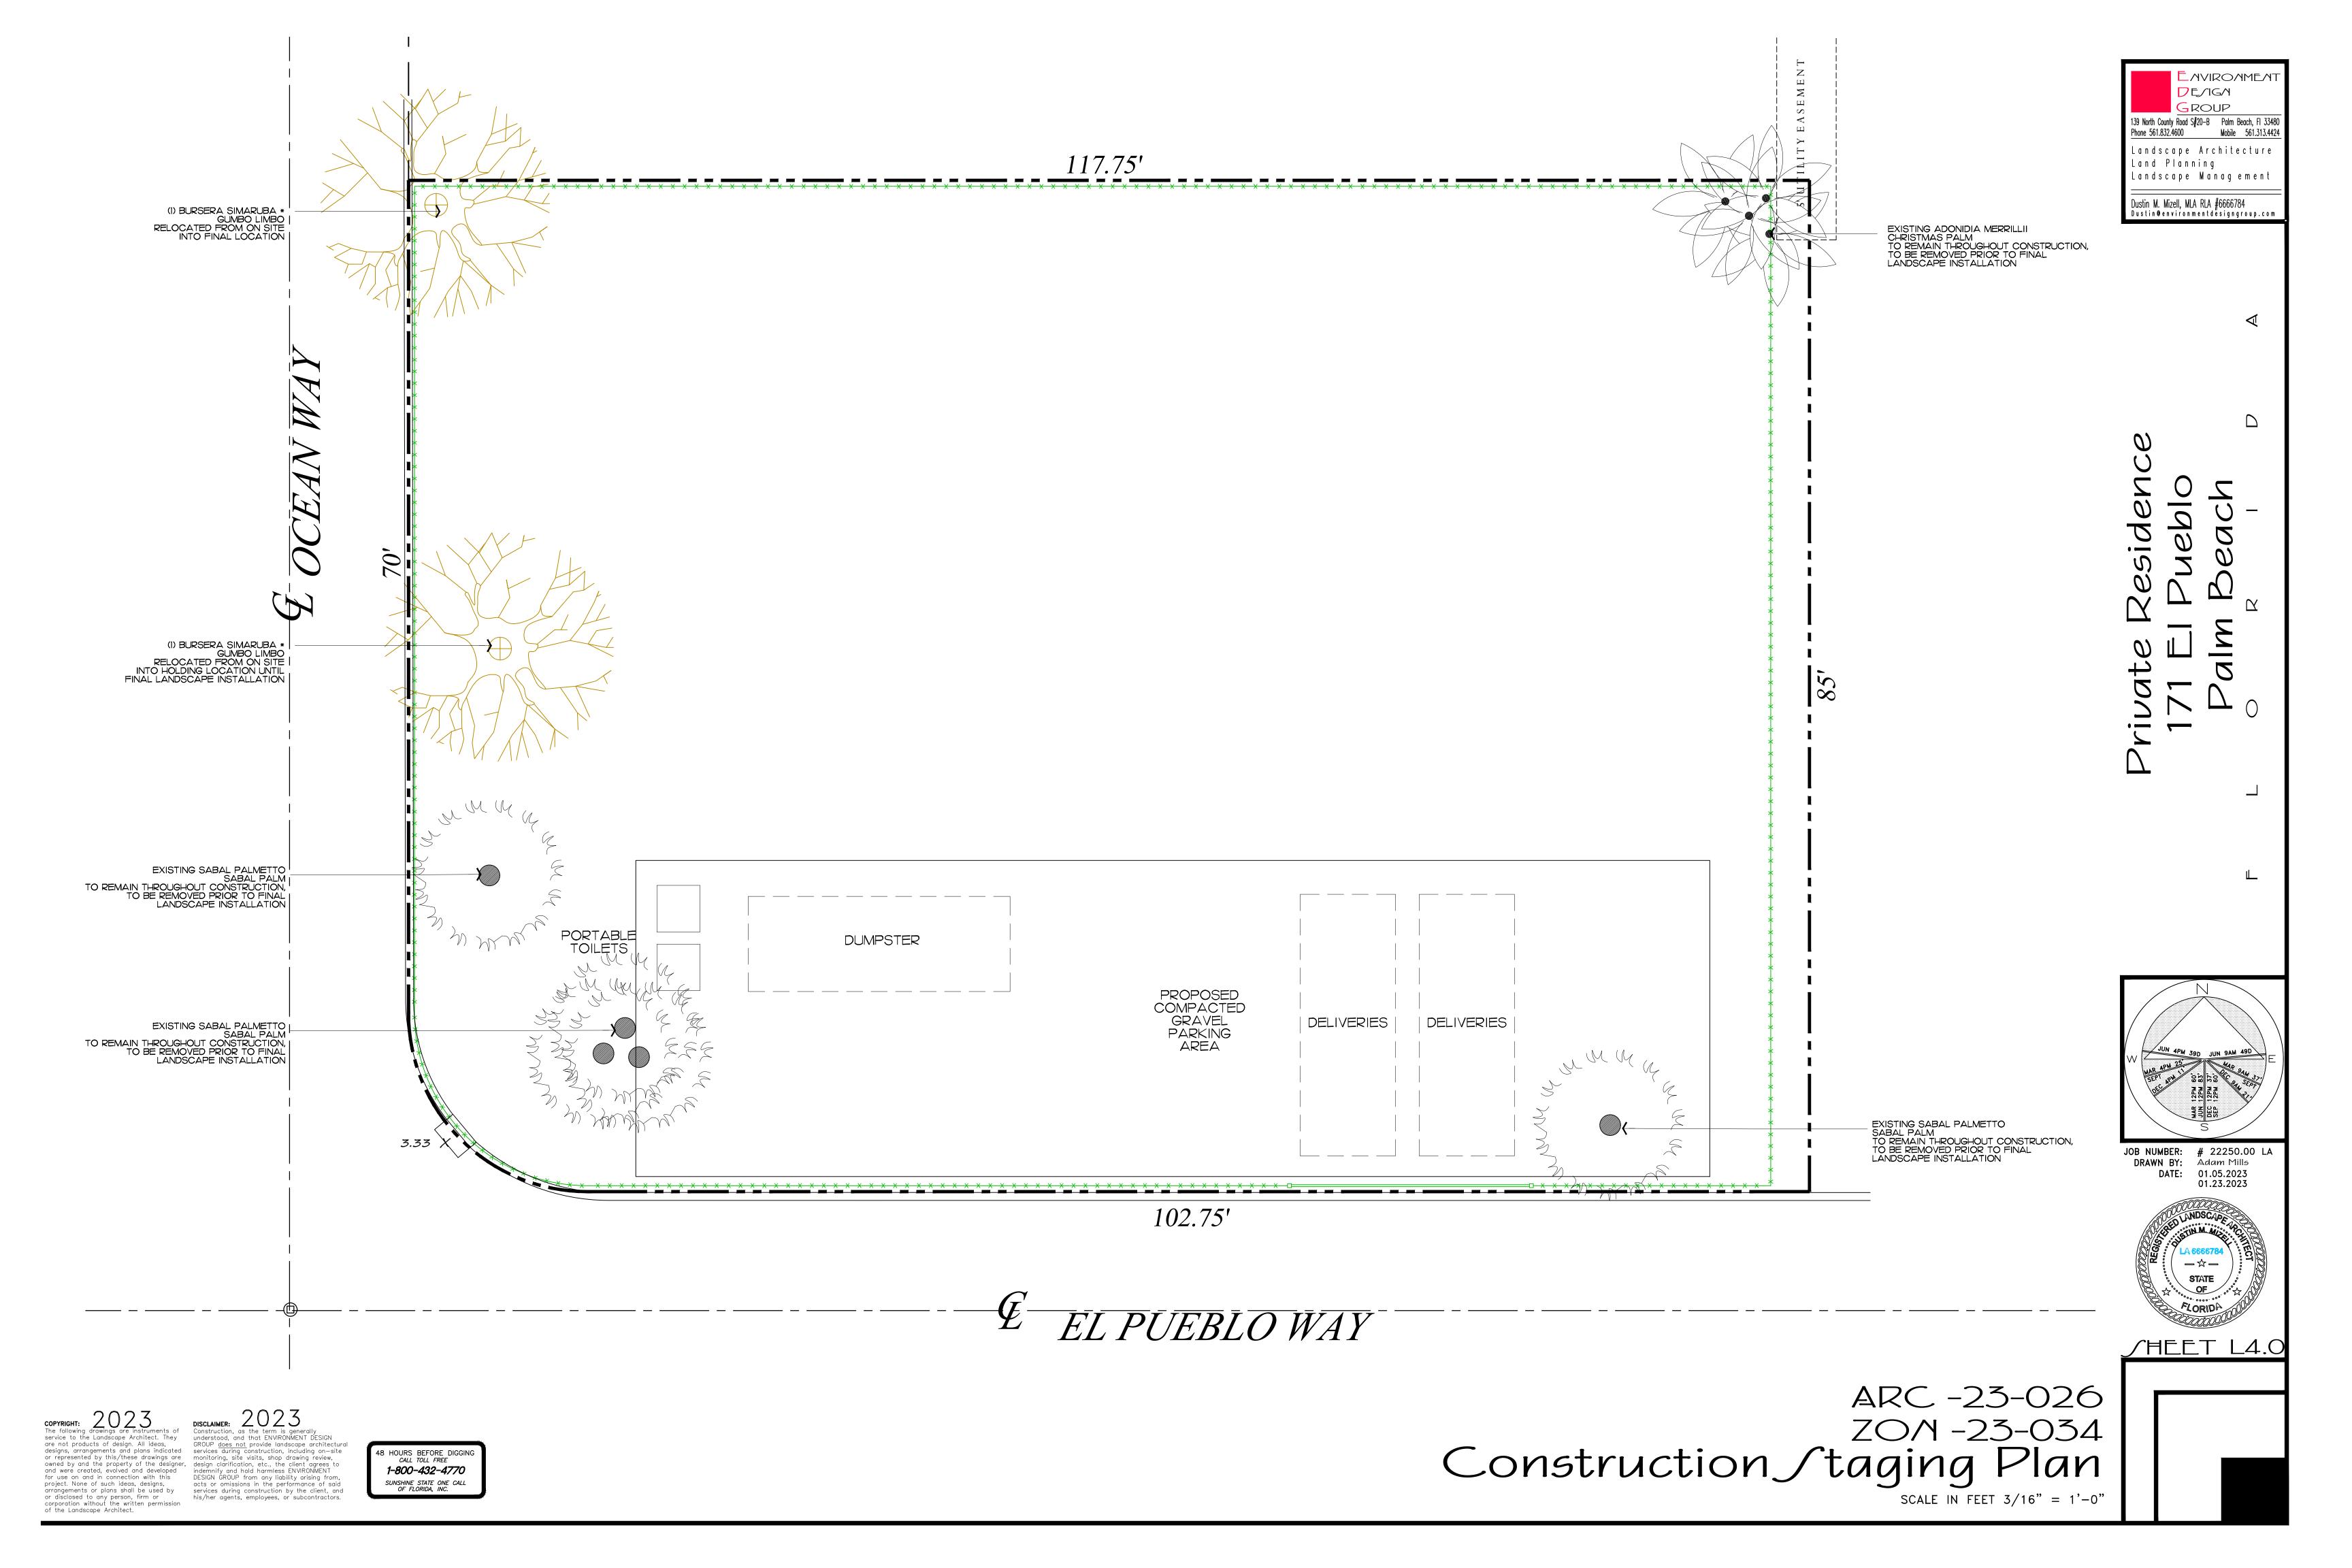
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JOB NUMBER: # 22250.00 LA
DRAWN BY: Mick Pastor
DATE: 01.05.2023
01.23.2023

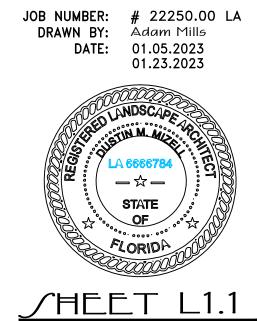

ARC -23-026 ZON -23-034 Truck Logistics Plan SCALE: NOT TO SCALE



SCHEDULE:

MONTH 1: DEMOLITION AND CLEANUP (3 - 5 DAYS)

LARGEST TRUCK ->

10-15 DUMP TRUCKS FOR DEBRIS REMOVAL TRAILER FOR EXCAVATOR / DEMOLITION LANDSCAPE TRUCKS -> SOD


IRRIGATION

NOTE: SEE SEPARATE "CONSTRUCTION STAGING PLAN" SHEET FOR INFORMATION ON LOCATIONS FOR PARKING, MATERIAL STORAGE, DELIVERIES, DUMPSTER, PORTABLE TOILETS, TIRE CLEANING AREA, SILT FENCE, ETC.

PROPOSED INGRESS TRUCK ROUTE

PROPOSED EGRESS TRUCK ROUTE

	CONCEPTUAL	CONSTRUCTION SCHEDULE
•	FEB 22TH 2023 - MAR 15TH 2023 - JUN-JULY 2023 -	TOWN COUNCIL
•	2 MONTHS 1.5 MONTHS 2.5 MONTHS POURS 1 MONTH 1.5 MONTHS .5 MONTH 1.5 MONTHS 2 MONTHS 5 MONTHS 6 MONTHS	- MOBILIZATION & DEMOLITION OF EXISTING STRUCTURES - SITE/BUILDING PREPARATION - FOUNDATION - BLOCK DELIVERIES & CONC. - ROOF TRUSS DELIVERY AND SET TRUSSES - WINDOW/DOOR DELIVERIES AN INSTALLATION - DRY-IN - INTERIOR FRAMING - ROUGH-IN - DRY WALL - FINISHES
	2 MONTHS 2 MONTHS	LANDSCAPE & HARDSCAPEINSTALLATIONFINAL INSPECTIONS
•	+/-24 MONTHS	 PROPOSED TOTAL CONSTRUCTION FOLLOWING BUILDING PERMIT

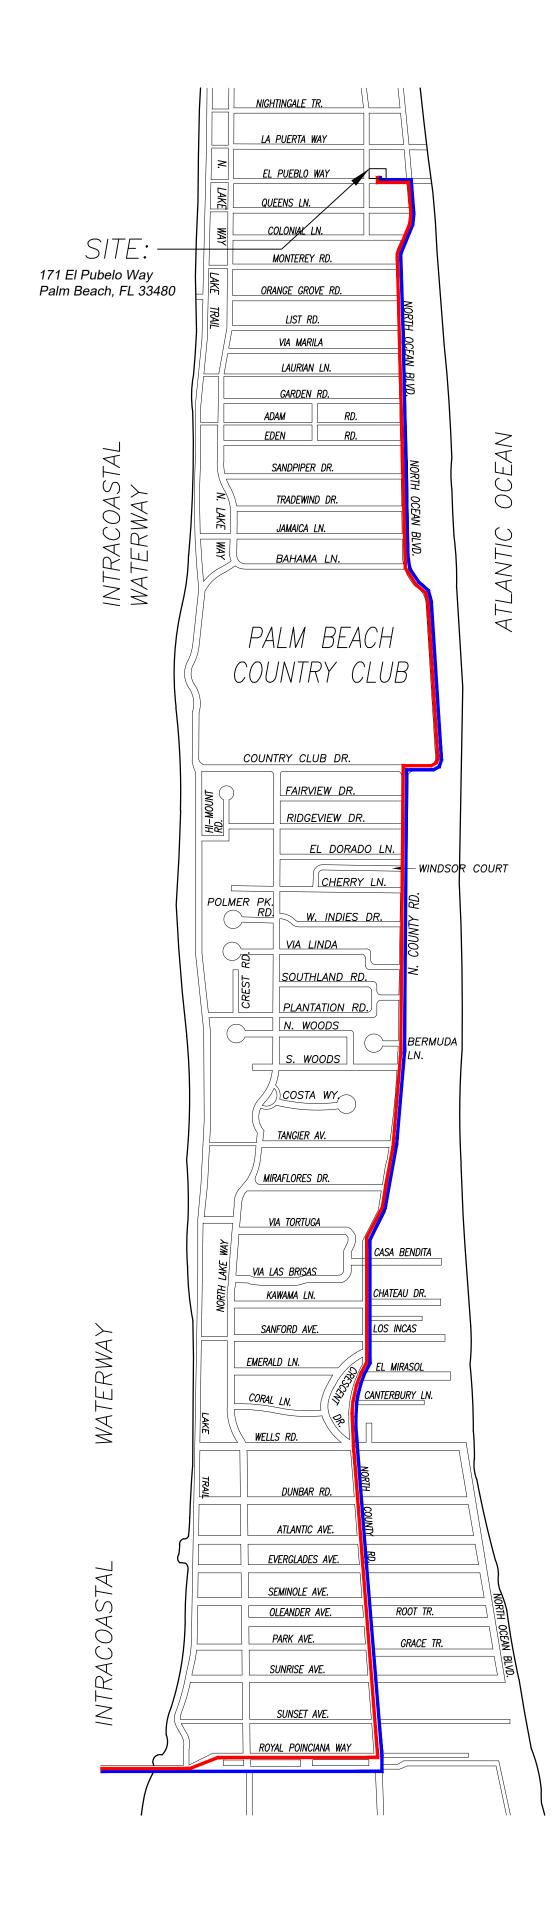


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services during construction by the client, and his/her agents, employees, or subcontractors.

48 HOURS BEFORE DIGGING
CALL TOLL FREE 1-800-432-4770 SUNSHINE STATE ONE CALL OF FLORIDA, INC.



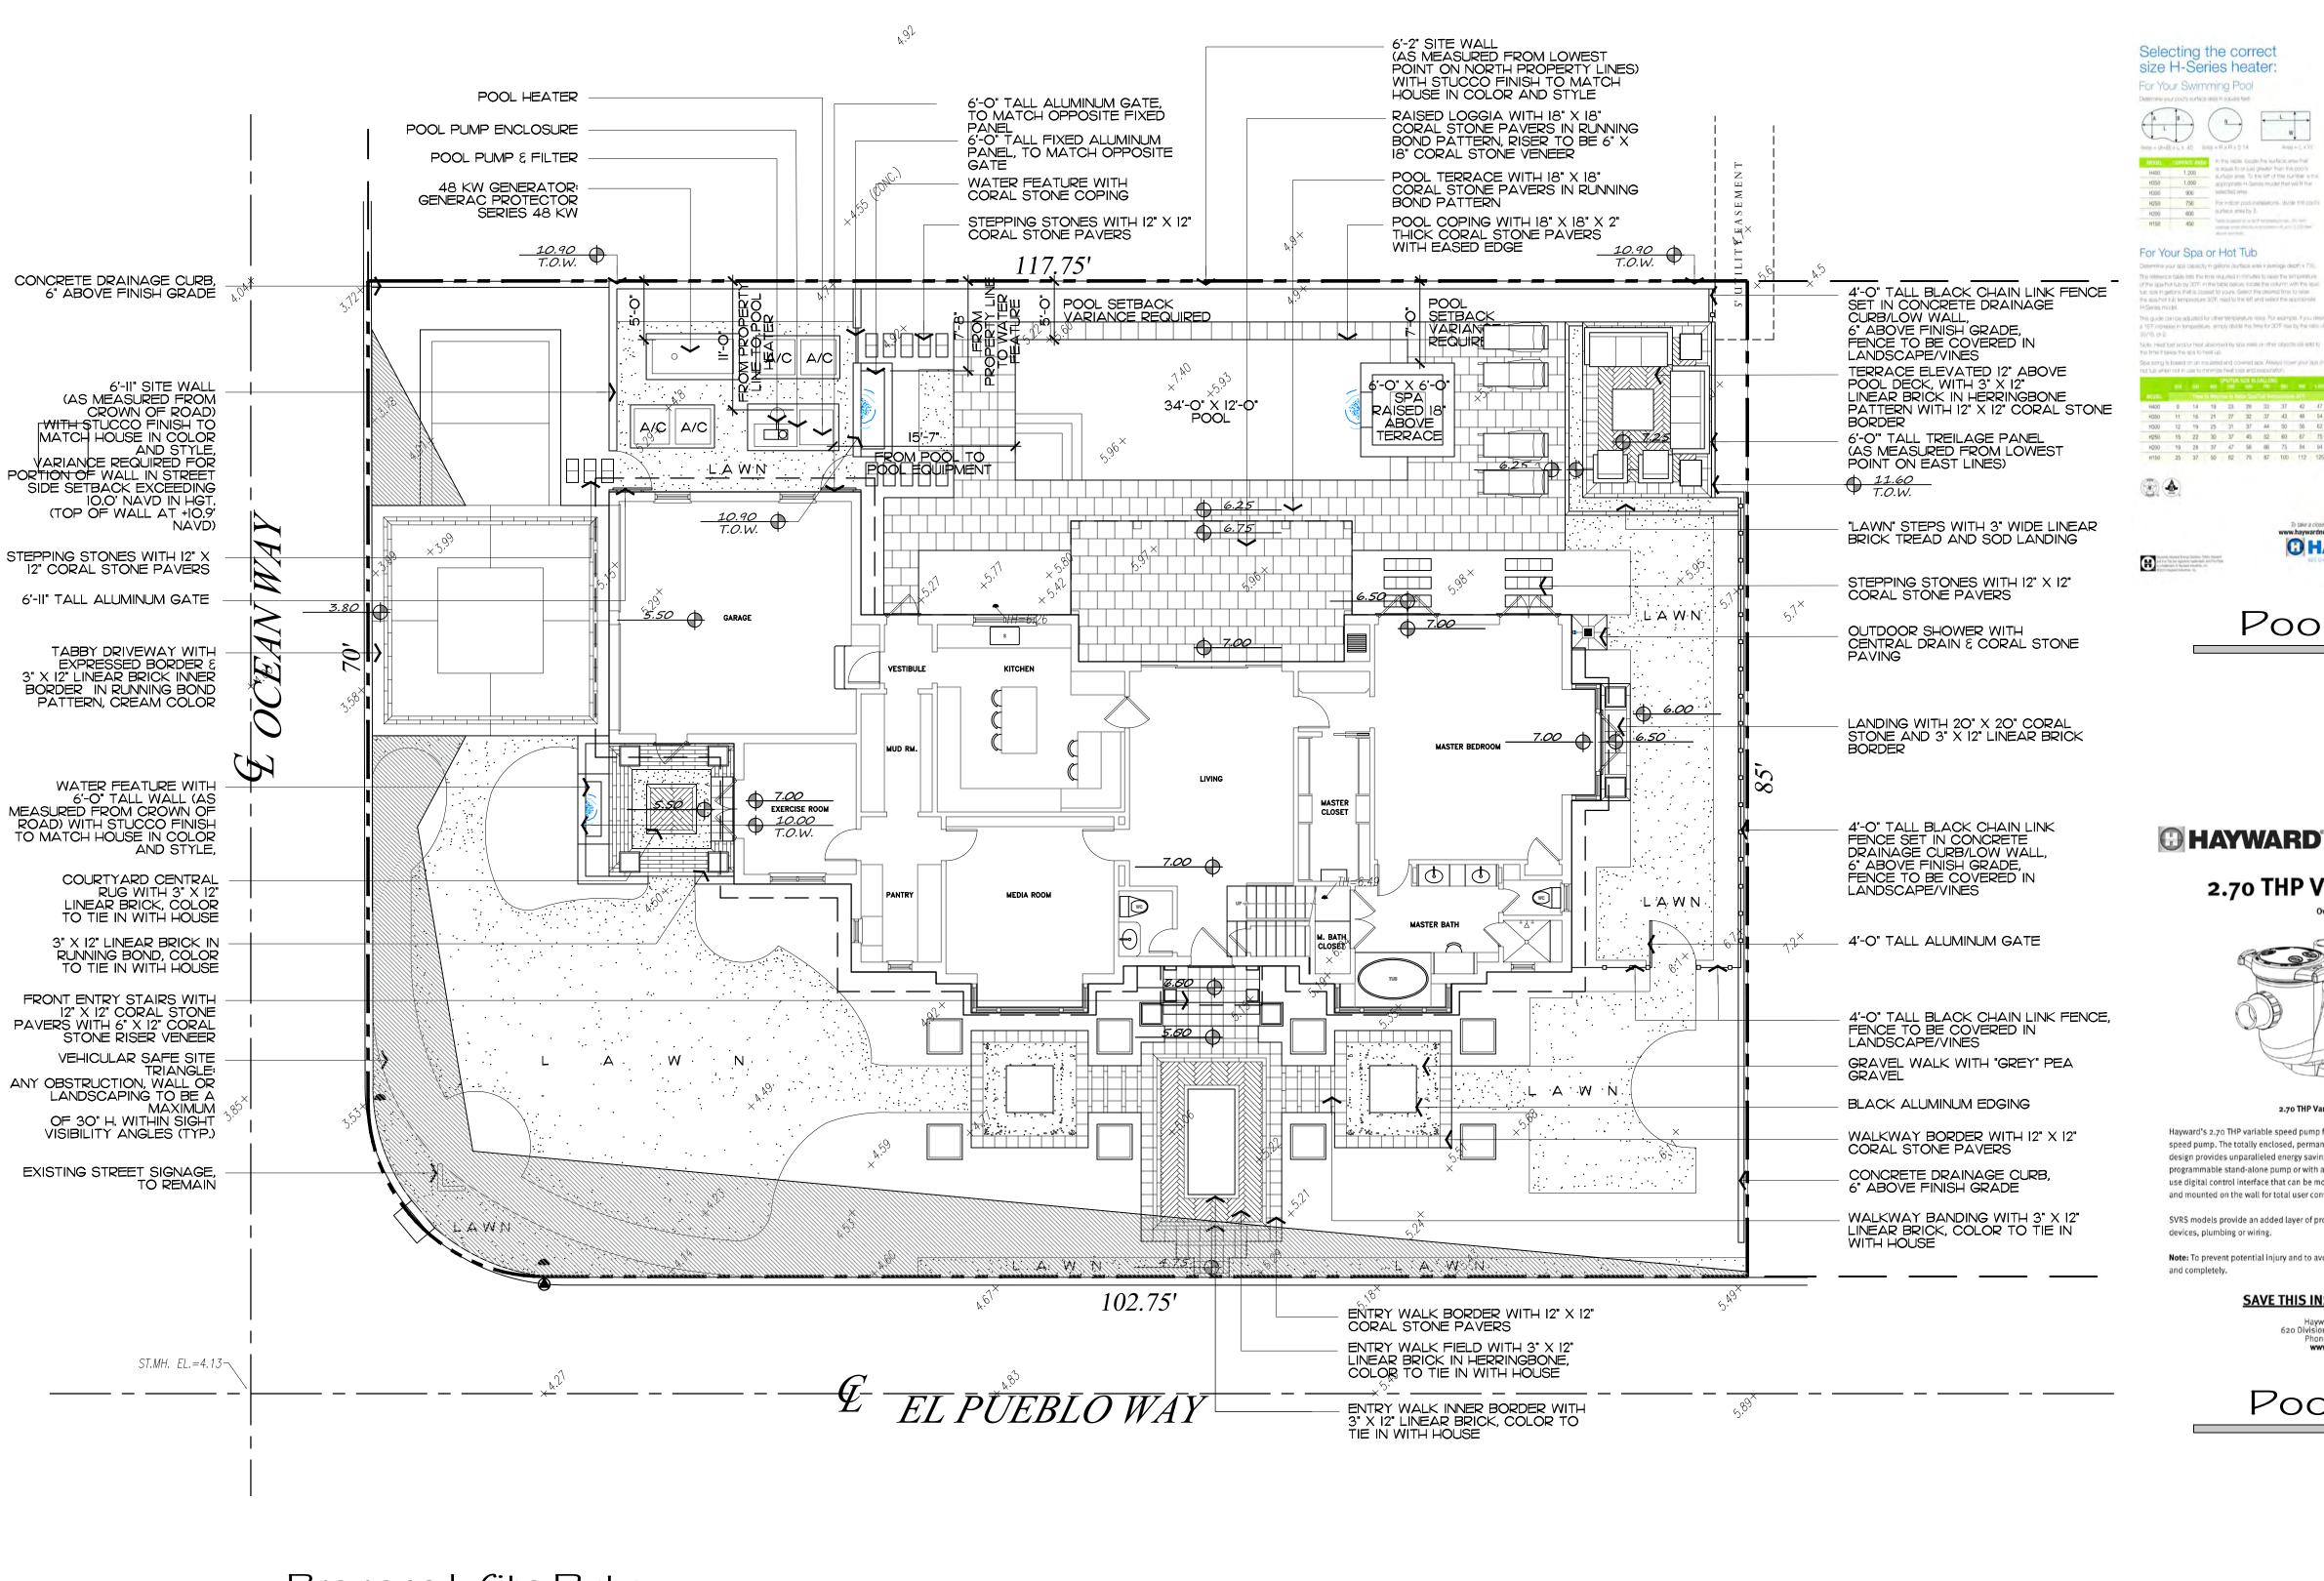

Pool Heater

Pool Pump



Pool Filter

www.haywardnet.com



JOB NUMBER: # 22250.00 LA DRAWN BY: Adam Mills

MEET L6.

01.05.2023 01.23.2023 02.07.2023

DE/IG/I

139 North County Road S#20-B Palm Beach, FI 33481

Phone 561.832.4600 Mobile 561.313.4424


Landscape Architecture

🛮 Landscape Management

Dustin M. Mizell, MLA RLA #6666784
Dustin@environmentdesigngroup.com


Land Planning


ROUP

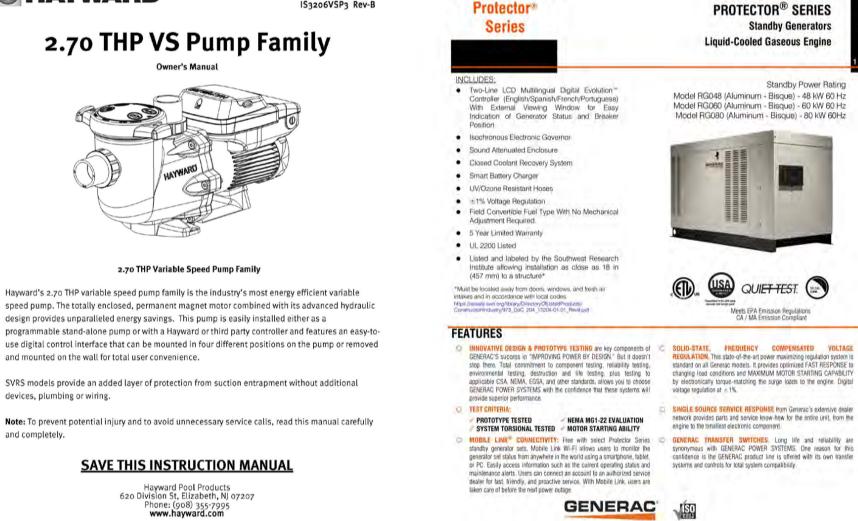

Generator

Pool Pump Enclosure

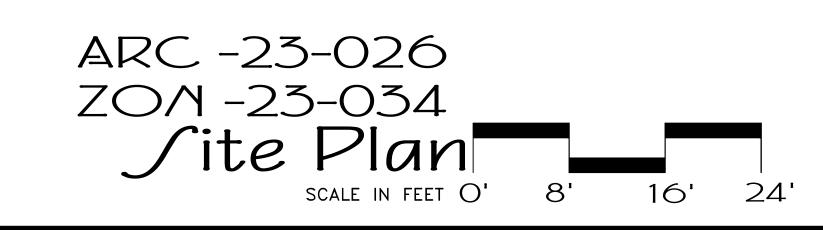

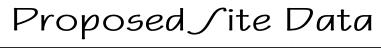

DESCRIPTION	REQUIR	ED	EXISTING PROPOSED			OPOSED
LOT ZONE				R-B - LOW DENS	ITY RESIDENTIAL	
LOT AREA				9960.4	16 S.F.	
OPEN / PERMEABLE SPACE	MINIMUM 45%	4,482.21 S.F.	40.51%	4,035 S.F.	45.36%	4,519 S.F.
FRONT YARD LANDSCAPE	MINIMUM 40% OF FRONT YARD	1,000 S.F.	54.92%	1,590 S.F.	49%	1,038 S.F.
PERIMETER LANDSCAPE WITHIN 10' OF PROPERTY LINE	MINIMUM 50% OF REQ'D OPEN SPACE	2,241 S.F.	68.88%	2,488 S.F.	50.08%	2,245 S.F.

PROPOSED IMPROVEMENTS

I. NEW HARDSCAPE
2. NEW LANDSCAPE
3. NEW POOL & SPA
4. POOL VARIANCE
5. PROPOSED GENERATOR

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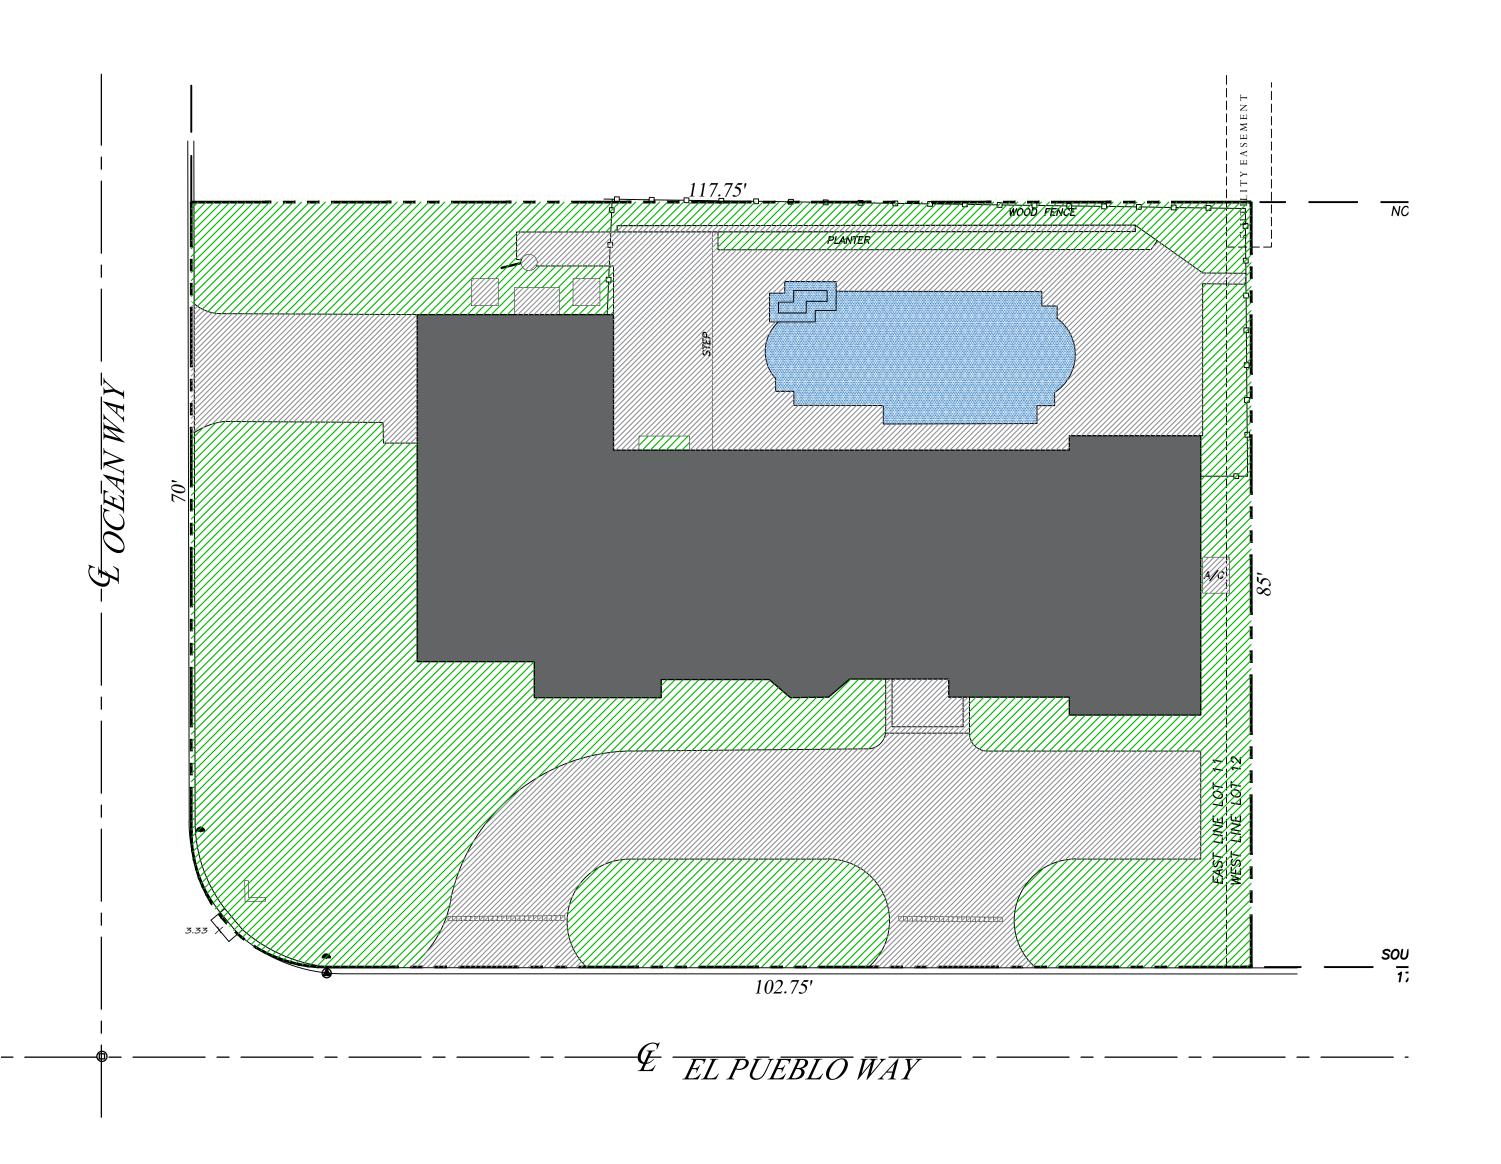
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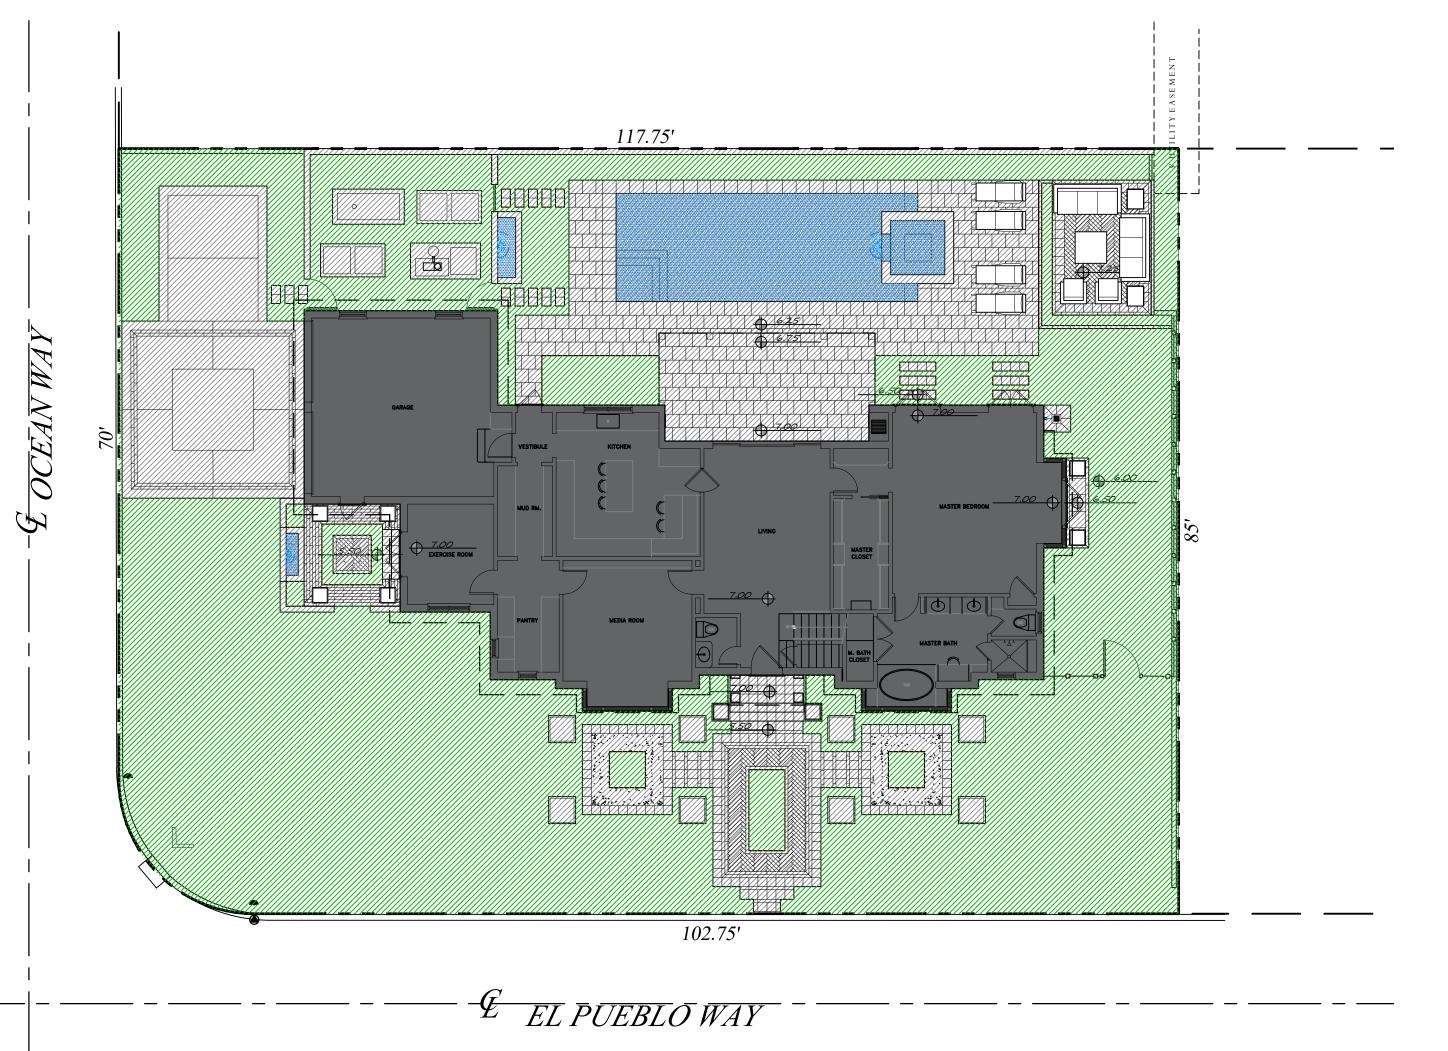
Legend IMPERVIOUS AREA (HOUSE/STRUCTURE) IMPERVIOUS AREA (HARDSCAPE) PERVIOUS AREA / OPEN SPACE



/HEET L6.1

ARC -23-026





Existing Lot Coverage Graphic

Proposed Lot Coverage Graphic

Proposed Site Data

DESCRIPTION	REQUIRE	ED	EX	ISTING	PR	OPOSED
LOT ZONE				R-B - LOW DENS	ITY RESIDENTIAL	
LOT AREA				9960.4	46 S.F.	
OPEN / PERMEABLE SPACE	MINIMUM 45%	4,482.21 S.F.	40.51%	4,035 S.F.	45.36%	4,519 S.F.
FRONT YARD LANDSCAPE	MINIMUM 40% OF FRONT YARD	1,000 S.F.	54.92%	1,590 S.F.	49%	1,038 S.F.
PERIMETER LANDSCAPE WITHIN 10' OF PROPERTY LINE	MINIMUM 50% OF REQ'D OPEN SPACE	2,241 S.F.	68.88%	2,488 S.F.	50.08%	2,245 S.F.

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48 HOURS BEFORE DIGGING CALL TOLL FREE 1-800-432-4770

ZON-23-034 Site Calculation/Lot Coverage Graphics



Driveway

TABBY FINISH AND EXPRESSED BORDER



Entry Walk/Banding Accents/Raised Terrace

3 X 12 LINEAR BRICK



Entry Walk/Pool Terrace/Loggia/Raised Terrace

12 X 12 PAVERS 18 X 18 PAVERS



Raised Terrace Steps

3" WIDE LINEAR BRICK AS RISER/TREAD WITH SOD LANDING





Entry Garden Paving

GREY GRAVEL FOR ENTRY PARTERRE GARDENS



Pottery

FORMAL PLANTER FOR CALAMONDIN TREES AND TOPIARY SPHERES

> ARC -23-026 ZON-23-034 Hardscape Images



JOB NUMBER: # 22250.00 LA
DRAWN BY: Adam Mills
DATE: 01.23.2023



/HEET L6.2

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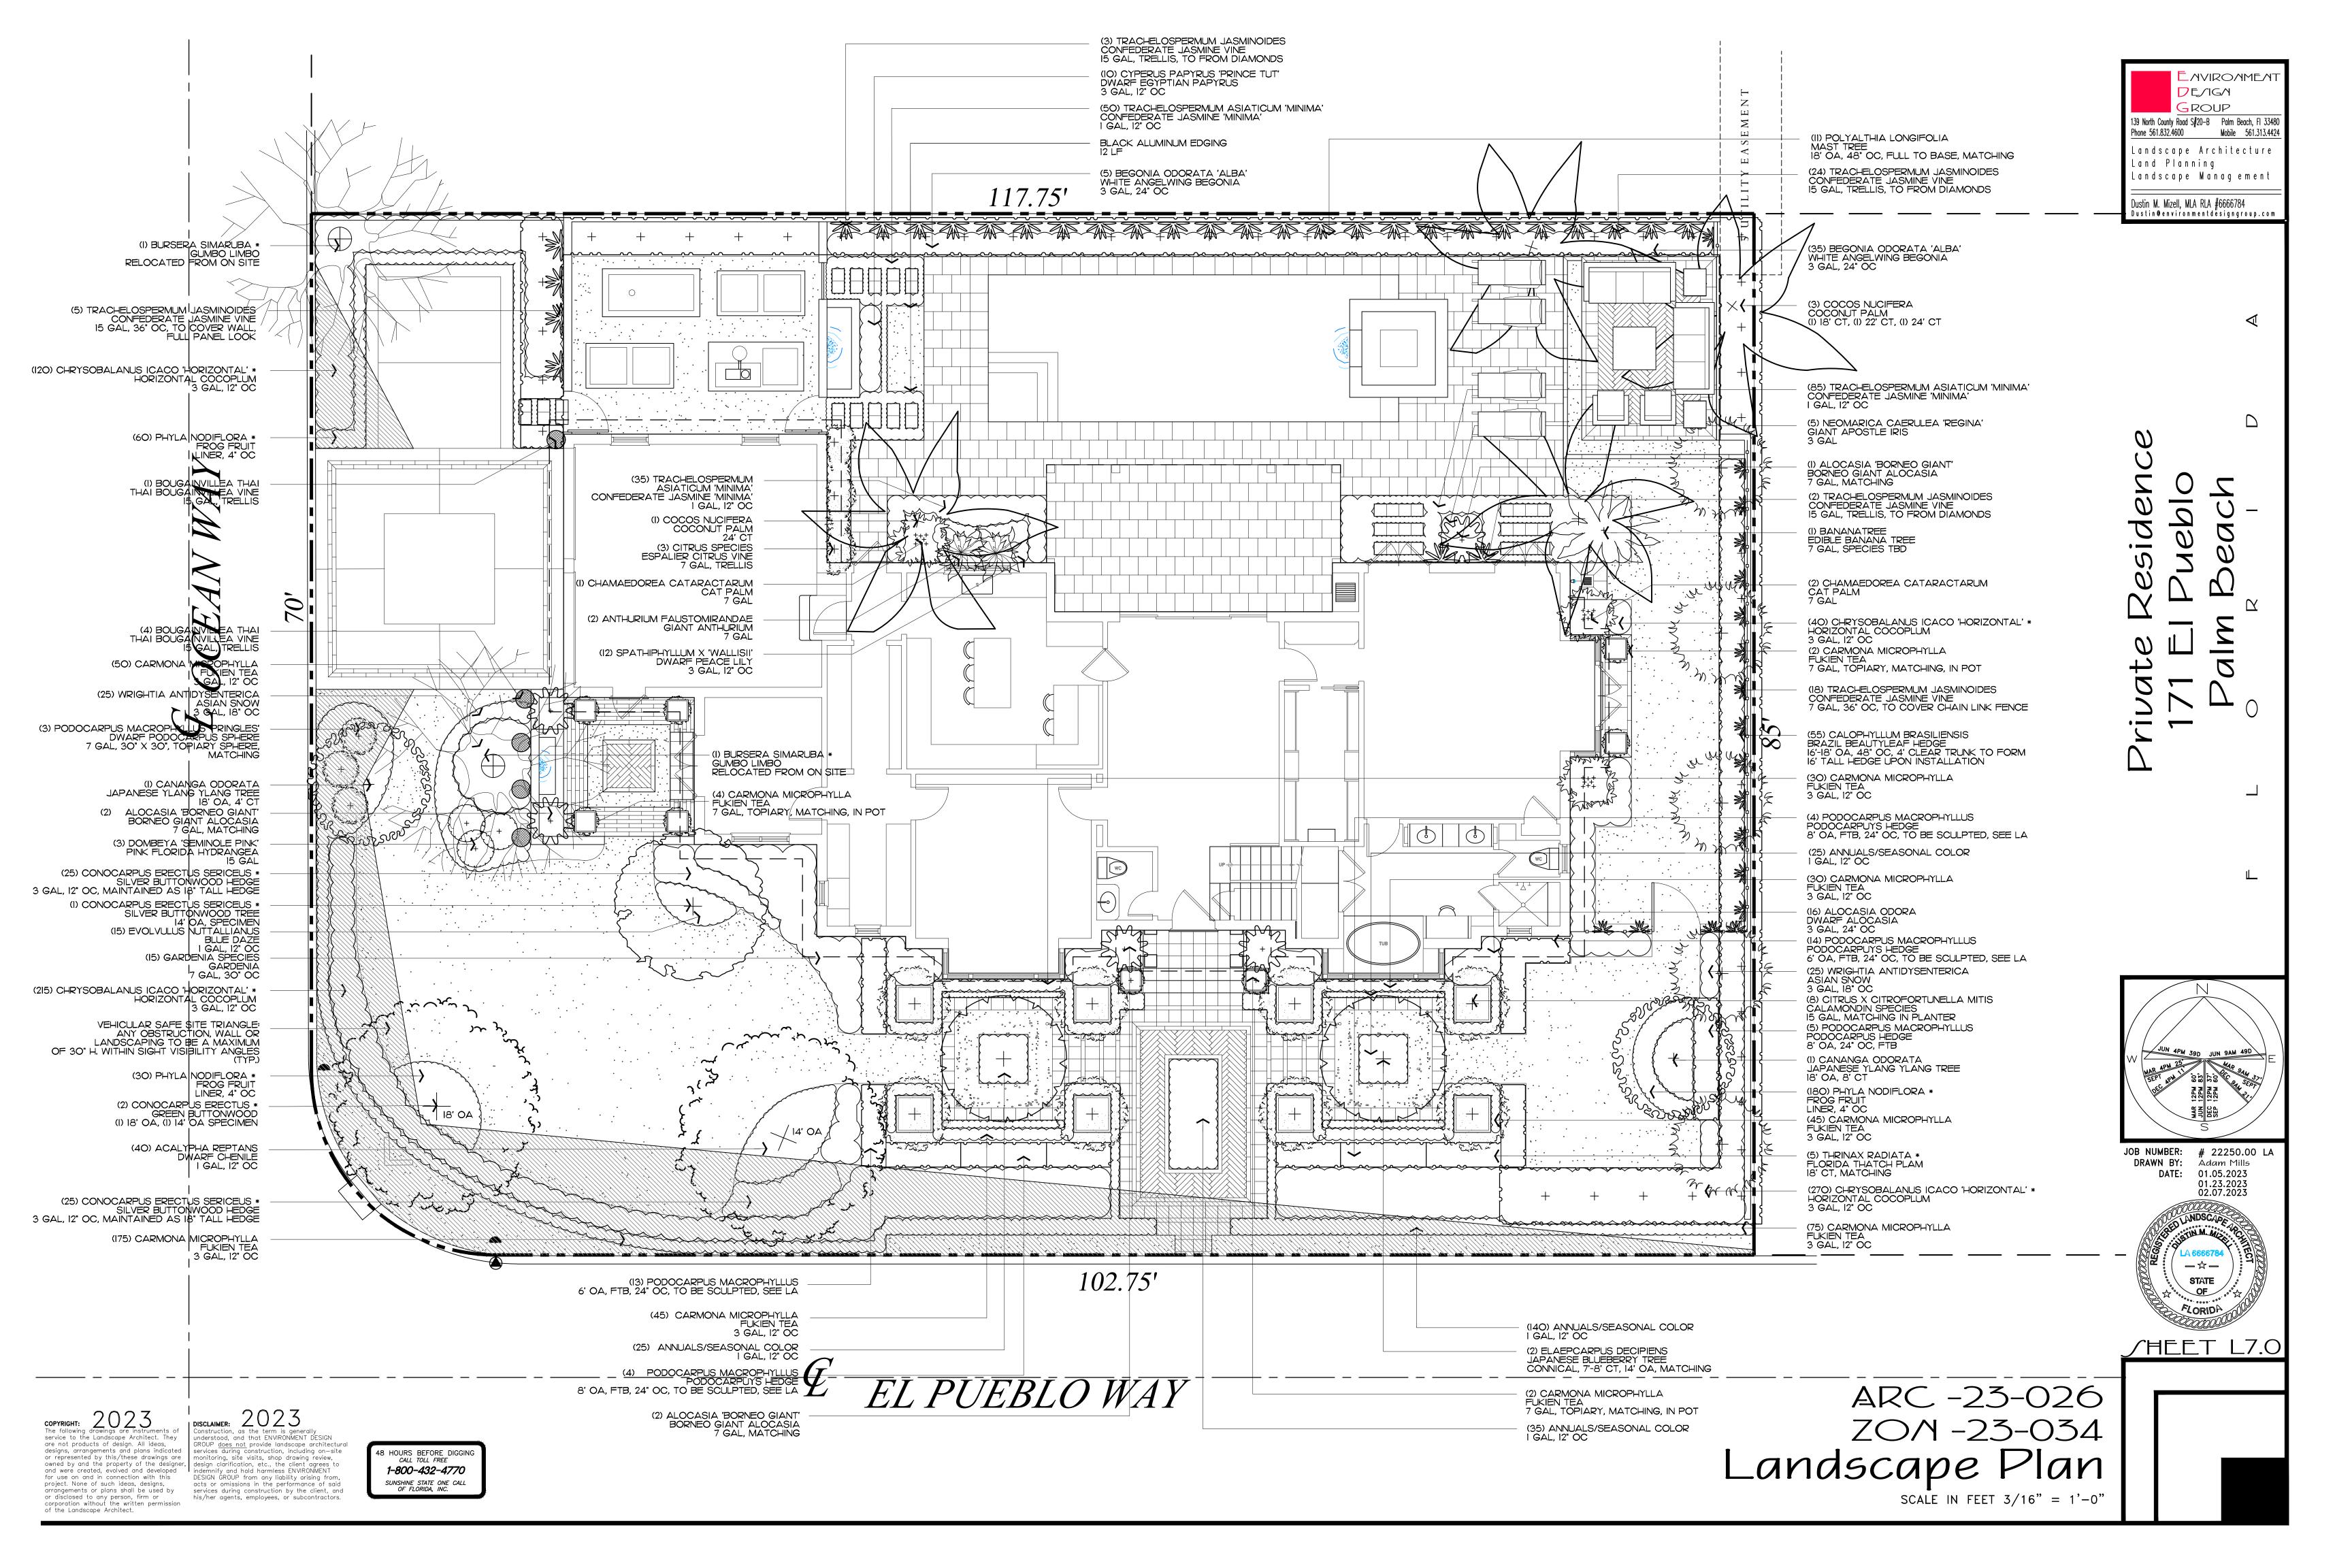
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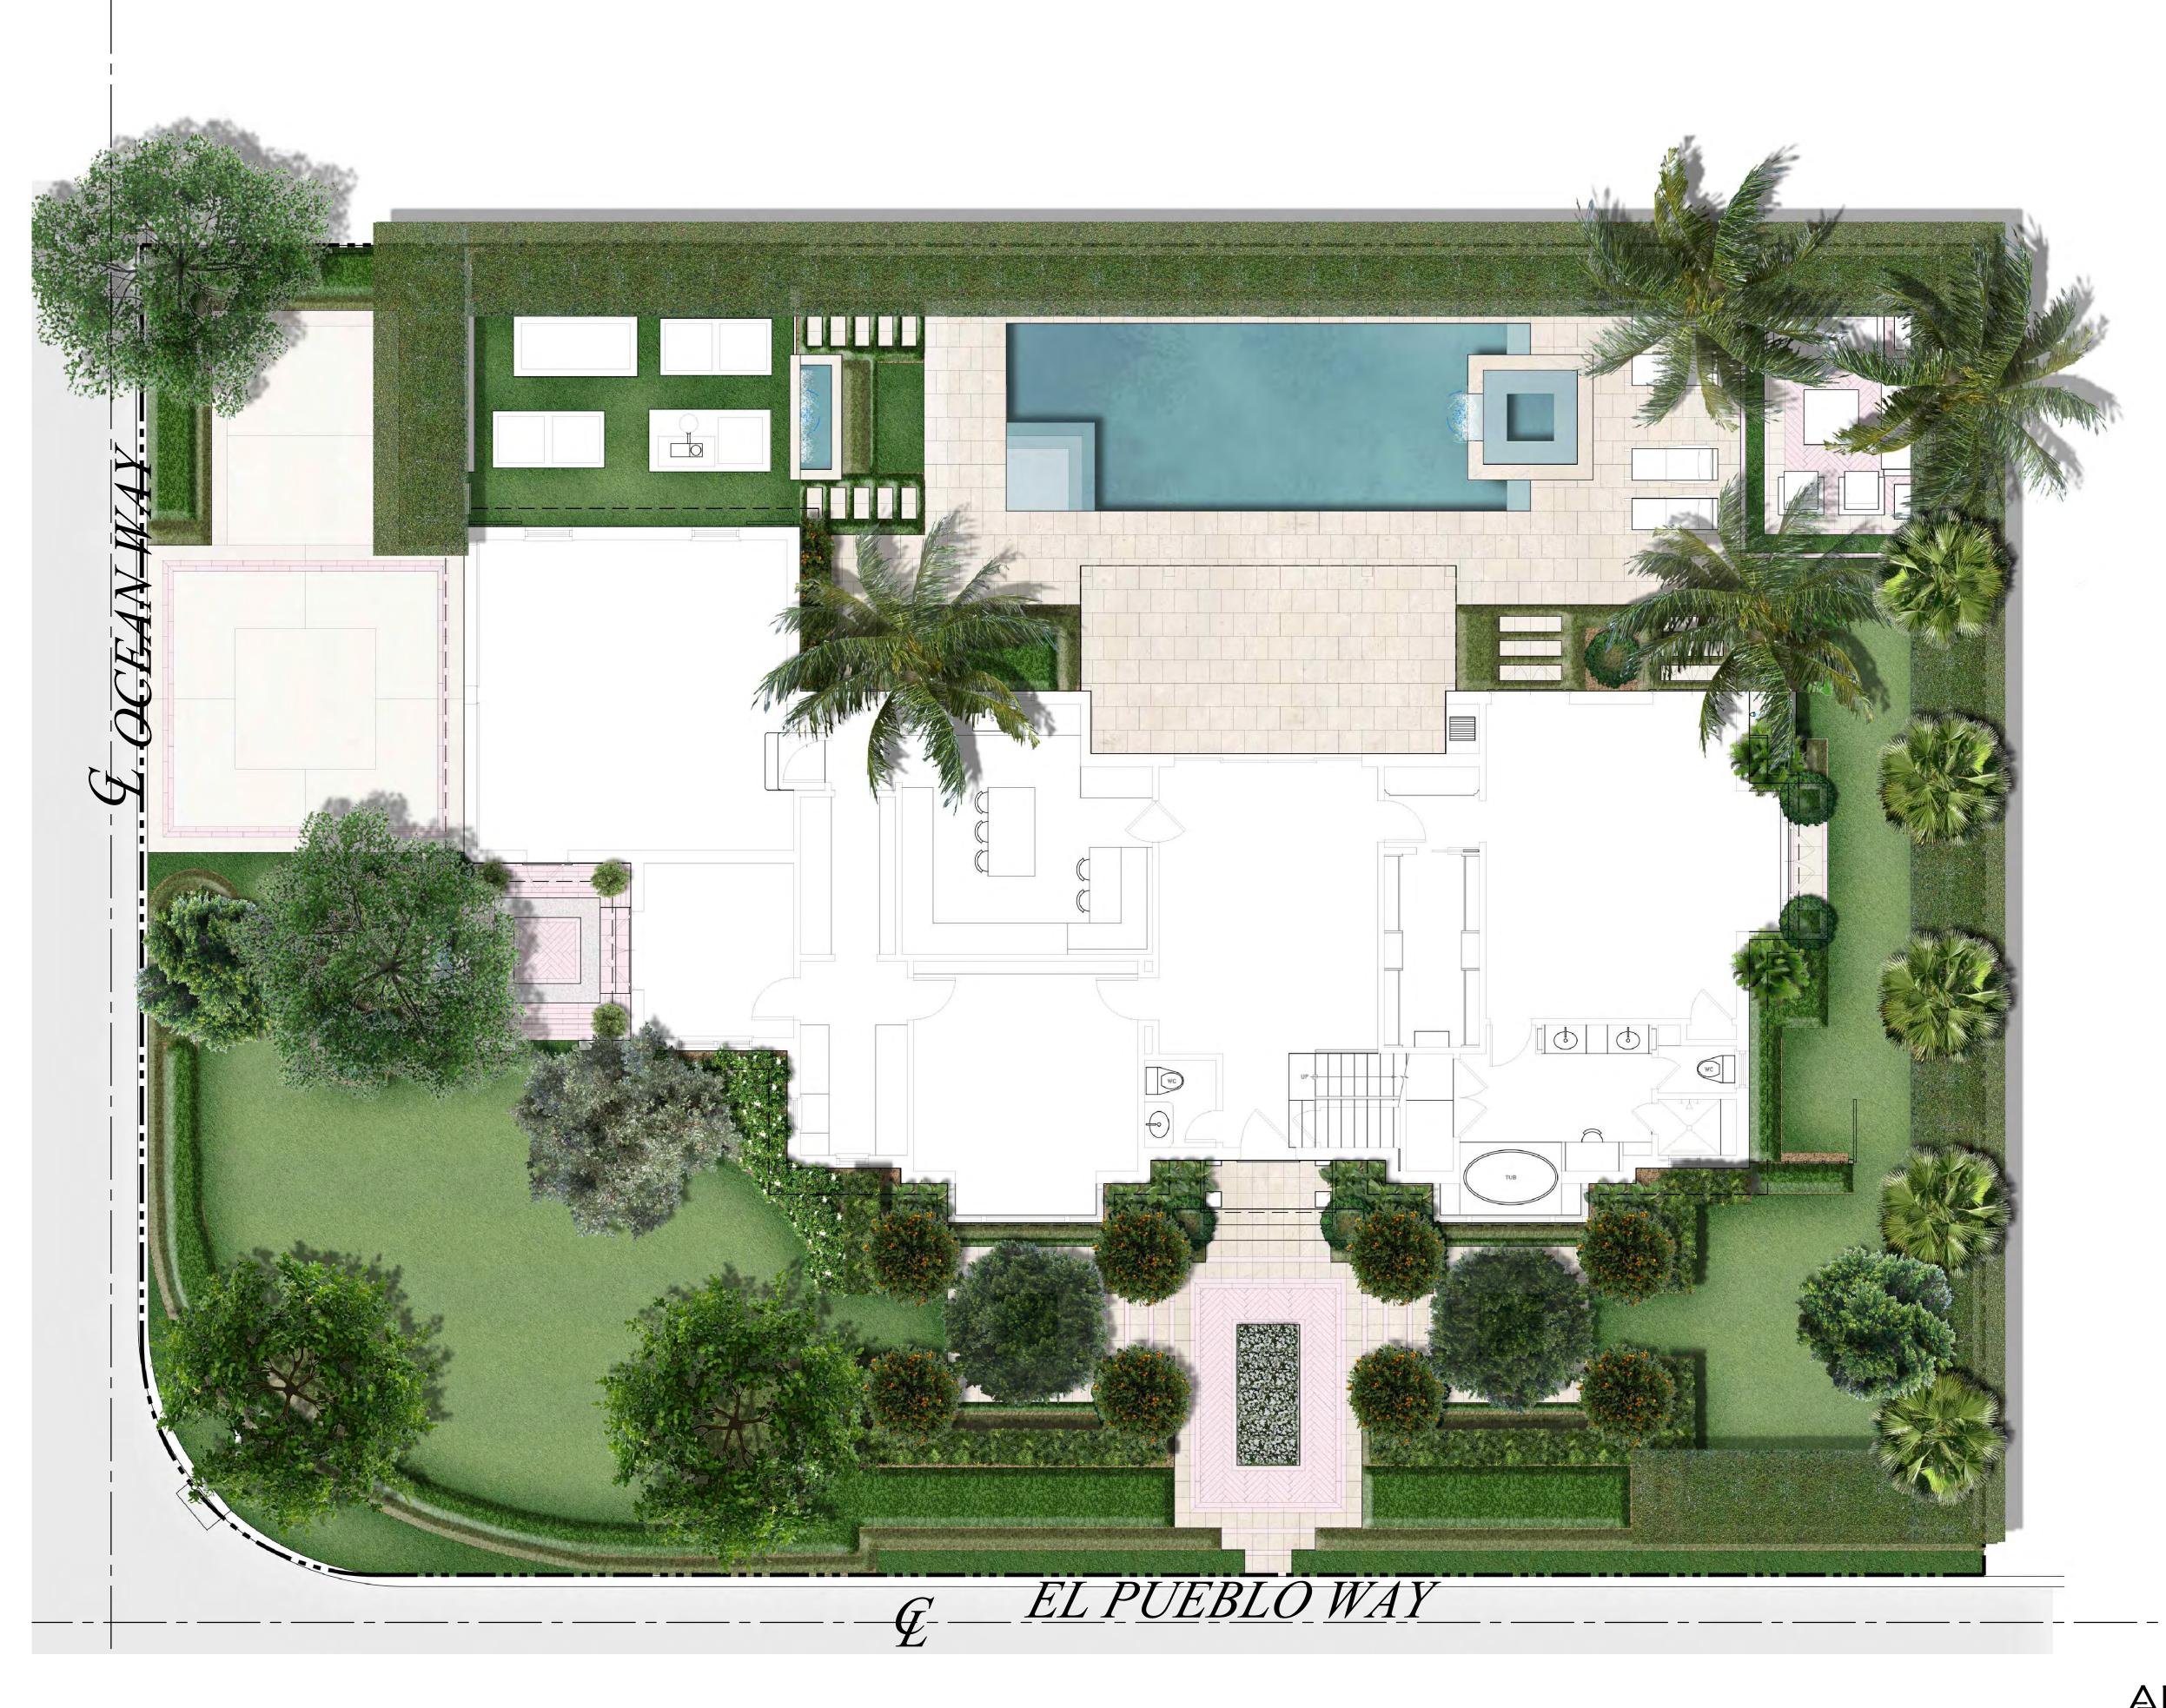
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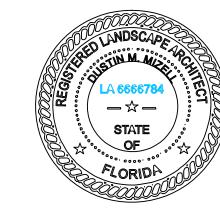
48 HOURS BEFORE DIGGING CALL TOLL FREE 1-800-432-4770





DE/IG/I GROUP 139 North County Road S#20-B Palm Beach, FI 33480 Phone 561.832.4600 Mobile 561.313.4424 Landscape Architecture Land Planning Landscape Management Dustin M. Mizell, MLA RLA #6666784 Dustin@environmentdesigngroup.com

JOB NUMBER: # 22250.00 LA
DRAWN BY: Lauren Freeman
DATE: 01.23.2023
02.08.2023



✓HEET L7.1

ARC -23-026 ZOM -23-034

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Rendered Landscape Plan Scale in FEET O'

Trees

SYMBOL	PLANT NA	AME	QTY.	DESCRIPTION	NATIVE
	BURSERA S GUMBO LIN		2	RELOCATED FROM ON SITE	YES
Sold of the second of the seco	CHANAGA (YLANG YLA		2	(I) 18' OA, 4' CT, (I) 18' OA, 8' CT	NO
+	I	US ERECTUS TONWOOD TREE	2	18' OA SPECIMEN, 14' OA SPECIMEN	YES
+		US ERECTUS SERICEUS TONWOOD TREE	1	14' OA SPECIMEN	YES
+		JS DECIPIENS BLUENERRY TREE	2	CONNICAL, 7'-8' CT, 14' OA	NO
		TOTAL:	9		

Palms

SYMBOL	PLANT NAME	QTY.	DESCRIPTION	NATIVE
	COCOS NUCIFERA COCONUT PALM	4	18' CT, 22' CT, (2) 24' CT	NO
+	THRINAX RADIATA THRINAX PALM	5	18' CT, MATCHING	YES

5 (55.5%)

TOTAL: NATIVE SPECIES: 5 (55.55%)

Groundcover & Vines

NATIVE SPECIES:

SYMBOL/KEY	PLANT NAME	QTY.	DESCRIPTION	NATIVE
	ANNUALS SEASONAL COLOR	225	I GAL, 12" OC	NO
	ACALYPHA REPTANS DWARF CHENILE	40	I GAL, 12" OC	NO
	BOUGAINVILLEA 'THAI ' THAI BOUGAINVILLEA VINE	5	15 GAL, TRELLIS	NO
entime entimes	CITRUS SPECIES ESPALIER CITRUS VINE	3	7 GAL, TRELLIS	NO
	EVOLVULUS GLOMERATUS BLUE DAZE	15	I GAL, 12" OC	NO
	PHYLA NODIFLORA FROG FRUIT	270	4" LINERS, 4" OC	YES
	TRACHELOSPERMUM ASIATICUM 'MINIMA' CONFEDERATE JASMINE 'MINIMA'	170	I GAL, I2" OC	NO
	TRACHELOSPERMUM JASMINOIDES CONFEDERATE JASMINE VINE	24	15 GAL, TRELLIS, SEE PLAN FOR SPECS	NO
		18	7 GAL	

770 TOTAL: 270 (35.06%) NATIVE SPECIES:

1-800-432-4770

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Lawn & Mulch

SYMBOL/KEY	PLANT NAME	QTY.	DESCRIPTION
LAWN	DIAMOND ZOYSIA LAWN	AS NEEDED	SOD PALLETS
PLANTING BED	SHREDDED EUCALYPTUS MULCH	AS NEEDED	MULCH ALL BEDS 3" MIN. DEPTH

Hedge & Shrubs

2015		QTY.	DESCRIPTION	NATIVE
\$ + 3 \$ - 3	ALOCASIA 'BORNEO GIANT' BORNEO GIANT ALOCASIA	5	7 GAL, MATCHING	NO
	ALOCASIA ODORA DWARF ALOCASIA	16	3 GAL, 24" OC	NO
	ANTHURIUM FAUSTOMIRANDAE GIANT ANTHURIUM	2	7 GAL	NO
	BEGONIA ODORATA 'ALBA' LITTLE LEAF CLUSIA HEDGE	40	3 GAL, 24" OC	NO
	BANANA TREE EDIBLE BANA TREE	1	7 GAL, SPECIES TBD	NO
+ + + +	CALOPHYLLUM BRASILIENSIS BRAZIL BEAUTY LEAF HEDGE	55	16'-18' OA, 48" OC, 4' CLEAR TRUNK TO FORM 16' HEDGE AT INSTALL	NO
	CARMONA MICROPHYLLA	450	3 GAL, 12" OC	NO
(+)	FUKIEN TEA	8	7 GAL, TOPIARY, MATCHING	
+ 3	CITRUS X CITROFORTUNELLA MITIS CALAMONDIN SPECIES	8	I5 GAL, MATCHING	NO
to the same	CHAMAEDOREA CATARACTARUM CAT PALM	3	7 GAL	NO
	CHRYSOBALANUS ICACO 'HORIZONTAL' HORIZONTAL COCOPLUM	645	3 GAL, 12" OC	YES
	CONOCARPUS ERECTUS SERICEUS SILVER BUTTONWOOD	50	3 GAL, 12" OC, 18" TALL HEDGE	YES
	CYPERUS PAPYRUS 'PRINCE TUT' DWARF EGYPTIAN PAPYRUS	10	3 GAL, 12" OC	NO
+	DOMBEYA 'SEMINOLE PINK' PINK FLORIDA HYDRANGEA	3	15 GAL, 24" OC	NO
	GARDENIA SPECIES MACHO FERN	30	7 GAL, 30" OC	NO
	NEOMARCIA REGINA GIANT APOSTLE IRIS	5	3 GAL	NO
,	PODOCARPUS MACROPHYLLUS	27	6' OA, 24" OC, SEE PLAN	NO
	PODOCARPUS HEDGE	13	8'0A, 24", SEE PLAN	
+ + 1	PODOCARPUS MACROPHYLLUS 'PRINGLES' DWARF PODOCARPUS TOPIARY	3	7 GAL, 30" X 30", TOPIARY SPHERE, MATCHING	NO
	SPATHIPHYLLUM X 'WALLISII' DWARF PEACE LILY	12	3 GAL, 12" OC	NO
	WRIGHTIA ANTIDYSENTERICA ASIAN SNOW	50	3 GAL, 18" OC	NO


TOTAL: 1,436 695 (48.40%)


Native Landscape Legend

PROPERTY ADDRESS:		
	REQUIRED	PROPOSED
LOT SIZE (SQ FT)		9960.46 SF
LANDSCAPE OPEN SPEACE (LOS) (SQ FT AND %)	4,482.21 SF (45.00%)	4,519.00 SF (45.36%)
PERIMTETER LOS (SQ FT AND %)	1,000 SF (40.00%)	1,038 SF (49.00%)
FRONT YARD LOS (SQ FT AND %)	2,241 SF (50.00%)	2,245 SF (50.08%)
NATIVE TREES %	35.00%	55.55%
NATIVE PALMS %	35.00%	55.55%
NATIVE SHRUBS %	35.00%	48.40%
NATIVE VINES / GROUND COVER %	35.00%	35.06%

ARC -23-026 ZON -23-034 Plant Schedule



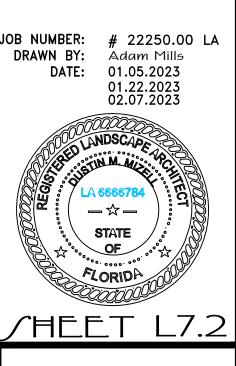

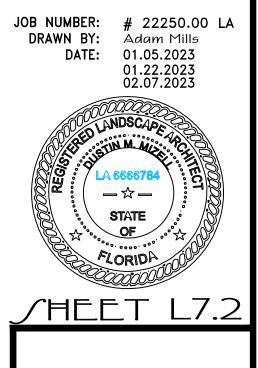


tree planting

MATERIAL SHALL CONSIST OF AT LEAST /3 NATIVE SOIL FROM THE HOLE DUG FOR THE PLANT. SEE SPECIFICATIONS FOR BACKFILL MIXTURE.


TOP OF BURLAP BALL SHALL BE AT LEAST I 1/2" ABOVE THE FIN. GRADE. - 3" MULCH LAYER (SHREDDED CYPRESS). BUILD 4'-6' CONTINUOUS SAUCER AROUND ROOT BALLS GREATER THAN 2'-O' IN DIAM. SHALL SIT ON MOUND OF UNDISTURBED - SOIL TO PREVENT SETTLING. ROOT BALLS SMALLER THAN 2'-O" DIAM. MAY SIT ON DIAMETER OF HOLE FOR BALL TO 2'-0' SHALL BE TWICE THE DIAMETER OF THE ROOTBALL. DIAMETER OF THE HOLE FOR ROOTBALLS 2'-0' ϵ GREATER SHALL BE 2'-O" LARGER THAN THE DIAM. OF THE BALL MATERIAL SHALL CONSIST OF AT LEAST /3 NATIVE SOIL FROM THE HOLE DUG FOR THE PLANT. SEE SPECIFICATIONS FOR BACKFILL MIXTURE. shrub planting


PRUNE SHRUBS AT OWNER'S DIRECTION.

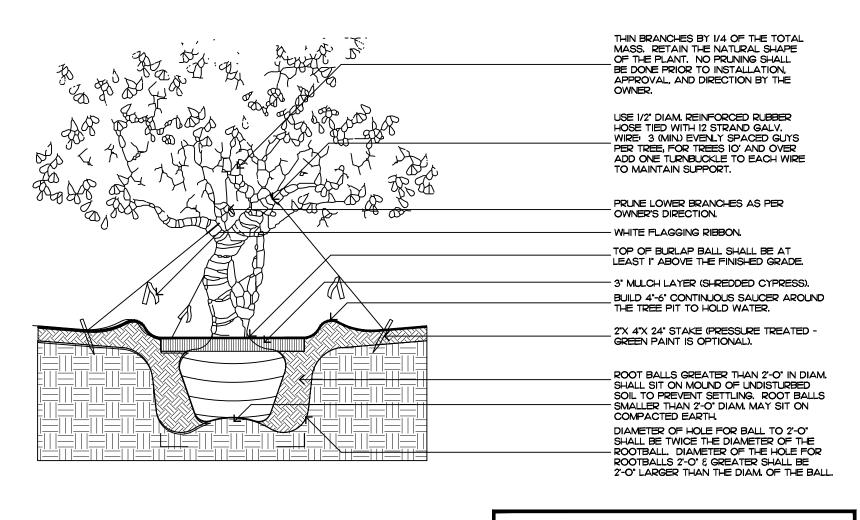

FILL MATERIAL SHALL CONSIST OF AT LEAST 1/3 NATIVE SOIL FROM THE HOLE DUG FOR THE PLANT. SEE SPECIFICATIONS FOR BACKFILL MIXTURE.

irregular and multi-stem tree

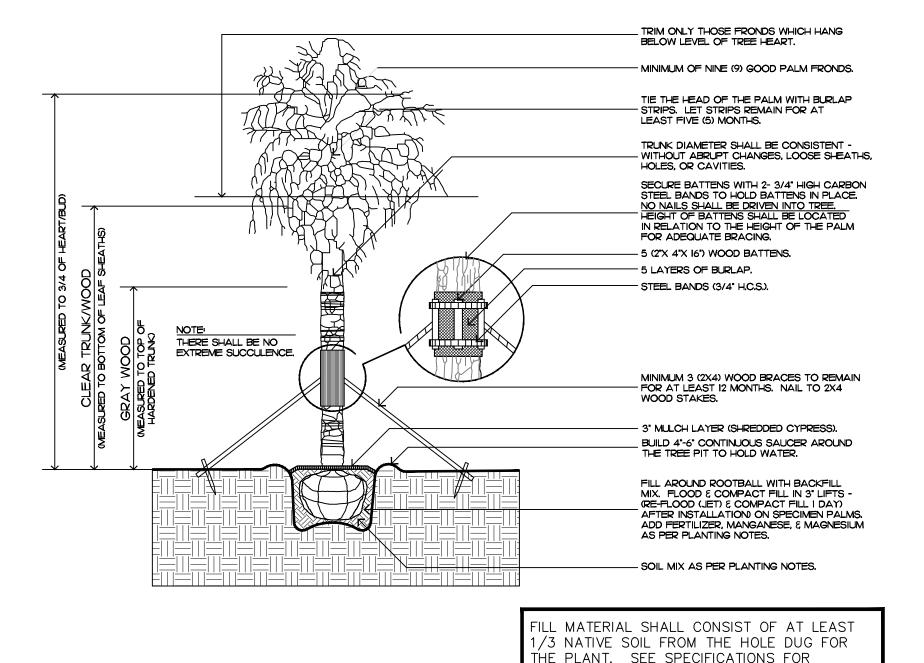

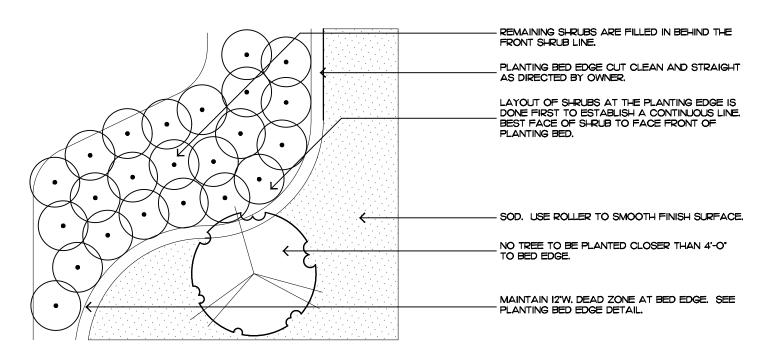

BACKFILL MIXTURE.

shrub & ground cover layout

palm tree planting

Planting Motes

COMMERCIAL FERTILIZER:

FERTILIZER SHALL BE COMPLETELY ORGANIC, IT SHALL BE UNIFORM IN COMPOSITION, DRY AND FREE FLOWING. THIS FERTILIZER SHALL BE DELIVERED TO THE SITE IN THE ORIGINAL UNOPENED BAGS, EACH BEARING THE MANUFACTURER'S STATEMENT OF ANALYSIS, AND SHALL MEET THE FOLLOWING REQUIREMENTS:

SIX PERCENT (6%) PHOSPHOROUS

SIX PERCENT (6%) POTASSIUM

FERTILIZER SHALL BE APPLIED TO ALL SHRUBS (1/3 LB. PER 3 GAL. POT, 1/4 LB. PER 1 GAL. POT) AND GROUNDCOVER. THE SAME FERTILIZER MIXTURE SHALL BE USED ON SOD AT A RATE OF 15 LBS. PER 1000 SQUARE FEET. A FOURTEEN PERCENT (14%) NITROGEN, FOURTEEN PERCENT (14%) PHOSPHOROUS AND FOURTEEN PERCENT (14%) POTASSIUM IS REQUIRED ON ALL TREES AND SHRUBS OVER 5'-O" IN HEIGHT (1/2 LB. PER 5'-O" OF SPREAD). AGRIFORM TABLETS WITH TWENTY PERCENT (20%) NITROGEN, TEN PERCENT (10%) PHOSPHOROUS, FIVE PERCENT (5%) POTASSIUM IN 21 GRAM SIZES SHALL BE APPLIED ALONG WITH THE FERTILIZER PROCESS (I WITH I GAL. PLANTS, 2 WITH 3 GAL. PLANTS AND 2 TABLETS PER I" OF TREE TRUNK CALIPER). BACK FILL HALFWAY UP THE ROOT BALL, PLACE ABOUT ONE INCH (I") FROM ROOT TIPS. MAGNESIUM SULFATE SHALL BE APPLIED TO ALL PALMS AT INSTALLATION AT A RATE OF 1/2 LB. PER INCH OF TRUNK CALIPER. MANGANESE SHALL BE APPLIED AT THE SAME RATE.

MULCH:

MULCH MATERIAL SHALL BE SHREDDED CYPRESS MULCH OR APPROVED EQUAL, MOISTENED AT THE TIME OF APPLICATION TO PREVENT WIND DISPLACEMENT. MULCH SHALL BE APPLIED TO A MINIMUM 3" DEPTH

SOD:

THE SOD SHALL BE FREE FROM WEEDS, FUNGUS, INSECTS AND DISEASES OF ANY KIND, CLEAN, STRONGLY ROOTED, UNIFORMLY SIZED STRIPS, MACHINE STRIPPED NOT MORE THAN TWENTY-FOUR (24) HOURS PRIOR TO LAYING.

JUB/TITUTION/:

NO SUBSTITUTION OF PLANT MATERIAL TYPES OR SIZES WILL BE ALLOWED WITHOUT WRITTEN AUTHORIZATION FROM THE OWNER. CONTAINER GROWN MATERIAL WILL NOT BE ACCEPTED AS SUBSTITUTE FOR BEB MATERIAL UNLESS PREVIOUSLY APPROVED. INTENDED SUBSTITUTIONS SHALL BE SPELLED OUT IN BID.

MEA/UREMENT/:

HEIGHT SHALL BE MEASURED FROM GROUND TO THE AVERAGE BRANCH HEIGHT OF CANOPY. SPREAD SHALL BE MEASURED TO THE END OF THE BRANCHING EQUALLY AROUND THE CROWN FROM THE CENTER OF THE TRUNK. MEASUREMENTS ARE NOT TO INCLUDE ANY TERMINAL GROWTH. SINGLE TRUNK TREES SHALL BE FREE OF "V" CROTCHES THAT COULD BE POINTS OF WEAK LIMB STRUCTURE OR DISEASE INFESTATION.

HEIGHT SHALL BE MEASURED FROM THE GROUND TO THE AVERAGE POINT WHERE MATURE PLANT GROWTH STOPS. SPREAD SHALL BE MEASURED TO THE END OF BRANCHING EQUALLY AROUND THE SHRUB MASS. MEASUREMENT AREA NOT TO

INCLUDE ANY TERMINAL GROWTH.

CLEAR TRUNK (C.T.) - SHALL BE MEASURED FROM THE GROUND AT TIME OF INSTALLATION TO THE POINT WHERE THE MATURE AGED TRUNK JOINS THE IMMATURE OR GREEN PORTION

OVERALL HEIGHT (O.A.) - SHALL BE MEASURED FROM THE GROUND AT THE TIME OF INSTALLATION TO THE AVERAGE FROND HEIGHT.

PALMS WITH MARRED OR BURNED TRUNKS WILL NOT BE ACCEPTED.

PLANTING JOIL AND BACKFILL:

PLANTING SOIL FOR USE IN PREPARING BACKFILL FOR PLANT PITS SHALL BE A FERTILE, FRIABLE AND NATURAL TOPSOIL, WITHOUT MIXTURE OF SUBSOIL MATERIALS, AND SHALL BE FREE FROM HEAVY CLAY STONES, LIME, LUMPS, SHELLS, PLANTS, ROOTS OR OTHER FOREIGN MATERIALS, WEEDS, OR NOXIOUS GRASSES (SUCH AS BERMUDA OR NUT GRASS). IT SHALL NOT CONTAIN TOXIC SUBSTANCES WHICH MAY BE HARMFUL TO THE PLANT GROWTH.

BACKFILL FOR SOD AREAS SHALL BE SUBJECT TO LESSER STANDARDS AT THE DISCRETION AND DECISION OF THE OWNER.

EXISTING TOPSOIL SHALL BE USED IN ALL PLANT MATERIAL PITS EXCEPT SABAL PALMS WHERE THE SOIL SHALL CONSIST OF CLEAN SAND.

PLANTING SOIL FOR USE IN BEDS FOR ANNUALS AND/OR PERENNIALS SHALL CONTAIN ONE-THIRD (1/3) POTTING SOIL OR A BLENDED TOPSOIL, TILL INTO TOP 10" - 12" OF SOIL WITH A TIME-RELEASE FERTILIZER.

PLANT MATERIALS:

PALMS, TREES, SHRUBS, GROUNDCOVERS AND VINES

PLANT SPECIES AND SIZE SHALL CONFORM TO THOSE INDICATED ON THE DRAWINGS. NOMENCLATURE SHALL CONFORM TO "STANDARDIZED PLANT NAMES", 1942 EDITION. ALL NURSERY STOCK SHALL BE IN ACCORDANCE WITH "GRADES AND STANDARDS FOR NURSERY PLANTS PARTS I & II", LATEST EDITION PUBLISHED BY THE FLORIDA DEPARTMENT OF AGRICULTURE AND CONSUMER SERVICES. UNLESS SPECIFIED OTHERWISE, ALL PLANTS SHALL BE FLORIDA GRADE NUMBER I OR BETTER AS DETERMINED BY THE FLORIDA DIVISION OF PLANT INDUSTRY. SPECIMEN MEANS AN EXCEPTIONALLY HEAVY, SYMMETRICAL TIGHTLY KNIT PLANT, SO TRAINED OR FAVORED IN ITS DEVELOPMENT THAT FIRST APPEARANCE IS UNQUESTIONABLE AND OUTSTANDINGLY SUPERIOR IN FORM, NUMBER OF BRANCHES, COMPACTNESS AND SYMMETRY. ALL PLANTS SHALL BE FRESHLY DUG, SOUND, HEALTHY, VIGOROUS, WELL BRANCHED AND FREE OF DISEASE AND INSECT EGGS AND LARVAE AND SHALL HAVE ADEQUATE ROOT SYSTEMS. TREES FOR PLANTING ROWS SHALL BE UNIFORM IN SIZE AND SHAPE. ALL MATERIALS SHALL BE SUBJECT TO APPROVAL BY THE OWNER. WHERE REQUIREMENTS ARE OMITTED FROM THE PLANT LIST, THE PLANTS FURNISHED SHALL BE NORMAL FOR THE VARIETY AND FLORIDA NUMBER 1. PLANTS SHALL BE PRUNED PRIOR TO DELIVERY ONLY UPON THE APPROVAL OF THE OWNER.

CONTAINER GROWN / TOCK:

ALL CONTAINER GROWN MATERIAL SHALL BE HEALTHY, VIGOROUS, WELL-ROOTED PLANTS AND ESTABLISHED IN THE CONTAINER IN WHICH THEY ARE SOLD. THE PLANTS SHALL HAVE TOPS OF GOOD QUALITY AND BE IN A HEALTHY GROWING CONDITION.

AN ESTABLISHED CONTAINER GROWN PLANT SHALL BE TRANSPLANTED INTO A CONTAINER AND GROWN IN THAT CONTAINER SUFFICIENTLY LONG ENOUGH FOR THE NEW FIBROUS ROOTS TO HAVE DEVELOPED SO THAT THE ROOT MASS WILL RETAIN ITS SHAPE AND HOLD TOGETHER WHEN REMOVED FROM THE

WARRANTY:

PLANT MATERIAL.

WARRANTY PLANTS, SHRUBS AND GROUNDCOVERS FOR A PERIOD OF NINETY (90) DAYS; TREES ξ PALMS FOR ONE YEAR (I) AGAINST UNHEALTHY CONDITION, EXCEPT AS MAY RESULT FROM NEGLECT BY OWNER, DAMAGE BY OTHERS, AND UNUSUAL PHENOMENA BEYOND INSTALLER'S CONTROL. REPLACE AT TIME REQUESTED BY THE OWNER OR LANDSCAPE ARCHITECT.

MAINTENANCE:

MAINTAIN LANDSCAPE WORK UNTIL THE LETTER OF SUBSTANTIAL COMPLETION BY THE GENERAL CONTRACTOR. INCLUDE WATERING, WEEDING, CULTIVATING, RESTORATION OF GRADE, MOWING AND TRIMMING GRASS, PRUNING TREES AND SHRUBS, PROTECTION FROM INSECTS AND DISEASES, FERTILIZATION AND SIMILAR OPERATIONS AS NEEDED TO ENSURE NORMAL GOOD HEALTH FOR LIVE

• S

AVIROMMEN'

Mobile 561.313.4424

DE/IG/I

139 North County Road S#20-B Palm Beach, Fl 3348

Landscape Architecture

Landscape Management

Dustin@environmentdesigngroup.com

Dustin M. Mizell, MLA RLA #6666784

Phone 561.832.4600

Land Planning

ROUP

JOB NUMBER: # 22250.00 LA DRAWN BY: Adam Mills DATE: 01.05.2023 01.23.2023 -☆-STATE

> OF FLORIDA /HEET L7.3

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ARC -23-026 ZOM -23-034 Planting Details & Specifications

Calophyllum brasiliensis Brazilian Beauty Leaf Hedge

Cocos Mucifera

Coconut Palm

Conocarpus erectus

∫ilver Buttonwood Ħedge



Bursera simaruba Gumbo Limbo

Conocarpus Erectus

∫ilver Buttonwood∫pecimen



Polyathia longifolia Mast Tree

Thrinax radiata

Florida Thatch Palm



Edible banana Edible Banana Tree / pecies



Eleacarpus decipiens Japanese Blueberry

Gardenia species

Gardenia



Citrus x Citrofortunella mitis Calamondin Species





Chamaedorea cataractarum Cat Palm



Chrysobalanus icaco'horizontal' Horizontal Cocoplum



Podocarpus Macrophyllus 'pringles' Dwarf podocarpus



Conocarpus erectus

Green Buttonwood

Phyla nodiflora Frog Fruit



Trachelospermum Jasminoides Confederate Jasmine Vine



Podocarpus Macrophyllus Podocarpus



Citrus / pecies Espalier Citrus Vine



Bougainvillea thai Thai Bougainvillea Vine



Wrightia antidysenterica Asian∫now



Dombeya 'seminole pink' Pink Florida Hydrangea



Alocasia Odora Dwarf Alocasia



Carmona microphylla Fukien tea

/HEET L7.4

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Proposed Plant Material

JOB NUMBER: # 22250.00 LA
DRAWN BY: Allison Padilla
DATE: 01.22.2023

DE/IGM GROUP


139 North County Road S#20-B Palm Beach, FI 33480 Phone 561.832.4600 Mobile 561.313.4424

Landscape Architecture

Landscape Management

Dustin M. Mizell, MLA RLA #6666784 Dustin@environmentdesigngroup.com

Land Planning

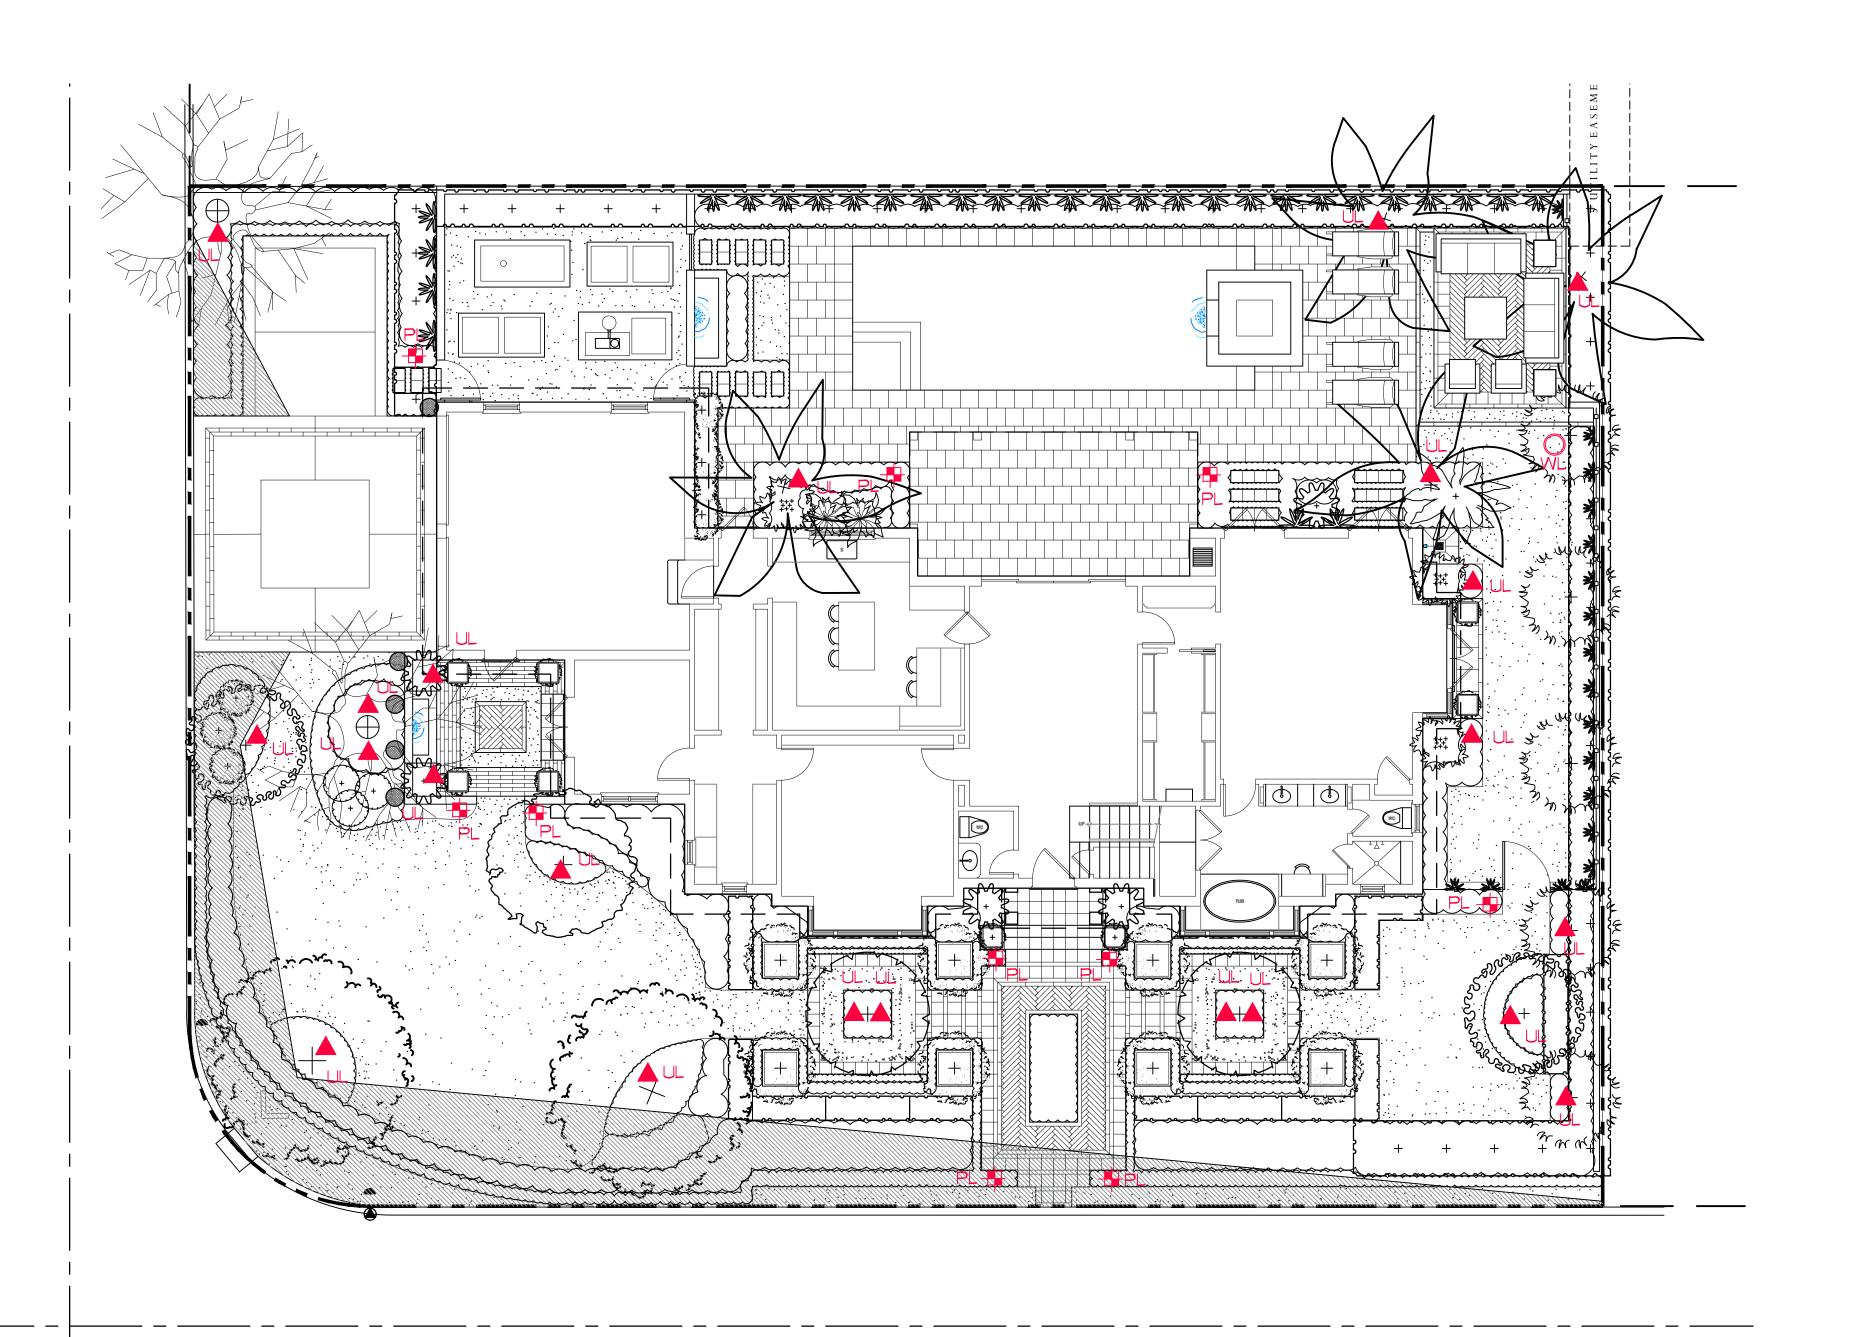

Lighting Schedule

SYMBOL	DESCRIPTION	QT`
▲ UL	<u>UPLIGHT</u> - AURORALIGHT - HSLI6-R TELLURIDE BRASS - 3 WATTS - LED 3000K	22
O WL	<u>WELL LIGHT</u> - AURORALIGHT - LWL5 LIGHTHAUS BRASS FINISH - 9 WATTS - LED 3000K	1
PL	<u>PATH LIGHT</u> - AURORALIGHT - LPL8 - CORONA BRASS FINISH - 4.5 WATTS - LED 3000K	10





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171 El Pueblo Palm Beach

JUN 4PM 39D JUN 9AM 49D

MAR APM 25

MAR APM 25

MAR APM 25

MAR APM 350

DIF OF C

JOB NUMBER: # 22250.00 LA
DRAWN BY: Adam Mills
Fean Twomey
DATE: 01.23.2023



✓ĦEET L8.0

64 sf.

ARC -23-026 ZON -23-034

Landscape Lighting Plan Scale IN FEET O'

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Tom, Staid Said Sound and SUNSHINE STATE ONE CALL OF FLORIDA, INC.



\int outh Elevation



Morth Elevation

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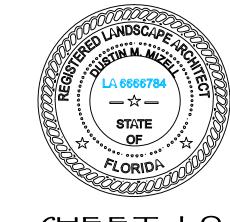
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ARC -23-026 ZOM -23-034 Rendered Landscape Elevations

DE/IG/I 139 North County Road S#20-B Palm Beach, FI 33480 Phone 561.832.4600 Mobile 561.313.4424 Landscape Architecture Land Planning Landscape Management Dustin M. Mizell, MLA RLA #6666784 Dustin@environmentdesigngroup.com

JOB NUMBER: # 22250.00 LA
DRAWN BY: Lauren Freeman
01.23.2023
02.08.2023



/HEET L9.0



East Elevation



West Elevation

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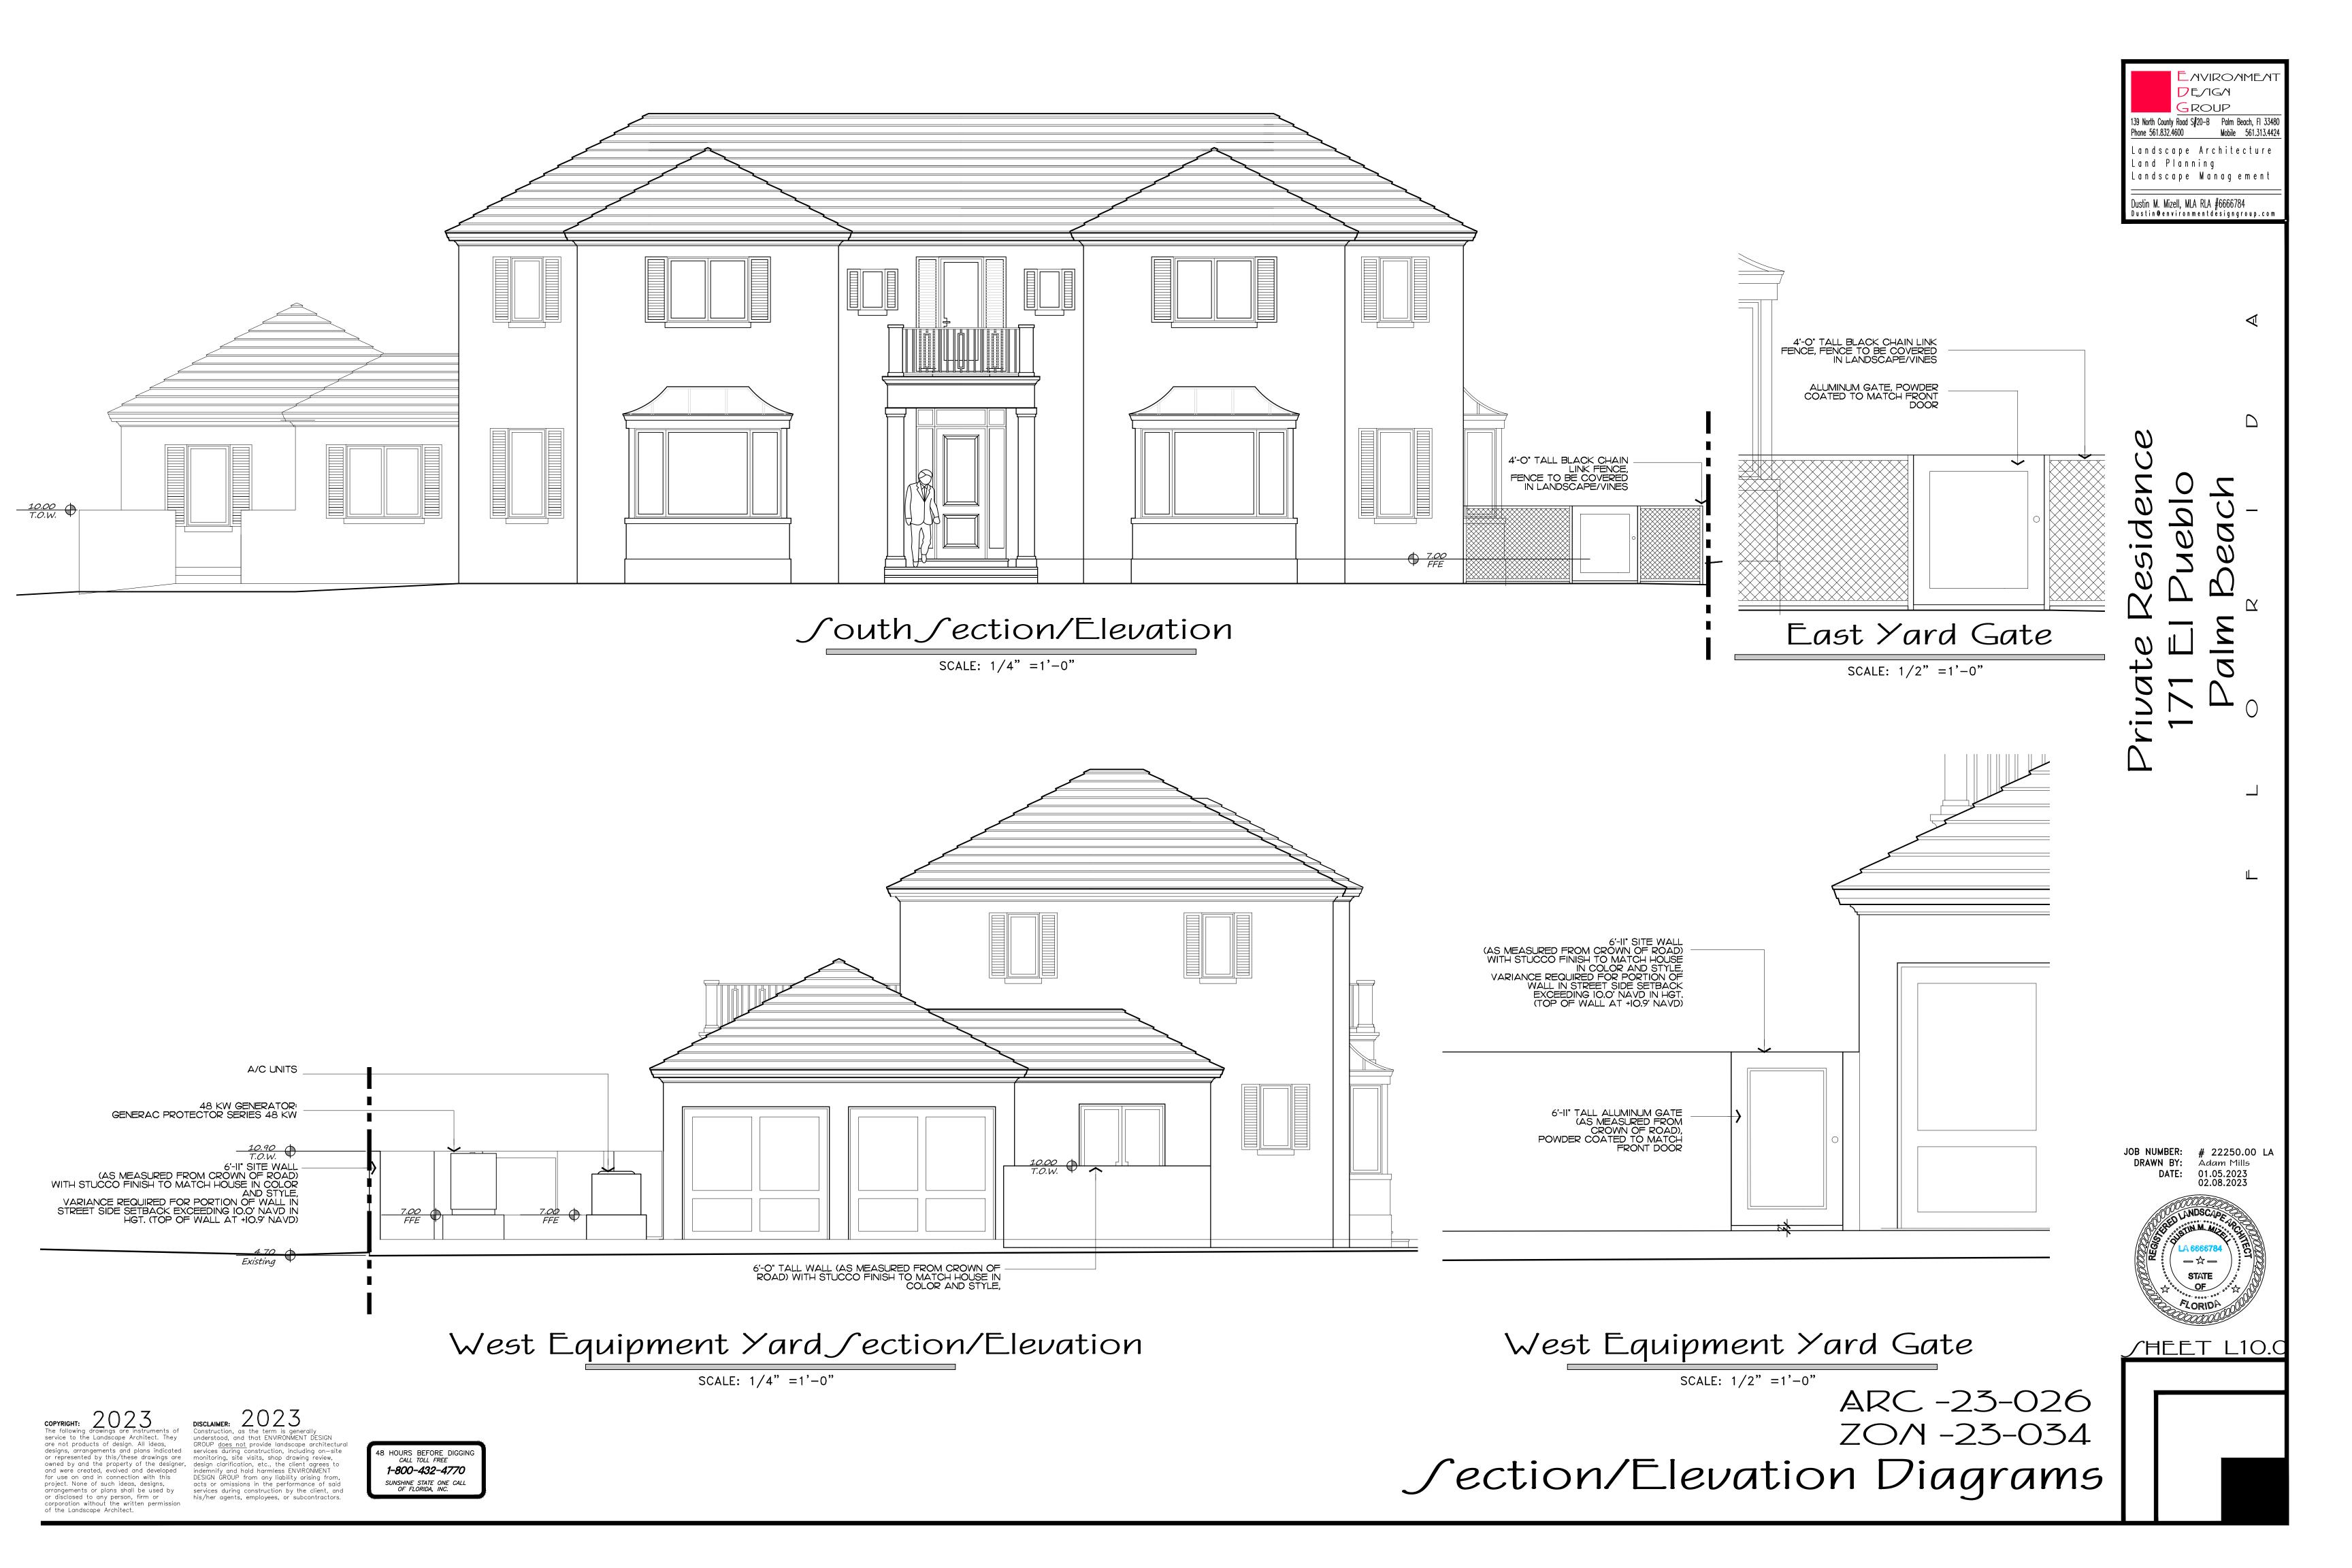
ARC -23-026 ZOM -23-034 Rendered Landscape Elevations Scale IN FEET O' 4'


139 North County Road S#20-B Palm Beach, FI 33480 Phone 561.832.4600 Mobile 561.313.4424 Landscape Architecture Land Planning Landscape Management Dustin M. Mizell, MLA RLA #6666784 Dustin@environmentdesigngroup.com

JOB NUMBER: # 22250.00 LA
DRAWN BY: Lauren Freeman
DATE: 01.23.2023
02.08.2023



✓HEET L9.1



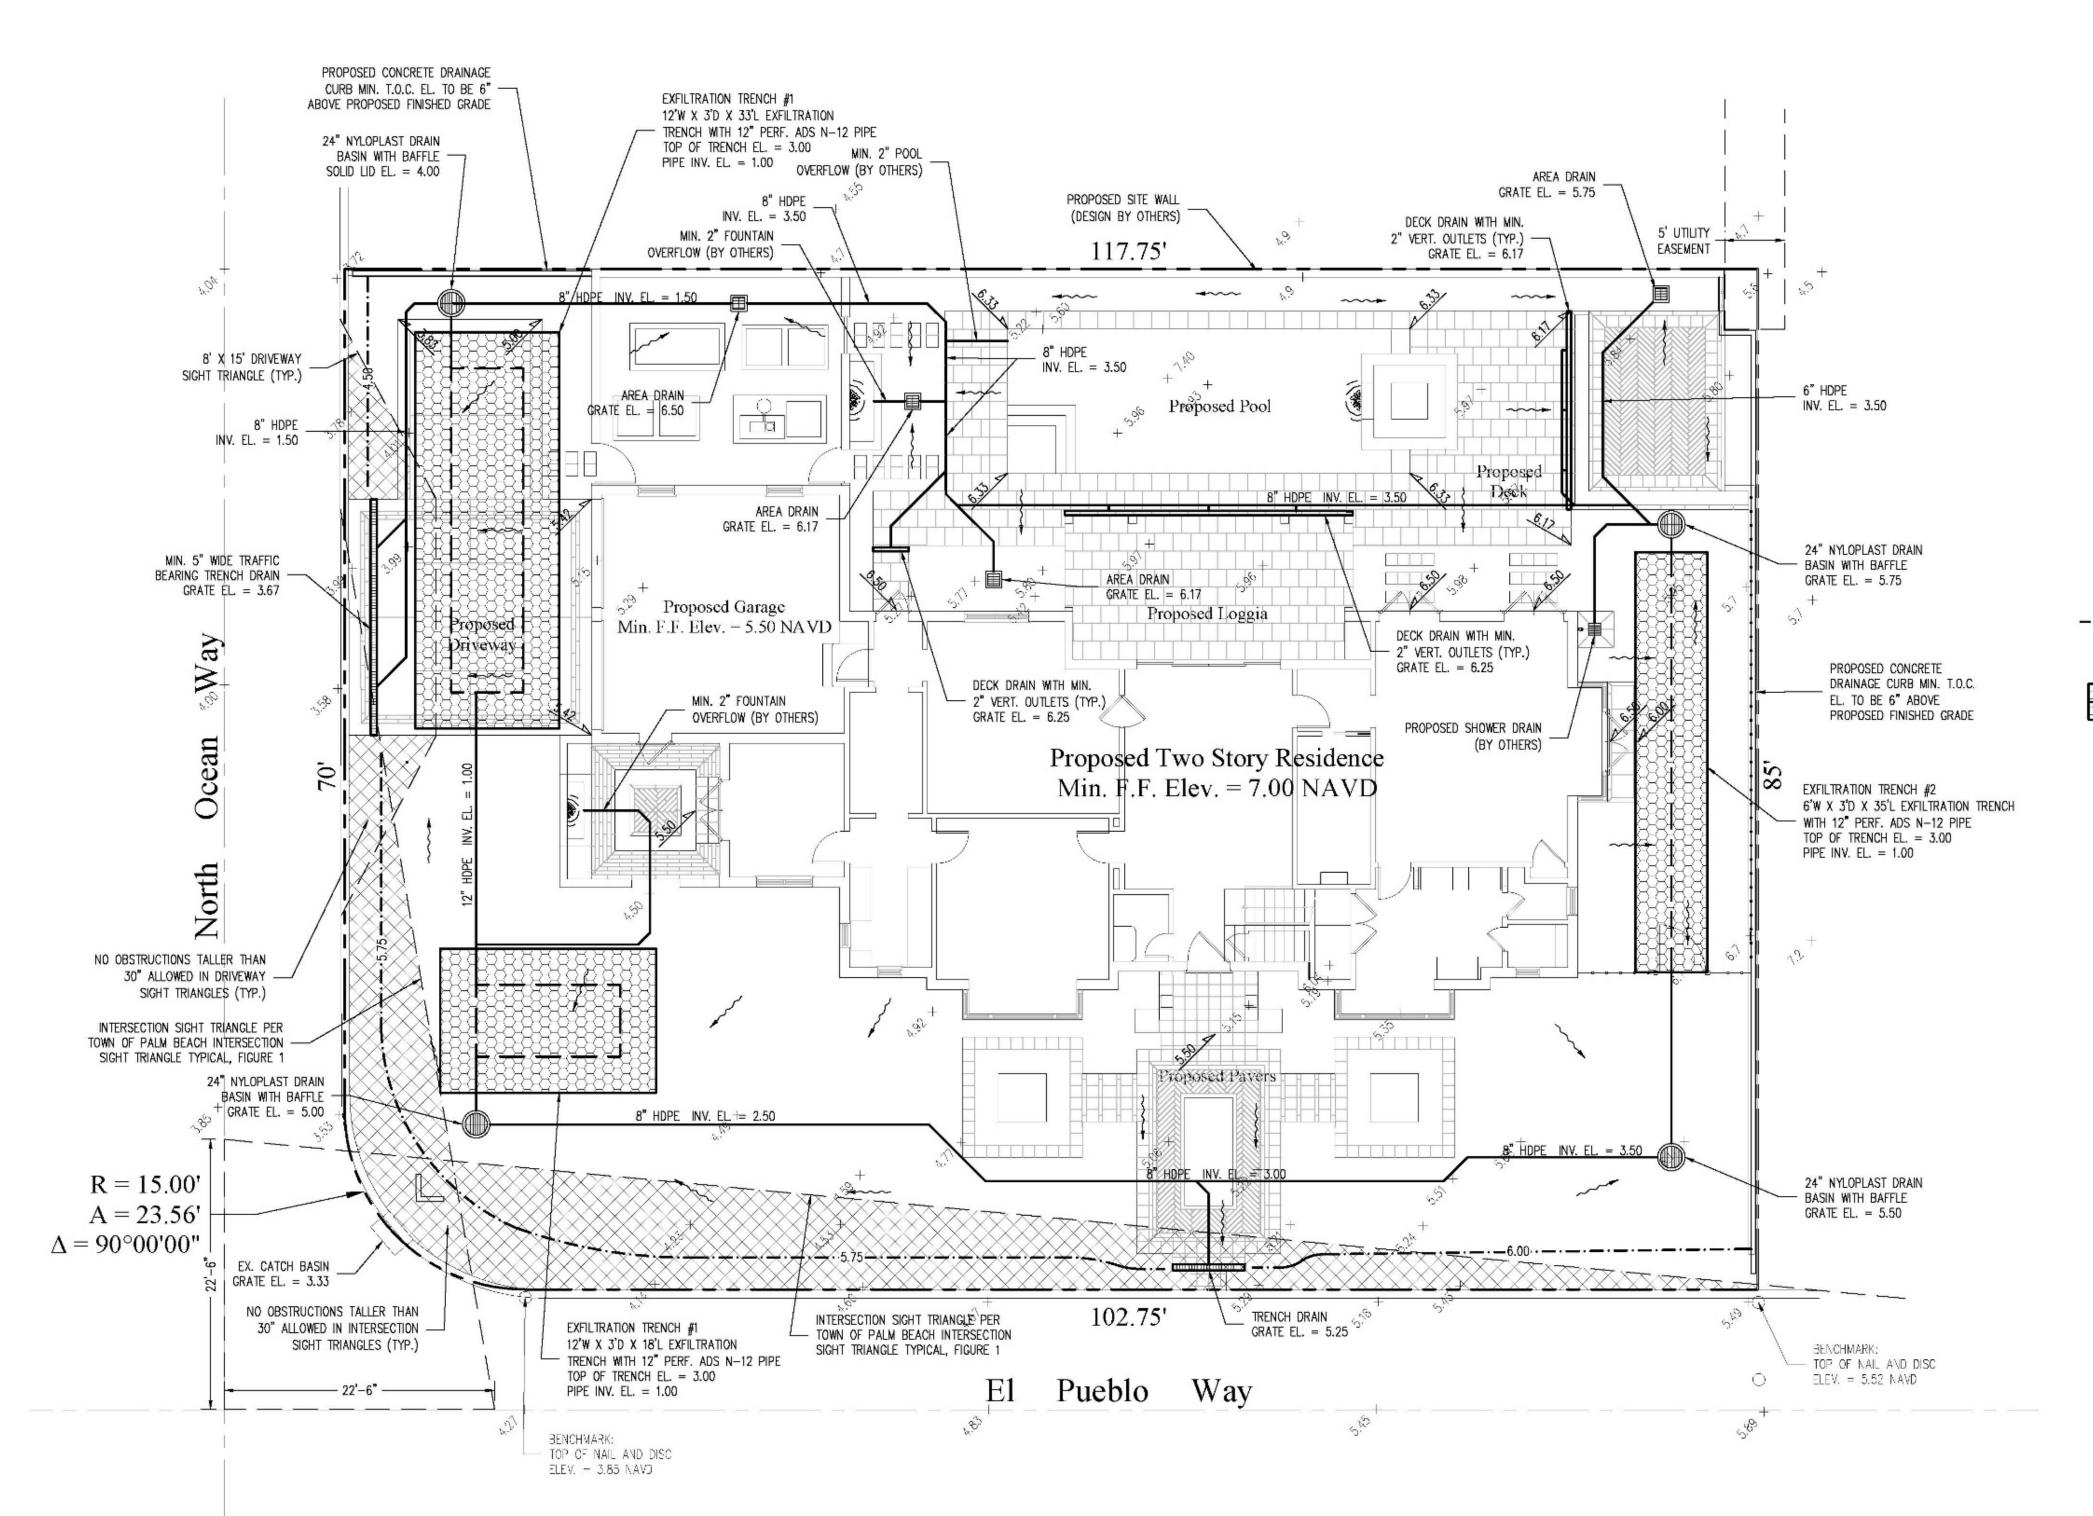

STORMWATER RETENTION CALCULATIONS

A. SITE INFORMATION

C = 1.0 (impervious surface)

Impervious Surface Runoff Volume:

1.0 x 2 in/hr x 5,358 sq.ft. x 1 ft./12 in. = 893 cu.ft.

 $0.2 \times 2 \text{ in/hr} \times 4,602 \text{ sq.ft.} \times 1 \text{ ft./12 in.} = 154 \text{ cu.ft.}$

C. PROPOSED EXFILTRATION TRENCH SIZING

Hydraulic Conductivity

Hydraulic Conductivity

Saturated Trench Depth

Un-Saturated Trench Depth

Total Volume Retained in Exfiltration Trenches = 1,113 cu.ft.

1) Exfiltration trenches and storm piping to be protected from

2) Roof drain downspouts are to be connected to the proposed

downspout locations prior to installation of drainage system.

hydraulic conductivity prior to exfiltration trench installation.

3) Exfiltration trench design uses an assumed value of hydraulic

4) Contractor shall mill and overlay all roadway cuts a minimum

of 50 ft. on either side of the excavation the entire width of

5) Contractor is responsible for installing and maintaining erosion

6) Video inspection of storm drainage system required prior to

drainage system. Contractor to provide engineer with

conductivity. Client may obtain a site specific test for

Depth to Water Table

= Total Length of Trench Provided = 51 ft

= Total Length of Trench Provided = 35 ft

DU = Un-Saturated Trench Depth = 1.50 ft

= 12 ft

= 2.17 ft

= 1.50 ft

= 2.17 ft

= 1.50 ft

= 1.50 ft

= 310 cu.ft.

= 0.00005 cfs/sq.ft./ft. of head

= 0.00005 cfs/sq.ft./ft. of head

Total Volume to be Retained = 1,047 cu.ft.

C = 0.2 (pervious surface)

Pervious Runoff Volume:

W = Trench Width

Exfiltration Trench #2

W = Trench Width

V = Volume Treated

roots with a root barrier.

each affected lane.

installation of sod.

control measures during construction.

Notes:

H2 = Depth to Water Table

DS = Saturated Trench Depth

i = 2 in/hr

Total Property Area = 9,960 sq.ft.


Drainage Area Impervious Surface =5,358 sq.ft.

Drainage Area Pervious Surface = 4,602 sq.ft.

B. ESTIMATED STORMWATER RETENTION VOLUME

The retention volume is estimated using the Rational Method (Q=CiA)



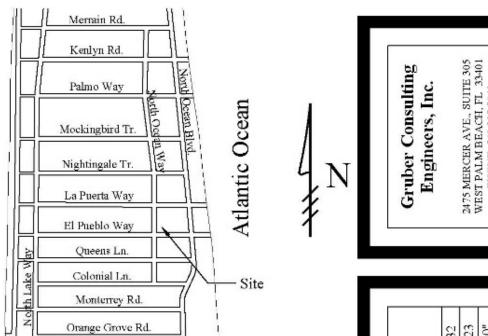

CALL 1-800-432-4770

ormation	2022-0132	01/21/2023	1/8" = 1'-0"	KM	CG	
Project Information	Project No.	Issue Date	Scale	Drawn By	Checked By	

Residence

Legend

EXISTING ELEVATION PER WALLACE SURVEYING CORP. (NAVD-88)

Location Map


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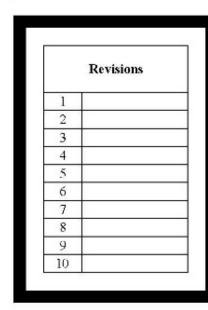
PROPOSED ELEVATION (NAVD-88)

---7.00--- PROPOSED ELEVATION CONTOUR (NAVD-88) FLOW DIRECTION

EXFILTRATION TRENCH AREA DRAIN

24" NYLOPLAST DRAIN BASIN WITH BAFFLE



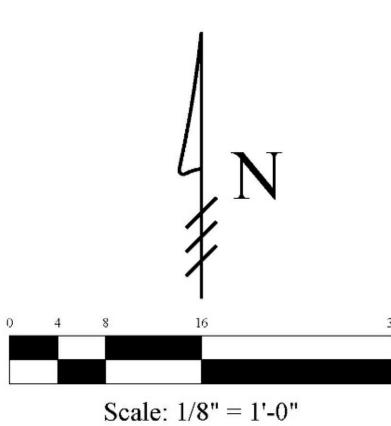

Chad M. Gruber

FL P.E. No. 57466



Digitally signed by Chad M Gruber Date: 2023.01.21 18:56:59 -05'00'

This item has been electronically signed and sealed by Chad M. Gruber on the date adjacent to the seal using a SHA authentication code.

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> Plan Background from Hardscape Plan by Environment Design Group Received 1/20/23

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ARC-23-026 ZON-23-034

Sheet No. C-1

