

## Scope of Work

- \* Demolition of existing landscape \* Demolition of existing driveway, pool deck, and east path
  - \* New hardscape and associated landscape



## Private Residence 249 Jandpiper Drive Palm Beach

L O R I D A

Application #: 月/B-22-013

Final Jubmittal

Date of Presentation: 11.16.22

∫heet Index

Cover Sheet

Survey

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L1.1 - Existing Site Photos

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C-1 - Civil Engineering Plan

## Design Team/Consultants

### Landscape Architects

ENVIRONMENT DESIGN GROUP

139 NORTH COUNTY ROAD SUITE 20B

PALM BEACH, FL 33480

561.832.4600

WWW.ENVIRONMENTDESIGNGROUP.COM

### Civil Engineer


GRUBER CONSULTING ENGINEERS

2475 MERCER AVE

WEST PALM BEACH, FL 33401

561.312.2041

LOCATION MAP N.T.S.

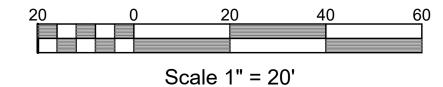


### NOTES ON SCHEDULE B2 TITLE EXCEPTIONS

### 1-8. Standard exceptions. Not plottable.

9. Restrictions, dedications, conditions, reservations, easements and other matters shown on the plat of DODGE ESTATES, as recorded in Plat Book 27, Page(s) 119, but deleting any covenant, condition or restriction indicating a preference, !lmitation or discrimination based on race, color, religion, sex, handicap, famllral status or national origin to the extent such covenants, conditions or restrictions violate 42 USC 3604(c). <u>Affects the subject property</u>. All pertinent items are plotted hereon.

10. Declaration of Covenants, Conditions and Restrictions recorded In Book. 880, Page 249; together with Waiver recorded in Book 3974, Page 842, but deleting any covenant, condition or restriction indicating a preference, limitation or discrimination based on race, color, religion, sex, handicap, familial status or national origin to the extent such covenants, conditions or restrictions violate 42 USC 3604{c). Affects the subject property, blanket Declaration of Covenants, Conditions and Restrictions, not plottable.

- 11. Agreement with the Town of Palm Beach as set forth in instrument recorded In Book
- 6040, Page 65. Affects the subject property, agreement, not plottable.
- 12. Terms and conditions of any existing unrecorded lease(s), and all rights of lessee(s) and any parties claiming through the lessee(s) under the lease(s). *Not plottable.*

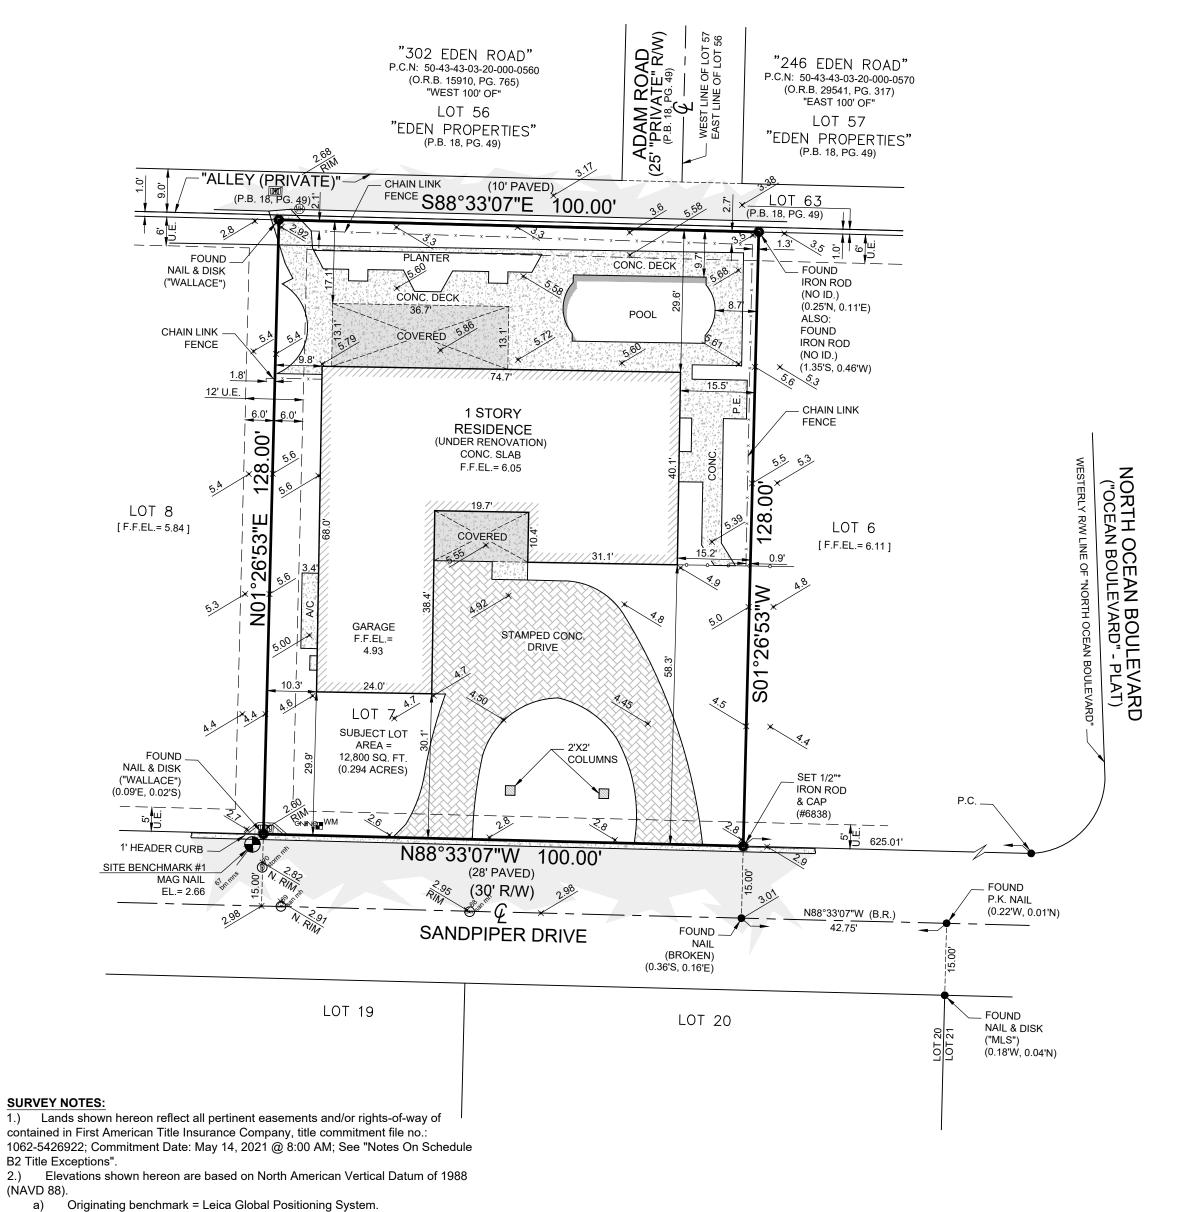

CERTIFIED TO: Alec Scheiner; Rabideau Klein; Kochman & Ziska PLC; First American Title Insurance Company; First Republic Bank, Its Successors and/or Assigns PROPERTY ADDRESS: 249 Sandpiper Drive, Palm Beach, FL 33480 FLOOD ZONE: AE (FIRM 120220-12299C0581F 10/05/2017) BASE FLOOD ELEVATION = 6' (NAVD 88) DESCRIPTION: Lot 7, DODGE ESTATES, according to the Plat thereof as recorded in Plat Book 27, Page 119, of the Public Records of Palm Beach County, Florida.

#### BOUNDARY SURVEY

**REVISIONS:** 

This survey is not valid without embossed surveyor's seal and/or an authenticated electronic signature and authenticated electronic seal.

Registered Land Surveyor, Florida Certificate No. MICHAEL J. MILLER #4034

Y220864

CRD. FILE

MILLER LAND SURVEYING

1121 LAKE AVENUE
LAKE WORTH BEACH, FLORIDA 33460
PHONE: (561) 586-2669 - FAX: (561) 582-0151
www.millersurveying.com
e-mail: orders@millersurveying.com

SCALE:

DRAWN BY:

FIELD WK:

DATE:

1" = 20' PICARD

M.M. / B.M.

08/01/2022

	M - 4.9	71 - A
	JOB NO.	Y220864
	PREV. JOB NO'S.	Y210769
)	REF:	L97/17 F46/53

Book

NORTH

00.00

b) \* existing elevation (NAVD 88 typical).

3.) No underground improvements located.4.) All bearings and distances shown hereon are plat and measured unless otherwise

5.) This firms "Certificate of Authorization" number is "LB 6838".

LEGEND:

	LEGENL	):								
I		- CALCULATED	(, )		PLAT		POINT OF INTERSECTION		_	ASPHALT PAVEMENT
1		CONCRETE BLOCK STRUCTURE			RADIUS	1 .0.0.	POINT OF COMMENCEMENT			7.01.17.21.7.77.2.11.2.77.
1		CONCRETE MONUMENT			CENTRAL "DELTA" ANGLE		POINT OF BEGINNING	200 27 23 517		CONCRETE FLATWORK
1	CONC. =	CONCRETE	L	=	ARC LENGTH	R/W =	RIGHT OF WAY		=	CONCRETE FLATWORK
1	D.E. =	DRAINAGE EASEMENT	CH.B.	=	CHORD BEARING	— × — × — =	CHAIN LINK FENCE	(XYXYXXX)		DAVED DDION EL ATIMOS
1	U.E. =	UTILITY EASEMENT	N.G.V.D.	=	NATIONAL GEODETIC VERTICAL DATUM	=	WOOD FENCE		=	PAVER BRICK FLATWOR
1		POOL EQUIPMENT	O.R.B.	=	OFFICIAL RECORD BOOK	<del></del>	METAL FENCE	$\overline{\odot}$	=	WOOD POWER POLE
1	F.F.EL. =	FINISHED FLOOR ELEVATION	P.B.	=	PLAT BOOK		CENTERLINE	₩M	=	WATER METER
1	EL. =	ELEVATION	P.C.	=	POINT OF CURVATURE		EASEMENT	~		FIRE HYDRANT
1	(B.R.) =	BEARING REFERENCE	P.T.	=	POINT OF TANGENCY	=	COVERED	<i>5</i> ₹0		
1	(D) =	= DEED	P.R.C.	=	POINT OF REVERSE CURVATURE	OHL	OVERHEAD LINES		=	CATCH BASIN
- 1	(8.4)		D 0 0		DOINT OF COMPOUND OUR WATURE		LOTITIE	GAM	_	CANITADY MANILOLE



Existing Street View Looking Morth



Existing Street View Looking Morth




Existing Street View Looking Morth



Existing Street View Looking West



Existing / treet View Looking East

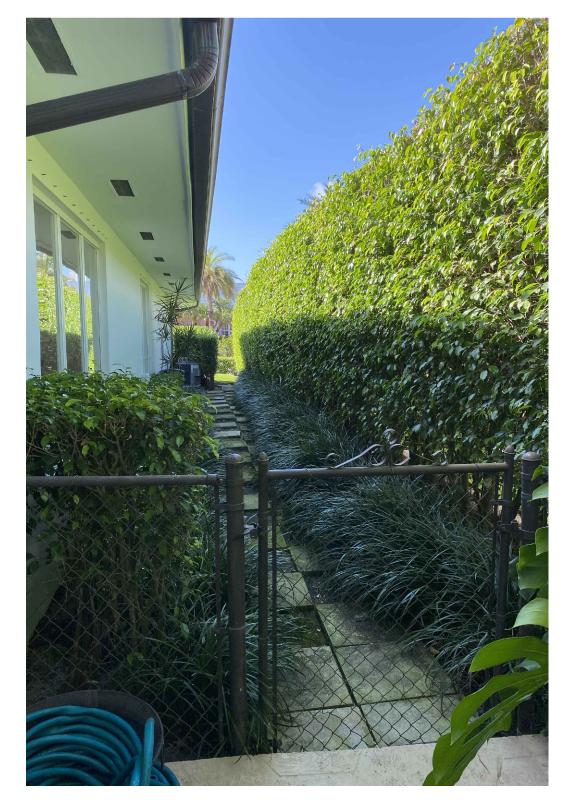

Ex. View to West Side Yard



Ex. View to West Side Yard

JOB NUMBER: # 22025.00 LA
DRAWN BY: Lauren Freeman
08.01.2022
09.06.2022
09.26.2022

✓HEET L1.0

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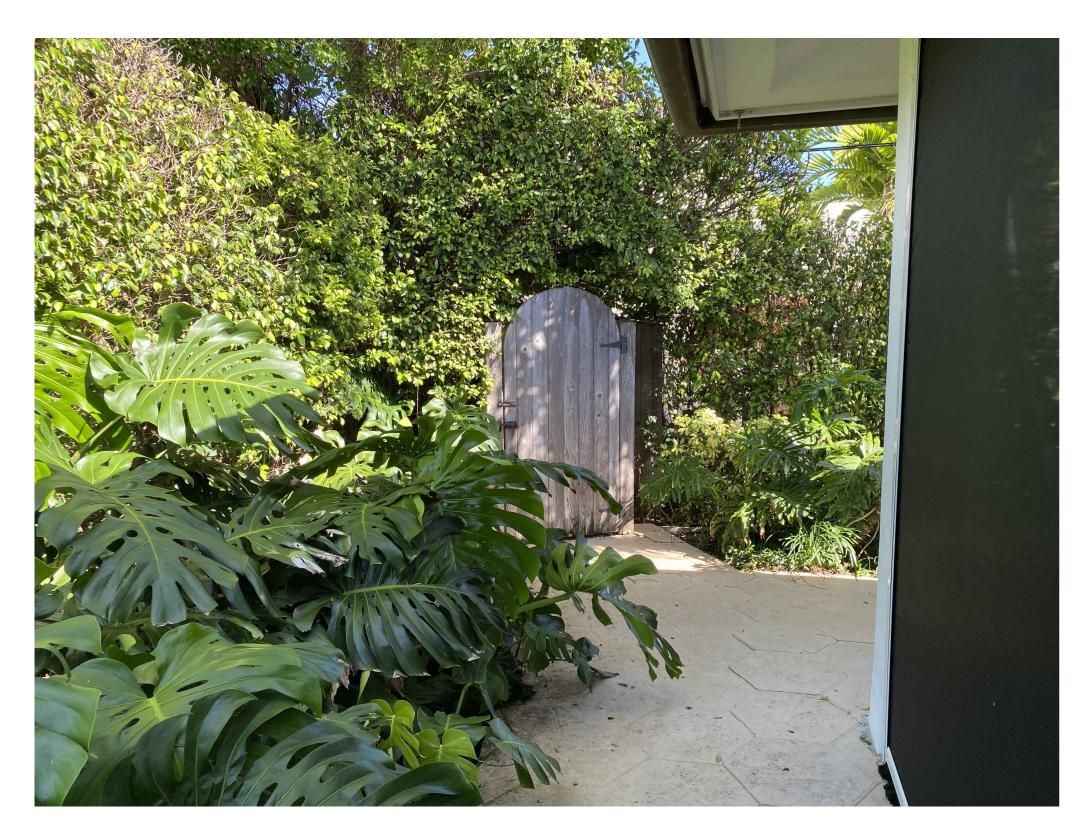
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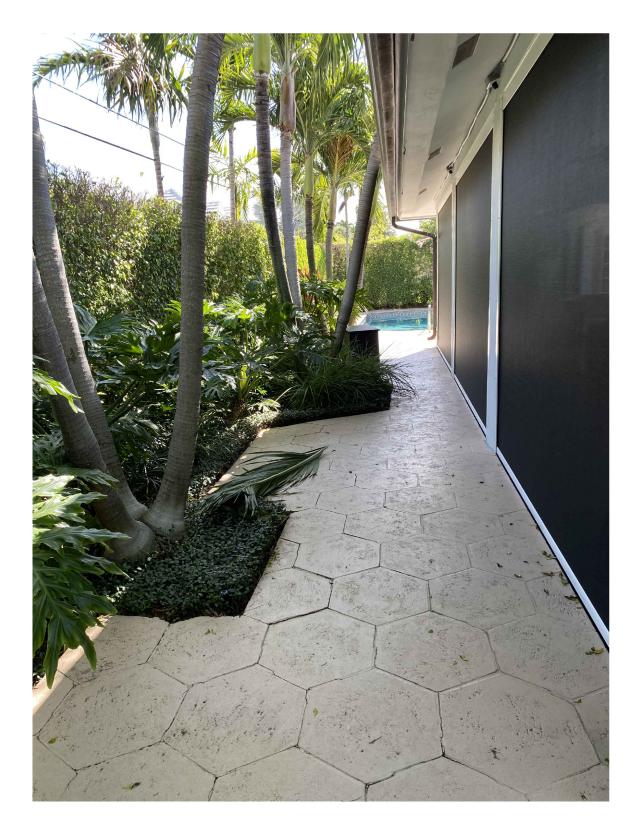
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1-800-432-4770

月/B-22-013 Existing Site Photos

Landscape Architecture Land Planning Landscape Management Dustin M. Mizell, MLA RLA #6666784 Dustin@environmentdesigngroup.com



Existing View to Morthwest Yard



Ex. View to Aorth Yard



Existing View to Mortheast Yard



Ex. View to East Yard



Ex. View to East Yard

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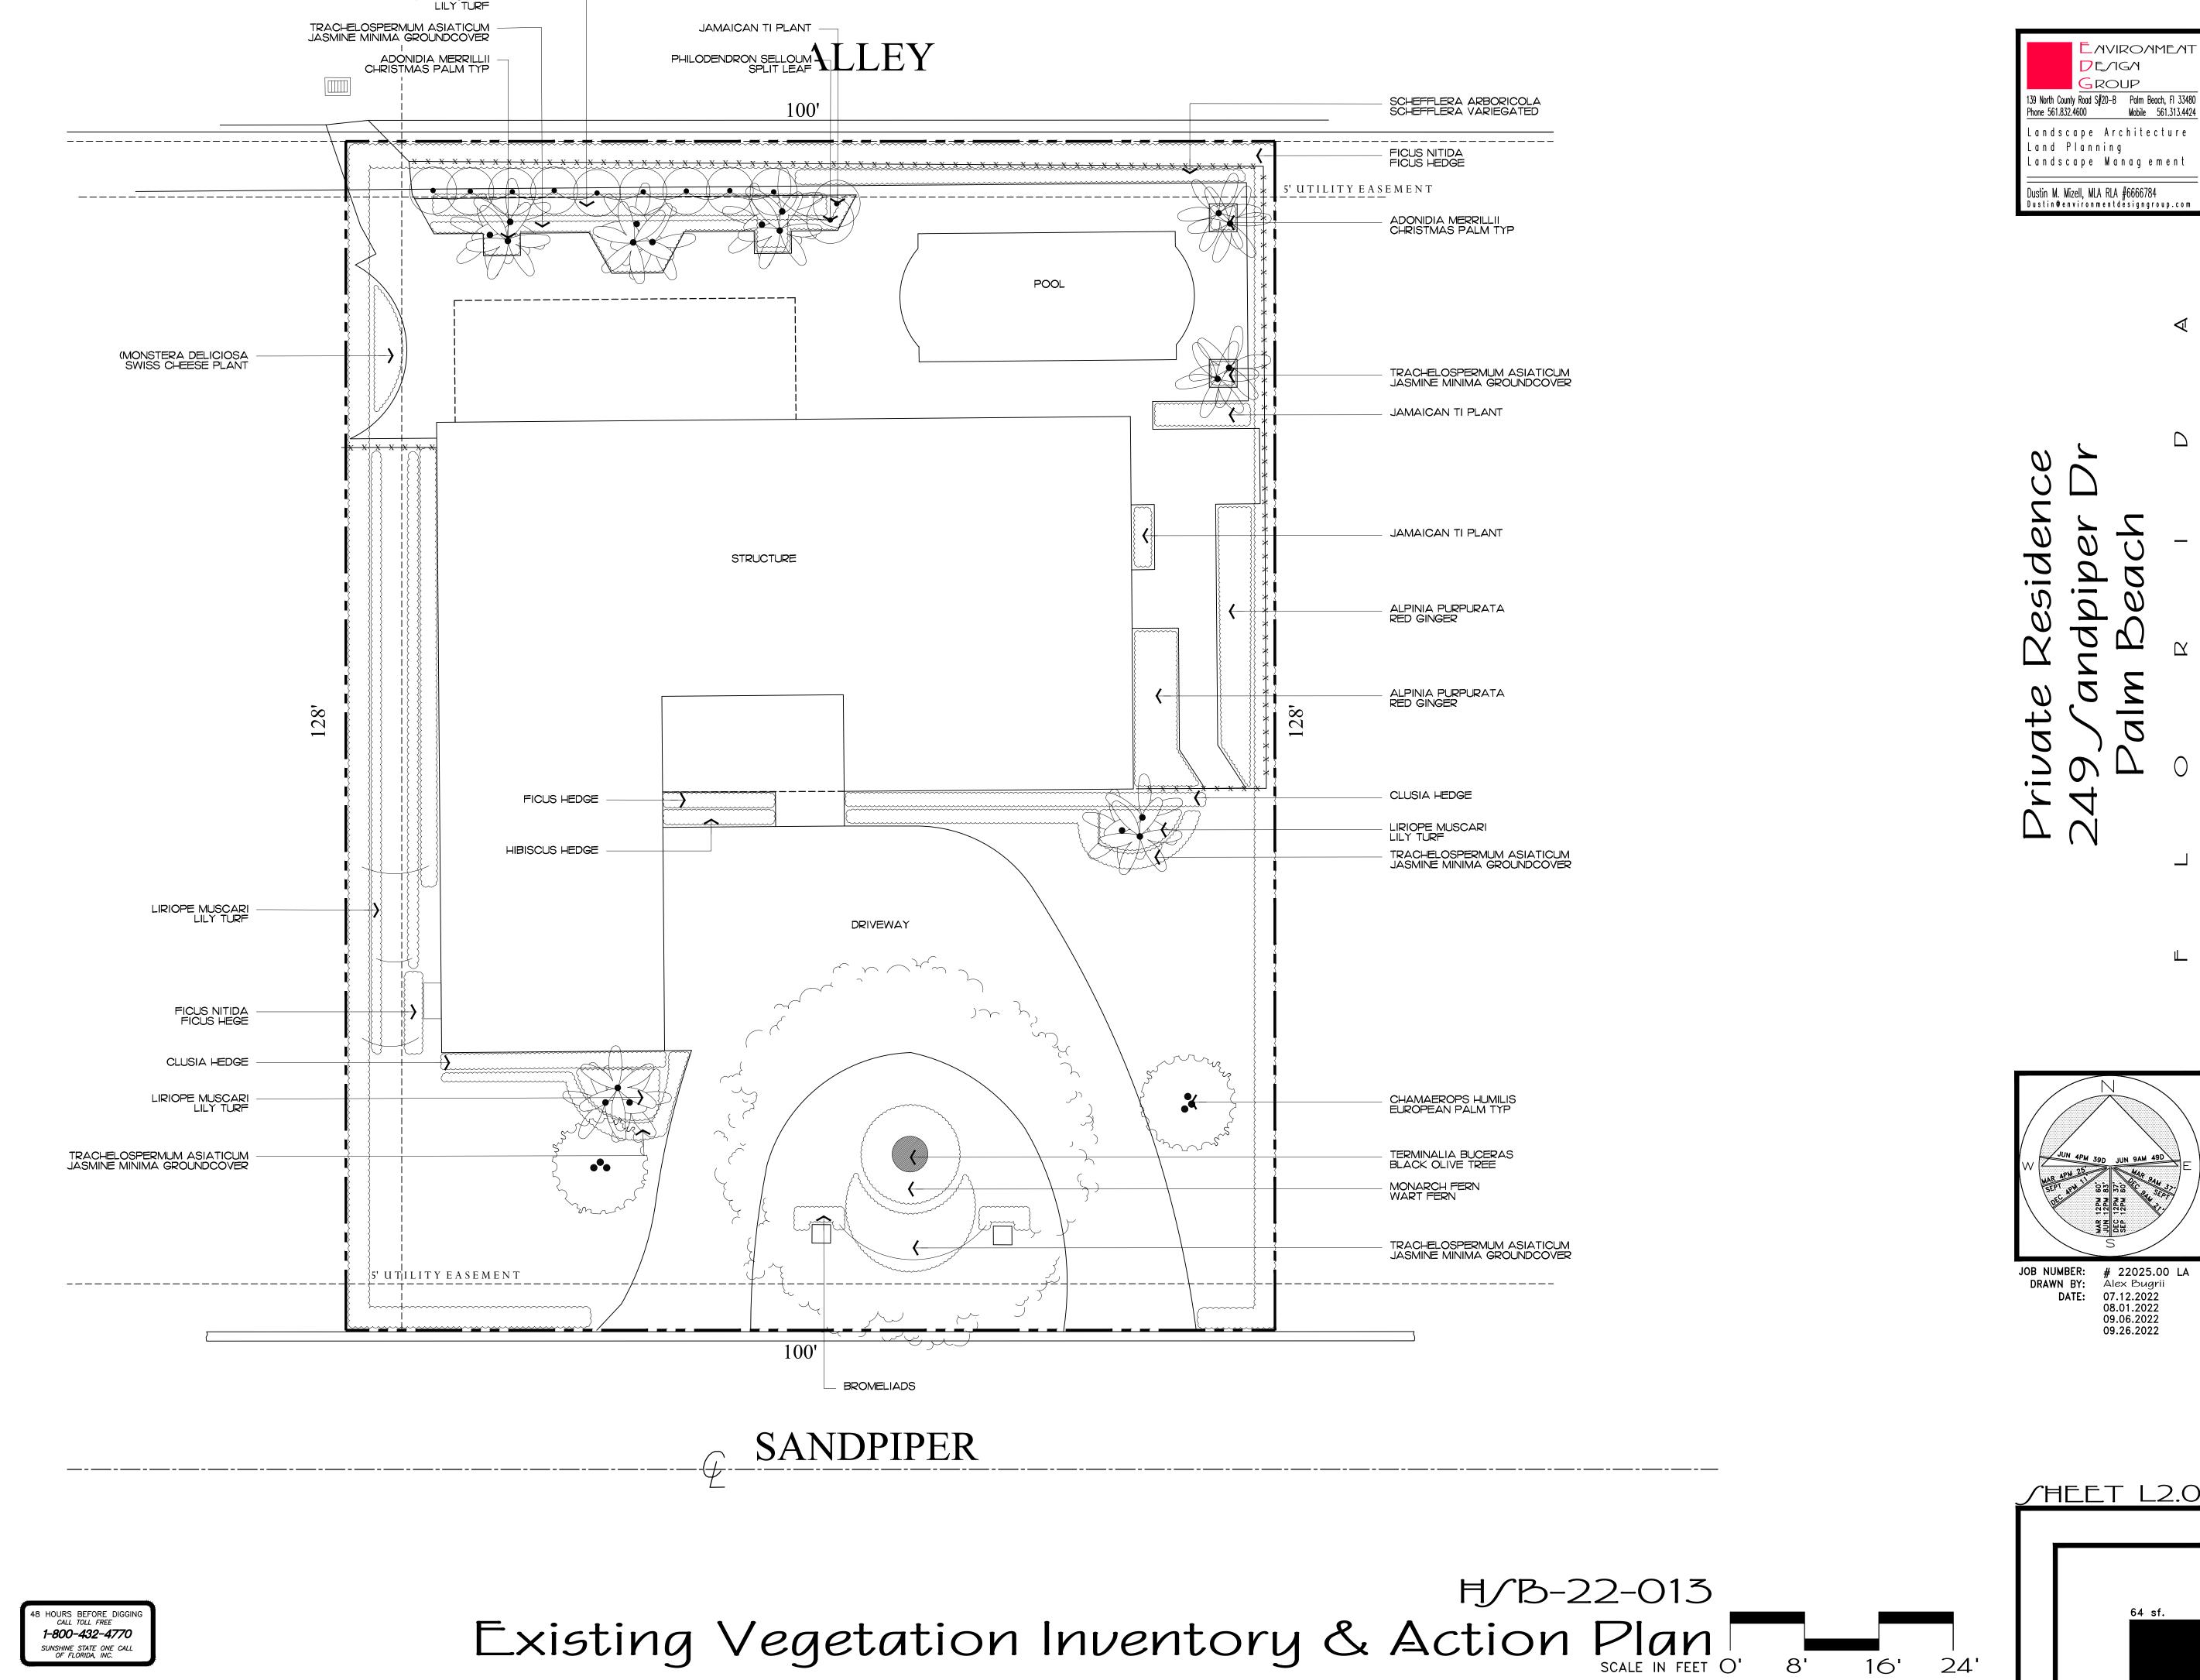
月/B-22-013 Existing Site Photos

**D**E/IG/I ROUP Landscape Architecture Land Planning Landscape Management Dustin M. Mizell, MLA RLA #6666784 Dustin@environmentdesigngroup.com


JOB NUMBER: # 22025.00 LA
DRAWN BY: Lauren Freeman

DATE: 08.01.2022
09.06.2022
09.26.2022


/HEET L1.1





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HAMMOND AVE.

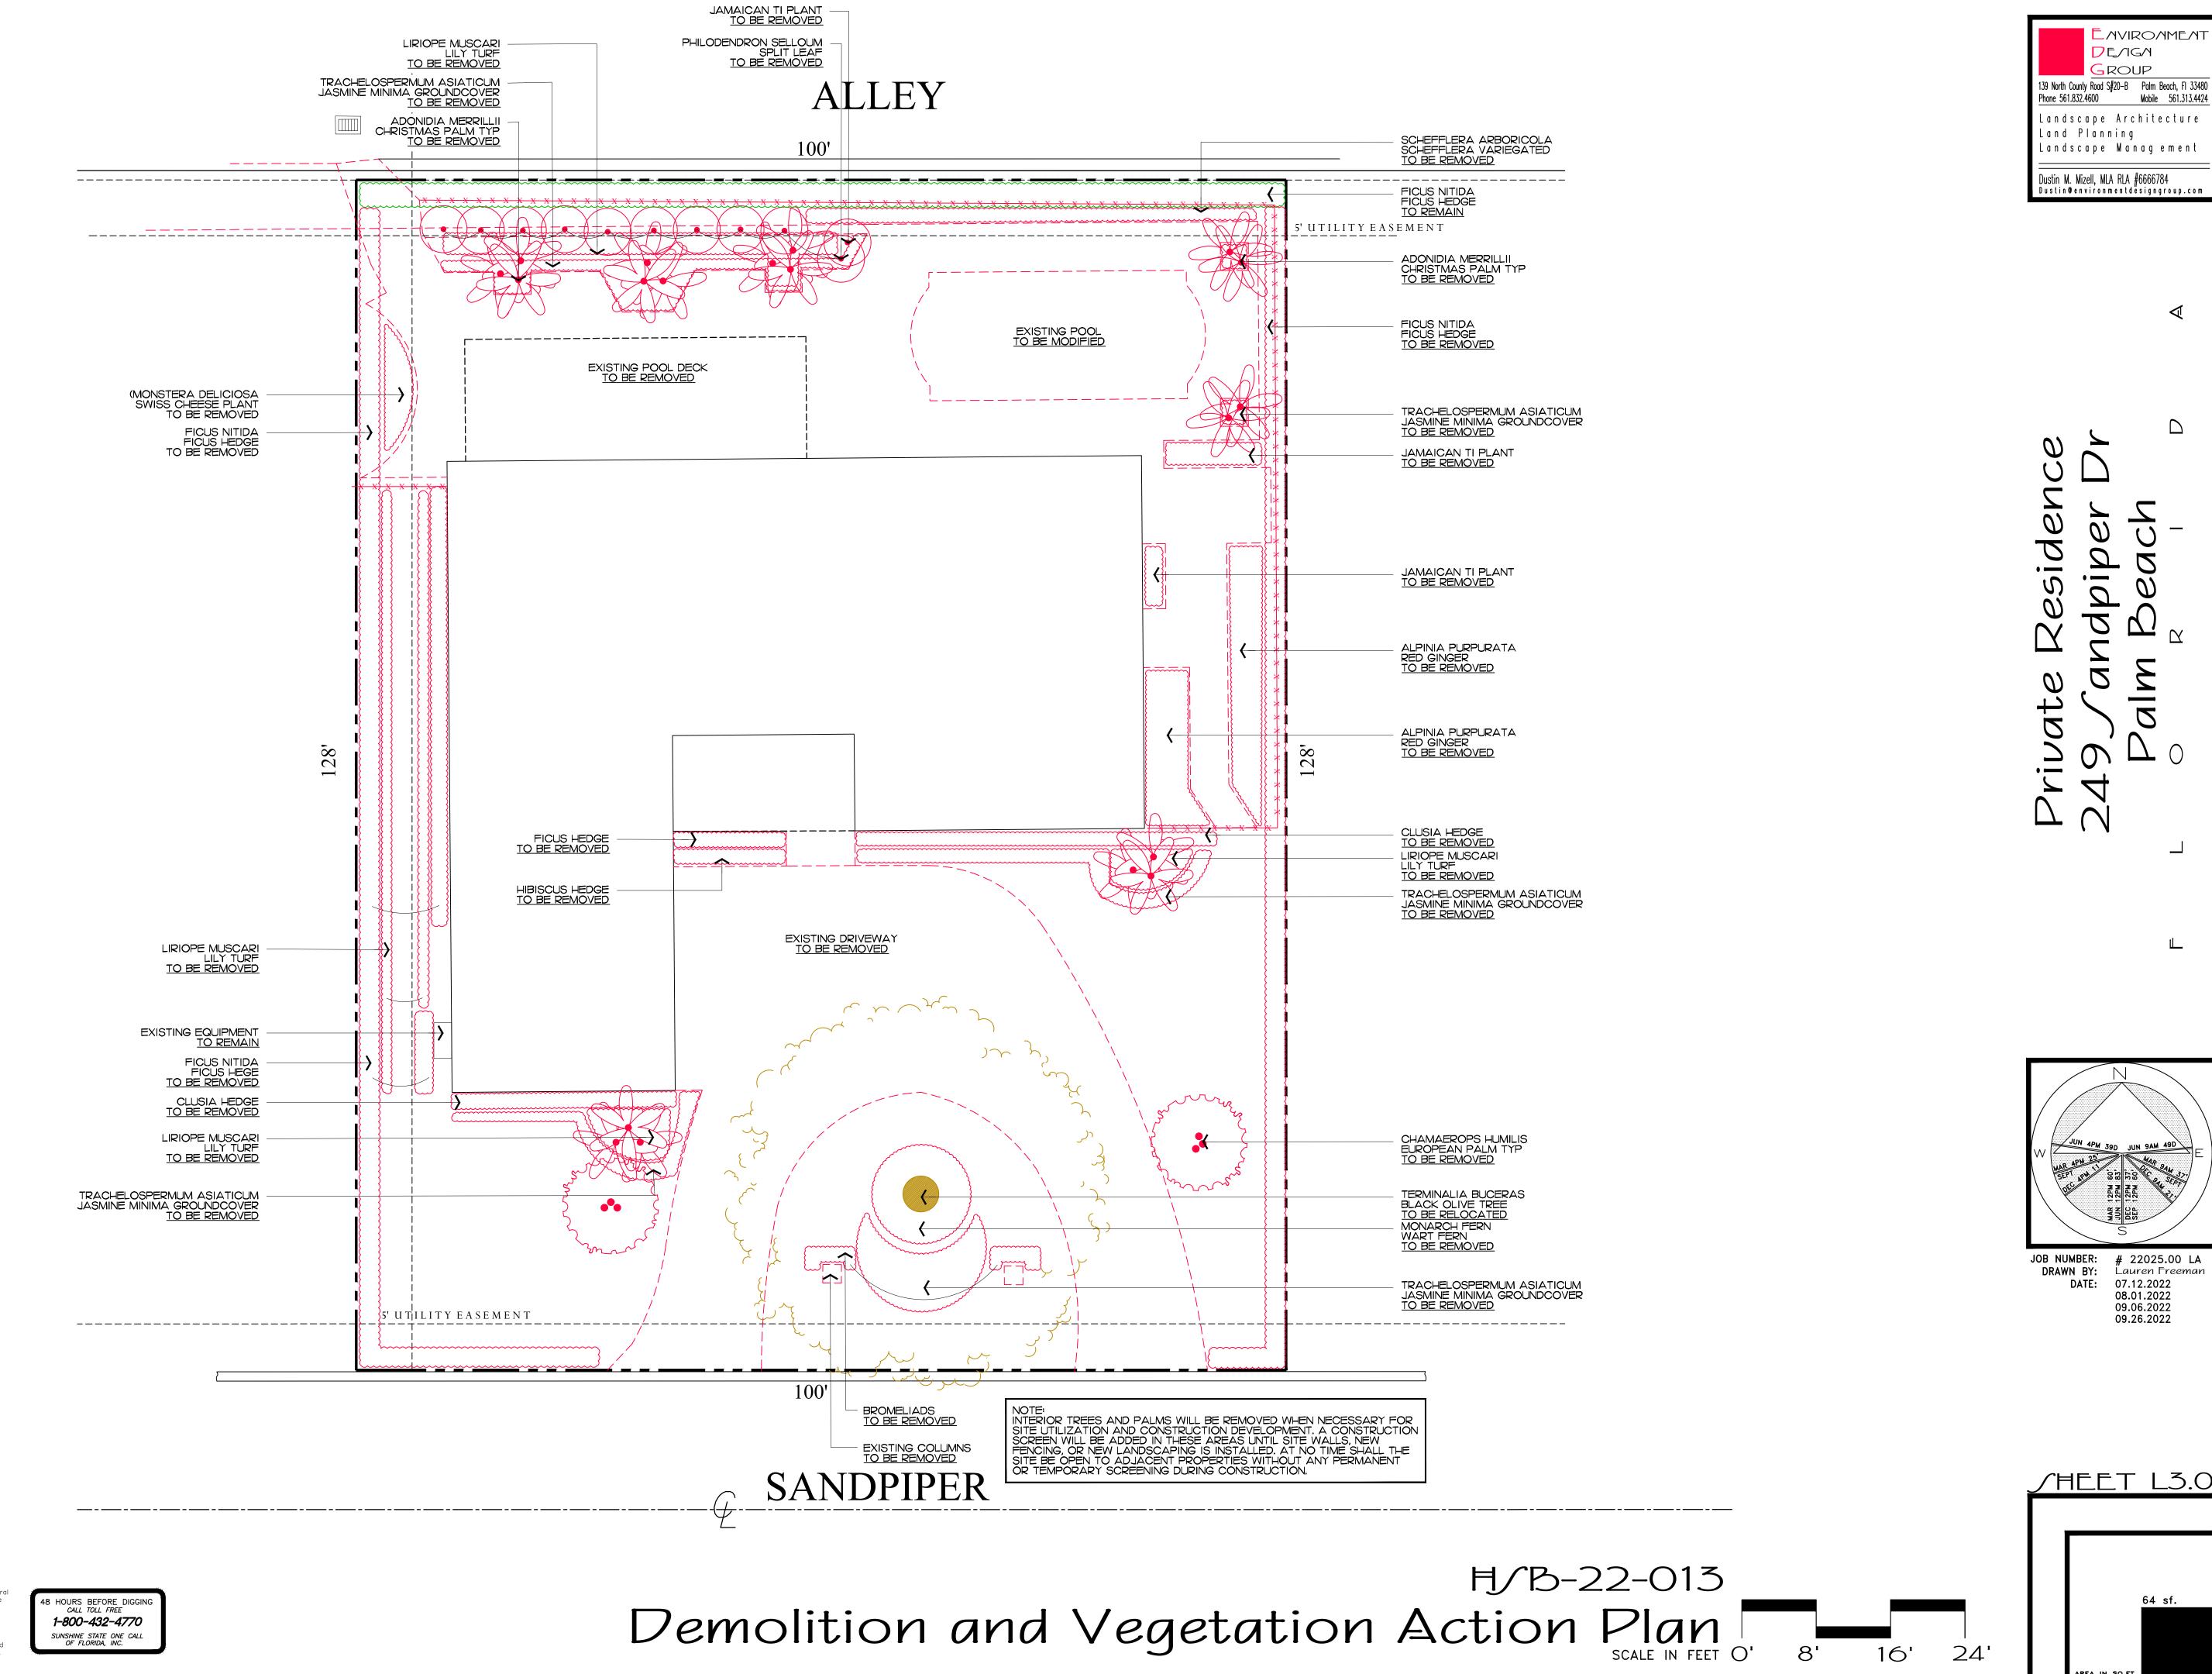

Residen

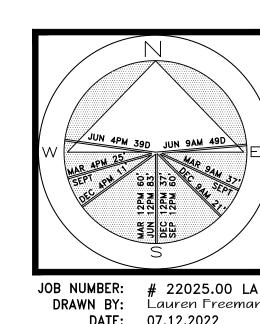dpi
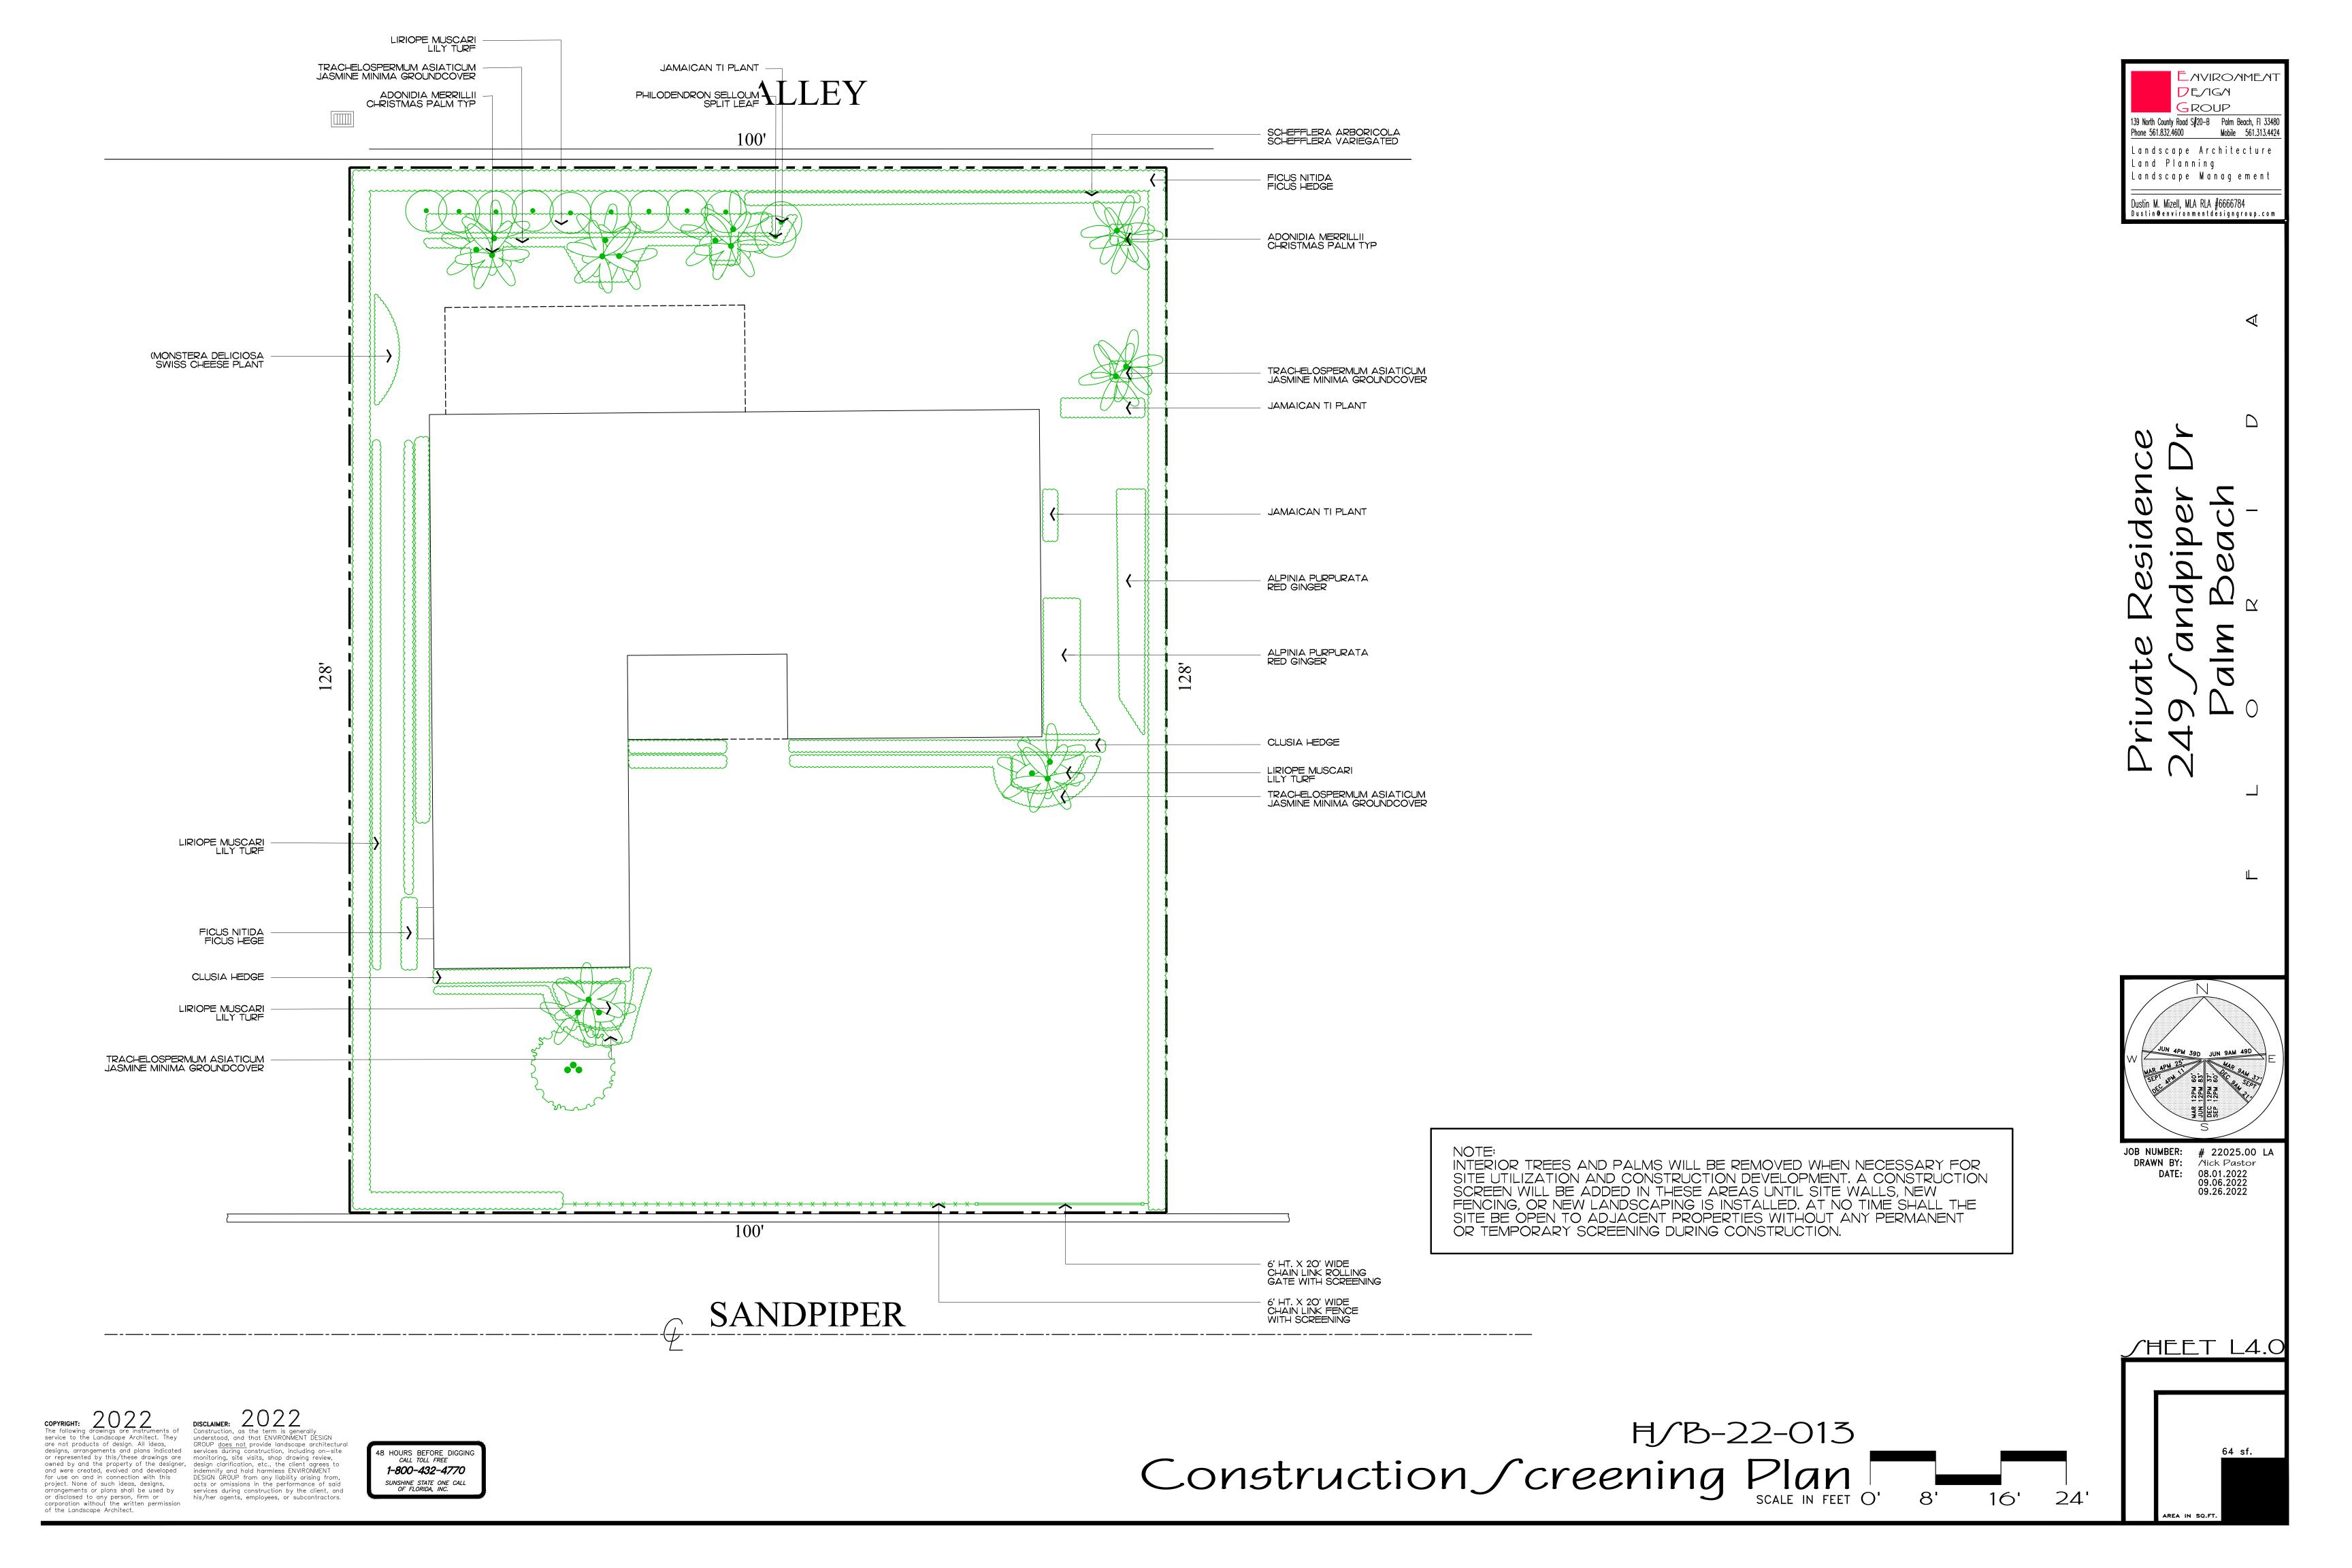
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DRAWN BY: Aick Pastor
DATE: 08.01.2022
09.06.2022
09.26.2022

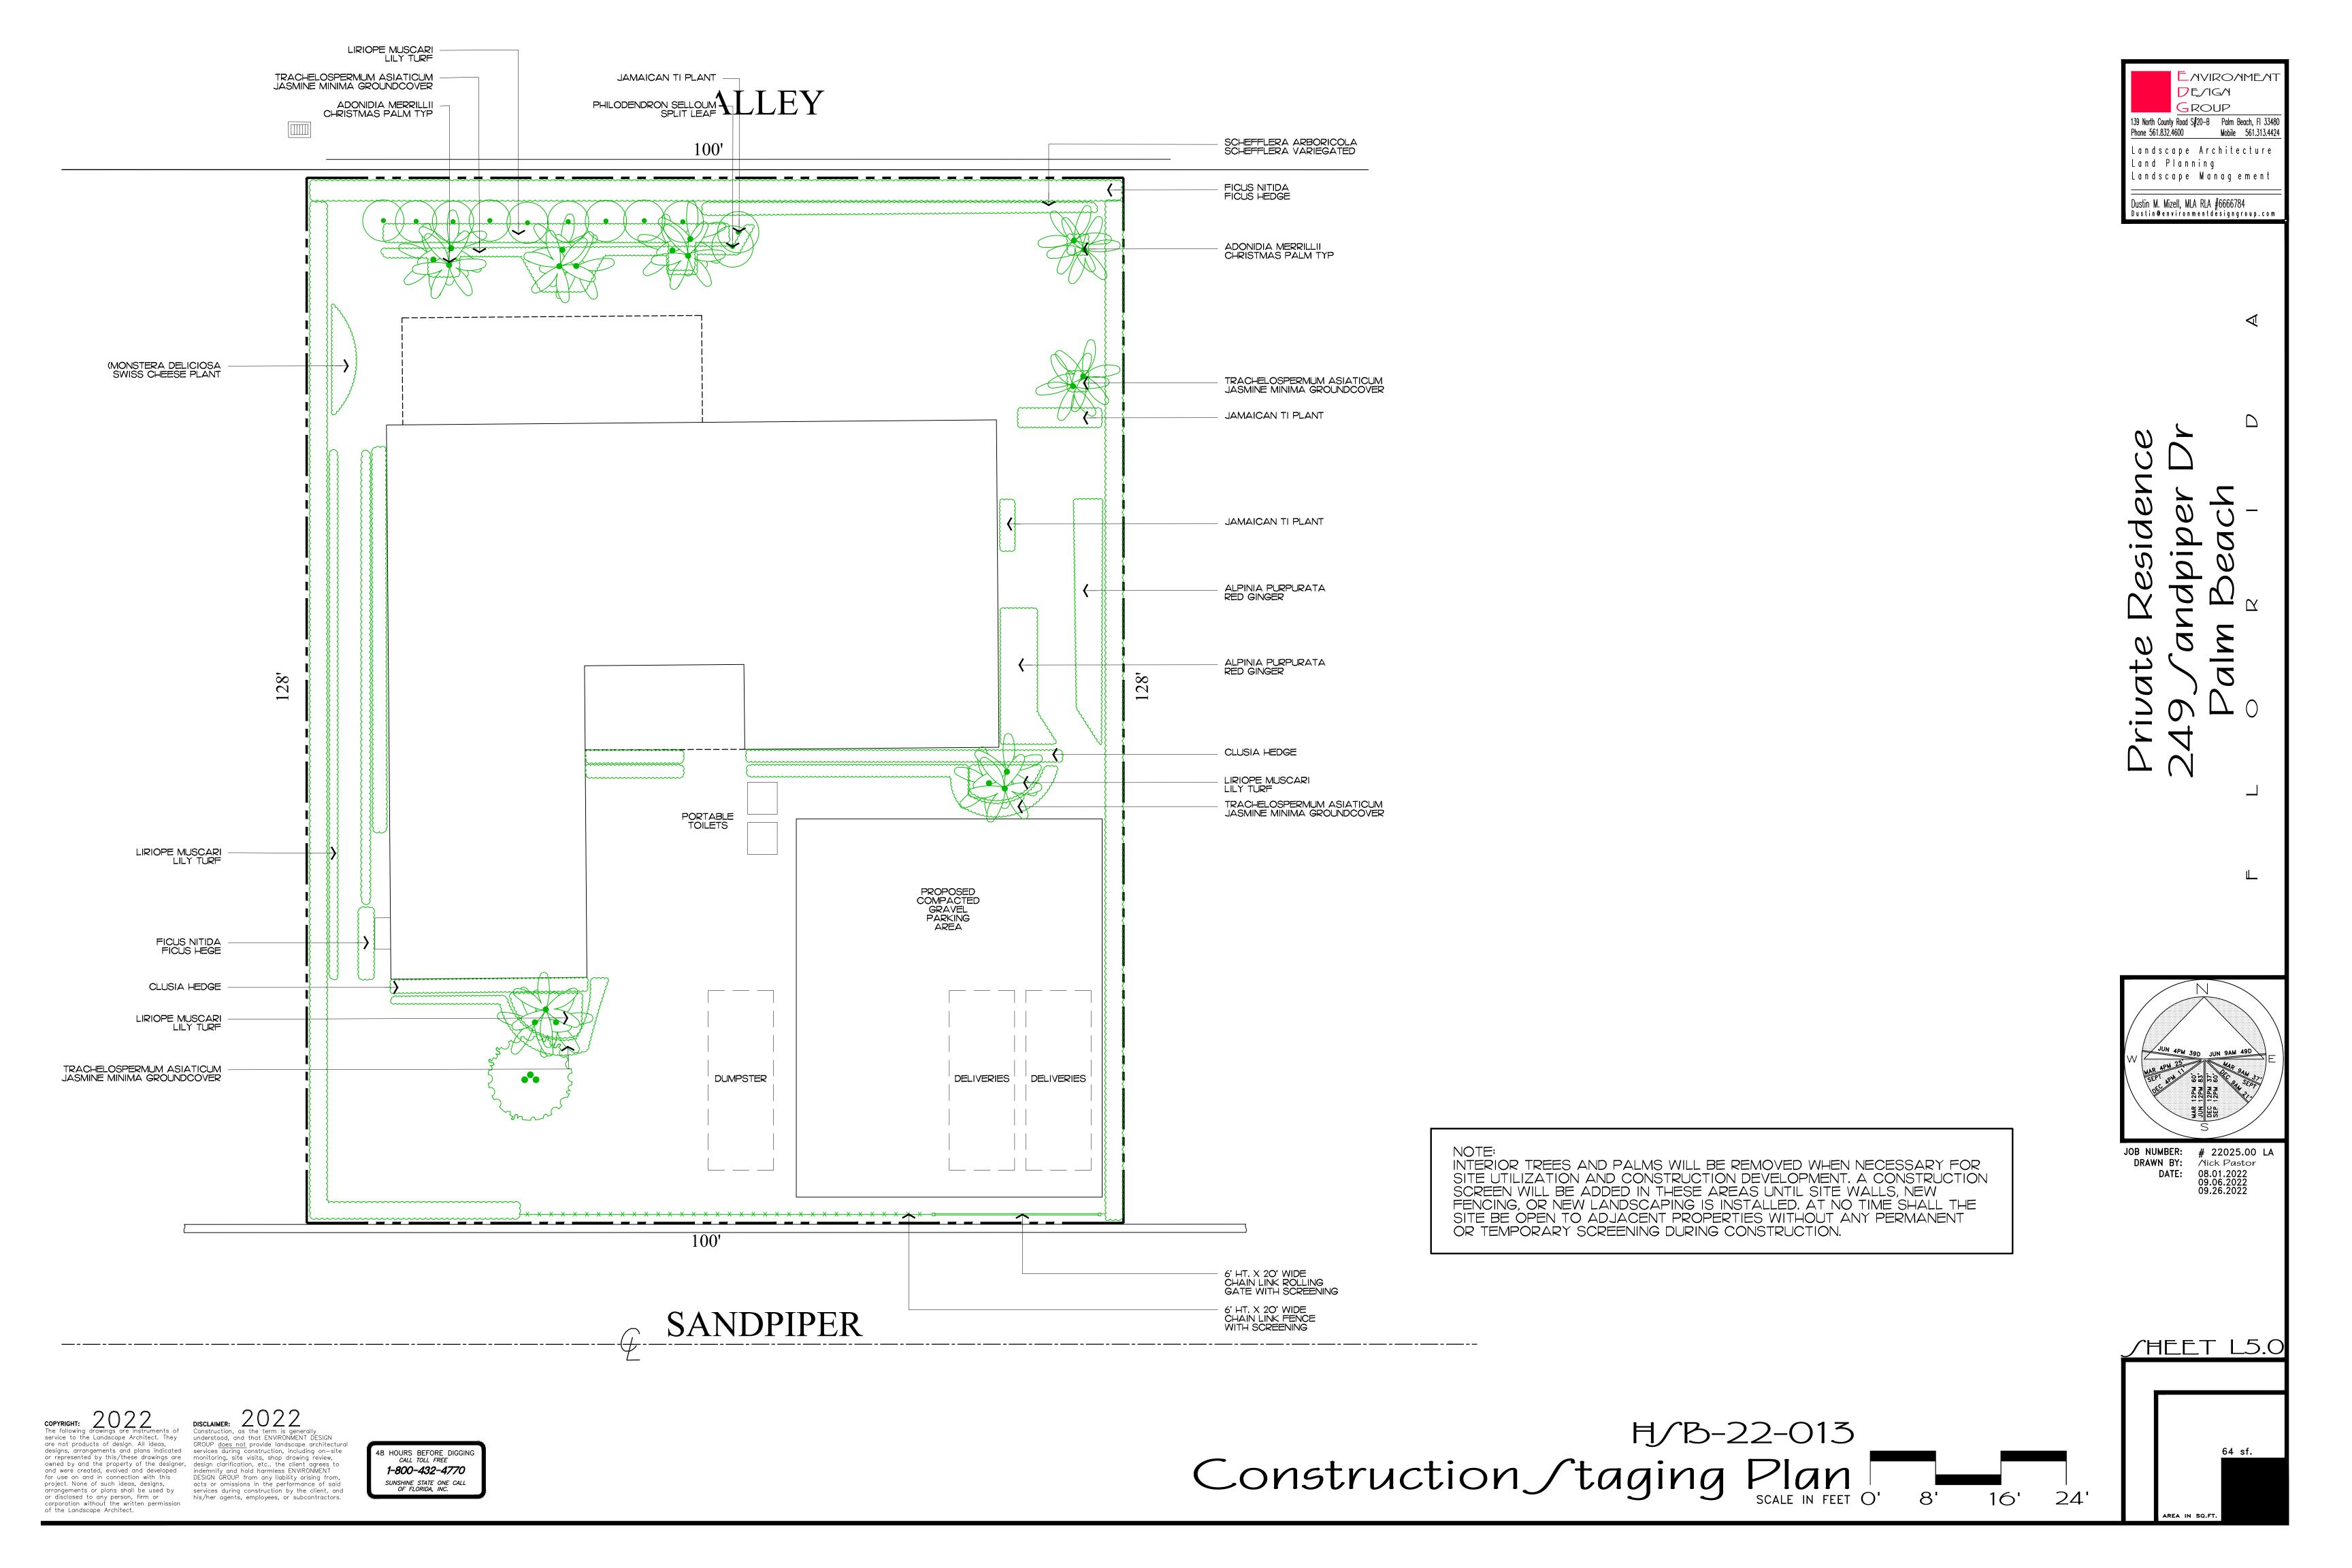/HEET L6.0

PROPOSED TRUCK INGRESS / EGRESS ROUTES MAP

SCHEDULE:

**MONTH 1: DEMOLITION AND CLEANUP** (3 - 5 DAYS)

LARGEST TRUCK ->

10-15 DUMP TRUCKS FOR DEBRIS REMOVAL TRAILER FOR EXCAVATOR / DEMOLITION LANDSCAPE TRUCKS -> IRRIGATION

NOTE: SEE SEPARATE "CONSTRUCTION STAGING PLAN" SHEET FOR INFORMATION ON LOCATIONS FOR PARKING, MATERIAL STORAGE, DELIVERIES, DUMPSTER, PORTABLE TOILETS, TIRE CLEANING AREA, SILT FENCE, ETC.

PROPOSED INGRESS TRUCK ROUTE

PROPOSED EGRESS TRUCK ROUTE

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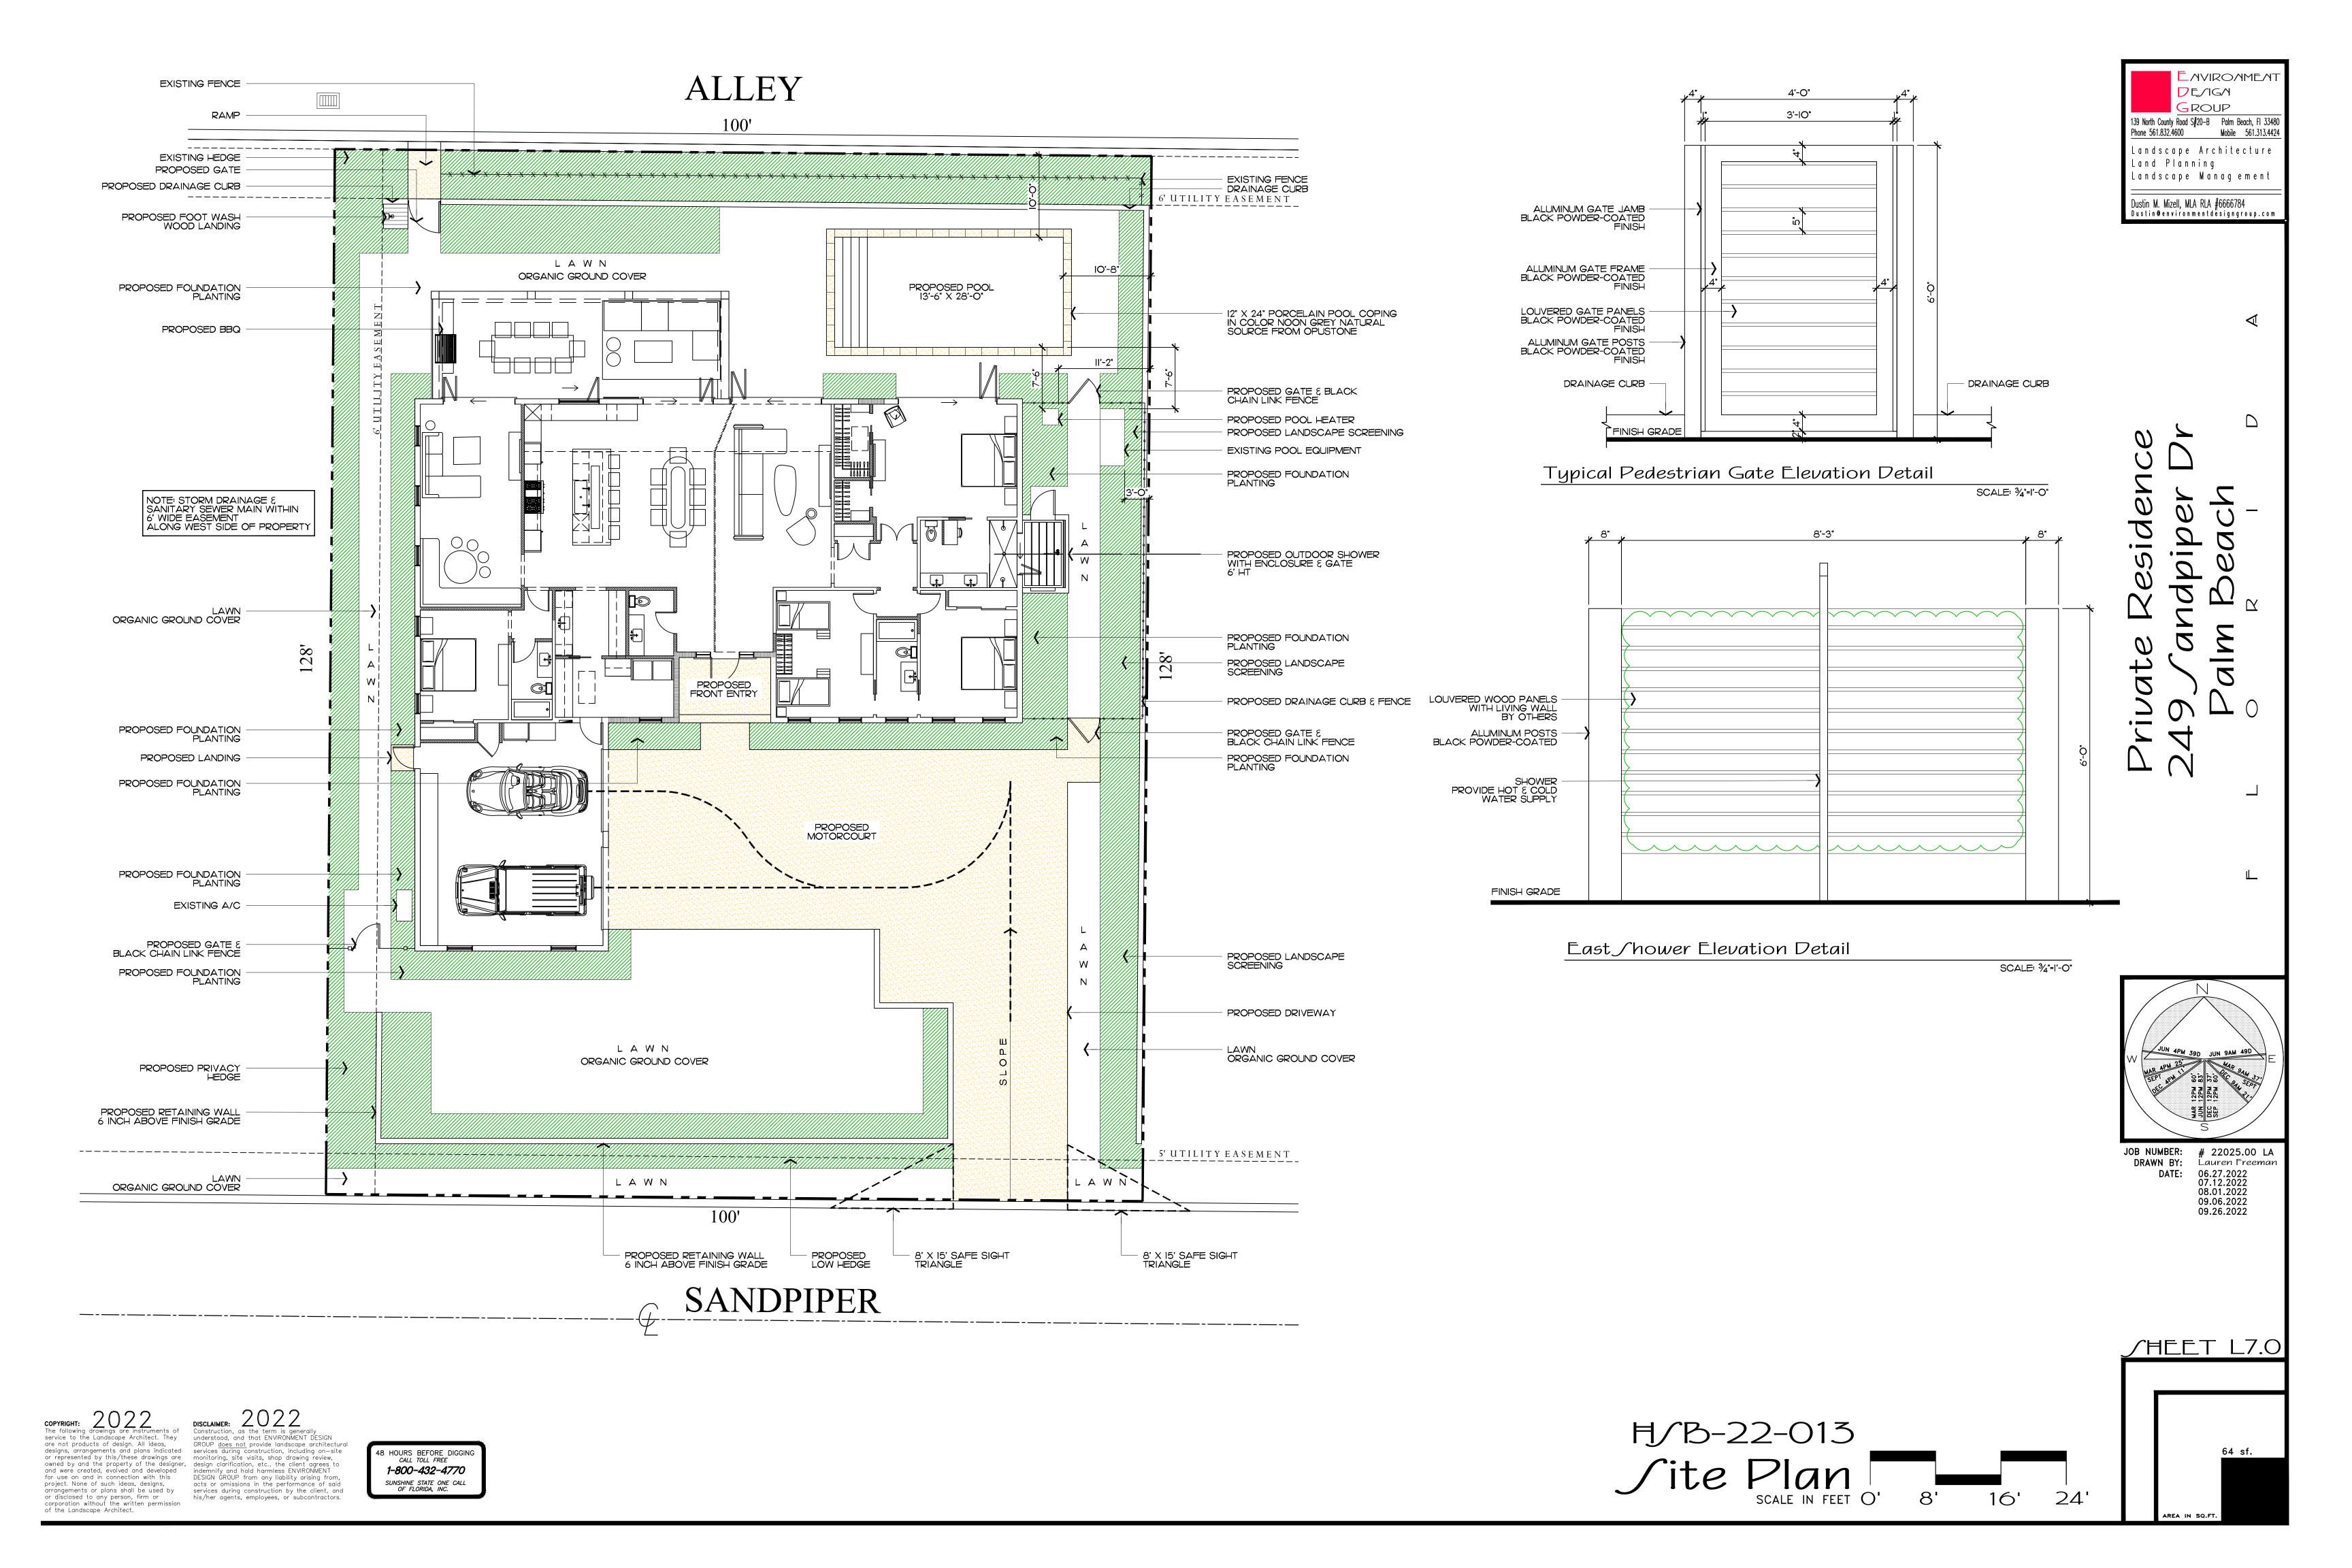
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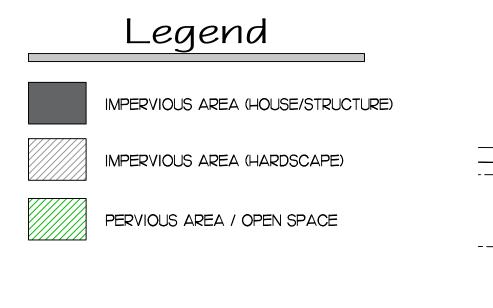
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H/B-22-013
Truck Logistics Plan
SCALE: NOT TO SCALE





## **ALLEY**

100'

**D**E/IG/I Landscape Architecture Land Planning Landscape Management


Dustin M. Mizell, MLA RLA #6666784 Dustin@environmentdesigngroup.com

JOB NUMBER: # 22025.00 LA
DRAWN BY: Alex Bugrii
07.12.2022
08.01.2022
09.06.2022
09.26.2022

/HEET L7.1

## Proposed Site Data

DESCRIPTION	REQUIRED		PROPOSED		
LOT ZONE			R-B - LOW DE	ENSITY RESIDENTIAL	
LOT AREA	10,000 S.F. MINIMUM		12,796 S.F.		
OPEN / PERMEABLE SPACE	MINIMUM 45%	5,758 S.F.	46.9%	6,006 S.F.	
FRONT YARD LANDSCAPE	MINIMUM 40% OF FRONT YARD	1,000 S.F.	81.9%	2,084 S.F.	
PERIMETER LANDSCAPE WITHIN 10' OF PROPERTY LINE	MINIMUM 50% OF REQ'D OPEN SPACE	2,879 S.F.	87.9%	3,654 S.F.	

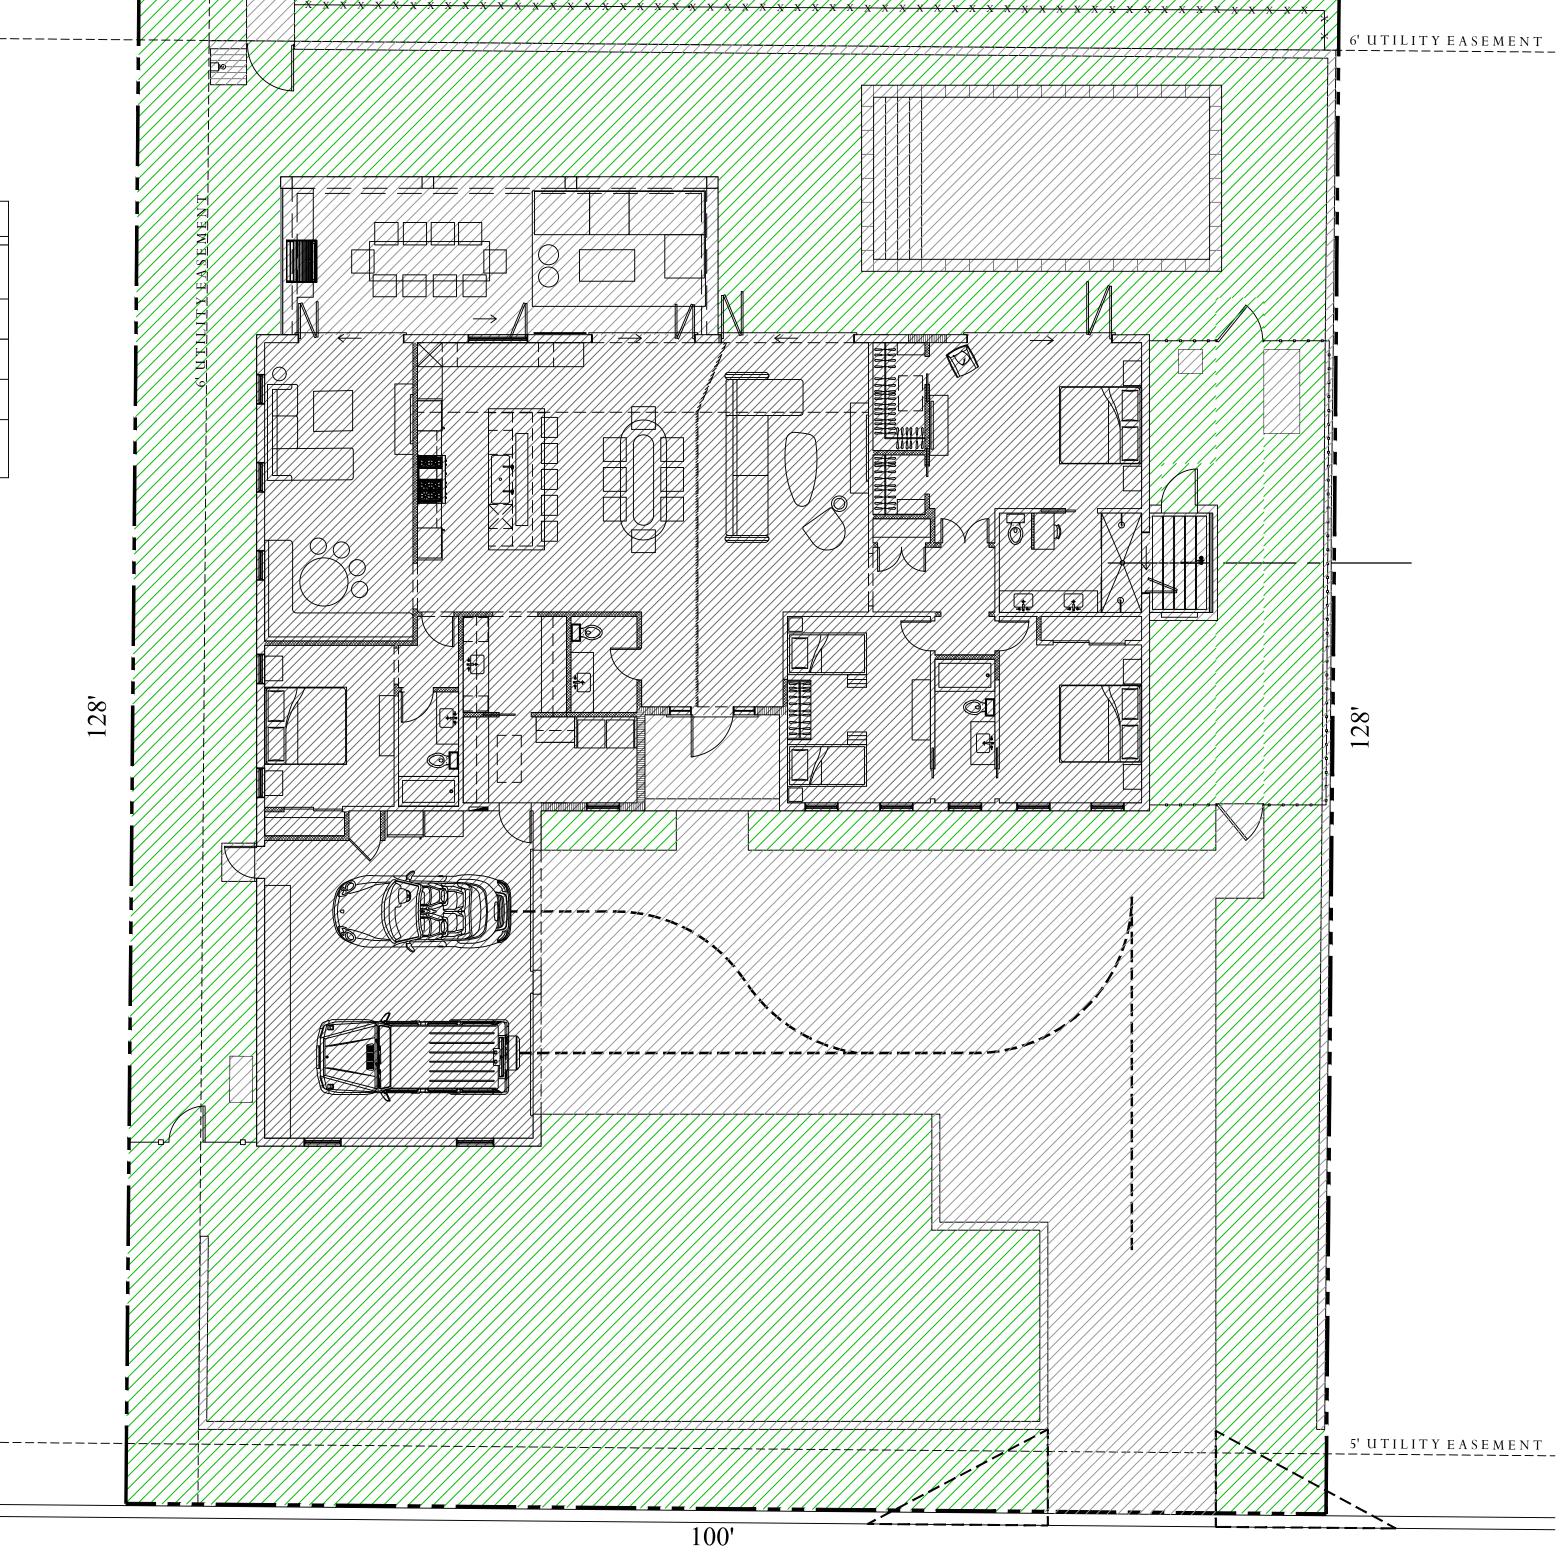

Landscape Open Space

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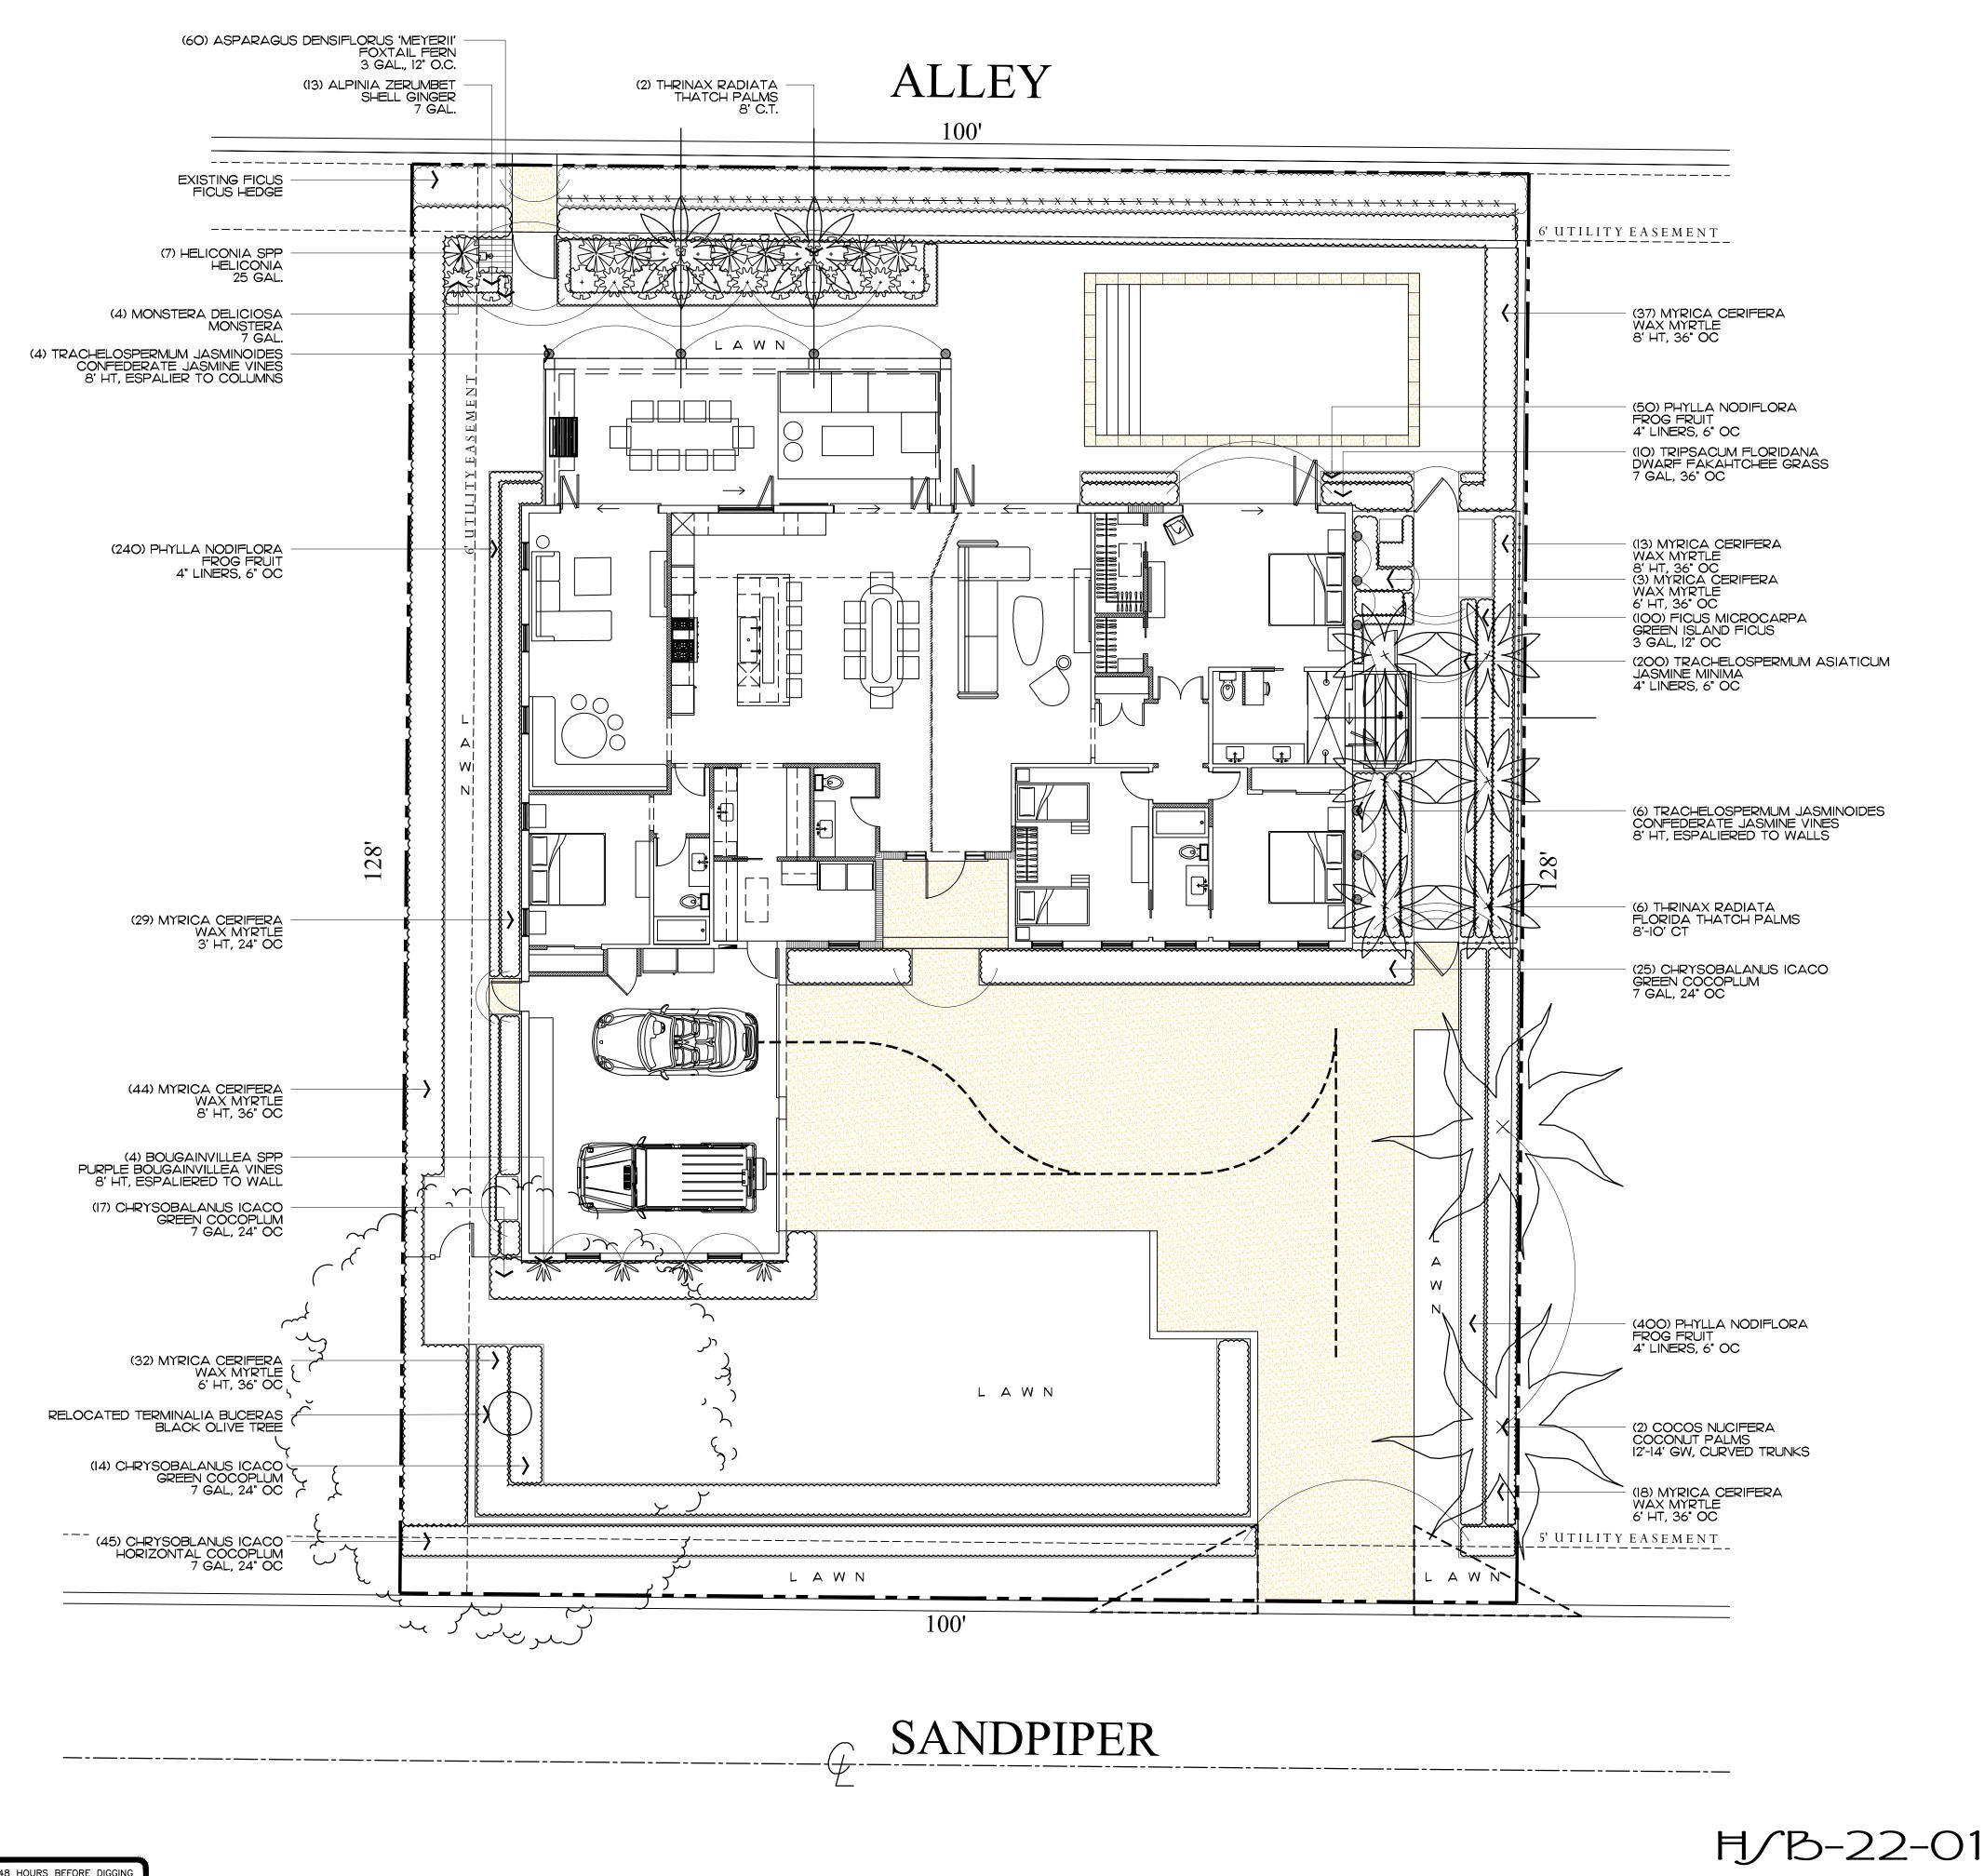
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#JB-22-013 Site Calculation/Lot Coverage Graphics



DE/IG/I ROUP 139 North County Road S#20-B Palm Beach, Fl 33481 Phone 561.832.4600 Mobile 561.313.4424 Landscape Architecture Land Planning Landscape Management Dustin M. Mizell, MLA RLA #6666784 Dustin@environmentdesigngroup.com

> <u>7</u> 65 • 7 •

 $\Box$ 

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DRAWN BY: Lauren Freeman
DATE: 06.27.2022

/HEET L8.0

AREA IN SQ.FT.

64 sf.

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H/B-22-013 Landscape Plan SCALE IN FEET O'

## Palms

SYMBOL	PLANT NAME	QTY.	DESCRIPTION	NATIVE
	COCOS NUCIFERA COCONUT PALM	2	12'-14' GW, CURVED TRUNKS	NO
A H A A A A A A A A A A A A A A A A A A	THRINAX RADIATA THATCH PALM	8	8'-10' CT	YES

TOTAL: 10 NATIVE SPECIES: 8 (80%)

## Shrubs

SYMBOL/KEY	PLANT NAME	QTY.	DESCRIPTION	NATIVE
\$\frac{1}{2}\frac{1}{2	ALPINIA ZERUMBET SHELL GINGER	13	7 GAL	NO
	CHRYSOBALANUS ICACO GREEN COCOPLUM	84	7 GAL, 24" OC	YES
	HELICONIA SPP HELICONIA	7	25 GAL	NO
5 + 3 5 + 3	MONSTERA DELICIOSA MONSTERA	7	25 GAL	NO
	MYRICA CERIFERA WAX MYRTLE HEDGE	29 53	3' HT, 24" OC 6' HT, 36" OC	YES
	TRIPSACUM FLORIDANA DWARF FAKAHATCHEE GRASS	94 IO	8' HT, 36" OC 3 GAL, 36" OC	YES

270 (90.9%)

## Vines, & Groundcovers

NATIVE SPECIES:

SYMBOL/KEY	PLANT NAME	QTY. DESCRIPTION		NATIVE
	ASPARAGUS DENSIFLORUS 'MEYERII' FOXTAIL FERN	60	3 GAL, 12" OC	NO
	BOUGAINVILLEA SPP PURPLE BOUGAINVILLEA VINES	4	8' HT, ESPALIERED TO WALLS	NO
	FICUS MICROCARPA GREEN ISLAND FICUS	100	3 GAL, 12" OC	NO
	PHYLLA NODIFLORA FROG FRUIT	690	3 GAL, 12" OC	YES
	TRACHELOSPERMUM ASIATICUM JASMINE MINIMA	200	4" LINERS, 6" OC	NO
	TRACHELOSPERMUM JASMINOIDES CONFEDERATE JASMINE VINES	10	8' HT, ESPALIERED TO WALLS	NO

1,064

690 (64.8%)

## Lawn & Mulch

	SYMBOL/KEY	PLANT NAME	QTY.	DESCRIPTION
	LAWN	DIAMOND ZOYSIA LAWN	AS NEEDED	SOD PALLETS
_	PLANTING BED	SHREDDED EUCALYPTUS MULCH	AS NEEDED	MULCH ALL BEDS 3" MIN. DEPTH

## **DE/IGN** Landscape Architecture Land Planning Landscape Management Dustin M. Mizell, MLA RLA #6666784 Dustin@environmentdesigngroup.com


# Native Landscape Legend

PROPERTY ADDRESS:	249 SANDPIPER DRIVE			
	REQUIRED	PROPOSED		
LOT SIZE (SQ FT)	10,000 SF	12,796 SF		
LANDSCAPE OPEN SPACE (LOS) (SQ FT AND %)	5,758 SF (MIN 45%)	6,006 SF (46.9%)		
PERIMTETER LOS (SQ FT AND %)	2,879 SF (MIN 50% LOS)	3,654 SF (87.9%)		
FRONT YARD LOS (SQ FT AND %)	1,000 SF (40% MIN)	2,084 SF (81.9%)		
NATIVE TREES %	N/A	N/A		
NATIVE PALMS %	35%	80%		
NATIVE SHRUBS %	35%	90.9%		
NATIVE VINES / GROUND COVER %	35%	64.8%		

Private 249 Sai

JOB NUMBER: # 22025.00 LA
DRAWN BY: Lauren Freeman
DATE: 07.12.2022

/HEET L8.2 Ħ/B-22-013 Plant∫chedule

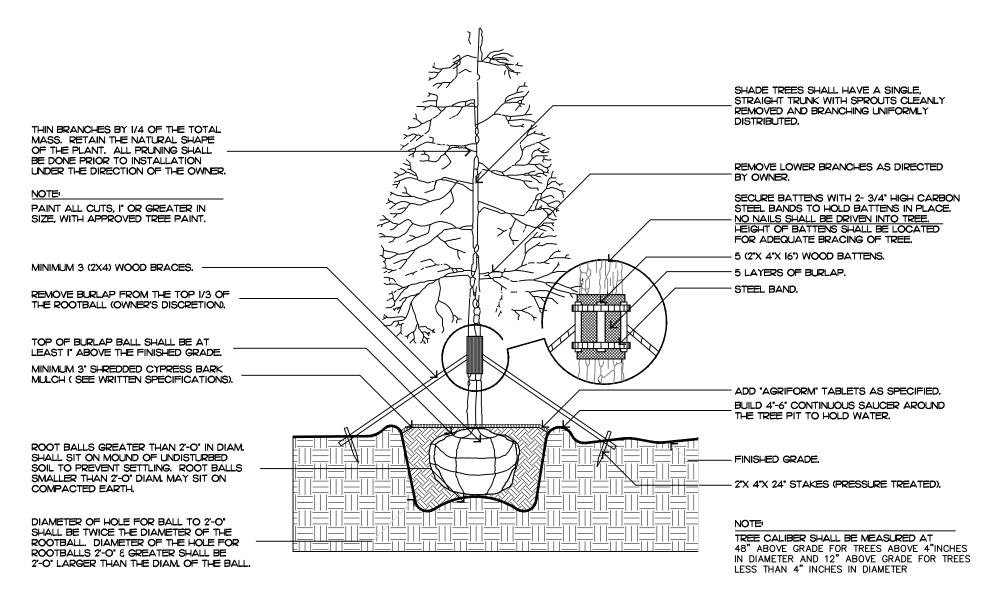

tree planting

MATERIAL SHALL CONSIST OF AT LEAST /3 NATIVE SOIL FROM THE HOLE DUG FOR THE PLANT. SEE SPECIFICATIONS FOR BACKFILL MIXTURE.

MASS. RETAIN THE NATURAL SHAPE

BE DONE PRIOR TO INSTALLATION


APPROVAL, AND DIRECTION BY THE

USE 1/2" DIAM, REINFORCED RUBBER

PRUNE LOWER BRANCHES AS PER


THE TREE PIT TO HOLD WATER.


- WHITE FLAGGING RIBBON.

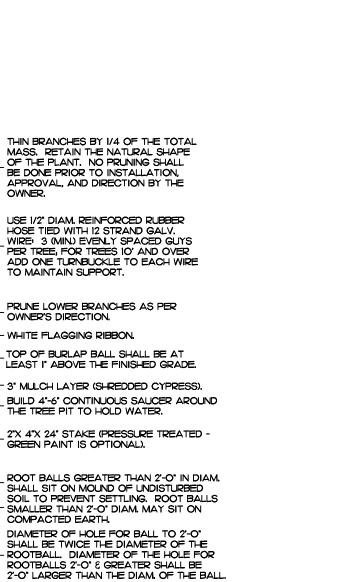


FILL MATERIAL SHALL CONSIST OF AT LEAST 1/3 NATIVE SOIL FROM THE HOLE DUG FOR THE PLANT. SEE SPECIFICATIONS FOR BACKFILL MIXTURE.

irregular and multi-stem tree

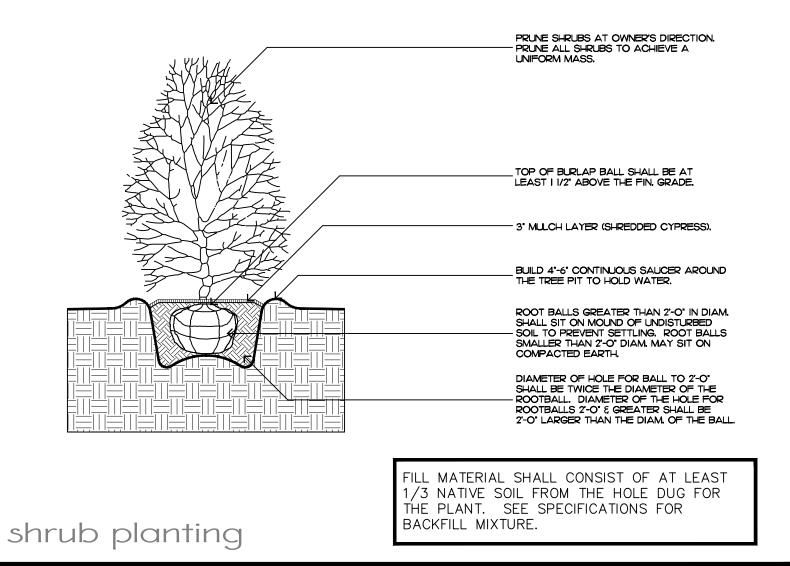

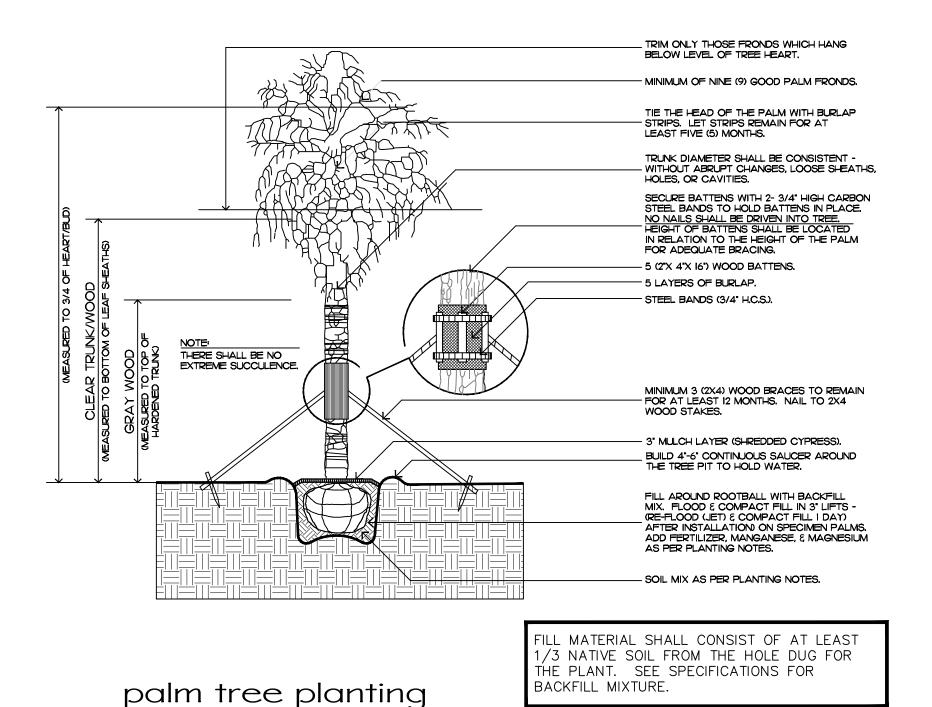

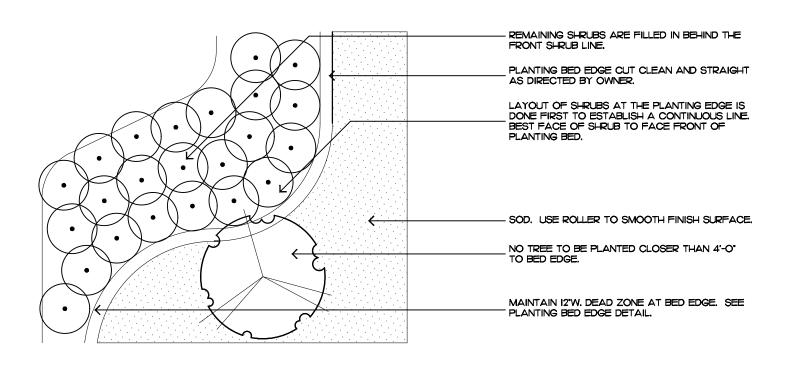

shrub & ground cover layout

## Planting Motes

### COMMERCIAL FERTILIZER:

FERTILIZER SHALL BE COMPLETELY ORGANIC, IT SHALL BE UNIFORM IN COMPOSITION, DRY AND FREE FLOWING. THIS FERTILIZER SHALL BE DELIVERED TO THE SITE IN THE ORIGINAL UNOPENED BAGS, EACH BEARING THE MANUFACTURER'S STATEMENT OF ANALYSIS, AND SHALL MEET THE FOLLOWING REQUIREMENTS:

SIX PERCENT (6%) PHOSPHOROUS

SIX PERCENT (6%) POTASSIUM

FERTILIZER SHALL BE APPLIED TO ALL SHRUBS (1/3 LB. PER 3 GAL. POT, 1/4 LB. PER 1 GAL. POT) AND GROUNDCOVER. THE SAME FERTILIZER MIXTURE SHALL BE USED ON SOD AT A RATE OF 15 LBS. PER 1000 SQUARE FEET. A FOURTEEN PERCENT (14%) NITROGEN, FOURTEEN PERCENT (14%) PHOSPHOROUS AND FOURTEEN PERCENT (14%) POTASSIUM IS REQUIRED ON ALL TREES AND SHRUBS OVER 5'-O" IN HEIGHT (1/2 LB. PER 5'-O" OF SPREAD). AGRIFORM TABLETS WITH TWENTY PERCENT (20%) NITROGEN, TEN PERCENT (10%) PHOSPHOROUS, FIVE PERCENT (5%) POTASSIUM IN 21 GRAM SIZES SHALL BE APPLIED ALONG WITH THE FERTILIZER PROCESS (I WITH I GAL. PLANTS, 2 WITH 3 GAL. PLANTS AND 2 TABLETS PER I" OF TREE TRUNK CALIPER). BACK FILL HALFWAY UP THE ROOT BALL. PLACE ABOUT ONE INCH (I") FROM ROOT TIPS. MAGNESIUM SULFATE SHALL BE APPLIED TO ALL PALMS AT INSTALLATION AT A RATE OF 1/2 LB. PER INCH OF TRUNK CALIPER. MANGANESE SHALL BE APPLIED AT THE SAME RATE.

### MULCH:

MULCH MATERIAL SHALL BE SHREDDED CYPRESS MULCH OR APPROVED EQUAL, MOISTENED AT THE TIME OF APPLICATION TO PREVENT WIND DISPLACEMENT. MULCH SHALL BE APPLIED TO A MINIMUM 3" DEPTH

### SOD:

THE SOD SHALL BE FREE FROM WEEDS, FUNGUS, INSECTS AND DISEASES OF ANY KIND, CLEAN, STRONGLY ROOTED, UNIFORMLY SIZED STRIPS, MACHINE STRIPPED NOT MORE THAN TWENTY-FOUR (24) HOURS

### JUB/TITUTION/:

NO SUBSTITUTION OF PLANT MATERIAL TYPES OR SIZES WILL BE ALLOWED WITHOUT WRITTEN AUTHORIZATION FROM THE OWNER. CONTAINER GROWN MATERIAL WILL NOT BE ACCEPTED AS SUBSTITUTE FOR BEB MATERIAL UNLESS PREVIOUSLY APPROVED. INTENDED SUBSTITUTIONS SHALL BE SPELLED OUT IN BID.

### MEA/UREMENT/:

HEIGHT SHALL BE MEASURED FROM GROUND TO THE AVERAGE BRANCH HEIGHT OF CANOPY. SPREAD SHALL BE MEASURED TO THE END OF THE BRANCHING EQUALLY AROUND THE CROWN FROM THE CENTER OF THE TRUNK. MEASUREMENTS ARE NOT TO INCLUDE ANY TERMINAL GROWTH. SINGLE TRUNK TREES SHALL BE FREE OF "V" CROTCHES THAT COULD BE POINTS OF WEAK LIMB STRUCTURE OR DISEASE INFESTATION.

HEIGHT SHALL BE MEASURED FROM THE GROUND TO THE AVERAGE POINT WHERE

MATURE PLANT GROWTH STOPS. SPREAD SHALL BE MEASURED TO THE END OF BRANCHING EQUALLY AROUND THE SHRUB MASS. MEASUREMENT AREA NOT TO INCLUDE ANY TERMINAL GROWTH.

CLEAR TRUNK (C.T.) - SHALL BE MEASURED FROM THE GROUND AT TIME OF INSTALLATION TO THE POINT WHERE THE MATURE AGED TRUNK JOINS THE IMMATURE OR GREEN PORTION

OVERALL HEIGHT (O.A.) - SHALL BE MEASURED FROM THE GROUND AT THE TIME OF INSTALLATION TO THE AVERAGE FROND HEIGHT.

PALMS WITH MARRED OR BURNED TRUNKS WILL NOT BE ACCEPTED.

### PLANTING JOIL AND BACKFILL:

PLANTING SOIL FOR USE IN PREPARING BACKFILL FOR PLANT PITS SHALL BE A FERTILE, FRIABLE AND NATURAL TOPSOIL, WITHOUT MIXTURE OF SUBSOIL MATERIALS, AND SHALL BE FREE FROM HEAVY CLAY STONES, LIME, LUMPS, SHELLS, PLANTS, ROOTS OR OTHER FOREIGN MATERIALS, WEEDS, OR NOXIOUS GRASSES (SUCH AS BERMUDA OR NUT GRASS). IT SHALL NOT CONTAIN TOXIC SUBSTANCES WHICH MAY BE HARMFUL TO THE PLANT GROWTH.

BACKFILL FOR SOD AREAS SHALL BE SUBJECT TO LESSER STANDARDS AT THE DISCRETION AND DECISION OF THE OWNER.

EXISTING TOPSOIL SHALL BE USED IN ALL PLANT MATERIAL PITS EXCEPT SABAL PALMS WHERE THE SOIL SHALL CONSIST OF CLEAN SAND.

PLANTING SOIL FOR USE IN BEDS FOR ANNUALS AND/OR PERENNIALS SHALL CONTAIN ONE-THIRD (1/3) POTTING SOIL OR A BLENDED TOPSOIL, TILL INTO TOP 10" - 12" OF SOIL WITH A TIME-RELEASE FERTILIZER.

### PLANT MATERIALS:

PALMS, TREES, SHRUBS, GROUNDCOVERS AND VINES

PLANT SPECIES AND SIZE SHALL CONFORM TO THOSE INDICATED ON THE DRAWINGS. NOMENCLATURE SHALL CONFORM TO "STANDARDIZED PLANT NAMES", 1942 EDITION. ALL NURSERY STOCK SHALL BE IN ACCORDANCE WITH "GRADES AND STANDARDS FOR NURSERY PLANTS PARTS I & II", LATEST EDITION PUBLISHED BY THE FLORIDA DEPARTMENT OF AGRICULTURE AND CONSUMER SERVICES. UNLESS SPECIFIED OTHERWISE, ALL PLANTS SHALL BE FLORIDA GRADE NUMBER I OR BETTER AS DETERMINED BY THE FLORIDA DIVISION OF PLANT INDUSTRY. SPECIMEN MEANS AN EXCEPTIONALLY HEAVY, SYMMETRICAL TIGHTLY KNIT PLANT, SO TRAINED OR FAVORED IN ITS DEVELOPMENT THAT FIRST APPEARANCE IS UNQUESTIONABLE AND OUTSTANDINGLY SUPERIOR IN FORM, NUMBER OF BRANCHES, COMPACTNESS AND SYMMETRY. ALL PLANTS SHALL BE FRESHLY DUG, SOUND, HEALTHY, VIGOROUS, WELL BRANCHED AND FREE OF DISEASE AND INSECT EGGS AND LARVAE AND SHALL HAVE ADEQUATE ROOT SYSTEMS. TREES FOR PLANTING ROWS SHALL BE UNIFORM IN SIZE AND SHAPE. ALL MATERIALS SHALL BE SUBJECT TO APPROVAL BY THE OWNER. WHERE REQUIREMENTS ARE OMITTED FROM THE PLANT LIST, THE PLANTS FURNISHED SHALL BE NORMAL FOR THE VARIETY AND FLORIDA NUMBER 1. PLANTS SHALL BE PRUNED PRIOR TO DELIVERY ONLY UPON THE APPROVAL OF THE OWNER.

### CONTAINER GROWN / TOCK:

ALL CONTAINER GROWN MATERIAL SHALL BE HEALTHY, VIGOROUS, WELL-ROOTED PLANTS AND ESTABLISHED IN THE CONTAINER IN WHICH THEY ARE SOLD. THE PLANTS SHALL HAVE TOPS OF GOOD QUALITY AND BE IN A HEALTHY GROWING CONDITION.

AN ESTABLISHED CONTAINER GROWN PLANT SHALL BE TRANSPLANTED INTO A CONTAINER AND GROWN IN THAT CONTAINER SUFFICIENTLY LONG ENOUGH FOR THE NEW FIBROUS ROOTS TO HAVE DEVELOPED SO THAT THE ROOT MASS WILL RETAIN ITS SHAPE AND HOLD TOGETHER WHEN REMOVED FROM THE

### WARRANTY:

WARRANTY PLANTS, SHRUBS AND GROUNDCOVERS FOR A PERIOD OF NINETY (90) DAYS; TREES  $\xi$  PALMS FOR ONE YEAR (I) AGAINST UNHEALTHY CONDITION, EXCEPT AS MAY RESULT FROM NEGLECT BY OWNER, DAMAGE BY OTHERS, AND UNUSUAL PHENOMENA BEYOND INSTALLER'S CONTROL. REPLACE AT TIME REQUESTED BY THE OWNER OR LANDSCAPE ARCHITECT.

### MAINTENANCE:

MAINTAIN LANDSCAPE WORK UNTIL THE LETTER OF SUBSTANTIAL COMPLETION BY THE GENERAL CONTRACTOR. INCLUDE WATERING, WEEDING, CULTIVATING, RESTORATION OF GRADE, MOWING AND TRIMMING GRASS, PRUNING TREES AND SHRUBS, PROTECTION FROM INSECTS AND DISEASES, FERTILIZATION AND SIMILAR OPERATIONS AS NEEDED TO ENSURE NORMAL GOOD HEALTH FOR LIVE PLANT MATERIAL.

Planting Details & Specifications

• —

AVIROMMEN'

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Landscape Management

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Land Planning

ROUP

JOB NUMBER: # 22025.00 LA Lauren Freeman 07.12.2022 08.01.2022 09.06.2022 09.26.2022

/HEET L8.3




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48 HOURS BEFORE DIGGING CALL TOLL FREE 1-800-432-4770 SUNSHINE STATE ONE CALL OF FLORIDA, INC.





JOB NUMBER: # 22025.00 LA
DRAWN BY: Lauren Freeman

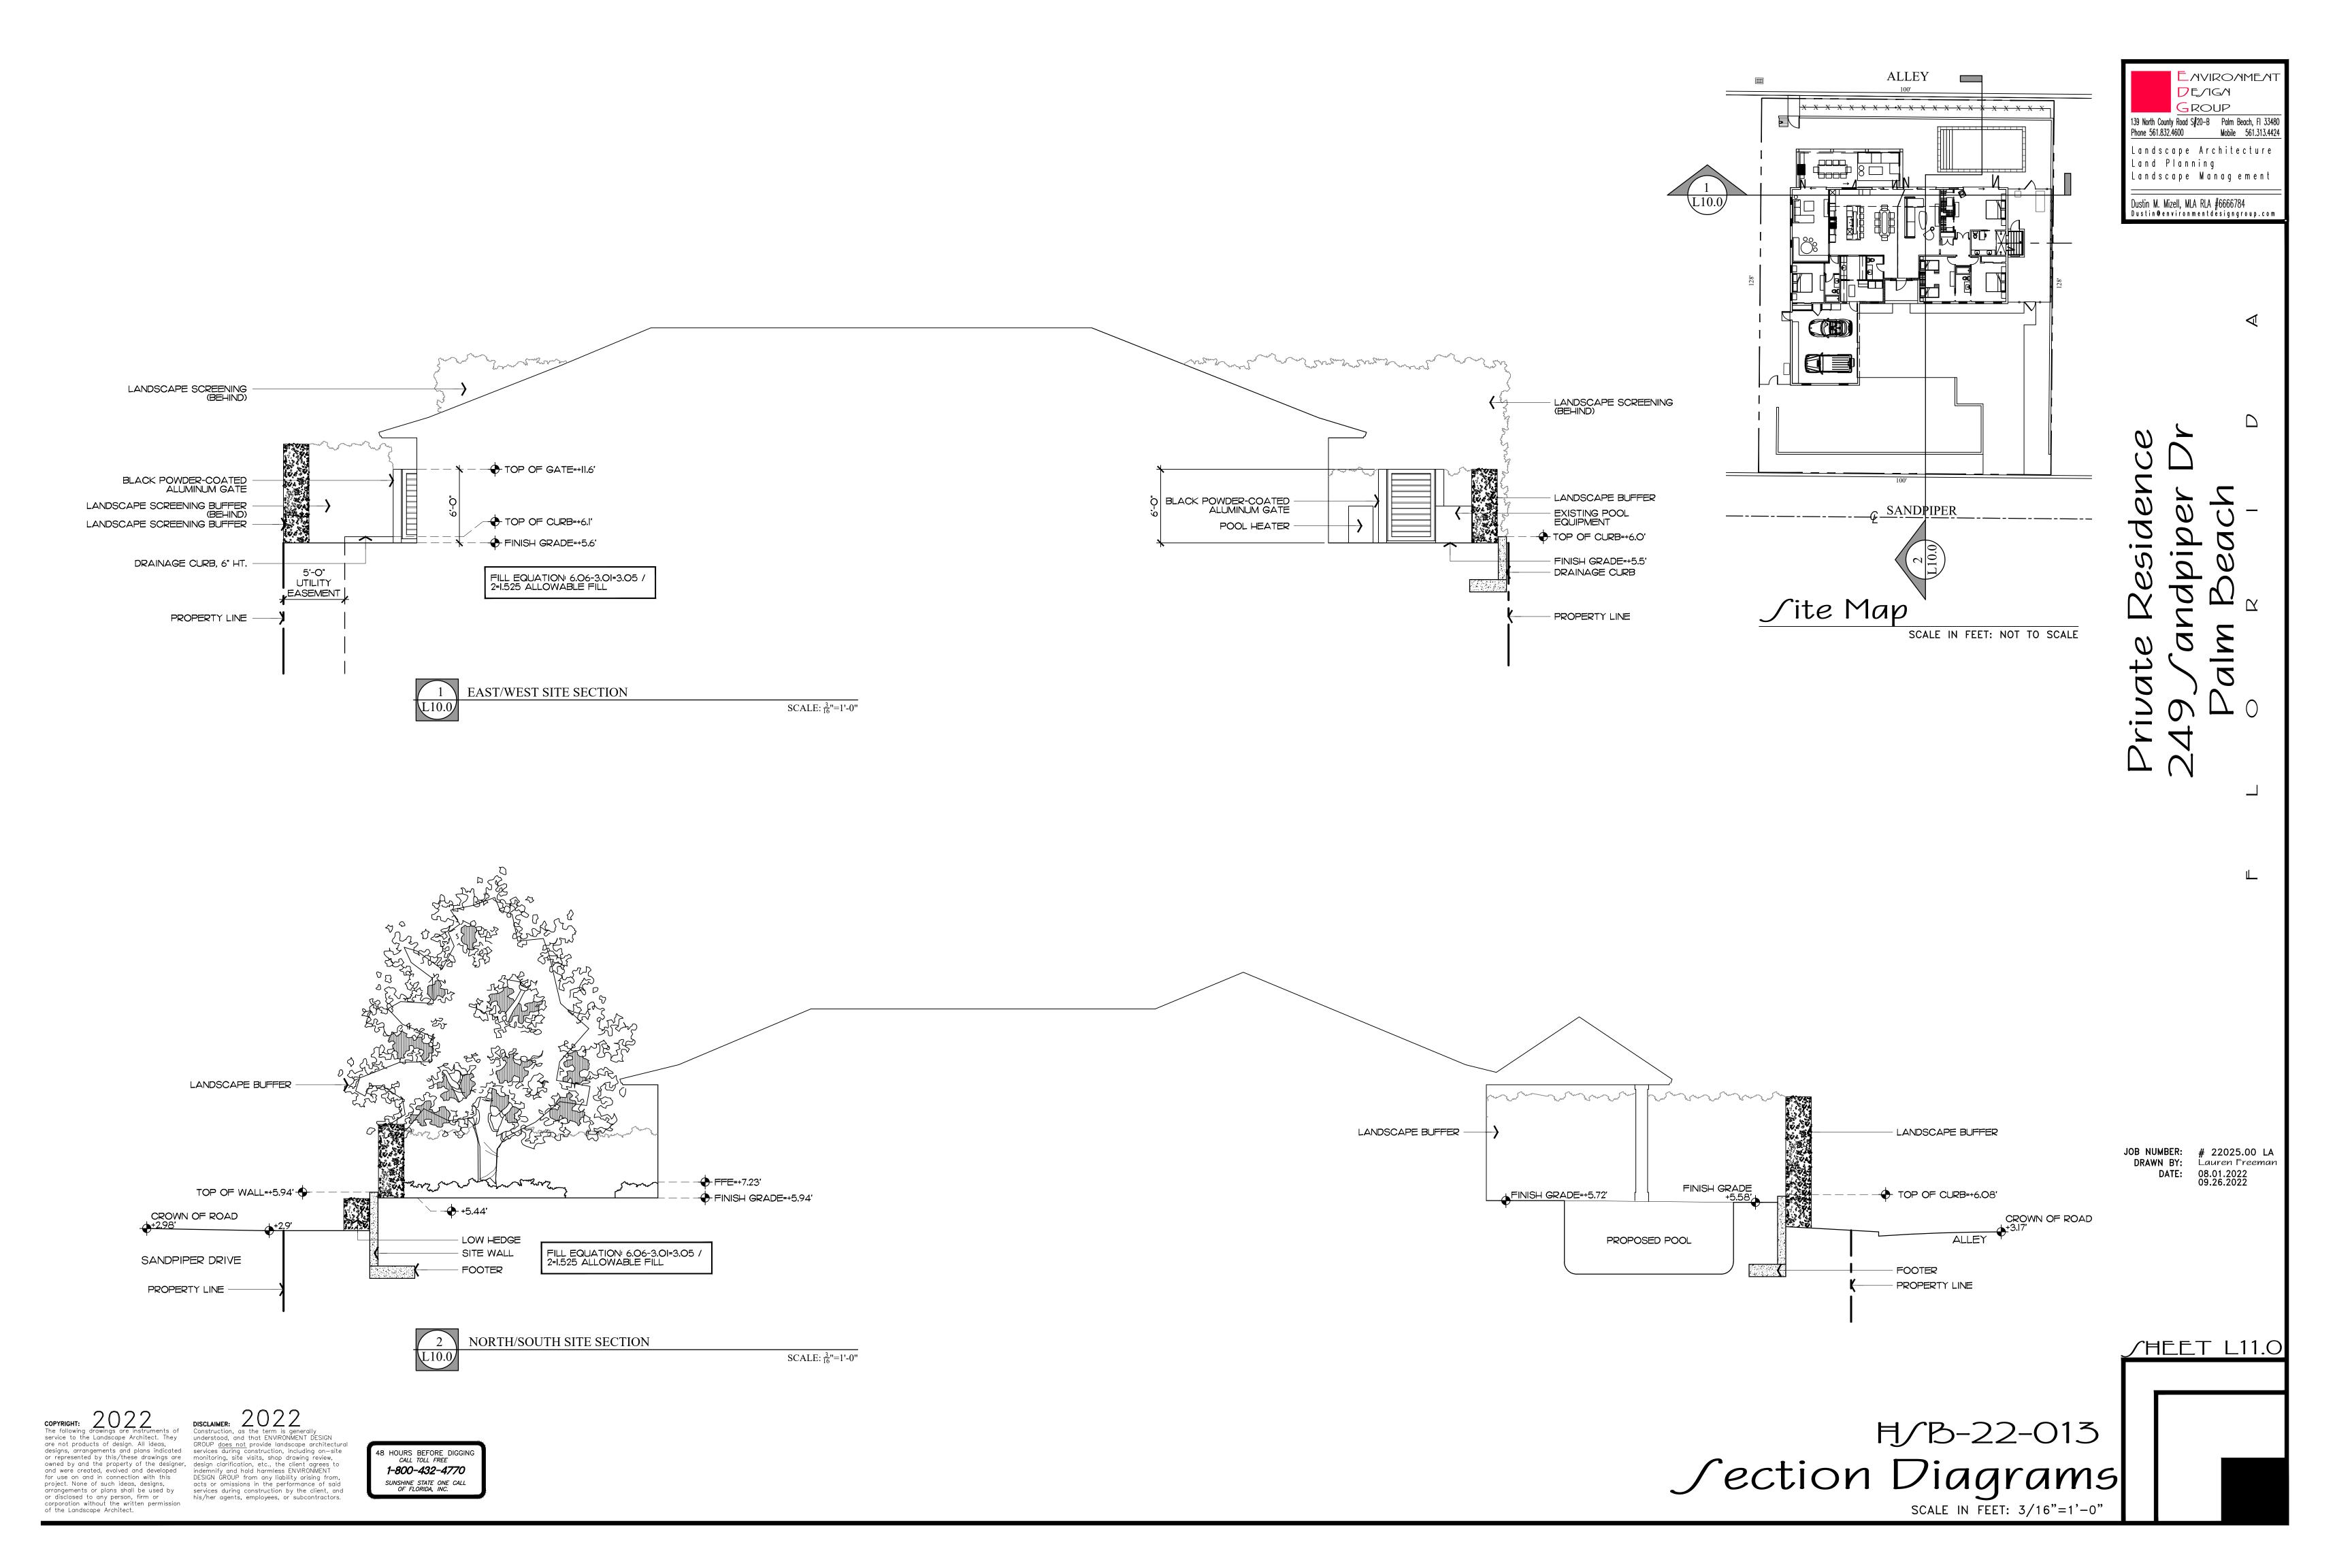DATE: 08.01.2022
09.26.2022





Porcelain Pavers

-DRIVEWAY -POOL COPING -LANDINGS


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48 HOURS BEFORE DIGGING CALL TOLL FREE 1-800-432-4770



Sandpiper Drive

TRENCH DRAIN \_ GRATE EL. = 4.00

**48 HOURS BEFORE DIGGING** CALL 1-800-432-4770 SUNSHINE STATE ONE CALL OF FLORIDA, INC. Contractor is responsible for obtaining location of existing utilities prior to commencement of construction activities.

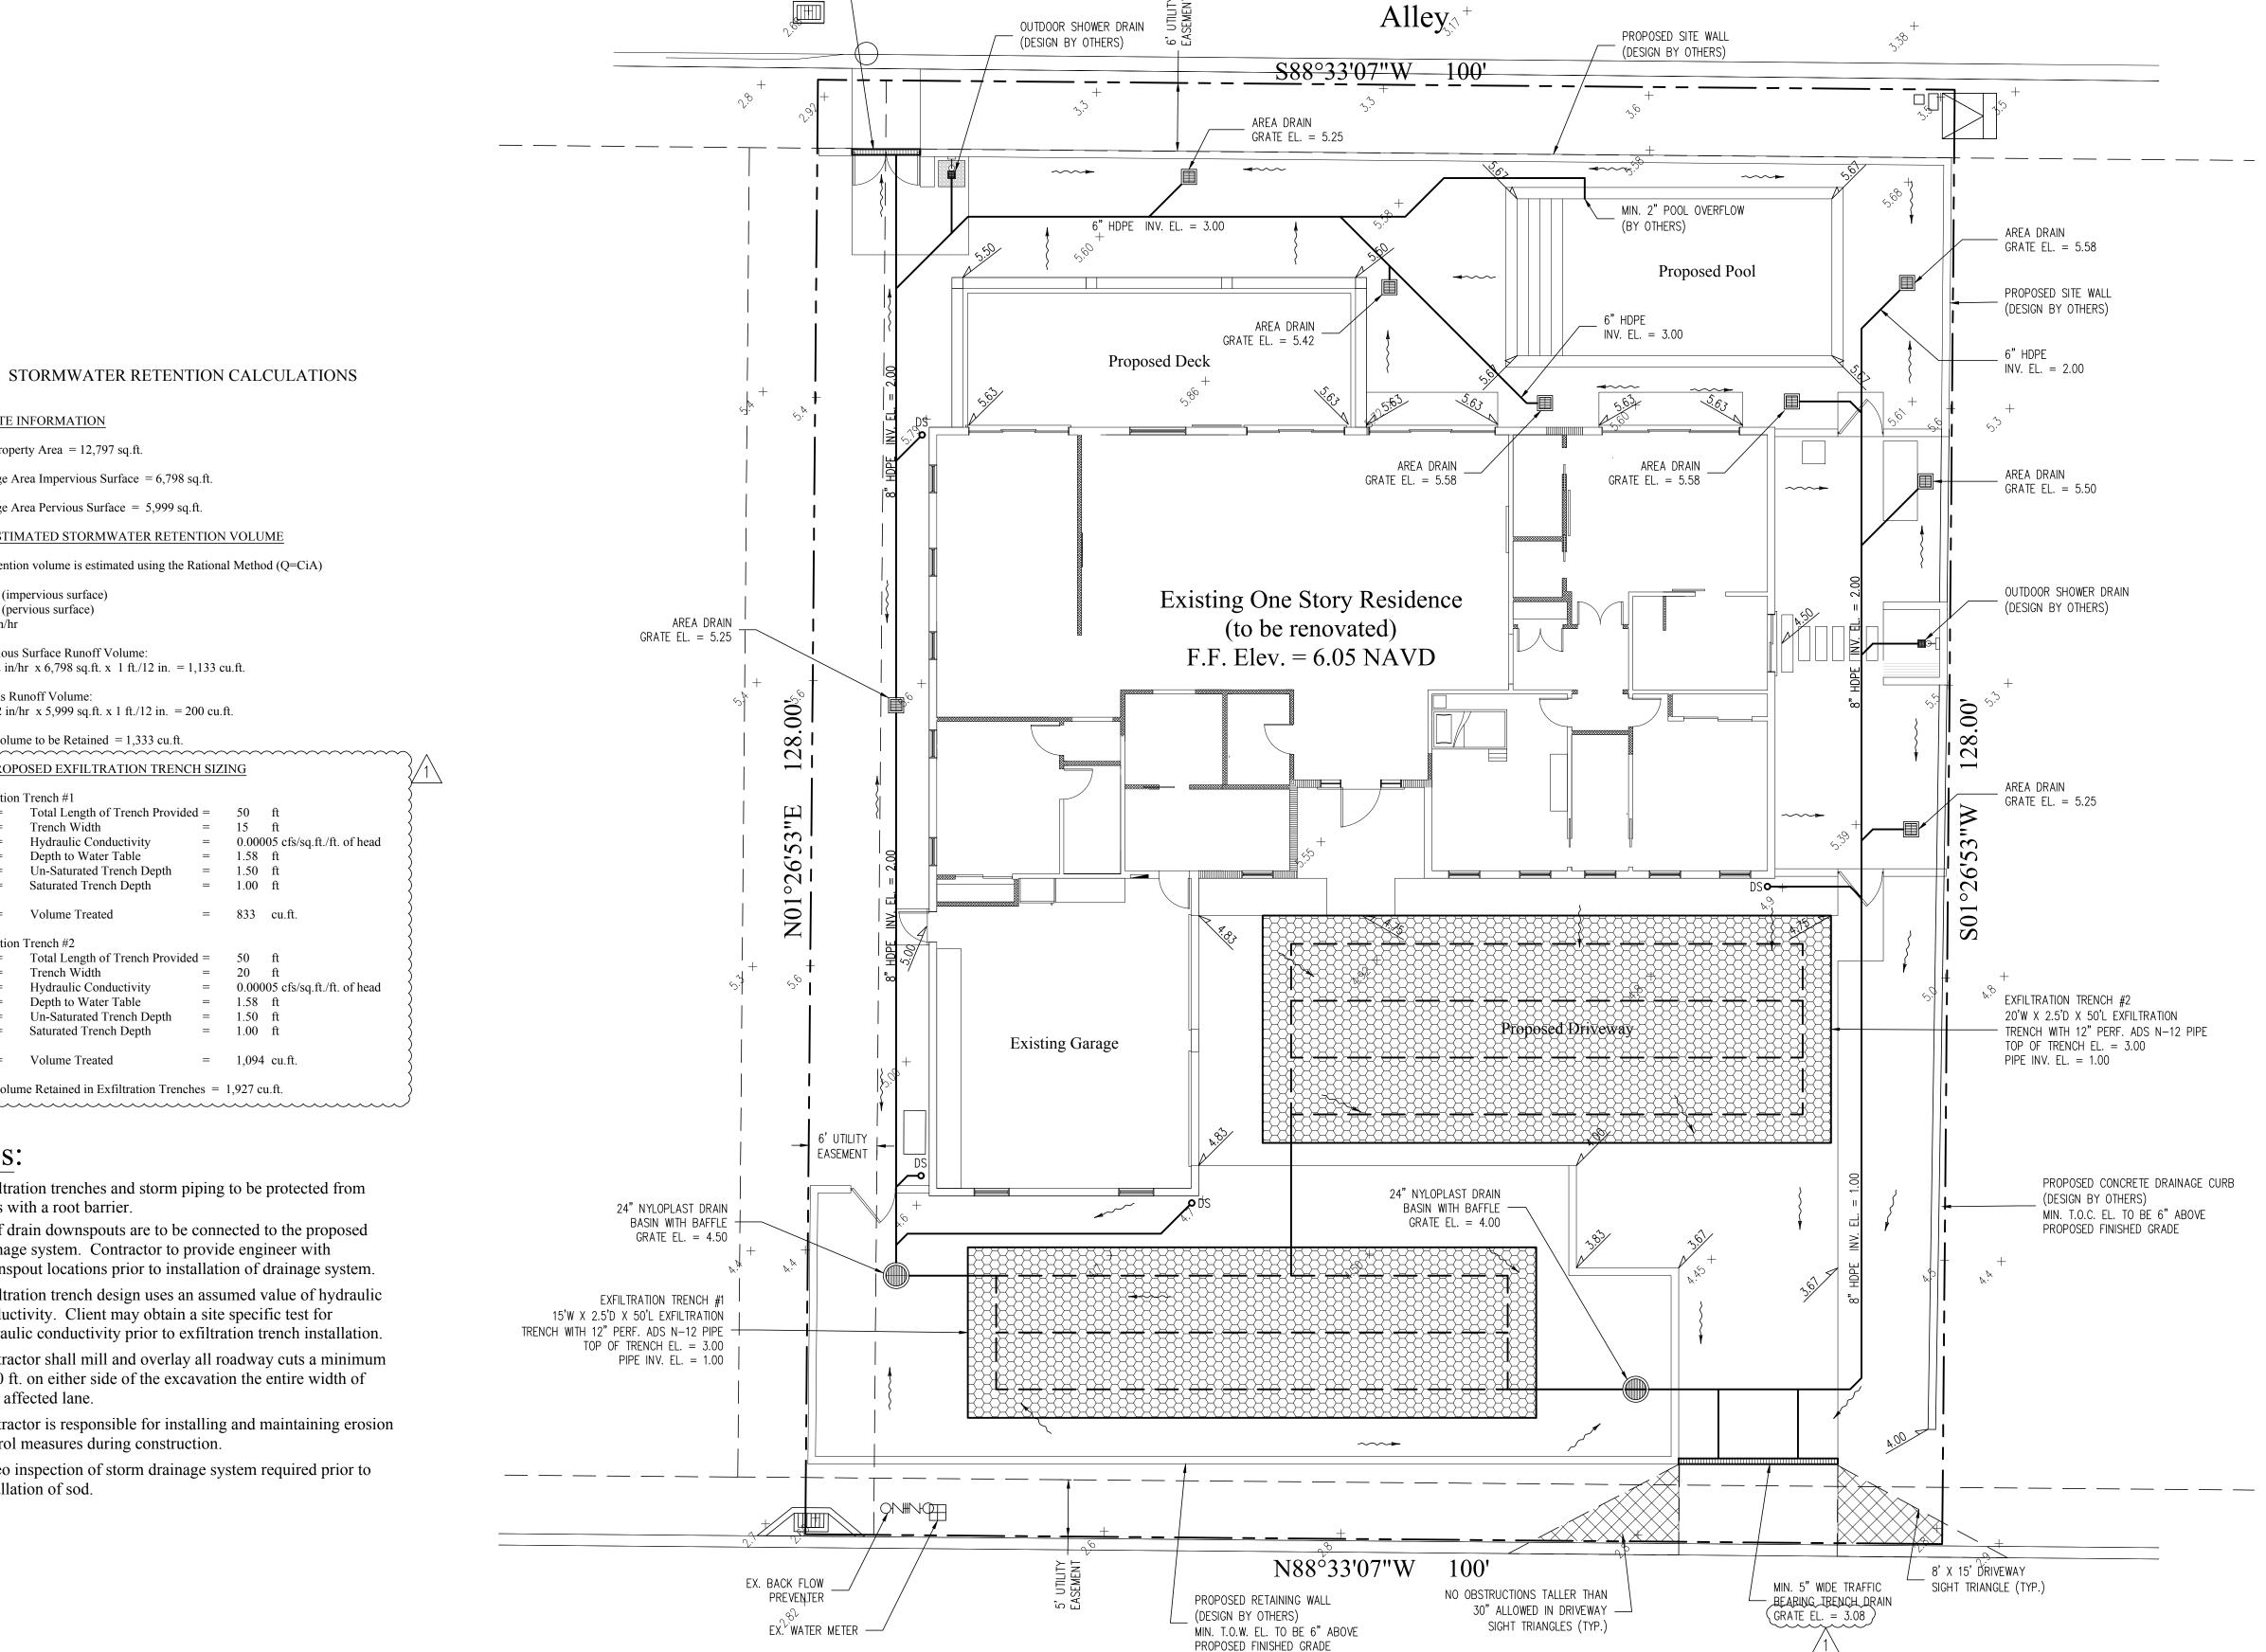

La Puerta Way El Pueblo Way Queens Ln. Colonial Ln. Orange Grove Rd. Via Marila Laurian Ln. Garden Rd.

'ation

X

Legend

EXISTING ELEVATION PER MILLER LAND SURVEYING (NAVD-88) PROPOSED ELEVATION (NAVD-88)

Tradewind Dr.

Location Map

N.T.S.


---7.00--- PROPOSED ELEVATION CONTOUR (NAVD-88)

FLOW DIRECTION

24" NYLOPLAST DRAIN BASIN WITH BAFFLE

AREA DRAIN

EXFILTRATION TRENCH

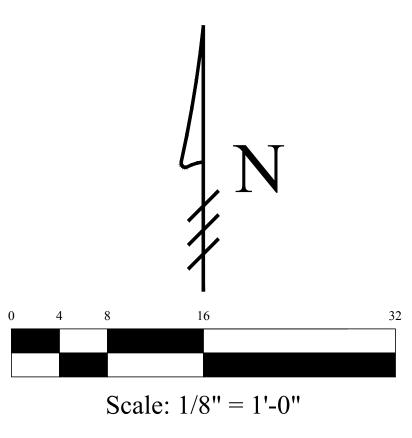


09/14/2022

09/14/22 ADD EXISTING TOPO; REVISE PROPOSED GRADING; REVISE EXFILTRATION TRENCH CALCULATIONS Chad M. Gruber

This item has been electronically signed and sealed by Chad M. Gruber on the date adjacent to the seal using a SHA authentication code. Printed copies of this document are not considered signed and sealed and the SHA authentication code must be verified on any electronic copies.

> Plan Background from Hardscape Plan by Environment Design Group Received 7/13/22

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A. SITE INFORMATION Total Property Area = 12,797 sq.ft.

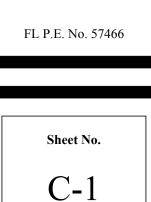Drainage Area Impervious Surface = 6,798 sq.ft.

Drainage Area Pervious Surface = 5,999 sq.ft.

B. ESTIMATED STORMWATER RETENTION VOLUME

The retention volume is estimated using the Rational Method (Q=CiA) C = 1.0 (impervious surface)

C = 0.2 (pervious surface) i = 2 in/hr

Impervious Surface Runoff Volume:  $1.0 \times 2 \text{ in/hr} \times 6,798 \text{ sq.ft.} \times 1 \text{ ft./12 in.} = 1,133 \text{ cu.ft.}$ 

Pervious Runoff Volume:  $0.2 \times 2 \text{ in/hr } \times 5,999 \text{ sq.ft.} \times 1 \text{ ft./}12 \text{ in.} = 200 \text{ cu.ft.}$ 

Total Volume to be Retained = 1,333 cu.ft.

C. PROPOSED EXFILTRATION TRENCH SIZING Exfiltration Trench #1 L = Total Length of Trench Provided = 50 ft W = Trench Width K = Hydraulic Conductivity = 0.00005 cfs/sq.ft./ft. of head H2 = Depth to Water Table = 1.58 ftDU = Un-Saturated Trench Depth = 1.50 ft = 1.00 ft DS = Saturated Trench Depth V = Volume Treated Exfiltration Trench #2 L = Total Length of Trench Provided = 50 ft W = Trench Width = 20 ft K = Hydraulic Conductivity = 0.00005 cfs/sq.ft./ft. of head

Depth to Water Table DU = Un-Saturated Trench Depth = 1.50 ftDS = Saturated Trench Depth = 1.00 ftV = Volume Treated = 1,094 cu.ft.

Total Volume Retained in Exfiltration Trenches = 1,927 cu.ft. 

### Notes:

- 1) Exfiltration trenches and storm piping to be protected from roots with a root barrier.
- 2) Roof drain downspouts are to be connected to the proposed drainage system. Contractor to provide engineer with downspout locations prior to installation of drainage system.
- 3) Exfiltration trench design uses an assumed value of hydraulic conductivity. Client may obtain a site specific test for hydraulic conductivity prior to exfiltration trench installation.
- 4) Contractor shall mill and overlay all roadway cuts a minimum of 50 ft. on either side of the excavation the entire width of each affected lane.
- 5) Contractor is responsible for installing and maintaining erosion control measures during construction.
- 6) Video inspection of storm drainage system required prior to installation of sod.