

ARC: 22-115
ZON: 22-125


Rafael A. Rodriguez

LIC Number AR0016608

REVISIONS


DATE:
05.31.2022

A2

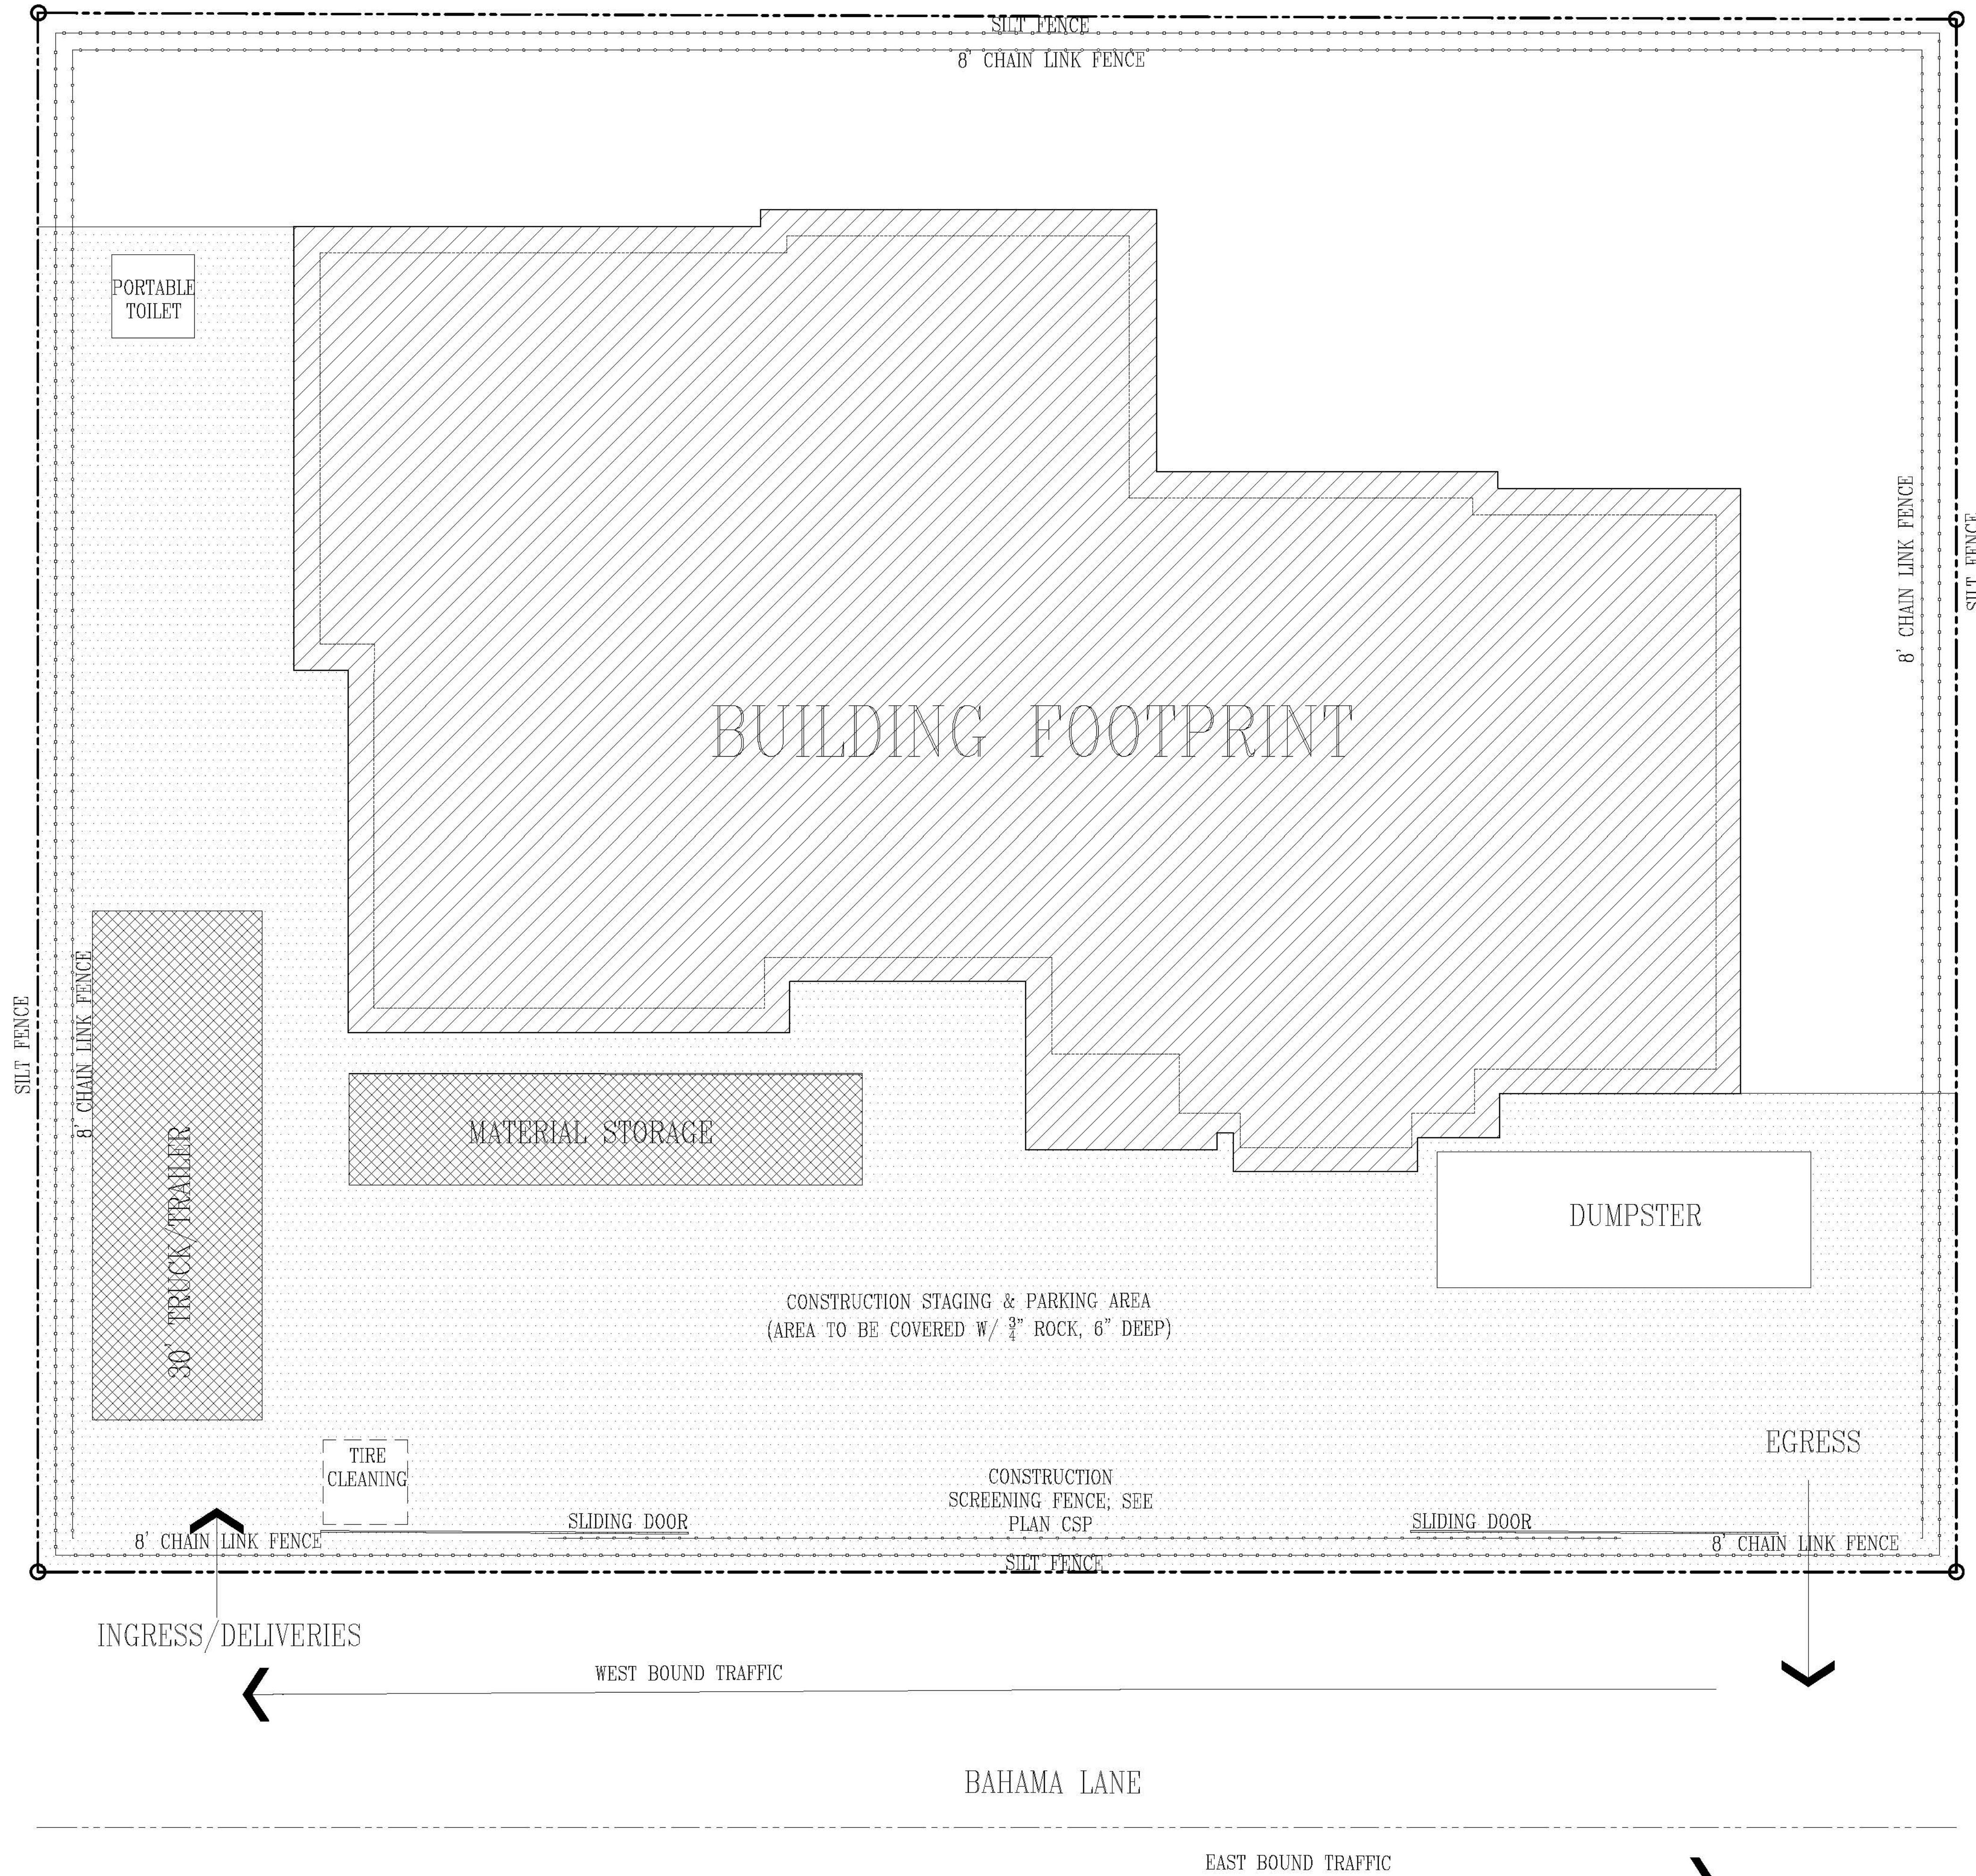

ARC: 22-115
ZON: 22-125

8' HT. CHAINLINK FENCE WITH
BLACK OR GREEN
MEASH ATTACHED TO OUTSIDE OF FENCE.

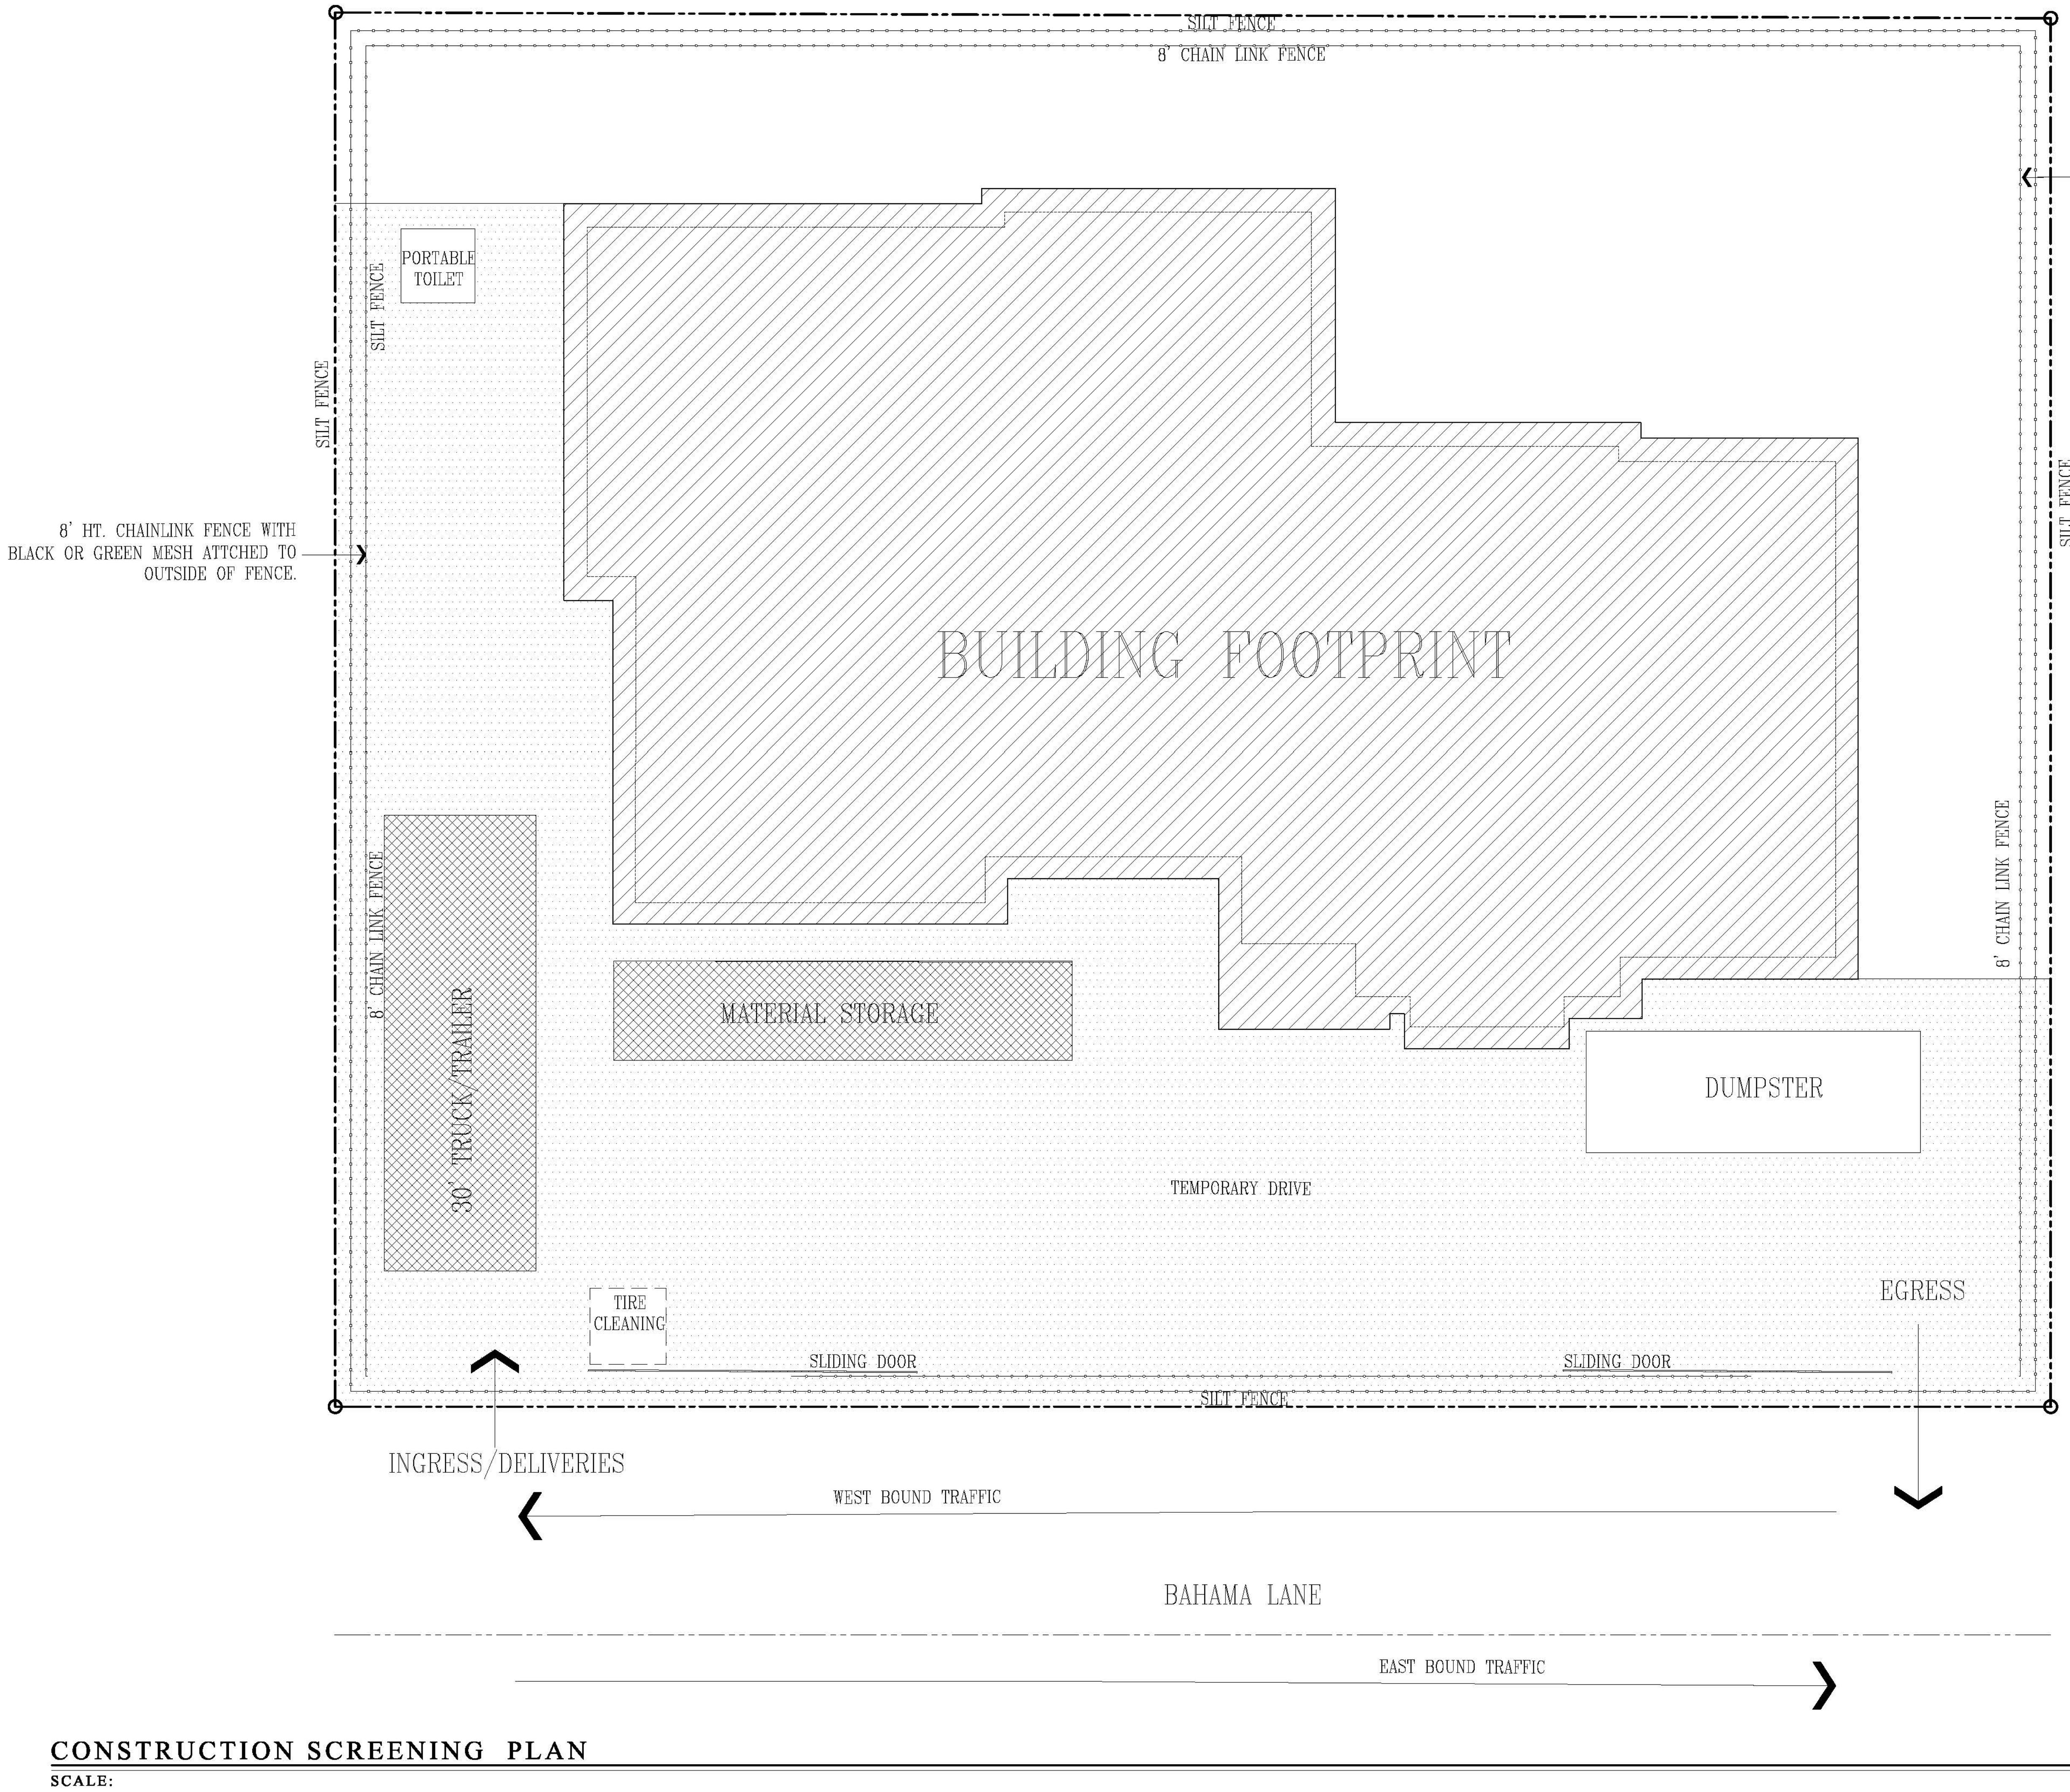

ARC: 22-115
ZON: 22-125

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44 Cocconut Row, Suite 1-6 Palm Beach, FL 33480
561.659.3616



FRONT VIEW(SOUTH VIEW)

EXISTING HOUSE RENOVATION
233 BAHAMA LANE, PALM BEACH
FLORIDA, 33480

Rafael A. Rodriguez

LIC Number AR0016608

REVISIONS

DATE:
05.31.2022

3D-1

ARC: 22-115
ZON: 22-125

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44 Cocconut Row, Suite 1-6 Palm Beach, FL 33480
561.659.3616

EXISTING HOUSE RENOVATION
233 BAHAMA LANE, PALM BEACH
FLORIDA, 33480

Rafael A. Rodriguez

LIC Number AR0016608

REVISIONS

DATE:
05.31.2022



REAR VIEW(NORTH-EAST VIEW)

ARC: 22-115
ZON: 22-125

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44 Cocconut Row, Suite 1-6 Palm Beach, FL 33480 561.699.3616



REAR VIEW(NORTH-WEST VIEW)

EXISTING HOUSE RENOVATION
233 BAHAMA LANE, PALM BEACH
FLORIDA, 33480

Rafael A. Rodriguez


LIC Number AR0016608

REVISIONS

DATE:
05.31.2022

3D-3


Private Residence 233 Bahama Lane Palm Beach

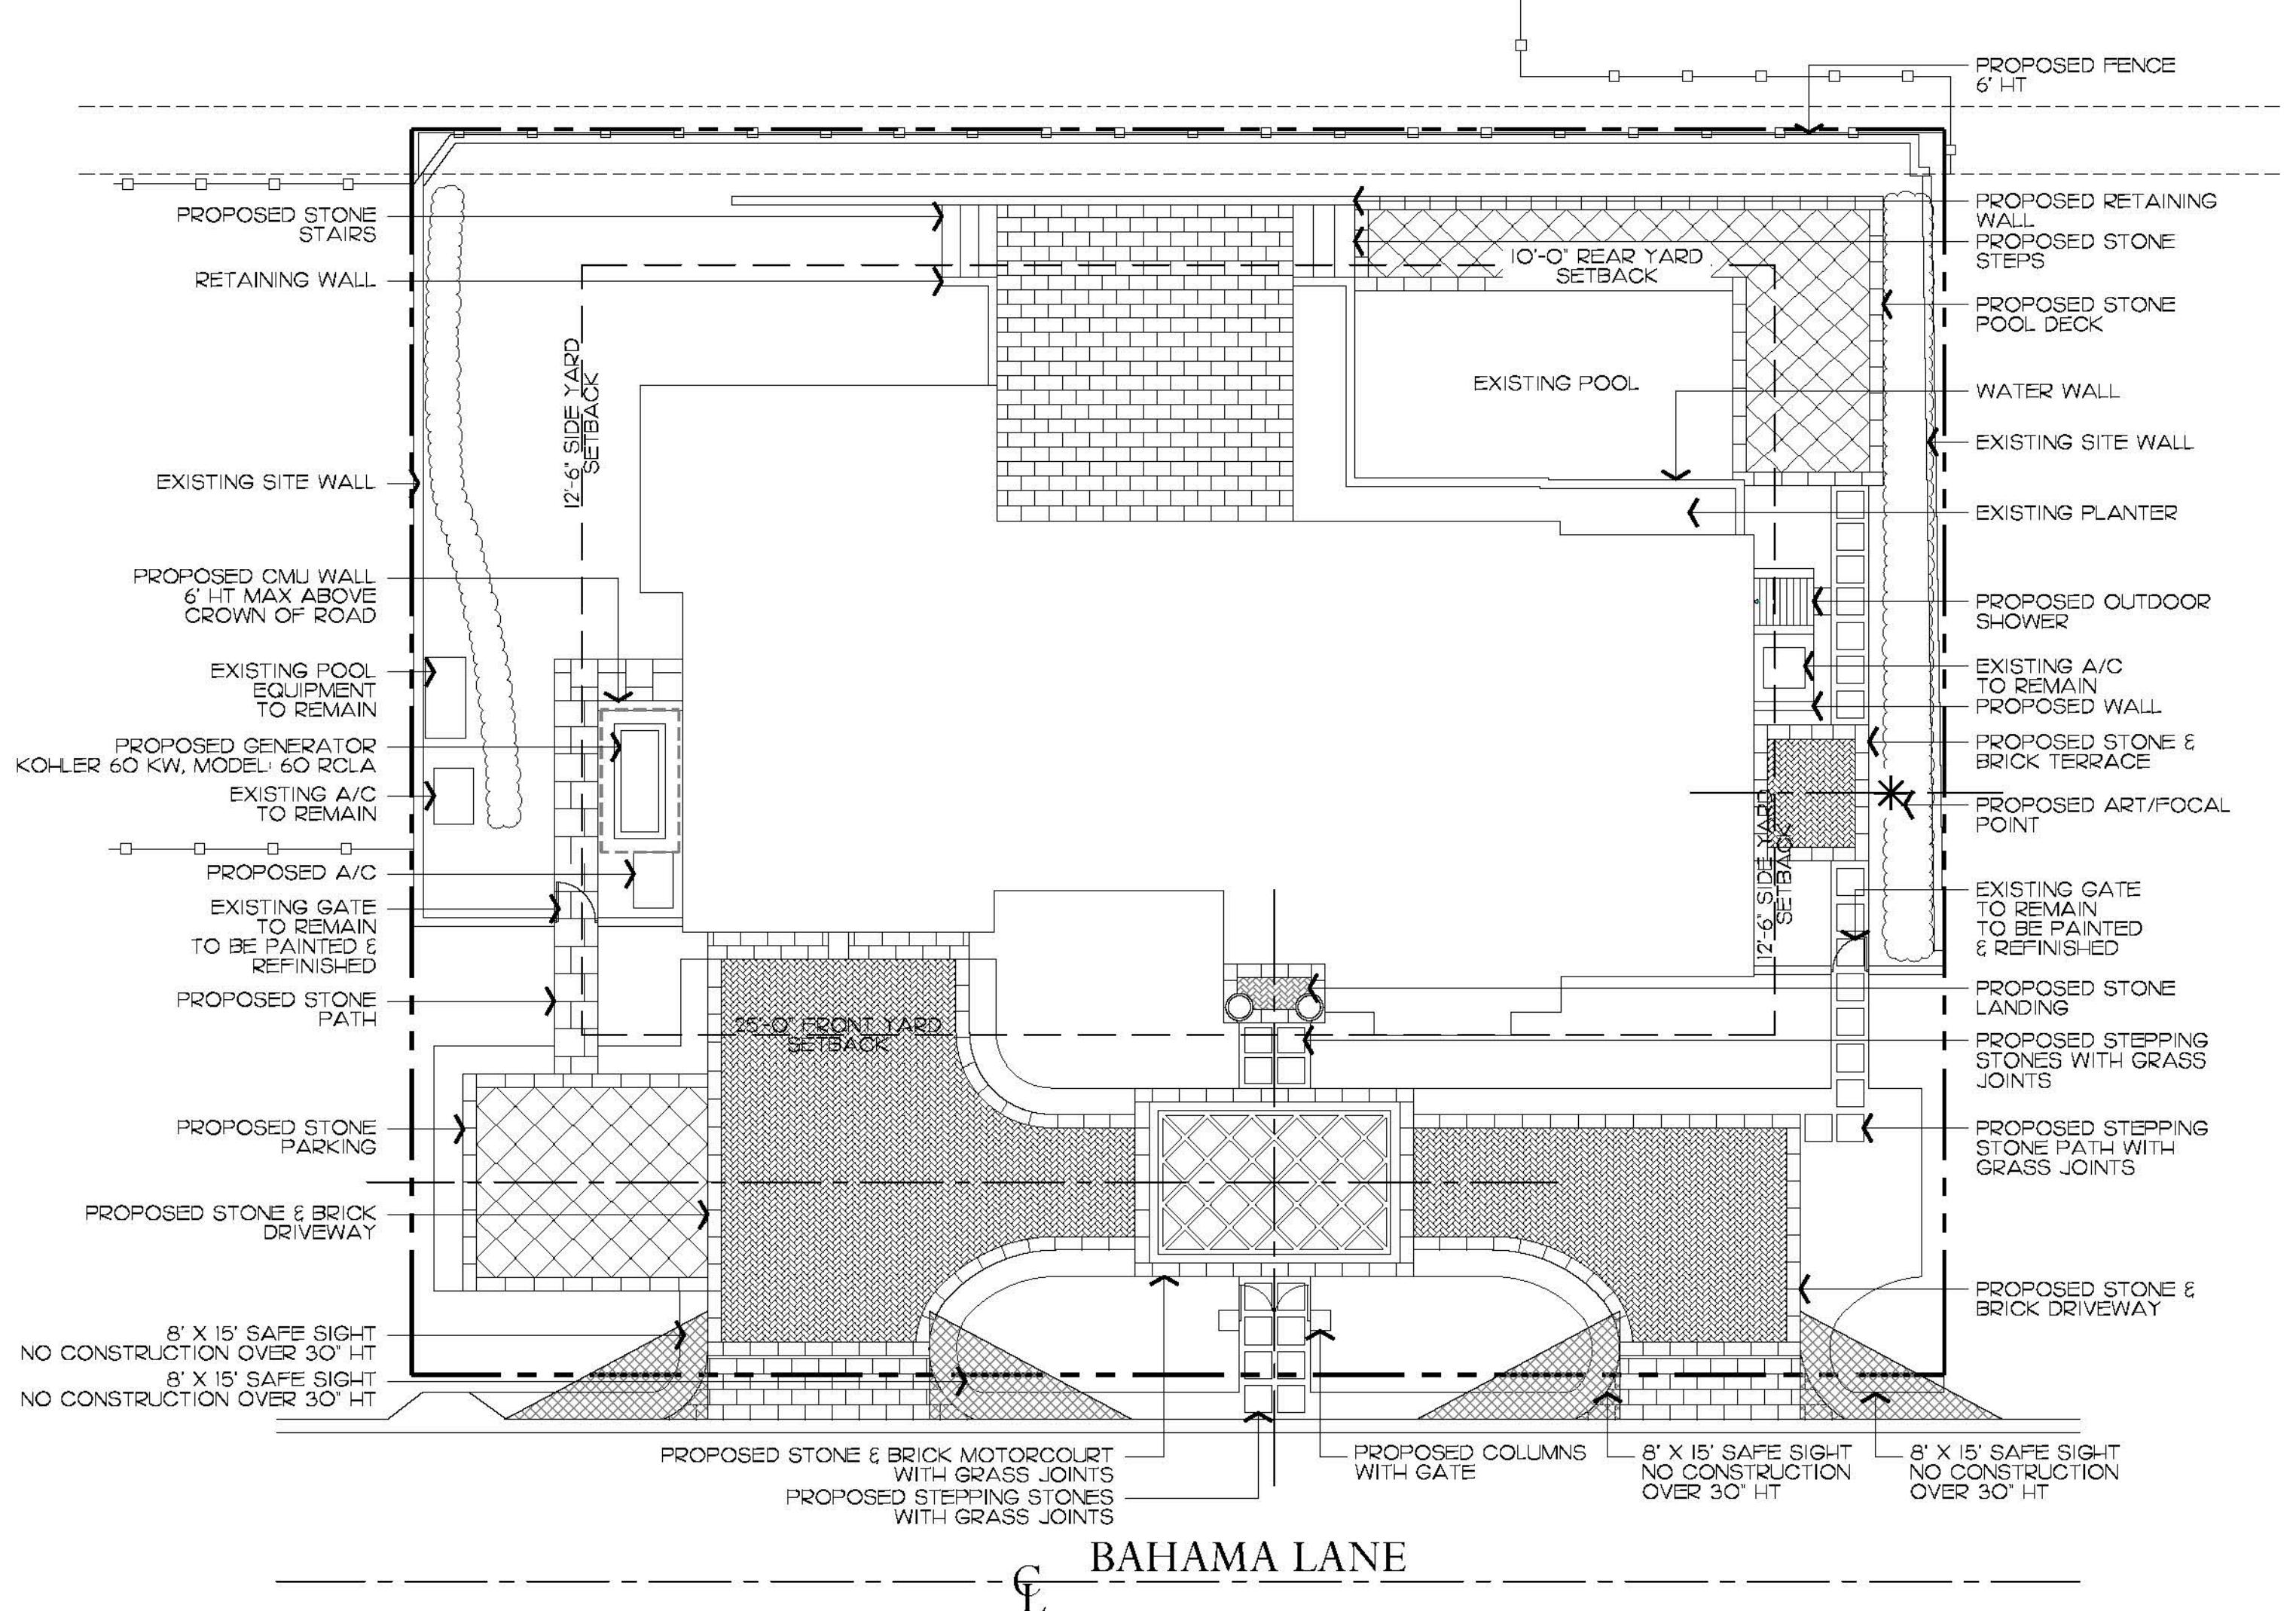

Previously Approved Site Plan

Previously Approved Site Data


DESCRIPTION	REQUIRED	PROPOSED
LOT ZONE		R-B - LOW DENSITY RESIDENTIAL
LOT AREA	10,000 S.F. MINIMUM	10,370 S.F.
OPEN / PERMEABLE SPACE	MINIMUM 45% 4,666.5 S.F.	38.9% 4,001 S.F.
FRONT YARD LANDSCAPE	MINIMUM 40% OF FRONT YARD 1,130 S.F.	40.3% 1,139 S.F.
PERIMETER LANDSCAPE WITHIN 10' OF PROPERTY LINE	MINIMUM 50% OF REQ'D OPEN SPACE 2,333.25 S.F.	53.4% 2,491 S.F.

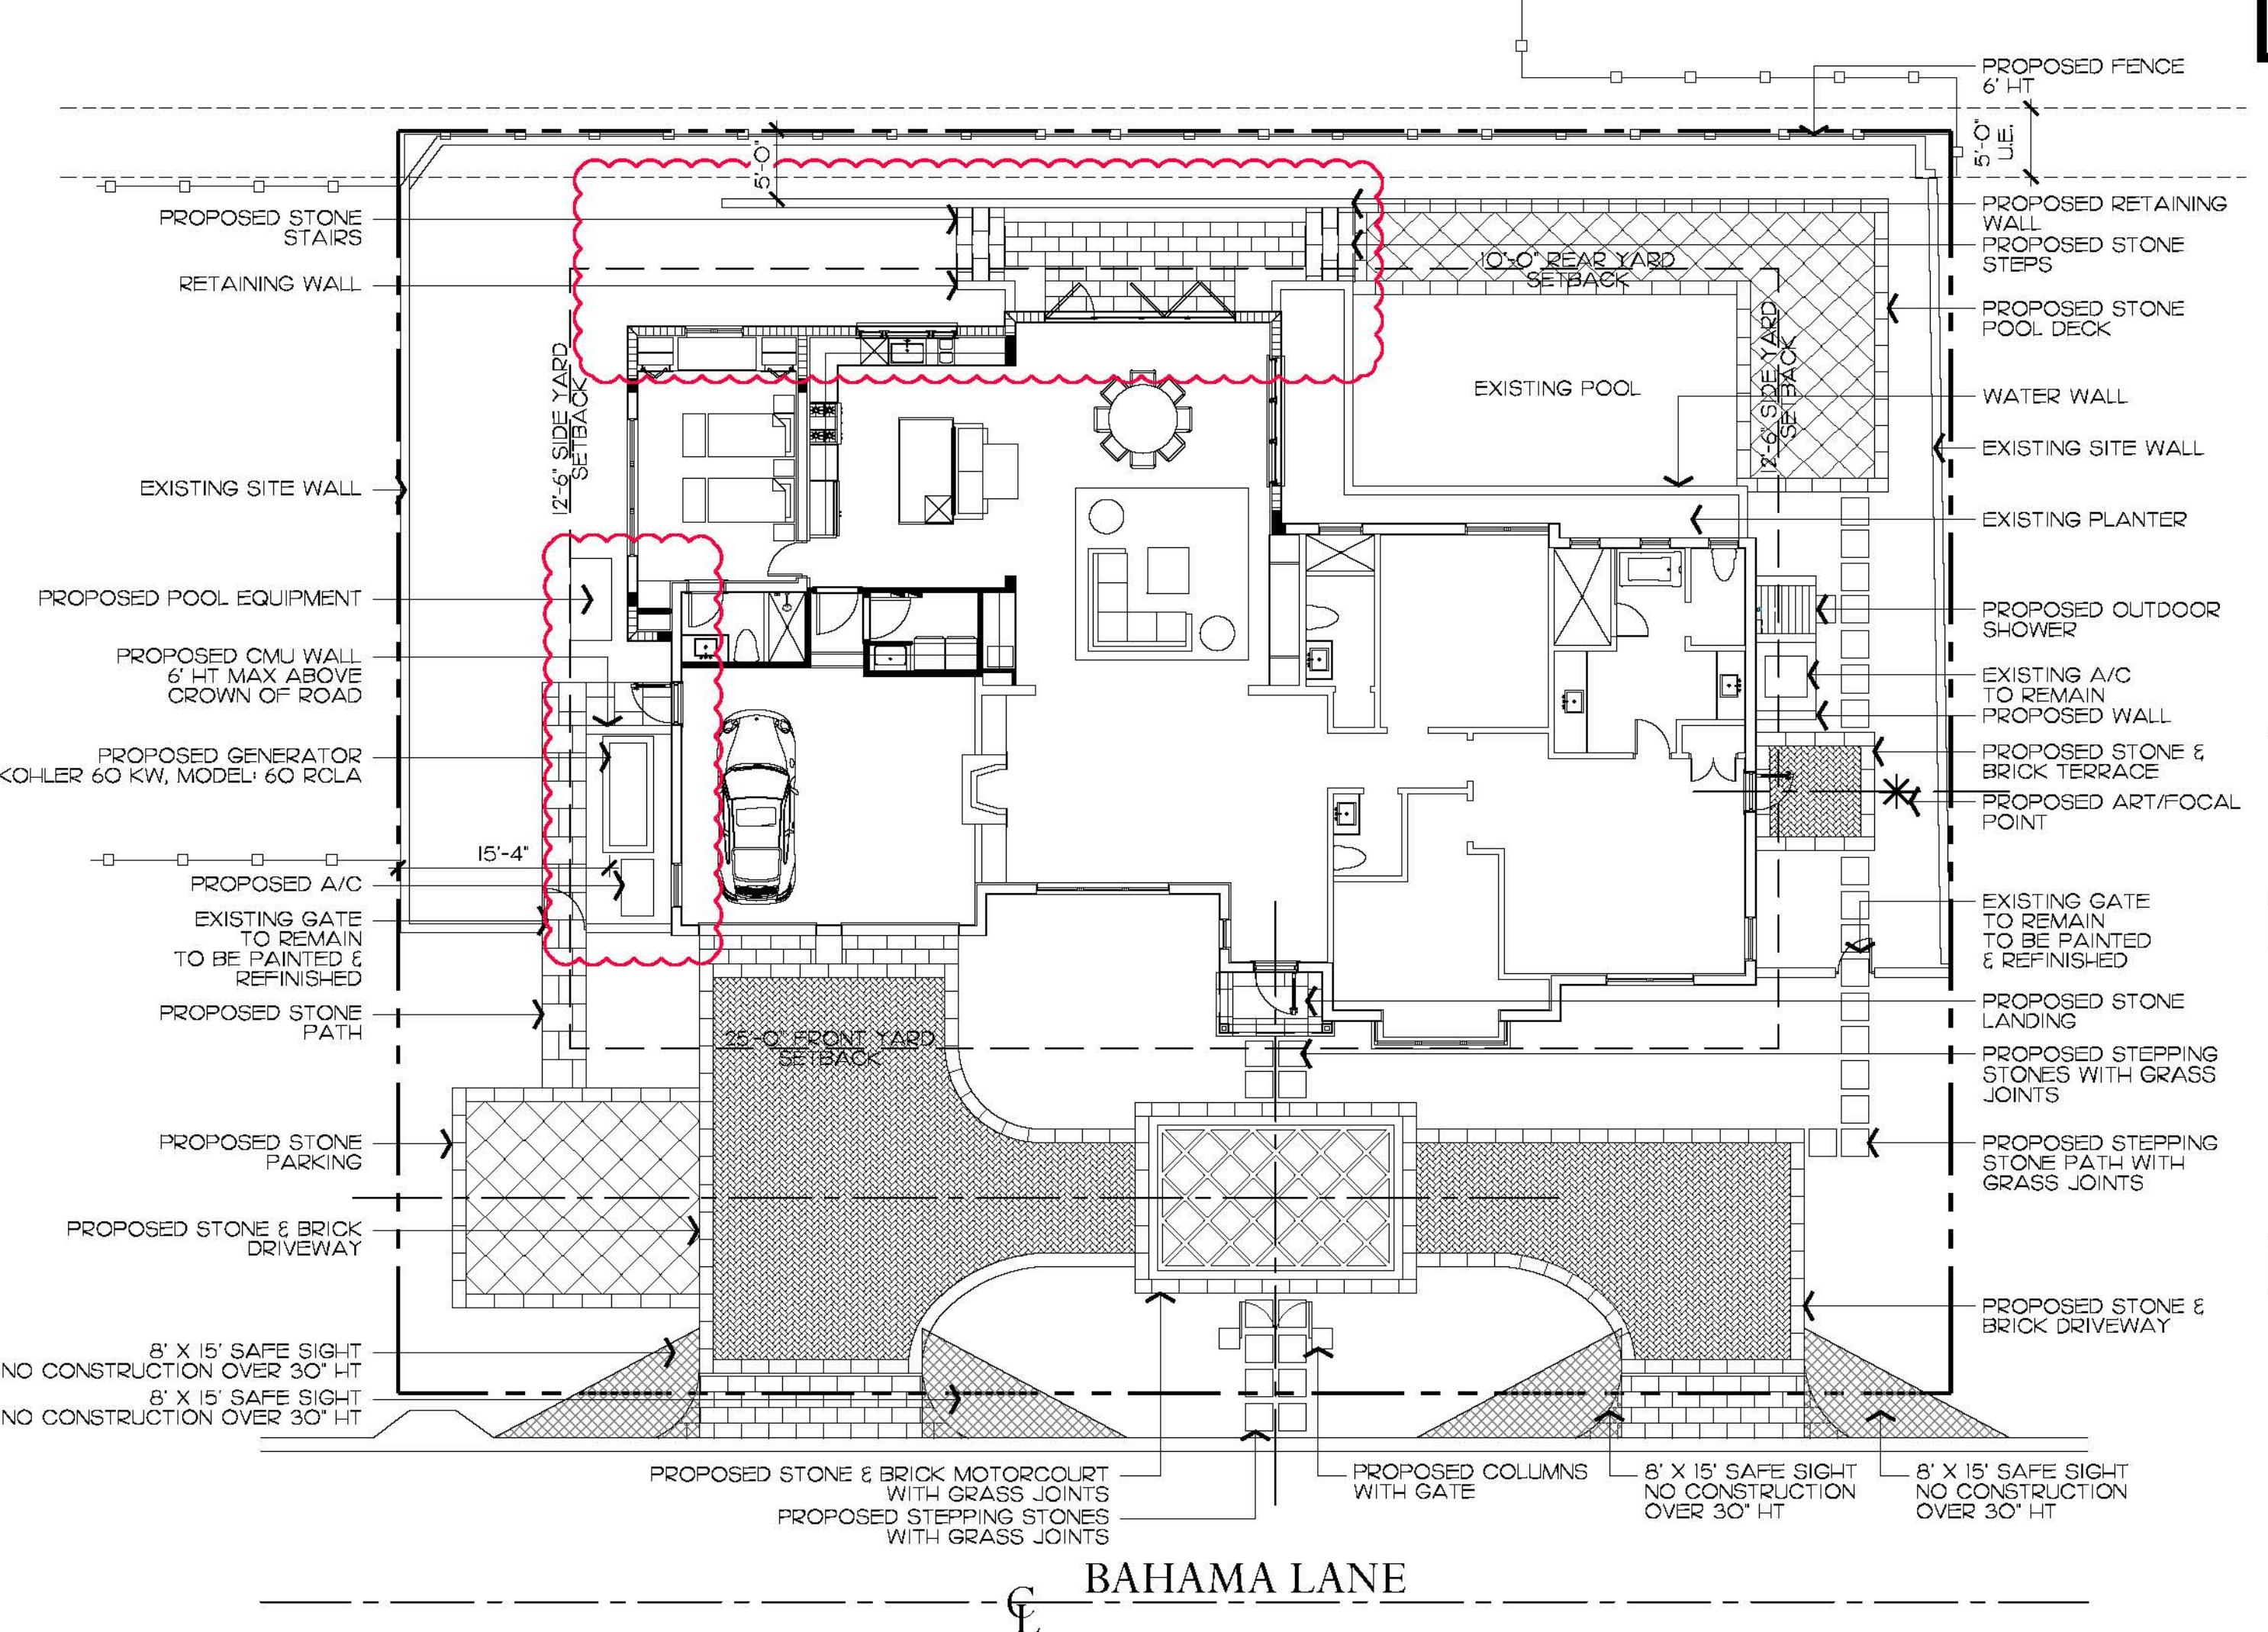

Currently Proposed Site Plan

Currently Proposed Site Data


DESCRIPTION	REQUIRED	PROPOSED
LOT ZONE		R-B - LOW DENSITY RESIDENTIAL
LOT AREA	10,000 S.F. MINIMUM	10,370 S.F.
OPEN / PERMEABLE SPACE	MINIMUM 45% 4,666.5 S.F.	37.6% 3,901 S.F.
FRONT YARD LANDSCAPE	MINIMUM 40% OF FRONT YARD 1,130 S.F.	40.3% 1,139 S.F.
PERIMETER LANDSCAPE WITHIN 10' OF PROPERTY LINE	MINIMUM 50% OF REQ'D OPEN SPACE 2,333.25 S.F.	53.8% 2,515 S.F.

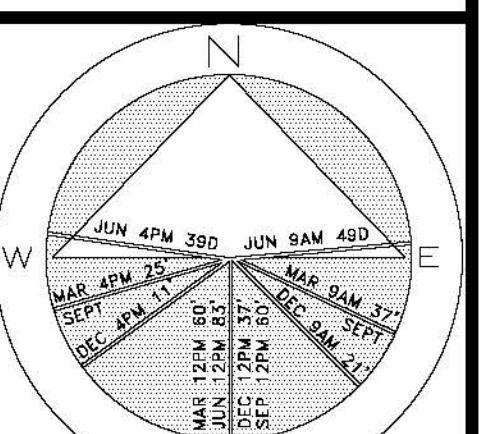

JOB NUMBER: # 21218.00 LA
DRAWN BY: Lauren Freeman
DATE: 06.27.2022




NOTE: NO SITE PLAN CHANGES
WILL BE VISIBLE FROM BAHAMA LANE

Private Residence
233 Bahama Lane
Palm Beach

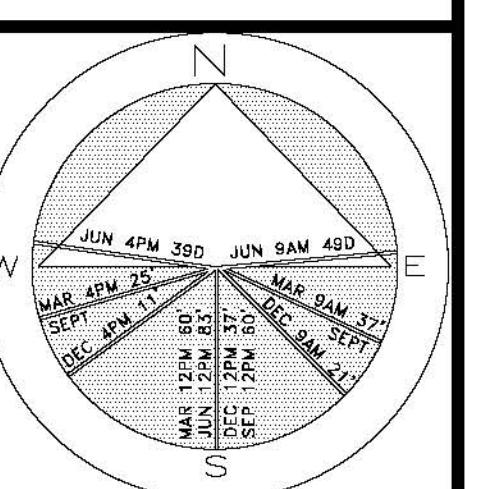

JOB NUMBER: # 21218.00 LA
DRAWN BY: Lauren Freeman
Jean Tuomey
DATE: 06.27.2022

SHEET L2.0

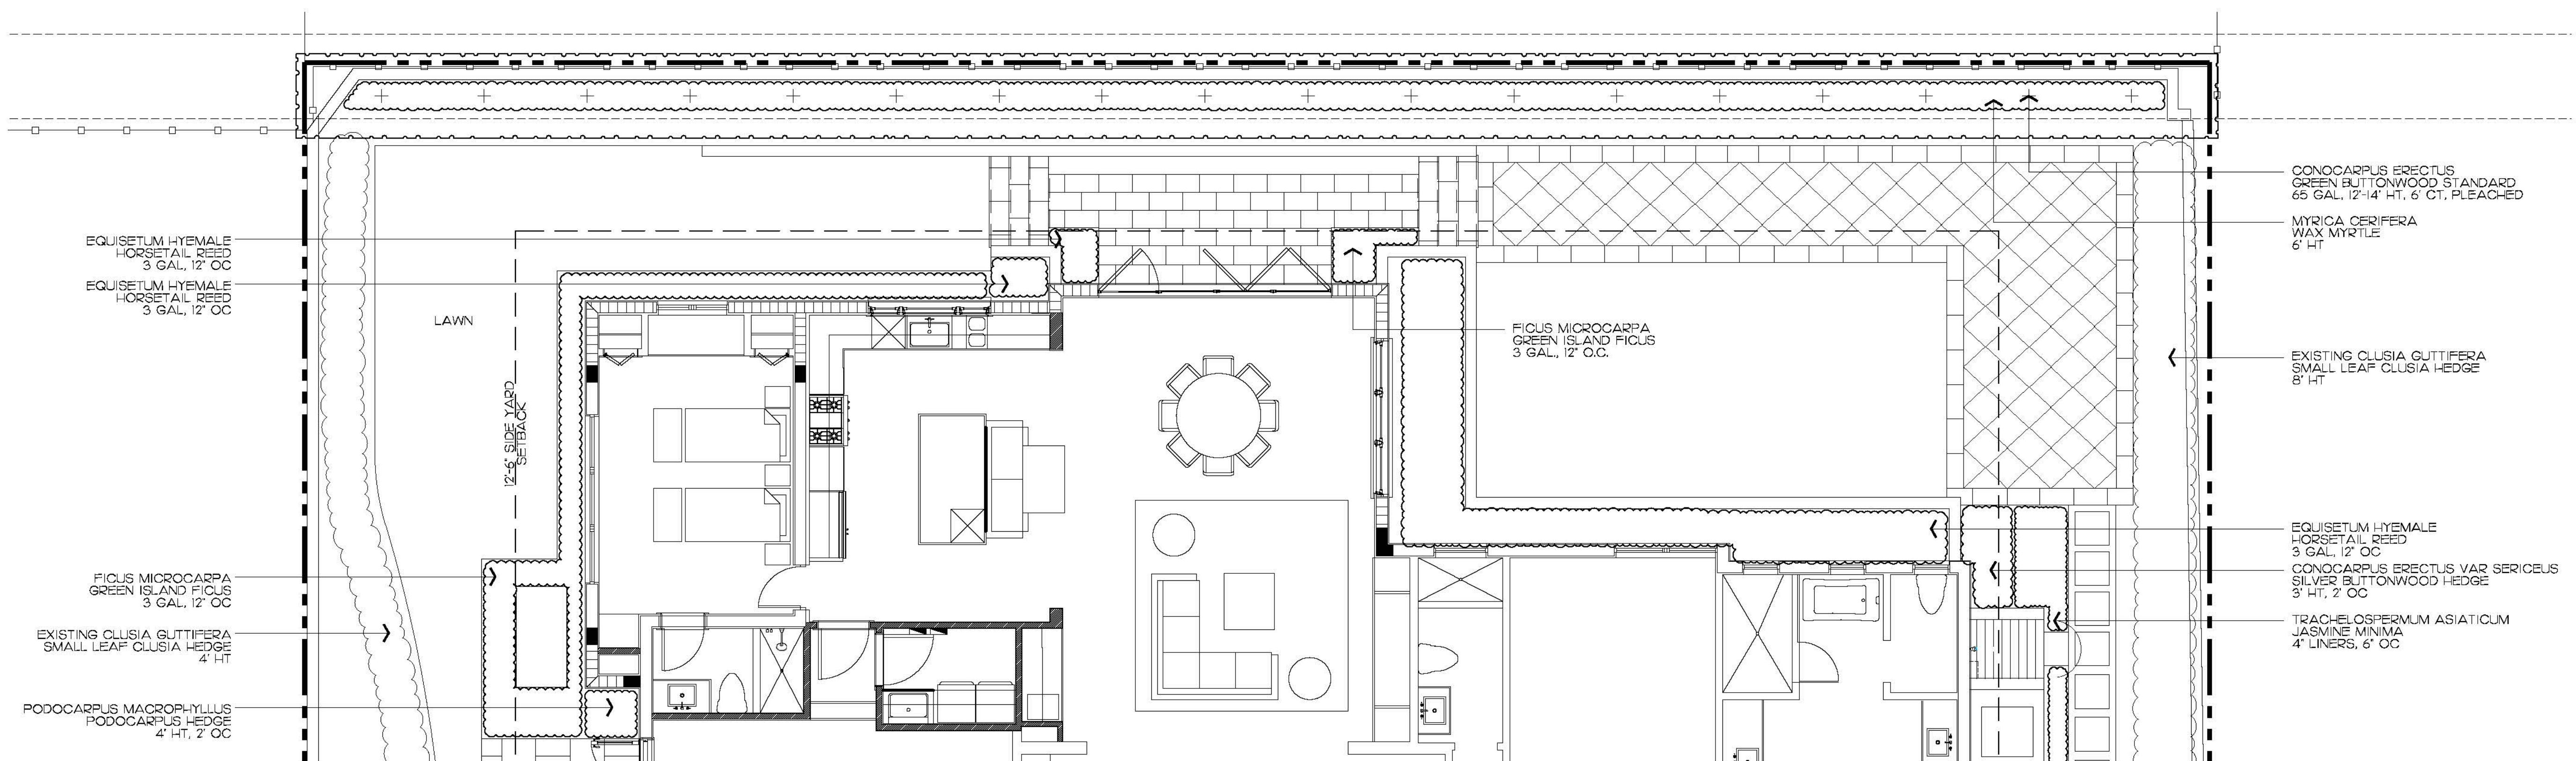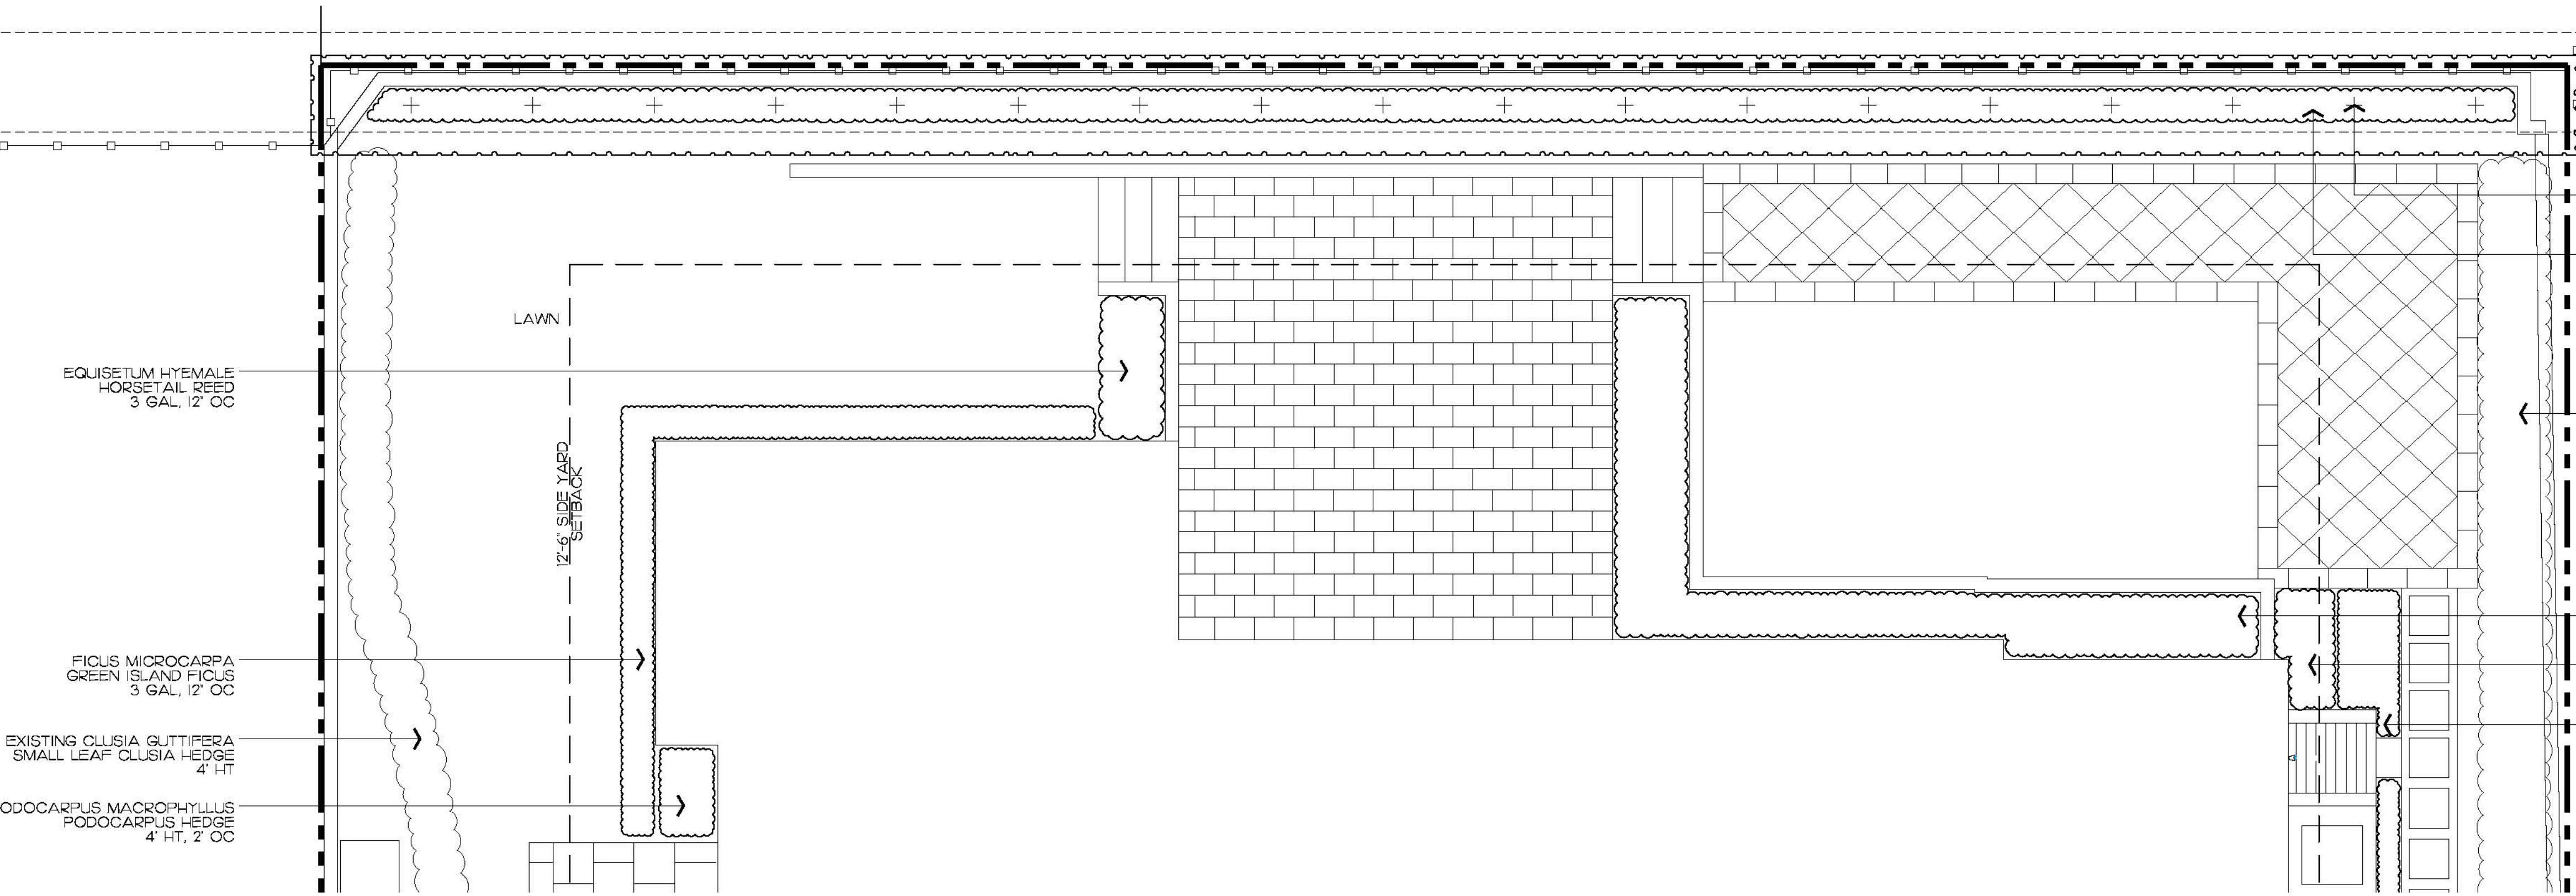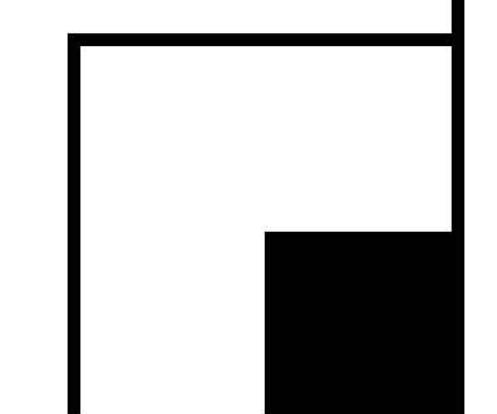

48 HOURS BEFORE DIGGING
CALL TOLL FREE
1-800-432-4770
SUNSHINE STATE ONE CALL
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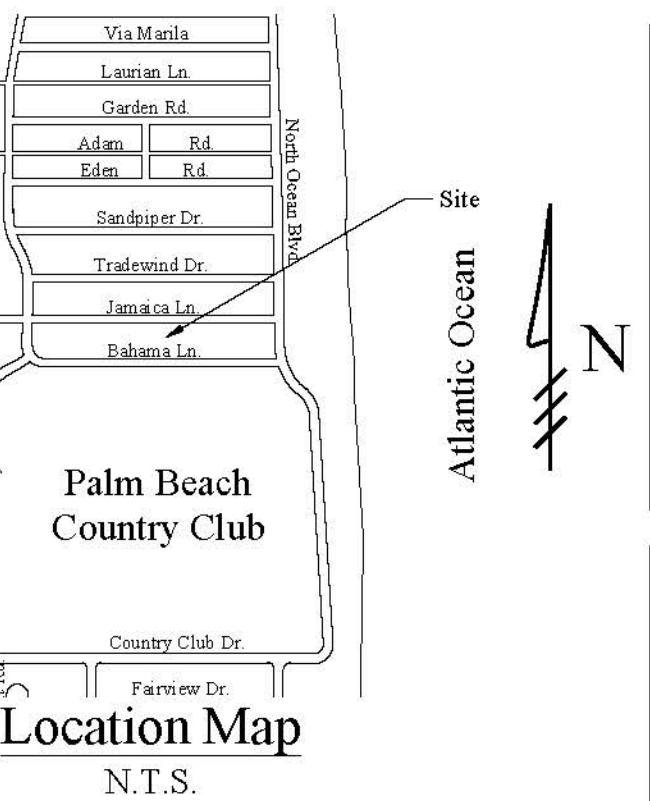
2022

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NOTE: NO LANDSCAPE CHANGES
WILL BE VISIBLE FROM BAHAMA LANE
OR SURROUNDING PROPERTIES

ARCOM# ARC-22-011
Landscape Plan - Limits of Work

SCALE IN FEET: 3/16"=1'-0"



Gruber Consulting Engineers, Inc.
2675 MERCER AVE, SUITE 305
WEST PALM BEACH, FL 33401
PHONE: 561.212.2041
office@gruberconsulting.com

Project Information	
Project No.	2021-0169
Issue Date	05/07/2022
Scale	1'8" = 1'-0"
Drawn By	KM
Checked By	CG

Conceptual Site Grading & Drainage Plan For:
Proposed Renovation
233 Bahama Lane
Palm Beach, Florida

Revisions	
1	
2	
3	
4	
5	
6	
7	
8	
9	
10	

Chad M. Gruber
FL P.E. No. 57466

Sheet No.
C-1

STORMWATER RETENTION CALCULATIONS

A. SITE INFORMATION

Total Property Area = 10,370 sq.ft.

Drainage Area Impervious Surface
(existing residence, pool, decks, proposed driveway, walkways) = 6,632 sq.ft.

Drainage Area Pervious Surface = 3,738 sq.ft.

B. ESTIMATED STORMWATER RETENTION VOLUME

The retention volume is estimated using the Rational Method ($Q=CiA$)
where:
 $C = 1.0$ (impervious surface)
 $C = 0.2$ (pervious surface)
 $i = 2 \text{ in/hr}$

Impervious Surface Runoff Volume:
 $1.0 \times 2 \text{ in/hr} \times 6,632 \text{ sq.ft.} \times 1 \text{ ft./12 in.} = 1,106 \text{ cu.ft.}$

Pervious Runoff Volume:
 $0.2 \times 2 \text{ in/hr} \times 3,738 \text{ sq.ft.} \times 1 \text{ ft./12 in.} = 125 \text{ cu.ft.}$


Total Volume to be Retained = 1,231 cu.ft.

C. PROPOSED EXFILTRATION TRENCH SIZING

L = Total Length of Trench Provided = 85 ft
W = Trench Width = 6 ft
K = Hydraulic Conductivity = 0.00005 cfs/sq.ft./ft. of head
H2 = Depth to Water Table = 4.50 ft
DU = Un-Saturated Trench Depth = 3.00 ft
DS = Saturated Trench Depth = 0.00 ft
V = Volume Treated = 1,466 cu.ft.


Notes:

- 1) Exfiltration trenches and storm piping to be protected from roots with a root barrier.
- 2) Roof drain downspouts are to be connected to the proposed drainage system. Contractor to provide engineer with downspout locations prior to installation of drainage system.
- 3) Exfiltration trench design uses an assumed value of hydraulic conductivity. Client may obtain a site specific test for hydraulic conductivity prior to exfiltration trench installation.
- 4) Contractor shall mill and overlay all roadway cuts a minimum of 50 ft. on either side of the excavation the entire width of each affected lane.
- 5) Contractor is responsible for installing and maintaining erosion control measures during construction.
- 6) Video inspection of storm drainage system required prior to installation of sod.

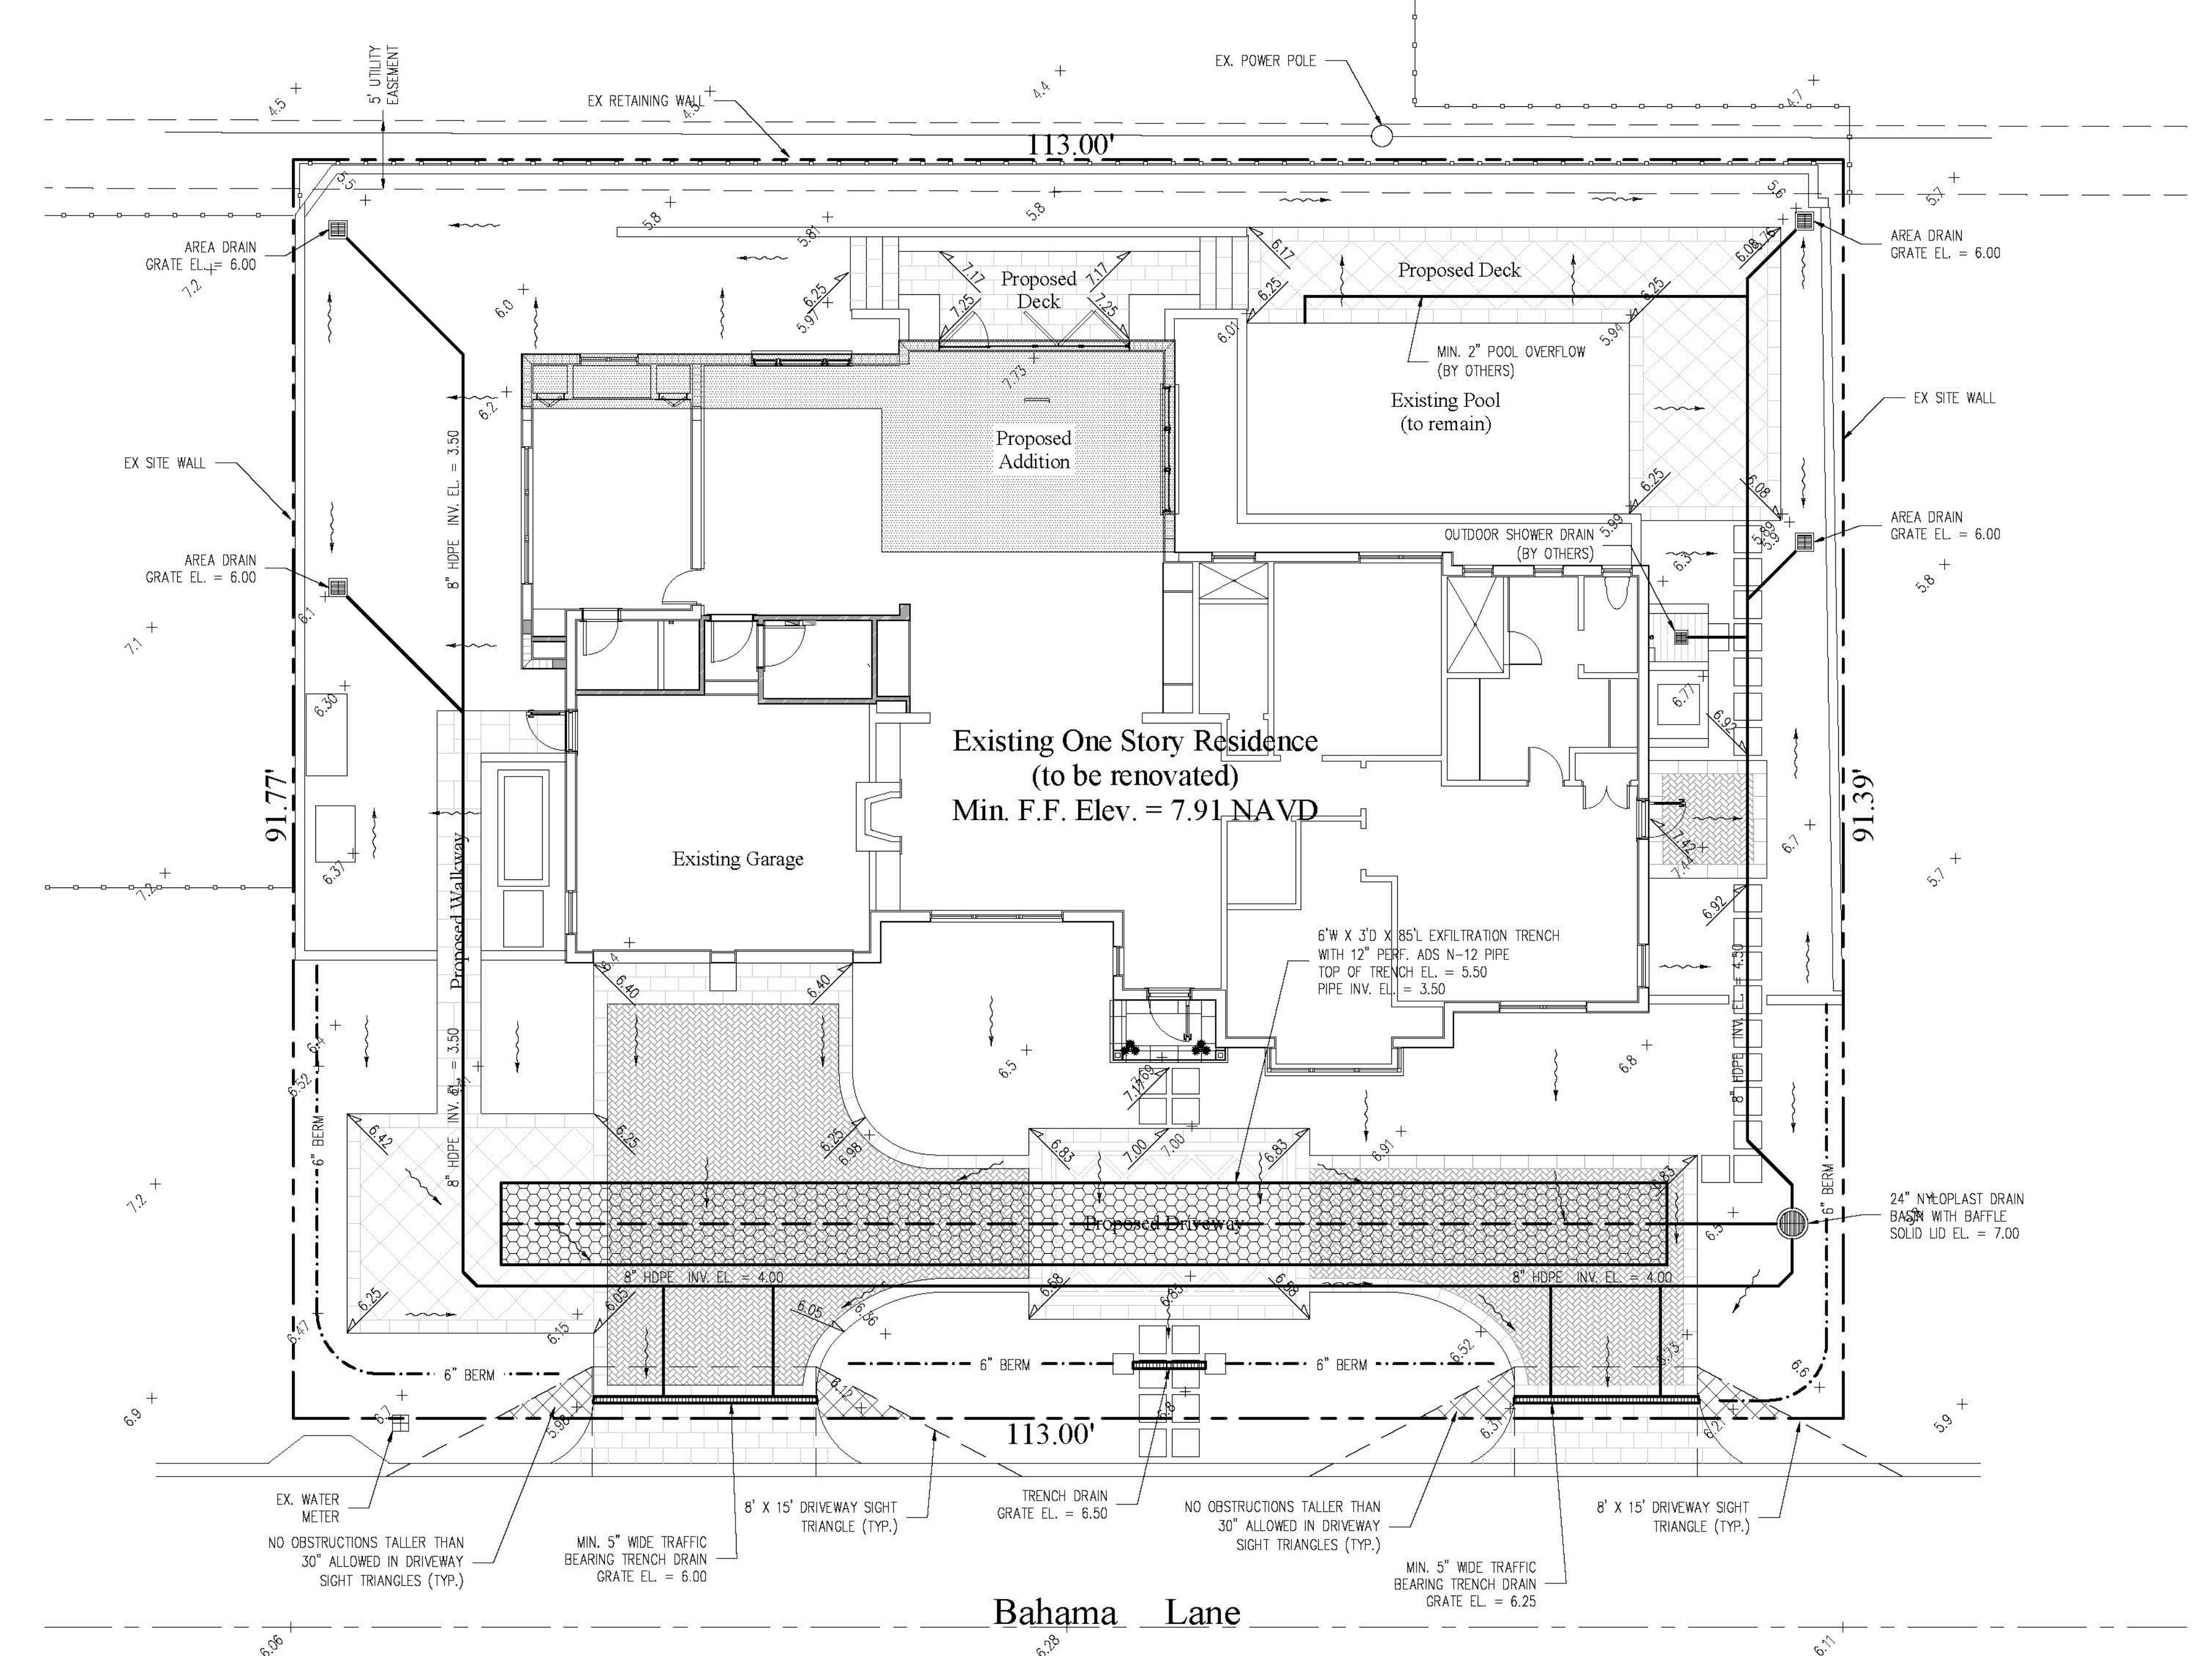

Legend

- EXISTING ELEVATION PER WALLACE SURVEYING CORP. (NAVD-88)
- PROPOSED ELEVATION (NAVD-88)
- - - PROPOSED ELEVATION CONTOUR (NAVD-88)
- FLOW DIRECTION
- [Hatched Box] EXFILTRATION TRENCH
- [Square] AREA DRAIN
- [Circle with Baffle] 24" NYLOPLAST DRAIN BASIN WITH BAFFLE

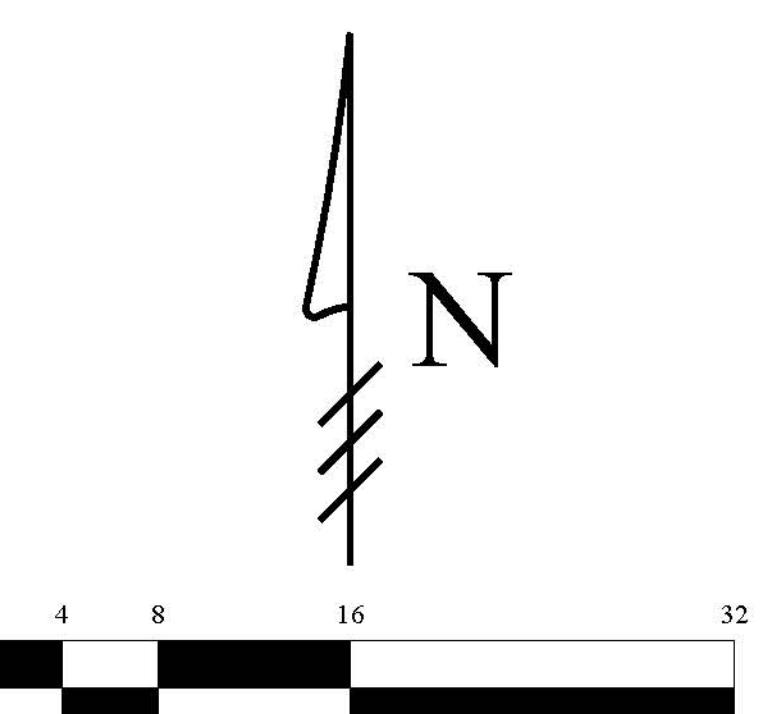

Scale: 1/8" = 1'-0"

This item has been electronically signed and sealed by Chad M. Gruber on the date adjacent to the seal using a SHA authentication code. Printed copies of this document are not considered signed and sealed and the SHA authentication code must be verified on any electronic copies.

Plan Background from Hardscape Plan by Environment Design Group Received 5/4/22

ARC-22-

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