# DE GUARDIOLA RESIDENCE

5 1 5 NORTH LAKE WAY PALM BEACH, FLORIDA

RECEIVED By elyn at 1:35 pm, Jul 15, 2022

MAJOR PROJECT WITH NOTICE


(COMBO PROJECT WITH SITE PLAN REVIEW, SPECIAL EXCEPTION, AND VARIANCE REQUESTS)

DRC FINAL SUBMITTAL REV 01

JULY 13, 2022

ARCOM MEETING DATE: JULY 27, 2022

TOWN COUNCIL MEETING DATE: AUGUST 10, 2022

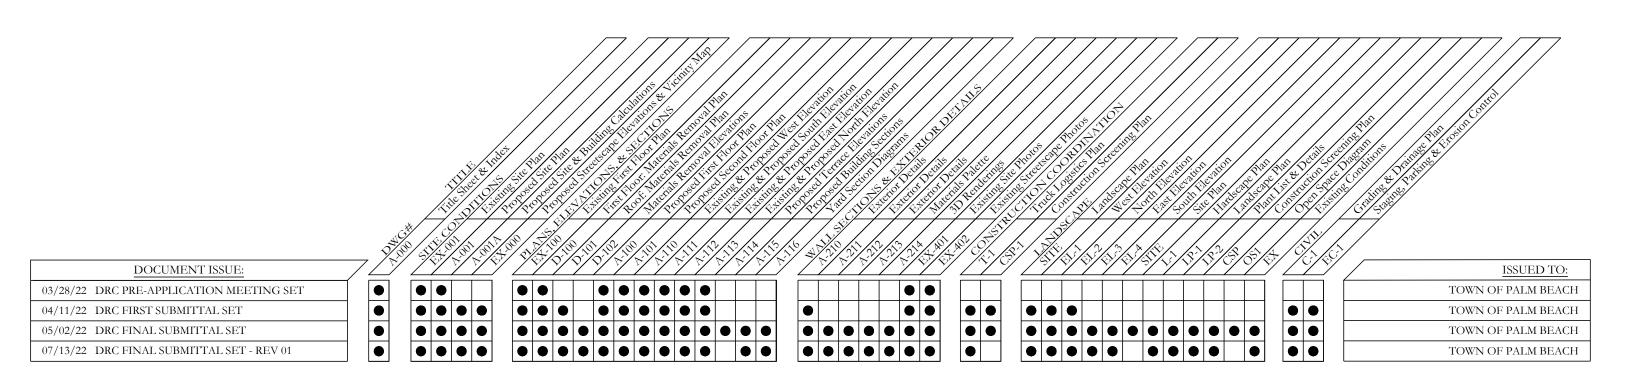



CIVIL ENGINEER GRUBER CONSULTING ENGINEERS, INC. 2475 MERCER AVENUE, SUITE 305 WEST PALM BEACH, FL 33401 561-312-2041

ARCHITECT FAIRFAX & SAMMONS ARCHITECTS 214 BRAZILIAN AVENUE, SUITE 100 PALM BEACH, FL 33480 561-805-8591

LANDSCAPE ARCHITECT NIEVERA WILLIAMS DESIGN 625 N. FLAGLER DRIVE, STE 502 WEST PALM BEACH, FL 33401 561-659-2820

# SCOPE OF WORK:

1. PARTIAL DEMOLITION, ENLARGEMENT AND CONVERSION OF AN EXISTING 1-STORY RESIDENCE TO A 2-STORY RESIDENCE

# LEGAL DESCRIPTION:

LOT 5, PLAT OF **TANGIER ESTATES** , ACCORDING TO THE PLAT THEREOF, AS RECORDED IN PLAT BOOK 12, PAGE 16, PUBLIC RECORDS OF PALM BEACH COUNTY, FLORIDA.

MUNICIPALITY: PALM BEACH LOCATION ADDRESS: 515 NORTH LAKE WAY PARCEL CONTROL NUMBER: 50-43-43-14-01-000-0050

# CODES AND STANDARDS:

THIS PROJECT WAS DESIGNED IN ACCORDANCE WITH THE 2020 FLORIDA BUILDING CODE.

DRC FINAL SUBMITTAL- REV 01 07/13/2022 DRC FINAL SUBMITTAL SET 05/02/2022 DRC FIRST SUBMITTAL SET 04/11/2022

FILE NUMBER:

03/28/2022

DRC PRE-APP MEETING SET

ARC-22-129

ZON-22-089

ZONING CASE NUMBER:

515 NORTH LAKE WAY PALM BEACH, FLORIDA 33480

COVER SHEET

JULY 13, 2022

N.T.S.

SCALE


MRVC



FAIRFAX & SAMMONS

FAIRFAX, SAMMONS & PARTNERS, LLC. 214 BRAZILIAN AVENUE, PALM BEACH 33480 TELEPHONE (561) 805-8591 LICENSE NO. AA26000846

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NOTE: ELEVATIONS REFERENCED TO NAVD SURVEY ELEVATIONS

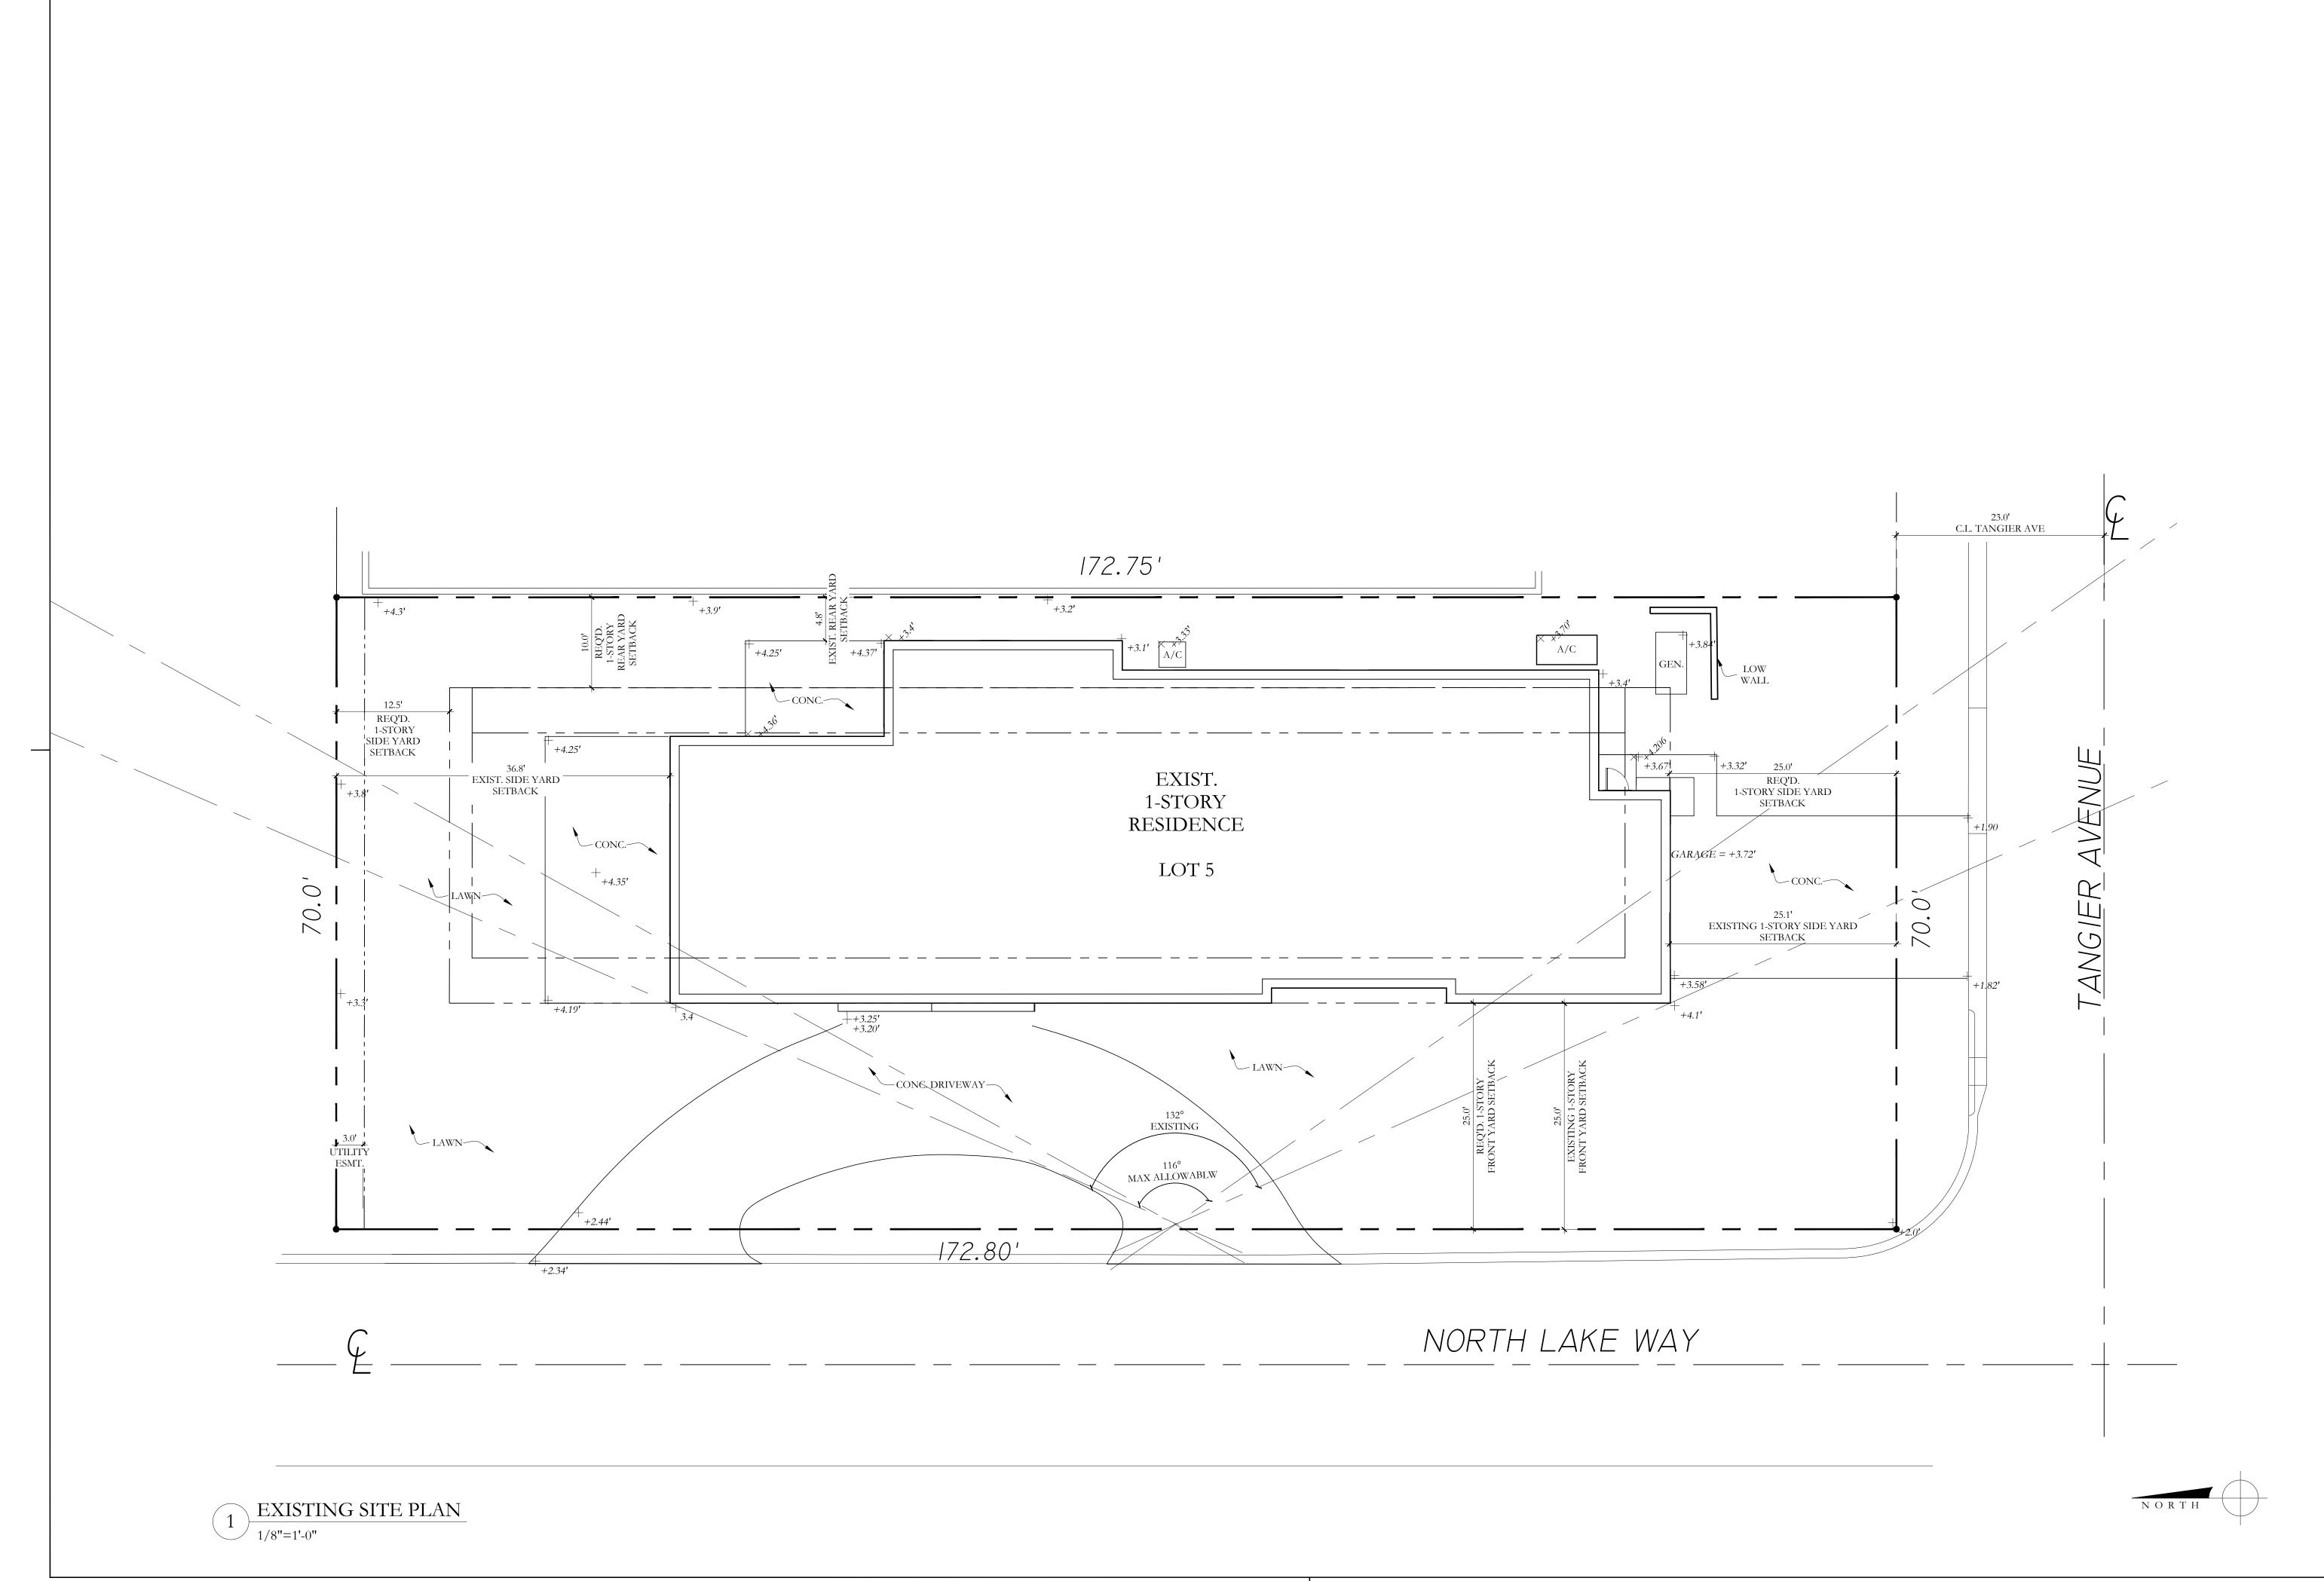LEGEND:

+<sub>+5.50'</sub> EXISTING SPOT ELEVATION

<u>NOTE:</u> REFER TO LANDSCAPE ARCHITECTURE AND CIVIL ENGINEERING DRAWINGS FOR ADDITIONAL GRADING INFORMATION

DRC FINAL SUBMITTAL- REV 01 07/08/2022 DRC FINAL SUBMITTAL SET 05/02/2022 DRC FIRST SUBMITTAL SET 04/11/2022

DRC PRE-APP MEETING SET 03/28/2022

> FILE NUMBER: ARC-22-129

ZONING CASE NUMBER:

ZON-22-089

515 NORTH LAKE WAY
PALM BEACH, FLORIDA 33480

SHEET TITLE EXISTING SITE PLAN

JUNE 8, 2022 SCALE

1/8" = 1'-0" MRVC

EX-001






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NOTE: ELEVATIONS REFERENCED TO NAVD SURVEY ELEVATIONS

LEGEND:

+<sub>+5.50'</sub> EXISTING SPOT ELEVATION

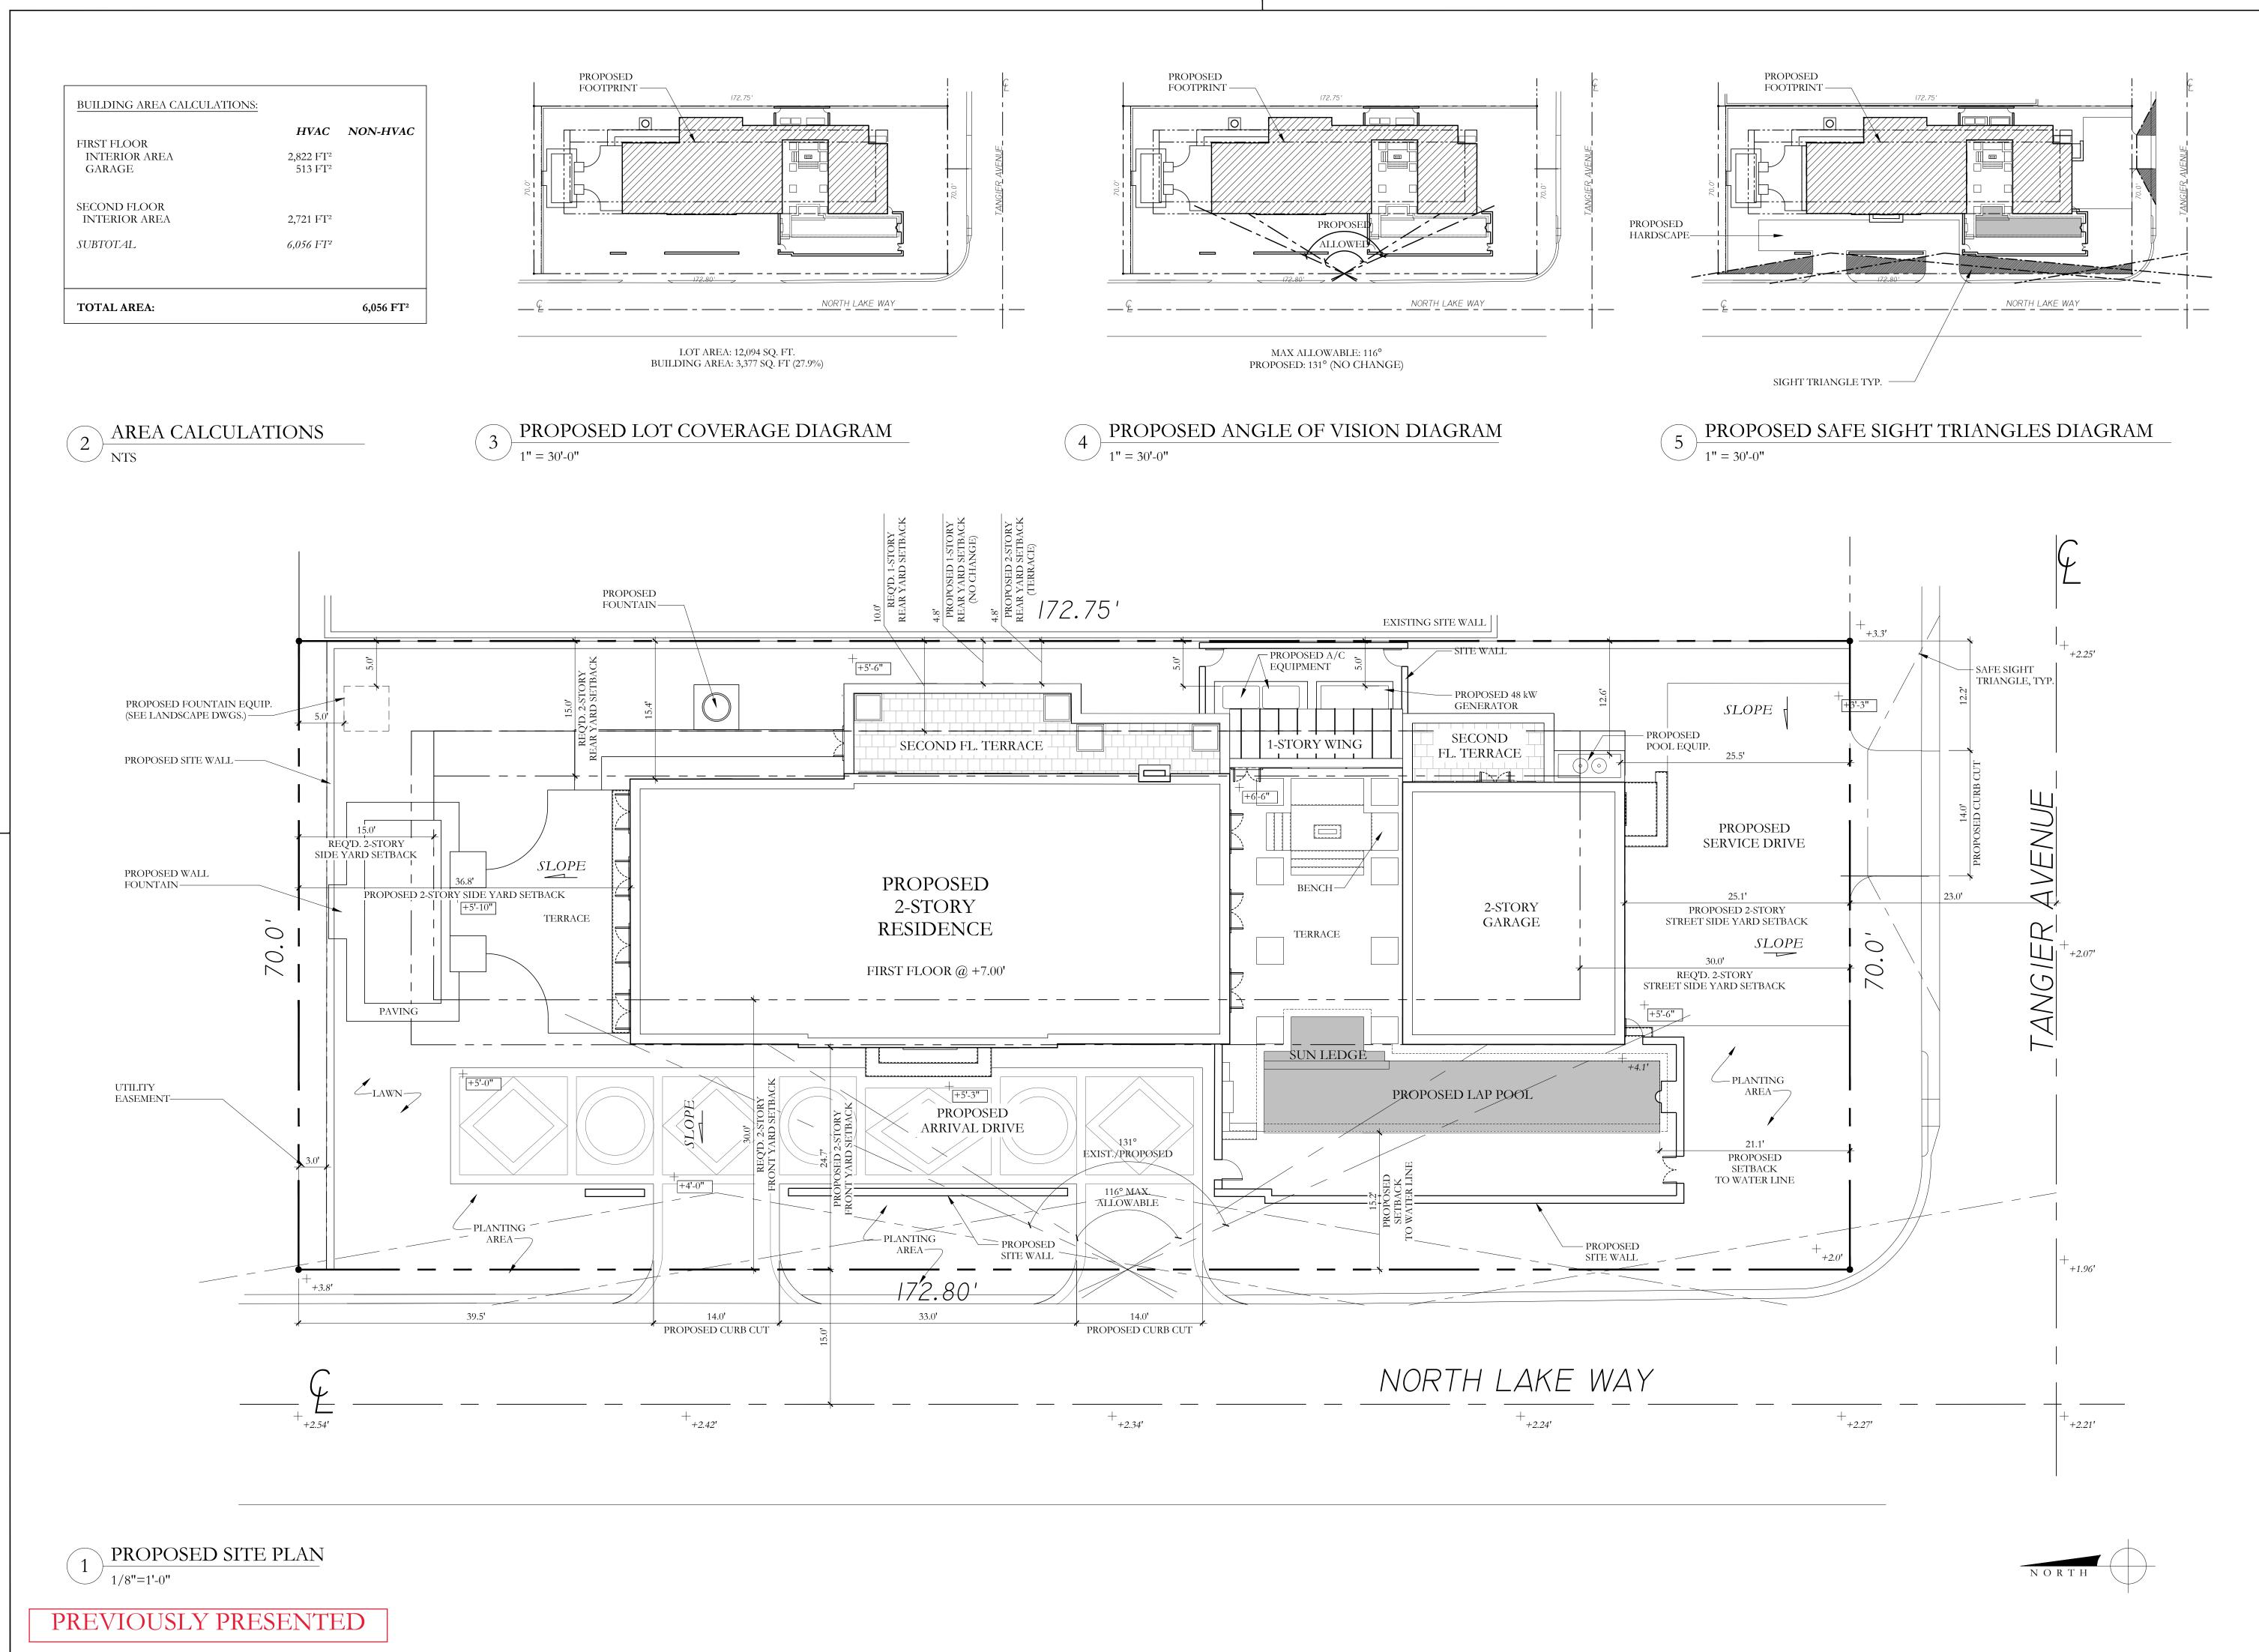+ PROPOSED SPOT ELEVATION

DRC FINAL SUBMITTAL SET 05/02/2022

DRC FIRST SUBMITTAL SET 04/11/2022

DRC PRE-APP MEETING SET 03/28/2022

ARC-22-129

FILE NUMBER:

ZONING CASE NUMBER:

ZON-22-089

515 NORTH LAKE WAY PALM BEACH, FLORIDA 33480

SHEET TITLE

PROPOSED SITE PLAN

DATE
MAY 2, 2022

SCALE
1/8"=1'-0"

BY
MRVC

FAIRFAX & SAMMONS

NEW YORK-PALM BEACH

FAIRFAX, SAMMONS & PARTNERS, LLC.


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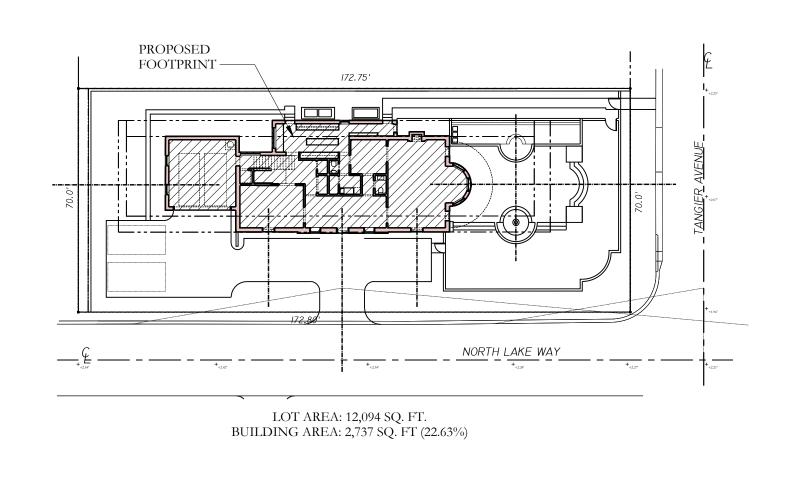
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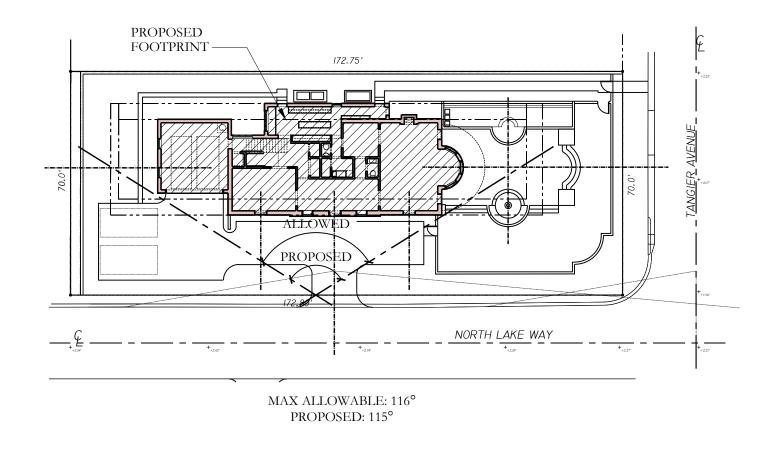
LICENSE NO. AA26000846


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2 AREA CALCULATIONS
NTS

PROPOSED LOT COVERAGE DIAGRAM


1" = 30' 0"

4 PROPOSED ANGLE OF VISION DIAGRAM

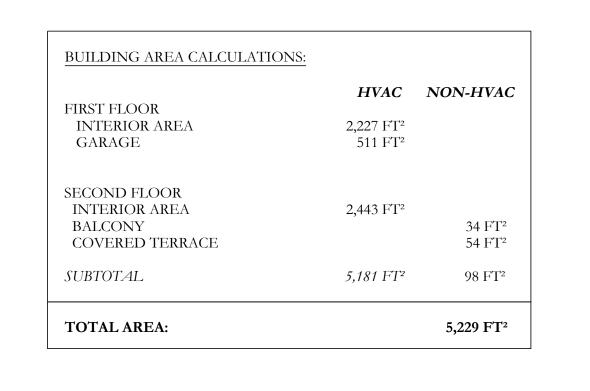1" = 30'-0"

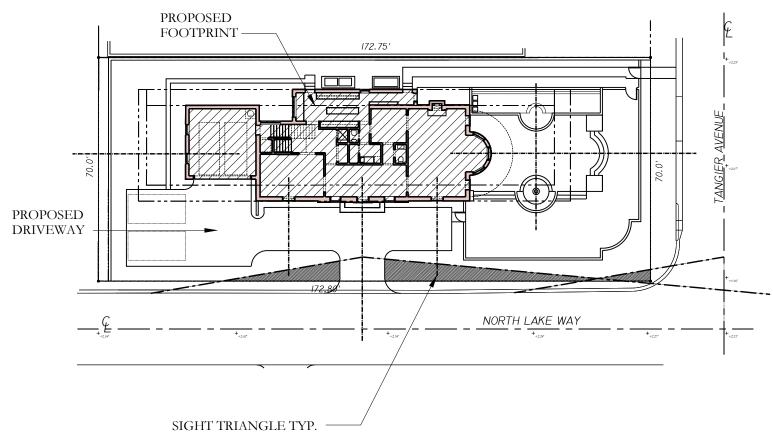5 PROPOSED SAFE SIGHT TRIANGLES DIAGRAM

1" = 30'-0"

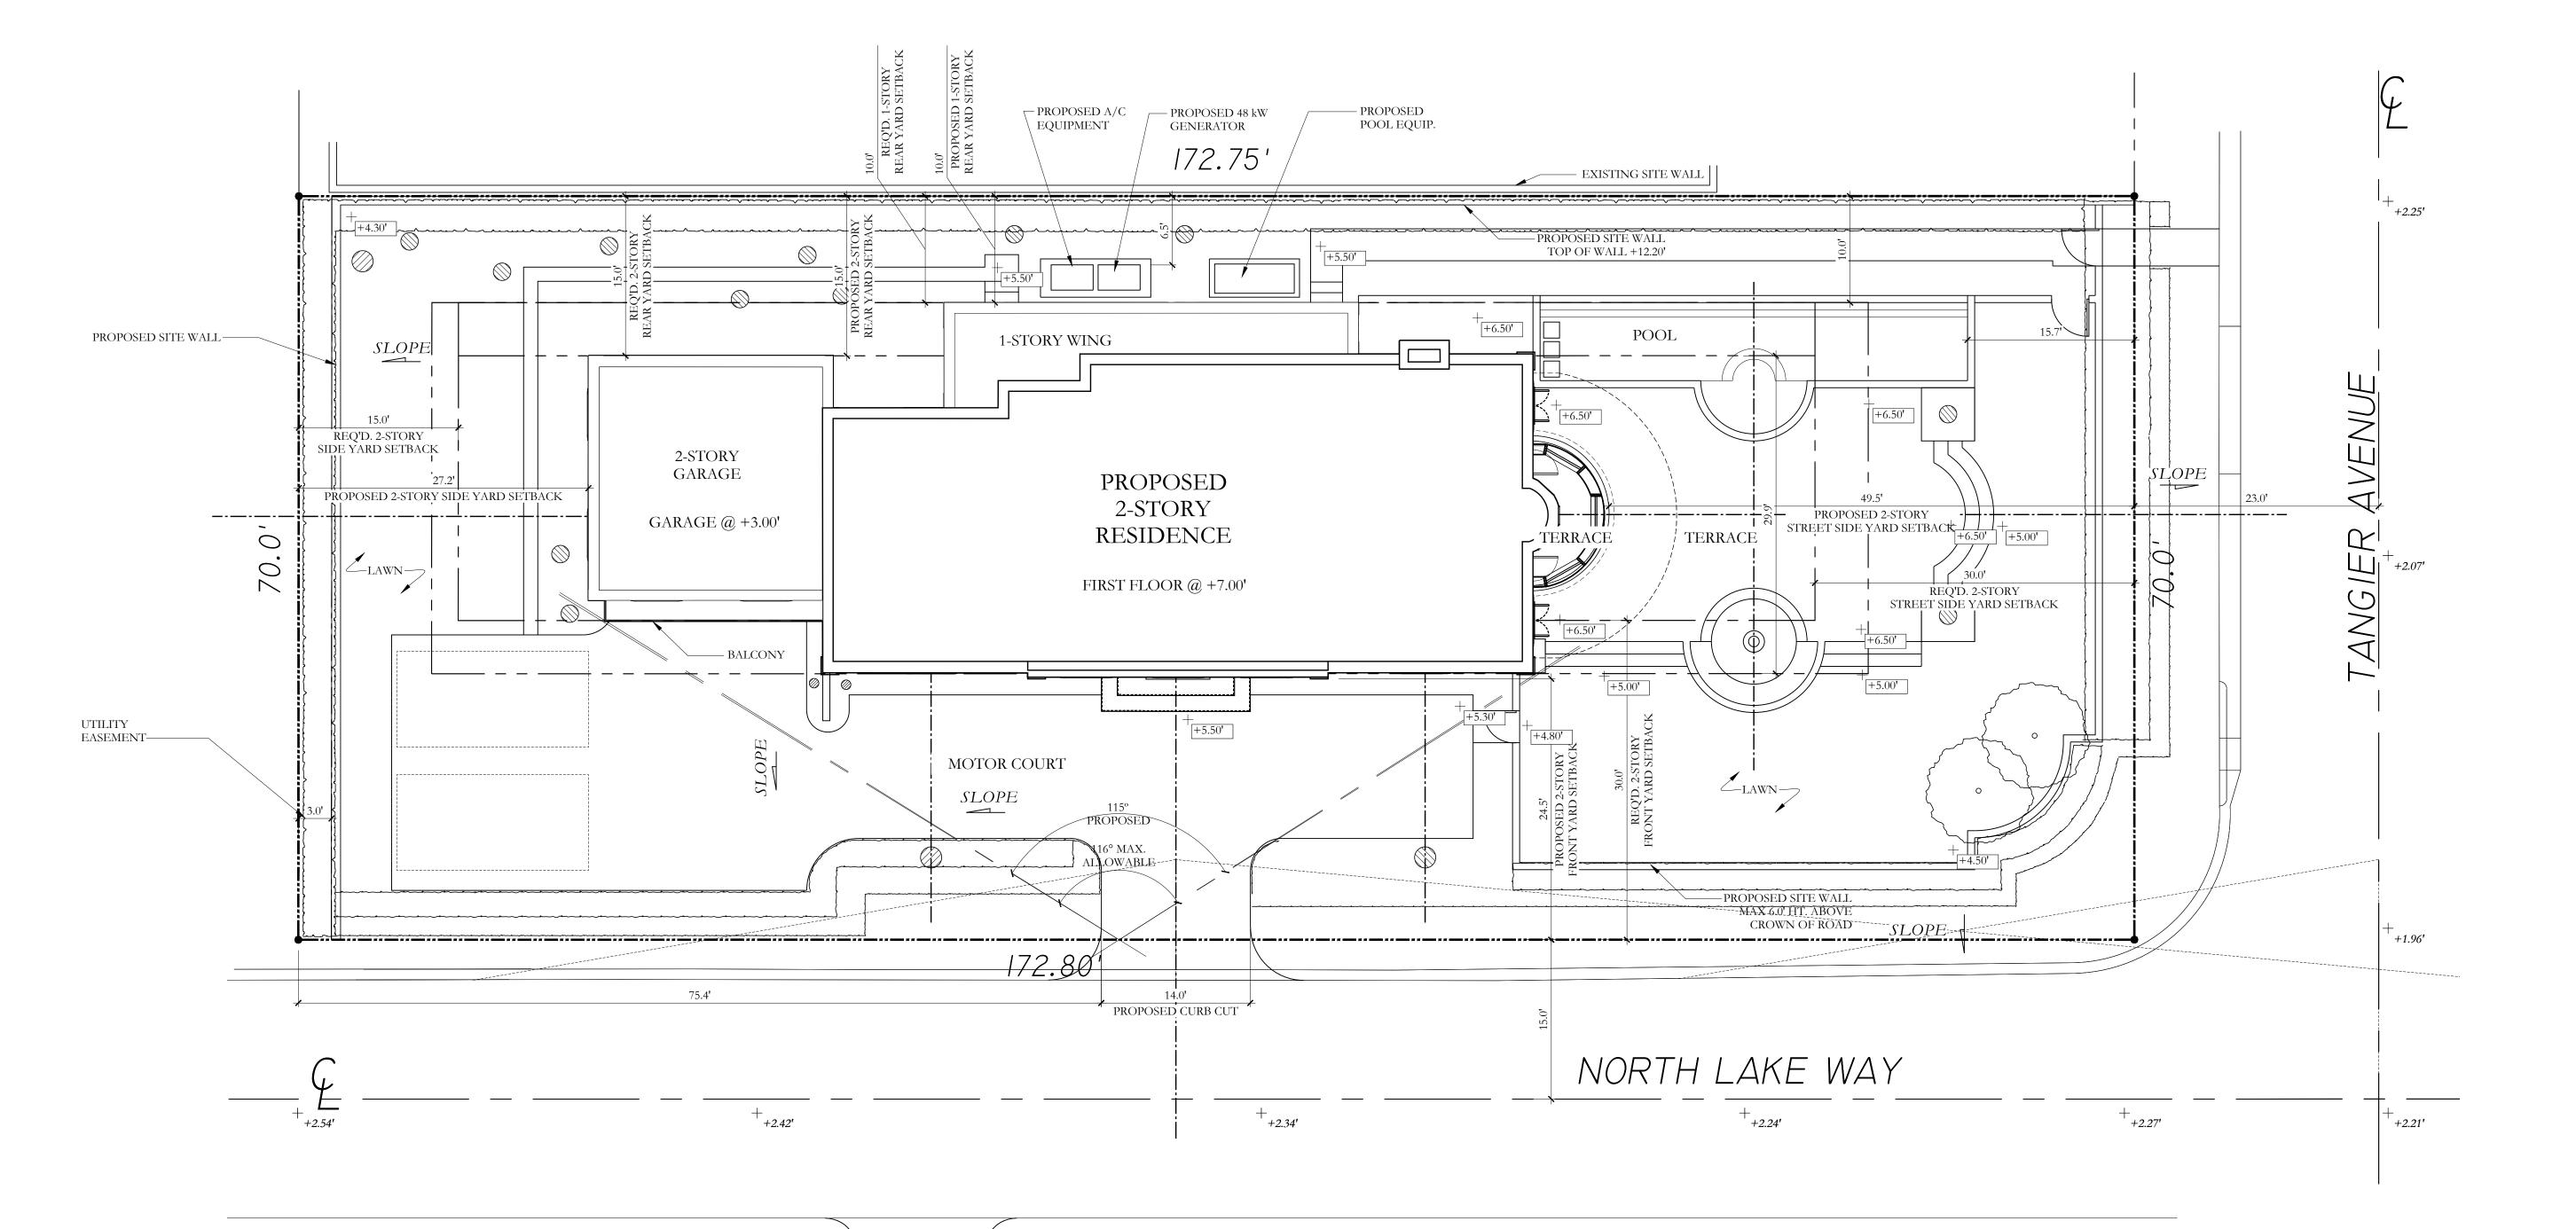

PROPOSED SITE PLAN

1/8"=1'-0"

N O R T H

NOTE: ELEVATIONS
REFERENCED TO NAVD
SURVEY ELEVATIONS

<u>LEGEND:</u>

+<sub>+5.50'</sub> EXISTING SPOT ELEVATION

+ PROPOSED SPOT ELEVATION

DRC FINAL SUBMITTAL- REV 01 07/13/2022

DRC FINAL SUBMITTAL SET 05/02/2022

DRC FIRST SUBMITTAL SET 04/11/2022

DRC PRE-APP MEETING SET 03/28/2022

ARC-22-129

FILE NUMBER:

ZON-22-089

515 NORTH LAKE WAY PALM BEACH, FLORIDA 33480

SHEET TITLE

PROPOSED SITE PLAN

DATE
JULY 13, 2022

SCALE
1/8"=1'-0"

BY
MRVC

FAIR FAX & SAM MONS

NEW YORK-PALM BEACH

FAIRFAX, SAMMONS & PARTNERS, LLC.

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### Town of Palm Beach Planning Zoning and Building Palm Beach, FL 33480

www.townofpalmbeach.com

Line #	Zoning Legend						
1	Property Address:						
2	Zoning District:	R-B Low Density Residential					
3	Structure Type:	: CBS					
4		Required/Allowed	Existing	Proposed	Variance Request		
5	Lot Size (sq ft)	10,000 s.f. min.	12,094 s.f.	N/C			
6	Lot Depth	100' min.	70'	N/C			
7	Lot Width	100' min.	172.75' - 172.80'	N/C			
8	Lot Coverage (1-story) (Sq Ft and %)	4,837 s.f. (40%) max.	3,867 s.f. (31.97%)	N/A			
9	Lot Coverage (2-story) (Sq Ft and %)	3,628 s.f. (30%) max.	N/A	3,335 s.f. (27.58%)			
10	Enclosed Square Footage (Basement. 1st Fl. 2nd Fl Accesory Structues. etc	N/A	3,867 s.f.	6,056 s.f.			
11	Cubic Content Ratio (CCR) (R-B ONLY)	3.98 (48,134 c.f.) max.	2.88 (34,803 c.f.)	5.13 (62,024 c.f.)	Х		
12	*Front Yard (West) Setback (1st Story) (Ft.)	25.0' min.	25.0'	N/A			
13	*Front Yard (West) Setback (2nd Story) (Ft.)	30.0' min.	N/A	24.7'	Х		
14	* Street Side Yard (South) Setback (1st Story) (Ft.)	25.0' min.	25.1'	N/A			
15	* Street Side Yard (South) Setback (2nd Story) (Ft.)	30.0' min.	N/A	25.1'	Х		
16	* Side Yard (North) Setback (1st Story) (Ft.)	12.5' min.	36.8'	N/A			
17	* Side Yard (North) Setback (2nd Story) (Ft.)	15.0' min.	N/A	36.8'			
18	*Rear Yard (East) Setback (1st Story) (Ft.)	10.0' min.	4.8'	N/C	Х		
19	*Rear Yard (East) Setback (2nd Story) (Ft.)	15.0' min.	N/A	4.8' (Terrace)	Х		
20	Swimming Pool (Front Yard) Setback (Ft.)	25.0.' min.	N/A	15.2'	Х		
21	Angle of Vision (Deg.)	116 deg. max.	131 deg.	N/C	Х		
22	Building Height (1-story) (Ft.)	14' max.	9.0'	10.67'			
23	Building Height (2-story) (Ft.)	22' max.	N/A	21.5'			
24	Overall Building Height (1-story) (Ft.)	17' max. (flat roof)	11.92'	14.5'			
25	Overall Building Height (2-story) (Ft.)	25' max. (flat roof)	N/A	24.67'			
26	Site Wall in Front/Street Side Yard Setback	6.0' max.	N/A	7.5'	Х		
27	Crown of Road (COR) (N Lake Way) (NAVD)	N/A	+2.36' NAVD (avg.)	N/C			
28	Crown of Road (COR) (Tangier Ave.) (NAVD)	N/A	+2.09' NAVD (avg.)	N/C			
29	Max. Amount of Fill Added to Site (Ft.)	2.23'	N/A	2.23'			
30	Finished Floor Elev. (FFE)(NAVD)	N/A	+5.1' NAVD	+7.0' NAVD			
31	Zero Datum for point of meas. (NAVD)	N/A	+5.1' NAVD	+7.0' NAVD			
32	FEMA Flood Zone Designation	N/A	AE (El. 6)	N/C			
33	Base Flood Elevation (BFE)(NAVD)	N/A	+7.0' NAVD	N/C			
34	Landscape Open Space (LOS) (Sq Ft and %)	5,443 s.f. (45%) min.	N/A	5,451 (45.1%)			
35		2,722 s.f. (22.5%) min.	N/A	2,459 (56.9%)			
36	Front Yard LOS (1-story) (Sq Ft and %)		N/A	1,738 (40.2%)			
37	**Native Plant Species %						

\* Indicate each yard area with cardinal direction (N,S,E,W)

\*\* Provide Native plant species calculation per category as requited by Ord. 24-2021 on separate table

If value is not changing, enter N/C

If value is not applicable, enter N/A



PRPOSED CUBIC CONTENT TABULATIONS:					
MASS:	SQUARE FOOTAGE:	<u>HEIGHT:</u>	VOLUME: (IN CUBIC FEET)		
TWO-STORY HOUSE	2,001 SQ. FT.	21.5 FT.	43,022 CU. FT.		
TWO-STORY GARAGE	720 SQ. FT.	18.25 FT.	13,140 CU. FT.		
ONE-STORY WING AT HOUSE	371 SQ. FT.	10.67 FT.	3,958 CU. FT.		
ONE-STORY WING AT GARAGE	243 SQ. FT.	7.83 FT.	1,904 CU. FT.		
ALLOWABLE C.C.R. CALCULATION:			$TOTAL = 62,024 \text{ FT}^3$		


3.5 + [ ((60,000 - 12,094) / 50,000) x 0.5 ]

 $3.5 + [(47,906/50,000) \times 0.5]$  $3.5 + [0.958 \times 0.5]$ 


3.5 + [0.479]

3.98 CCR OR 48,134 CU. FT.

CUBIC CONTENT TABULATION  $\begin{array}{c} 2 \\ \hline \text{N.T.S.} \end{array}$ 

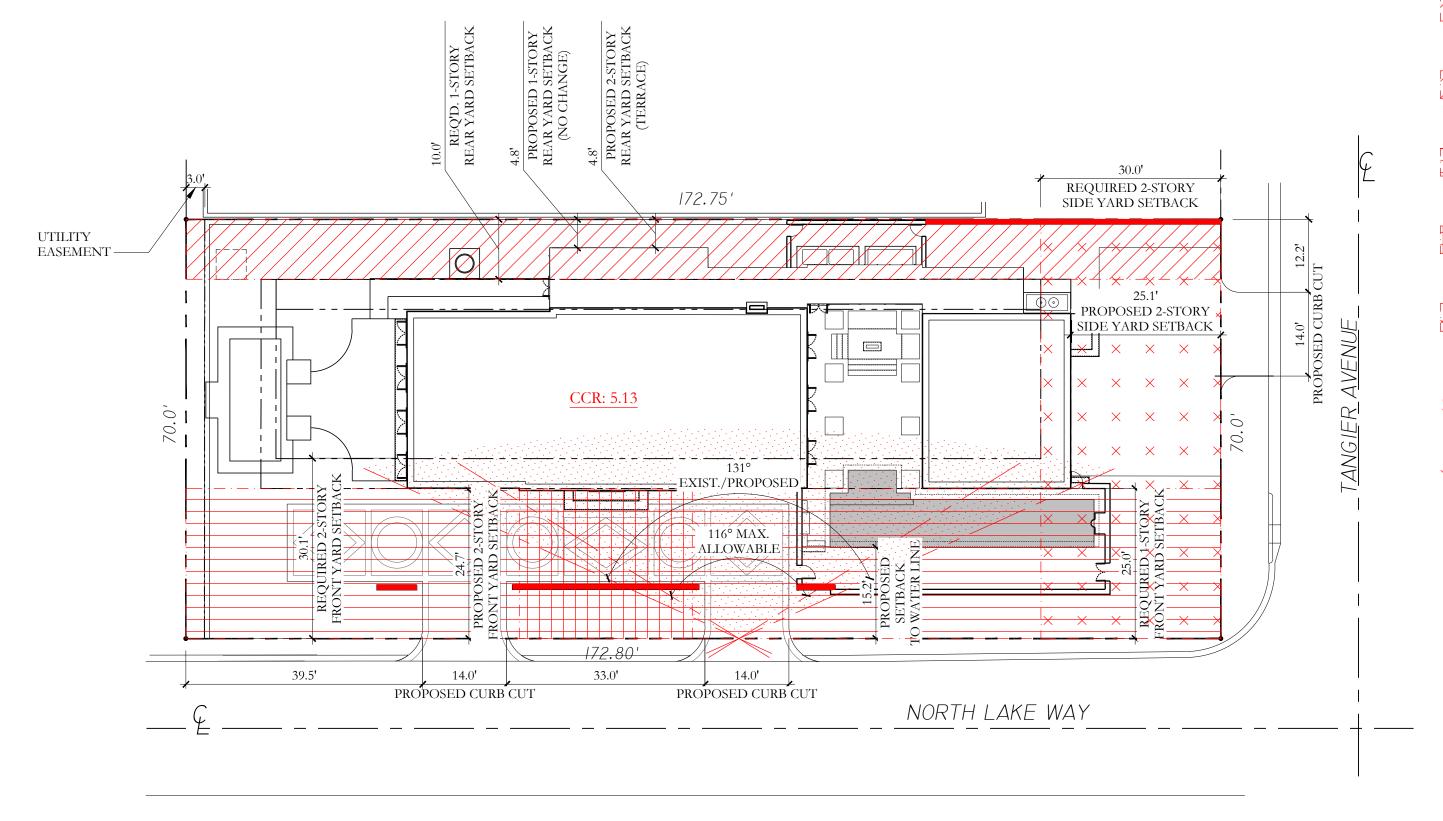

SITE PLAN VARIANCES DIAGRAM

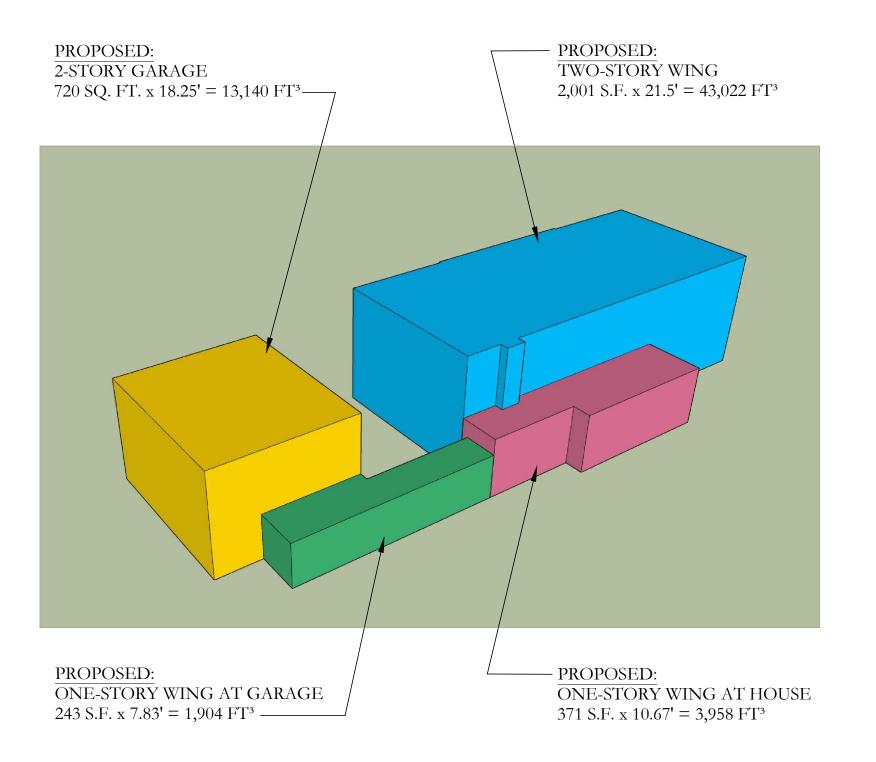

PROPOSED CUBIC CONTENT - VIEW FROM SOUTHEAST N.T.S.

# MAX FILL DEPTH:

(7.00 - 2.54)/2 = 2.23 ft. max.

# AVERAGE FILL DEPTH:

(5.5 + 5.0 + 5.5 + 3.25 + 5.5 + 6.5 + 6.5 + 6.0 + 5.8 + 5.68 +6.0 + 5.0 + 4.25 + 4.0 + 5.25 + 4.0 + 4.0 + 5.5 + 6.57 + 4.5 + 3.0 + 3.25 + 5.5)/23 = 5.04'  $7.00' - 5.04' = \sim 1.96'$  ft.

# FILL AREA:

12,094 SF - 416 SF (LESS THE EASEMENT & RETAINING WALL) = 11,678 SF 11,678 : 12,094 \* 100 = (11,678 \* 100) : 12,094 = $1,167,800:12,094 = 96.56\% = \sim 97\%$ 

NOTE:

ALL VALUES ARE APPROXIMATE, REFER TO CIVIL DRAWINGS FOR ADDITIONAL INFORMATION

SITE FILL CALCULATIONS

east rear yard setback of 4.8 ft in lieu of 10 ft required.

VARIANCE 1: Sec. 134-893(b)(9)a.: First story

VARIANCE 2: Sec. 134-893(b)(9)b.: Second story east rear yard setback of 4.8 ft in lieu of 10 ft required.

LEGEND

VARIANCE 3: Sec. 134-1757: A swimming pool within the required front yard with a 15.2 ft setback in lieu of 25 ft required.

VARIANCE 4: Sec. 134-893(b)(5)b.: A second story west front yard setback of 24.7 ft in lieu of the 30 ft required.

VARIANCE 5: Sec. 134-1576: A second story south street side yard setback of 25.1 ft in lieu of the 30 ft required

> VARIANCE 6: Sec. 134-893(b)(13): A Cubic Content Ratio (CCR) of 5.13 in lieu of the 2.88 existing and 3.98 maximum allowed

VARIANCE 7: Sec. 134-893(b)(6): Angle of Vision of 131 degrees in lieu of the 116 degrees maximum allowed

VARIANCE 8: Sec. 134-1667: Site walls in the front and street side yard setbacks with a height of 7.5 ft measured from crown of road, in lieu of the maximum 6 ft allowed

> DRC FINAL SUBMITTAL SET 05/02/2022 DRC FIRST SUBMITTAL SET 04/11/2022

> > FILE NUMBER:

03/28/2022

DRC PRE-APP MEETING SET

ARC-22-129

ZONING CASE NUMBER: ZON-22-089

515 NORTH LAKE WAY PALM BEACH, FLORIDA 33480

PROPOSED SITE & BUILDING CALCULATIONS

SHEET NO MAY 2, 2022 SCALE A-001A1/8"=1'-0" MRVC



FAIRFAX & SAMMONS - NEW YORK~PALM BEACH -FAIRFAX, SAMMONS & PARTNERS, LLC. 214 BRAZILIAN AVENUE, PALM BEACH 33480 TELEPHONE (561) 805-8591

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LICENSE NO. AA26000846

PREVIOUSLY PRESENTED



## Town of Palm Beach Planning Zoning and Building Palm Beach, FL 33480

www.townofpalmbeach.com

Line #	Zoning Legend							
1	Property Address:	515 North Lake Way, Palm Beach, FL 33480						
2	Zoning District:	R-B Low Density Residential						
3	Structure Type:	CBS						
4		Required/Allowed	Existing	Proposed	Variance Request			
5	Lot Size (sq ft)	10,000 s.f. min.	12,094 s.f.	N/C				
6	Lot Depth	100' min.	70'	N/C				
7	Lot Width	100' min.	172.75' - 172.80'	N/C				
8	Lot Coverage (1-story) (Sq Ft and %)	4,837 s.f. (40%) max.	3,867 s.f. (31.97%)	N/A				
9	Lot Coverage (2-story) (Sq Ft and %)	3,628 s.f. (30%) max.	N/A	2,737 s.f. (22.63%)				
10	Enclosed Square Footage (Basement, 1st Fl. 2nd Fl., Accesory Structues, etc)	N/A	3,867 s.f.	5,279 s.f.				
11	Cubic Content Ratio (CCR) (R-B ONLY)		2.88 (34,803 c.f.)	4.41 (53,377 c.f.)	Х			
12	*Front Yard (West) Setback (1st Story) (Ft.)	25.0' min.	25.0'	N/A				
13	*Front Yard (West) Setback (2nd Story) (Ft.)	30.0' min.	N/A	24.5'	Х			
14	* Street Side Yard (South) Setback (1st Story) (Ft.)	25.0' min.	25.1'	N/A				
15	* Street Side Yard (South) Setback (2nd Story) (Ft.)	30.0' min.	N/A	49.5'				
16	* Side Yard (North) Setback (1st Story) (Ft.)	12.5' min.	36.8'	N/A				
17	* Side Yard (North) Setback (2nd Story) (Ft.)	15.0' min.	N/A	27.2'				
18	*Rear Yard (East) Setback (1st Story) (Ft.)	10.0' min.	4.8'	10.0'				
19	*Rear Yard (East) Setback (2nd Story) (Ft.)	15.0' min.	N/A	15.0'				
20	Angle of Vision (Deg.)	116 deg. max.	131 deg.	115 deg.				
21	Building Height (1-story) (Ft.)	14' max.	9.0'	N/C				
22	Building Height (2-story) (Ft.)	22' max.	N/A	21.5'				
23	Overall Building Height (1-story) (Ft.)	17' max. (flat roof)	11.92'	N/C				
24	Overall Building Height (2-story) (Ft.)	25' max. (flat roof)	N/A	25.0'				
25	Crown of Road (COR) (N Lake Way) (NAVD)	N/A	+2.36' NAVD (avg.)	N/C				
26	Crown of Road (COR) (Tangier Ave.) (NAVD)	N/A	+2.09' NAVD (avg.)	N/C				
27	Max. Amount of Fill Added to Site (Ft.)	2.23'	N/A	2.23'				
28	Finished Floor Elev. (FFE)(NAVD)	N/A	+5.1' NAVD	+7.0' NAVD				
29	Zero Datum for point of meas. (NAVD)		+5.1' NAVD	+7.0' NAVD				
30	FEMA Flood Zone Designation	N/A	AE (El. 6)	N/C				
31	Base Flood Elevation (BFE)(NAVD)	N/A	+7.0' NAVD	N/C				
32	Landscape Open Space (LOS) (Sq Ft and %)	5,445 s.f. (45%) min.	N/A	5,650 (46.69%)				
33		2,420 s.f. (54.3%) min.	N/A	3,458 (77%)				
34	Front Yard LOS (1-story) (Sq Ft and %)		N/A	2,502 (57.9%)				
35	**Native Plant Species %							

\* Indicate each yard area with cardinal direction (N,S,E,W)

\*\* Provide Native plant species calculation per category as requited by Ord. 24-2021 on separate table

ZONING LEGEND

TWO-STORY HOUSE

TWO-STORY GARAGE

ONE-STORY AT GREAT RM. (1ST FL.)

ONE-STORY AT KITCHEN (1ST FL.)

BEDROOM 2/OFFICE BALCONY

PRIMARY BED. COVERED TERRACE

MASS:

If value is not changing, enter N/C

If value is not applicable, enter N/A

172.80'

SITE PLAN VARIANCES DIAGRAM

1/16" = 1'-0"



— PROPOSED:

PROPOSED:

2-STORY HOUSE

 $1,907 \text{ SQ. FT. } \times 21.5' = 41,001 \text{ FT}^3$ 

BED. 2/OFFICE BALCONY

 $39 \text{ S.F. } \times 8.67' = 338 \text{ FT}^3$ 

LEGEND

NORTH LAKE WAY

of the 30 ft required.

VARIANCE 1: Sec. 134-893(b)(5)b.: A second story west front yard setback of 24.5 ft in lieu

VARIANCE 2: Sec. 134-893(b)(13): A Cubic

CCR: 4.41 Content Ratio (CCR) of 4.41 in lieu of the 2.88 existing and 3.98 maximum allowed

# MAX FILL DEPTH:

(7.00 - 2.54)/2 = 2.23 ft. max.

### AVERAGE FILL DEPTH:

(5.5 + 5.0 + 5.5 + 3.25 + 5.5 + 6.5 + 6.5 + 6.0 + 5.8 + 5.68 +6.0 + 5.0 + 4.25 + 4.0 + 5.25 + 4.0 + 4.0 + 5.5 + 6.57 + 4.5 +3.0 + 3.25 + 5.5)/23 = 5.04'  $7.00' - 5.04' = \sim 1.96'$  ft.

#### FILL AREA:

12,094 SF - 416 SF (LESS THE EASEMENT & RETAINING WALL) = 11,678 SF11,678 : 12,094 \* 100 = (11,678 \* 100) : 12,094 = $1,167,800:12,094 = 96.56\% = \sim 97\%$ 

# *NOTE:*

ALL VALUES ARE APPROXIMATE, REFER TO CIVIL DRAWINGS FOR ADDITIONAL INFORMATION

# SITE FILL CALCULATIONS NTS

PROPOSED:

PRIMBARY BEDROOM COVERED TERRACE 59 SQ. FT.  $\times$  8.0' = 472 FT<sup>3</sup> ——— DRC PRE-APP MEETING SET

ZONING CASE NUMBER:

FILE NUMBER:

ARC-22-129

DRC FINAL SUBMITTAL- REV 01 07/13/2022

05/02/2022

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DRC FINAL SUBMITTAL SET

DRC FIRST SUBMITTAL SET

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515 NORTH LAKE WAY

PALM BEACH, FLORIDA 33480

PROPOSED SITE & BUILDING CALCULATIONS

JULY 13, 2022 SCALE 1/8"=1'-0"

MRVC

SHEET NO A-001A

FAIRFAX & SAMMONS

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PRPOSED CUBIC CONTENT TABULATIONS: SQUARE FOOTAGE: HEIGHT: VOLUME: (IN CUBIC FEET) 1,907 SQ. FT. 21.5 FT. 41,001 CU. FT. 8,261 CU. FT. 511 SQ. FT. 16.17 FT. 80 SQ. FT. 11.5 FT. 920 CU. FT. 19 SQ. FT. 190 CU. FT. ONE-STORY AT PRIMARY BED. (2ND FL.) 10.0 FT. 233 SQ. FT. 9.0 FT. 2,097 CU. FT. (VARIES) 21.5 FT. 98 CU. FT. 39 SQ. FT. 338 CU. FT. 8.67 FT. 59 SQ. FT. 472 CU. FT. 8.0 FT.

 $TOTAL = 53,377 FT^3$ 

ALLOWABLE C.C.R. CALCULATION:

 $3.5 + [(60,000 - 12,094) / 50,000) \times 0.5]$ 

 $3.5 + [(47,906/50,000) \times 0.5]$  $3.5 + [0.958 \times 0.5]$ 

CHIMNEY

3.5 + [ 0.479 ]

3.98 CCR OR 48,134 CU. FT.

CUBIC CONTENT TABULATION

PROPOSED: – PROPOSED: 2-STORY HOUSE TWO-STORY GARAGE  $511 \text{ S.F. } \times 16.17' = 8,261 \text{ FT}^3$ 1,907 SQ. FT. x 21.5' = 41,001 FT<sup>3</sup> ---– PROPOSED: - PROPOSED: ONE-STORY AT GREAT RM. ONE-STORY AT KITCHEN  $80 \text{ S.F. } \text{x } 11.5' = 920 \text{ FT}^3$ 233 S.F.  $\times$  9.0' = 3,958 FT<sup>3</sup> PROPOSED: CHIMNEY

172.75'

CCR: 4.41

3 PROPOSED CUBIC CONTENT - VIEW FROM SOUTHEAST N.T.S.


VARIES x  $21.5' = 98 \text{ FT}^3$ 


4 PROPOSED CUBIC CONTENT - VIEW FROM SOUTHWEST N.T.S.


PROPOSED:

19 S.F.  $\times$  10.0' = 190 FT<sup>3</sup> –

ONE-STORY AT PRIMARY BEDROOM

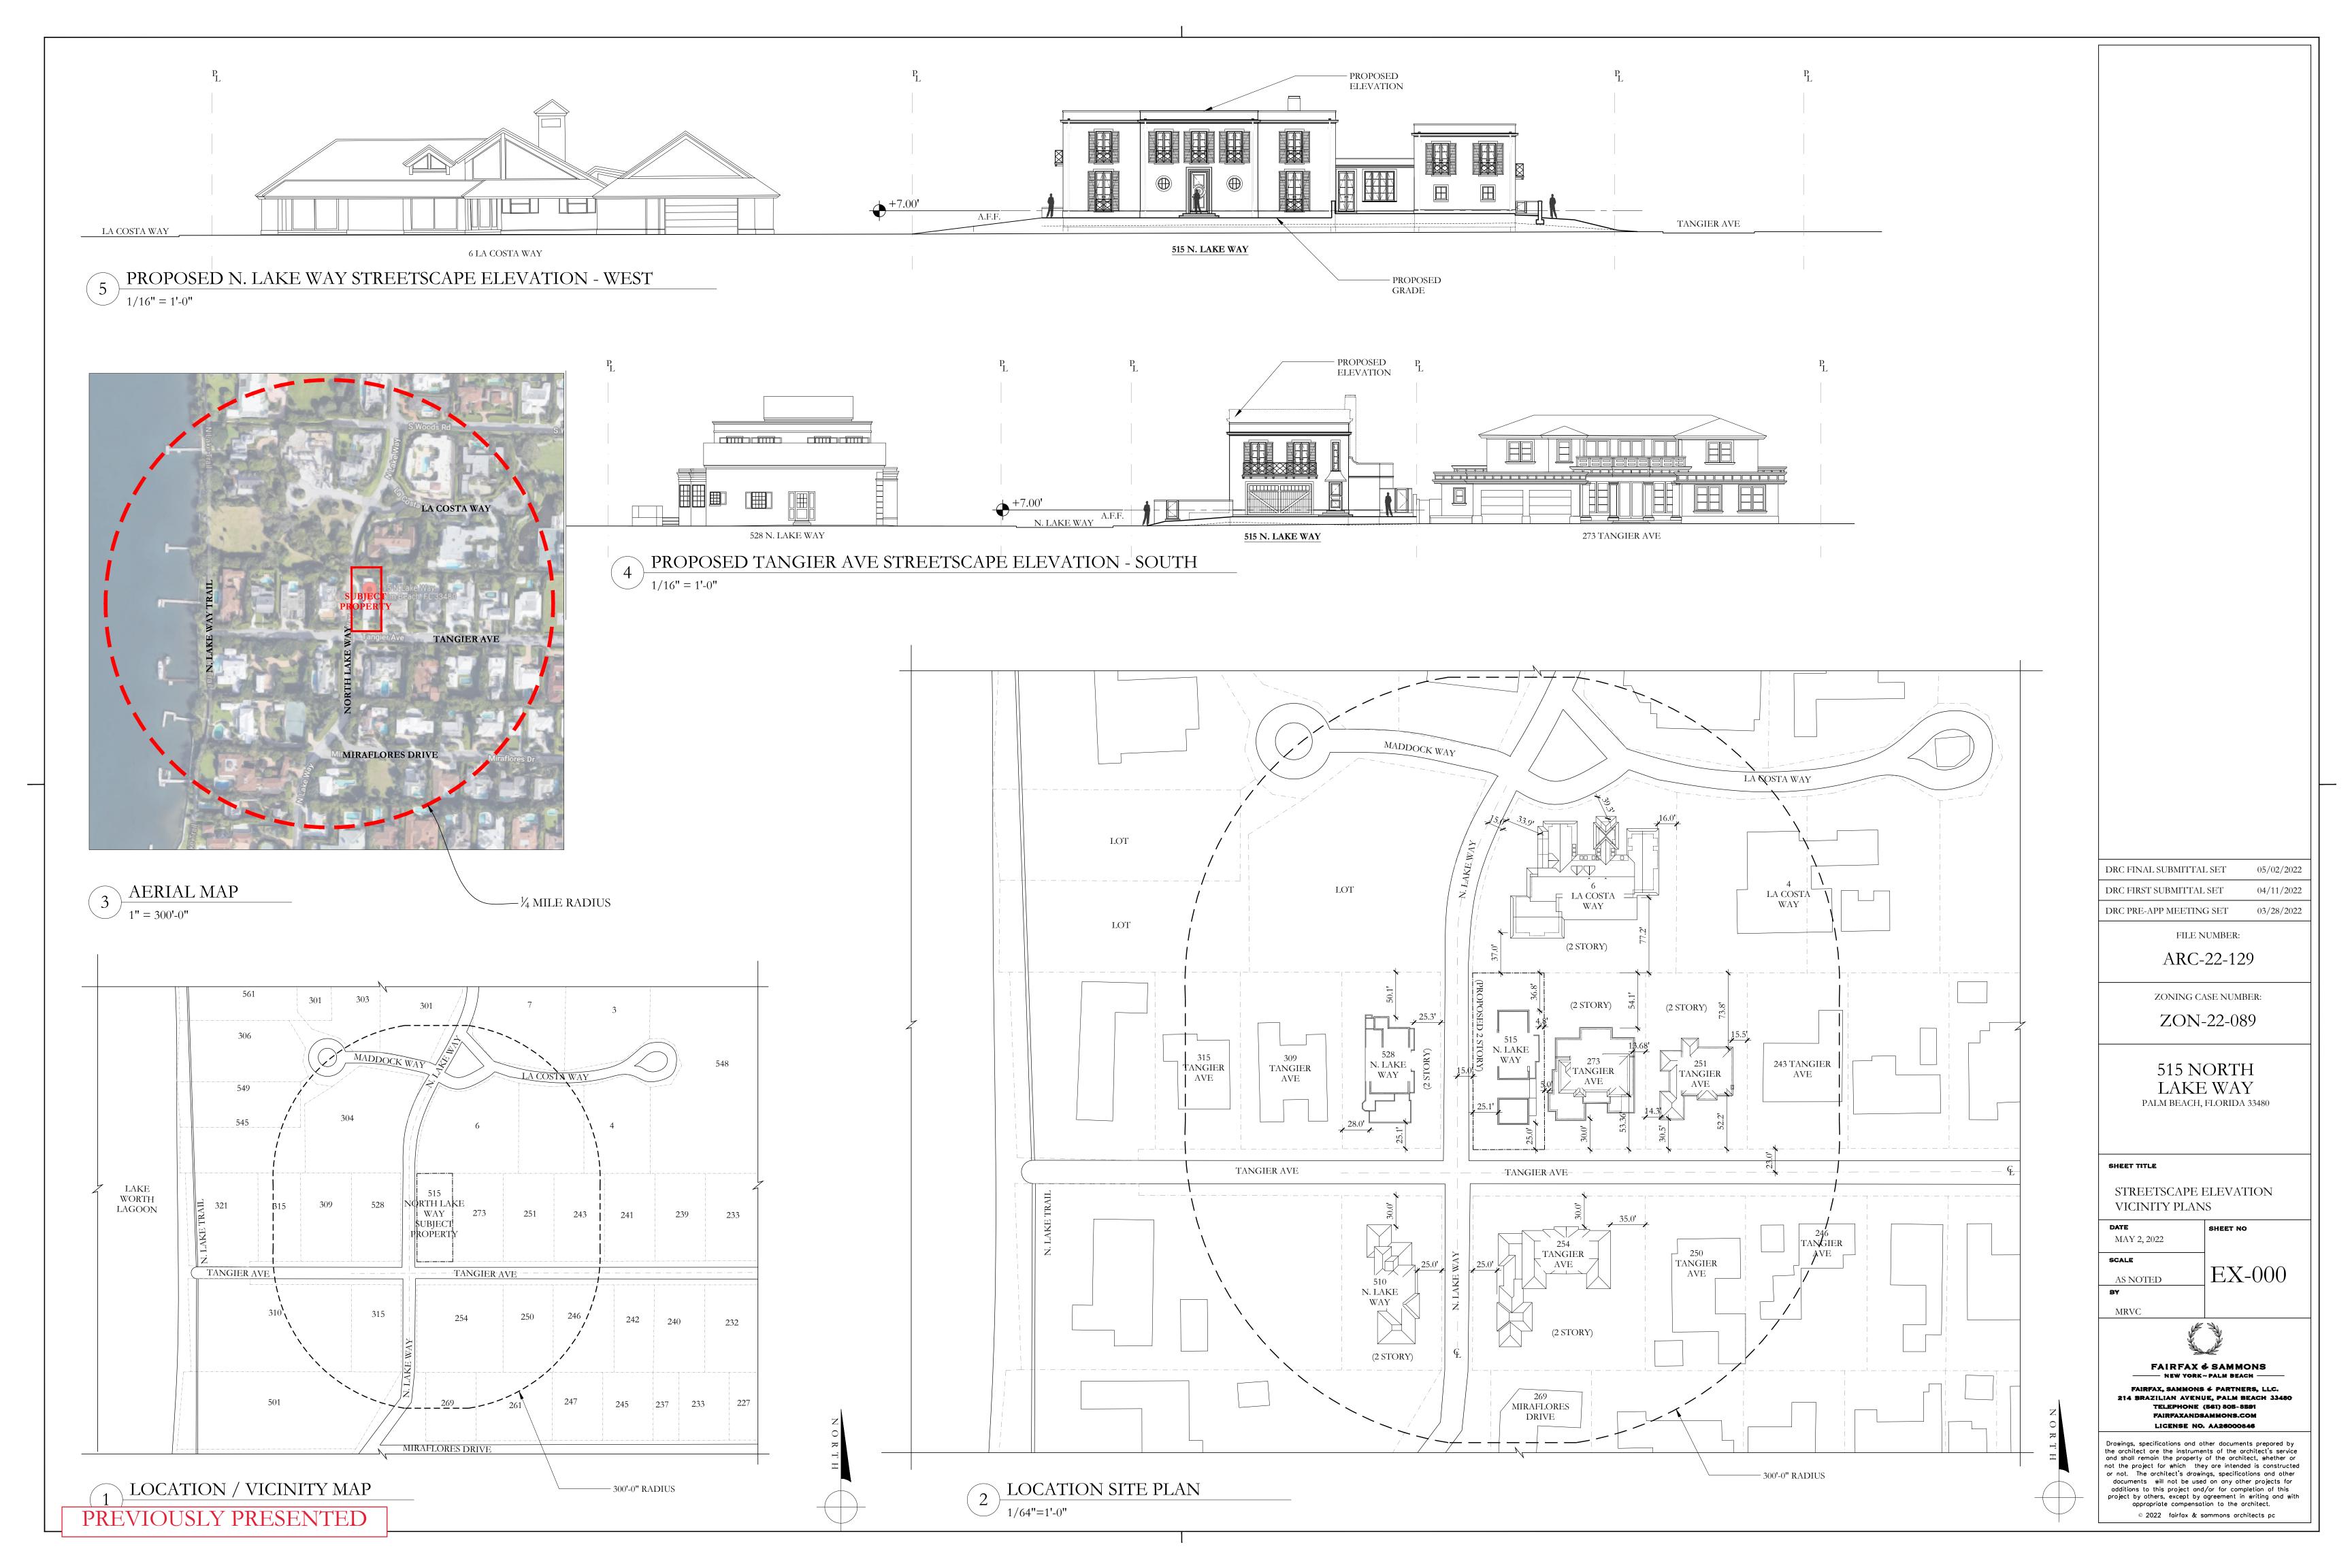

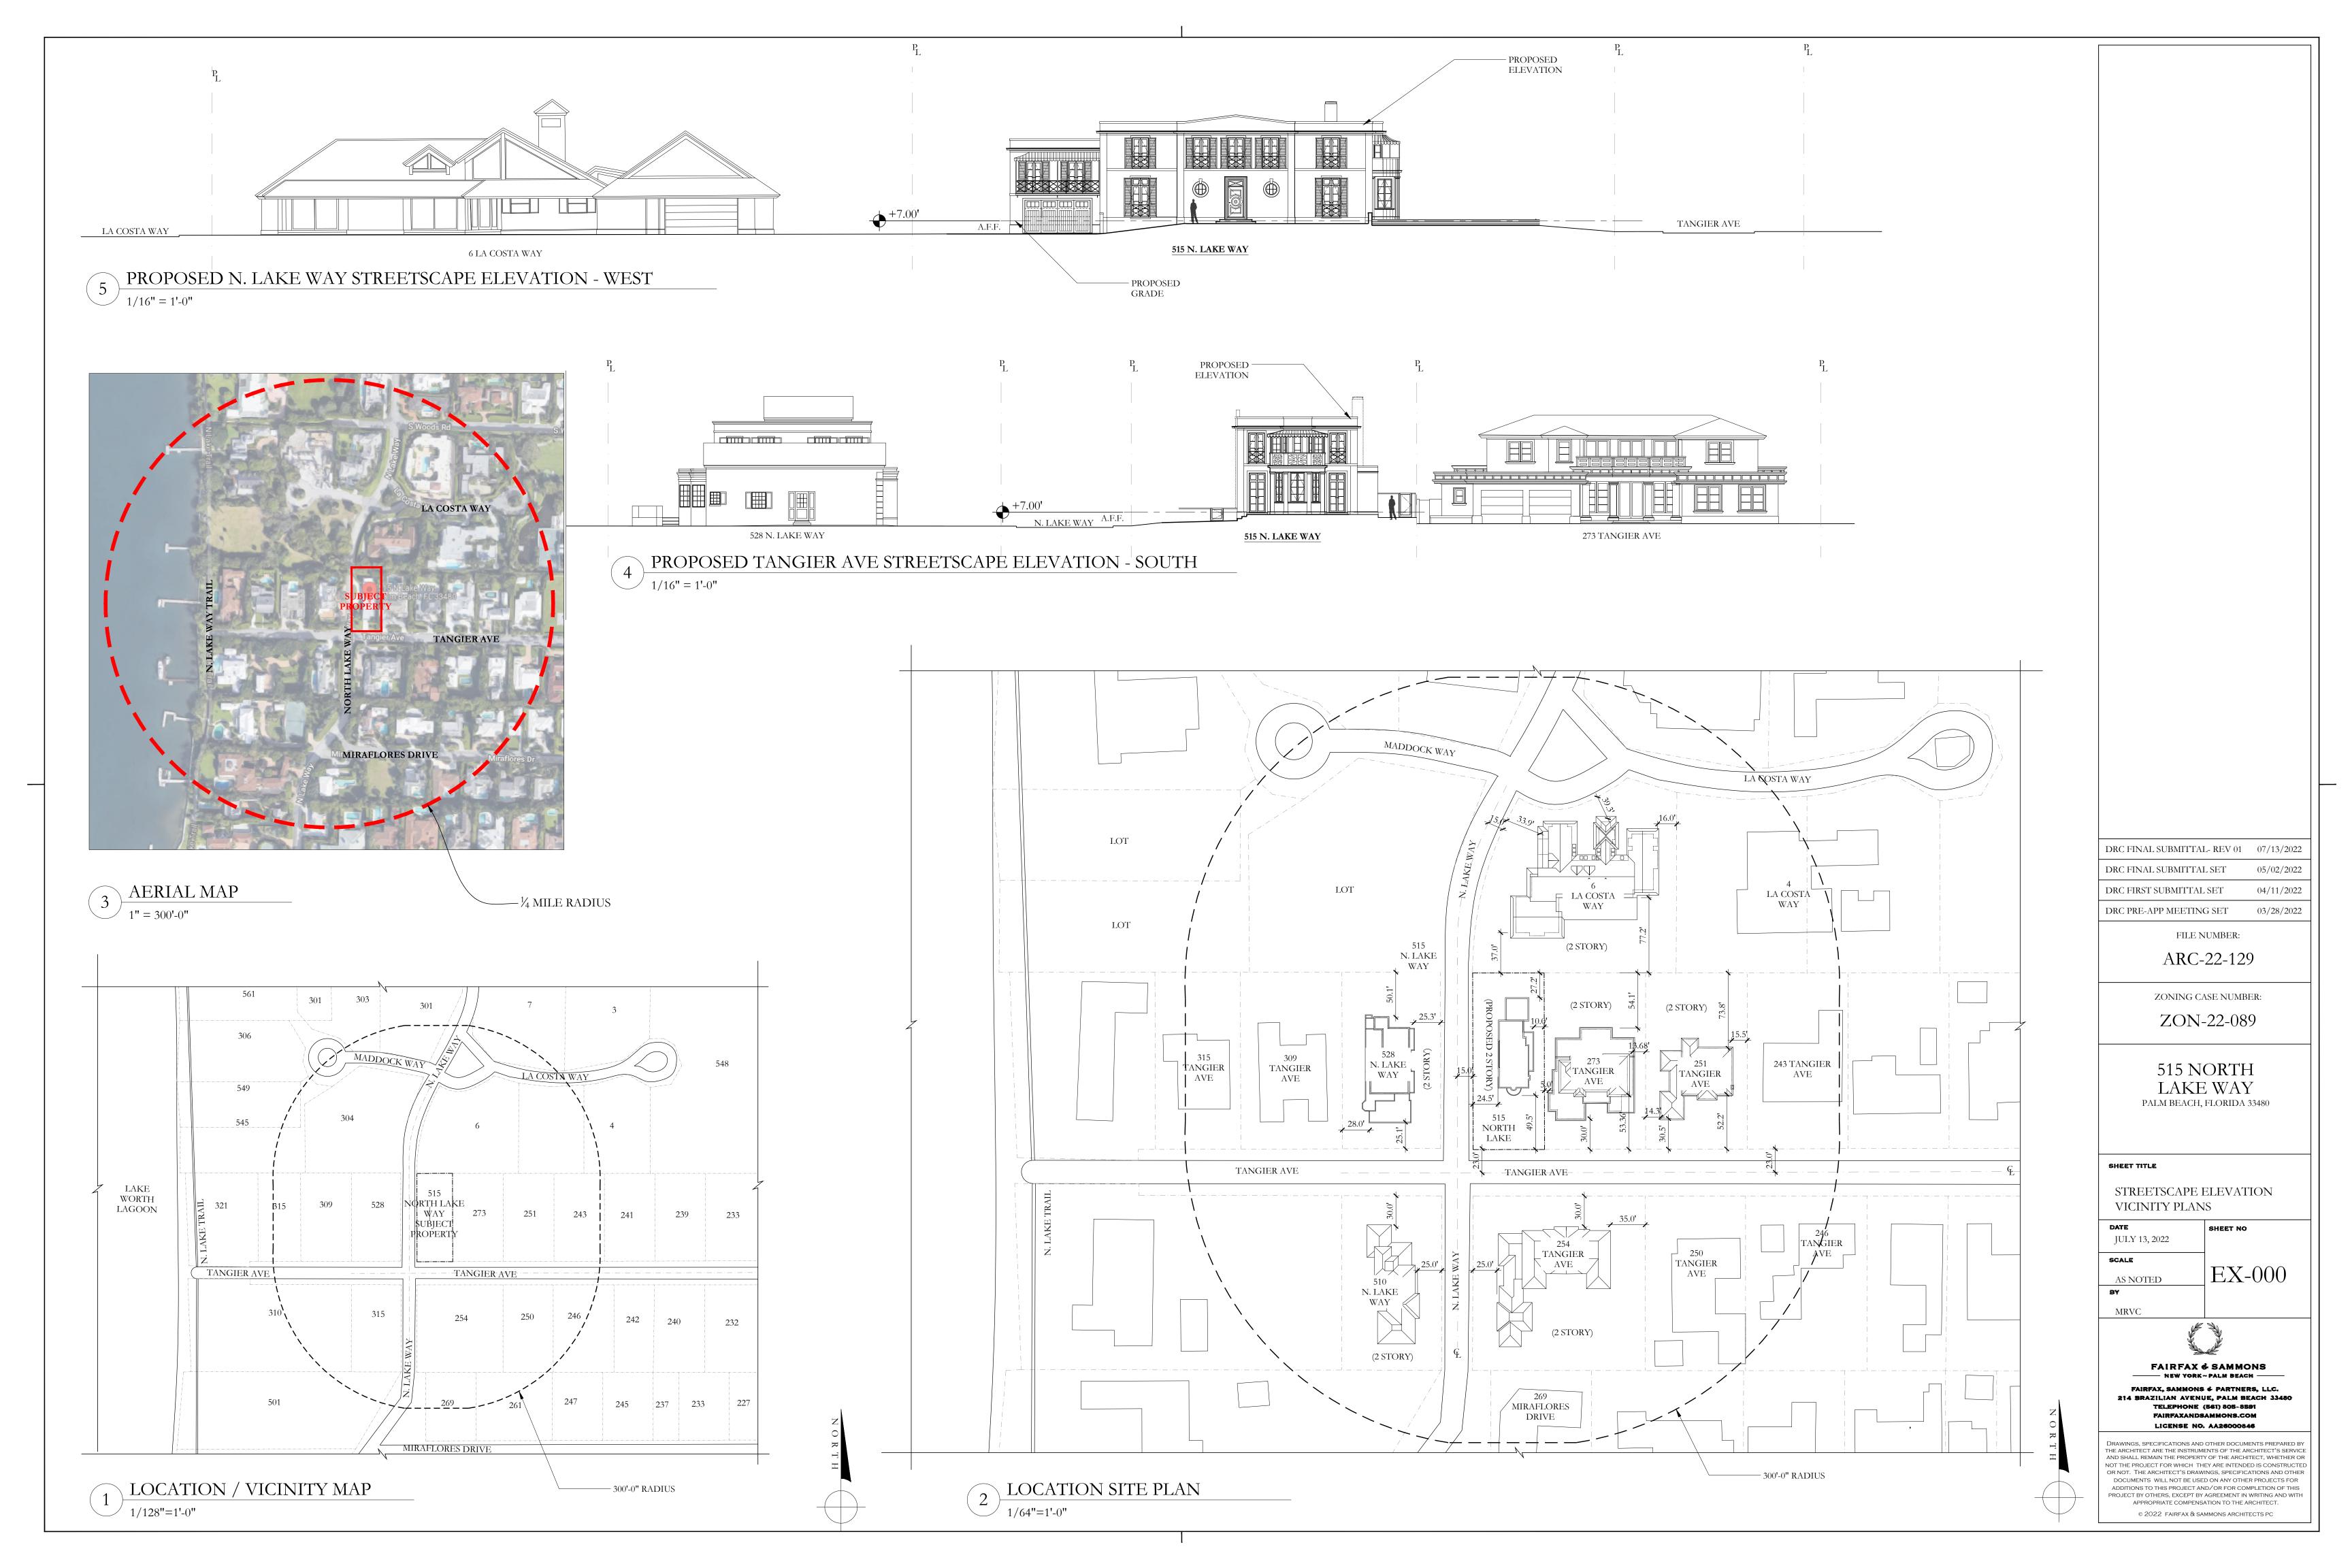

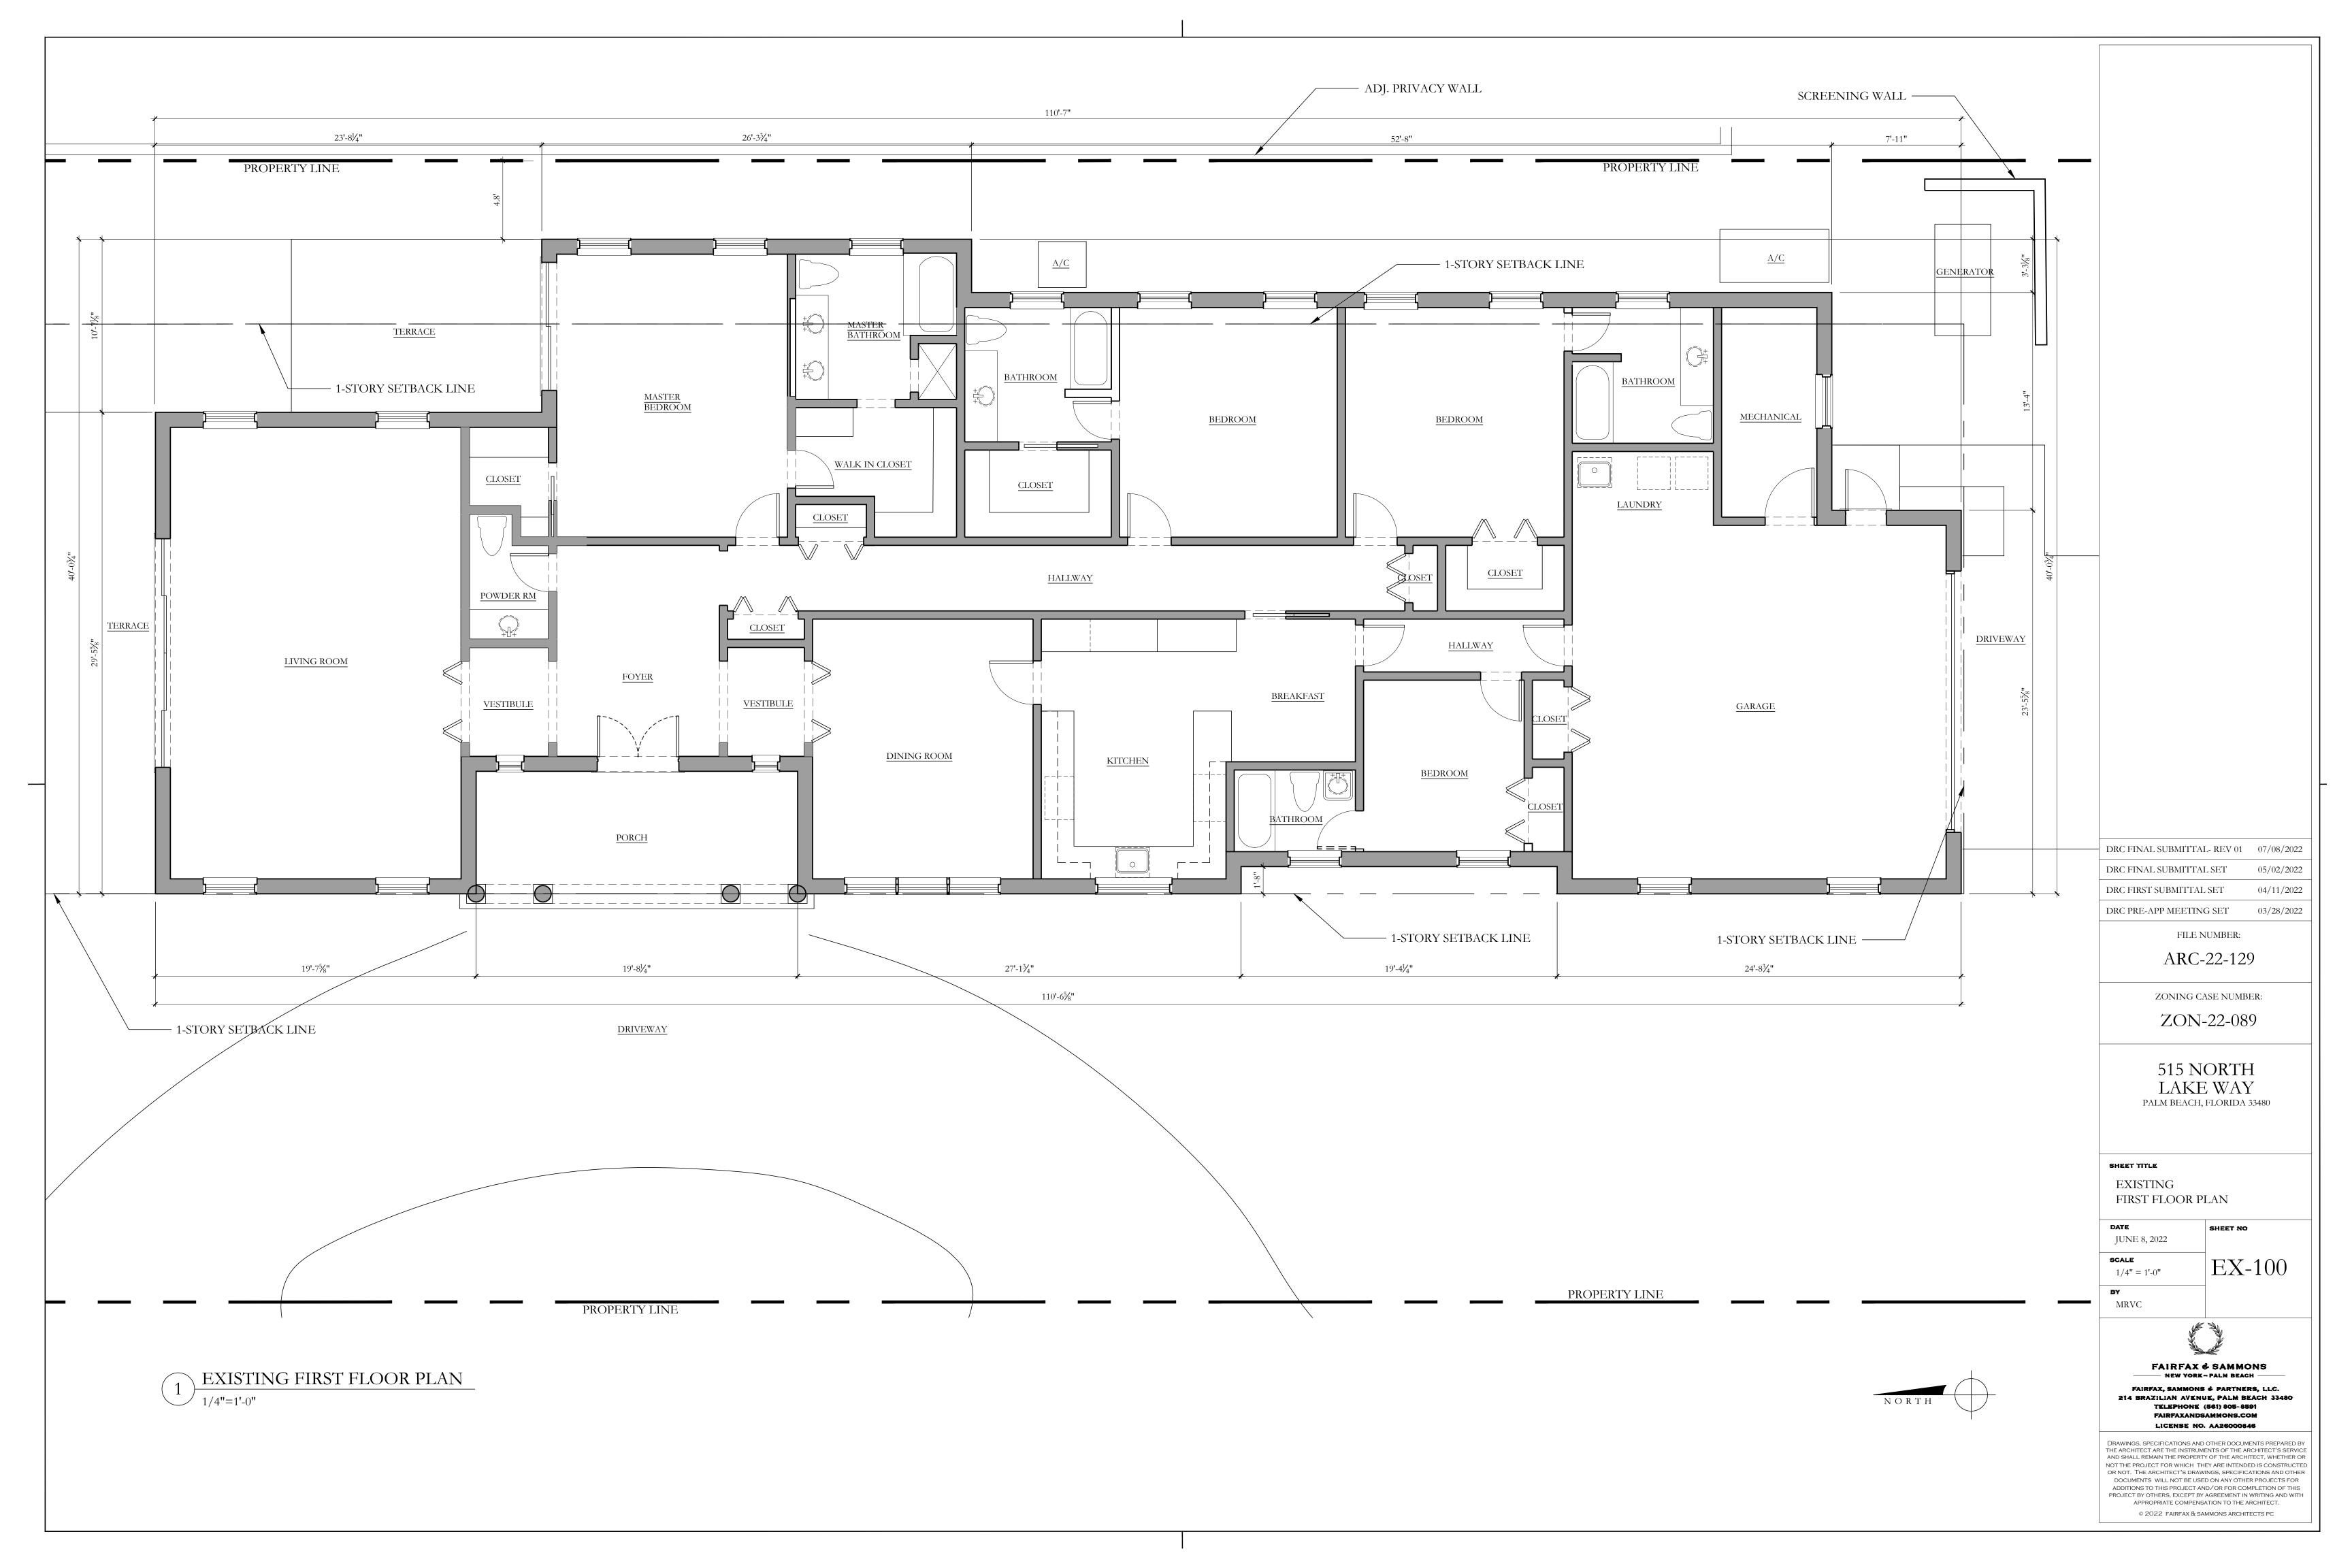

# DEMOLITION GENERAL NOTES:


- 1. PRIOR TO COMMENCEMENT OF THE WORK, THE CONTRACTOR SHALL BECOME FAMILIAR WITH THE SCOPE OF THE PROJECT AND VERIFY ALL EXISTING CONDITIONS AND DIMENSIONS AT THE JOB SITE.
- 2. PRIOR TO COMMENCEMENT OF THE WORK, THE CONTRACTOR AND/OR OWNER SHALL PERFORM SURVEY(S) AND, IF NECESSARY, REMEDIATION OF EXISTING MATERIALS PER APPLICABLE CODES AND REGULATIONS.
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- 8. THE CONTRACTOR SHALL PROVIDE PROTECTION AND CONDUCT DEMOLITION OPERATIONS IN SUCH A MANNER AS TO PREVENT INJURY OR DAMAGE TO PERSONS OR PROPERTY. HE SHALL MITIGATE THE AMOUNT OF DUST, DEBRIS, AND NOISE RESULTING FROM DEMOLITION


OPERATIONS AND SUBSEQUENT WORK, AND SHALL LEAVE THE JOBSITE DAILY IN A CLEAN AND ACCEPTABLE MANNER.

9. THE CONTRACTOR SHALL REMOVE ALL EXISTING CONSTRUCTION NOT REQUIRED FOR REUSE OR REINSTALLATION, INCLUDING BUT NOT LIMITED TO PARTITIONS, DOORS, HARDWARE, FLOORS, CEILINGS, ELECTRICAL, MECHANICAL, PLUMBING, GAS, AND RELATED EQUIPMENT.

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11. ALL BUILDING FOUNDATIONS (FOOTINGS AND STEM WALLS), MASONRY WALLS, FLOOR SLABS, AND HEADER/TIE BEAMS SHALL BE RETAINED IN PLACE, WITH THE ONLY EXCEPTIONS AT THOSE EXTERIOR WALLS THAT ARE INDICATED TO BE REMOVED IN THEIR ENTIRETY.



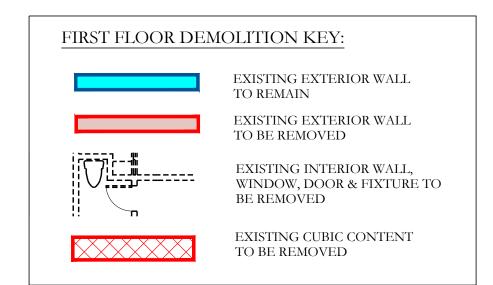

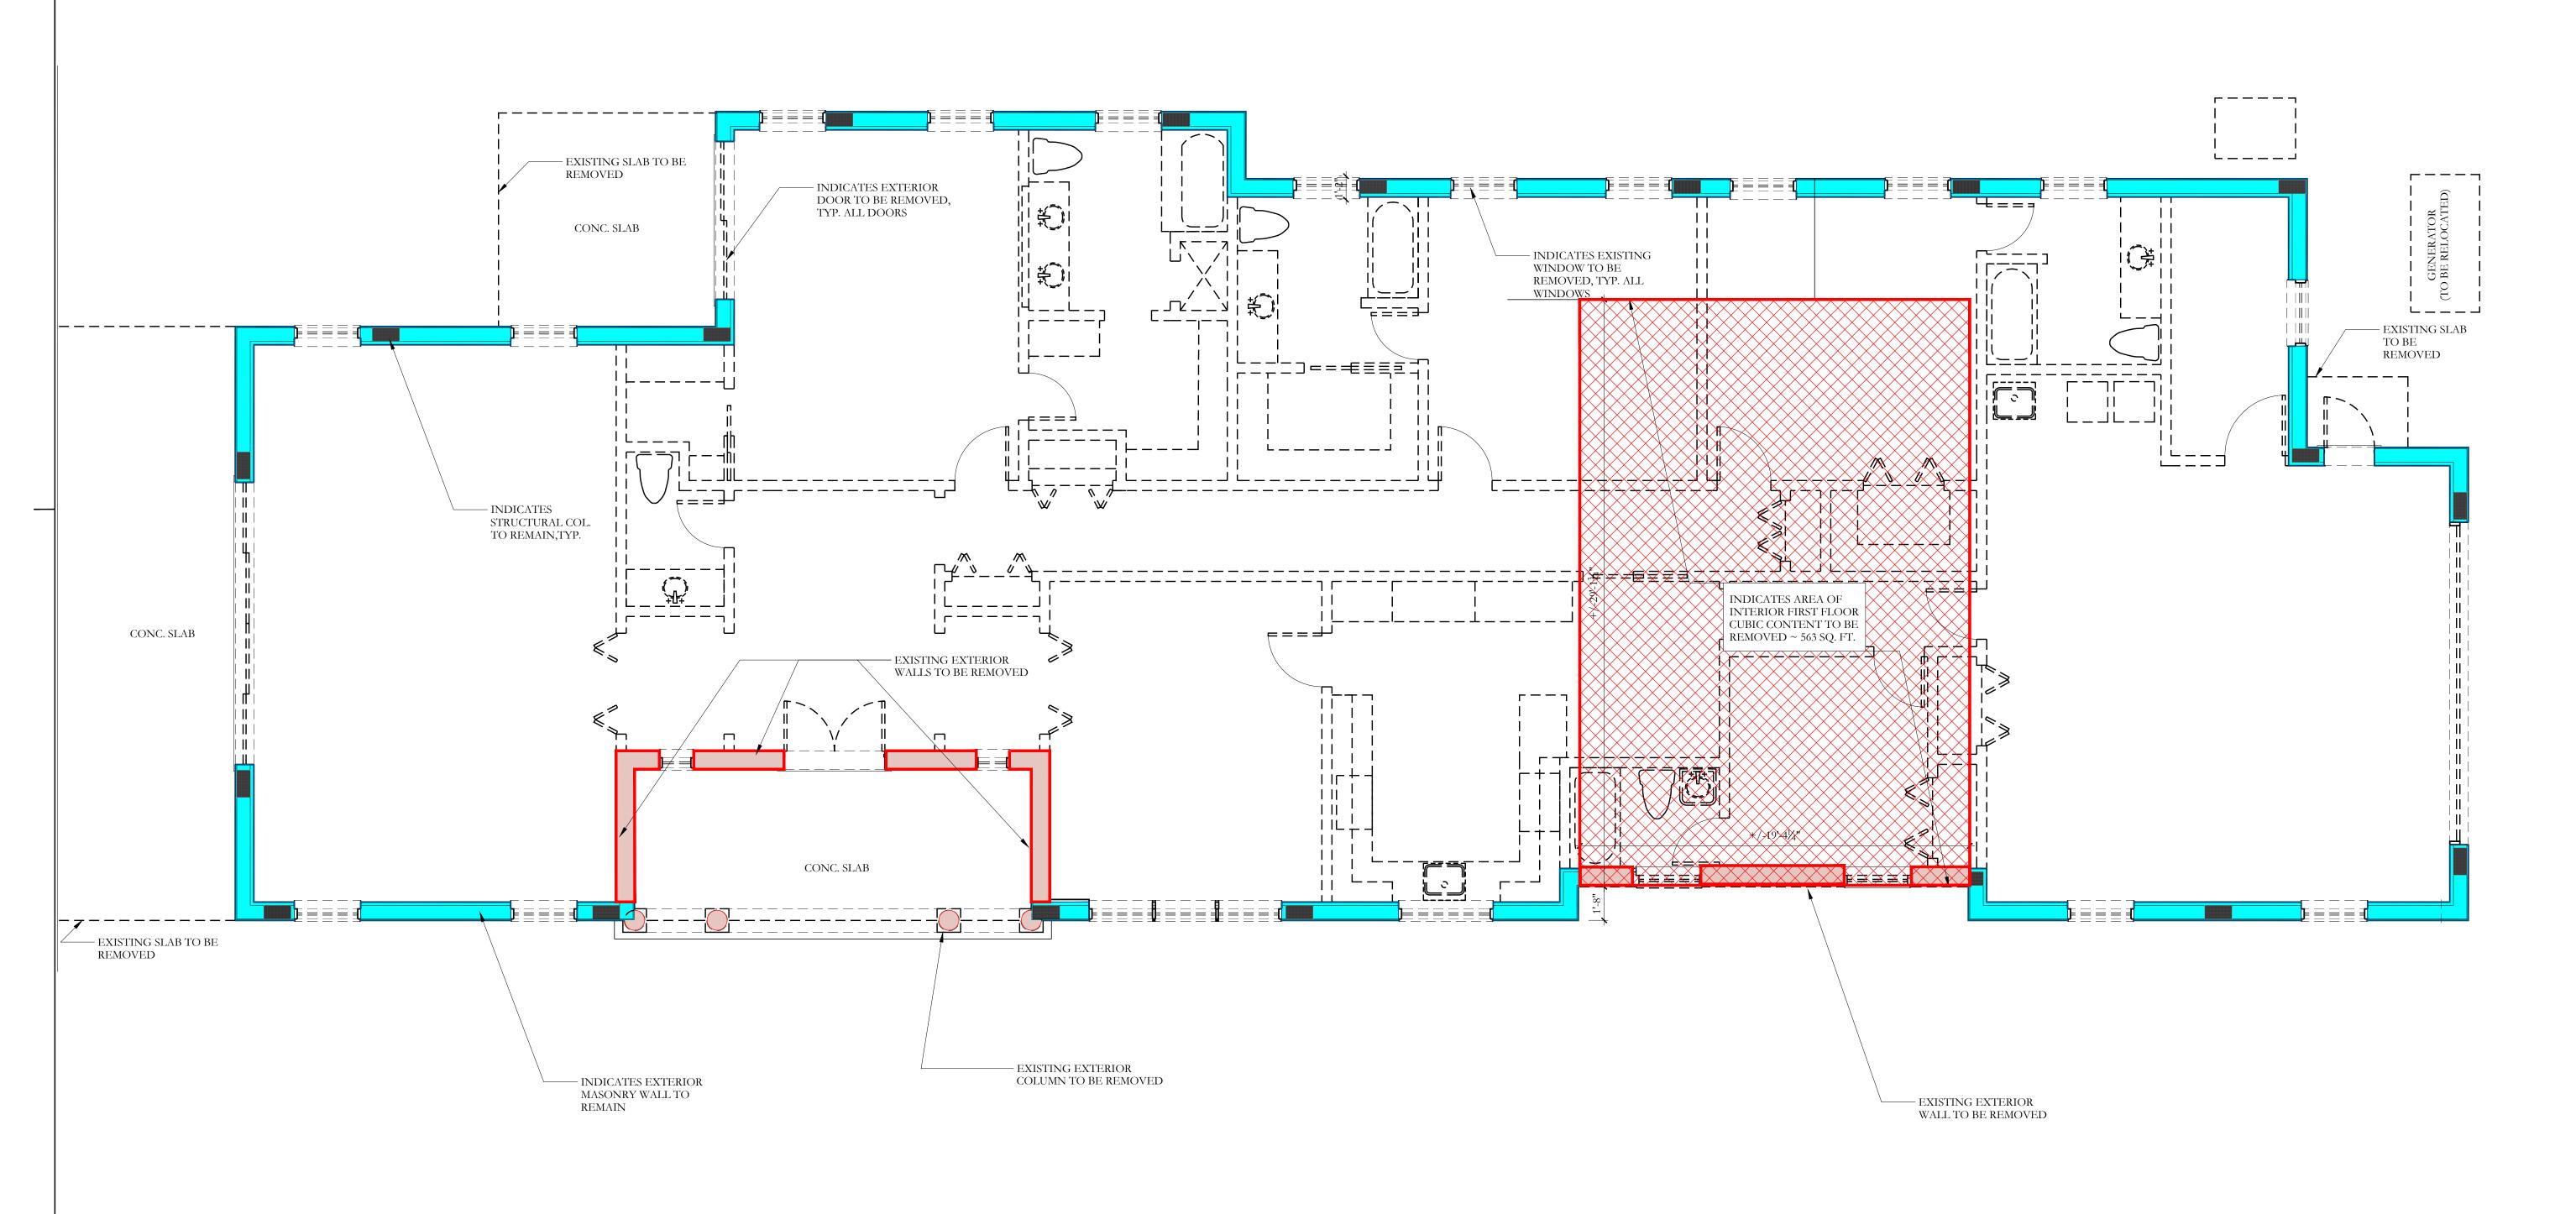DRC FINAL SUBMITTAL SET 05/02/2022

DRC FIRST SUBMITTAL SET 04/11/2022

DRC PRE-APP MEETING SET 03/28/2022

FILE NUMBER:
ARC-22-129

ZONING CASE NUMBER: ZON-22-089

515 NORTH LAKE WAY PALM BEACH, FLORIDA 33480

SHEET TITLE

FIRST FLOOR
MATERAILS REMOVAL PLAN

MAY 2, 2022

SCALE

1/4"=1'-0"

BY

MRVC

FAIRFAX & SAMMONS

NEW YORK-PALM BEACH

FAIRFAX, SAMMONS & PARTNERS, LLC.

214 BRAZILIAN AVENUE, PALM BEACH 3348

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TELEPHONE (561) 805-8591

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PREVIOUSLY PRESENTED

FIRST FLOOR MATERIALS REMOVAL PLAN

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FIRST FLOOR MATERIALS REMOVAL PLAN


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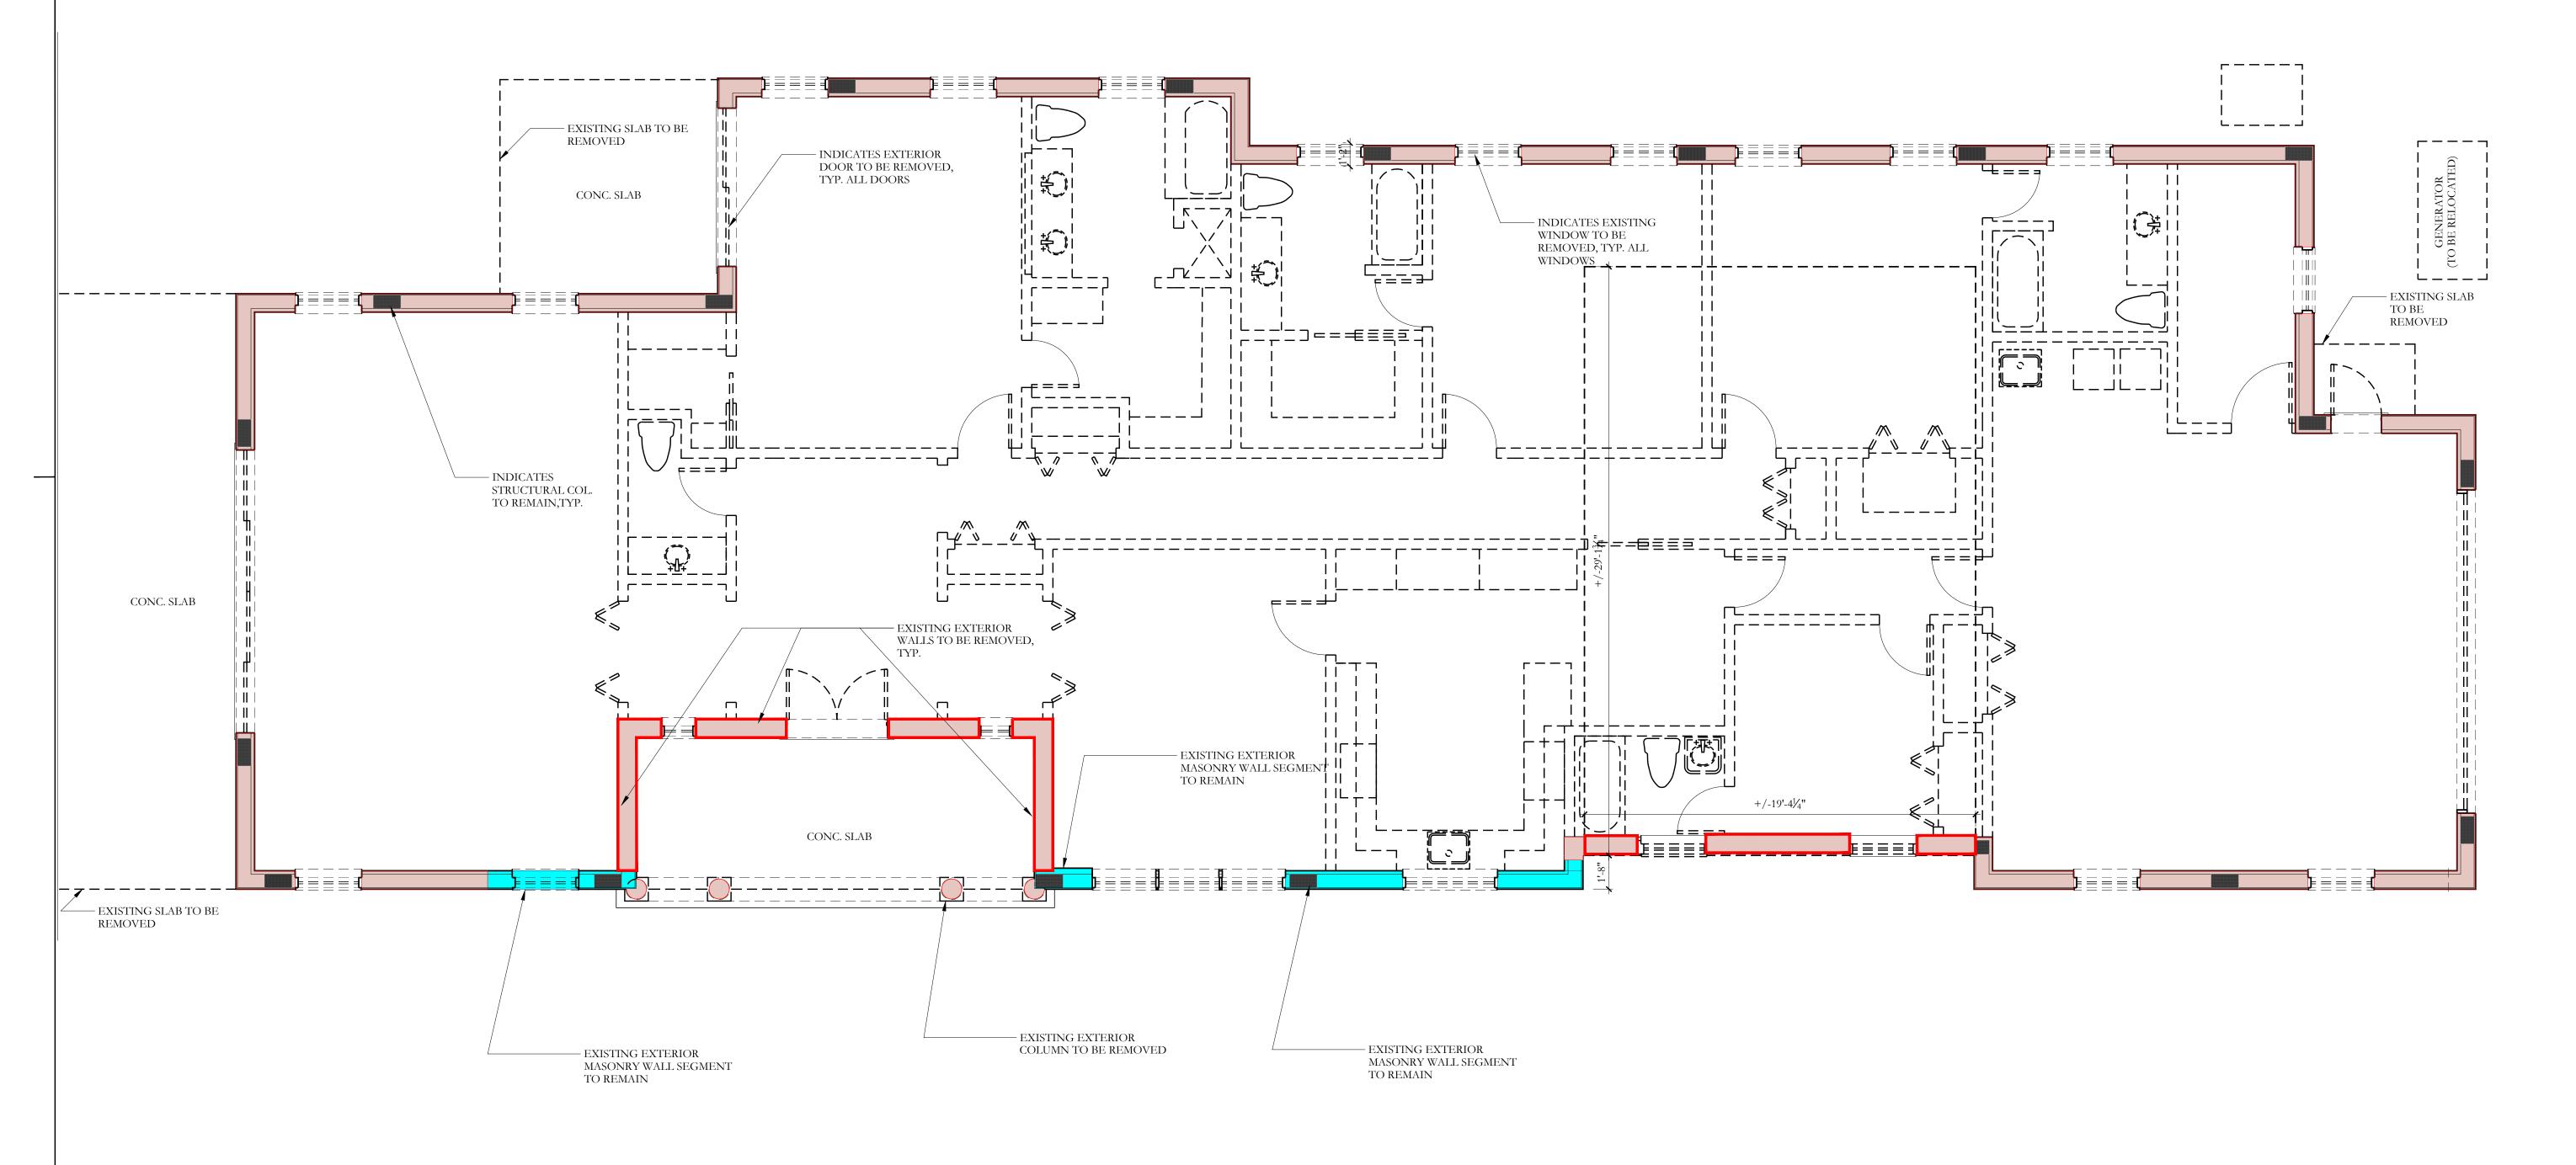
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DRC FINAL SUBMITTAL- REV 01 07/13/2022

DRC FINAL SUBMITTAL SET 05/02/2022

DRC FIRST SUBMITTAL SET 04/11/2022

DRC PRE-APP MEETING SET 03/28/2022

FILE NUMBER:

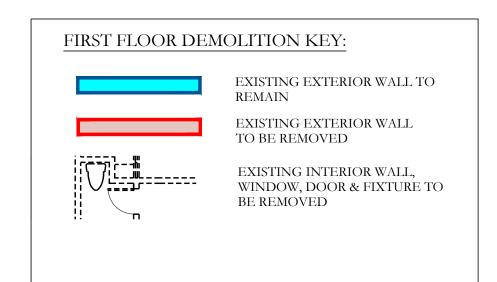ARC-22-129

ZONING CASE NUMBER:

ZON-22-089

515 NORTH LAKE WAY PALM BEACH, FLORIDA 33480

SHEET TITLE

FIRST FLOOR
MATERAILS REMOVAL PLAN

JULY 13, 2022

SCALE

1/4"=1'-0"

BY

MRVC

FAIRFAX & SAMMONS

NEW YORK-PALM BEACH

FAIRFAX, SAMMONS & PARTNERS, LLC.

FAIRFAX, SAMMONS & PARTNERS, LLC.
214 BRAZILIAN AVENUE, PALM BEACH 33486
TELEPHONE (561) 805-8591
FAIRFAXANDSAMMONS.COM
LICENSE NO. AA26000846

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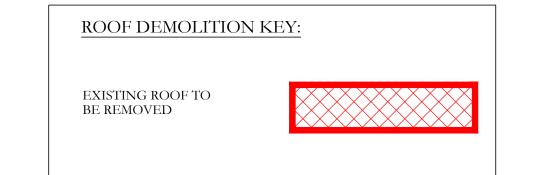
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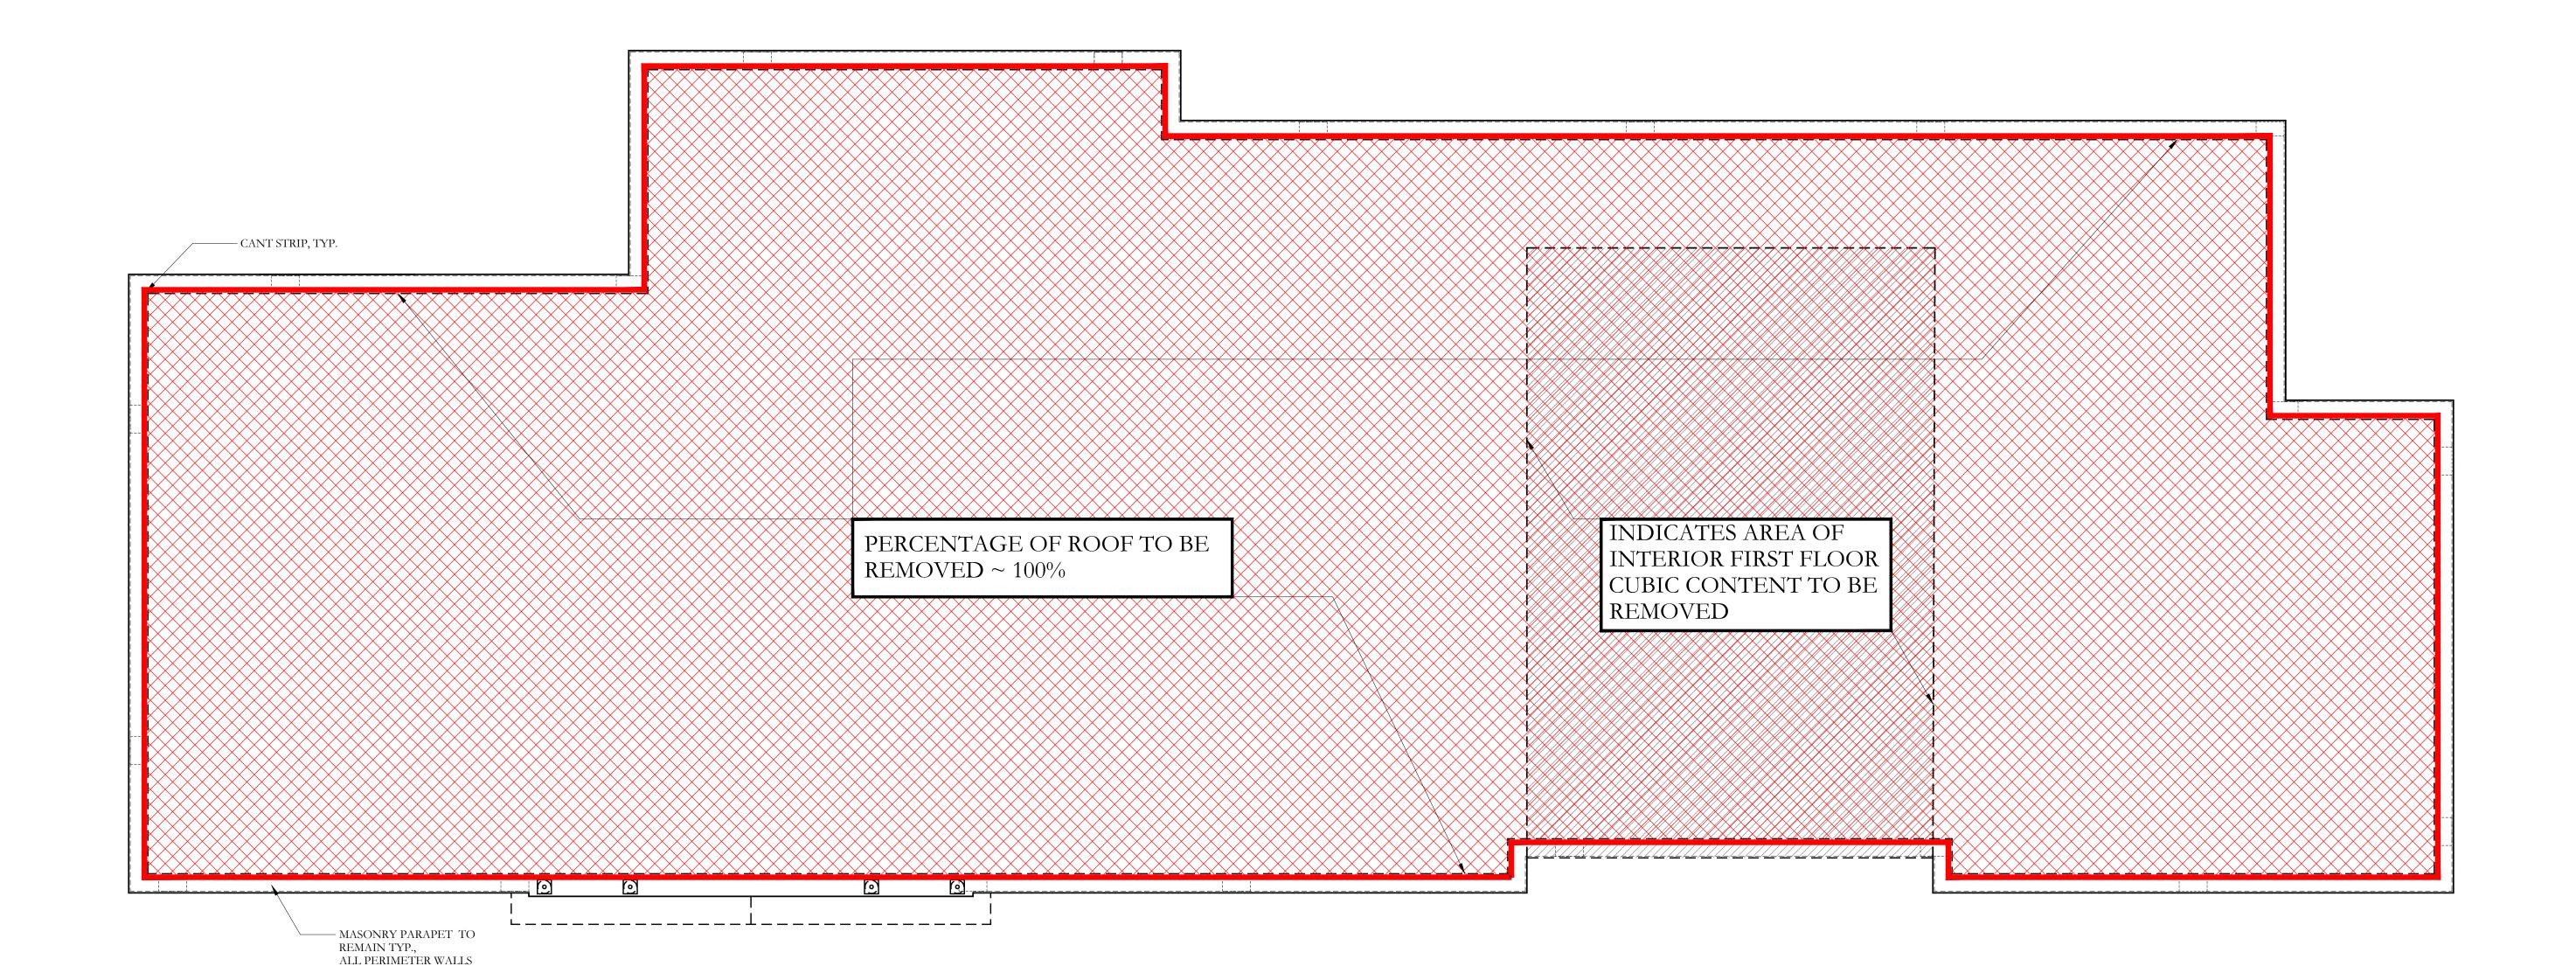
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ROOF MATERIALS REMOVAL PLAN

1/4"=1'-0"

NORTH

DRC FINAL SUBMITTAL SET 05/02/2022

DRC FIRST SUBMITTAL SET 04/11/2022

DRC PRE-APP MEETING SET

FILE NUMBER:
ARC-22-129

ZONING CASE NUMBER:

03/28/2022

ZON-22-089

515 NORTH LAKE WAY PALM BEACH, FLORIDA 33480

SHEET TITLE

ROOF
MATERIALS REMOVAL PLAN

MAY 2, 2022

SCALE

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BY

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