

INDEX OF DRAWINGS

ARCHITECTURAL

AO- PLOT PLAN, INDEX.

A1- EXISTING NEIGHBORING PROPERTIES PLAN.

A2- PROPOSED NEIGHBORING PROPERTIES PLAN.

A3- EXISTING AND PROPOSED STREETSCAPE. A4.1- EXISTING AND PROPOSED SITE PLANS.

A4.2- EXISTING AND PROPOSED FLOOR PLANS.

A5- EROSION CONTROL AND SITE UTILIZATION PLAN.

A6- EXISTING MAIN HOUSE FIRST FLOOR PLAN.

A7- MATERIALS REMOVAL PLAN.

A8- PROPOSED MAIN HOUSE FIRST FLOOR PLAN.

A9- EXISTING MAIN HOUSE SECOND FLOOR PLAN.

A10- PROPOSED MAIN HOUSE SECOND FLOOR PLAN.

A11.1 - ORIGINAL, EXISTING, PROPOSED NORTH ELEVATIONS.

A11.2- EXISTING, PROPOSED NORTH ELEVATIONS.

A11.3- NORTH ELEVATION COLOR RENDERING.

A12.1 - ORIGINAL, EXISTING, PROPOSED SOUTH ELEVATIONS.

A12.2- EXISTING, PROPOSED SOUTH ELEVATIONS.

A12.3- SOUTH ELEVATION COLOR RENDERING.

A13.1 - ORIGINAL, EXISTING, PROPOSED EAST ELEVATIONS.

A13.2- EXISTING, PROPOSED EAST ELEVATIONS.

A13.3- EXISTING AND PROPOSED EAST ELEVATIONS (1/8")

A14.1- ORIGINAL, EXISTING AND PROPOSED WEST ELEVATIONS.

A14.2- EXISTING, PROPOSED WEST ELEVATIONS.

A14.3- EXISTING AND PROPOSED WEST ELEVATIONS (1/8")

A15- EXIST, GARAGE/ G. HOUSE 1st AND 2nd. FLOOR PLANS AND MATERIALS REMOVAL.

A16- PROPOSED GARAGE/GUEST HOUSE ADDITION FLOOR PLAN.

A17- PROPOSED GARAGE/GUEST HOUSE ADDITION ROOF PLANS.

A18.1 - ORIGINAL, EXISTING AND PROPOSED GARAGE/GUEST HOUSE ADDITION WEST ELEVATIONS.

A18.2 - EXISTING AND PROPOSED GARAGE/GUEST HOUSE ADDITION WEST ELEVATIONS.

A18.3 - WEST ELEVATION COLOR RENDERING.

A19.1 - ORIGINAL, EXISTING AND PROPOSED GARAGE/GUEST HOUSE ADDITION EAST ELEVATIONS

A19.2- EXISTING AND PROPOSED GARAGE/GUEST HOUSE ADDITION EAST ELEVATIONS

A20.1 - ORIGINAL, EXISTING AND PROPOSED GARAGE/GUEST HOUSE ADDITION SOUTH AND NORTH ELEVATIONS

A20.2- EXISTING AND PROPOSED GARAGE/GUEST HOUSE ADDITION SOUTH AND NORTH ELEVATIONS

A21- CUBIC CONTENT CALCULATIONS


A22- DETAILS.

A23- LOGISTIC PLAN AND CONSTRUCTION TIMELINE

SURVEY

BOUNDARY, TOPOGRAPHIC AND EASEMENT SURVEY

		Line 0	ZONING LEGEND			
		1	PROPERTY ADDRESS	324 BARTON AVENUE, PALM BEACH, FLORIDA		
		2	ZONING DISTRICT	R-B		
		3	STRUCTURE TYPE	WALL: CBS - ROOF: FLAT CONCRET TILE SLOPED ROOF		
		4		REQUIRED/ALLOWED	EXISTING	PROPOSED
		5	LOT SIZE (SQ. FT.)	10,000 MIN.	18,709	18,709
		6	LOT DEPTH	100 MIN.	187.09'	187.09'
		7	LOT WIDTH	100 MIN.	100.0'	100.0'
		8	LOT COVERAGE	5, 612 MAX. (30%)	4,288 (22.92%)	5,174 (27.7%)
		9	ENCLOSED SQUARE FOOTAGE		7,165	8,050
		10	CUBIC CONTENT RADIO	3.91 MAX.	3.19	3.46
	MAIN HOUSE	11A	FRONT YARD SETBACK (1 STORY)	25.00 MIN.	36.3'	36.3'
		11B	FRONT YARD SETBACK (2 STORY)	30.00 MIN.	41.3'	41.3'
		12A	SIDE YARD SETBACK (1 STORY)	12.50 MIN.	N/A (W) 7.5' (E)	N/A (W) 7.5' (E)
		13A	SIDE YARD SETBACK (2 STORY)	15.00 MIN.	14.8' (W) 14.7' (E)	14.8 (W) 14.7' (E)
		14A	REAR YARD SETBACK (1 STORY)	10.00 MIN.	98.84	108.29'
		14B	REAR YARD SETBACK (2 STORY)	15.00 MIN.	89.8'	89.8'
	GUEST HOUSE	12B	SIDE YARD SETBACK (1 STORY)	12.50 MIN.	73.6' (W) 10.12 (E)	60.3' (W) 10.12 (E)
		13B	SIDE YARD SETBACK (2 STORY)	15.00 MIN.	73.6' (W) 4.9' (E)	73.6' (W) 4.9' (E)
		14C	REAR YARD SETBACK (1 STORY)	10.00 MIN.	N/A	10.64'
		14D	REAR YARD SETBACK (2 STORY)	15.00 MIN.	9.8'	9.8'
L		15	ANGLE OF VISION	100 DEGREES	82° –21°	82* -21'
		16	BUILDING HEIGHT	22.0'	20.33'	20.33'
		17	OVERALL BUILDING HEIGHT	30.0'	26.83'	26.83'
		18	CROWN OF ROAD (COR) (NAVD)	2.79'	2.79'	2.79'
		19	MAX. AMOUNT OF FILL ADDED TO SITE			0.0'
MAIN	N HOUSE	20A	FINISH FLOOR ELEVATION (FFE) (NAVD)	+7.00' NAVD	+5.34 NAVD	+5.34 NAVD
GUES	T HOUSE	20B	FINISH FLOOR ELEVATION (FFE) (NAVD)	+7.00' NAVD	+3.39 NAVD	+3.39 NAVD
		21	ZERO DATUM FOR PT. OF MEAS. (NAVD)	+7.00' NAVD	+7.00' NAVD	+7.00' NAVD
		22	FEMA FLOOD ZONE DESIGNATION	AE	AE	AE
		23	BASE FLOOD ELEVATION (BFE) (NAVD)	+7.00' NAVD	+7.00' NAVD	+7.00' NAVD
		24	LANDSCAPE OPEN SPACE (LOS)	8,419 MIN. (45%)	10,590 (56.6%)	9,704 (51.8%)
		25	PERIMETER (LOS)	2,870.8 MIN. (50%)	3,085.3 (53.73%)	3,053.8 (53.19%)
		26	FRONT YARD (LOS)	1,200.0 MIN. (45%)	995 (33.2%)	995 (33.2%)
		27	NATIVE PLANT SPECIES %			

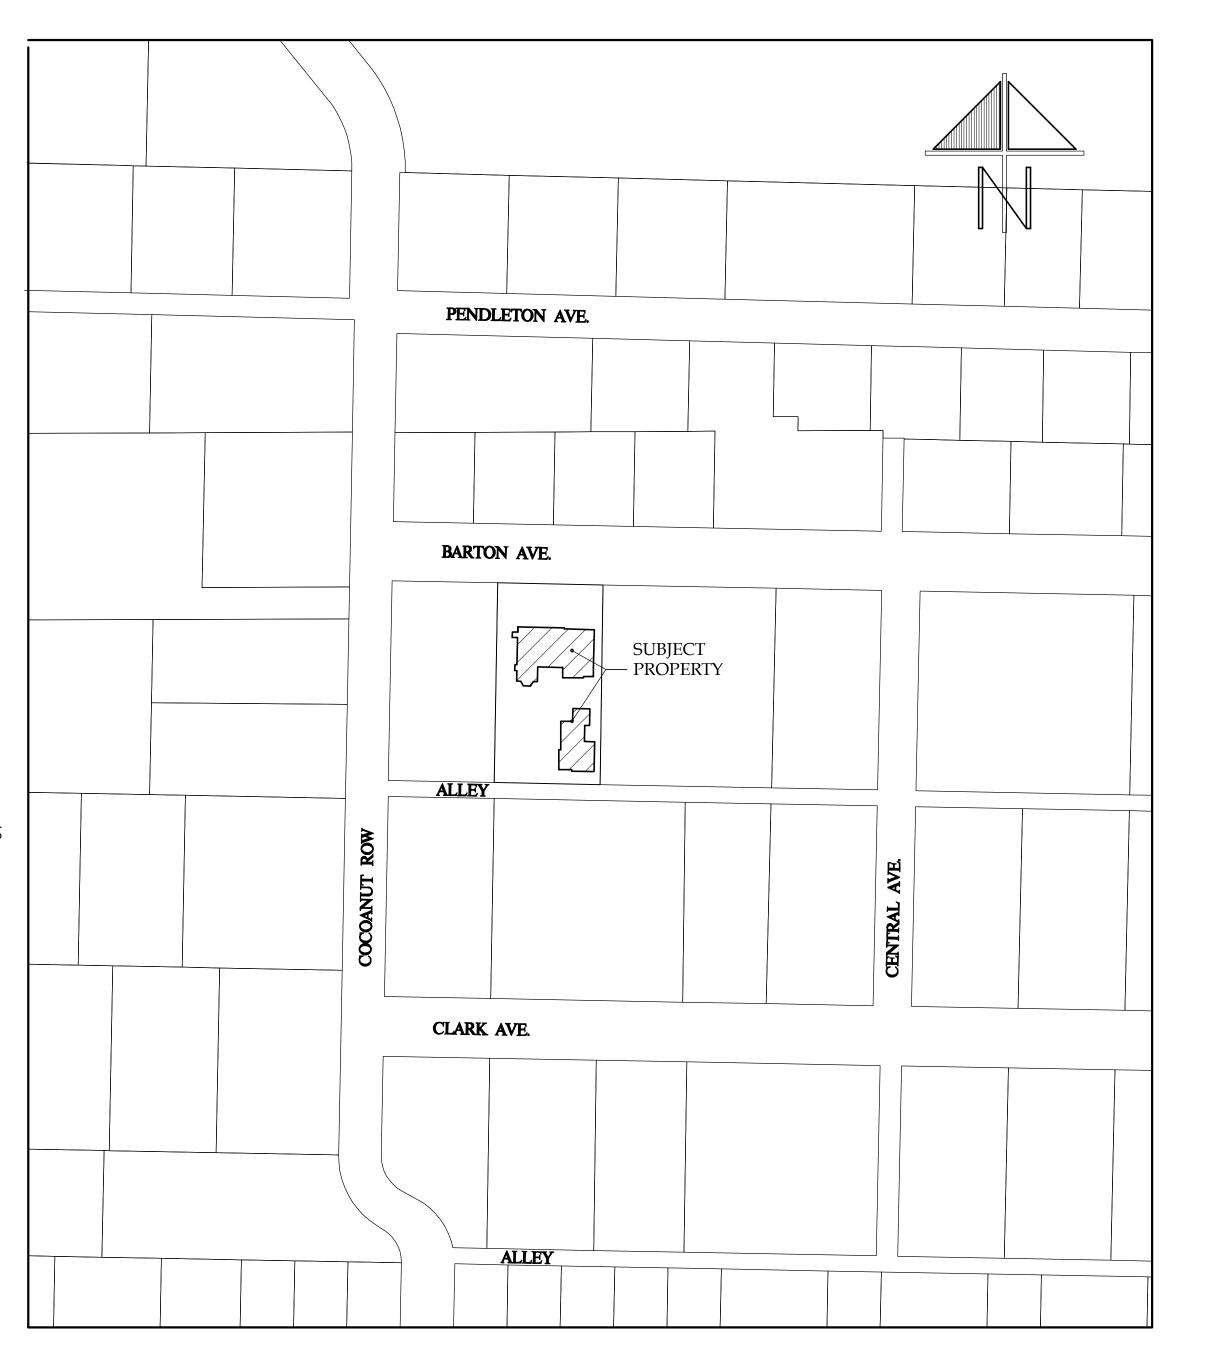



ARCHITECT:

SKA Architect + Planner Attn: Jacqueline Albarran 324 Royal Palm Way Suite 227 Palm Beach, Fl 33480 (561) 655 - 7676

CONSULTING SURVEYORS:


Wallace Surveying 5553 Village Blvd. West Palm Beach, FL 33407 (561) 640 - 4551

SCOPE OF WORK

-One story addition to rear of Main House in areas that are not original. Roof and new impact wood windows and doors to match existing.

-One story addition to separate Garage/Guest House at rear of property. Roof and new impact wood windows and doors to match existing.

-Cracked cast stone driveway pavers to be replaced.

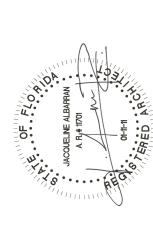

 ∞

2

0

DATE: -054

D G

HEARING ZON-22

-22


28

SUBMITTAL: 03 HSB-


FINAL


03-28-22



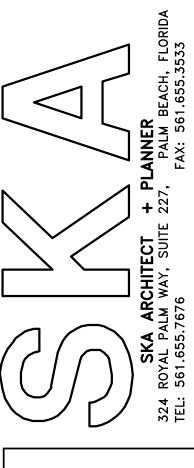


LER RESIDENCE Barton Avenu

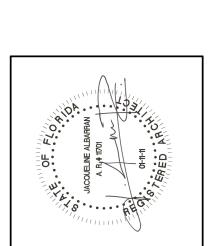

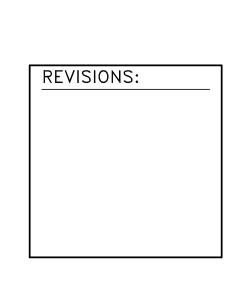


SHEET	NUMBER:			
A1				
DATE:				
	03-28-22			
JOB #				
	0454			



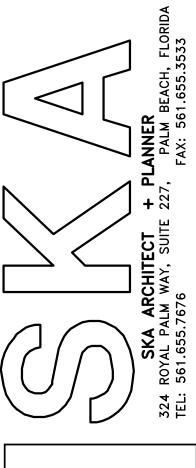

MILLER RESIDENCE
24 BARTON AVENU

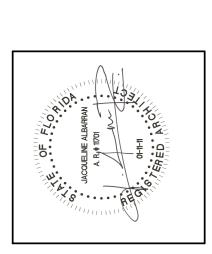

REVISIONS:

SHEET NUMBER:

A2

DATE:

03-28-22

JOB #

0454

HSB

SHEET NUMBER:

DATE: 03-28-22 JOB #

0454

SUBJECT PROPERTY









SUBJECT PROPERTY





NEIGHBORING PROPERTIES ON THE SIDE





NEIGHBORING PROPERTIES ACROSS THE STREET












SUBJECT PROPERTY AT FRONT

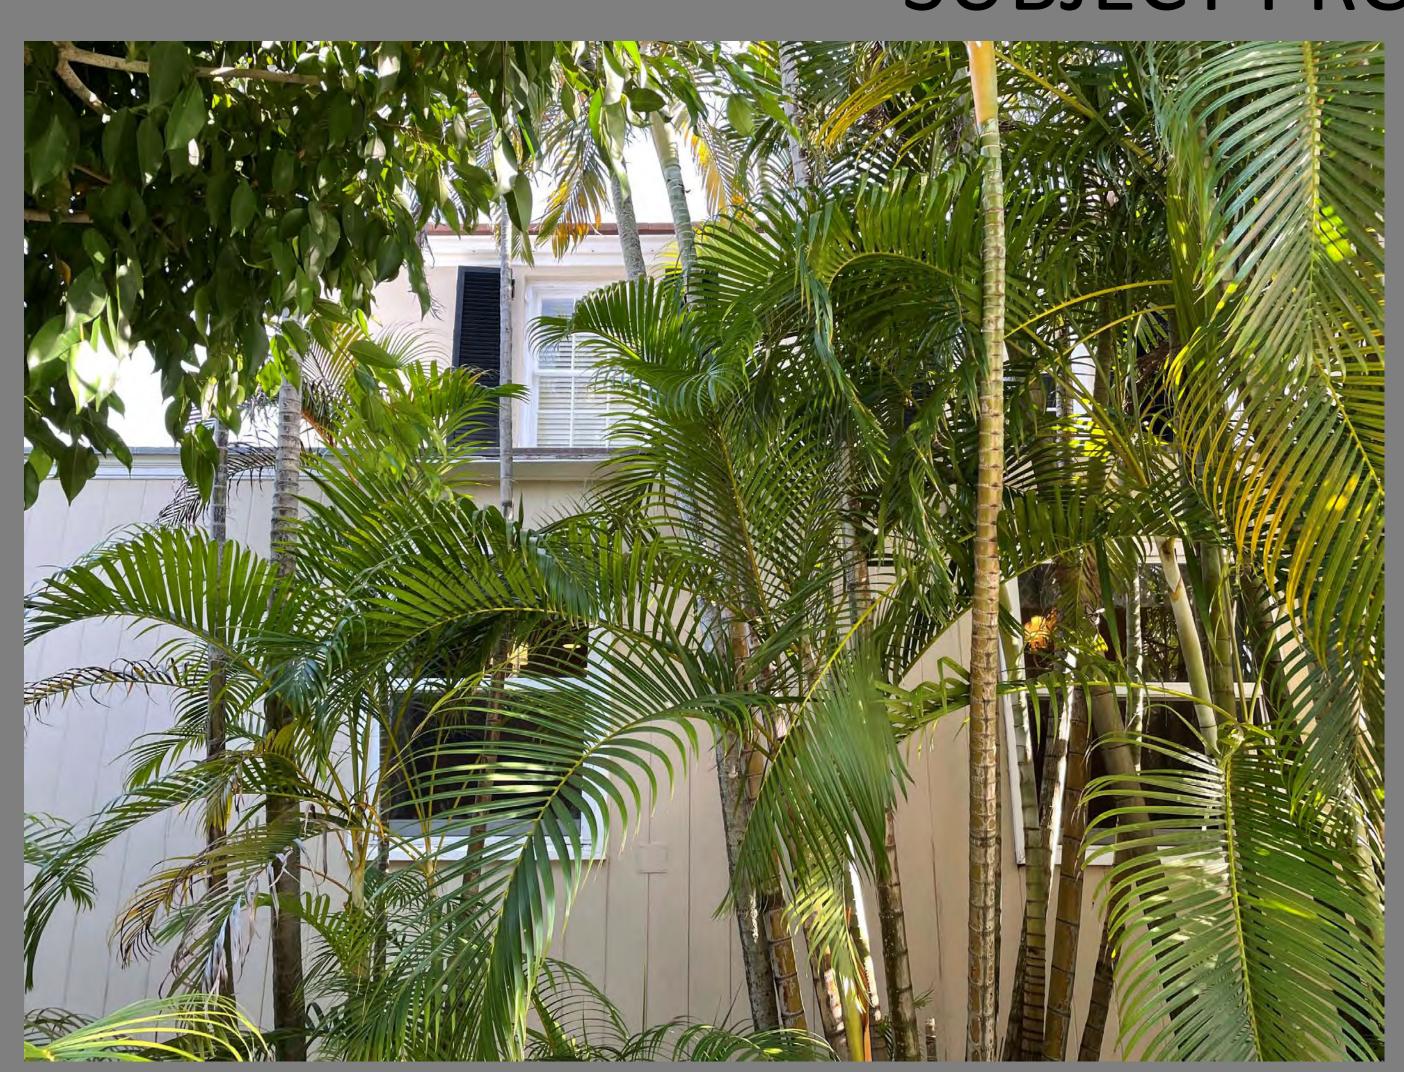

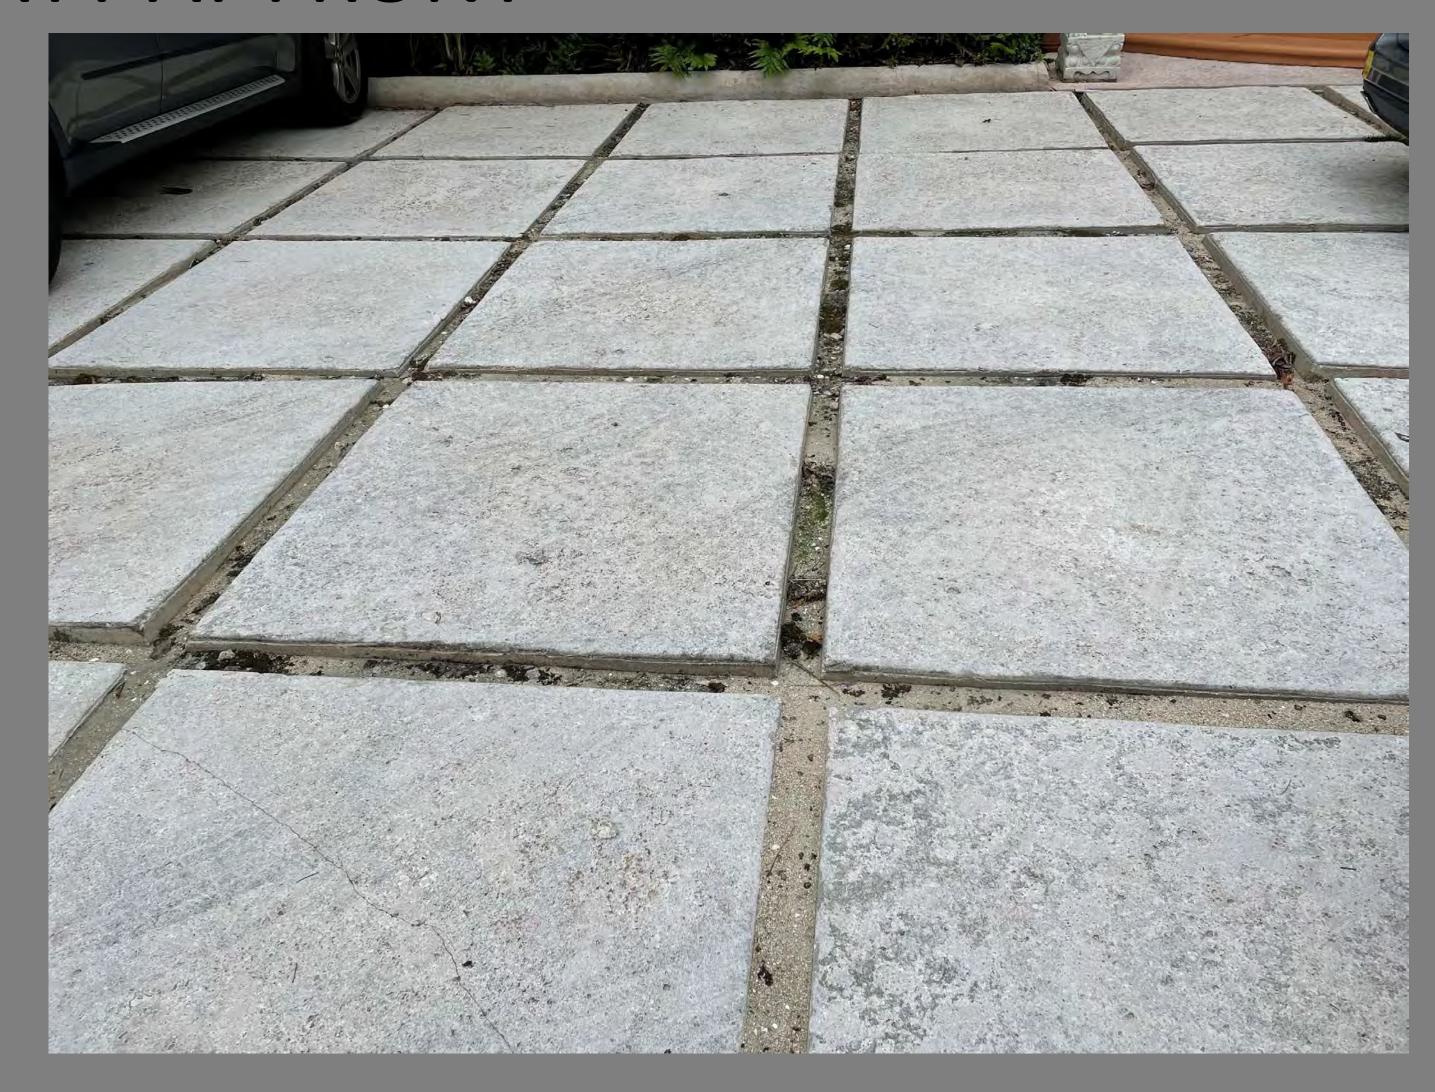


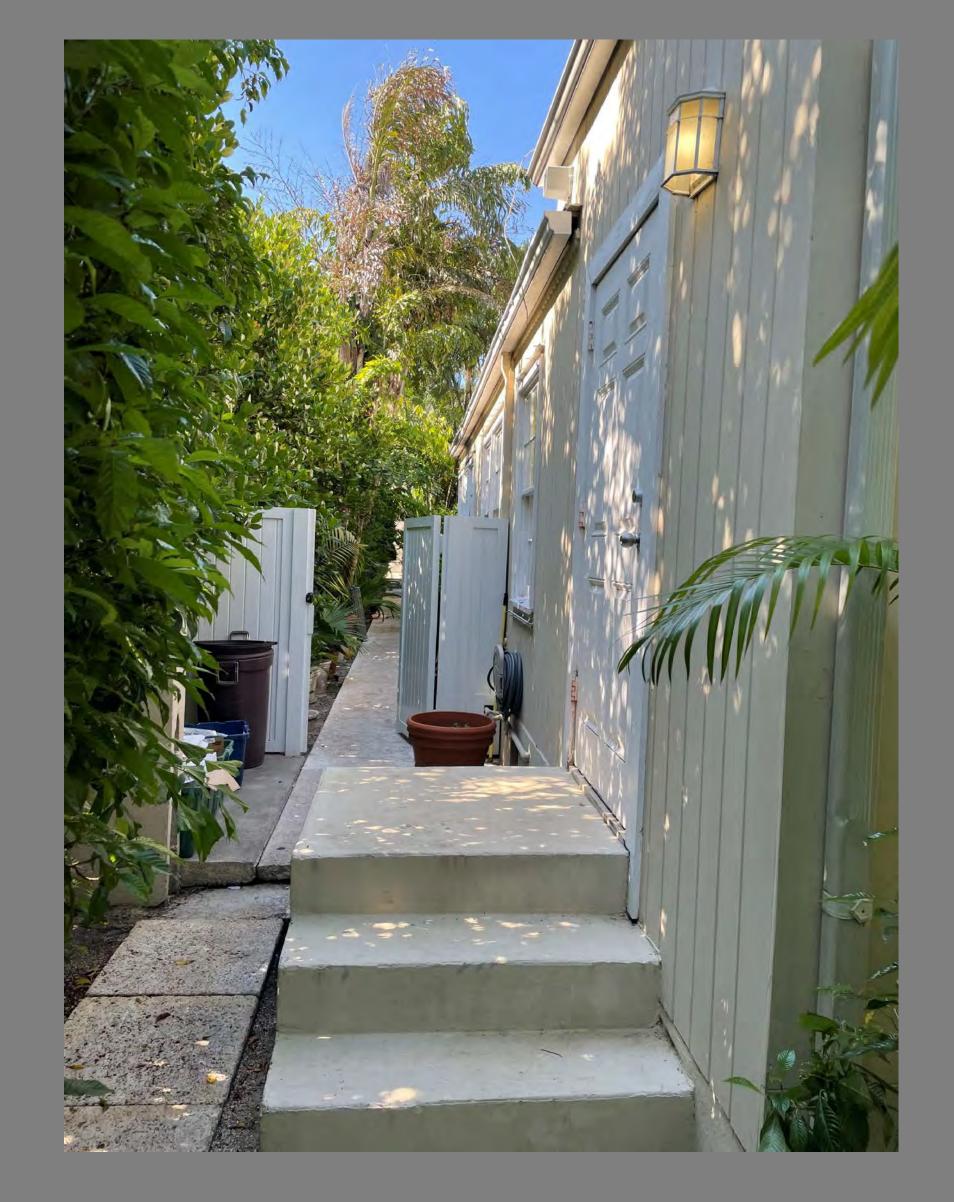

SUBJECT PROPERTY AT SIDE





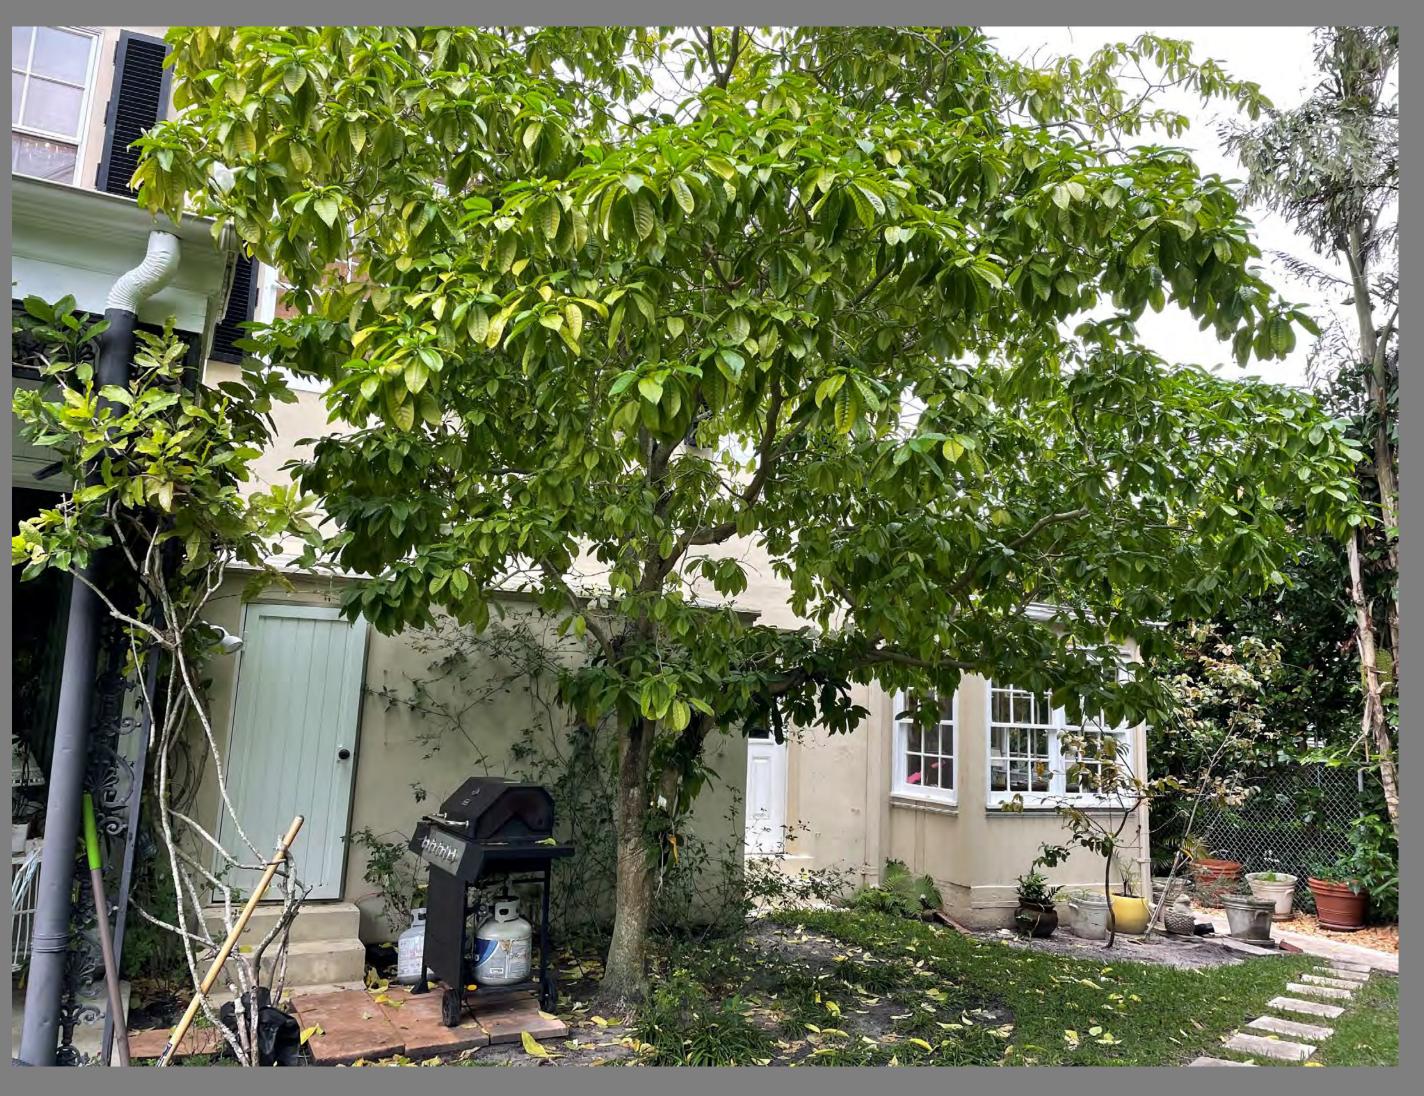



MAIN HOUSE



SUBJECT PROPERTY
AT REAR GARDEN



GARAGE/GUEST HOUSE



LOGGIA








SUBJECT PROPERTY GARAGE/GUEST HOUSE AT REAR ALLEY





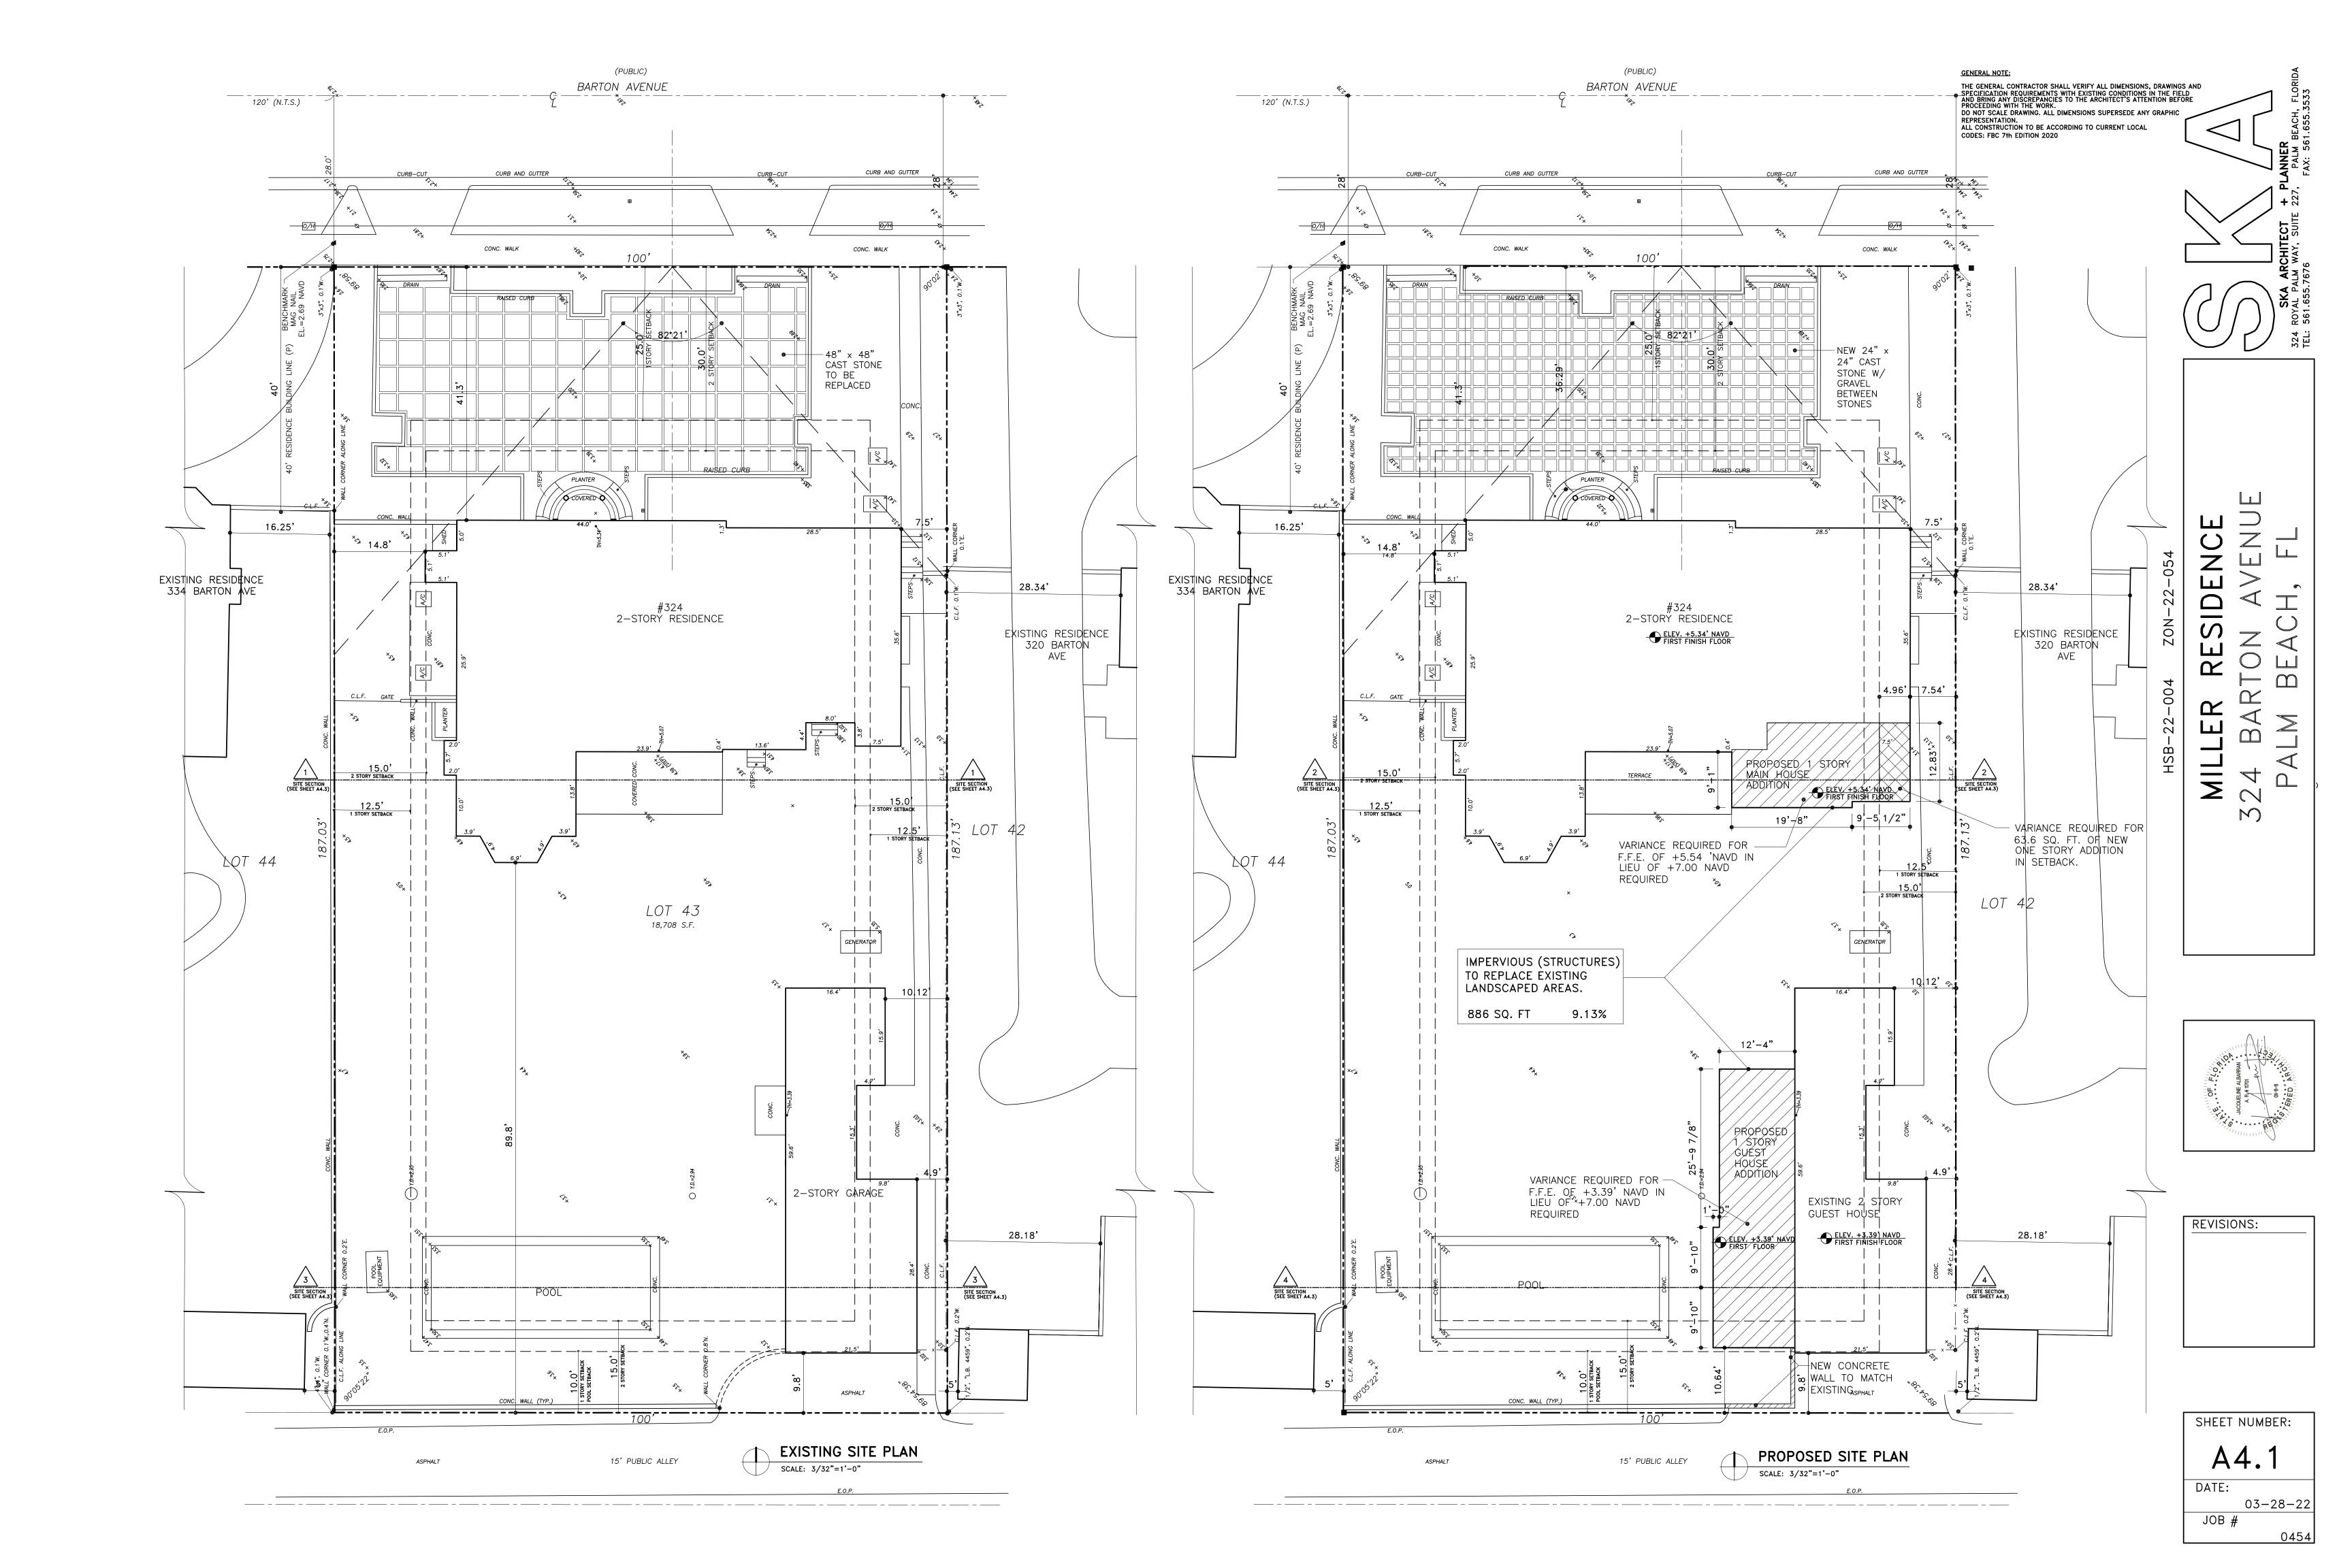


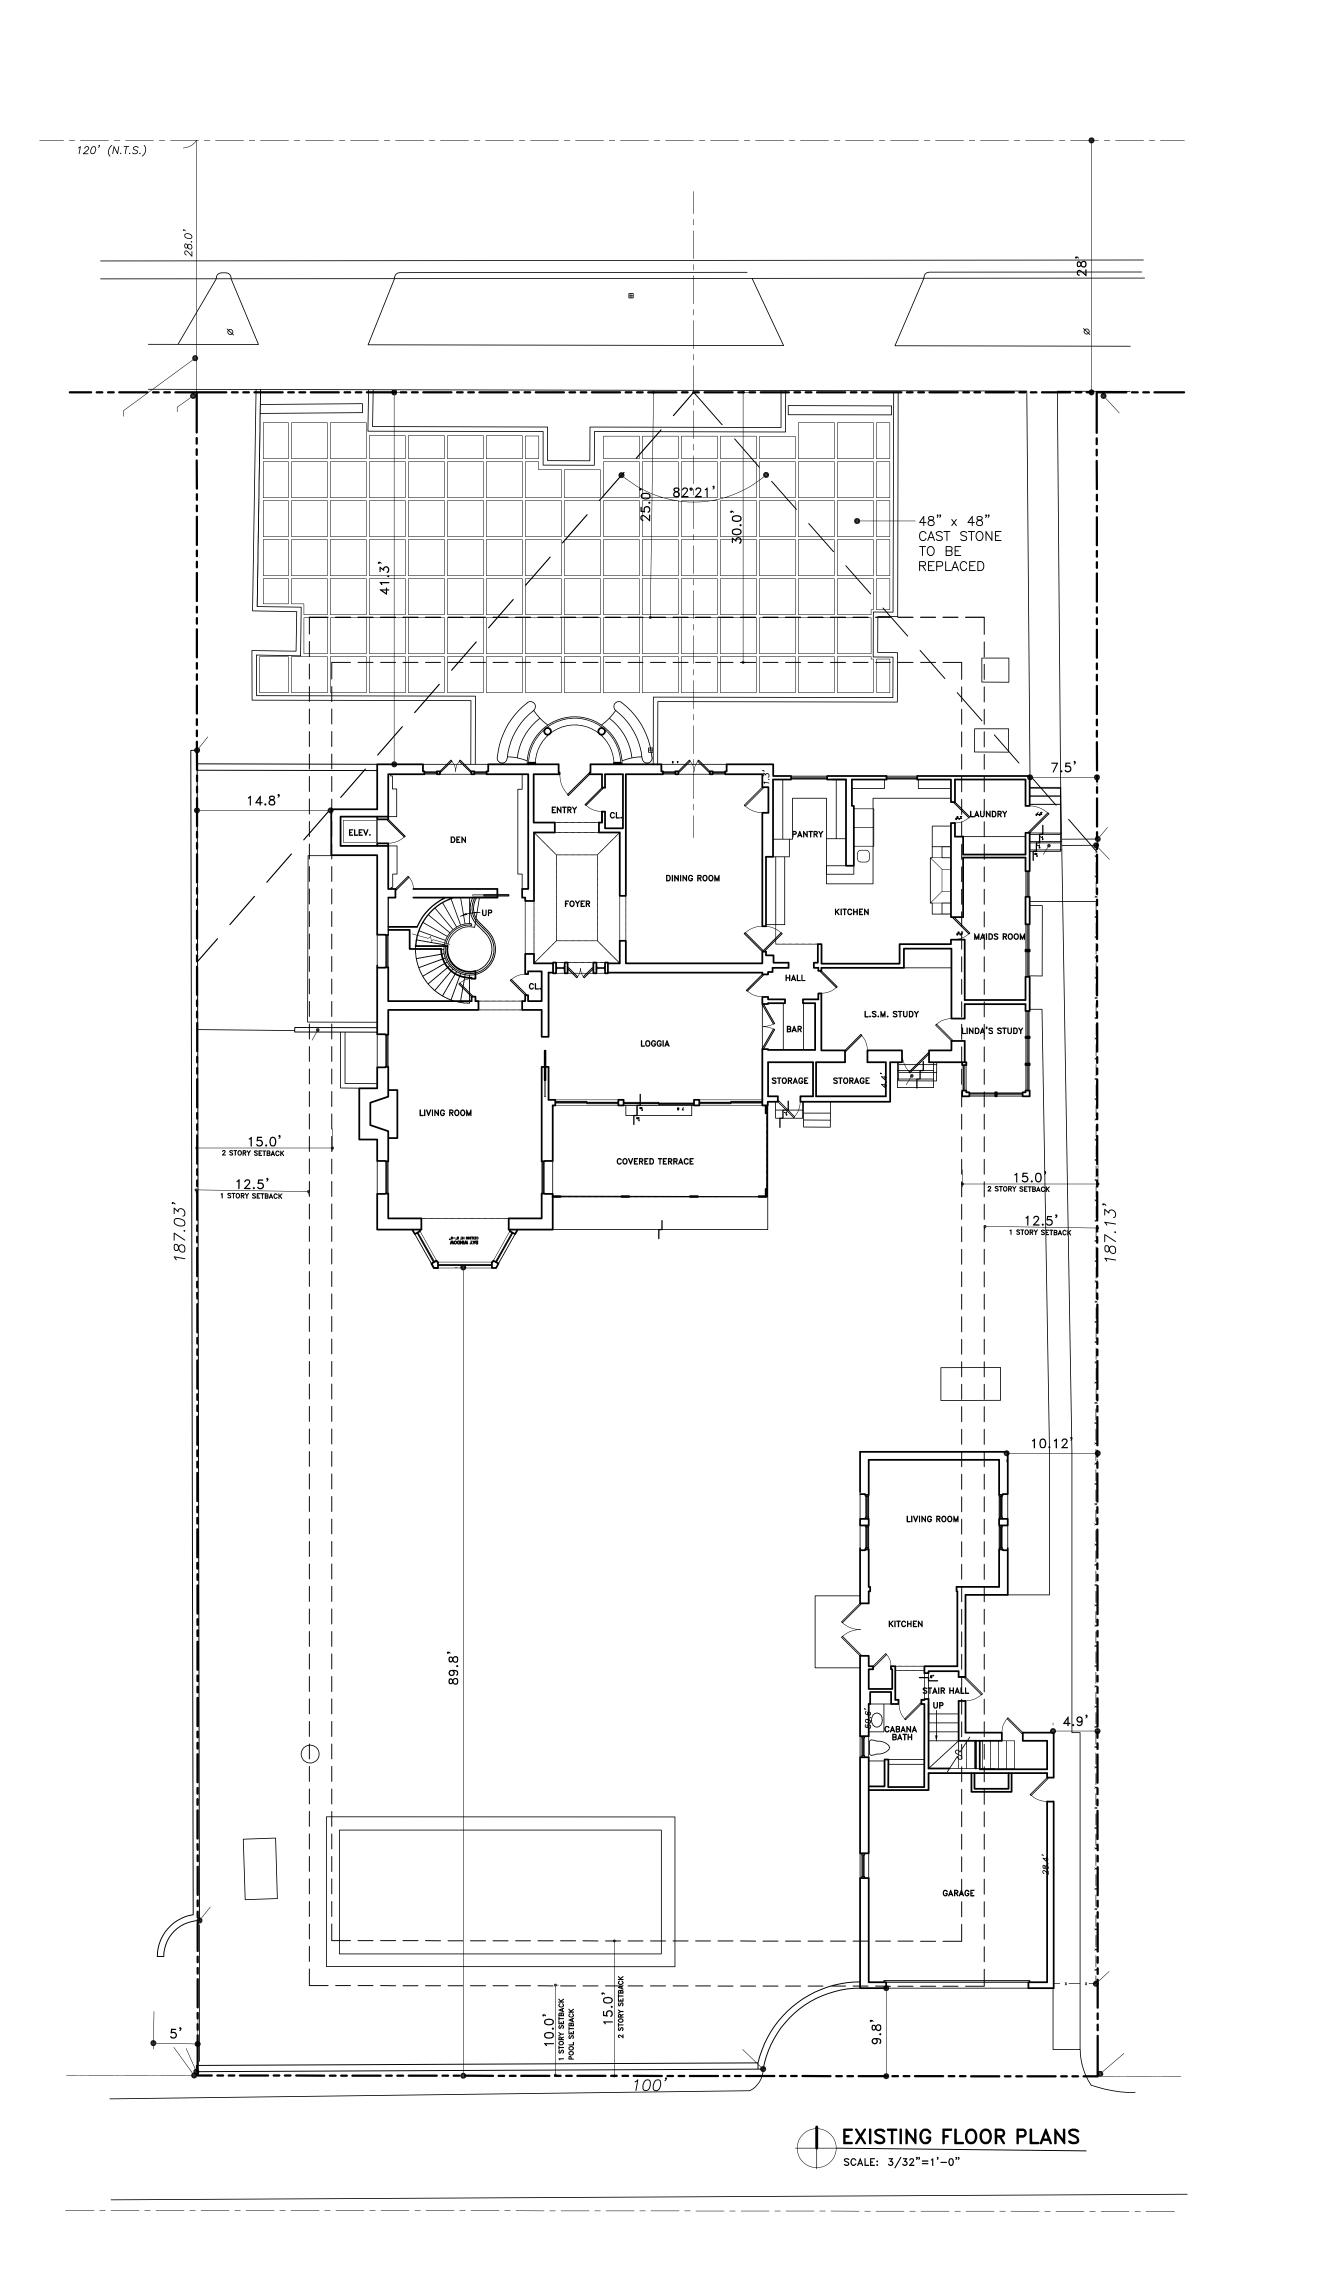

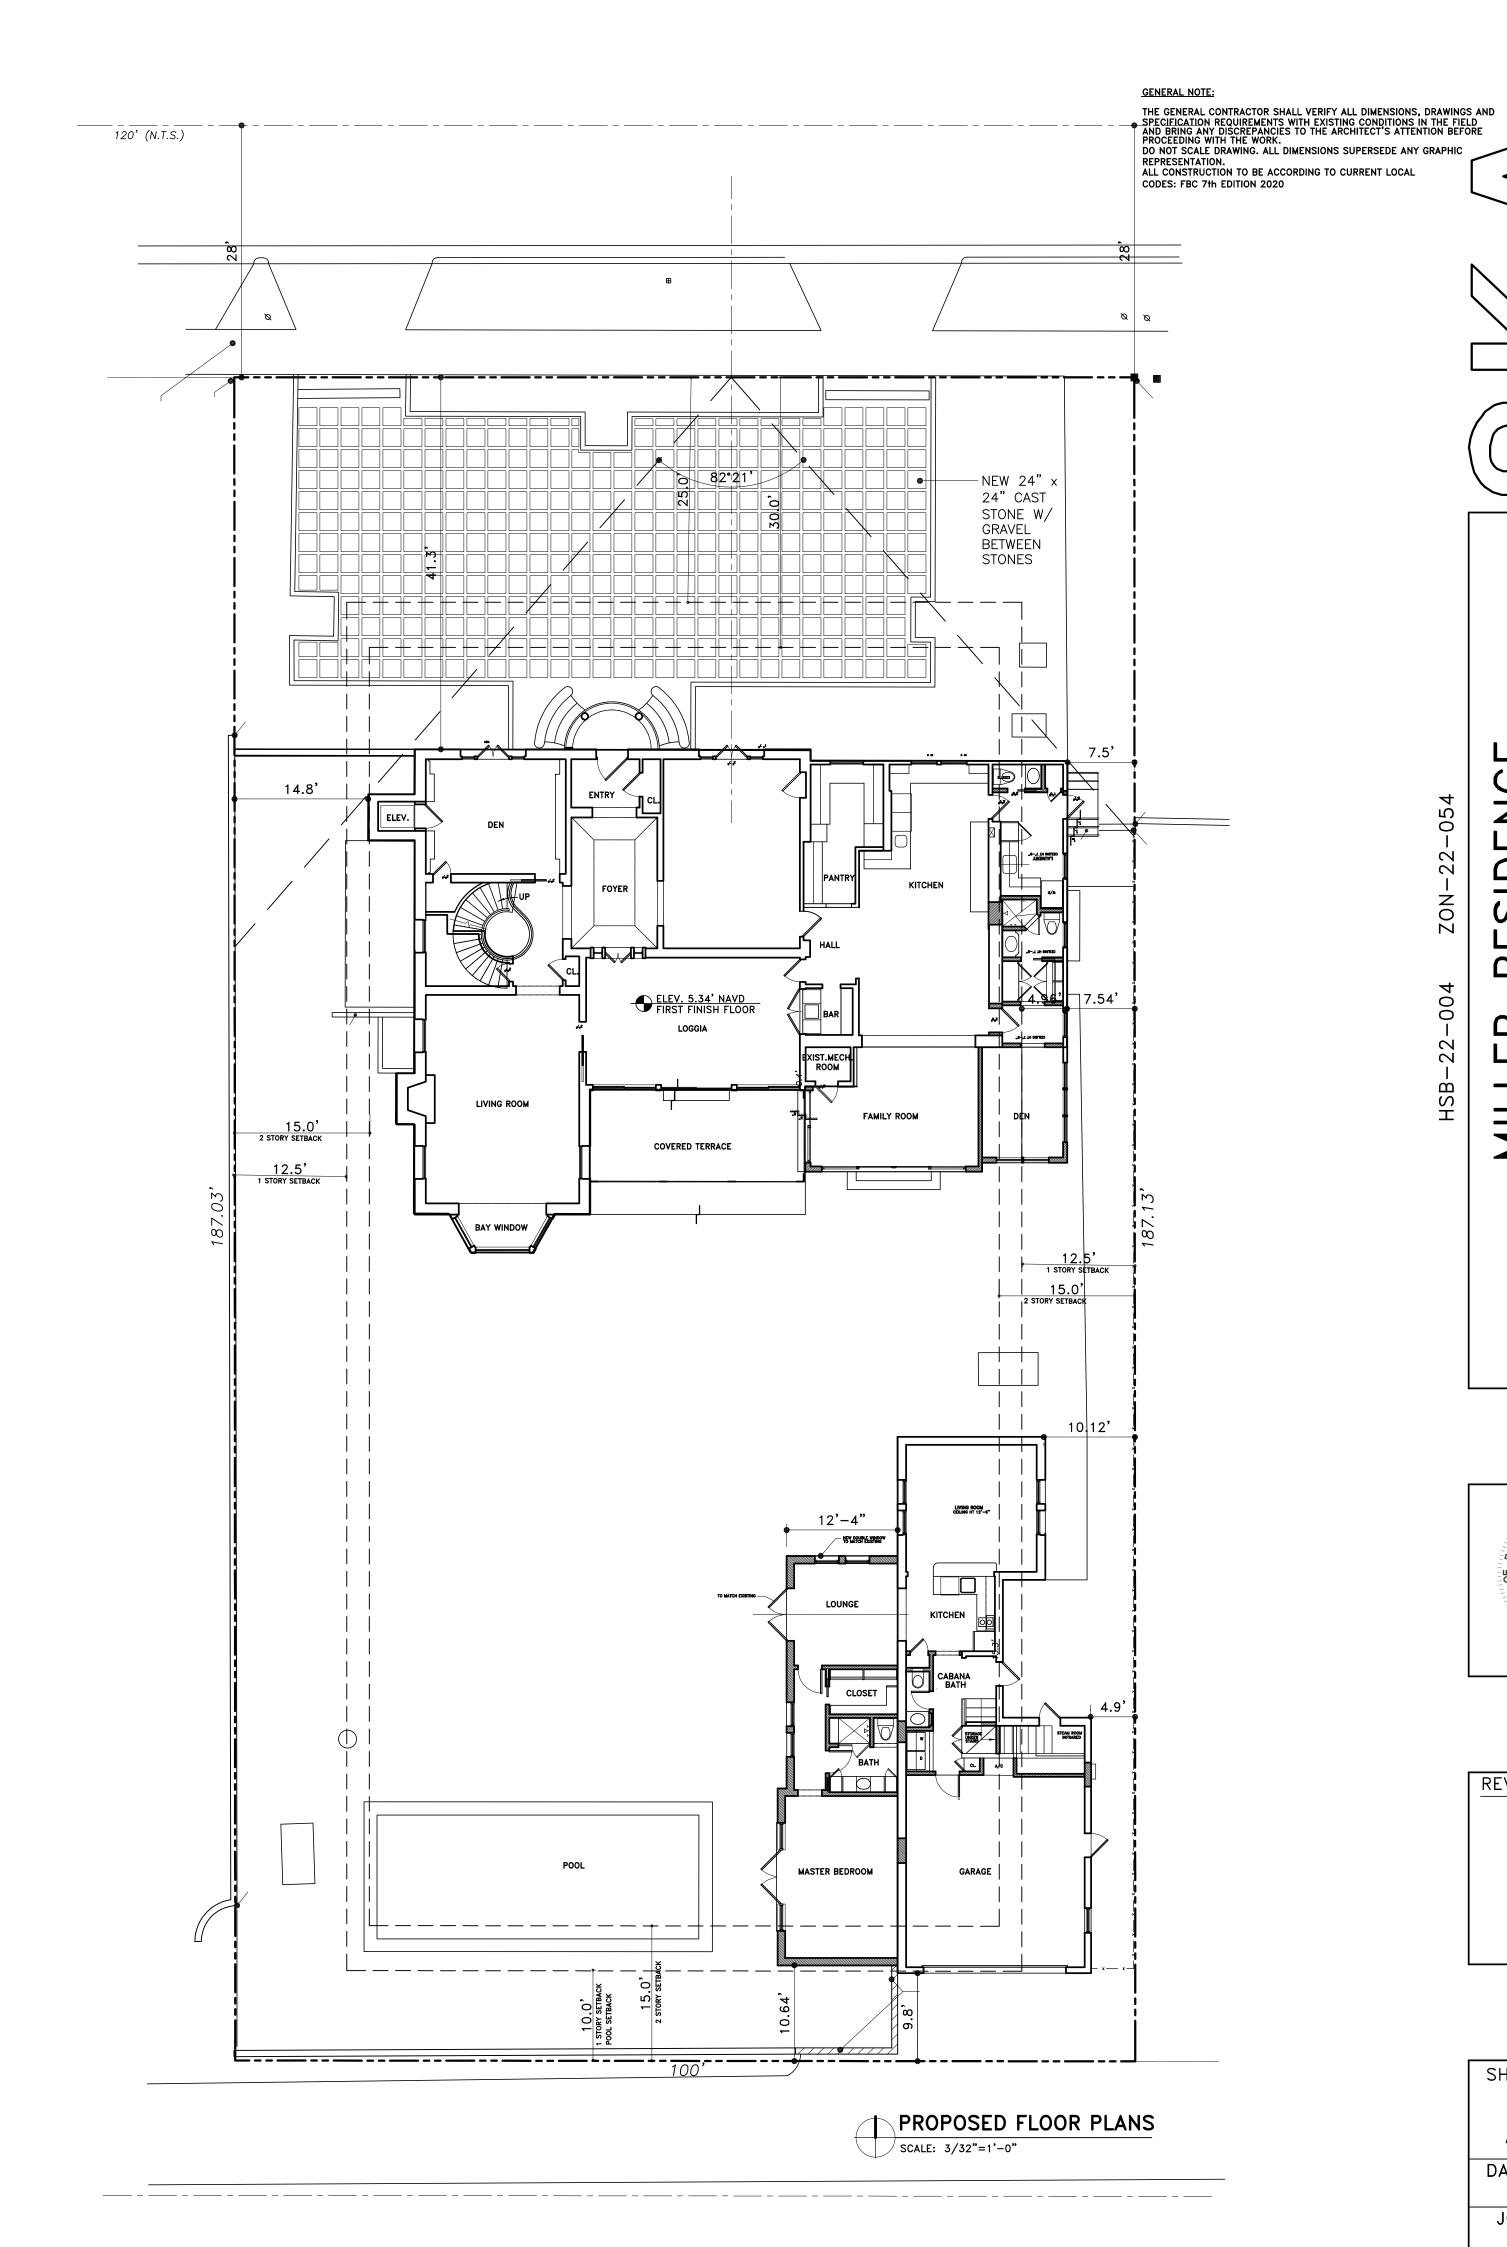

MILLER RESIDENCE 324 BARTON AVENUE


A RI TOO OF THE ALBARBAN A RI TOO OF THE TOO

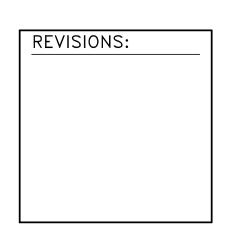

SHEET NUMBER:


DATE: 03-28-22

JOB #

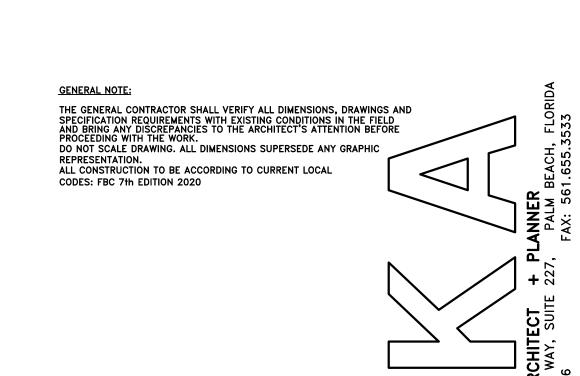




EXISTING MAIN HOUSE SITE SECTION 1
SCALE: 3/32" = 1'-0"

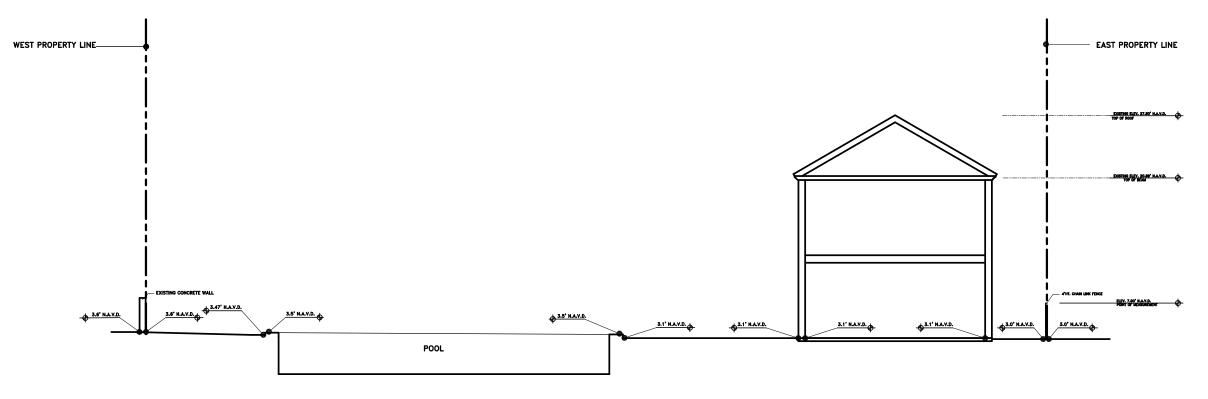

3 EXISTING GARAGE/GUEST HOUSE SITE SECTION 3



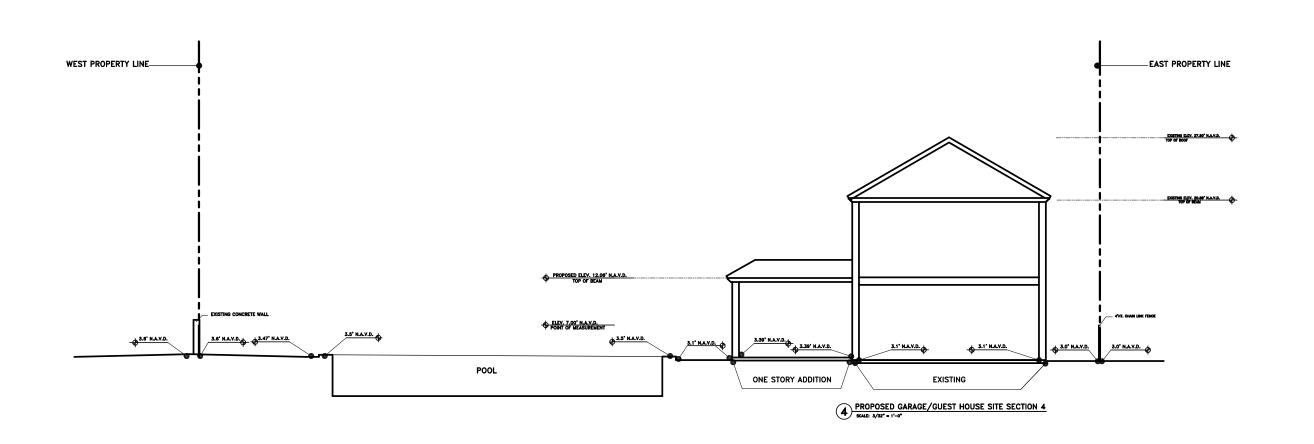

RESIDENCE

-054


NOZ

REVISIONS:


SHEET NUMBER:

DATE: 03-28-22

JOB # 0454

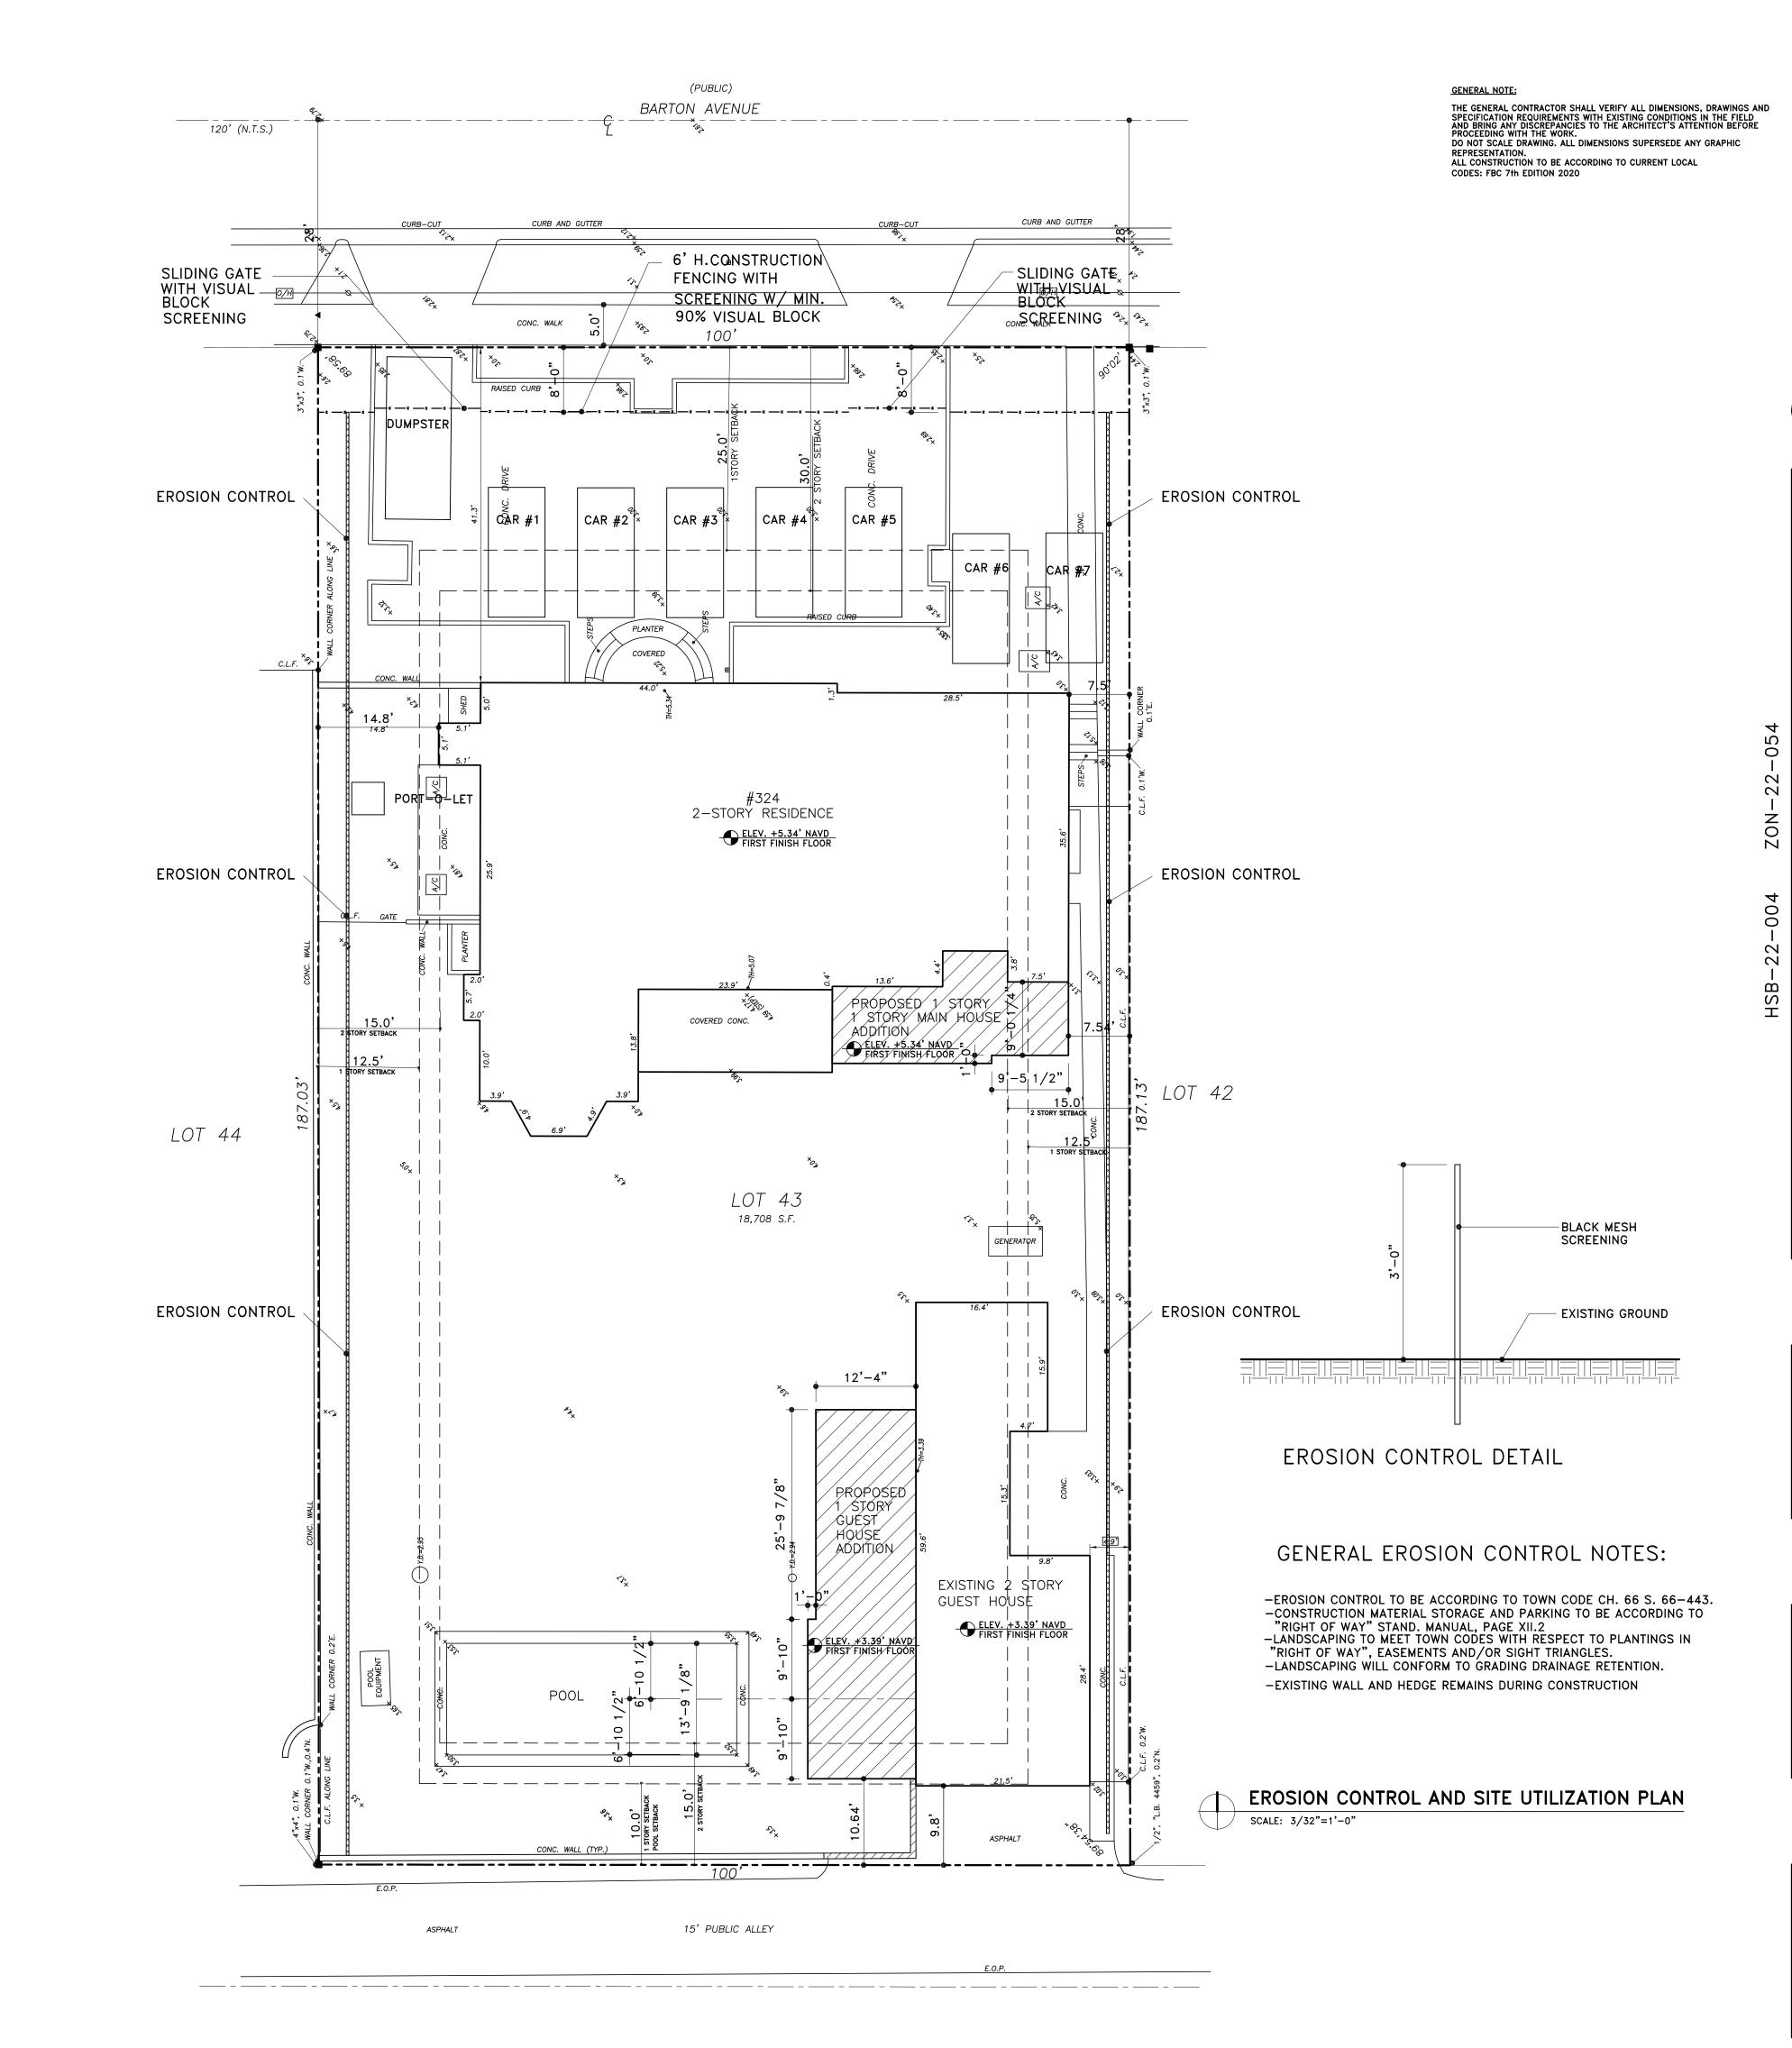

MILLER RESIDENCE 24 BARTON AVENUE PALM BEACH, FL

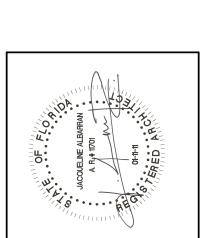

REVISIONS:

SHEET NUMBER:

A5

DATE:

03-28-22

0454

JOB #

19'-6"

SCALE: 1/4" = 1'-0"

THE GENERAL CONTRACTOR SHALL VERIFY ALL DIMENSIONS, DRAWINGS AND SPECIFICATION REQUIREMENTS WITH EXISTING CONDITIONS IN THE FIELD AND BRING ANY DISCREPANCIES TO THE ARCHITECT'S ATTENTION BEFORE PROCEEDING WITH THE WORK.

DO NOT SCALE DRAWING. ALL DIMENSIONS SUPERSEDE ANY GRAPHIC

REPRESENTATION.

ALL CONSTRUCTION TO BE ACCORDING TO CURRENT LOCAL CODES: FBC 7th EDITION 2020.

EXISTING WALLS TO REMAIN

M

REVISIONS:


SHEET NUMBER: A6 DATE: 03-28-22 JOB #

0454

THE GENERAL CONTRACTOR SHALL VERIFY ALL DIMENSIONS, DRAWINGS AND SPECIFICATION REQUIREMENTS WITH EXISTING CONDITIONS IN THE FIELD AND BRING ANY DISCREPANCIES TO THE ARCHITECT'S ATTENTION BEFORE PROCEEDING WITH THE WORK.

DO NOT SCALE DRAWING. ALL DIMENSIONS SUPERSEDE ANY GRAPHIC

REPRESENTATION.
ALL CONSTRUCTION TO BE ACCORDING TO CURRENT LOCAL CODES: FBC 7th EDITION 2020.

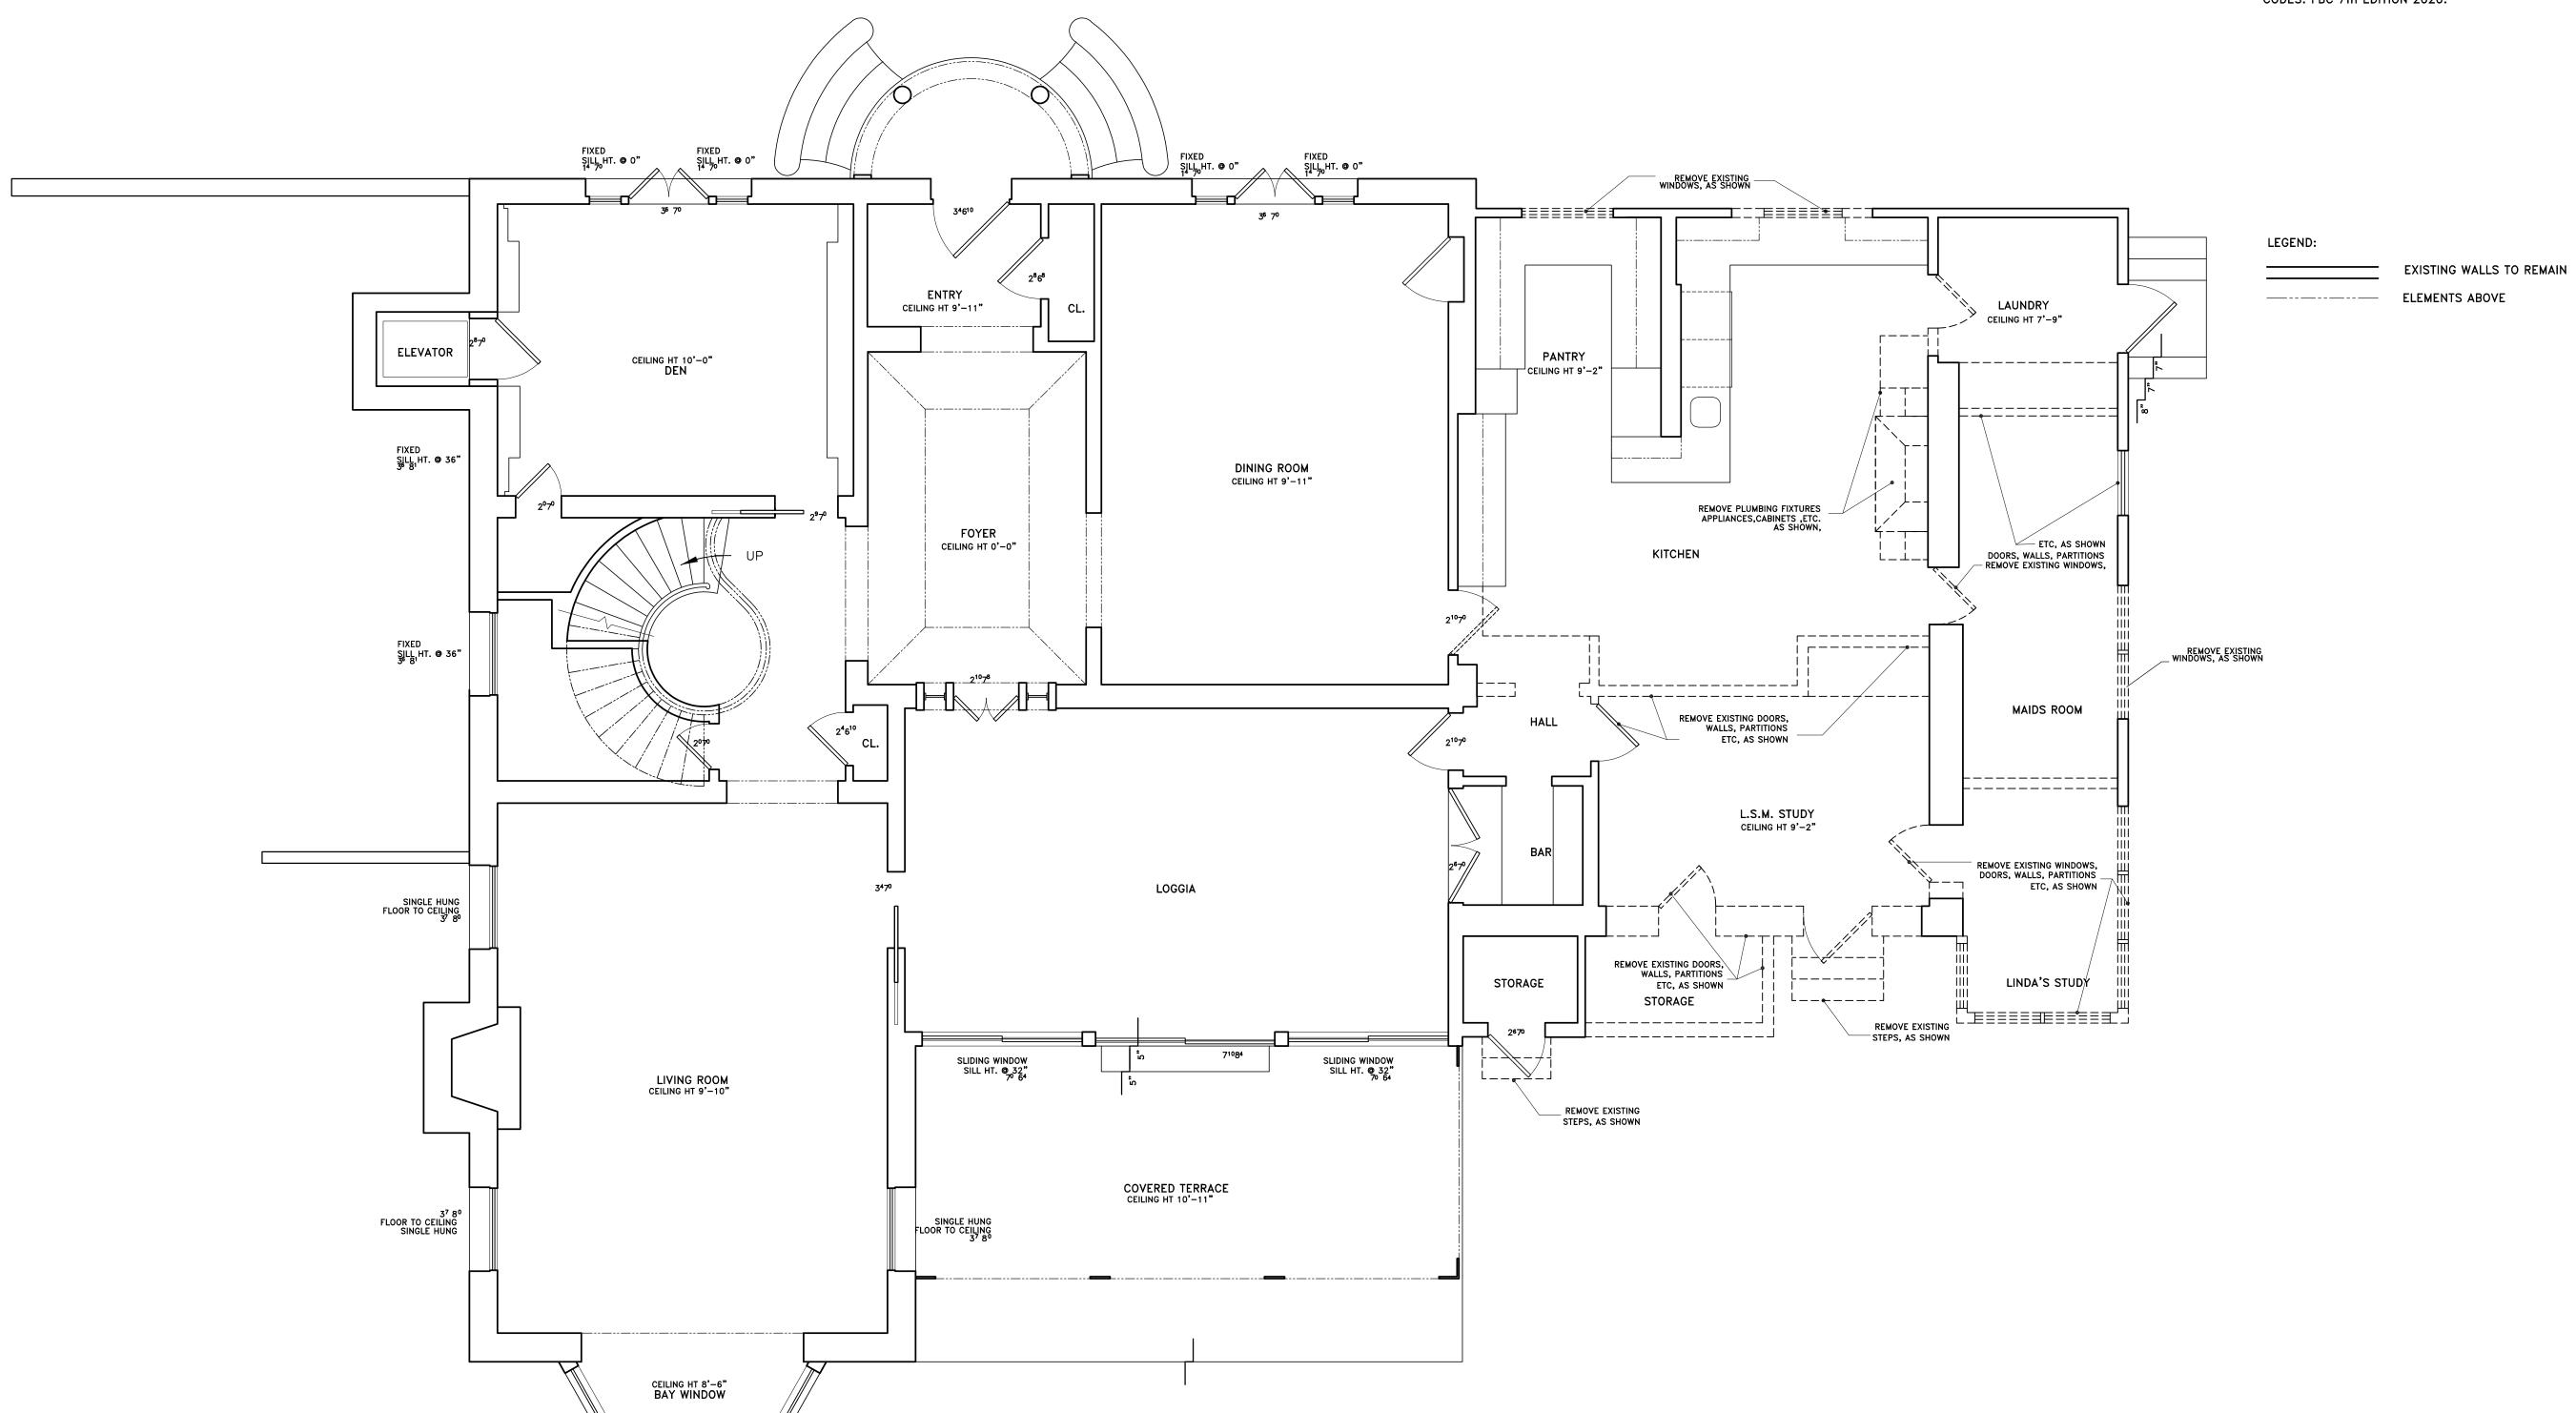

FIRST FLOOR MAIN HOUSE MATERIALS REMOVAL PLAN

SCALE: 1/4" = 1'-0"

LER RESIDENCE
BARTON AVENUE

JACOUELINE ALBAFRAN

A R# T701

OF FCO

SHEET NUMBER:

A7

DATE:

03-28-22

JOB #

0454