

VICINITY MAP SCALE: N.T.S.

PROJECT TEAM

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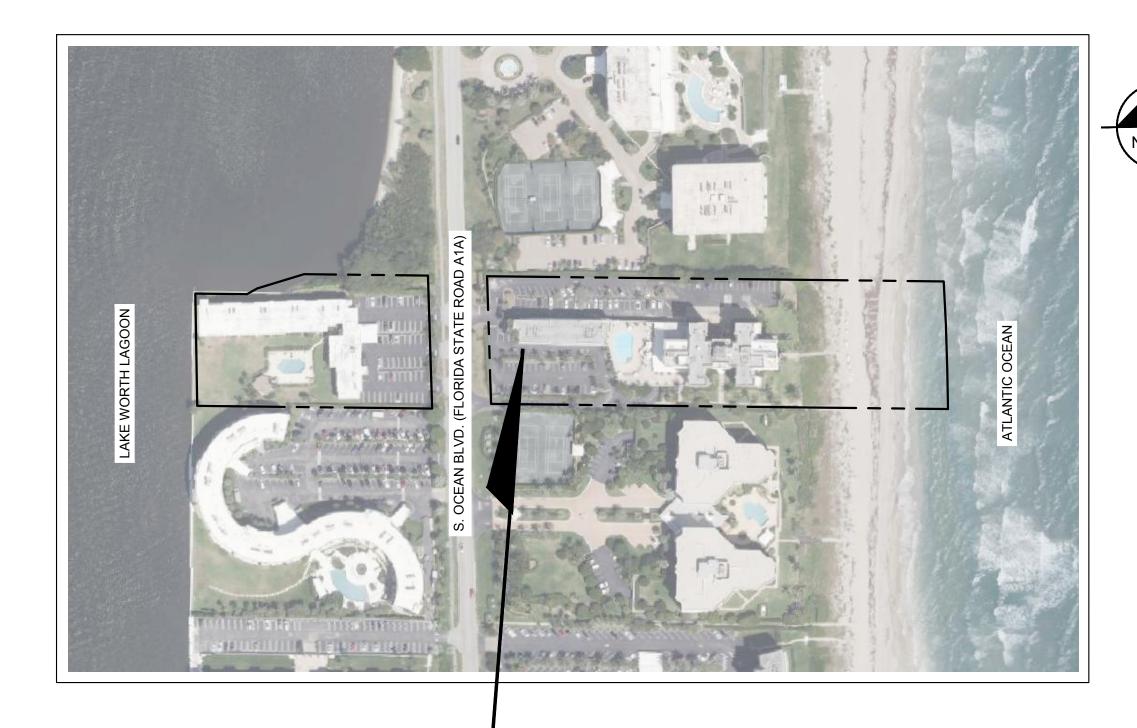
SITE PLAN PACKAGE FOR

AMBASSADOR EDGEWATER

PREPARED FOR

OKO GROUP

JAN. 2025



PROJECT LOCATION

2730 S. OCEAN BLVD, PALM BEACH, FL 33480 2720 S. OCEAN BLVD, PALM BEACH, FL 33480

> **VICINITY MAP** NOT TO SCALE SECTION: 23 TOWNSHIP: 44S RANGE: 43E

Sheet List Table

Sheet Number Sheet Title **COVER SHEET GENERAL NOTES** C1.01 C2.00 OVERALL DEMOLITION AND EROSION CONTROL PLAN DEMOLITION AND EROSION CONTROL PLAN C2.02 DEMOLITION AND EROSION CONTROL PLAN C2.03 DEMOLITION AND EROSION CONTROL PLAN DEMOLITION AND EROSION CONTROL DETAILS OVERALL HORIZONTAL CONTROL, PAVEMENT MARKING C3.00 AND SIGNAGE PLAN HORIZONTAL CONTROL, PAVEMENT MARKING AND C3.01 SIGNAGE PLAN HORIZONTAL CONTROL, PAVEMENT MARKING AND C3.02 SIGNAGE PLAN HORIZONTAL CONTROL, PAVEMENT MARKING AND SIGNAGE PLAN C4.00 OVERALL PAVING GRADING AND DRAINAGE PLAN C4.01 PAVING GRADING AND DRAINAGE PLAN PAVING, GRADING AND DRAINAGE PLAN C4.02 PAVING, GRADING AND DRAINAGE PLAN C4.03 TYPICAL SECTIONS TYPICAL SECTIONS PAVING, GRADING AND DRAINAGE DETAILS PAVING, GRADING AND DRAINAGE DETAILS C4.11 PAVING, GRADING AND DRAINAGE DETAILS C4.12 C4.13 PAVING. GRADING AND DRAINAGE DETAILS C5.00 OVERALL UTILITY PLAN UTILITY PLAN C5.01 UTILITY PLAN C5.02 UTILITY PLAN C5.03 C5.10 **UTILITY DETAILS** UTILITY DETAILS C5.12 UTILITY DETAILS C6.00 MANEUVERABILITY PLAN MANEUVERABILITY PLAN C6.01 C6.02 MANEUVERABILITY PLAN C6.03 MANEUVERABILITY PLAN MANEUVERABILITY PLAN C6.04 C6.05 B-1 MANEUVERABILITY PLAN C6.06

B-1 MANEUVERABILITY PLAN

VERTICAL DATUM
ELEVATIONS SHOWN HEREON ARE BASED ON THE
NORTH AMERICAN VERTICAL DATUM OF 1988. IAVD '88 ELEV. + 1.57' = NGVD '29 ELEVATION

Know what's **below.** Call before you dig. SUNSHINE STATE ONE CALL OF FLORIDA, INC.

SHEET NUMBER C1.00

SHEE

COVER

Kim

AMBASSADOR EDGEWATER PREPARED FOR OKO GROUP

CALL 2 WORKING DAYS
BEFORE YOU DIG

THE PRESENCE OF GROUNDWATER SHOULD BE ANTICIPATED. CONTRACTOR'S BID SHALL INCLUDE CONSIDERATION FOR ADDRESSING THIS ISSUE AND OBTAINING ALL NECESSARY PERMITS.

GENERAL CONSTRUCTION NOTES

- 1. THE CONTRACTOR AND SUBCONTRACTORS SHALL OBTAIN A COPY OF THE FLORIDA DEPARTMENT OF TRANSPORTATION "STANDARD SPECIFICATIONS FOR ROAD AND BRIDGE CONSTRUCTION" (LATEST EDITION), AND BECOME FAMILIAR WITH THE CONTENTS PRIOR TO
- THE CONTRACTOR SHALL BE RESPONSIBLE FOR FURNISHING ALL MATERIAL AND LABOR TO CONSTRUCT THE FACILITY AS SHOWN AND DESCRIBED IN THE CONSTRUCTION DOCUMENTS IN ACCORDANCE WITH THE APPROPRIATE APPROVING AUTHORITIES. SPECIFICATIONS AND REQUIREMENTS. CONTRACTOR SHALL CLEAR AND GRUB ALL AREAS UNLESS OTHERWISE INDICATED, REMOVING TREES, STUMPS, ROOTS, MUCK, EXISTING PAVEMENT AND ALL OTHER
- 3. IT IS THE CONTRACTOR'S RESPONSIBILITY TO CONTACT THE VARIOUS UTILITY COMPANIES WHICH MAY HAVE BURIED OR AERIAL UTILITIES WITHIN OR NEAR THE CONSTRUCTION AREA BEFORE COMMENCING WORK. THE CONTRACTOR SHALL PROVIDE 2 WORKING DAYS MINIMUM NOTICE TO ALL UTILITY COMPANIES PRIOR TO BEGINNING CONSTRUCTION. THE CONTRACTOR MUST CALL THE UTILITY COMPANIES BEFORE COMMENCING WORK.
- 4. THE CONTRACTOR SHALL BE RESPONSIBLE FOR OBTAINING ALL REQUIRED CONSTRUCTION PERMITS AND BONDS IF REQUIRED PRIOR TO CONSTRUCTION.
- 5. THE CONTRACTOR SHALL HAVE AVAILABLE AT THE JOB SITE AT ALL TIMES ONE COPY OF THE CONSTRUCTION DOCUMENTS INCLUDING PLANS. SPECIFICATIONS. AND SPECIAL CONDITIONS AND COPIES OF ANY REQUIRED CONSTRUCTION PERMITS.
- 6. ANY DISCREPANCIES ON THE DRAWINGS SHALL BE IMMEDIATELY BROUGHT TO THE ATTENTION OF THE OWNER AND ENGINEER BEFORE COMMENCING WORK. NO FIELD CHANGES OR DEVIATIONS FROM DESIGN ARE TO BE MADE WITHOUT PRIOR APPROVAL OF THE OWNER AND THE ENGINEER.
- ALL COPIES OF COMPACTION, CONCRETE AND OTHER REQUIRED TEST RESULTS ARE TO BE SENT TO THE OWNER AND ENGINEER DIRECTLY FROM THE TESTING AGENCY.
- 8. THE CONTRACTOR SHALL BE RESPONSIBLE FOR SUBMITTING TO THE ENGINEER A CERTIFIED RECORD SURVEY SIGNED AND SEALED BY A PROFESSIONAL LAND SURVEYOR REGISTERED IN THE STATE OF FLORIDA DEPICTING THE ACTUAL FIELD LOCATION OF ALL CONSTRUCTED IMPROVEMENTS THAT ARE REQUIRED BY THE JURISDICTIONAL AGENCIES FOR THE CERTIFICATION PROCESS. ALL SURVEY COSTS WILL BE THE CONTRACTOR'S RESPONSIBILITY
- THE CONTRACTOR SHALL BE RESPONSIBLE FOR DOCUMENTING AND MAINTAINING AS-BUILT INFORMATION WHICH SHALL BE RECORDED AS CONSTRUCTION PROGRESSES OR AT THE COMPLETION OF APPROPRIATE CONSTRUCTION INTERVALS AND SHALL BE RESPONSIBLE FOR PROVIDING AS-BUILT DRAWINGS TO THE OWNER FOR THE PURPOSE OF CERTIFICATION TO JURISDICTIONAL AGENCIES AS REQUIRED. ALL AS-RUILT DATA SHALL BE COLLECTED BY A STATE OF FLORIDA PROFESSIONAL LAND SURVEYOR WHOSE SERVICES ARE ENGAGED BY THE
- 10. THE CONTRACTOR SHALL BE RESPONSIBLE FOR VERIFYING THAT THE PROPOSED IMPROVEMENTS SHOWN ON THE PLANS DO NOT CONFLICT WITH ANY KNOWN EXISTING OR OTHER PROPOSED IMPROVEMENTS. IF ANY CONFLICTS ARE DISCOVERED, THE CONTRACTOR SHALL NOTIFY THE OWNER PRIOR TO INSTALLATION OF ANY PORTION OF THE SITE WORK THAT WOULD BE AFFECTED. FAILURE TO NOTIFY OWNER OF AN IDENTIFIABLE CONFLICT PRIOR TO PROCEEDING WITH INSTALLATION RELIEVES OWNER OF ANY OBLIGATION TO PAY FOR A RELATED CHANGE ORDER.
- 11. CONTRACTOR SHALL BE SOLELY RESPONSIBLE FOR VERIFYING ALL QUANTITIES, TAKE-OFF MEASUREMENTS, MATERIALS, ETC. DURING THE BID PROCESS WHEN DISCREPANCIES OCCUR, THE PHYSICAL PLAN TAKES PRECEDENCE. THE ENGINEER. LANDSCAPE ARCHITECT. COUNTY CITY OR PROJECT MANAGERS ARE NOT TO BE HELD RESPONSIBLE FOR DISCREPANCIES TO
- 12. THE CONTRACTOR SHALL LIMIT CONSTRUCTION OPERATIONS TO WITHIN THE LIMITS OF CONSTRUCTION. THE CONTRACTOR IS SOLELY RESPONSIBLE FOR ANY DAMAGES OUTSIDE THE
- 13. CONTRACTOR IS ADVISED THAT THE U.S. ENVIRONMENTAL PROTECTION AGENCY REQUIRES THAT ALL OPERATORS FILE A NOTICE OF INTENT (NOI) FOR STORMWATER DISCHARGES ASSOCIATED WITH CONSTRUCTION ACTIVITY UNDER THE NPDES GENERAL PERMIT PRIOR TO BEGINNING WORK. IT IS THE CONTRACTOR'S SOLE RESPONSIBILITY TO OBTAIN THE SAME. A COPY SHALL BE SENT TO THE ENGINEER OF RECORD, ARCHITECT OF RECORD AND THE
- 14. FLORIDA LAW (F.S. 553.851) PROTECTION OF UNDERGROUND PIPELINES MANDATES THAT 'NO EXCAVATOR SHALL COMMENCE OR PERFORM ANY EXCAVATION WITHOUT FIRST OBTAINING INFORMATION CONCERNING THE POSSIBLE LOCATION OF GAS PIPELINES IN THE AREA O PROPOSED EXCAVATION." THE EXCAVATOR MUST NOTIFY THE GAS UTILITY A MINIMUM OF 2 WORKING DAYS AND A MAXIMUM OF 5 WORKING DAYS PRIOR TO EXCAVATION.
- 15. THE CONTRACTOR SHALL BE RESPONSIBLE TO COORDINATE WITH THE LOCAL ELECTRICAL PROVIDER ON ANY WORK IN THE VICINITY OF OVERHEAD OR UNDERGROUND POWER LINES.
- 16. CONTRACTOR SHALL BE RESPONSIBLE FOR REVIEWING ALL PLANS RELATED TO SITE WORK INCLUDING (BUT NOT LIMITED TO) LANDSCAPE, IRRIGATION, SITE LIGHTING, BUILDING FOUNDATION, PLUMBING, FIRE SPRINKLER, AND OTHER APPLICABLE PLANS FOR CONFLICTING INFORMATION AND ALERT OWNER'S REPRESENTATIVE OF ANY CONFLICT FOR RESOLUTION.
- 17. CONTRACTOR SHALL VERIFY LOCATION OF ALL IRRIGATION, STREET LIGHTING, AND ELECTRICAL CONDUIT THAT WILL BE IN CONFLICT WITH ANY PROPOSED CONSTRUCTION AND SHALL RESOLVE CONFLICT ACCORDINGLY. COST OF CONFLICT RESOLUTION SHALL BE
- 18. ANY DEBRIS RESULTING FROM STRIPPING AND DEMOLITION OPERATIONS SHALL BE REMOVED FROM THE SITE AT FREQUENT INTERVALS TO PREVENT THIS MATERIAL FROM ACCUMULATING 19. UPON REMOVAL OF TREES, SHRUBS OR ANY STUMP GRINDING, NO ROOT GREATER THAN
- THREE INCHES IN DIAMETER SHALL REMAIN WITHIN FIVE FEET OF AN UNDERGROUND STRUCTURE OR UTILITY LINE OR UNDER SLABS OR FOOTINGS OR PAVED AREAS.
- 20. THE CONTRACTOR SHALL RESTORE ALL DISTURBED VEGETATION IN KIND, UNLESS SHOWN 21. THE CONTRACTOR SHALL ENSURE THAT ANY TREE OR SHRUB PLACED WITHIN WATER,
- SEWER OR DRAINAGE EASEMENTS SHALL CONFORM TO THE TOWN OF PALM BEACH

TRENCH SAFETY ACT

- 1. CONTRACTOR SHALL BE SOLELY RESPONSIBLE FOR COMPLIANCE WITH THE STATE OF FLORIDA TRENCH SAFETY ACT
- 2. WHERE EXCAVATIONS TO A DEPTH IN EXCESS OF FIVE FEET (5') ARE REQUIRED. THE CONTRACTOR SHALL INCLUDE THE FOLLOWING INFORMATION IN THE BID:
- A. A REFERENCE TO THE TRENCH SAFETY STANDARDS THAT WILL BE IN EFFECT DURING THE PERIOD OF CONSTRUCTION OF THE PROJECT
- B. WRITTEN ASSURANCES BY THE CONTRACTOR PERFORMING THE TRENCH EXACTION THAT SUCH CONTRACTOR WILL COMPLY WITH THE APPLICABLE TRENCH SAFETY STANDARDS.
- C. A SEPARATE ITEM IDENTIFYING THE COST OF COMPLIANCE WITH THE APPLICABLE
- 3. WHEN A BID IS NOT SUBMITTED, THE CONTRACTOR SHALL SUBMIT THE INFORMATION LISTED IN ITEM "2" TO THE ENGINEER PRIOR TO STARTING WORK.

<u>UTILITIES</u>

EXISTING UTILITIES SHOWN ARE LOCATED ACCORDING TO THE INFORMATION AVAILABLE TO THE ENGINEER AT THE TIME OF THE TOPOGRAPHIC SURVEY AND HAVE NOT BEEN INDEPENDENTLY VERIFIED BY THE OWNER OR THE ENGINEER. GUARANTFF IS NOT MADE THAT ALL EXISTING UNDERGROUND UTILITIES ARE SHOWN OR THAT THE LOCATION OF THOSE SHOWN ARE ENTIRELY ACCURATE. FINDING THE ACTUAL LOCATION OF ANY EXISTING UTILITIES IS THE CONTRACTOR'S RESPONSIBILITY AND SHALL BE DONE BEFORE HE COMMENCES ANY WORK IN THE VICINITY. FURTHERMORE, THE CONTRACTOR SHALL BE FULLY RESPONSIBLE FOR ANY AND ALL DAMAGES DUE TO THE CONTRACTOR'S FAILURE TO EXACTLY LOCATE AND PRESERVE ANY AND ALL UNDERGROUND UTILITIES. THE OWNER OR ENGINEER WILL ASSUME NO LIABILITY FOR ANY DAMAGES SUSTAINED OR COST INCURRED BECAUSE OF THE OPERATIONS IN THE VICINITY OF EXISTING UTILITIES OR STRUCTURES, NOR FOR TEMPORARY BRACING AND SHORING OF SAME. IF IT IS NECESSARY TO SHORE, BRACE, SWING OR RELOCATE A UTILITY, THE UTILITY COMPANY OR DEPARTMENT AFFECTED SHALL BE CONTACTED AND THEIR PERMISSION OBTAINED REGARDING THE METHOD TO USE FOR SUCH

WATER AND SEWER UTILITY NOTES

- ALL CONSTRUCTION SHALL MEET OR EXCEED THE LOCAL WATER AND SEWER REQUIREMENTS AND THE FLORIDA DEPARTMENT OF ENVIRONMENTAL PROTECTION REQUIREMENTS UNLESS OTHERWISE NOTED. IT IS THE CONTRACTOR'S RESPONSIBILITY TO OBTAIN THE SPECIFICATIONS AND DETAILS FROM THE LOCAL AGENCY.
- THE CONTRACTOR SHALL CONSTRUCT GRAVITY SEWER LATERALS, MANHOLES AND GRAVITY SEWER LINES AS SHOWN OF THESE PLANS. THE CONTRACTOR SHALL FURNISH ALL NECESSARY MATERIALS, EQUIPMENT, MACHINERY, TOOLS, MEANS OF TRANSPORTATION AND LABOR NECESSARY TO COMPLETE THE WORK IN FULL AND COMPLETE ACCORDANCE WITH THE SHOWN, DESCRIBED AND REASONABLY INTENDED REQUIREMENTS OF THE CONTRACT DOCUMENTS AND JURISDICTIONAL AGENCY REQUIREMENTS. IN THE EVENT THAT THE CONTRACT DOCUMENTS AND THE JURISDICTIONAL AGENCY REQUIREMENTS ARE NOT IN AGREEMENT, THE MOST STRINGENT SHALL GOVERN.
- EXISTING UTILITIES SHOWN ARE LOCATED ACCORDING TO THE INFORMATION AVAILABLE TO THE ENGINEER AT THE TIME OF THE TOPOGRAPHIC SURVEY AND HAVE NOT BEEN INDEPENDENTLY VERIFIED BY THE OWNER OR THE ENGINEER. GUARANTEE IS NOT MADE THAT ALL EXISTING UNDERGROUND UTILITIES ARE SHOWN OR THAT THE LOCATION OF THOSE SHOWN ARE ENTIRELY ACCURATE. FINDING THE ACTUAL LOCATION OF ANY EXISTING UTILITIES IS THE CONTRACTOR'S RESPONSIBILITY AND SHALL BE DONE BEFORE HE COMMENCES ANY WORK IN THE VICINITY. FURTHERMORE, THE CONTRACTOR SHALL BE FULLY RESPONSIBLE FOR ANY AND ALL DAMAGES DUE TO THE CONTRACTOR'S FAILURE TO EXACTLY LOCATE AND PRESERVE ANY AND ALL UNDERGROUND UTILITIES. THE OWNER OR ENGINEER WILL ASSUME NO LIABILITY FOR ANY DAMAGES SUSTAINED OR COST INCURRED BECAUSE OF THE OPERATIONS IN THE VICINITY OF EXISTING UTILITIES OR STRUCTURES. NOR FOR TEMPORARY BRACING AND SHORING OF SAME. IF IT IS NECESSARY TO SHORE, BRACE, SWING OR RELOCATE A UTILITY, THE UTILITY COMPANY OR DEPARTMENT AFFECTED SHALL BE CONTACTED AND THEIR PERMISSION OBTAINED REGARDING THE METHOD TO USE FOR
- DEFLECTION OF PIPE JOINTS AND CURVATURE OF PIPE SHALL NOT EXCEED THE MANUFACTURER'S SPECIFICATIONS. SECURELY CLOSE ALL OPEN ENDS OF PIPE AND FITTINGS WITH A WATERTIGHT PLUG WHEN WORK IS NOT IN PROGRESS. THE INTERIOR OF ALL PIPES SHALL BE CLEAN AND JOINT SURFACES WIPED CLEAN AND DRY AFTER THE PIPE HAS BEEN LOWERED INTO THE TRENCH. VALVES SHALL BE PLUMB AND LOCATED ACCORDING TO THE PLANS
- ALL PHASES OF INSTALLATION, INCLUDING UNLOADING, TRENCHING, LAYING AND BACK FILLING, SHALL BE DONE IN A FIRST CLASS WORKMANLIKE MANNER. ALL PIPE AND FITTINGS SHALL BE CAREFULLY STORED FOLLOWING MANUFACTURER'S RECOMMENDATIONS. CARE SHALL BE TAKEN TO AVOID DAMAGE TO THE COATING OR LINING OF ANY D.I. PIPE FITTINGS. ANY PIPE OR FITTING WHICH IS DAMAGED OR WHICH HAS FLAWS OR IMPERFECTIONS WHICH, IN THE OPINION OF THE ENGINEER OR OWNER, RENDERS IT UNFIT FOR USE, SHALL NOT BE USED. ANY PIPE NOT SATISFACTORY FOR USE SHALL BE CLEARLY MARKED AND IMMEDIATELY REMOVED FROM THE JOB SITE, AND SHALL BE REPLACED AT THE CONTRACTOR'S EXPENSE.
- 6. WATER FOR FIRE FIGHTING SHALL BE AVAILABLE FOR USE PRIOR TO COMBUSTIBLES BEING BROUGHT ON
- ALL UTILITY AND STORM DRAIN TRENCHES LOCATED UNDER AREAS TO RECEIVE PAVING SHALL BE COMPLETELY BACK FILLED IN ACCORDANCE WITH THE GOVERNING JURISDICTIONAL AGENCY'S SPECIFICATIONS. IN THE EVENT THAT THE CONTRACT DOCUMENTS AND THE JURISDICTIONAL AGENCY REQUIREMENTS ARE NOT IN AGREEMENT, THE MOST STRINGENT SHALL GOVERN.
- 8. UNDERGROUND LINES SHALL BE AS-BUILT BY A STATE OF FLORIDA PROFESSIONAL LAND SURVEYOR
- CONTRACTOR SHALL PERFORM, AT HIS OWN EXPENSE, ANY AND ALL TESTS REQUIRED BY THE SPECIFICATIONS AND/OR ANY AGENCY HAVING JURISDICTION. THESE TESTS MAY INCLUDE, BUT MAY NOT BE LIMITED TO, INFILTRATION AND EXFILTRATION, TELEVISION INSPECTION AND A MANDREL TEST ON GRAVITY SEWER. A COPY OF THE TEST RESULTS SHALL BE PROVIDED TO THE UTILITY PROVIDER, OWNER AND JURISDICTIONAL AGENCY AS REQUIRED.
- 10. ALL PIPES AND CONNECTIONS ARE TO BE RESTRAINED IN ACCORDANCE WITH THE DETAILS OR JURISDICTIONAL AGENCY REQUIREMENTS, WHICHEVER IS MOST STRINGENT.
- ALL WATER DISTRIBUTION SYSTEM MATERIALS (INCLUDING SERVICES) AND INSTALLATION SHALL CONFORM TO THE SPECIFICATIONS OF THE LOCAL WATER PROVIDER AS PROVIDED IN THEIR STANDARD SPECIFICATIONS MANUAL AND THE FLORIDA DEPARTMENT OF ENVIRONMENTAL PROTECTION. THE CONTRACTOR IS RESPONSIBLE TO OBTAIN SPECIFICATION MANUALS PRIOR TO BIDDING THE PROJECT.
- 12. ALL POTABLE WATER PIPE AND PIPE FITTINGS INSTALLED UNDER THIS PROJECT WILL BE COLOR CODED OR MARKED IN ACCORDANCE WITH F.A.C. 62-555.320(21)(B)3, USING BLUE AS THE PREDOMINANT COLOR. (UNDERGROUND PLASTIC PIPE WILL BE SOLID-WALL BLUE PIPE WILL HAVE A CO-EXTRUDED BLUE EXTERNAL SKIN, OR WILL BE WHITE OR BLACK WITH BLUE STRIPES INCORPORATED INTO, OR APPLIED TO, THE PIPE WALL, PIPE STRIPED DURING THE MANUFACTURING OF THE PIPE WILL HAVE CONTINUOUS STRIPES THAT RUN PARALLEL TO THE AXIS OF THE PIPE, THAT ARE LOCATED AT NO GREATER THAN 90—DEGREE INTERVALS AROUND THE PIPE, AND THAT WILL REMAIN INTACT DURING AND AFTER INSTALLATION OF THE PIPE. IF TAPE OR PAINT IS USED TO STRIPE PIPE DURING AND AFTER INSTALLATION 18. SLOPES SHALL BE LEFT IN A ROUGHENED CONDITION DURING THE GRADING PHASE TO THE PIPE, THE TAPE OR PAINT WILL BE APPLIED IN A CONTINUOUS LINE THAT RUNS PARALLEL TO THE AXIS OF THE PIPE AND THAT IS LOCATED ALONG THE TOP OF THE PIPE; FOR PIPE WITH AN INTERNAL DIAMETER OR 24"OR GREATER. TAPE OR PAINT WILL BE APPLIED IN CONTINUOUS LINES ALONG EACH SIDE OF THE PIPE AS WELL AS ALONG THE TOP OF THE PIPE. ABOVEGROUND PIPE WILL BE PAINTED BLUE OR WILL BE COLOR CODED OR MARKED LIKE UNDERGROUND PIP
- ALL WATER MAINS ARE DESIGNED FOR A MINIMUM WORKING PRESSURE OF 150 PSI, HAVE COMPRESSION TYPE BELL JOINTS AND BE EITHER ANSI/AWWA C-151/A21.51-02 DUCTILE IRON PIPE (D.I.P.), CLASS 50 FOR 6"DIAMETER PIPE AND LARGER AND CLASS 51 IF PIPE DIAMETER IS SMALLER THAN 6"OR ANSI/AWWA C-900-97. PVC PIPE WITH A MAXIMUM SDR OF 18. ALL D.I.P. WATER MAINS SHALL BE CEMENT LINED AND SEAL COATED IN ACCORDANCE WITH ANSI/AWWA STANDARDS. ALL D.I.P. FORCE MAINS SHALL BE COATED OUTSIDE WITH A BITUMINOUS COATING APPROXIMATELY ONE MIL THICK IN APPLICATION. ALL D.I.P. FORCE MAINS AND GRAVITY SEWER MAINS SHALL BE COATED INSIDE WITH POLYBOND VIRGIN POLYETHYLENE COMPLYING WITH A.S.T.M. DESIGNATION D 1248 AND HAVE A MINIMUM "N" VALUE OF 0.012. SEE PROJECT SPECIFICATIONS MANUAL FOR MORE DETAILS. OR PROTECTOR 401 CEREMIC EPOXY. ALL D.I.P. PIPE SHALL BE LAID WITH A MINIMUM OF 30"CLEAR COVER. ALL PVC PIPE SHALL BE LAID WITH A MINIMUM OF 36"CLEAR COVER.
- NEW OR RELOCATED, UNDERGROUND WATER MAINS INCLUDED IN THIS PROJECT WILL BE LAID TO PROVIDE A HORIZONTAL DISTANCE OF AT LEAST THREE FEET BETWEEN THE OUTSIDE OF THE WATER MAIN AND THE OUTSIDE OF ANY EXISTING OR PROPOSED VACUUM-TYPE SANITARY SEWER, STORM SEWER, STORMWATER FORCE MAIN, OR PIPELINE CONVEYING RECLAIMED WATER; A HORIZONTAL DISTANCE OF AT LEAST SIX FEET BETWEEN THE OUTSIDE OF THE WATER MAIN AND THE OUTSIDE OF ANY EXISTING OR PROPOSED GRAVITY-TYPE SANITARY SEWER(OR A HORIZONTAL DISTANCE OF AT LEAST THREE FEET BETWEEN THE OUTSIDE OF THE WATER MAIN AND THE OUTSIDE OF ANY EXISTING OR PROPOSED GRAVITY-TYPE SANITARY SEWER IF THE BOTTOM OF THE WATER MAIN WILL BE LAID AT LEAST SIX INCHES ABOVE THE TOP OF THE SEWER); A HORIZONTAL DISTANCE OF AT LEAST SIX FEET BETWEEN THE OUTSIDE OF THE WATER MAIN AND THE OUTSIDE OF ANY EXISTING OR PROPOSED PRESSURE-TYPE SANITARY SEWER, WASTEWATER FORCE MAIN, OR PIPELINE CONVEYING RECLAIMED WATER.
- 15. NEW OR RELOCATED, UNDERGROUND WATER MAINS INCLUDED IN THIS PROJECT THAT WILL CROSS ANY EXISTING OR PROPOSED GRAVITY- OR VACUUM-TYPE SANITARY SEWER OR STORM SEWER WILL BE LAID SO THE OUTSIDE OF THE WATER MAIN IS AT LEAST SIX INCHES ABOVE THE OTHER PIPELINE OR AT LEAST 12 INCHES BELOW THE OTHER PIPELINE; NEW OR RELOCATED, UNDERGROUND WATER MAINS INCLUDED IN THIS PROJECT THAT. WILL CROSS ANY EXISTING OR PROPOSED PRESSURE-TYPE SANITARY SEWER, WASTEWATER OR STORMWATER FORCE MAIN, OR PIPELINE CONVEYING RECLAIMED WATER WILL BE LAID SO THE OUTSIDE OF THE WATER MAIN IS AT LEAST 12 INCHES ABOVE OR BELOW THE OTHER
- 16. THE WATER SYSTEM SHALL BE CLEANED OF DEBRIS, FLUSHED AND TESTED FOR A PERIOD OF NOT LESS THAN 2 HOURS AT A MINIMUM STARTING PRESSURE OF 150 PSI WITH AN ALLOWABLE LEAKAGE NOT TO EXCEED THE ALLOWABLE GAL/HR IN ACCORDANCE WITH THE ANSI/AWWA C-600-05 STANDARD SECTION

(EQUATION L = $SD\sqrt{P}$)

- L = ALLOWABLE LEAKAGE, GALLONS/HOUR S = LENGTH OF PIPE TESTED. FEET D = NOMINAL DIAMETER, INCHES
- P = AVERAGE TEST PRESSURE, LB/IN GAUGE
- 17. AFTER THE PRESSURE TEST, THE SYSTEM SHALL BE DISINFECTED. DISINFECTION SHALL BE IN ACCORDANCE W/ANSI/AWWA C651-05 STD. BACTERIOLOGICAL TESTS SHALL BE TAKEN TWO (2) CONSECUTIVE DAYS, AT LEAST 24 HOURS APART AND SHALL BE AT LEAST ONE SAMPLE PER 1,200 FEET OF MAIN IN THE SYSTEM. THE SAMPLE SHALL HAVE A HETEROTROPHIC PLATE COUNT (HPC) LESS THAN 500 CFU/ML AND SHALL BE FREE OF COLIFORM
- 18. AT THE TIME OF BACTERIOLOGICAL SAMPLING, CHLORINE RESIDUAL DETERMINATION SHALL BE MADE TO INSURE THAT CHLORINE CONCENTRATION IN THE MAIN IS NO HIGHER THAN THAT GENERALLY IN THE SYSTEM (4.0 MG/L FREE OR 4.0 MG/L COMBINED MAXIMUM), OR LESS THAN 0.2 MG/L FREE OR 0.6 MG/L COMBINED. THE RESULT SHALL BE REPORTED ALONG WITH THE BACTERIOLOGICAL TEST RESULTS. ALL TESTING SHALL BE COORDINATED AND PAID FOR BY THE CONTRACTOR.

INTERRUPTION OF EXISTING UTILITIES

ANY CONSTRUCTION WORK THAT REQUIRES INTERRUPTION OF SERVICE TO ANY CUSTOMER SHALL BE DONE SO WITH A MINIMUM OF SEVENTY-TWO (72) HOUR NOTICE TO, AND WRITTEN APPROVAL BY THE APPROPRIATE UTILITY COMPANY. THE CONTRACTOR SHALL ARRANGE A MEETING WITH THE LOCAL JURISDICTIONAL AGENCIES AND OTHER GOVERNING AGENCIES, AND OTHER AFFECTED UTILITIES PRIOR TO SCHEDULING THE SHUTDOWN TO ASSESS THE SCOPE OF WORK. ALL SYSTEM SHUT DOWNS SHALL BE SCHEDULED BY THE CONTRACTOR AT SUCH TIME THAT SYSTEM DEMAND IS LOW. THIS GENERALLY REQUIRES NIGHT TIME WORK BY THE CONTRACTOR AND REQUIRES FULL TIME INSPECTION BY A REPRESENTATIVE OF THE UTILITY. ALL COST FOR OVERTIME WORK BY THE REPRESENTATIVE OF THE UTILITY SHALL BE BORNE BY THE CONTRACTOR, EACH CUSTOMER AFFECTED BY THE SHUT DOWN SHALL BE PROVIDED, MINIMUM, FORTY-EIGHT (48) HOURS WRITTEN NOTIFICATION BY THE CONTRACTOR.

EROSION CONTROL NOTES

- THE STORM WATER POLLUTION PREVENTION PLAN ("SWPPP") IS COMPRISED OF THIS EROSION AND SEDIMENTATION CONTROL PLAN, THE STANDARD DETAILS, AND ALL SUBSEQUENT REPORTS AND RELATED DOCUMENTS PROVIDED BY THE CONTRACTOR
- ALL CONTRACTORS AND SUBCONTRACTORS INVOLVED WITH STORM WATER POLLUTION PREVENTION SHALL OBTAIN A COPY OF THE STORM WATER POLLUTION PREVENTION PLAN AND THE STATE OF FLORIDA NATIONAL POLLUTANT DISCHARGE ELIMINATION SYSTEM GENERAL PERMIT (NPDES PERMIT) AND BECOME FAMILIAR WITH THEIR CONTENTS.
- THE CONTRACTOR SHALL IMPLEMENT BEST MANAGEMENT PRACTICES AS REQUIRED BY THI SWPPP. ADDITIONAL BEST MANAGEMENT PRACTICES SHALL BE IMPLEMENTED AS DICTATED BY CONDITIONS AT NO ADDITIONAL COST TO THE OWNER THROUGHOUT ALL PHASES OF
- BEST MANAGEMENT PRACTICES (BMP'S) AND CONTROLS SHALL CONFORM TO FEDERAL. STATE, OR LOCAL REQUIREMENTS OR MANUAL OF PRACTICE, AS APPLICABLE. THE CONTRACTOR SHALL IMPLEMENT ADDITIONAL CONTROLS AS DIRECTED BY THE PERMITTING
- EROSION AND SEDIMENTATION CONTROL PLAN MUST CLEARLY DELINEATE ALL STATE WATERS. PERMITS FOR ANY CONSTRUCTION ACTIVITY IMPACTING STATE WATERS OR REGULATED WETLANDS MUST BE MAINTAINED ON SITE AT ALL TIMES.
- THE CONTRACTOR SHALL MINIMIZE CLEARING TO THE MAXIMUM EXTENT PRACTICAL OR AS REQUIRED BY THE GENERAL PERMIT. CONTRACTOR SHALL DENOTE ON PLAN THE TEMPORARY PARKING AND STORAGE AREA WHICH SHALL ALSO BE USED AS THE EQUIPMENT MAINTENANCE AND CLEANING AREA.
- EMPLOYEE PARKING AREA, AND AREA FOR LOCATING PORTABLE FACILITIES, OFFICE ALL WASH WATER (CONCRETE TRUCKS, VEHICLE CLEANING, EQUIPMENT CLEANING, ETC.)
- SHALL BE DETAINED AND PROPERLY TREATED OR DISPOSED. SUFFICIENT OIL AND GREASE ABSORBING MATERIALS AND FLOTATION BOOMS SHALL BE MAINTAINED ON SITE OR READILY AVAILABLE TO CONTAIN AND CLEAN-UP FUEL OR
- . RUBBISH, TRASH, GARBAGE, LITTER, OR OTHER SUCH MATERIALS SHALL BE DEPOSITED INTO 7. CHANGES MADE BY CHANGE ORDER OR CONSTRUCTION CHANGE DIRECTIVE. SEALED CONTAINERS. MATERIALS SHALL BE PREVENTED FROM LEAVING THE PREMISES THROUGH THE ACTION OF WIND OR STORM WATER DISCHARGE INTO DRAINAGE DITCHES OR
- 11. ALL STORM WATER POLLUTION PREVENTION MEASURES PRESENTED ON THE PLAN, SHALL BE INITIATED AS SOON AS PRACTICABLE.
- MORE THAN 7 DAYS WHERE CONSTRUCTION HAS TEMPORARILY OR PERMANENTLY CEASED. 13. DISTURBED PORTIONS OF THE SITE WHERE CONSTRUCTION ACTIVITY HAS PERMANENTLY
- STOPPED SHALL BE PERMANENTLY STABILIZED. THESE AREAS SHALL BE STABILIZED NO LATER THAN 7 DAYS AFTER THE LAST CONSTRUCTION ACTIVITY OCCURRED. 14. IF THE ACTION OF VEHICLES TRAVELING OVER THE GRAVEL CONSTRUCTION ENTRANCES IS NOT SUFFICIENT TO REMOVE THE MAJORITY OF DIRT OR MUD, THEN THE TIRES MUST BE WASHED BEFORE THE VEHICLES ENTER A PUBLIC ROAD. IF WASHING IS USED, PROVISIONS
- 15. ALL MATERIALS SPILLED, DROPPED, WASHED, OR TRACKED FROM VEHICLES ONTO ROADWAYS OR INTO STORM DRAINS MUST BE REMOVED AS SOON AS POSSIBLE.

MUST BE MADE TO INTERCEPT THE WASH WATER AND TRAP THE SEDIMENT BEFORE IT IS

- 16. THE CONTRACTOR SHALL BE RESPONSIBLE FOR REMOVING SEDIMENT IN THE DETENTION POND AND ANY SEDIMENT THAT MAY HAVE COLLECTED IN THE STORM SEWER DRAINAGE SYSTEMS IN CONJUNCTION WITH THE STABILIZATION OF THE SITE.
- 17. ON-SITE & OFF-SITE SOIL STOCKPILE AND BORROW AREAS SHALL BE PROTECTED FROM EROSION AND SEDIMENTATION THROUGH IMPLEMENTATION OF BEST MANAGEMENT PRACTICES. STOCKPILE AND BORROW AREA LOCATIONS SHALL BE NOTED ON THE EROSION AND SEDIMENTATION CONTROL PLAN AND PERMITTED IN ACCORDANCE WITH GENERAL PERMIT
- REDUCE RUNOFF VELOCITIES AND EROSION.
- 19. DUE TO GRADE CHANGES DURING THE DEVELOPMENT OF THE PROJECT, THE CONTRACTOR SHALL BE RESPONSIBLE FOR ADJUSTING THE EROSION CONTROL MEASURES AS NECESSARY AS CONSTRUCTION PROGRESSES (SILT FENCES, ETC.) TO PREVENT EROSION
- 20. ALL CONSTRUCTION SHALL BE STABILIZED AT THE END OF EACH WORKING DAY, INCLUDES BACK FILLING OF TRENCHES FOR UTILITY CONSTRUCTION AND PLACEMENT OF
- EROSION AND SEDIMENTATION CONTROL PLANS PROVIDED HEREIN ARE A GUIDELINE ONLY. THE CONTRACTOR IS RESPONSIBLE FOR PREPARING THE FINAL STORM WATER POLLUTION PREVENTION PLAN. THE PLAN SHALL BE SUBMITTED TO THE OWNER AND ENGINEER WHICH DEMONSTRATES THE MECHANISMS AND PRACTICES THAT WILL RE FA THE CONSTRUCTION SITE AND SURROUNDING AREA DURING CONSTRUCTION. THE PLAN SHALL BE CONSISTENT WITH FEDERAL NATIONAL POLLUTANT DISCHARGE ELIMINATION SYSTEM (NPDES PERMIT REQUIREMENTS PERTAINING TO POLLUTION PREVENTION PLANS. THE PLAN SHALL INCLUDE, BUT NOT BE LIMITED TO, THE LOCATIONS OF SILT BARRIERS, TURBIDITY SCREENS OR TEMPORARY SHEETING, EMERGENCY RESPONSE PRACTICES, AND OTHER METHODS TO PREVENT POLLUTION. REFUELING OR STORAGE OF VEHICLES OR EQUIPMENT THAT UTILIZE PETROLEUM BASED PRODUCTS SHALL BE PROHIBITED ANYWHERE WITHIN 50 FEET OF A WATER'S EDGE. THE PLAN SHALL BE SUBMITTED TO THE OWNER AFTER NOTICE OF AWARD AND PRIOR TO NOTICE TO PROCEED. AFTER REVIEW BY OWNER HE PLAN SHALL BE FILED WITH ALL APPLICABLE REGULATORY AGENCIES BY THE CONTRACTOR. REFER TO FURTHER NOTES AND DETAILS WITHIN THESE DOCUMENTS.
- 22. SILT FENCE IS REQUIRED AS SHOWN ON THE PLANS AND ANYWHERE ADDITIONAL AS REQUIRED BY CONSTRUCTION. SILT FENCE IS NOT APPLICABLE IN PAVEMENT AREAS. LIMITS OF CONSTRUCTION SHOWN ARE DIAGRAMATIC. CONTRACTOR TO PROVIDE PLAN FOR SHOP
- 23. THE CONTRACTOR SHALL BE RESPONSIBLE FOR THE CONTROL OF DUST AND DIRT RISING AND SCATTERING IN THE AIR DURING CONSTRUCTION AND SHALL PROVIDE WATER SPRINKLING OR OTHER SUITABLE METHODS OF CONTROL. THE USE OF MOTOR OILS AND OTHER PETROLEUM BASED OR TOXIC LIQUIDS FOR DUST SUPPRESSION OPERATIONS IS PROHIBITED. THE CONTRACTOR SHALL COMPLY WITH ALL GOVERNING REGULATIONS PERTAINING TO ENVIRONMENTAL PROTECTION.

MAINTENANCE

- ALL MEASURES STATED ON THE EROSION AND SEDIMENT CONTROL PLAN. AND IN THE STORM WATER POLLUTION PREVENTION PLAN, SHALL BE MAINTAINED IN FULLY FUNCTIONAL CONDITION UNTIL NO LONGER REQUIRED FOR A COMPLETED PHASE OF WORK OR FINAL STABILIZATION OF THE SITE. ALL EROSION AND SEDIMENTATION CONTROL MEASURES. SHALL BE CHECKED BY A QUALIFIED PERSON AT LEAST ONCE EVERY SEVEN CALENDAR DAYS AND WITHIN 24 HOURS OF THE END OF A 0.5" RAINFALL EVENT, AND CLEANED AND REPAIRED IN ACCORDANCE WITH THE FOLLOWING:
- INLET PROTECTION DEVICES AND BARRIERS SHALL BE REPAIRED OR REPLACED IF THEY HOW SIGNS OF UNDERMINING, OR DETERIORATION. INLET PROTECTION DEVICES SHALL BE CLEANED OUT AT REGULAR INTERVALS OR AS THEY BECOME FULL OF DEBRIS
- ALL SEEDED AREAS SHALL BE CHECKED REGULARLY TO SEE THAT A GOOD STAND IS MAINTAINED. AREAS SHOULD BE FERTILIZED, WATERED AND RESEEDED AS NEEDED.
- SHALL BE REMOVED FROM THE SILT FENCES WHEN IT REACHES ONE-HALF THE HEIGHT OF CONTROL DEVICES (MUTCD) SHALL BE STRICTLY OBSERVED.

THE CONSTRUCTION ENTRANCES SHALL BE MAINTAINED IN A CONDITION WHICH WILL

- PREVENT TRACKING OR FLOW OF MUD ONTO PUBLIC RIGHTS-OF-WAY. THIS MAY REQUIRE PERIODIC TOP DRESSING OF THE CONSTRUCTION ENTRANCES AS CONDITIONS DEMAND.
- ALL MAINTENANCE OPERATIONS SHALL BE DONE IN A TIMELY MANNER BUT IN NO CASE LATER THAN 2 CALENDAR DAYS FOLLOWING THE INSPECTION.

DEMOLITION NOTES

- 1. ALL MATERIAL REMOVED FROM THIS SITE BY THE CONTRACTOR SHALL BE DISPOSED OF BY THE CONTRACTOR IN A LEGAL MANNER.
- REFER TO THE TOPOGRAPHIC SURVEY FOR ADDITIONAL DETAILS OF EXISTING STRUCTURES, ETC., LOCATED WITHIN THE PROJECT SITE. UNLESS OTHERWISE NOTED, ALL EXISTING BUILDINGS, STRUCTURES, SLABS, CONCRETE, ASPHALT, DEBRIS PILES, SIGNS, AND ALL APPURTENANCES ARE TO BE REMOVED FROM THE SITE BY THE CONTRACTOR AND PROPERLY DISPOSED OF IN A LEGAL MANNER AS PART OF THIS CONTRACT. SOME ITEMS TO BE REMOVED MAY NOT BE DEPICTED ON THE TOPOGRAPHIC SURVEY. IT IS THE CONTRACTOR'S RESPONSIBILITY TO VISIT THE SITE AND DETERMINE THE FULL EXTENT OF TEMS TO BE REMOVED. IF ANY ITEMS ARE IN QUESTION, THE CONTRACTOR SHALL CONTACT THE OWNER PRIOR TO REMOVAL OF SAID ITEMS.
- 3. THE CONTRACTOR SHALL REFER TO THE DEMOLITION PLAN AND LANDSCAPE PLAN FOR DEMOLITION/PRESERVATION OF EXISTING TREES. ALL TREES NOT SPECIFICALLY SHOWN TO BE REMOVED OR RELOCATED SHALL BE PRESERVED AS A PART OF THIS CONTRACT. TREE PROTECTION FENCING SHALL BE INSTALLED PRIOR TO ANY DEMOLITION. CONTRACTOR TO SEE LANDSCAPE PLAN FOR TREE PROTECTION REQUIREMENTS. ALL TREES TO REMAIN UNLESS OTHERWISE NOTED. CONTRACTOR TO NOTE EXISTING TREES TO REMAIN. SHOULD ANY TREE TO BE REMAIN BE DAMAGED BY THE CONTRACTOR, IT WILL REQUIRE REPLACEMENT IN KIND.

MINIMUM REQUIRED AS-BUILT INFORMATION

- ALL AS—BUILT INFORMATION SUBMITTED TO THE ENGINEER SHALL BE SUFFICIENTLY ACCURATE, CLEAR, AND LEGIBLE TO SATISFY THE ENGINEER THAT THE INFORMATION PROVIDES A TRUE REPRESENTATION OF THE IMPROVEMENTS CONSTRUCTED.
- A. TOP ELEVATION OF EACH MANHOLE FRAME AND COVER / GRATE AS WELL ALL OTHER 2. ALL UNPAVED AREAS DISTURBED BY CONSTRUCTION SHALL BE REGRADED AND SODDED, STRUCTURES (HEADWALLS, CONTROL STRUCTURES, ETC.).
- B. INVERT ELEVATION OF EACH LINE ENTERING AND LEAVING EACH STRUCTURE, INCLUDING 3. TRAFFIC CONTROL ON ALL FDOT, LOCAL AND COUNTY RIGHTS-OF-WAY SHALL MEET THE UNDERDRAIN PIPES.
- C. INVERTS OF ALL MITERED END SECTIONS
- D. ACTUAL GRADE OF PIPE BETWEEN THE STRUCTURES
- INVERT ELEVATION AND TWO HORIZONTAL TIES FROM PERMANENT VISIBLE OBJECTS TO ALL STORM STUB-OUTS.
- CONTRACTOR SHALL PROVIDE ACCURATE AS-BUILT DIMENSIONS AND ELEVATIONS OF THE STORM WATER MANAGEMENT AREAS IMMEDIATELY AFTER FINAL GRADING AND PRIOR TO SEEDING OR SODDING OF THE SLOPES. AT A MINIMUM, THE CONTRACTOR SHALL PROVIDE CROSS SECTIONS ON ALL SIDES OF THE WATER MANAGEMENT AREAS AT 100-FOOT INTERVALS. THE CROSS SECTIONS SHALL BE PROVIDED FROM TOP OF BANK TO THE SLOPE BREAK BELOW CONTROL ELEVATION THE ENGINEER'S APPROVAL IS REQUIRED PRIOR TO GRASSING OF THE BANK. IF ANY MODIFICATIONS ARE SPECIFIED,
- ADDITIONAL AS-BUILTS MAY BE REQUIRED. 3. LOCATIONS AND DEPTHS OF UNDERGROUND UTILITIES.
- 4. REVISIONS TO ROUTING OF PIPING AND CONDUITS.
- REVISIONS TO ELECTRICAL CIRCUITRY.

100-FOOT INTERVALS MUST BE PROVIDED.

- 6. ACTUAL EQUIPMENT LOCATIONS.
- 8. CHANGES MADE FOLLOWING ENGINEER'S WRITTEN ORDERS.
- 9. DETAILS NOT ON THE ORIGINAL CONTRACT DRAWINGS.
- 10. FIELD RECORDS FOR VARIABLE AND CONCEALED CONDITIONS. 12. STABILIZATION PRACTICES SHOULD BE INITIATED AS SOON AS PRACTICAL, BUT IN NO CASE 11. ALL SLEEVES, FITTINGS, TEES, BENDS, VALVES, ETC. SHALL BE LOCATED BY NORTHING AND EASTING (OR METHOD APPROVED BY ENGINEER) AND ELEVATION OF TOP OF PIPE FOR ALL
 - 12. RECORD DRAWINGS SHALL INDICATE AS-BUILT DATA FOR EVERY ELEVATION SHOWN ON THE

CONSTRUCTED SLEEVING. AS-BUILTS FOR ALL SLEEVING DEPICTING TOP OF PIPE AT

- 13. IF A NEW BENCHMARK LOCATION IS ESTABLISHED, CONTRACTOR SHALL PROVIDE A BENCH LOOP CLOSURE TO THE CLOSEST EXISTING BENCHMARKS IN BOTH DIRECTIONS. ALL BENCHMARK DATA SHALL BE SUBMITTED BY A REGISTERED LAND SURVEYOR.
- 14. IDENTIFICATION OF ADDENDUM ITEMS ISSUED DURING BIDDING PERIOD.
- 15. THE CONTRACTOR IS RESPONSIBLE FOR ENSURING THAT ALL AS-BUILT DATA FOR UTILITIES AND SLEEVING IS COLLECTED PRIOR TO PAVEMENT SECTION CONSTRUCTION. PRELIMINARY UTILITY AS-BUILTS MUST BE PROVIDED TO THE ENGINEER FOR REVIEW PRIOR TO PAVEMENT SECTION CONSTRUCTION.

16. PRESSURE SYSTEMS (WATER):

- A. ACTUAL LENGTHS BETWEEN BRANCHES AND VALVES ALONG THE MAIN RUN.
- B. TOP OF PIPE AND FINISHED GRADE ELEVATIONS AT 100' INTERVALS.
- C. LOCATE WITH MEASUREMENTS FROM PERMANENT VISIBLE OBJECTS ALL
- FITTINGS/ACCESSORIES NOT VISIBLE FROM THE SURFACE (MINIMUM TWO POINT TIES). D. AS-BUILT INFORMATION SUBMITTED TO THE ENGINEER SHALL BE SUFFICIENTLY ACCURATE, CLEAR AND LEGIBLE TO SATISFY THE ENGINEER THAT THE INFORMATION PROVIDES A TRUE REPRESENTATION OF THE IMPROVEMENTS CONSTRUCTED.
- ALL AS-BUILT INFORMATION SUBMITTED TO THE ENGINEER SHALL BE SUFFICIENTLY ACCURATE, CLEAR AND LEGIBLE TO SATISFY THE ENGINEER THAT THE INFORMATION PROVIDES A TRUE REPRESENTATION OF THE IMPROVEMENTS CONSTRUCTED.
- UPON COMPLETION OF CONSTRUCTION, THE CONTRACTOR SHALL SUBMIT TO THE ENGINEER OF RECORD COMPLETE SETS OF AS-BUILT CONSTRUCTION DRAWINGS AS REQUIRED FOR SUBMITTAL AND APPROVAL. THESE DRAWINGS SHALL BE MARKED TO SHOW "AS-BUILT" CONSTRUCTION CHANGES AND DIMENSIONED LOCATIONS AND ELEVATIONS OF ALL IMPROVEMENTS AND SHALL BE SIGNED AND SEALED BY A FLORIDA REGISTERED LAND SURVEYOR.
- ALL OTHER REQUIRED PRESSURE PIPE INFORMATION IN ACCORDANCE WITH THE AS-BUILT REQUIREMENTS OF PALM BEACH COUNTY.
- UTILITY CROSSING SEPARATION INFORMATION FOR THAT PROVIDED ON THE PLANS
- A. SIZE AND MATERIAL OF CROSSING PIPES B. TOP ELEVATION OF BOTTOM PIPE
- C. BOTTOM ELEVATION OF TOP PIPE
- D. FINISH SURFACE ELEVATION OVER UTILITY CROSSING

PRECONSTRUCTION RESPONSIBILITIES

- UPON RECEIPT OF NOTICE OF AWARD, THE CONTRACTOR SHALL ARRANGE A PRECONSTRUCTION CONFERENCE TO INCLUDE ALL INVOLVED GOVERNMENTAL AGENCIES,
- 2. THE CONTRACTOR SHALL CONTACT "SUNSHINE STATE ONE CALL OF FLORIDA, INC. (811)" AT LEAST 2 WORKING DAYS PRIOR TO BEGINNING ANY EXCAVATION.

ALL AFFECTED UTILITY OWNERS, THE OWNER, THE ENGINEER AND ITSELF.

- 3. PRIOR TO BEGINNING CONSTRUCTION, THE CONTRACTOR SHALL VERIFY THE SIZE, LOCATION, ELEVATION, AND MATERIAL OF ALL EXISTING UTILITIES WITHIN THE AREA OF
- EXISTING UTILITY LOCATIONS SHOWN ON THESE PLANS ARE APPROXIMATE. THE ENGINEER 4. ALL EXISITNG PBCWUD FACILITIES (IE. VALVES) TO BE OPERATED BY PBCWUD PERSONNEL ASSUMES NO RESPONSIBILITY FOR THE ACCURACY OF EXISTING UTILITIES SHOWN OR FOR ANY EXISTING UTILITIES NOT SHOWN.
- 5. IF UPON EXCAVATION, AN EXISTING UTILITY IS FOUND TO BE IN CONFLICT WITH THE PROPOSED CONSTRUCTION OR TO BE OF A SIZE OR MATERIAL DIFFERENT FROM THAT SHOWN ON THE PLANS; THE CONTRACTOR SHALL IMMEDIATELY NOTIFY THE ENGINEER.
- CONSTRUCTION SAFETY

 ALL CONSTRUCTION SHALL BE DONE IN A SAFE MANNER, SPECIFICALLY, THE RULES AND ALL CONSTRUCTION SHALL BE DONE IN A SAFE MANNER, SPECIFICALLY, THE RULES AND IF ANY NEW LANDSCAPE MATERIALS ARE INSTALLED AS PART OF THIS PROJECT THEN SOD IF ANY NEW LANDSCAPE MATERIALS ARE INSTALLED AS PART OF THIS PROJECT THEN SOD SILT FENCES SHALL BE REPAIRED TO THEIR ORIGINAL CONDITIONS IF DAMAGED. SEDIMENT FLORIDA DEPARTMENT OF TRANSPORTATION (FDOT) AND THE MANUAL OF UNIFORM TRAFFIC

- THE CONTRACTOR SHALL PROTECT ALL PERMANENT REFERENCE MONUMENTS AND TAKE ALL PRECAUTIONS NECESSARY TO AVOID DAMAGE TO SURVEY MAKERS DURING CONSTRUCTION. ANY SURVEY MARKERS DAMAGED DURING CONSTRUCTION WILL BE
- REPLACED AT THE EXPENSE OF THE CONTRACTOR. 2. BENCHMARK LOCATION AND ELEVATION ARE AS REPRESENTED BY SURVEYOR AT THE TIME OF SURVEY. CONTRACTOR SHALL VERIFY ITS CORRECTNESS AT TIME OF
- 3. ALL ELEVATIONS ON THE PLANS OR REFERENCED IN THE SPECIFICATIONS ARE BASED ON NORTH AMERICAN VERTICAL DATUM OF 1988 (N.A.V.D. 88).

PAVING, GRADING AND DRAINAGE NOTES

TYPICAL PAVEMENT SECTIONS AS INDICATED ON THE DRAWINGS.

- . ALL PAVING, CONSTRUCTION, MATERIALS, AND WORKMANSHIP WITHIN PUBLIC RIGHT-OF-WAY SHALL BE IN ACCORDANCE WITH LOCAL COUNTY OR STATE SPECIFICATIONS AND STANDARDS (LATEST EDITION) OR FDOT SPECIFICATIONS AND STANDARDS (LATEST EDITION) IF NOT COVERED BY LOCAL OR COUNTY REGULATIONS, WHICHEVER IS MOST
- UNLESS OTHERWISE NOTED.
- REQUIREMENTS OF THE MANUAL OF UNIFORM TRAFFIC CONTROL DEVICES (U.S. DOT/FHA) THE REQUIREMENTS OF THE STATE AND ANY LOCAL AGENCY HAVING JURISDICTION. IN THE EVENT THAT THE CONTRACT DOCUMENTS AND THE JURISDICTIONAL AGENCY REQUIREMENTS ARE NOT IN AGREEMENT, THE MOST STRINGENT SHALL GOVERN.
- 4. THE CONTRACTOR SHALL GRADE THE SITE TO THE ELEVATIONS INDICATED AND SHALL REGRADE WASHOUTS WHERE THEY OCCUR AFTER EVERY RAINFALL UNTIL A GRASS STAND IS WELL ESTABLISHED OR ADEQUATE STABILIZATION OCCURS.
- 5. ALL OPEN AREAS WITHIN THE PROJECT SITE SHALL BE SODDED WITH BAHIA SOD UNLESS INDICATED OTHERWISE ON THE ENGINEERING OR LANDSCAPE PLANS. ALL AREAS INDICATED AS PAVEMENT SHALL BE CONSTRUCTED IN ACCORDANCE WITH THE
- WHERE EXISTING PAVEMENT IS INDICATED TO BE REMOVED AND REPLACED, THE CONTRACTOR SHALL SAW CUT A MINIMUM 2" DEEP FOR A SMOOTH AND STRAIGHT JOINT AND REPLACE THE PAVEMENT WITH THE SAME TYPE AND DEPTH OF MATERIAL AS EXISTING OR AS INDICATED.
- 8. WHERE NEW PAVEMENT MEETS THE EXISTING PAVEMENT. THE CONTRACTOR SHALL SAW CUT THE EXISTING PAVEMENT A MINIMUM 2" DEEP FOR A SMOOTH AND STRAIGHT JOINT AND MATCH THE EXISTING PAVEMENT ELEVATION WITH THE PROPOSED PAVEMENT UNLESS OTHERWISE INDICATED.
- 9. THE CONTRACTOR SHALL INSTALL FILTER FABRIC OVER ALL DRAINAGE STRUCTURES FOR THE DURATION OF CONSTRUCTION AND UNTIL ACCEPTANCE OF THE PROJECT BY THE OWNER. ALL DRAINAGE STRUCTURES AND PIPES WITHIN THE LIMITS OF CONSTRUCTION SHALL BE CLEANED OF DEBRIS AS REQUIRED DURING AND AT THE END OF CONSTRUCTION TO PROVIDE POSITIVE DRAINAGE FLOWS.
- 10. IF DEWATERING IS REQUIRED, THE CONTRACTOR SHALL OBTAIN ANY APPLICABLE REQUIRED PERMITS. THE CONTRACTOR IS TO COORDINATE WITH THE OWNER AND THE ENGINEER PRIOR TO ANY EXCAVATION.
- CONTRACTOR TO STRIP TOPSOIL AND ORGANIC MATTER FROM ALL AREAS OF THE SITE AS REQUIRED. IN SOME CASES TOPSOIL MAY BE STOCKPILED ON SITE FOR PLACEMENT WITHIN LANDSCAPED AREAS BUT ONLY AS DIRECTED BY THE OWNER.
- JURISDICTIONAL AGENCY OR TO FDOT STANDARDS. IN THE EVENT THAT THE CONTRACT DOCUMENTS AND THE JURISDICTIONAL AGENCY REQUIREMENTS ARE NOT IN AGREEMENT, THE MOST STRINGENT SHALL GOVERN. 13. ALL SLOPES AND AREAS DISTURBED BY CONSTRUCTION SHALL BE GRADED AS PER PLANS. THE AREAS SHALL THEN BE SODDED AS SPECIFIED IN THE PLANS, FERTILIZED,

12. FIELD DENSITY TESTS SHALL BE TAKEN AT INTERVALS IN ACCORDANCE WITH THE LOCAL

ACCEPTANCE OF THE JOB SHALL BE CORRECTED BY THE CONTRACTOR AT NO ADDITIONAL COST TO THE OWNER. 14. ALL CUT OR FILL SLOPES SHALL BE 4 (HORIZONTAL) :1 (VERTICAL) OR FLATTER UNLESS

MULCHED, WATERED, AND MAINTAINED UNTIL A GOOD STAND OF GRASS GROWTH IS

ESTABLISHED IN ALL AREAS. ANY AREAS DISTURBED FOR ANY REASON PRIOR TO FINAL

15. THE CONTRACTOR SHALL ENSURE THAT ISLAND PLANTING AREAS AND OTHER PLANTING AREAS ARE NOT COMPACTED AND DO NOT CONTAIN ROAD BASE MATERIALS. THE CONTRACTOR SHALL ALSO EXCAVATE AND REMOVE ALL UNDESIRABLE MATERIAL FROM ALL AREAS ON THE SITE TO BE PLANTED AND PROPERLY DISPOSED OF IN A LEGAL

WUD REQUIRED GENERAL PROJECT NOTES:

OTHERWISE SHOWN.

I. RECORD DRAWINGS SHALL BE PREPARED IN THE STATE PLANE COORDINATE SYSTEM.

- 2. ALL UTILITY FEATURES SHALL BE SHOWN IN THEIR AS-BUILT LOCATION. 3. STATE PLANE COORDINATES SHALL BE DISPLAYED ON RECORD DRAWINGS FOR ALL
- FEATURES SPECIFIED IN PBCWUD STANDARDS. 4. STATE PLANE COORDINATES SHALL BE SHOWN ON PROPERTY CORNERS AS REQUIRED BY
- 5. WATER AND SEWER AS-BUILTS SHALL BE IN ACCORDANCE WITH PBCWUD STANDARDS
- HYDRANT & HYDRANT SECURITY EQUIPMENT NOTES:

 1. FIRE HYDRANT SHALL BE EQUIPPED WITH A SET OF AFC "CAPTIVATER" SECURITY CAPS. THE CAPS SHALL BE CHAINED TO THE HYDRANT BODY AND INSTALLED PRIOR TO ISSUANCE OF "CONSTRUCTION WATER RELEASE" CERTIFICATION, A SCHEDULED INSPECTION
- 2. PLEASE NOTE THAT THE SECURITY CAPS CAN ONLY BE REMOVED USING SPECIAL WRENCHES. THE CONTRACTOR SHALL CONTACT THE PBCWUD INSPECTOR FOR ASSISTANCE IF ACCESS TO THE HYDRANT IS REQUIRED FOR FLUSHING OR TESTING PURPOSES.

BY PBCWUD IS REQUIRED TO VERIFY THE INSTALLATION AND OPERATION OF THE CAPS.

3. ALL FIRE HYDRANTS ARE TO BE INSTALLED SO THE PUMPER NOZZLE IS 5.0' MIN WITH RAISED CURB OR 6.0' MIN WITHOUT RAISED CURB AND 12.0' MAX. FROM THE EDGE OF PAVEMENT.

GENERAL WATER NOTES: I. ALL WATER MAIN DUCTILE IRON PIPE AND PIPE FITTINGS SHALL BE PAINTED WITH A 4" WIDE CONTINOUS BLUE LINE THAT RUNS PARALLEL TO THE AXIS OF THE PIPE AND IS

- LOCATED ALONG THE TOP OF THE PIPE. 2. ALL PVC WATER MAINS SHALL BE MARKED WITH ONE CONTINOUS STRIP OF 6" WIDE MAGNETIC BLUE CODED TAPE IMPRINTED WITH TWO (2) INCH HIGH LETTERING READING "CAUTION - POTABLE WATER LINE BURIED BELOW" AND LOCATED APPROXIMATELY TWELVE (12) INCHES ABOVE THE CROWN OF THE PIPE. THE WORDING SHALL OCCUR EVERY THREE
- 3. ALL WATER SERVICE BRASS FITTINGS ARE REQUIRED TO BE LEAD FREE.
- GENERAL SEWER NOTE:

 1. ON-SITE SEWER LATERALS ARE PRIVATELY OWNED AND MAINTAINED.
- ONLY WITH NO SHRUBS AND/OR TREES ARE TO BE INSTALLED WITHIN 5' OF ANY WATER METER AND WITHIN 7.5' OF ANY FIRE HYDRANT. TREES CANNOT BE INSTALLED WITHIN 10' OF A WUD WATER/GRAVITY/FORCE MAIN WITHOUT PRIOR PBCWUD APPROVAL AND THE INSTALLATION OF A ROOT BARRIER. ALSO IF ANY EXISTING TREES ARE LESS THAN 10' MINIMUM OF ANY NEW WUD MAIN A ROOT BARRIER IS REQUIRED TO BE INSTALLED OR TREE REMOVED/RELOCATED.

2. SEWER CLEANOUT MINI-MANHOLES ARE REQUIRED ON ALL CLEANOUTS WITHIN PAVEMENT

(7)

GRAPHIC SCALE IN FEET

EROSION CONTROL LEGEND

PROPERTY LINE — SF — SF — (SF) SILT FENCE TB TURBIDITY BARRIER —— X —— X —— (CL) TEMPORARY CONSTRUCTION FENCE (FS) FILTER SACK

(CE) CONSTRUCTION ENTRANCE

- EROSION CONTROL NOTES
- 1. SEDIMENT BASINS AND TRAPS, PERIMETER DIKES, SEDIMENT BARRIERS AND OTHER MEASURES INTENDED TO TRAP SEDIMENT SHALL BE CONSTRUCTED AS A FIRST STEP IN ANY LAND DISTURBING ACTIVITY AND SHALL BE MADE FUNCTIONAL BEFORE UP-SLOPE LAND DISTURBANCE TAKES PLACE.
- 2. ALL SEDIMENT CONTROL MEASURES ARE TO BE ADJUSTED TO MEET FIELD CONDITIONS AT THE TIME OF CONSTRUCTION AND BE CONSTRUCTED PRIOR TO ANY GRADING OR DISTURBANCE OF EXISTING SURFACE MATERIAL ON BALANCE OF SITE. PERIMETER SEDIMENT BARRIERS SHALL BE CONSTRUCTED TO PREVENT SEDIMENT OR TRASH FROM FLOWING OR FLOATING ON TO ADJACENT PROPERTIES.
- 3. PERMANENT OR TEMPORARY SOIL STABILIZATION SHALL BE APPLIED TO DENUDED AREAS WITHIN SEVEN (7) DAYS AFTER FINAL GRADE IS REACHED ON ANY PORTION OF THE SITE. TEMPORARY SOIL STABILIZATION SHALL BE APPLIED WITHIN SEVEN (7) DAYS TO DENUDED AREAS THAT MAY NOT BE AT FINAL GRADE BUT WILL REMAIN UNDISTURBED FOR LONGER THAN 30 DAYS. PERMANENT STABILIZATION SHALL BE APPLIED TO AREAS THAT ARE TO BE LEFT UNDISTURBED FOR MORE THAN ONE YEAR.
- 4. DURING CONSTRUCTION OF THE PROJECT, SOIL STOCK PILES SHALL BE STABILIZED, COVERED OR CONTAINED WITH SEDIMENT TRAPPING MEASURES. THE APPLICANT IS RESPONSIBLE FOR THE TEMPORARY PROTECTION AND PERMANENT STABILIZATION OF ALL SOIL STOCKPILES ON SITE AS WELL AS SOIL INTENTIONALLY TRANSPORTED FROM THE PROJECT SITE.
- 5. A PERMANENT VEGETATIVE COVER SHALL BE ESTABLISHED ON DENUDED AREAS NOT OTHERWISE PERMANENTLY STABILIZED.
- 6. AFTER ANY SIGNIFICANT RAINFALL, SEDIMENT CONTROL STRUCTURES WILL BE INSPECTED FOR INTEGRITY. ANY DAMAGED DEVICES SHALL BE CORRECTED IMMEDIATELY.
- 7. CONCENTRATED RUNOFF SHALL NOT FLOW DOWN CUT OR FILL SLOPES UNLESS CONTAINED WITHIN AN ADEQUATE TEMPORARY OR PERMANENT CHANNEL, FLUME, SLOPE DRAIN STRUCTURE OR APPROVED CONTROL.
- 8. SEDIMENT WILL BE PREVENTED FROM ENTERING ANY STORM WATER SYSTEM, DITCH OR CHANNEL. ALL STORM WATER INLETS THAT ARE MADE OPERABLE DURING CONSTRUCTION SHALL BE PROTECTED SO THAT SEDIMENT-LADEN WATER CANNOT ENTER THE CONVEYANCE SYSTEM WITHOUT FIRST BEING FILTERED OR OTHERWISE TREATED TO REMOVE SEDIMENT.
- 9. WHEN WORK IN A LIVE WATERCOURSE IS PERFORMED, PRECAUTIONS SHALL BE TAKEN TO MINIMIZE ENCROACHMENT, CONTROL SEDIMENT TRANSPORT AND STABILIZE THE WORK AREA TO THE GREATEST EXTENT POSSIBLE DURING CONSTRUCTION.
- 10. PERIODIC INSPECTION AND MAINTENANCE OF ALL SEDIMENT CONTROL STRUCTURES MUST BE PROVIDED TO ENSURE INTENDED PURPOSE IS ACCOMPLISHED. THE DEVELOPER, OWNER AND/OR CONTRACTOR SHALL BE CONTINUALLY RESPONSIBLE FOR ALL SEDIMENT CONTROLS. SEDIMENT CONTROL MEASURES SHALL BE IN WORKING CONDITION AT THE END OF EACH WORKING DAY.
- 11. WHERE CONSTRUCTION VEHICLE ACCESS ROUTES INTERSECT PAVED PUBLIC ROADS, PROVISIONS SHALL BE MADE TO MINIMIZE THE TRANSPORT OF SEDIMENT BY TRACKING ONTO THE PAVED SURFACE. WHERE SEDIMENT IS TRANSPORTED ONTO A PUBLIC ROAD SURFACE WITH CURBS AND GUTTERS, THE ROAD SHALL BE CLEANED THOROUGHLY AT THE END OF EACH DAY. SEDIMENT SHALL BE REMOVED FROM THE ROADS BY SHOVELING OR SWEEPING AND TRANSPORTED TO A SEDIMENT CONTROL DISPOSAL AREA. STREET WASHING SHALL BE ALLOWED ONLY AFTER SEDIMENT IS REMOVED IN THIS MANNER. THIS PROVISION SHALL APPLY TO INDIVIDUAL SUBDIVISION LOTS AS WELL AS TO LARGER LAND DISTURBING ACTIVITIES.
- 12. ALL TEMPORARY EROSION AND SEDIMENT CONTROL MEASURES SHALL BE REMOVED WITHIN 30 DAYS AFTER FINAL SITE STABILIZATION OR AFTER THE TEMPORARY MEASURES ARE NO LONGER NEEDED.
- 13. PROPERTIES AND WATERWAYS DOWNSTREAM FROM CONSTRUCTION SITES SHALL BE PROTECTED FROM SEDIMENT DEPOSITION AND EROSION AT ALL TIMES DURING
- 14. EROSION CONTROL DESIGN AND CONSTRUCTION SHALL FOLLOW THE REQUIREMENTS IN INDEX NUMBERS 101, 102 AND 103 OF F.D.O.T. ROADWAY AND TRAFFIC DESIGN STANDARDS AND COUNTY PERMITS.
- 15. CONTRACTOR IS RESPONSIBLE FOR ALL SURFACE WATER DISCHARGES, RAINFALL RUN OFF OR DEWATERING ACTIVITIES.
- 16. CONTRACTOR MUST INCORPORATE ALL BMP'S NECESSARY TO MEET OR EXCEED STATE WATER QUALITY AND SWPPP REQUIREMENTS.
- 17. THE POLLUTION PREVENTION PLAN IS A MINIMUM GUIDELINE ONLY. ADDITIONAL BMP'S MAY BE NECESSARY AT CONTRACTOR'S EXPENSE.
- 18. NOI TO BE POSTED ON SITE.
- 19. DEWATERING ACTIVITIES: A. DISCHARGE MUST NOT EXCEED STATE WATER QUALITY STANDARDS. B. CONTRACTOR MUST HAVE A TRANSFERABLE SFWMD DEWATERING PERMIT. C. NO HYDRAULIC PUMPS MAY BE USED FOR DEWATERING UNLESS APPROVED BY THE WATER MANAGEMENT DISTRICT FOR THAT AREA.

- 1. CONTRACTOR TO CONSIDER POTENTIAL DEWATERING ACTIVITIES WHEN PREPARING BID DOCUMENTS FOR THIS PROJECT. 2. CONTRACTOR SHALL OBTAIN ANY NECESSARY DEWATERING PERMITS AS SITE CONDITIONS AND CONSTRUCTION ACTIVITIES REQUIRE.
- 3. CONTRACTOR TO USE B.M.P.'S TO ENSURE COMPLIANCE WITH NPDES AND WATER MANAGEMENT DISTRICT REGULATIONS FOR STORMWATER DISCHARGE FROM CONSTRUCTION ACTIVITIES AND DEWATERING OPERATIONS. 4. THE ESCAPE OF SEDIMENT FROM THE SITE SHALL BE PREVENTED BY THE INSTALLATION
- OF EROSION AND SEDIMENT CONTROL MEASURES AND PRACTICES PRIOR, OR CONCURRENT WITH LAND DISTURBING ACTIVITIES.

PHASING NOTES

- CONTRACTOR MAY PHASE EROSION AND SEDIMENTATION CONTROL MEASURES IN ACCORDANCE WITH SITE CONSTRUCTION PHASING.
- CONTRACTOR SHALL ENSURE THAT THE CONSTRUCTION AREA IS SEPARATED FROM THE AREA NOT UNDER CONSTRUCTION WITH A TEMPORARY CHAIN LINK FENCE AND ENSURE THE SAFETY OF THE PUBLIC.

DEMOLITION LEGEND

PROPERTY LINE —— SS —— SS —— EXIST SANITARY LINE ----- W ----- EXIST WATER ———— STRM ———— EXIST STORM — GAS— GAS— EXIST GAS — TEL — TEL — EXIST TELEPHONE

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— E — E — E — EXIST UNDERGROUND ELECTRICAL

---- OE ----- EXIST OVERHEAD ELECTRIC EXIST LANDSCAPE EXIST LIGHT POLES

EXIST ELEVATION

—— SS —— SS —— EXIST SEWER TO BE DEMOLISHED E E E E E EXIST UNDERGROUND ELEC TO BE DEMOLISHED --- GAS---- EXIST GAS TO BE DEMOLISHED

— TEL — TEL — EXIST TELEPHONE TO BE DEMOLISHED — OE — OE — EXIST OVERHEAD ELECTRIC TO BE DEMOLISHED LIMITS OF DEMOLITION REMOVE EXIST. CONCRETE, ASPHALT, GRASS, GRAVEL AND OTHER IMPROVEMENTS

MILL AND RESURFACE

REMOVE EXISTING ASPHALT

DEMOLITION NOTES

- 1. ANY ITEMS TO REMAIN THAT ARE DAMAGED BY THE CONTRACTOR SHALL BE REPLACED TO THE EXISTING CONDITION OR BETTER AT THE CONTRACTOR'S EXPENSE.
- 2. REFER TO LANDSCAPE PLANS FOR TREE REMOVAL, RELOCATION, AND PROTECTION INFORMATION. ANY AREAS FOR LANDSCAPING SHALL HAVE ALL BASE AND SUBGRADE MATERIAL REMOVED TO A DEPTH
- ALL VALVE BOXES, MANHOLES, CATCH BASINS, AND OTHER ITEMS TO REMAIN SHALL BE ADJUSTED TO PROPOSED GRADE.
 - 4. THE INTENT OF THE DEMOLITION PLAN IS TO DEPICT EXISTING FEATURES THAT ENCUMBER THE PROPOSED CONSTRUCTION AREA AND ARE SCHEDULED FOR REMOVAL. SOME INCIDENTAL ITEMS MAY HAVE BEEN INADVERTENTLY OMITTED FROM THE PLAN. THE CONTRACTOR IS ENCOURAGED TO THOROUGHLY INSPECT THE SITE AS WELL AS REVIEW THE PLANS AND SPECIFICATIONS PRIOR TO SUBMITTING PRICING. CONTRACTOR WILL NOT RECEIVE ADDITIONAL COMPENSATION FOR INCIDENTAL ITEMS NOT SHOWN

ON THIS DEMOLITION PLAN.

- 5. THIS DEMOLITION PLAN IS BASED ON AVAILABLE UTILITY INFORMATION AND MAY OR MAY NOT BE ALL INCLUSIVE FOR THIS SITE. ANY UTILITIES ENCOUNTERED DURING DEMOLITION THAT ARE NOT DEPICTED/ADDRESSED ON THIS DRAWING SHOULD BE BROUGHT TO THE ATTENTION OF THE PROJECT ENGINEER IMMEDIATELY.
- CONTRACTOR IS REQUIRED TO OBTAIN ALL DEMOLITION AND DEWATERING PERMITS, IF APPLICABLE.
- 7. ALL FEATURES IDENTIFIED ON THIS PLAN WHICH ARE LISTED TO BE DEMOLISHED ARE TO BE REMOVED FROM THE SITE AND DISPOSED OF IN A LEGAL MANNER.
- 8. CONTRACTOR SHALL LIMIT ALL DEMOLITION ACTIVITIES TO THOSE AREAS DELINEATED ON THE CONSTRUCTION DRAWINGS UNLESS OTHERWISE DIRECTED BY THE DEVELOPER OR AS REQUIRED FOR CONSTRUCTION OF IMPROVEMENTS.

9. CONTRACTOR IS RESPONSIBLE FOR CONTROLLING

AIRBORNE DUST AND POLLUTANTS BY USING

OF CONTROL.

WATER SPRINKLING OR OTHER SUITABLE MEANS

REPLACE DAMAGED STRUCTURES AT THEIR EXPENSE. 13. CONTRACTOR MUST PROTECT THE PUBLIC AT ALL TIMES WITH FENCING, BARRICADES, ENCLOSURES, ETC. AS APPROVED BY THE TOWN OF PALM

BEACH AND CONSTRUCTION MANAGER.

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11. ALL ASPHALT TO BE REMOVED SHALL BE SAW

12. WHERE REMAINING, INLETS, MANHOLE COVERS,

AND VALVE COVERS TO BE PROTECTED IN

CUT ADJACENT TO REMAINING IMPROVEMENTS.

PAVEMENT REMOVAL AREAS. CONTRACTOR SHALL

ADJOINING ROADWAYS, SIDEWALKS, ETC.

PUBLIC. HAUL ROUTE TO BE CLOSELY MONITORED

ROADWAYS AND WALKWAYS TO BE CLEARED DAILY

OR AS NECESSARY TO MAINTAIN PUBLIC SAFETY.

- 14. CONTINUOUS ACCESS SHALL BE MAINTAINED FOR SURROUNDING PROPERTIES AT ALL TIMES DURING DEMOLITION OF EXISTING FACILITIES AND CONSTRUCTION OF NEW FACILITIES. SIGNAGE SHALL BE POSTED TO DIRECT THE PUBLIC TO THE PATH OF TRAVEL.
- 15. REFER TO THE TOPOGRAPHIC SURVEY FOR ADDITIONAL DETAILS OF EXISTING STRUCTURES, ETC., LOCATED WITHIN THE PROJECT SITE. UNLESS OTHERWISE NOTED, ALL EXISTING BUILDINGS, STRUCTURES, SLABS, CONCRETE, ASPHALT, DEBRIS PILES, SIGNS, AND ALL APPURTENANCES ARE TO BE REMOVED FROM THE SITE BY THE CONTRACTOR AND PROPERLY DISPOSED OF IN A LEGAL MANNER AS PART OF THIS CONTRACT. SOME ITEMS TO BE REMOVED MAY NOT BE DEPICTED ON THE TOPOGRAPHIC SURVEY. IT IS THE CONTRACTOR'S RESPONSIBILITY TO VISIT THE SITE AND DETERMINE THE FULL EXTENT OF ITEMS TO BE REMOVED. IF ANY ITEMS ARE IN QUESTION, THE CONTRACTOR SHALL CONTACT THE OWNER PRIOR TO REMOVAL OF SAID ITEMS.
- 16. ALL TREES NOT SPECIFICALLY SHOWN TO BE PRESERVED OR RELOCATED SHALL BE REMOVED AS A PART OF THIS CONTRACT. TREE PROTECTION FENCING SHALL BE INSTALLED PRIOR TO ANY DEMOLITION.
- 17. CONTRACTOR SHALL COORDINATE THE LIMITS OF UTILITY DEMOLITION WITH PROPOSED PLANS.

LEVATIONS SHOWN HEREON ARE BASED ON THE NORTH AMERICAN VERTICAL DATUM OF 1988. NAVD '88 ELEV. + 1.57' = NGVD '29 ELEVATION

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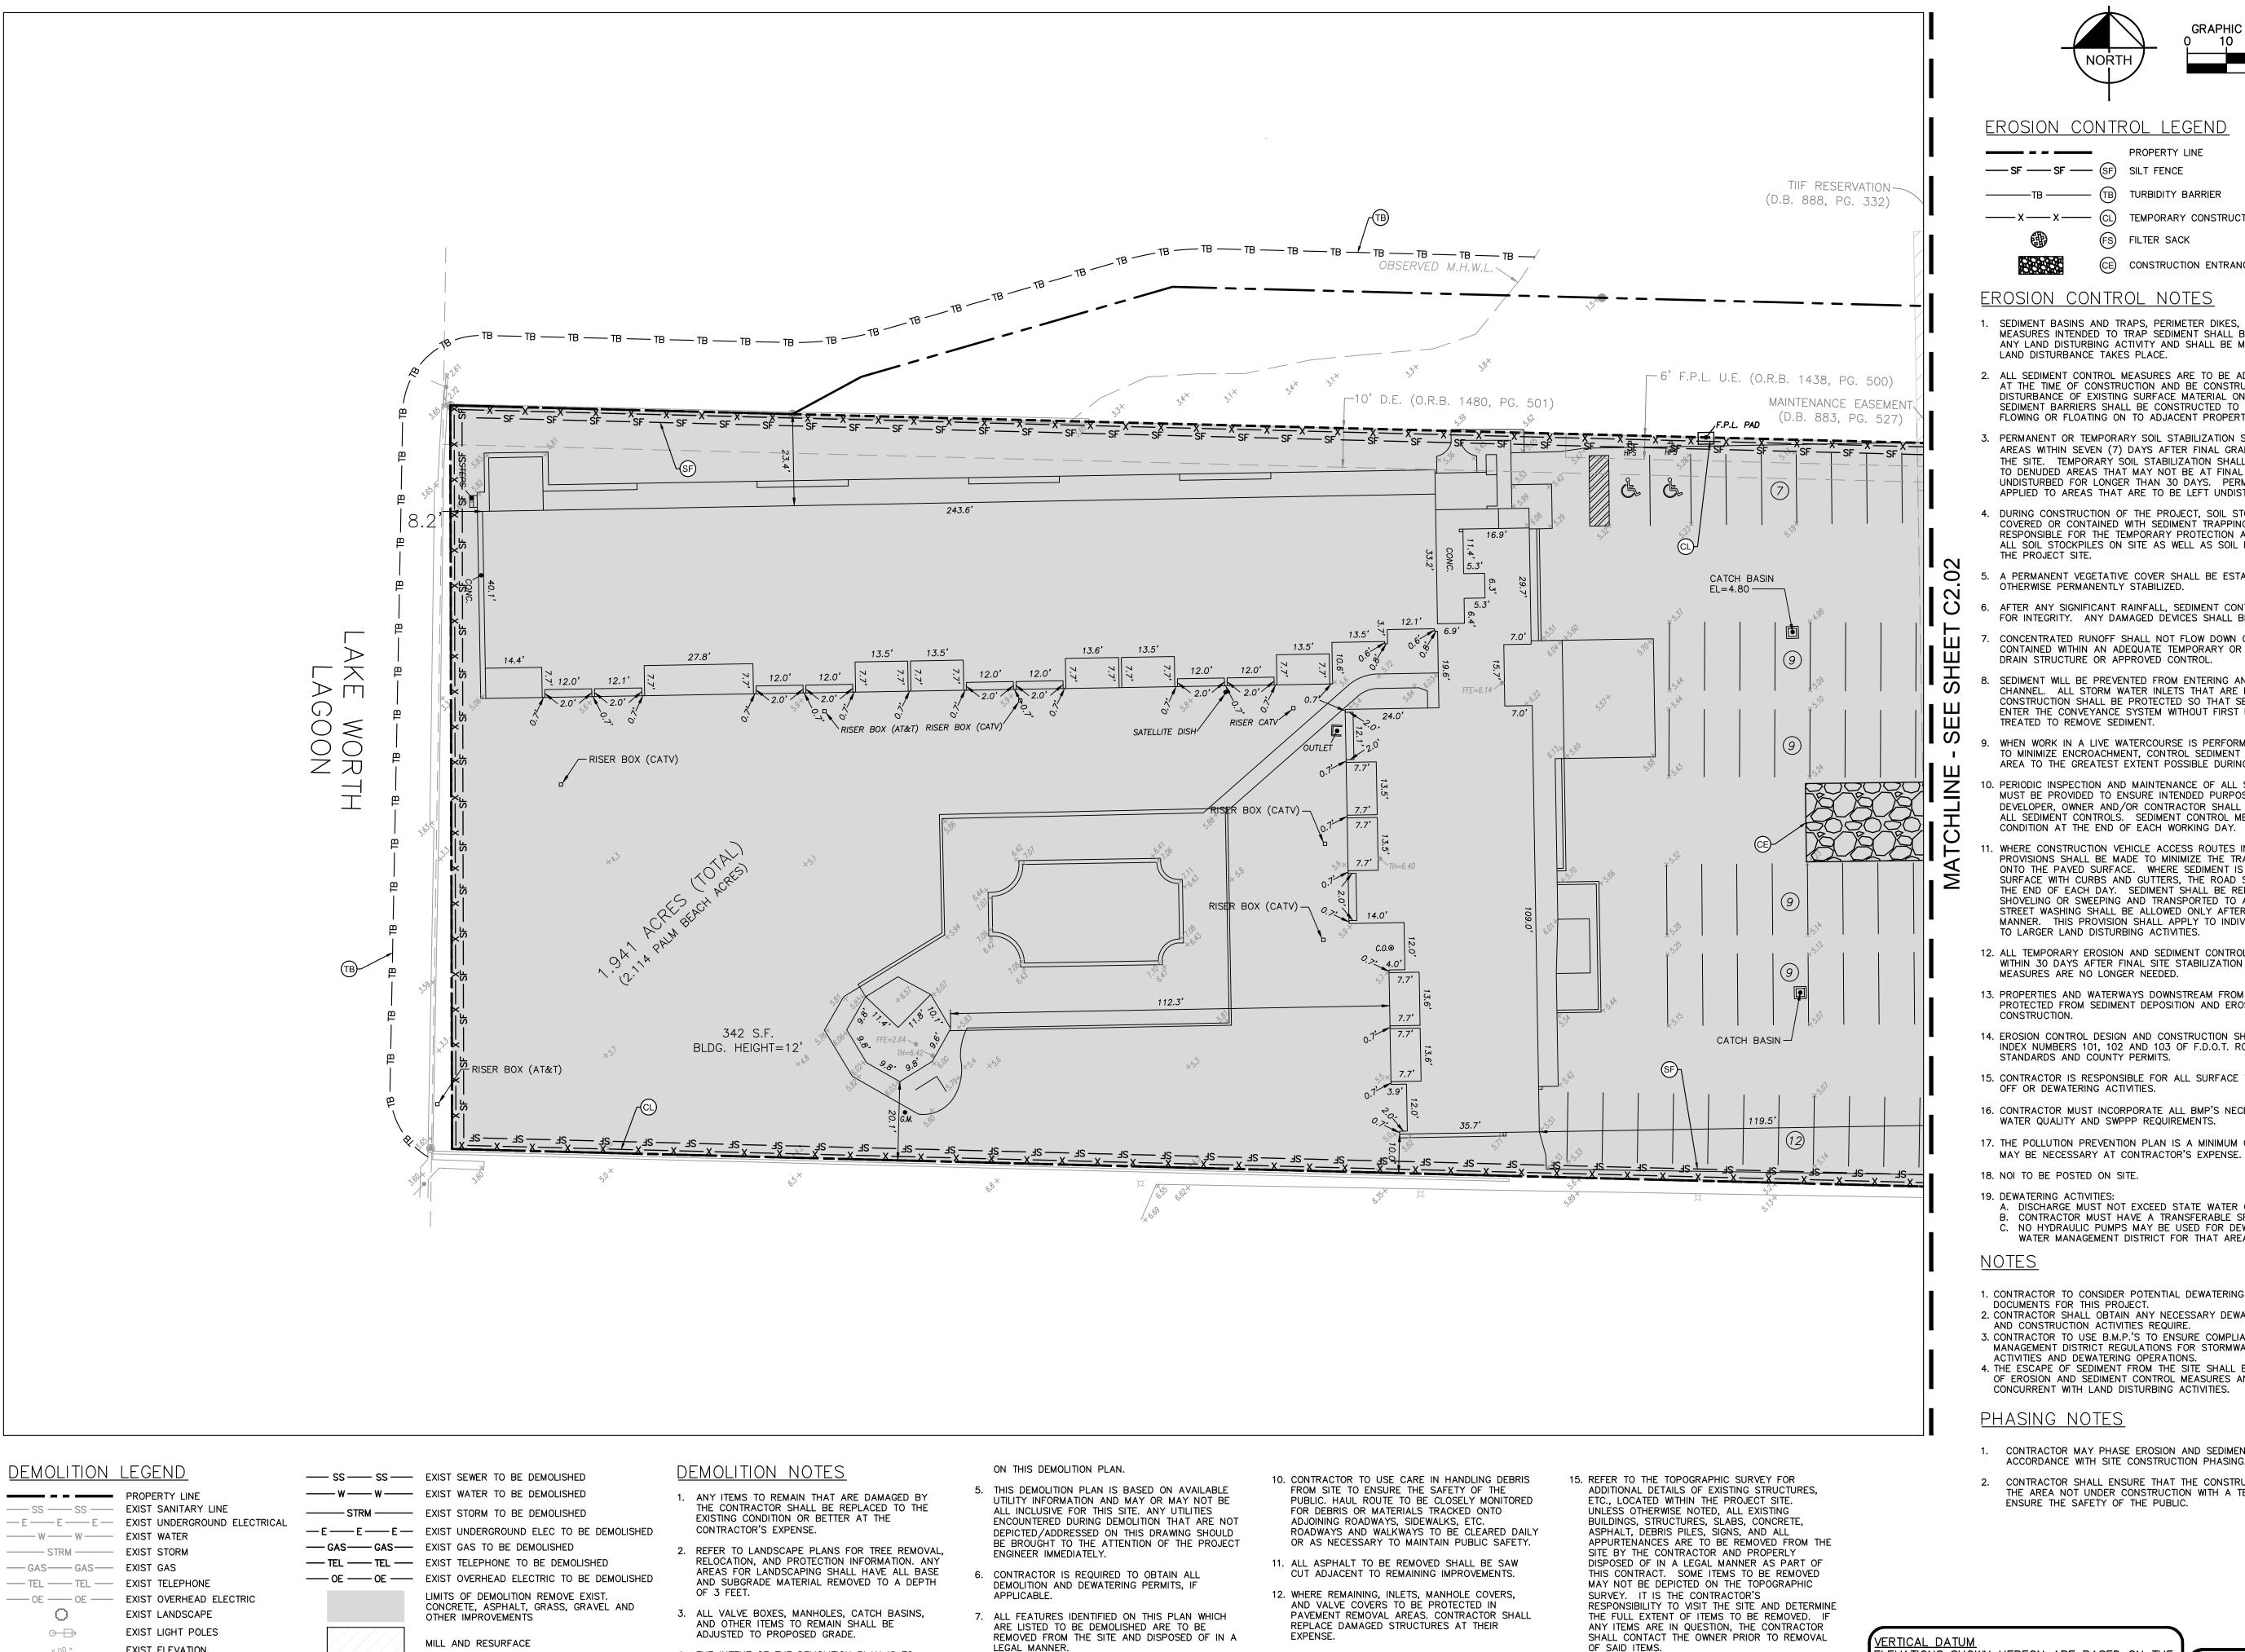
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SUNSHINE STATE ONE CALL OF FLORIDA, INC.



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GRAPHIC SCALE IN FEET

EROSION CONTROL LEGEND

PROPERTY LINE TB (TB) TURBIDITY BARRIER ——X——X—— (CL) TEMPORARY CONSTRUCTION FENCE (FS) FILTER SACK (CE) CONSTRUCTION ENTRANCE

EROSION CONTROL NOTES

- SEDIMENT BASINS AND TRAPS, PERIMETER DIKES, SEDIMENT BARRIERS AND OTHER MEASURES INTENDED TO TRAP SEDIMENT SHALL BE CONSTRUCTED AS A FIRST STEP IN ANY LAND DISTURBING ACTIVITY AND SHALL BE MADE FUNCTIONAL BEFORE UP-SLOPE LAND DISTURBANCE TAKES PLACE.
- ALL SEDIMENT CONTROL MEASURES ARE TO BE ADJUSTED TO MEET FIELD CONDITIONS AT THE TIME OF CONSTRUCTION AND BE CONSTRUCTED PRIOR TO ANY GRADING OR DISTURBANCE OF EXISTING SURFACE MATERIAL ON BALANCE OF SITE. PERIMETER SEDIMENT BARRIERS SHALL BE CONSTRUCTED TO PREVENT SEDIMENT OR TRASH FROM FLOWING OR FLOATING ON TO ADJACENT PROPERTIES.
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- 4. DURING CONSTRUCTION OF THE PROJECT, SOIL STOCK PILES SHALL BE STABILIZED, COVERED OR CONTAINED WITH SEDIMENT TRAPPING MEASURES. THE APPLICANT IS RESPONSIBLE FOR THE TEMPORARY PROTECTION AND PERMANENT STABILIZATION OF ALL SOIL STOCKPILES ON SITE AS WELL AS SOIL INTENTIONALLY TRANSPORTED FROM THE PROJECT SITE.
- 5. A PERMANENT VEGETATIVE COVER SHALL BE ESTABLISHED ON DENUDED AREAS NOT OTHERWISE PERMANENTLY STABILIZED.
- AFTER ANY SIGNIFICANT RAINFALL, SEDIMENT CONTROL STRUCTURES WILL BE INSPECTED FOR INTEGRITY. ANY DAMAGED DEVICES SHALL BE CORRECTED IMMEDIATELY.
- CONCENTRATED RUNOFF SHALL NOT FLOW DOWN CUT OR FILL SLOPES UNLESS CONTAINED WITHIN AN ADEQUATE TEMPORARY OR PERMANENT CHANNEL, FLUME, SLOPE DRAIN STRUCTURE OR APPROVED CONTROL.
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- WHEN WORK IN A LIVE WATERCOURSE IS PERFORMED, PRECAUTIONS SHALL BE TAKEN TO MINIMIZE ENCROACHMENT, CONTROL SEDIMENT TRANSPORT AND STABILIZE THE WORK AREA TO THE GREATEST EXTENT POSSIBLE DURING CONSTRUCTION.
- PERIODIC INSPECTION AND MAINTENANCE OF ALL SEDIMENT CONTROL STRUCTURES MUST BE PROVIDED TO ENSURE INTENDED PURPOSE IS ACCOMPLISHED. THE DEVELOPER, OWNER AND/OR CONTRACTOR SHALL BE CONTINUALLY RESPONSIBLE FOR ALL SEDIMENT CONTROLS. SEDIMENT CONTROL MEASURES SHALL BE IN WORKING CONDITION AT THE END OF EACH WORKING DAY.
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- 12. ALL TEMPORARY EROSION AND SEDIMENT CONTROL MEASURES SHALL BE REMOVED WITHIN 30 DAYS AFTER FINAL SITE STABILIZATION OR AFTER THE TEMPORARY MEASURES ARE NO LONGER NEEDED.
- 13. PROPERTIES AND WATERWAYS DOWNSTREAM FROM CONSTRUCTION SITES SHALL BE PROTECTED FROM SEDIMENT DEPOSITION AND EROSION AT ALL TIMES DURING
- 14. EROSION CONTROL DESIGN AND CONSTRUCTION SHALL FOLLOW THE REQUIREMENTS IN INDEX NUMBERS 101, 102 AND 103 OF F.D.O.T. ROADWAY AND TRAFFIC DESIGN STANDARDS AND COUNTY PERMITS.
- 15. CONTRACTOR IS RESPONSIBLE FOR ALL SURFACE WATER DISCHARGES, RAINFALL RUN OFF OR DEWATERING ACTIVITIES.
- 16. CONTRACTOR MUST INCORPORATE ALL BMP'S NECESSARY TO MEET OR EXCEED STATE WATER QUALITY AND SWPPP REQUIREMENTS.
- 17. THE POLLUTION PREVENTION PLAN IS A MINIMUM GUIDELINE ONLY. ADDITIONAL BMP'S
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- 1. CONTRACTOR TO CONSIDER POTENTIAL DEWATERING ACTIVITIES WHEN PREPARING BID DOCUMENTS FOR THIS PROJECT. 2. CONTRACTOR SHALL OBTAIN ANY NECESSARY DEWATERING PERMITS AS SITE CONDITIONS AND CONSTRUCTION ACTIVITIES REQUIRE.
- 3. CONTRACTOR TO USE B.M.P.'S TO ENSURE COMPLIANCE WITH NPDES AND WATER MANAGEMENT DISTRICT REGULATIONS FOR STORMWATER DISCHARGE FROM CONSTRUCTION ACTIVITIES AND DEWATERING OPERATIONS. 4. THE ESCAPE OF SEDIMENT FROM THE SITE SHALL BE PREVENTED BY THE INSTALLATION
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PHASING NOTES

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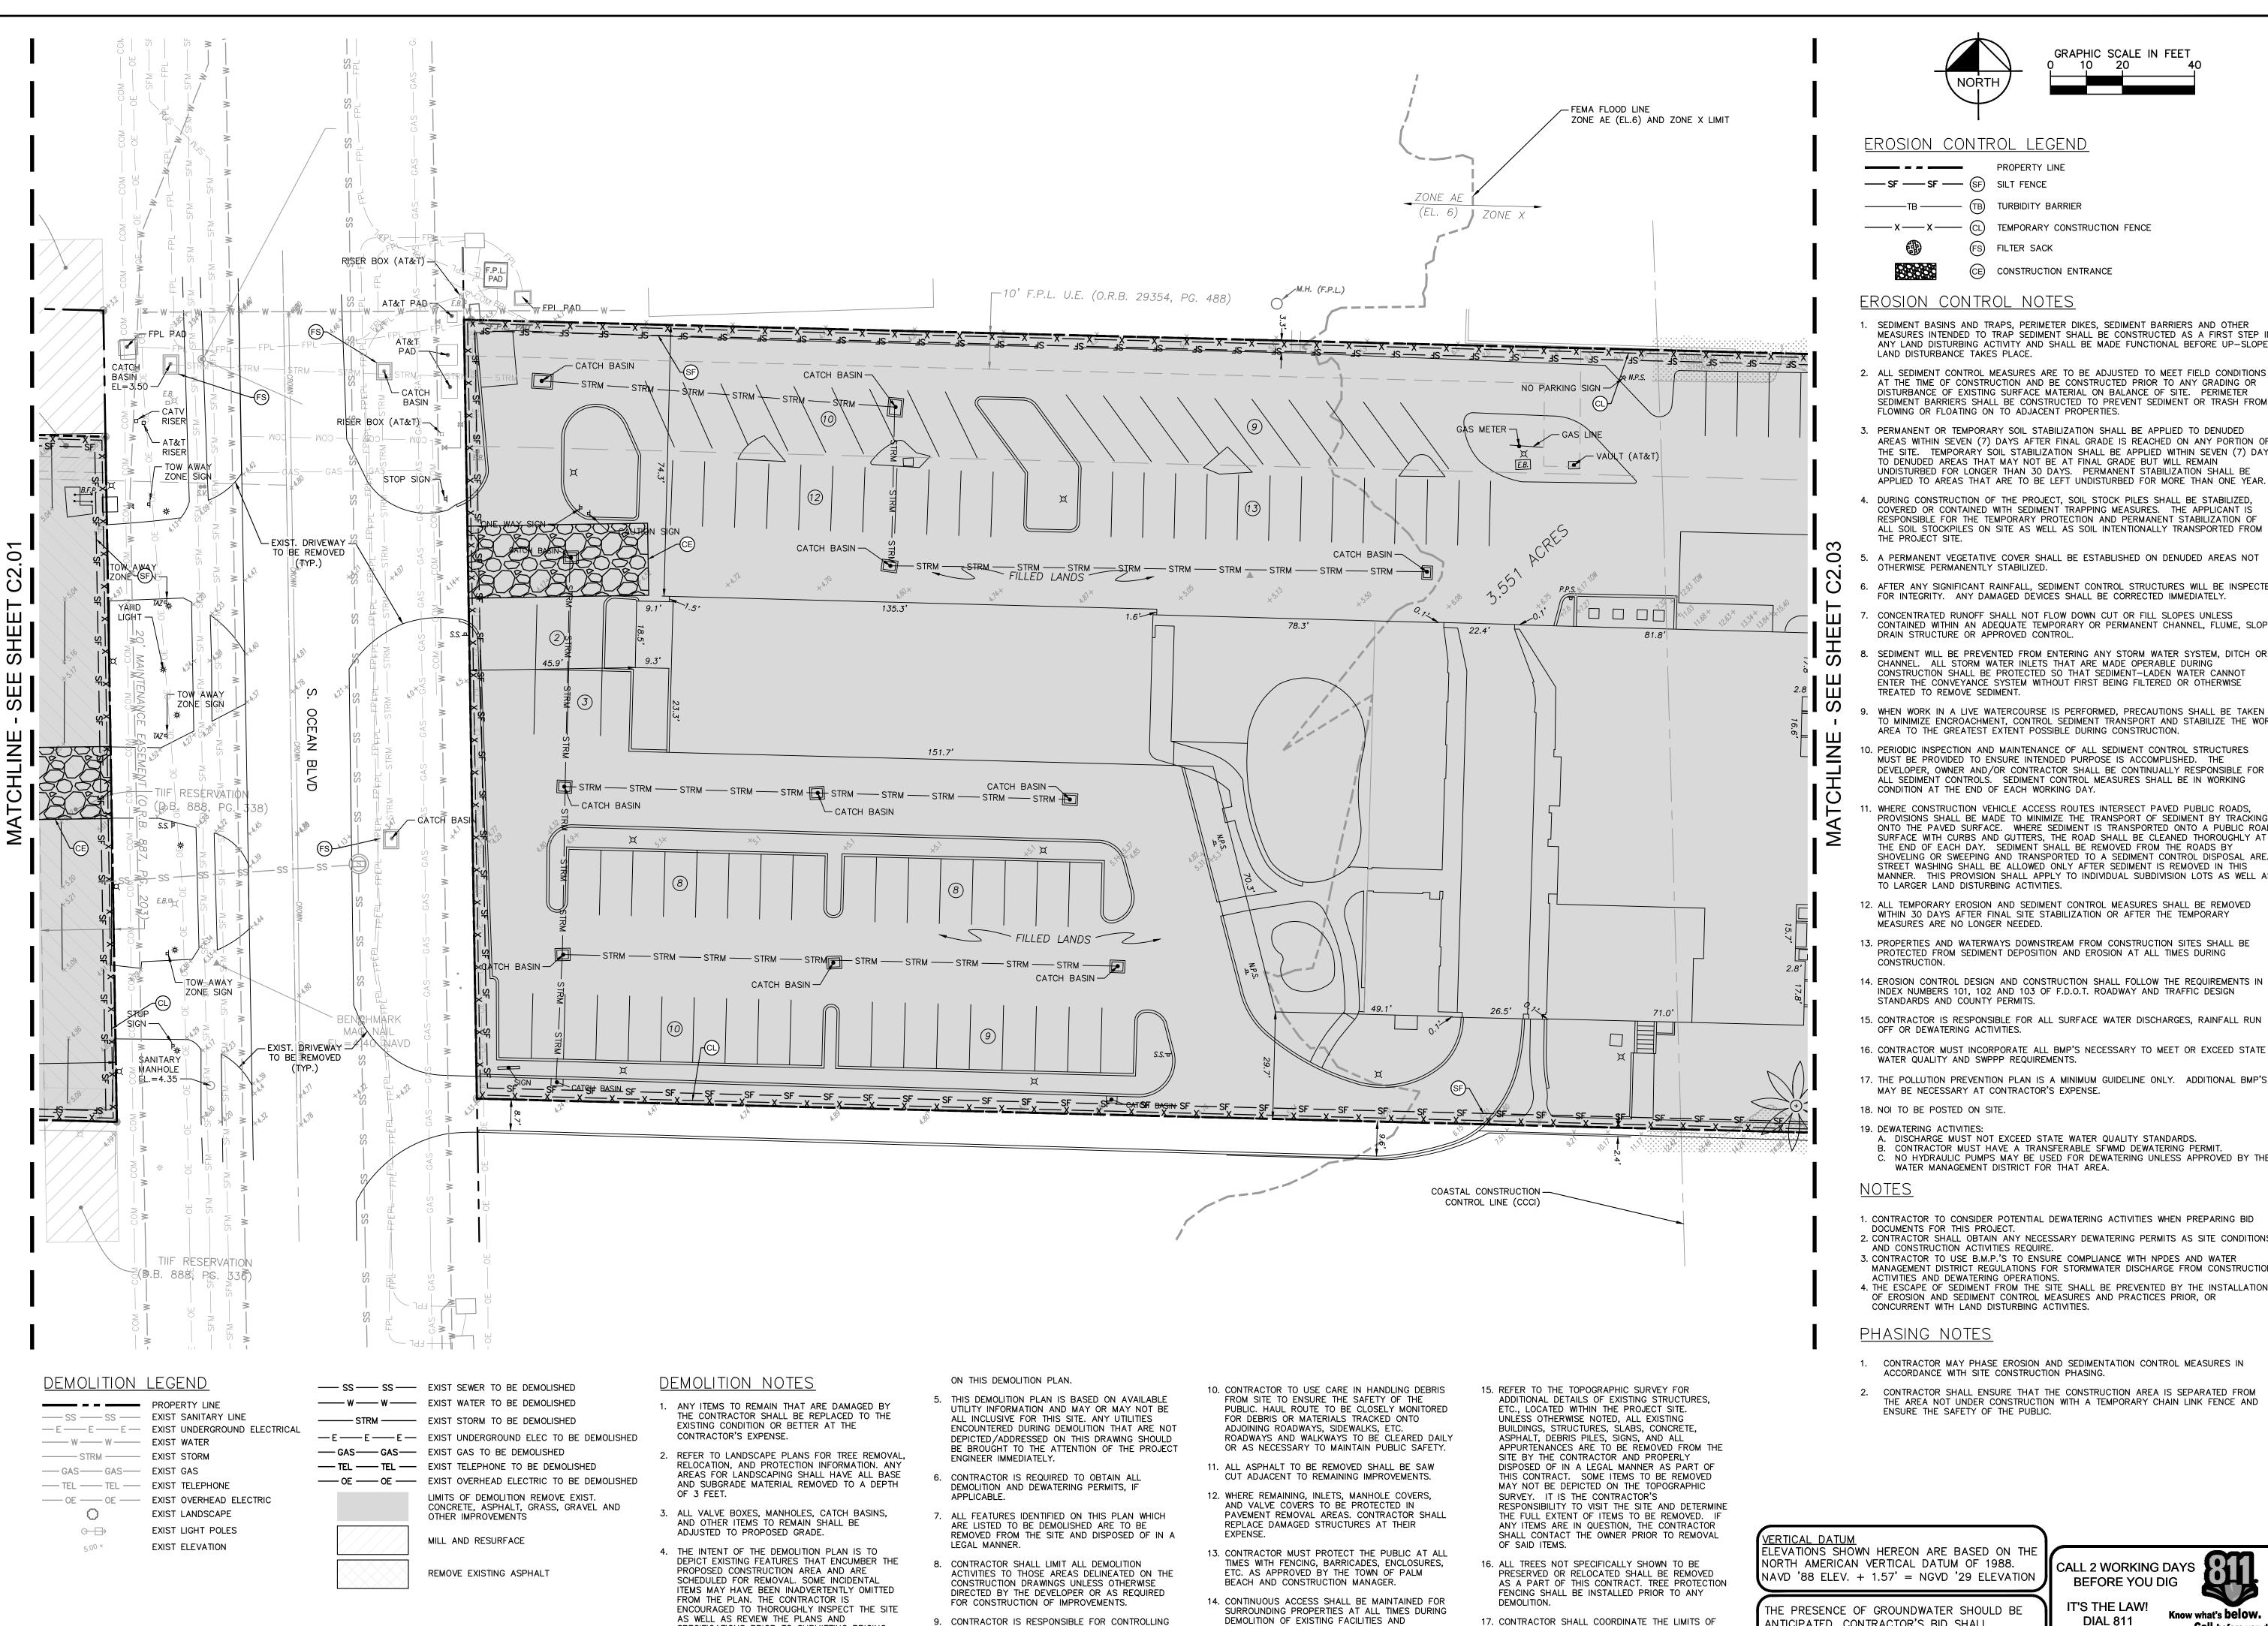
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SHEET NUMBER C2.01

Call before you dig



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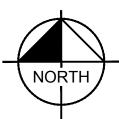
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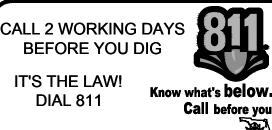
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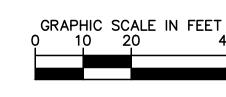
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- 11. WHERE CONSTRUCTION VEHICLE ACCESS ROUTES INTERSECT PAVED PUBLIC ROADS, PROVISIONS SHALL BE MADE TO MINIMIZE THE TRANSPORT OF SEDIMENT BY TRACKING ONTO THE PAVED SURFACE. WHERE SEDIMENT IS TRANSPORTED ONTO A PUBLIC ROAD SURFACE WITH CURBS AND GUTTERS, THE ROAD SHALL BE CLEANED THOROUGHLY AT THE END OF EACH DAY. SEDIMENT SHALL BE REMOVED FROM THE ROADS BY SHOVELING OR SWEEPING AND TRANSPORTED TO A SEDIMENT CONTROL DISPOSAL AREA. STREET WASHING SHALL BE ALLOWED ONLY AFTER SEDIMENT IS REMOVED IN THIS MANNER. THIS PROVISION SHALL APPLY TO INDIVIDUAL SUBDIVISION LOTS AS WELL AS TO LARGER LAND DISTURBING ACTIVITIES.
- 12. ALL TEMPORARY EROSION AND SEDIMENT CONTROL MEASURES SHALL BE REMOVED WITHIN 30 DAYS AFTER FINAL SITE STABILIZATION OR AFTER THE TEMPORARY MEASURES ARE NO LONGER NEEDED.
- 13. PROPERTIES AND WATERWAYS DOWNSTREAM FROM CONSTRUCTION SITES SHALL BE PROTECTED FROM SEDIMENT DEPOSITION AND EROSION AT ALL TIMES DURING
- 14. EROSION CONTROL DESIGN AND CONSTRUCTION SHALL FOLLOW THE REQUIREMENTS IN INDEX NUMBERS 101, 102 AND 103 OF F.D.O.T. ROADWAY AND TRAFFIC DESIGN STANDARDS AND COUNTY PERMITS.
- 15. CONTRACTOR IS RESPONSIBLE FOR ALL SURFACE WATER DISCHARGES, RAINFALL RUN OFF OR DEWATERING ACTIVITIES.
- 16. CONTRACTOR MUST INCORPORATE ALL BMP'S NECESSARY TO MEET OR EXCEED STATE WATER QUALITY AND SWPPP REQUIREMENTS.
- 17. THE POLLUTION PREVENTION PLAN IS A MINIMUM GUIDELINE ONLY. ADDITIONAL BMP'S MAY BE NECESSARY AT CONTRACTOR'S EXPENSE.
- 18. NOI TO BE POSTED ON SITE.
- 19. DEWATERING ACTIVITIES: A. DISCHARGE MUST NOT EXCEED STATE WATER QUALITY STANDARDS. B. CONTRACTOR MUST HAVE A TRANSFERABLE SFWMD DEWATERING PERMIT. C. NO HYDRAULIC PUMPS MAY BE USED FOR DEWATERING UNLESS APPROVED BY THE WATER MANAGEMENT DISTRICT FOR THAT AREA.

- 1. CONTRACTOR TO CONSIDER POTENTIAL DEWATERING ACTIVITIES WHEN PREPARING BID DOCUMENTS FOR THIS PROJECT. 2. CONTRACTOR SHALL OBTAIN ANY NECESSARY DEWATERING PERMITS AS SITE CONDITIONS
- 3. CONTRACTOR TO USE B.M.P.'S TO ENSURE COMPLIANCE WITH NPDES AND WATER MANAGEMENT DISTRICT REGULATIONS FOR STORMWATER DISCHARGE FROM CONSTRUCTION ACTIVITIES AND DEWATERING OPERATIONS.
- 4. THE ESCAPE OF SEDIMENT FROM THE SITE SHALL BE PREVENTED BY THE INSTALLATION OF EROSION AND SEDIMENT CONTROL MEASURES AND PRACTICES PRIOR, OR CONCURRENT WITH LAND DISTURBING ACTIVITIES.

PHASING NOTES

AND CONSTRUCTION ACTIVITIES REQUIRE.

- 1. CONTRACTOR MAY PHASE EROSION AND SEDIMENTATION CONTROL MEASURES IN ACCORDANCE WITH SITE CONSTRUCTION PHASING.
- CONTRACTOR SHALL ENSURE THAT THE CONSTRUCTION AREA IS SEPARATED FROM THE AREA NOT UNDER CONSTRUCTION WITH A TEMPORARY CHAIN LINK FENCE AND ENSURE THE SAFETY OF THE PUBLIC.

CALL 2 WORKING DAYS **BEFORE YOU DIG**

DIAL 811

IT'S THE LAW!

LEVATIONS SHOWN HEREON ARE BASED ON THE NORTH AMERICAN VERTICAL DATUM OF 1988. NAVD '88 ELEV. + 1.57' = NGVD '29 ELEVATION

SHALL CONTACT THE OWNER PRIOR TO REMOVAL

PRESERVED OR RELOCATED SHALL BE REMOVED

FENCING SHALL BE INSTALLED PRIOR TO ANY

17. CONTRACTOR SHALL COORDINATE THE LIMITS OF

UTILITY DEMOLITION WITH PROPOSED PLANS.

AS A PART OF THIS CONTRACT. TREE PROTECTION


16. ALL TREES NOT SPECIFICALLY SHOWN TO BE


OF SAID ITEMS.

DEMOLITION.

THE PRESENCE OF GROUNDWATER SHOULD BE ANTICIPATED. CONTRACTOR'S BID SHALL INCLUDE CONSIDERATION FOR ADDRESSING THIS ISSUE AND OBTAINING ALL NECESSARY PERMITS.

SHEET NUMBER SUNSHINE STATE ONE CALL OF FLORIDA, INC.

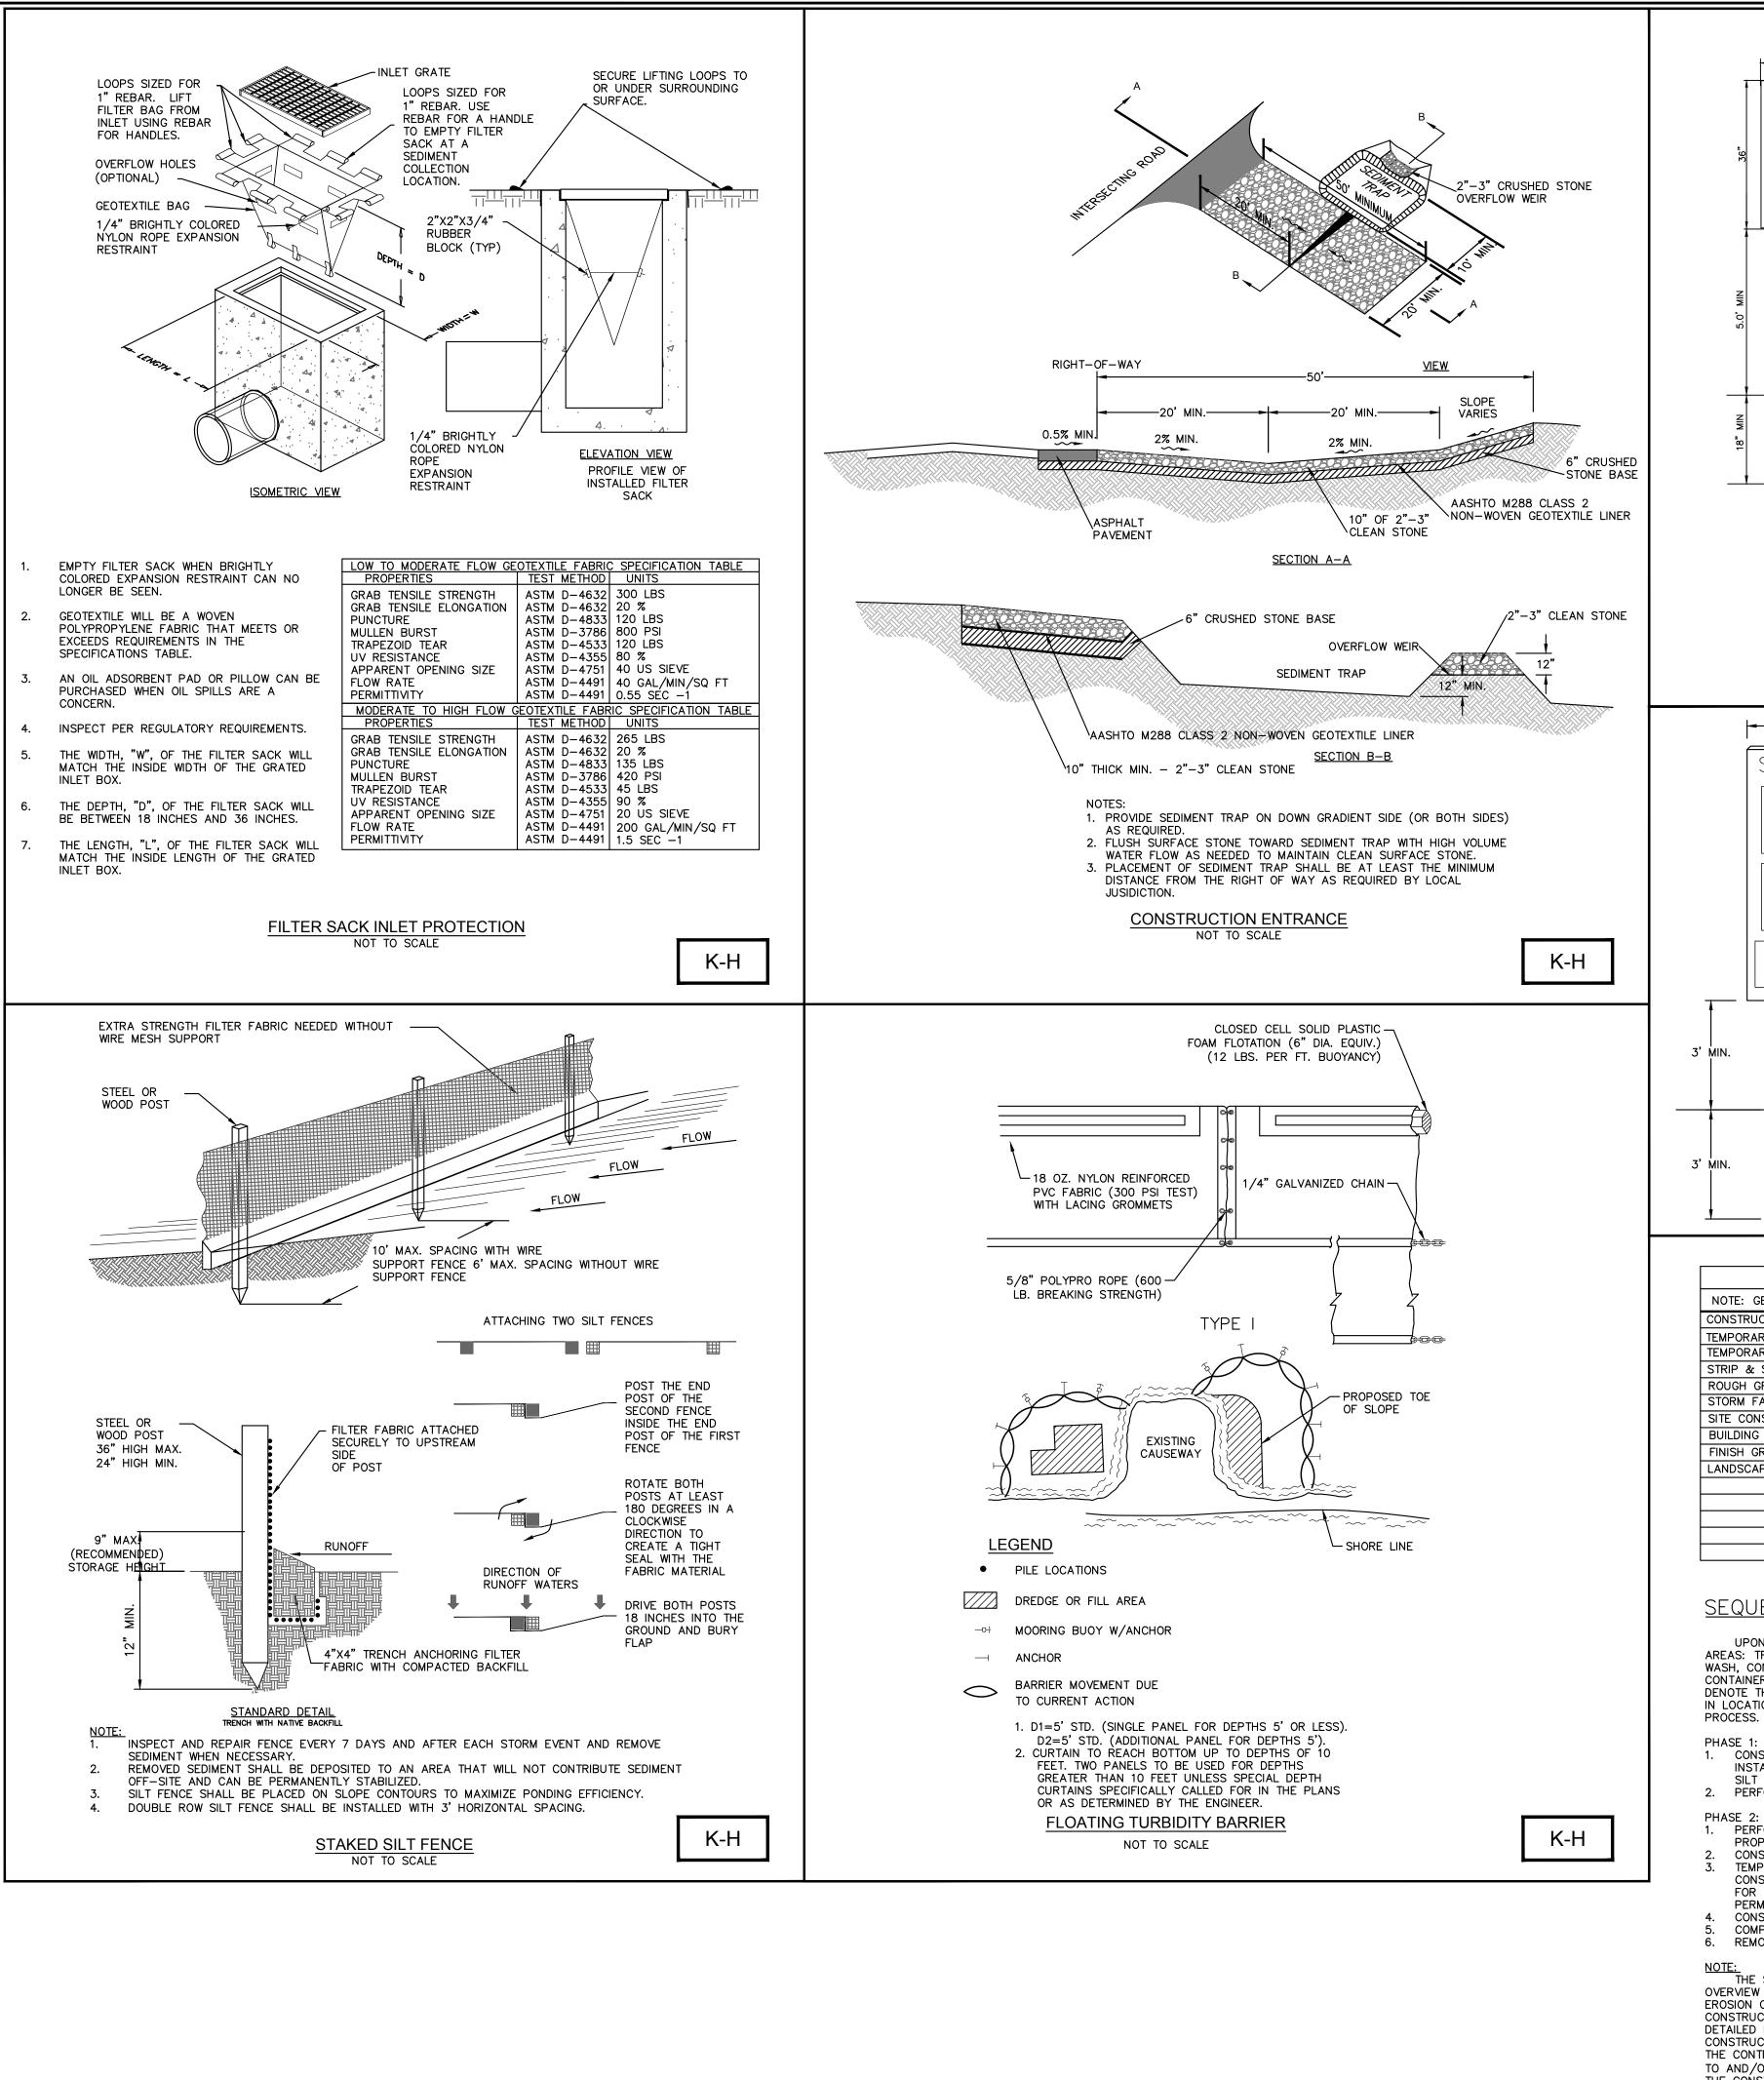

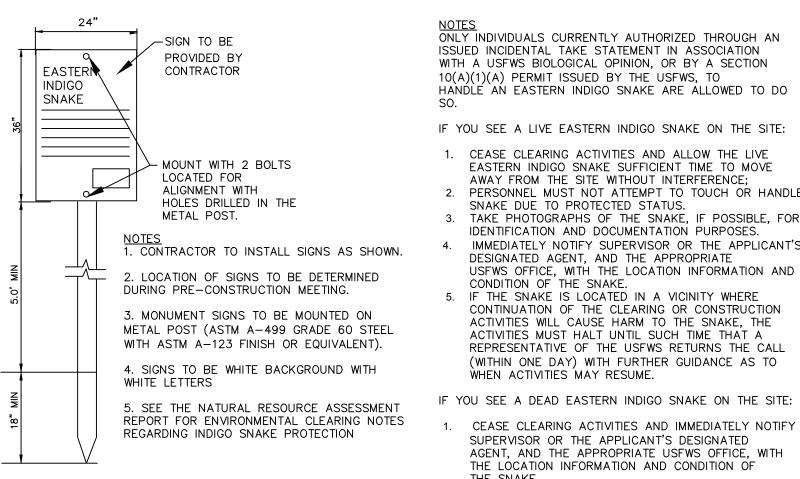

INDIGO SNAKE PROTECTION SIGN NOT TO SCALE

ONLY INDIVIDUALS CURRENTLY AUTHORIZED THROUGH AN ISSUED INCIDENTAL TAKE STATEMENT IN ASSOCIATION WITH A USFWS BIOLOGICAL OPINION, OR BY A SECTION 10(A)(1)(A) PERMIT ISSUED BY THE USFWS, TO HANDLE AN EASTERN INDIGO SNAKE ARE ALLOWED TO DO


IF YOU SEE A LIVE EASTERN INDIGO SNAKE ON THE SITE:

- 1. CEASE CLEARING ACTIVITIES AND ALLOW THE LIVE
- EASTERN INDIGO SNAKE SUFFICIENT TIME TO MOVE AWAY FROM THE SITE WITHOUT INTERFERENCE;
- 2. PERSONNEL MUST NOT ATTEMPT TO TOUCH OR HANDLE SNAKE DUE TO PROTECTED STATUS. TAKE PHOTOGRAPHS OF THE SNAKE, IF POSSIBLE, FOR
- IDENTIFICATION AND DOCUMENTATION PURPOSES. IMMEDIATELY NOTIFY SUPERVISOR OR THE APPLICANT'S DESIGNATED AGENT, AND THE APPROPRIATE
- CONDITION OF THE SNAKE. 5. IF THE SNAKE IS LOCATED IN A VICINITY WHERE CONTINUATION OF THE CLEARING OR CONSTRUCTION ACTIVITIES WILL CAUSE HARM TO THE SNAKE, THE ACTIVITIES MUST HALT UNTIL SUCH TIME THAT A REPRESENTATIVE OF THE USFWS RETURNS THE CALL (WITHIN ONE DAY) WITH FURTHER GUIDANCE AS TO WHEN ACTIVITIES MAY RESUME.
- IF YOU SEE A DEAD EASTERN INDIGO SNAKE ON THE SITE:
- CEASE CLEARING ACTIVITIES AND IMMEDIATELY NOTIFY SUPERVISOR OR THE APPLICANT'S DESIGNATED AGENT, AND THE APPROPRIATE USFWS OFFICE, WITH THE LOCATION INFORMATION AND CONDITION OF
- THE SNAKE 2. TAKE PHOTOGRAPHS OF THE SNAKE, IF POSSIBLE, FOR
- IDENTIFICATION AND DOCUMENTATION PURPOSES. THOROUGHLY SOAK THE DEAD SNAKE IN WATER AND THEN FREEZE THE SPECIMEN. THE APPROPRIATE WILDLIFE AGENCY WILL RETRIEVE THE DEAD SNAKE.

TELEPHONE NUMBERS OF USFWS FLORIDA FIELD OFFICES TO BE CONTACTED IF A LIVE OR DEAD EASTERN INDIGO SNAKE IS ENCOUNTERED:

NORTH FLORIDA FIELD OFFICE - (904) 731-3336 PANAMA CITY FIELD OFFICE - (850) 769-0552 SOUTH FLORIDA FIELD OFFICE - (772) 562-3909

K-H

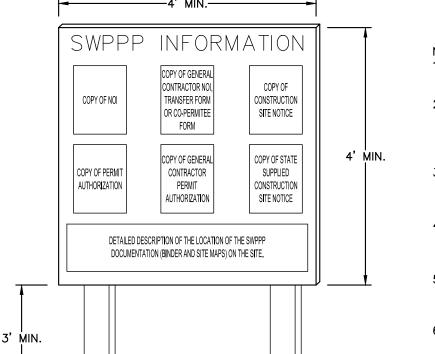

1. "SWPPP INFORMATION" MUST BE DISPLAYED PROMINENTLY ACROSS THE TOP OF THE SIGN, AS SHOWN IN THE DETAIL.

- 2. SIGN TO BE CONSTRUCTED OF A RIGID MATERIAL, SUCH AS PLYWOOD OR OUTDOOR SIGN BOARD. SIGN MUST BE CONSTRUCTED IN A MANNER TO PROTECT DOCUMENTS FROM DAMAGE DUE TO WEATHER (WIND, SUN, MOISTURE, ETC.).
- 3. THE SWPPP INFORMATION SIGN MUST BE LOCATED NEAR THE ENTRANCE/EXIT OF THE SITE, SUCH THAT IT IS ACCESSIBLE/VIEWABLE BY THE GENERAL PUBLIC, BUT NOT OBSTRUCTING VIEWS AS TO CAUSE A SAFETY HAZARD.
- 4. ALL POSTED DOCUMENTS MUST BE MAINTAINED IN A CLEARLY READABLE CONDITION AT ALL TIMES THROUGHOUT CONSTRUCTION AND UNTIL THE NOTICE-OF-TERMINATION (NOT) IS FILED FOR THE PERMIT.
- 5. CONTRACTOR SHALL POST OTHER STORM WATER AND/OR EROSION AND SEDIMENT CONTROL RELATED PERMITS ON THE SIGN AS REQUIRED BY THE LOCAL AGENCY.
- 6. SIGN SHALL BE LOCATED OUTSIDE OF PUBLIC RIGHT-OF-WAY AND EASEMENTS UNLESS APPROVED BY THE GOVERNING AGENCY.
- 7. CONTRACTOR IS RESPONSIBLE FOR ENSURING STABILITY OF THIS SWPPP INFORMATION SIGN.

SWPPP INFORMATION SIGN NOT TO SCALE

K-H

SOIL EROSION/SEDIMENTATION CONTROL OPERATION TIME SCHEDULE																								
NOTE: GENERAL CONTRACTOR TO COMPLETE TABLE WITH THEIR SPECIFIC PROJECT SCHEDULE																								
CONSTRUCTION SEQUENCE	JAN	FEB	MAR	APR	MAY	JUN	JUL	AUG	SEP	ОСТ	NOV	DEC	JAN	FEB	MAR	APR	MAY	JUN	JUL	AUG	SEP	ОСТ	NOV	DEC
TEMPORARY CONSTRUCTION ENTRANCE																								
TEMPORARY CONTROL MEASURES																								
STRIP & STOCKPILE TOPSOIL																								
ROUGH GRADE																								
STORM FACILITIES																								
SITE CONSTRUCTION																								
BUILDING PAD CONSTRUCTION																								
FINISH GRADING																								
LANDSCAPING/SEED/FINAL STABILIZATION																								

SEQUENCE OF CONSTRUCTION

UPON IMPLEMENTATION AND INSTALLATION OF THE FOLLOWING AREAS: TRAILER, PARKING, LAYDOWN, PORTA-POTTY, WHEEL WASH, CONCRETE WASHOUT, FUEL AND MATERIAL STORAGE CONTAINERS, SOLID WASTE CONTAINERS, ETC., IMMEDIATELY DENOTE THEM ON THE SITE MAPS AND NOTE ANY CHANGES IN LOCATION AS THEY OCCUR THROUGHOUT THE CONSTRUCTION

- 1. CONSTRUCT STABILIZED CONSTRUCTION ENTRANCE AND INSTALL TEMPORARY CONSTRUCTION FENCE, SILT FENCE,
- SILT DIKE AND INLET PROTECTION.
- 2. PERFORM CLEARING AND GRUBBING AND DEMOLITION.
- 1. PERFORM MASS GRADING, ROUGH GRADE TO ESTABLISH PROPOSED DRAINAGE PATTERNS. CONSTRUCT PROPOSED DRAINAGE INFRASTRUCTURE.
- TEMPORARILY SEED WITH PURE LIVE SEED, THROUGHOUT CONSTRUCTION, DISTURBED AREAS THAT WILL BE INACTIVE FOR 7 DAYS OR MORE OR AS REQUIRED BY GENERIC
- 4. CONSTRUCT PROPOSED IMPROVEMENTS. COMPLETE FINAL GRADING AND FINAL STABILIZATION. 6. REMOVE TEMPORARY EROSION CONTROL MEASURES.
- THE SEQUENCE OF CONSTRUCTION SHOWN ABOVE IS A GENERAL OVERVIEW AND IS INTENDED TO CONVEY THE GENERAL CONCEPTS OF THE EROSION CONTROL DESIGN AND SHOULD NOT BE RELIED UPON FOR CONSTRUCTION PURPOSES. THE CONTRACTOR IS SOLELY RESPONSIBLE FOR DETAILED PHASING AND CONSTRUCTION SEQUENCING NECESSARY TO CONSTRUCT THE PROPOSED IMPROVEMENTS INCLUDED IN THESE PLANS. THE CONTRACTOR SHALL NOTIFY ENGINEER IN WRITING IMMEDIATELY, PRIOR TO AND/OR DURING CONSTRUCTION IF ANY ADDITIONAL INFORMATION ON THE CONSTRUCTION SEQUENCE IS NECESSARY. CONTRACTOR IS SOLELY RESPONSIBLE FOR COMPLYING WITH THE REQUIREMENTS OF THE AUTHORITY HAVING JURISDICTION AND ALL OTHER APPLICABLE LAWS.

NOTE: DETAILS ARE INCLUDED FROM THE ENTITIES LISTED BELOW AND ARE PROVIDED FOR **INFORMATIONAL PURPOSES** ONLY. CONTRACTOR SHALL **OBTAIN AND CONFORM WITH TH** LATEST STANDARDS AND

ELEVATIONS SHOWN HEREON ARE BASED ON HILL NORTH AMERICAN VERTICAL DATUM OF 1988._ NAVD '88 ELEV. + 1.57' = NGVD '29 ELEVA[†]

THE PRESENCE OF GROUNDWATER SHOULD BE ANTICIPATED. CONTRACTOR'S BID SHALL INCLUDE CONSIDERATION FOR ADDRESSING T COUNTY ISSUE AND OBTAINING ALL NECESSARY PERN

KIMLEY-HORN AND ASSOCIATES DETAIL

DETAILS.

TCALL 2 WORKING DAYS AND B TOWN FOREMONDED THE LAW! Know what's **below.**


AL 811 BEACCAL Before your dig. WATER AND WAST ATL


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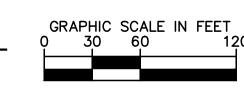
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HORIZONTAL CONTROL NOTES

- 1. ALL CURBING IS TYPE "D OR F" UNLESS OTHERWISE STATED.
- TYPE "D" CURB AND TYPE "F" CURB AND GUTTER SHALL BE CONSTRUCTED PER FDOT INDEX 300. ALL TYPE "D" CURB SHALL HAVE A 3' STRAIGHT TRANSITION AT THE BEGINNING AND ENDING POINTS WHEN NOT CONNECTING TO TYPE "F" CURB AND
- 3. ALL DIMENSIONS SHOWN ARE TO FACE OF CURB FOR TYPE "D OR F" CURB OR EDGE OF PAVEMENT FOR NO CURB, UNLESS OTHERWISE NOTED.
- 4. ALL CURB RAMPS AND SIDEWALKS ENTERING PARKING OR TRAVEL WAYS SHALL HAVE DETECTABLE WARNING SURFACES 2' DEEP AND THE WIDTH OF THE SIDEWALK. REFER TO LATEST FDOT DESIGN STANDARDS INDEX 522-002. 5. ALL RADII ARE 3' UNLESS OTHERWISE NOTED.
- ALL STOP BARS AND CROSSWALKS SHALL BE THERMOPLASTIC. ALL OTHER PAVEMENT MARKINGS ARE PAINT, UNLESS OTHERWISE NOTED.
- 7. REFER TO LANDSCAPE PLANS FOR PLANTING AND DETAILS.

KEY NOTE LEGEND

- (1) CONCRETE WHEEL STOP (TYP.). SEE DETAIL SHEET.
- 2 ACCESSIBLE PARKING SPACE W/ SINGAGE TYPICAL. SEE DETAIL SHEET FOR ACCESSIBLE PARKING SPACE SIZE, SIGN AND SYMBOL.
- TYPE "D" CURB TRANSITION.
- (5) PEDESTRIAN WALKWAY. SEE DETAIL SHEET.

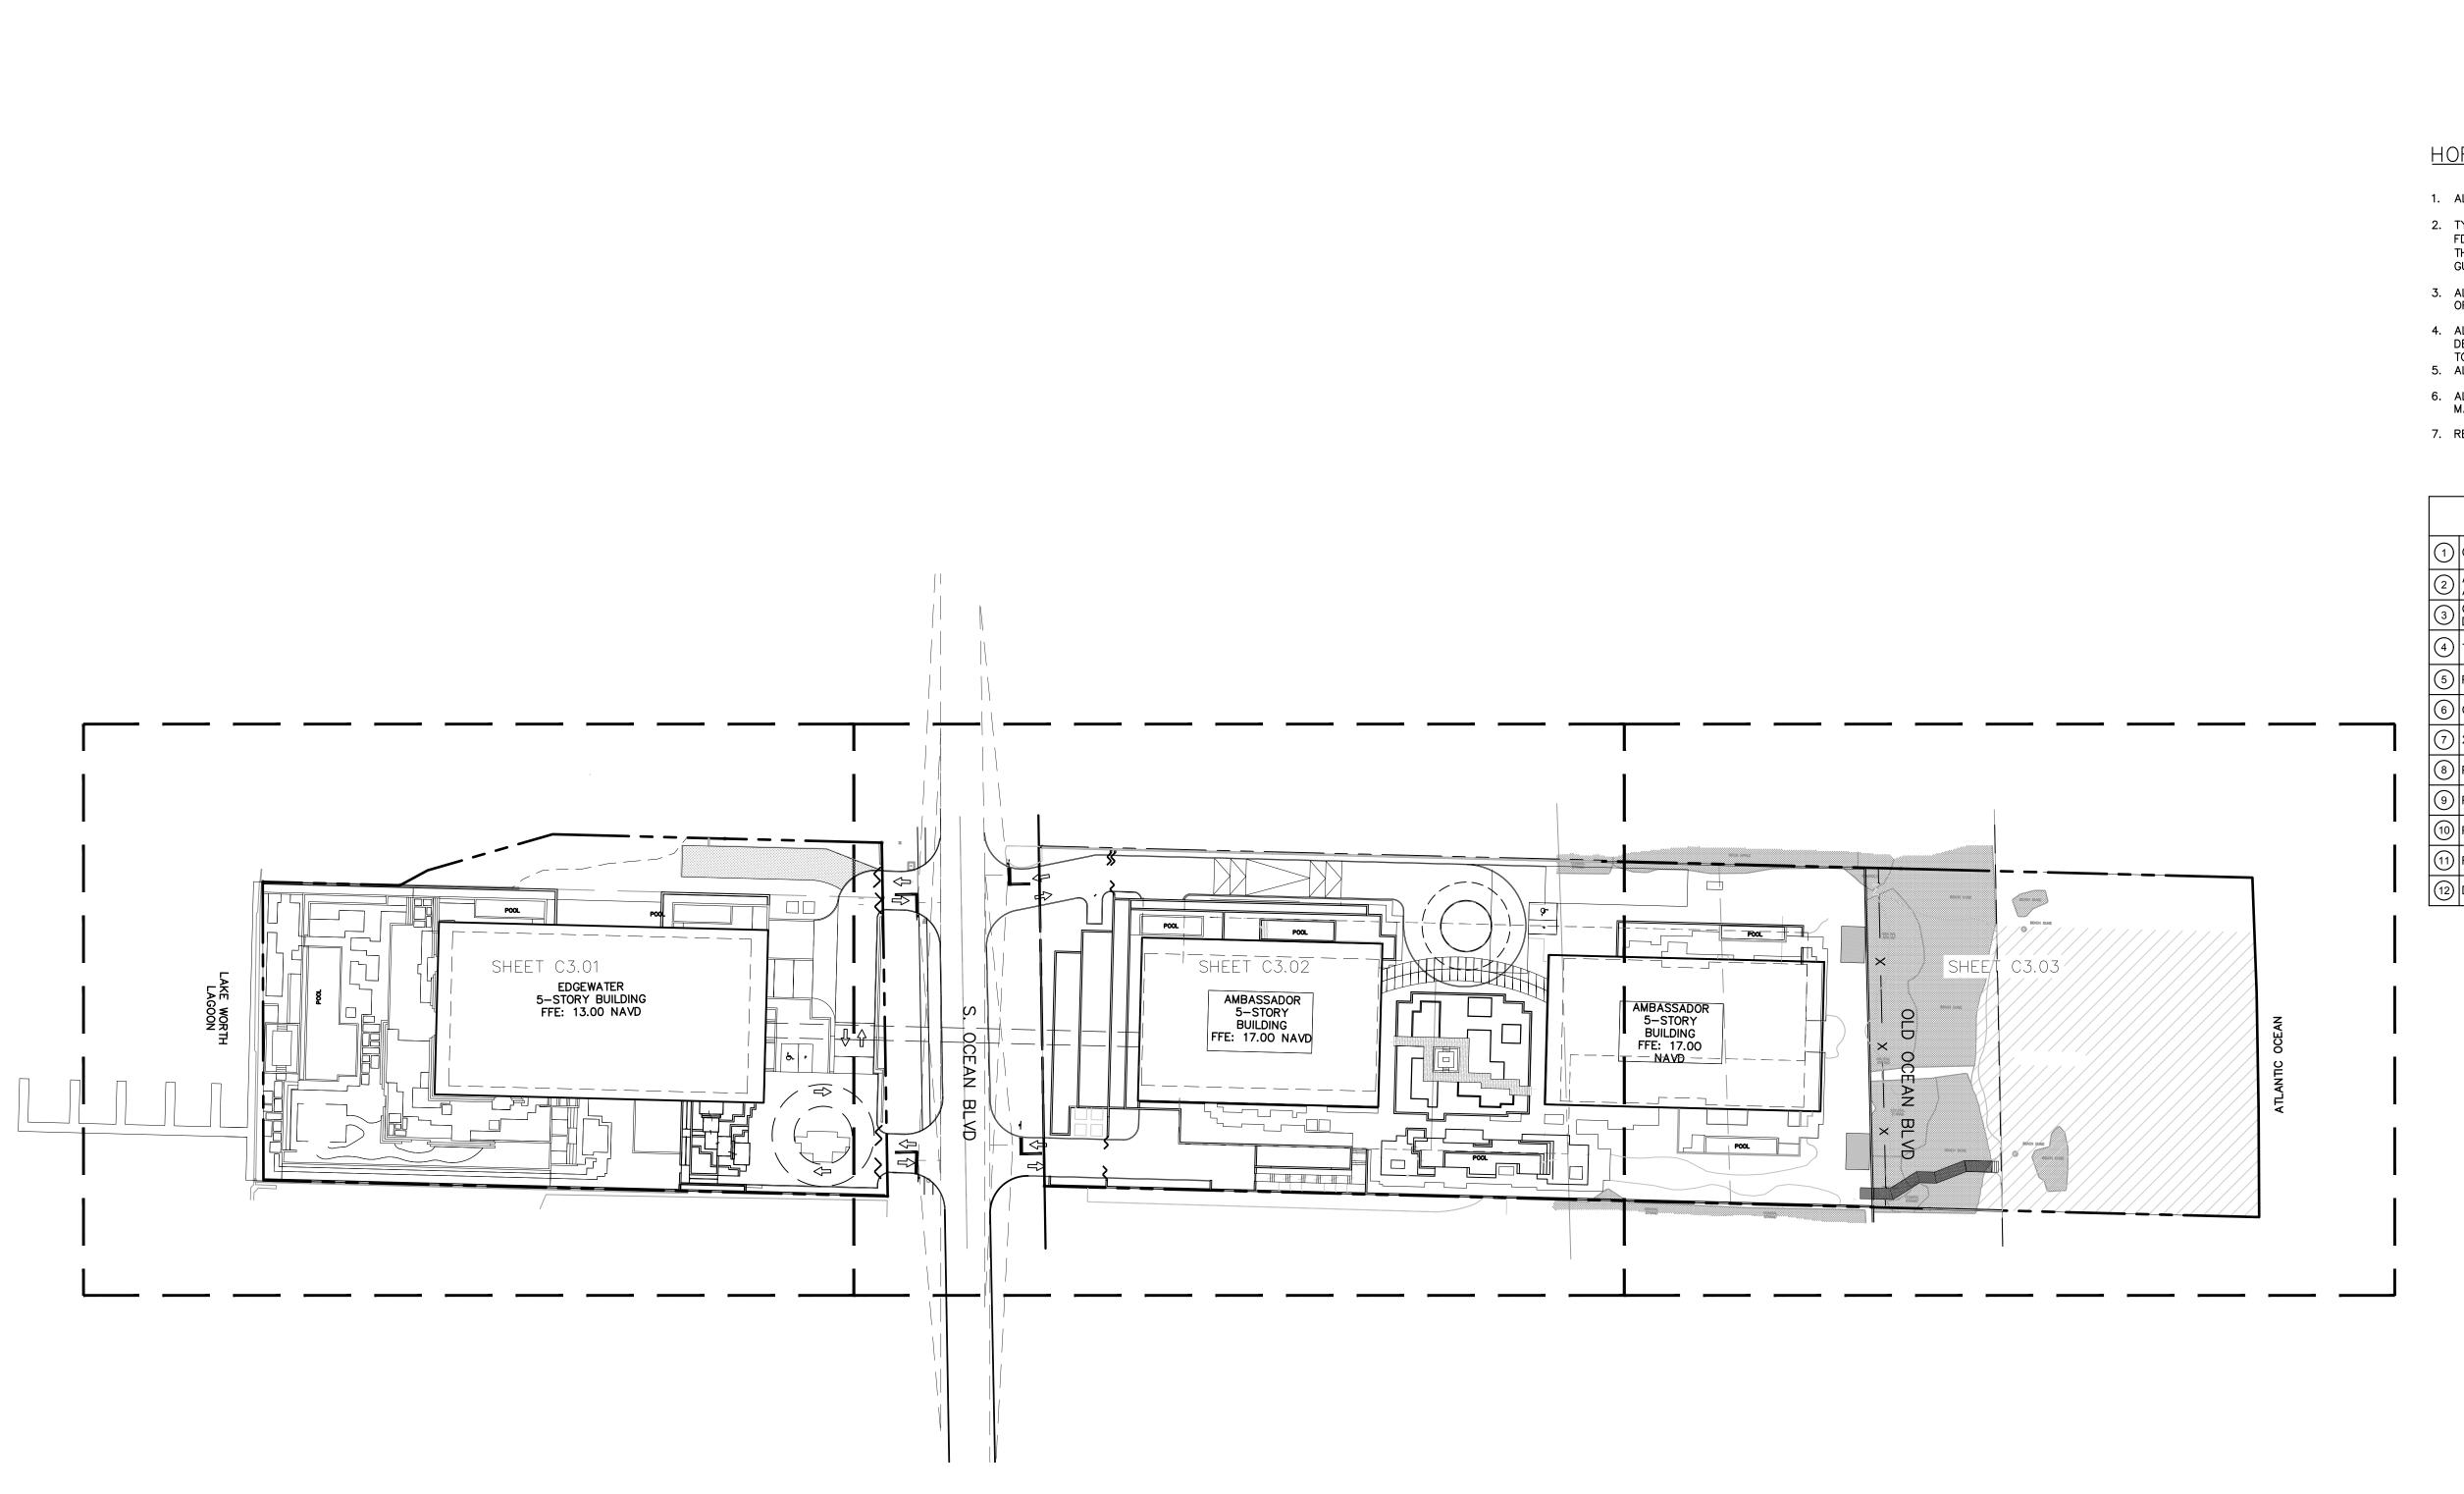- (9) PROPOSED LIGHT POLE. SEE PHOTOMETRIC PLAN.
- (10) PROPERTY LINE
- (11) FLUSH SIDEWALK.

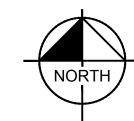3 CONCRETE TRANSFORMER PAD. CONTRACTOR TO COORDINATE WITH LOCAL FPL FOR DETAILS.

(6) CURB RAMP PER FDOT INDEX 304.

(7) 24" STOP BAR w/ "STOP" SIGN. SEE SIGNAGE DETAIL LEGEND.

(8) PROPOSED GATE.

VERTICAL DATUM
ELEVATIONS SHOWN HEREON ARE BASED ON THE NORTH AMERICAN VERTICAL DATUM OF 1988.


THE PRESENCE OF GROUNDWATER SHOULD BE ANTICIPATED. CONTRACTOR'S BID SHALL INCLUDE CONSIDERATION FOR ADDRESSING THIS ISSUE AND OBTAINING ALL NECESSARY PERMITS.

(12) DUMPSTER ENCLOSURE AREA W/ HEAVY DUTY CONCRETE PAD.

SHEET NUMBER C3.00

CALL 2 WORKING DAYS
BEFORE YOU DIG Know what's **below.** Call before you dig.

SUNSHINE STATE ONE CALL OF FLORIDA, INC.

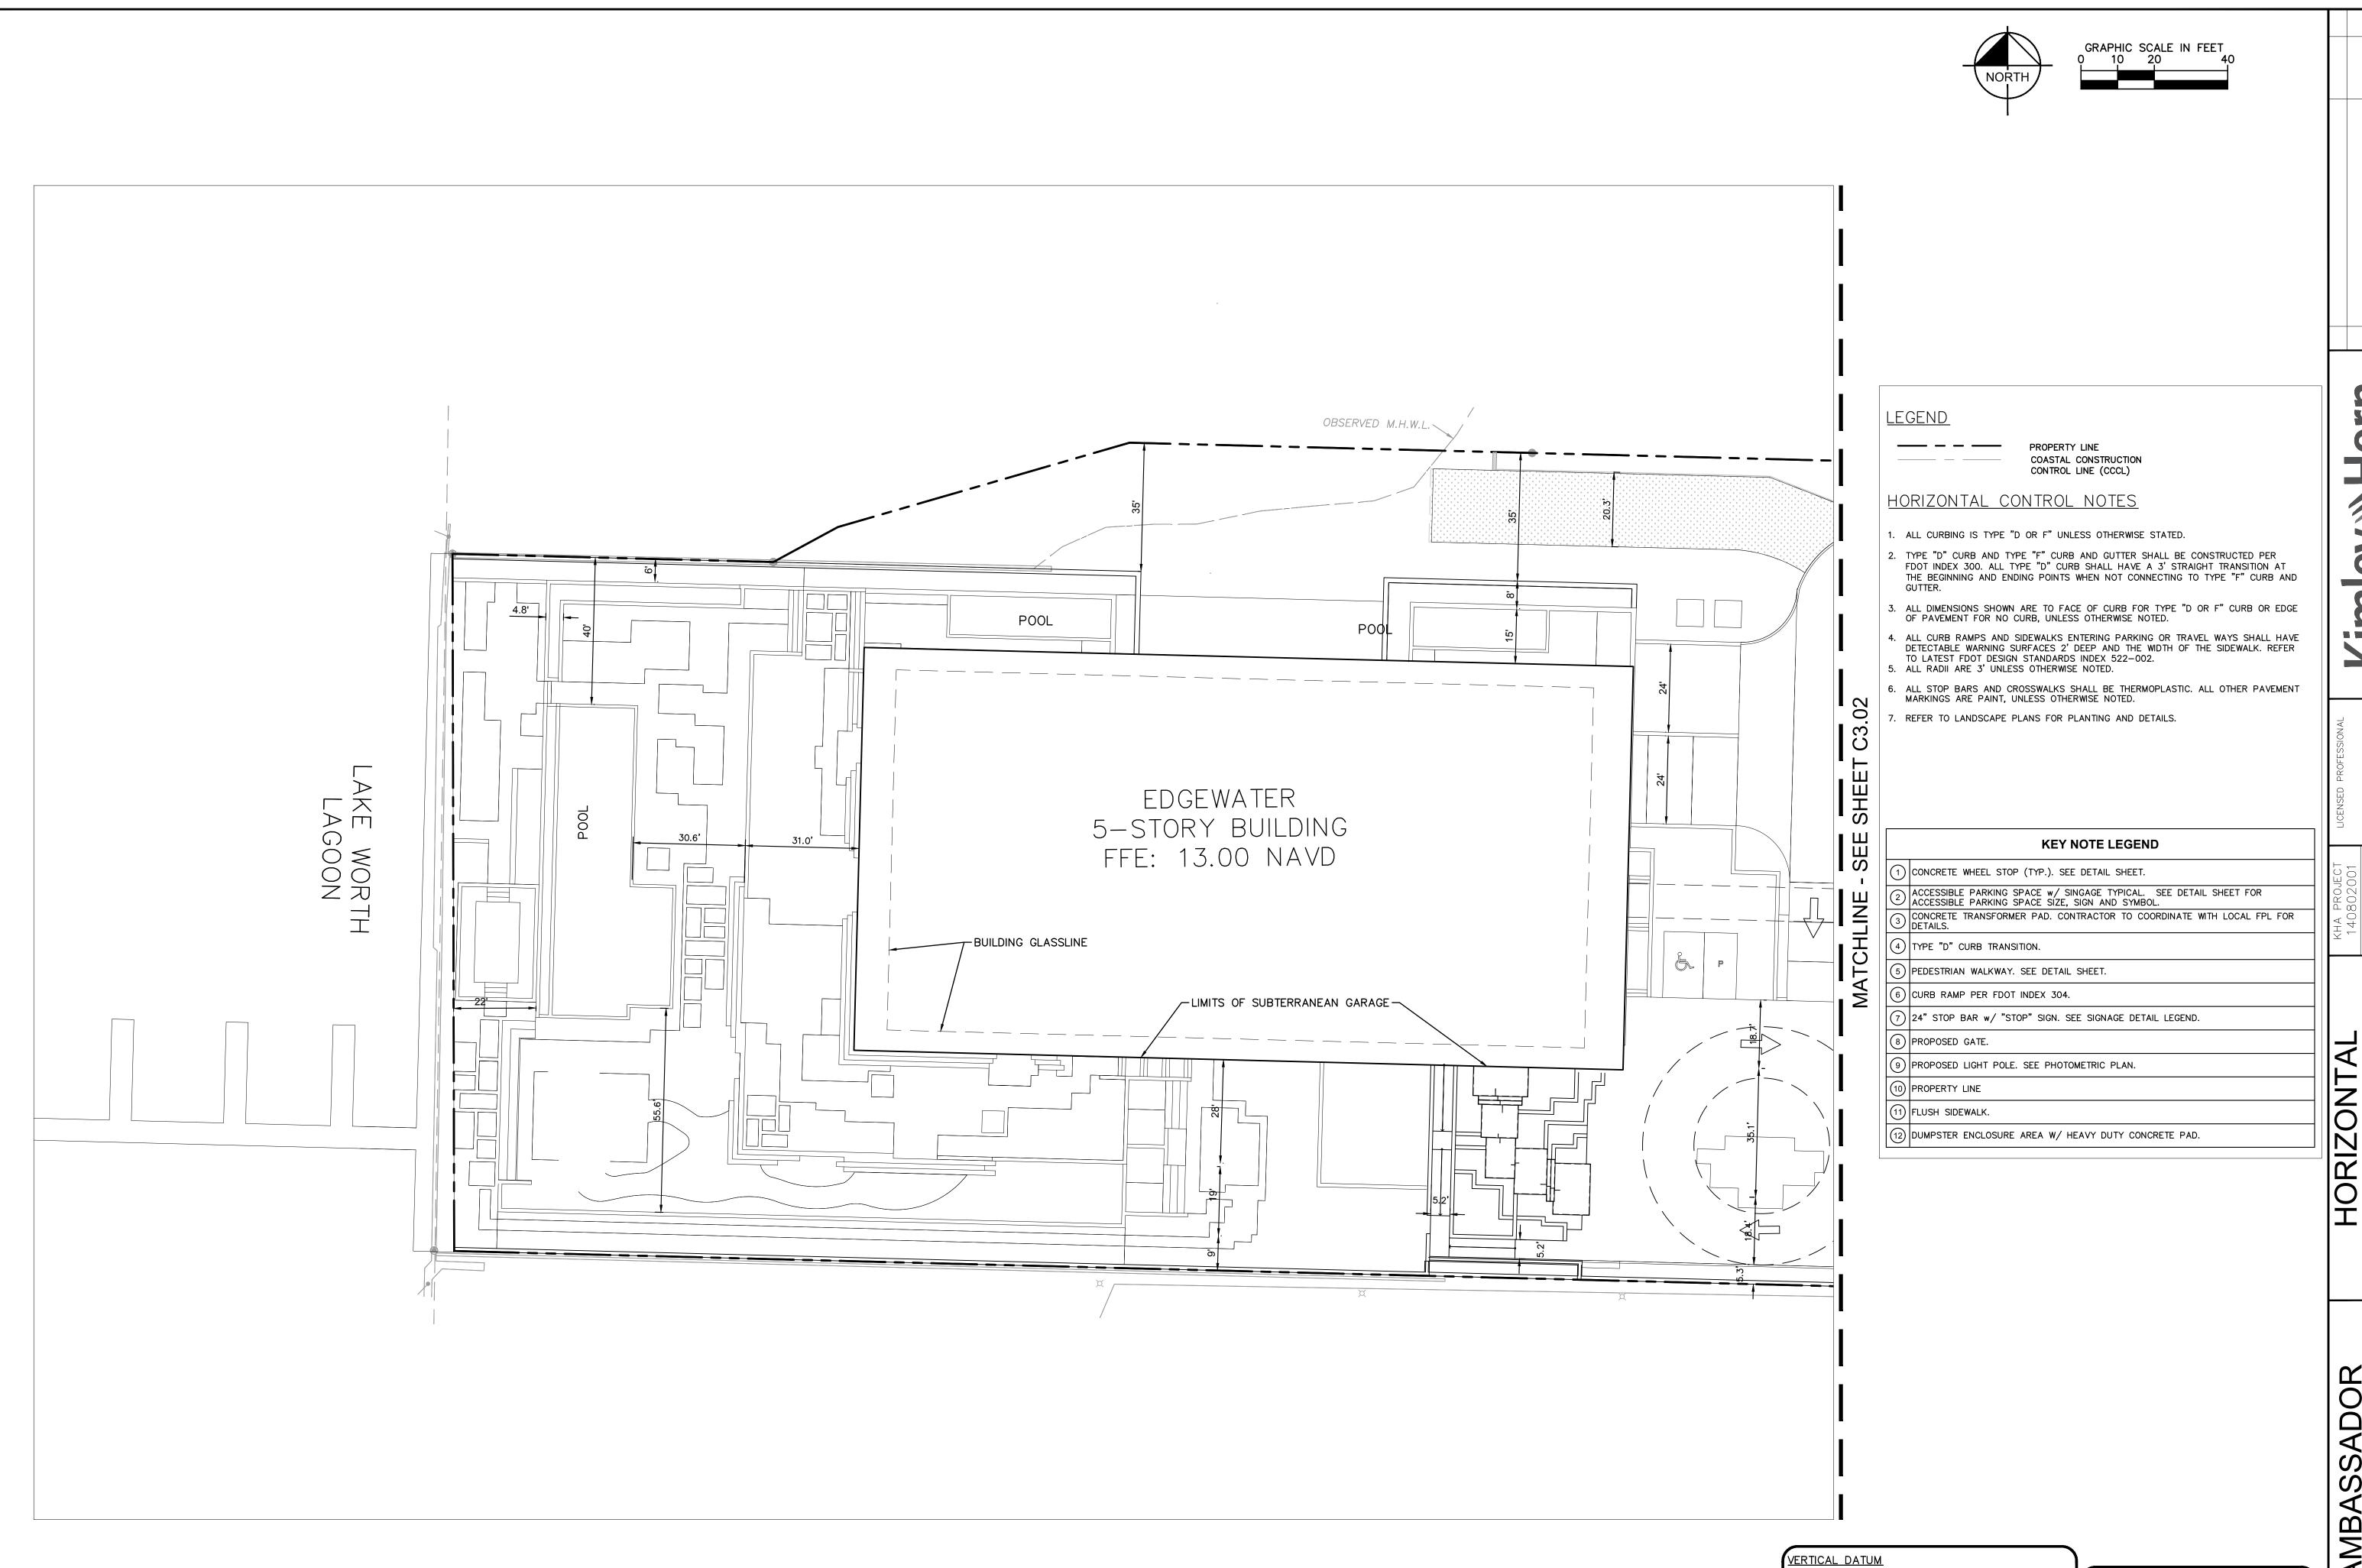

VERTICAL DATUM
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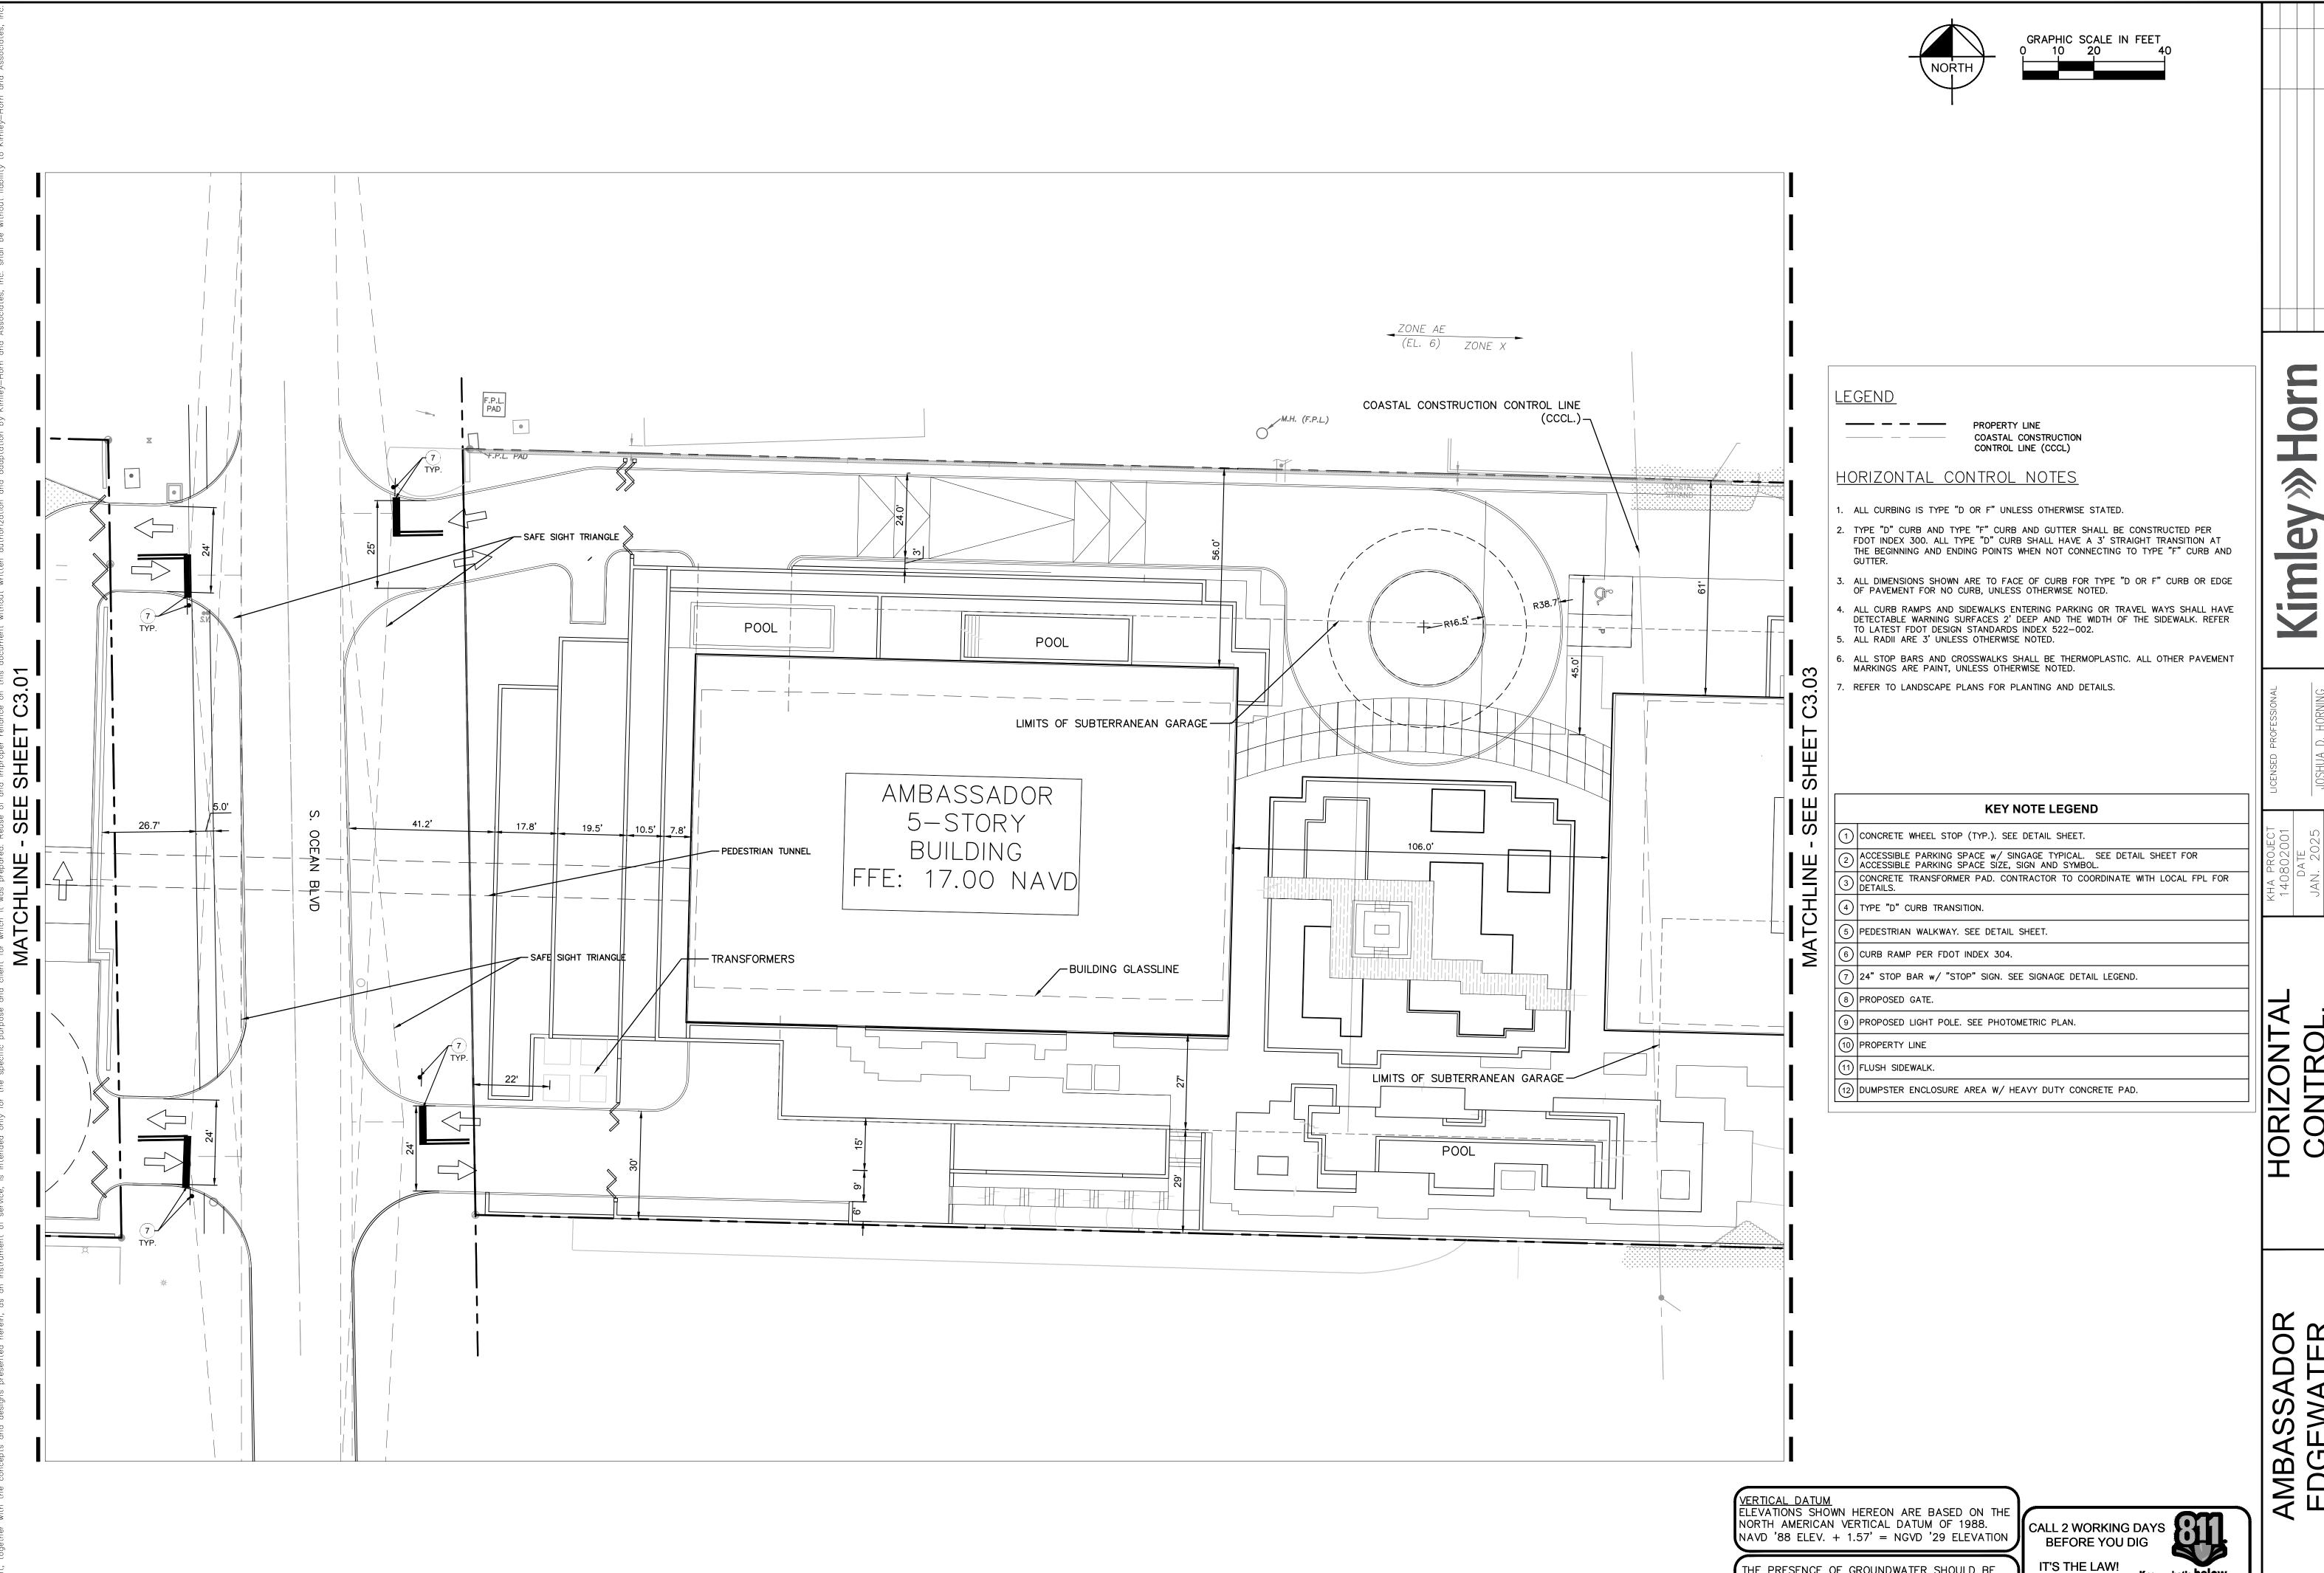
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CALL 2 WORKING DAYS
BEFORE YOU DIG IT'S THE LAW! **DIAL 811**

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SHEET NUMBER C3.01

VE



MARKING AGE PLAN

HORIZONTAL CONTROL, AVEMENT MARK AND SIGNAGE PL

AMBASSADOR EDGEWATER PREPARED FOR OKO GROUP

Know what's **below.** Call befo<u>re</u> you dig.

DIAL 811

SUNSHINE STATE ONE CALL OF FLORIDA, INC.

THE PRESENCE OF GROUNDWATER SHOULD BE

INCLUDE CONSIDERATION FOR ADDRESSING THIS ISSUE AND OBTAINING ALL NECESSARY PERMITS.

ANTICIPATED. CONTRACTOR'S BID SHALL



GRAPHIC SCALE IN FEET 0 10 20 40

PROPERTY LINE

COASTAL CONSTRUCTION CONTROL LINE (CCCL)

KEY NOTE LEGEND

AMBASSADOR EDGEWATER

VERTICAL DATUM ELEVATIONS SHOWN HEREON ARE BASED ON THE NORTH AMERICAN VERTICAL DATUM OF 1988. NAVD '88 ELEV. + 1.57' = NGVD '29 ELEVATION

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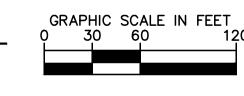
Know what's **below.**

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SHEET NUMBER C3.03

HORIZONTAL
CONTROL,
PAVEMENT MARKING
AND SIGNAGE PLAN





<u>LEGEND</u>

PROPERTY LINE — — CENTERLINE OF R/W UTILITY CROSSING PROPOSED STORM AREA INLET PROPOSED STORM CURB INLET PROPOSED STORM MANHOLE EXISTING STORM AREA INLET EXISTING STORM CURB INLET EXISTING STORM MANHOLE S SANITARY MANHOLE — F — F — FIRE LINE PIPE FIRE HYDRANT FIRE DEPARTMENT CONNECTION ----- OE ------ OVERHEAD LINE -----TEL ----- TELEPHONE LINE —— COM —— COMMUNICATIONS LINE ---E-E--- UNDERGROUND ELECTRIC LINE ---- FPL ---- FPL LINE —————— ELECTRICAL LINE — — — — — EXISTING UTILITY EASEMENTS — — — — — PROPOSED UTILITY EASEMENTS PROPOSED CONTOUR ELEVATIONS --- -27-- Existing contour elevations PROPOSED SPOT ELEVATION 30.00 ±ME MATCH EXISTING ELEVATION EXISTING ELEVATION \sim FLOW ARROW PROPOSED CONCRETE SIDEWALK PROPOSED PAVERS

PAVING, GRADING AND DRAINAGE NOTES

PROPOSED ASPHALT PAVEMENT

- ALL ELEVATIONS ON THE PLANS OR REFERENCED IN THE SPECIFICATIONS ARE BASED ON NORTH AMERICAN VERTICAL DATUM OF 1988 (NAVD 88)
- 2. THE CROSS SLOPE ON ADA ACCESSIBLE ROUTES SHALL NOT EXCEED 2.0%. THE LONGITUDINAL SLOPE ON ADA ACCESSIBLE ROUTES (NOT INCLUDING RAMPS) SHALL NOT EXCEED 5.0%. THE LONGITUDINAL SLOPE FOR RAMPS SHALL NOT EXCEED 1V:12H (8.3%). ACCESSIBLE PARKING SPACES SHALL NOT EXCEED 2.0% IN ANY DIRECTION (INCLUDING DIAGONAL).
- 3. ALL CATCH BASINS AND DRAINAGE COLLECTION STRUCTURES SHALL BE DESIGNED WITH AN EIGHTEEN INCH (18") VERTICAL SUMP FROM THE INVERT ELEVATION (OR BOTTOM OF BAFFLE) TO THE BOTTOM OF THE STRUCTURE.
- 4. DRAINAGE STRUCTURES SHALL BE CONSTRUCTED USING U.S. PRECAST (USP) U.S. FOUNDRY (USF) OR FLORIDA DEPARTMENT OF TRANSPORTATION STANDARD (FDOT) PRODUCTS AS SPECIFIED OR APPROVED EQUAL. ALL STORM DRAINAGE STRUCTURES MUST COMPLY WITH THE TOWN OF PALM BEACH DETAILS AND REGULATIONS.
- 4. ROOF DRAIN CONNECTIONS TO DRAINAGE PIPE SHALL BE AS FOLLOWS:
 A. FOR ADS N-12 CORRUGATED POLYETHYLENE DRAINAGE PIPE USE ADS DUAL WALL FABRICATED REDUCING SADDLE TEE 4"-24" DIAMETER
- B. FOR RCP DRAINAGE PIPE MAKE CONNECTION FDOT INDEX 280, CONCRETE COLLAR FOR JOINING MAINLINE PIPE AND STUB PIPE DETAIL
- C. NOTIFY CONSULTANT FOR CONNECTION METHOD TO STEEL PIPE.
- 5. ALL RAMPS SHALL COMPLY WITH FDOT INDEX 522.
- 6. STORM DRAIN PIPE SHALL BE AS FOLLOWS:

 A. REINFORCED CONCRETE PIPE (RCP) CLASS III PER ASTM C-76 OR HIGH DENSITY

 POLY-ETHYLENE (HDPE) PIPE FOR 24" OR LESS FOR PIPES AND

 HP (HIGH PERFORMANCE) STORM PIPE FOR PIPES 30" AND LARGER. ROOF
- LEADER PIPE MATERIAL SHALL BE PVC SDR-35.

 B. CORRUGATED POLYETHYLENE PIPE PER AASHTO M294 JOINTS SHALL BE WATER TIGHT
- C. ANY STORM PIPE USED MUST BE APPROVED BY LOCAL AUTHORITIES. CONTRACTOR SHALL SELECT THE MOST ECONOMICAL PRODUCT.
- CONTRACTOR SHALL CLEAN ALL PROPOSED DRAINAGE STRUCTURES AND PIPES UPON COMPLETION OF CONSTRUCTION.
- 8. PROPOSED ELEVATIONS OF CURB REPRESENT FACE OF CURB OR EDGE OF PAVEMENT ELEVATIONS UNLESS OTHERWISE NOTED.
- 9. PROPOSED ELEVATIONS IN ALL PERVIOUS AREAS REPRESENT FINISHED TOP OF SOD/GRASS OR ANY OTHER LANDSCAPING MATERIAL.
- 10 ALL DRAINAGE STRUCTURES SHALL CONFORM TO THE LATEST FOOT INDEX
- 10. ALL DRAINAGE STRUCTURES SHALL CONFORM TO THE LATEST FDOT INDEX STANDARDS. CONTRACTOR SHALL SUBMIT SHOP DRAWINGS TO THE ENGINEER PRIOR TO COMMENCEMENT OF CONSTRUCTION.
- 11. MATCH EXISTING GRADES AT TIE-IN LOCATIONS AT PROPERTY LINES.
- 12. TOP OF LANDSCAPED OR SODDED AREA AGAINST BUILDING SHALL BE MIN. 4"
 BELOW FINISH FLOOR ELEVATION AND AGAINST SIDEWALK SHALL BE MIN. 2"
 BELOW FINISH GRADE.

VERTICAL DATUM
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IT'S THE LAW!
DIAL 811

Know what's below.
Call before you dig.

SUNSHINE STATE ONE CALL OF FLORIDA, INC.

AME

EXISTING STORM MANHOLE S SANITARY MANHOLE ——F——F—— FIRE LINE PIPE — w — w — water pipe FIRE HYDRANT FIRE DEPARTMENT CONNECTION ——FOC——FOC—— FIBER OPTIC LINE OE OE OVERHEAD LINE TEL TEL TEL TELEPHONE LINE —— COM —— COMMUNICATIONS LINE ---E-E-UNDERGROUND ELECTRIC LINE ---- FPL ---- FPL LINE — — — — — EXISTING UTILITY EASEMENTS — — — — — PROPOSED UTILITY EASEMENTS

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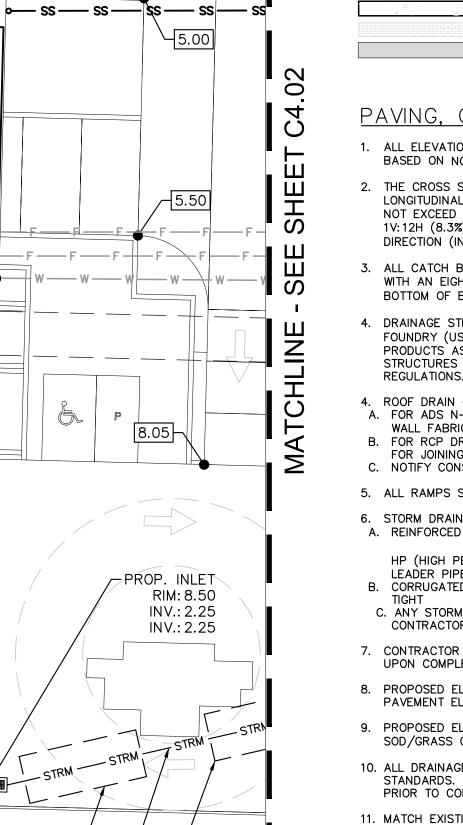
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11. MATCH EXISTING GRADES AT TIE-IN LOCATIONS AT PROPERTY LINES.

12. TOP OF LANDSCAPED OR SODDED AREA AGAINST BUILDING SHALL BE MIN. 4" BELOW FINISH FLOOR ELEVATION AND AGAINST SIDEWALK SHALL BE MIN. 2" BELOW FINISH GRADE.



PROP. DRAINAGE WELLS

OBSERVED M.H.W.L.

__38 LF OF PROP. 15"

<u> 12.95</u>

STORM PIPE

PROP. 15" STORM PIPE-

PROP. INLET

10.00

PROP. DRAINAGE WELLS

CAPACITY = 100 GPM

10 LF OF PROP. 15"

RIM: 8.95

INV.: 2.25 -

STORM PIPE -

RIM: 8.95

INV.: 2.25

INV.: 2.25 ¬

411.00

PROP. INLET

RIM: 8.95

INV.: 2.25

INV.: 2.25

POOL

EDGEWATER

5-STORY BUILDING

FFE: 13.00 NAVD

__119 LF OF PROP. 10'

EXFILTRATION TRENCH

— STRM — STRM — STRM — STRM — STRM — STRM —

PROP. MANHOLE

RIM: 8.00

INV.: 2.25

INV.: 2.25 -

-67 LF OF PROP. 10' EXFILTRATION TRENCH

-151 LF OF PROP. 15" STORM PIPE

-42 LF OF PROP. 10'

128 LF OF

PROP. 15" STORM PIPE -

EXFILTRATION TRENCH

CAPACITY = 100 GPM

RIM: 9.00

INV.: 2.00 -

84 LF OF PROP. 15"

10.50

12.95

8.50

10.50

25 LF OF PROP. 10'

EXFILTRATION TRENCH-

64 LF OF PROP. 15"

STORM PIPE-

15 LF OF PROP. 10' EXFILTRATION TRENCH-

STORM PIPE-

— STRM —— STRM —— STRM ——

<u>√ERTICAL DATUM</u> ELEVATIONS SHOWN HEREON ARE BASED ON THE NORTH AMERICAN VERTICAL DATUM OF 1988. NAVD '88 ELEV. + 1.57' = NGVD '29 ELEVATION

THE PRESENCE OF GROUNDWATER SHOULD BE ANTICIPATED. CONTRACTOR'S BID SHALL INCLUDE CONSIDERATION FOR ADDRESSING THIS ISSUE AND OBTAINING ALL NECESSARY PERMITS. CALL 2 WORKING DAYS IT'S THE LAW! Know what's **below. DIAL 811**

SUNSHINE STATE ONE CALL OF FLORIDA, INC.

SHEET NUMBER

BEFORE YOU DIG


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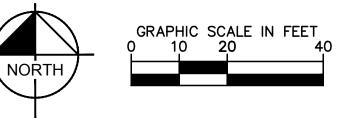
 \sim 5. ALL RAMPS SHALL COMPLY WITH FDOT INDEX 522.

----27--- Existing contour elevations 9ROPOSED SPOT ELEVATION 30.00 ±ME → MATCH EXISTING ELEVATION EXISTING ELEVATION FLOW ARROW PROPOSED CONCRETE SIDEWALK PROPOSED PAVERS PROPOSED ASPHALT PAVEMENT PAVING, GRADING AND DRAINAGE NOTES

N Z ОШ A

NN DR PA



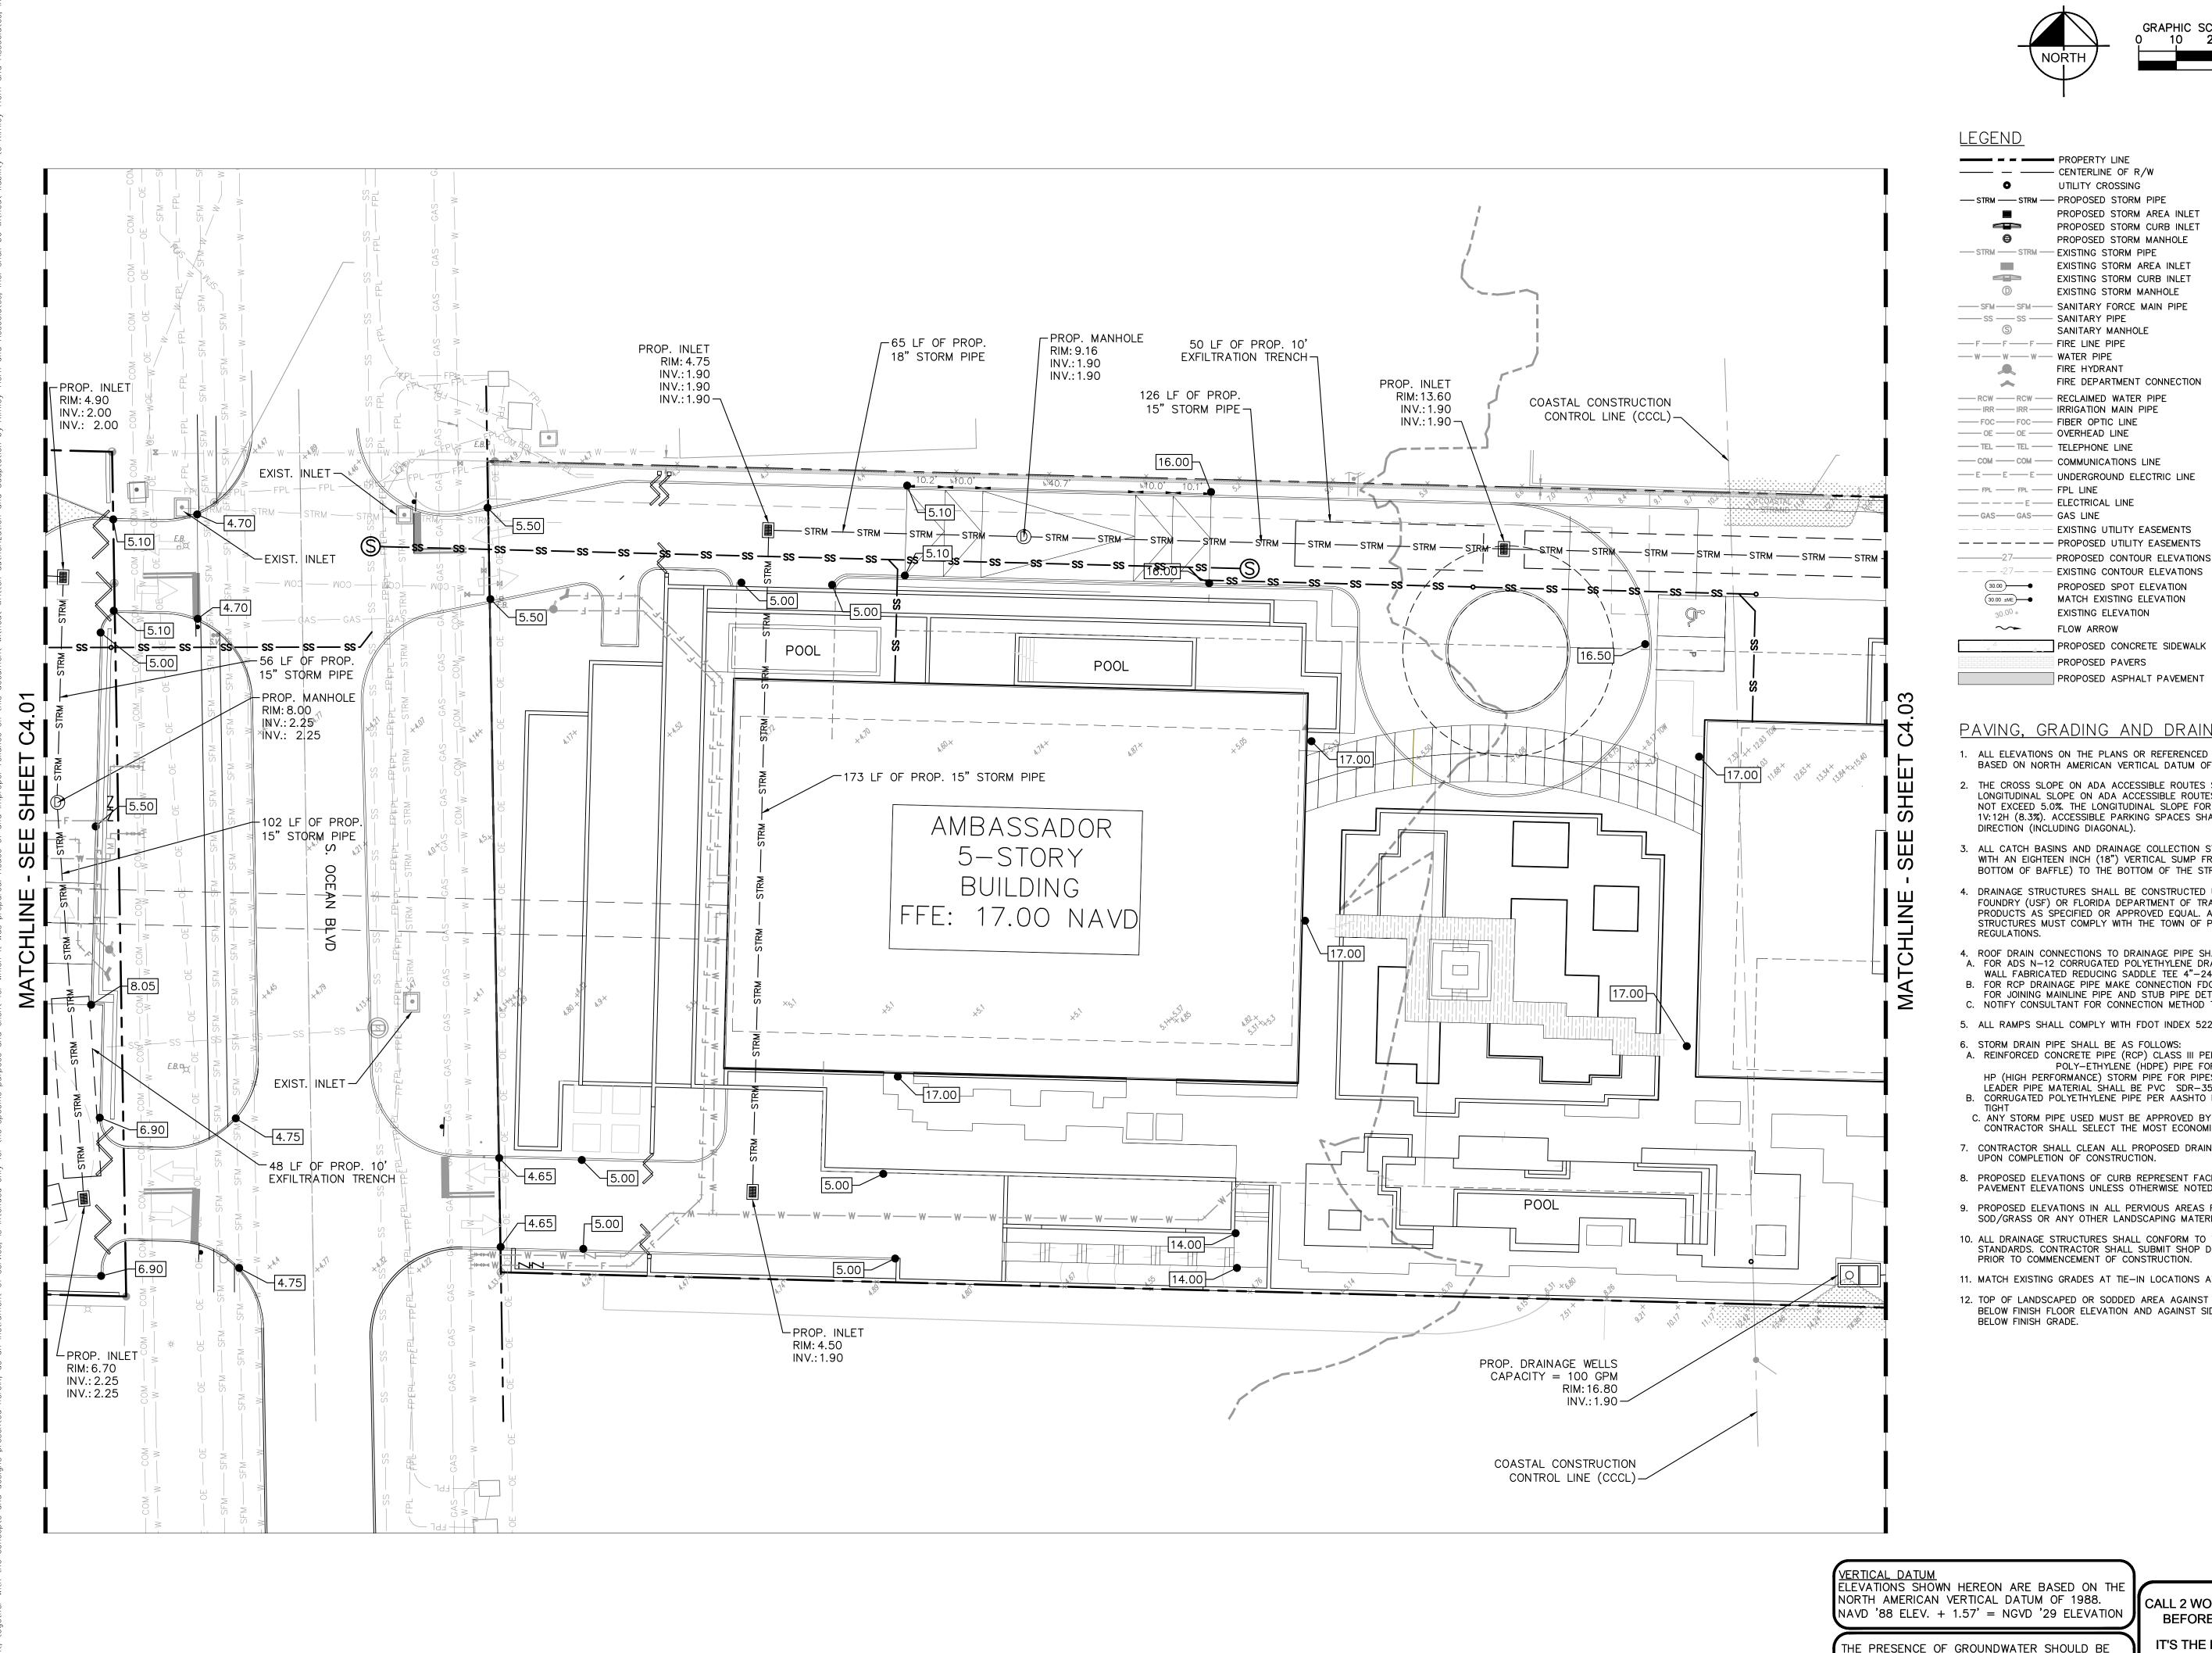

PROPERTY LINE ——— — CENTERLINE OF R/W UTILITY CROSSING PROPOSED STORM AREA INLET PROPOSED STORM CURB INLET PROPOSED STORM MANHOLE EXISTING STORM AREA INLET EXISTING STORM CURB INLET EXISTING STORM MANHOLE SANITARY MANHOLE ——F——F—— FIRE LINE PIPE — w — w — water pipe FIRE HYDRANT FIRE DEPARTMENT CONNECTION ——FOC——FOC—— FIBER OPTIC LINE OE OE OVERHEAD LINE ----TEL ----- TELEPHONE LINE —— COM —— COMMUNICATIONS LINE ---E-E-UNDERGROUND ELECTRIC LINE ---- FPL ---- FPL LINE — — — — — EXISTING UTILITY EASEMENTS ---- PROPOSED UTILITY EASEMENTS

PAVING, GRADING AND DRAINAGE NOTES

PROPOSED CONCRETE SIDEWALK

PROPOSED ASPHALT PAVEMENT

EXISTING ELEVATION

PROPOSED PAVERS

FLOW ARROW

1. ALL ELEVATIONS ON THE PLANS OR REFERENCED IN THE SPECIFICATIONS ARE BASED ON NORTH AMERICAN VERTICAL DATUM OF 1988 (NAVD 88)

THE CROSS SLOPE ON ADA ACCESSIBLE ROUTES SHALL NOT EXCEED 2.0%. THE LONGITUDINAL SLOPE ON ADA ACCESSIBLE ROUTES (NOT INCLUDING RAMPS) SHALL NOT EXCEED 5.0%. THE LONGITUDINAL SLOPE FOR RAMPS SHALL NOT EXCEED 1V:12H (8.3%). ACCESSIBLE PARKING SPACES SHALL NOT EXCEED 2.0% IN ANY DIRECTION (INCLUDING DIAGONAL).

3. ALL CATCH BASINS AND DRAINAGE COLLECTION STRUCTURES SHALL BE DESIGNED WITH AN EIGHTEEN INCH (18") VERTICAL SUMP FROM THE INVERT ELEVATION (OR BOTTOM OF BAFFLE) TO THE BOTTOM OF THE STRUCTURE.

4. DRAINAGE STRUCTURES SHALL BE CONSTRUCTED USING U.S. PRECAST (USP) U.S. FOUNDRY (USF) OR FLORIDA DEPARTMENT OF TRANSPORTATION STANDARD (FDOT) PRODUCTS AS SPECIFIED OR APPROVED EQUAL. ALL STORM DRAINAGE STRUCTURES MUST COMPLY WITH THE TOWN OF PALM BEACH DETAILS AND

4. ROOF DRAIN CONNECTIONS TO DRAINAGE PIPE SHALL BE AS FOLLOWS:

A. FOR ADS N-12 CORRUGATED POLYETHYLENE DRAINAGE PIPE USE ADS DUAL

WALL FABRICATED REDUCING SADDLE TEE 4"-24" DIAMETER B. FOR RCP DRAINAGE PIPE MAKE CONNECTION FDOT INDEX 280, CONCRETE COLLAR FOR JOINING MAINLINE PIPE AND STUB PIPE DETAIL

C. NOTIFY CONSULTANT FOR CONNECTION METHOD TO STEEL PIPE.

5. ALL RAMPS SHALL COMPLY WITH FDOT INDEX 522.

6. STORM DRAIN PIPE SHALL BE AS FOLLOWS:

A. REINFORCED CONCRETE PIPE (RCP) CLASS III PER ASTM C-76 OR HIGH DENSITY POLY-ETHYLENE (HDPE) PIPE FOR 24" OR LESS FOR PIPES AND HP (HIGH PERFORMANCE) STORM PIPE FOR PIPES 30" AND LARGER. ROOF

LEADER PIPE MATERIAL SHALL BE PVC SDR-35.

B. CORRUGATED POLYETHYLENE PIPE PER AASHTO M294 JOINTS SHALL BE WATER

C. ANY STORM PIPE USED MUST BE APPROVED BY LOCAL AUTHORITIES. CONTRACTOR SHALL SELECT THE MOST ECONOMICAL PRODUCT.

7. CONTRACTOR SHALL CLEAN ALL PROPOSED DRAINAGE STRUCTURES AND PIPES UPON COMPLETION OF CONSTRUCTION.

8. PROPOSED ELEVATIONS OF CURB REPRESENT FACE OF CURB OR EDGE OF PAVEMENT ELEVATIONS UNLESS OTHERWISE NOTED.

9. PROPOSED ELEVATIONS IN ALL PERVIOUS AREAS REPRESENT FINISHED TOP OF SOD/GRASS OR ANY OTHER LANDSCAPING MATERIAL.


10. ALL DRAINAGE STRUCTURES SHALL CONFORM TO THE LATEST FDOT INDEX STANDARDS. CONTRACTOR SHALL SUBMIT SHOP DRAWINGS TO THE ENGINEER

PRIOR TO COMMENCEMENT OF CONSTRUCTION. 11. MATCH EXISTING GRADES AT TIE-IN LOCATIONS AT PROPERTY LINES.

12. TOP OF LANDSCAPED OR SODDED AREA AGAINST BUILDING SHALL BE MIN. 4" BELOW FINISH FLOOR ELEVATION AND AGAINST SIDEWALK SHALL BE MIN. 2"

ELEVATIONS SHOWN HEREON ARE BASED ON THE NORTH AMERICAN VERTICAL DATUM OF 1988. NAVD '88 ELEV. + 1.57' = NGVD '29 ELEVATION

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IT'S THE LAW! Know what's below. **DIAL 811** Call before you dig.

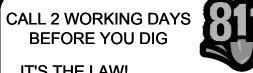SUNSHINE STATE ONE CALL OF FLORIDA, INC.

SHEET NUMBER C4.02

PLA VINC DR PA



GRAPHIC SCALE IN FEET
0 10 20 40

<u>LEGEND</u>

PROPERTY LINE ——— — CENTERLINE OF R/W UTILITY CROSSING PROPOSED STORM AREA INLET PROPOSED STORM CURB INLET PROPOSED STORM MANHOLE EXISTING STORM AREA INLET EXISTING STORM CURB INLET EXISTING STORM MANHOLE S SANITARY MANHOLE ——F——F—— FIRE LINE PIPE FIRE HYDRANT FIRE DEPARTMENT CONNECTION ——FOC——FOC—— FIBER OPTIC LINE ----- OE ------ OVERHEAD LINE — TEL — TEL — TELEPHONE LINE —— COM —— COMMUNICATIONS LINE ---E-E-UNDERGROUND ELECTRIC LINE ---- FPL ---- FPL LINE — — — — — EXISTING UTILITY EASEMENTS — — — — — PROPOSED UTILITY EASEMENTS PROPOSED CONTOUR ELEVATIONS ----27--- Existing contour elevations 9ROPOSED SPOT ELEVATION 30.00 ±ME → MATCH EXISTING ELEVATION EXISTING ELEVATION \sim FLOW ARROW PROPOSED CONCRETE SIDEWALK

PAVING, GRADING AND DRAINAGE NOTES

PROPOSED ASPHALT PAVEMENT

PROPOSED PAVERS

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VERTICAL DATUM ELEVATIONS SHOWN HEREON ARE BASED ON THE NORTH AMERICAN VERTICAL DATUM OF 1988. NAVD '88 ELEV. + 1.57' = NGVD '29 ELEVATION

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IT'S THE LAW!
DIAL 811

Know what's below.
Call before you dig.

SUNSHINE STATE ONE CALL OF FLORIDA, INC.

N. Ou dig. SHEET NUMBER

DOWN

OWN

MXE

FL LICENSE NUMBER

67505


PHONE:

PAVING, GRADING ND DRAINAGE PLAN

IBASSADOR SEWATER PREPARED FOR OKO GROUP


TYPICAL SECTION A-A

NOT TO SCALE

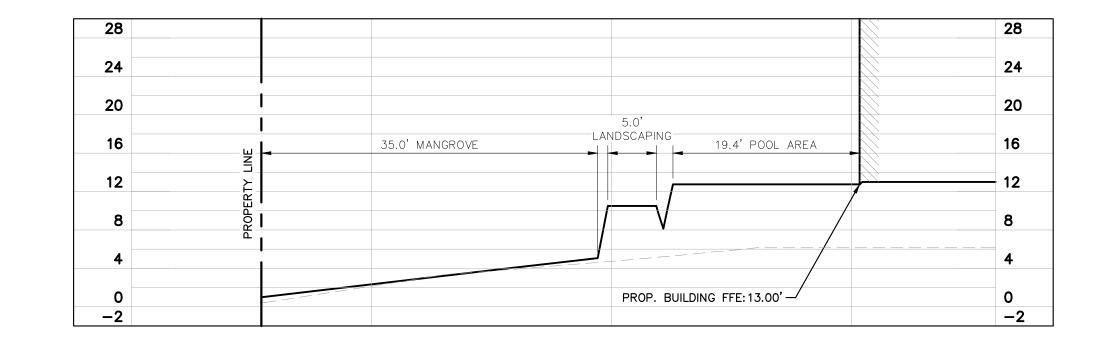


TYPICAL SECTION B-B

NOT TO SCALE

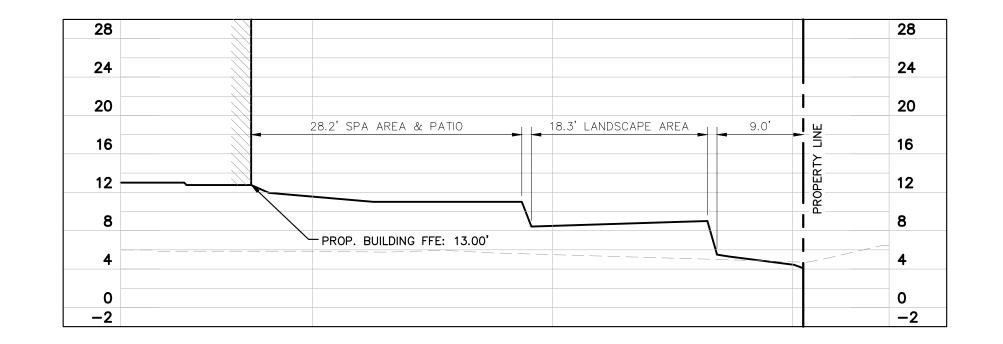


TYPICAL SECTION C-C

NOT TO SCALE

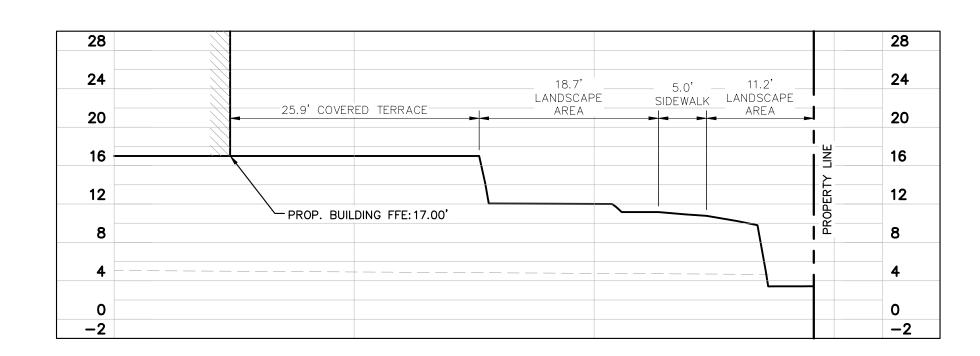


TYPICAL SECTION D-D

NOT TO SCALE

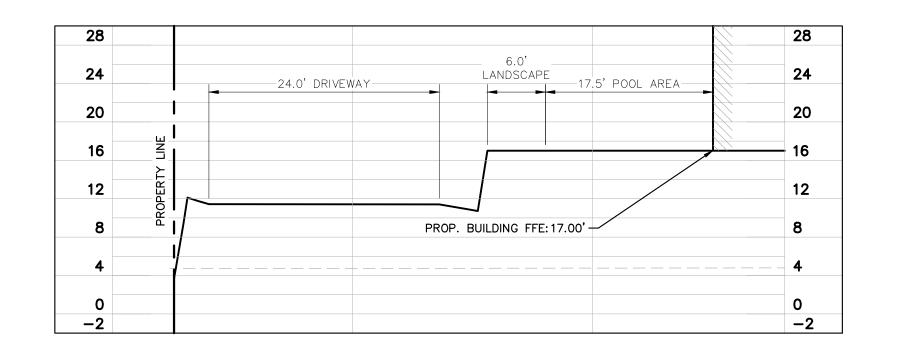

TYPICAL SECTION E-E

NOT TO SCALE

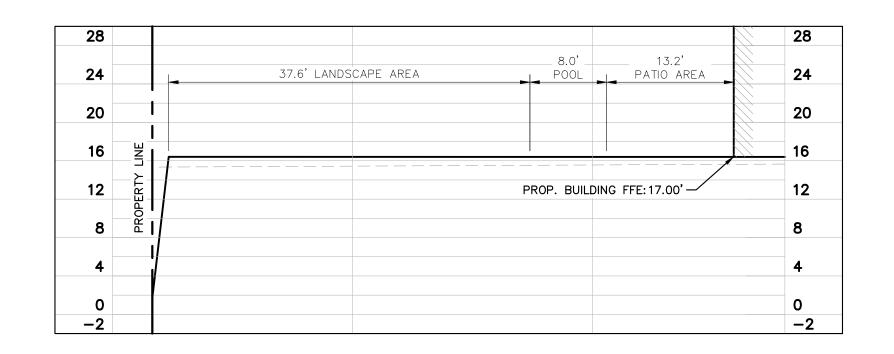

TYPICAL SECTION F-F

NOT TO SCALE



175 No. REVISIONS DAT

S KIMLEY-HORN AND ASSOCIATES, INC.
S. CONGRESS AVE, SUITE 201,
DELRAY BEACH, FL 33445
61-330-2345 FAX: 561-863-81


JOSHUA D. HORNING
FL LICENSE NUMBER
67505


DATE
JAN. 2025
SCALE AS SHOWN
DESIGNED BY MXE
PRAWN BY MXE

PICAL SECTIONS

AMBASSADOR EDGEWATER PREPARED FOR OKO GROLIP


PALM BEACH OX

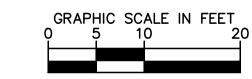

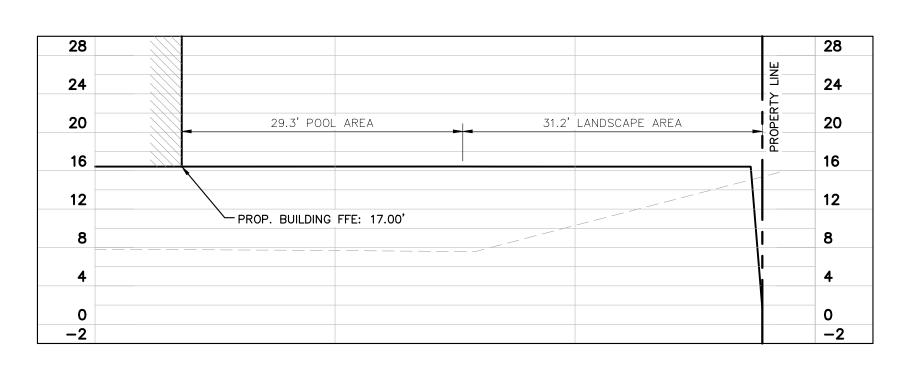


TYPICAL SECTION G-G

NOT TO SCALE

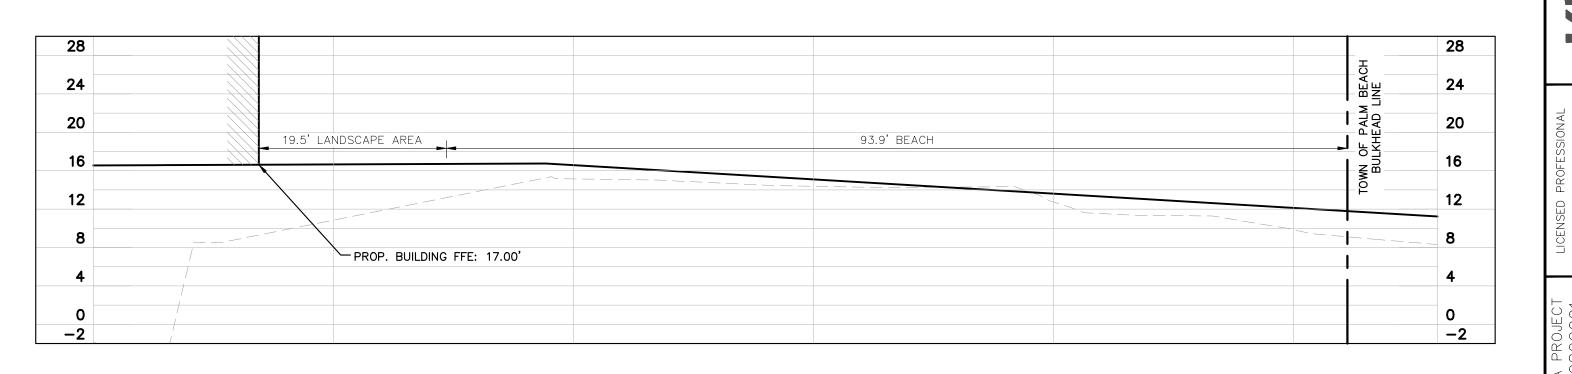


TYPICAL SECTION H-H

NOT TO SCALE

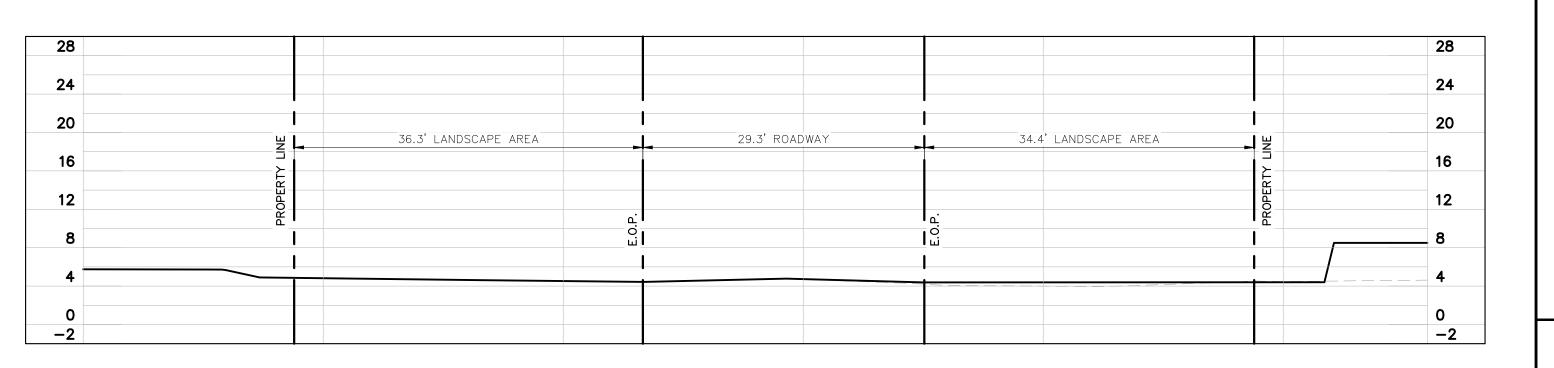

TYPICAL SECTION I-I

NOT TO SCALE

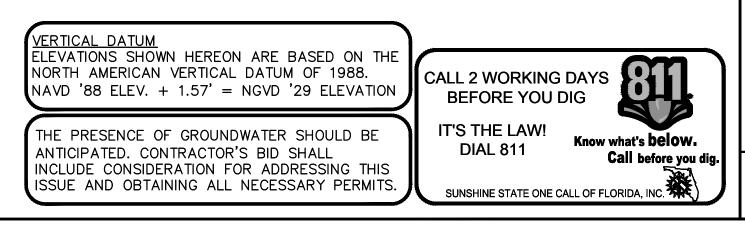

8175 No. REVISIONS DA

DELRAY BEACH, FL 33445

JET 561-330-2345 FAX: 561-863-8175

S SHOWN
WXE MXE FL LICENSE NUMBER
67505


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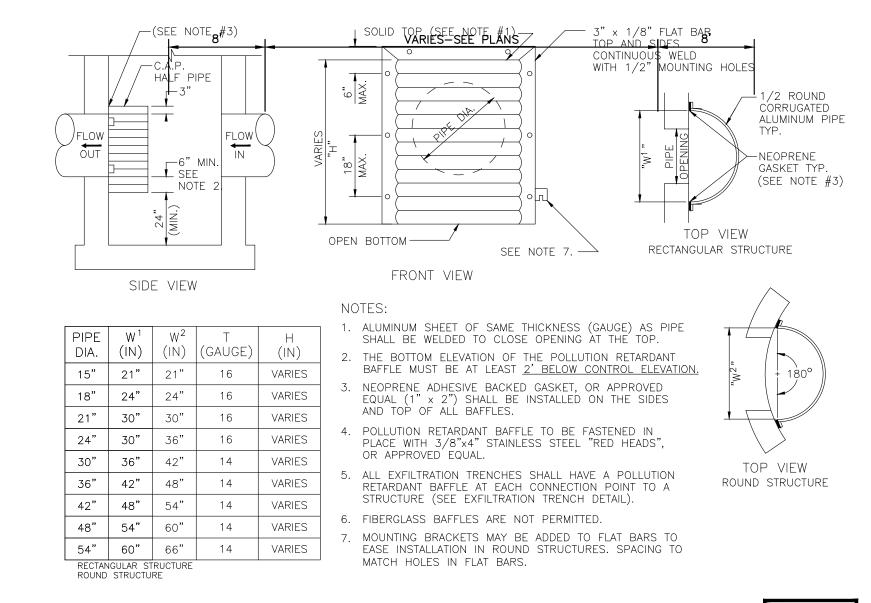
SECTIONS

SCALE AS SH
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TYPICAL SECTION


AMBASSADOR EDGEWATER PREPARED FOR




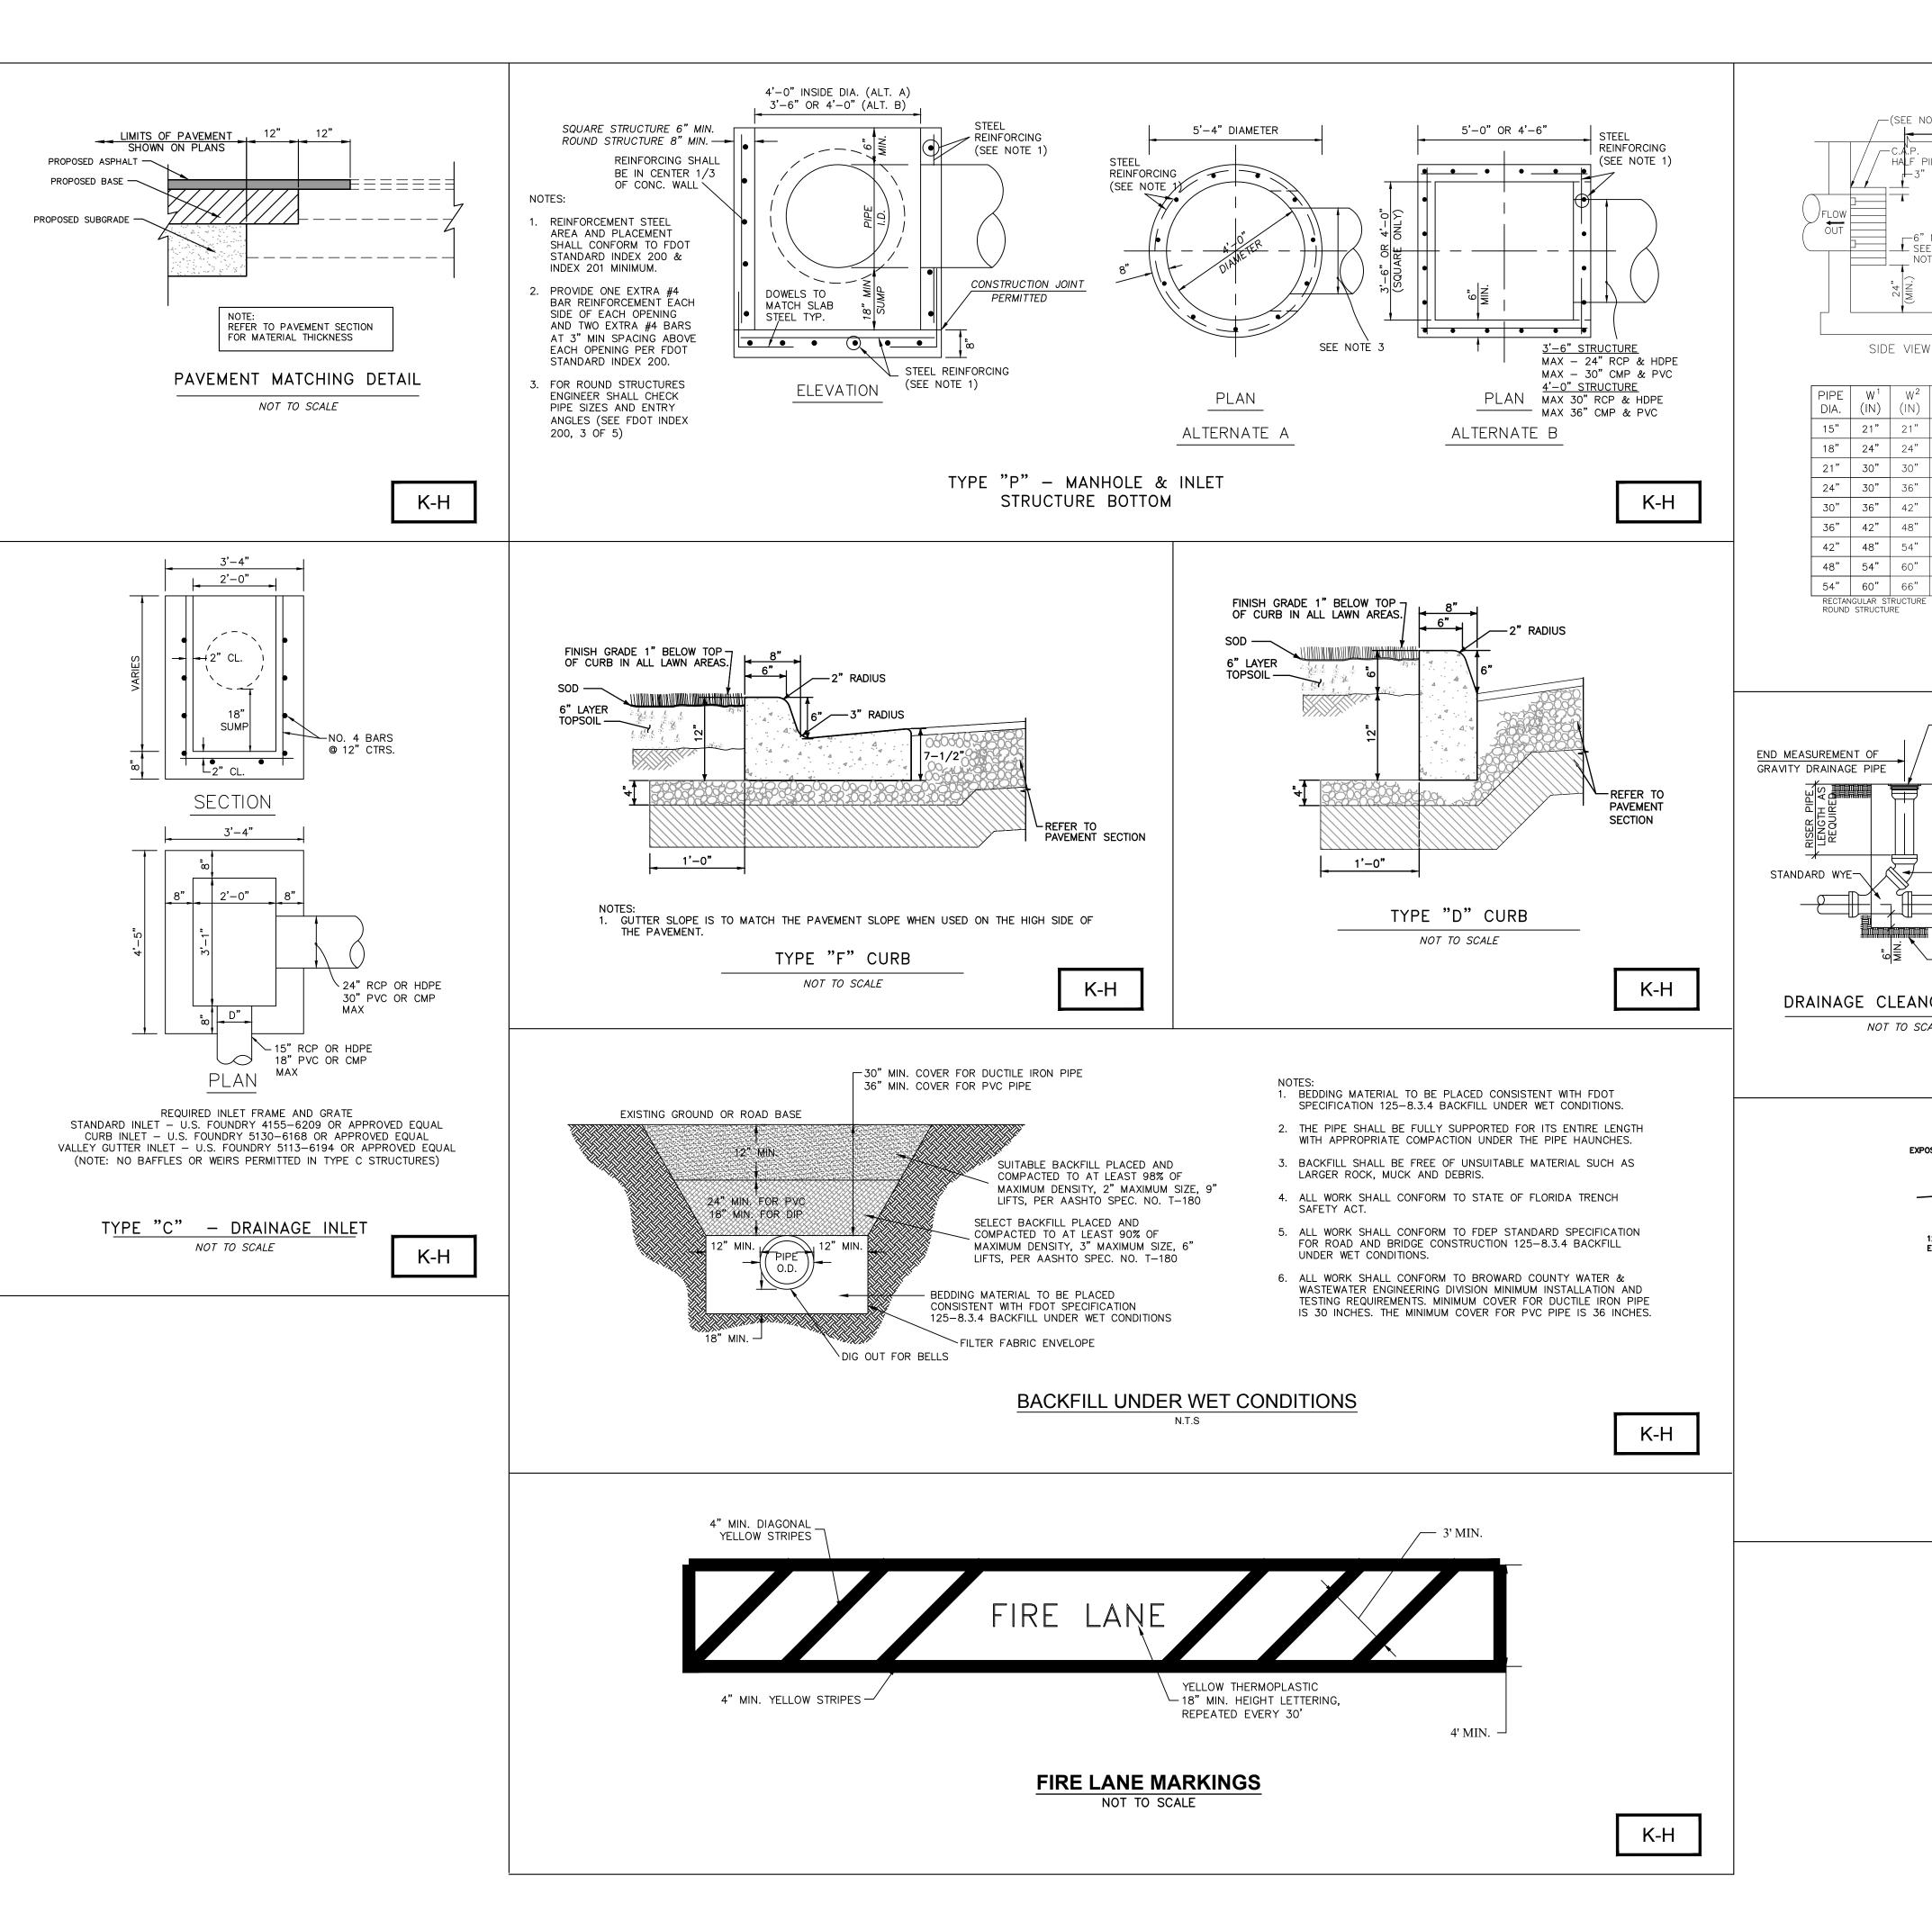

POLLUTION RETARDANT BAFFLE

NOT TO SCALE

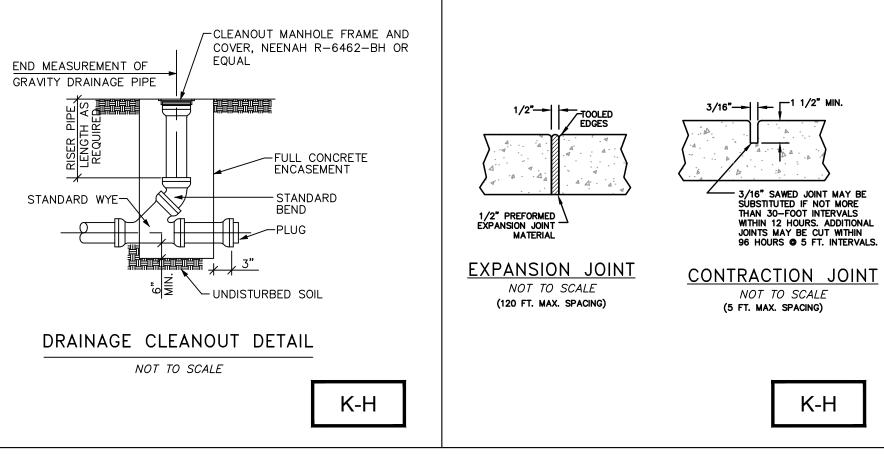

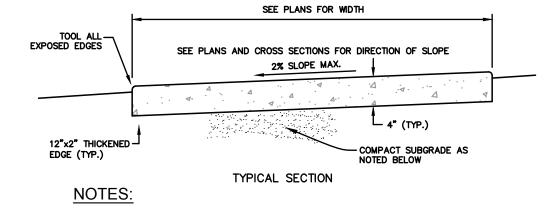

- 1. PROVIDE EXPANSION JOINTS BETWEEN SIDEWALK AND CURB OR AT ANY OTHER RIGID
- 2. EXPANSION JOINTS SHALL BE PROVIDED AT 120 FT. MAXIMUM SPACING.
- 3. ULTIMATE COMPRESSIVE STRENGTH OF CONCRETE SHALL BE 3,000 P.S.I. @ 28 DAYS FOR SIDEWALKS.
- 4. MINIMUM THICKNESS OF SIDEWALK SHALL BE 4" THICK CONCRETE.
- 5. FOR SIDEWALKS OR DRIVEWAYS WITHIN R.O.W., COMPACT SUBGRADE TO 98% OF MAXIMUM DENSITY AS DETERMINED BY ASTM1557. COMPACTION OUTSIDE R.O.W. MAY BE 95% OF MAXIMUM DENSITY.URS.

CONCRETE SIDEWALK DETAIL NOT TO SCALE

K-H

NOTE: DETAILS ARE INCLUDED FROM THE ENTITIES LISTED BELOW AND ARE PROVIDED FOR INFORMATIONAL PURPOSES ONLY. CONTRACTOR SHALL OBTAIN AND CONFORM WITH THE LATEST STANDARDS AND DETAILS.

K-H

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KIMLEY-HORN AND ASSOCIATES DETAIL


TOWN

TOWN OF PALM BEACH MUNICIPAL SERVICES DEPARTMENT DETAIL

PALM BEACH COUNTY WATER AND WASTEWATER DETAIL

MBASSADOR DGEWATER PREPARED FOR OKO GROUP

C4.10

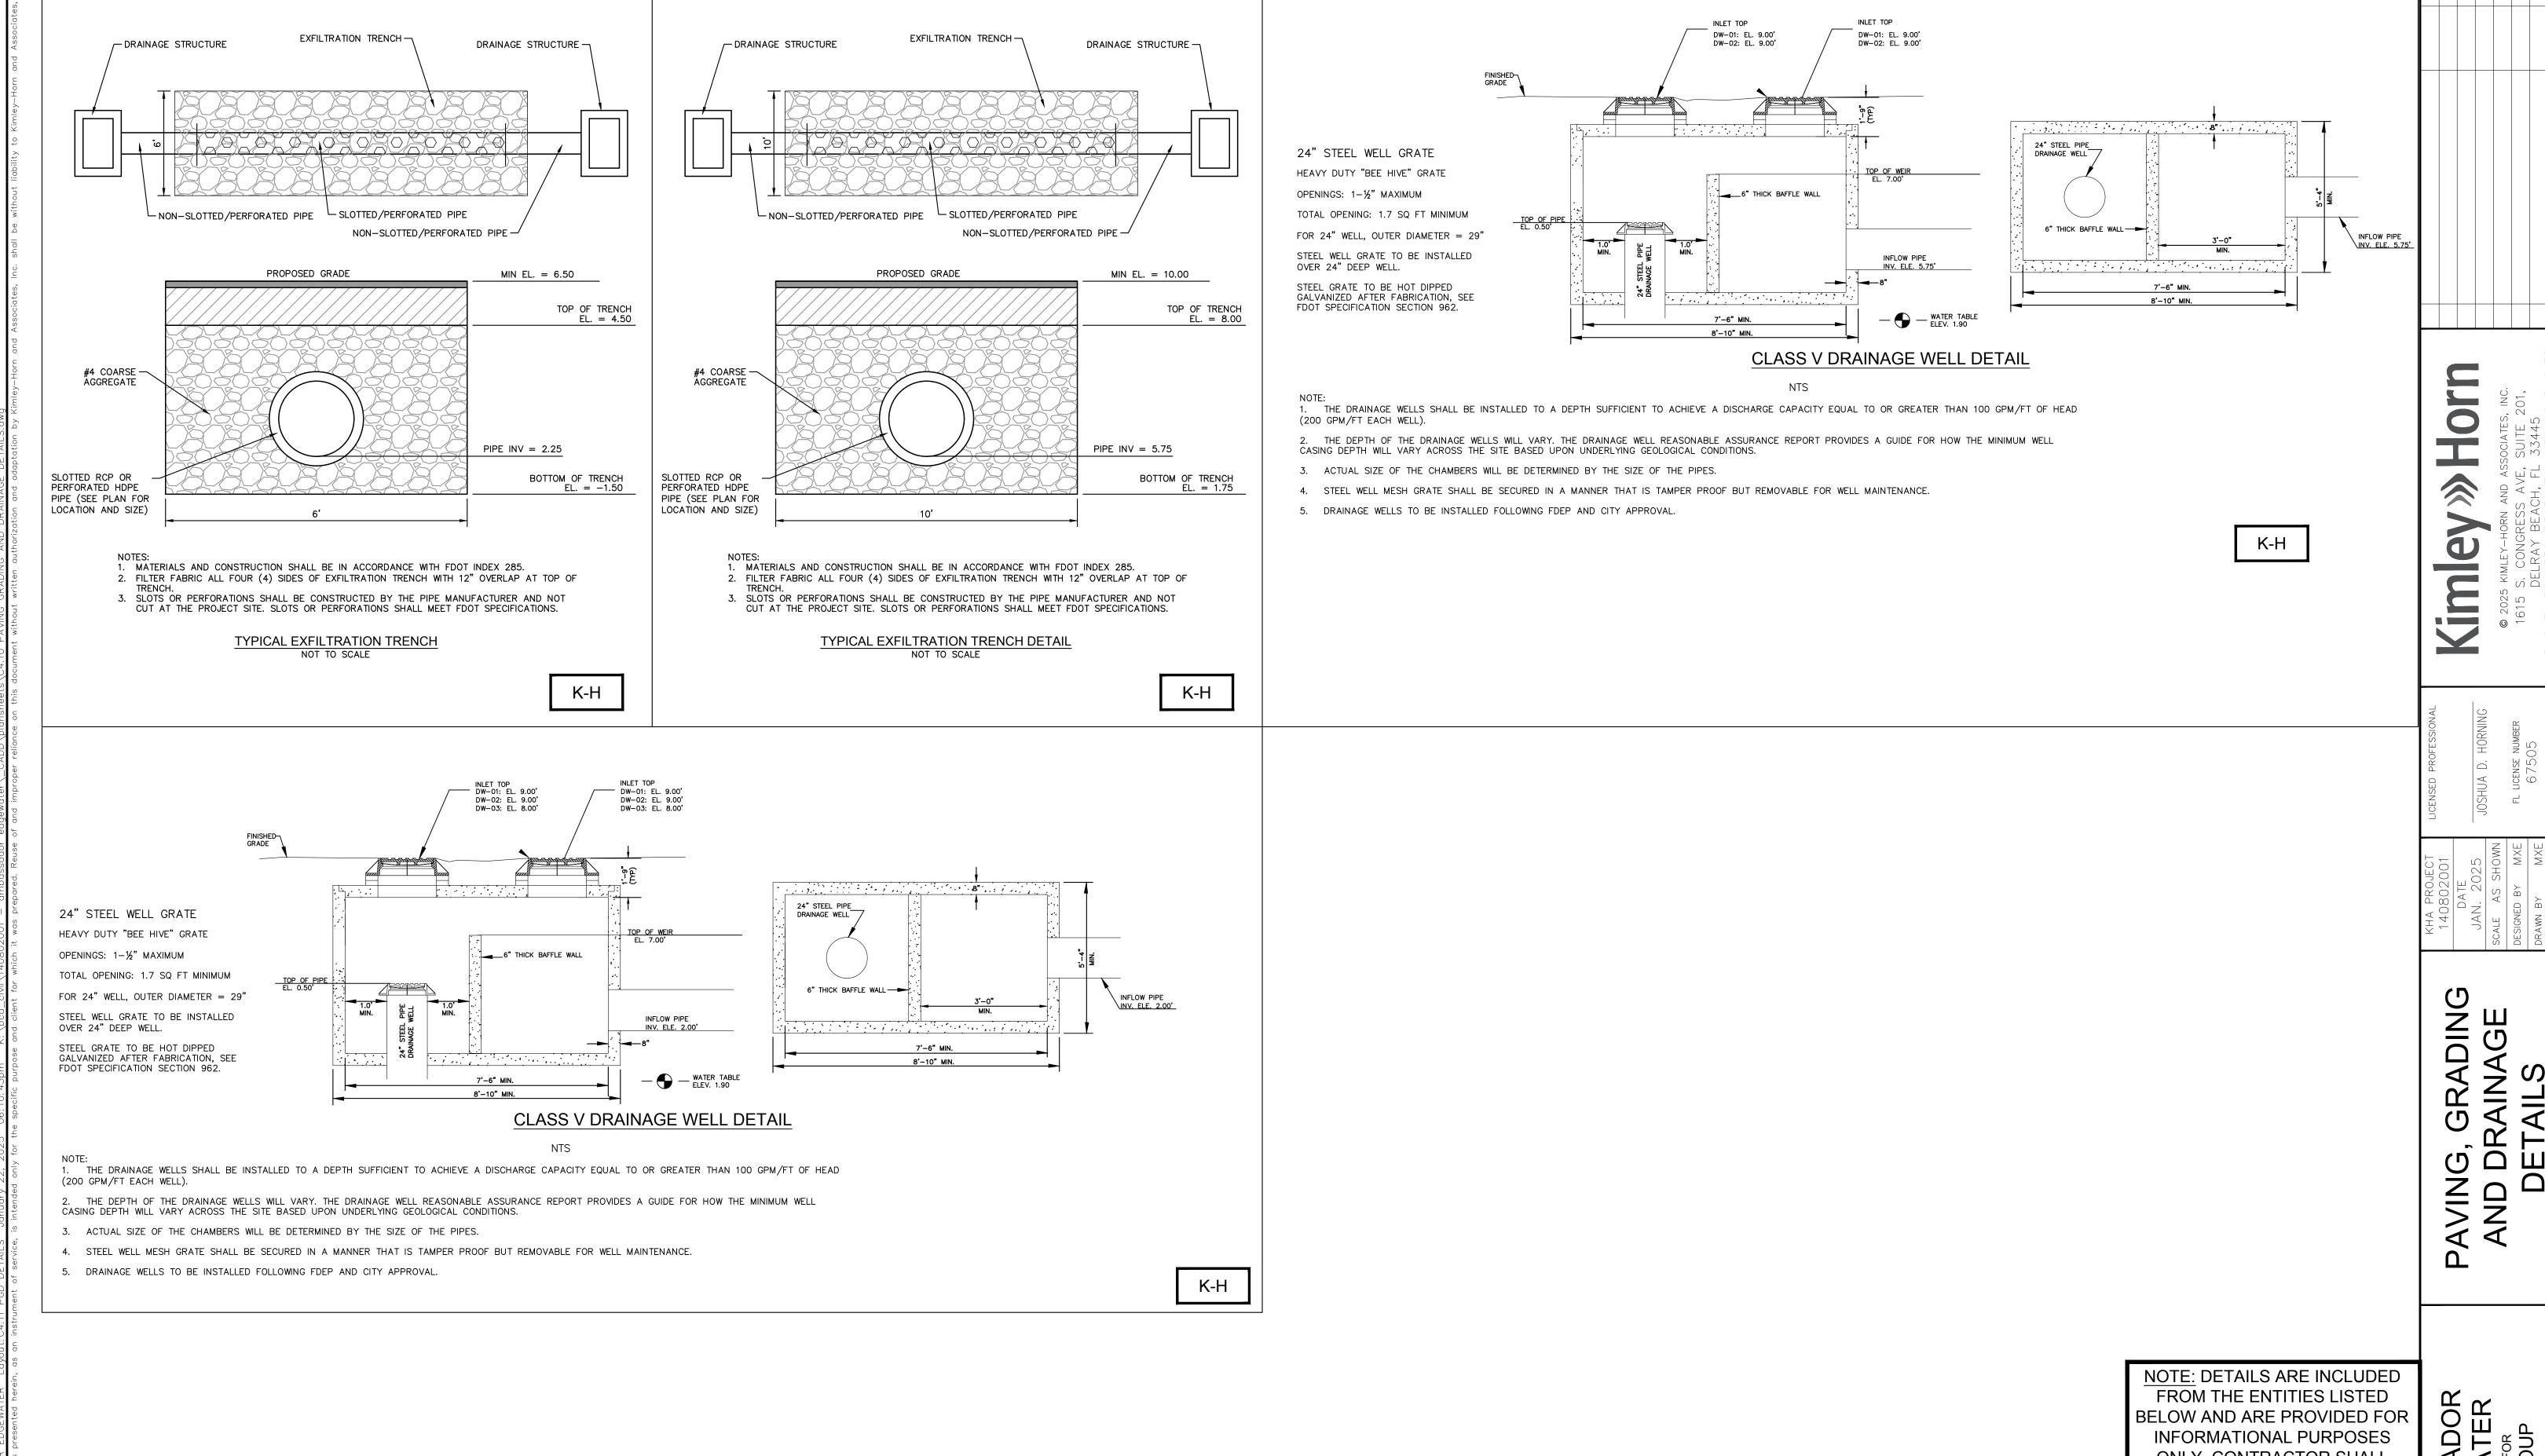

ONLY. CONTRACTOR SHALL OBTAIN AND CONFORM WITH THE LATEST STANDARDS AND DETAILS.


KIMLEY-HORN AND ASSOCIATES DETAIL


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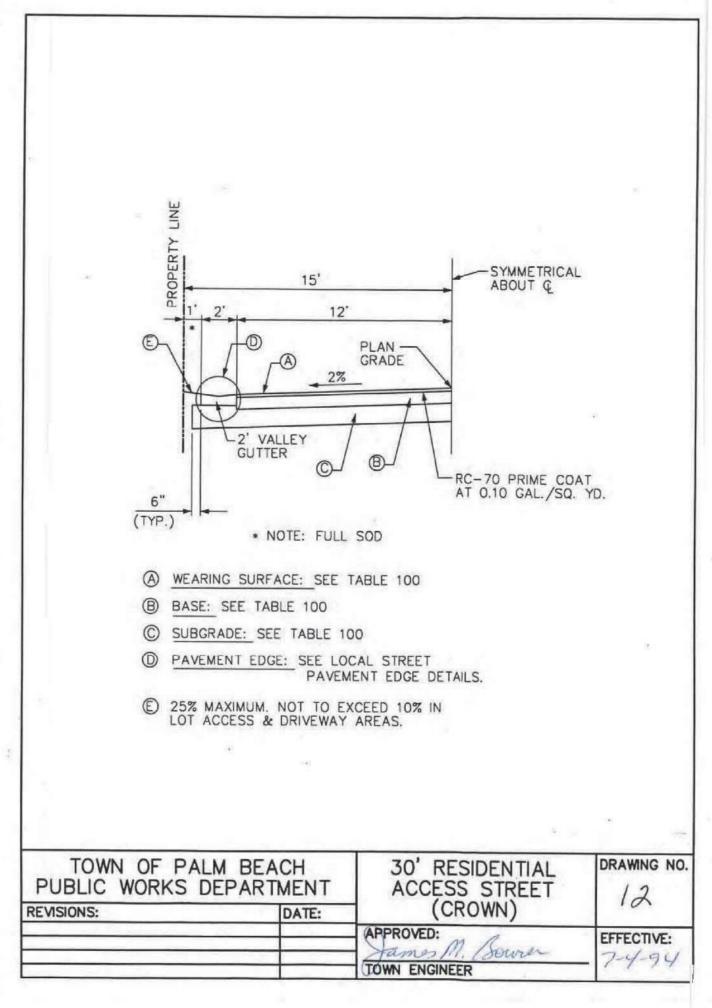
TOWN OF PALM BEACH MUNICIPAL SERVICES DEPARTMENT DETAIL


PALM BEACH COUNTY


WATER AND WASTEWATER DETAIL




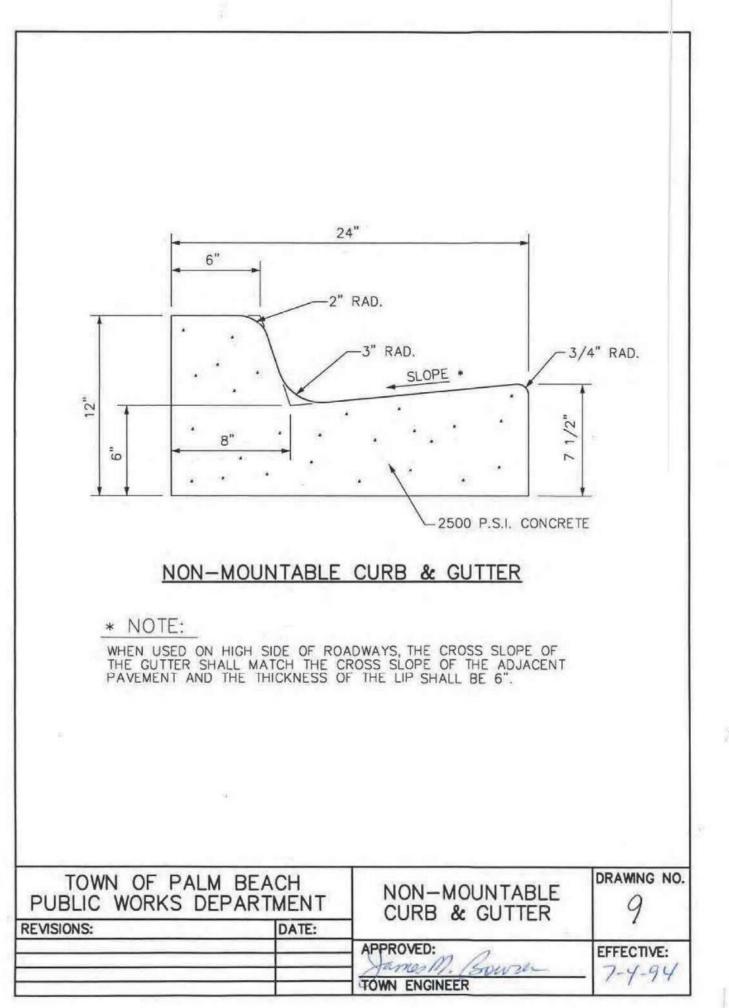


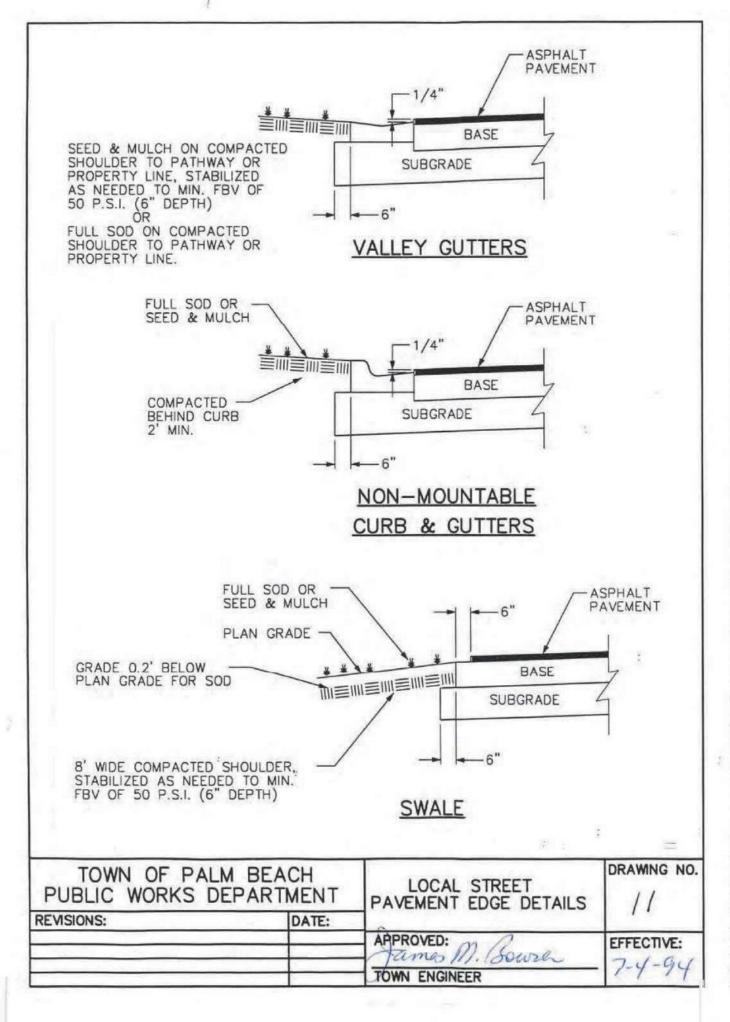


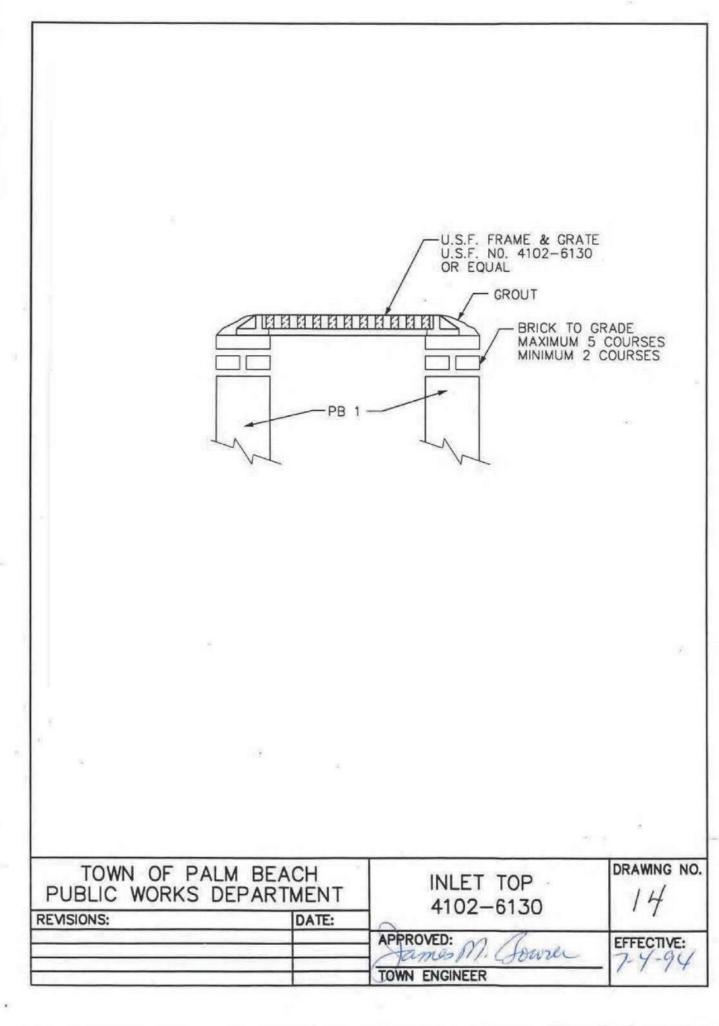


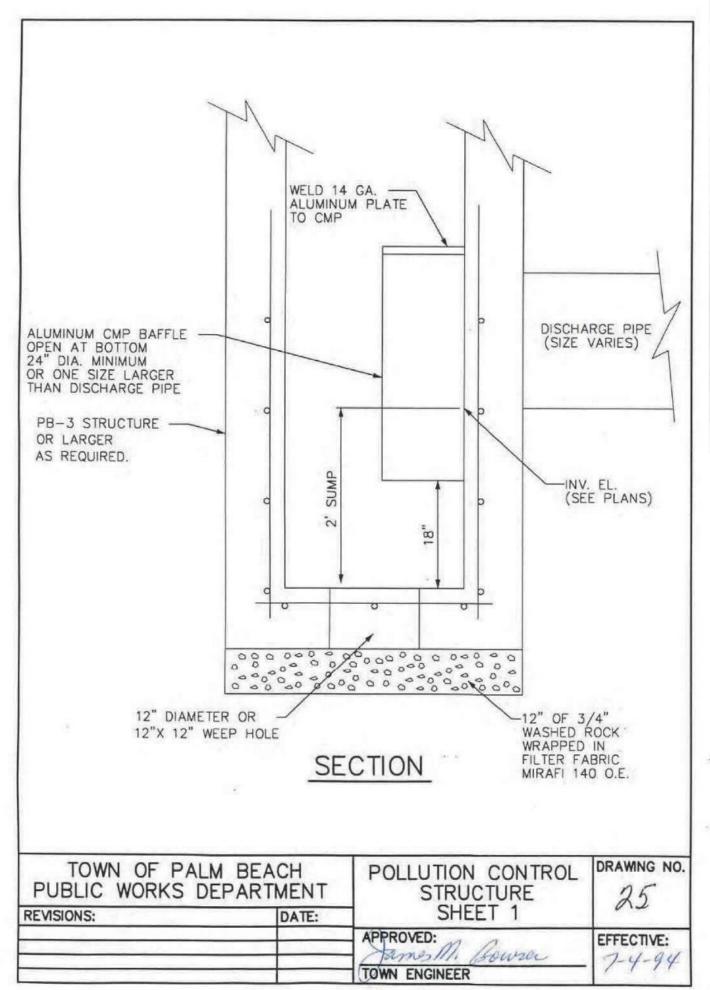

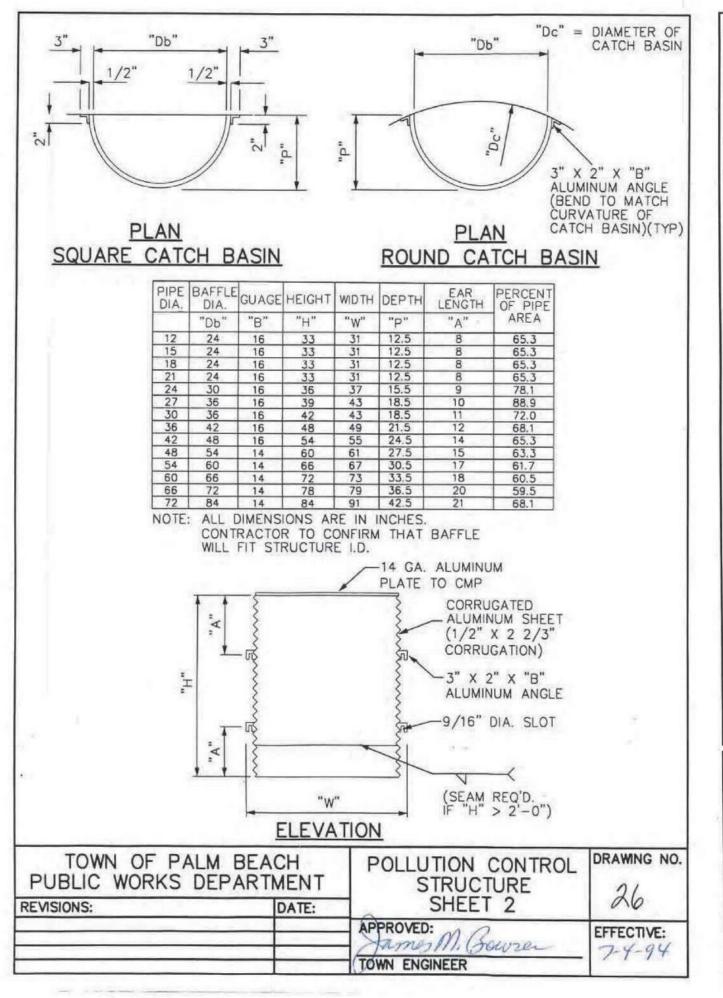

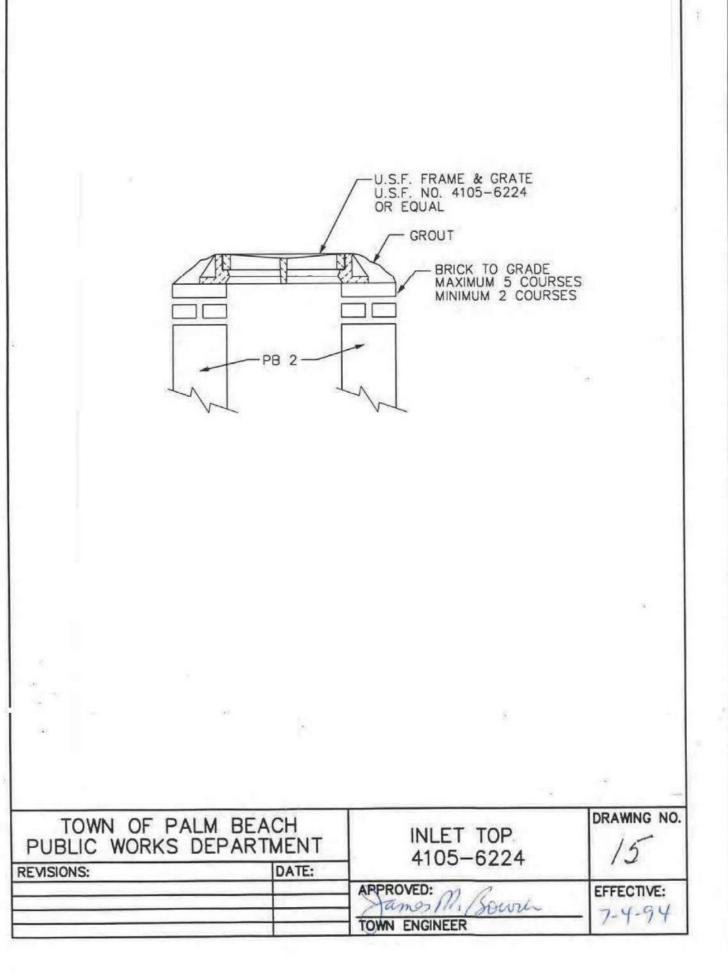

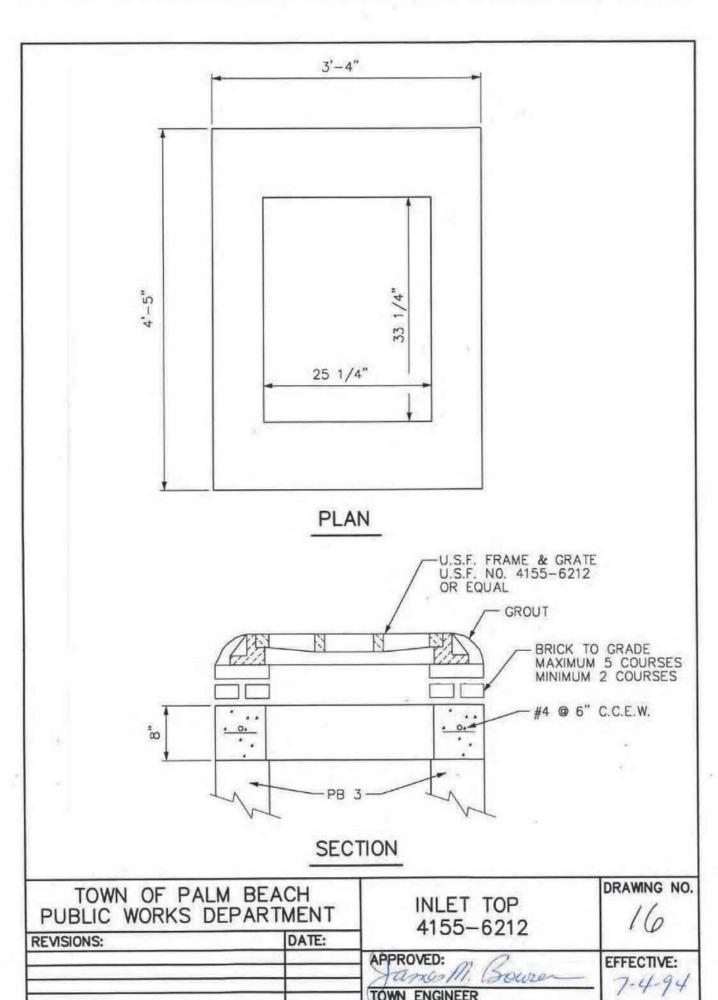


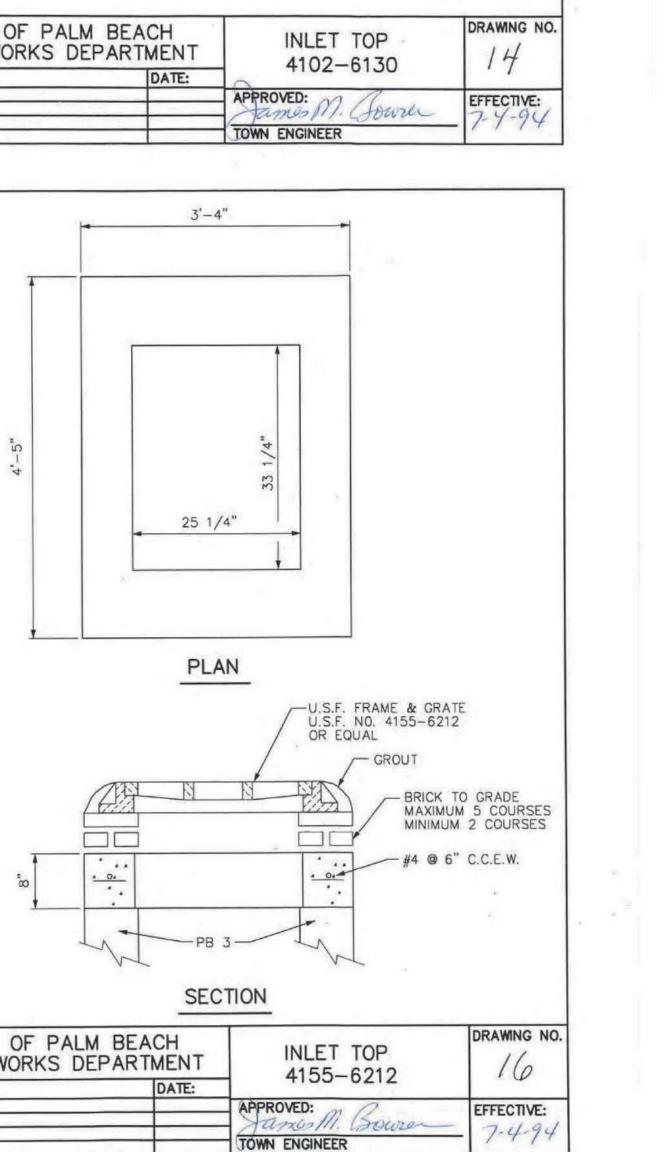



GRADIN

G

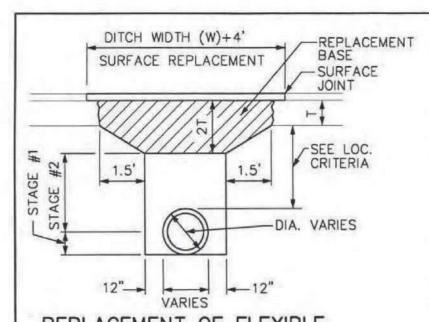

REPLACEMENT OF FLEXIBLE PAVEMENT FOR PERMITTED PAVEMENT CUT

DENSITY PROCEDURES:

THE BACKFILL FOR THE FIRST AND SECOND STAGES SHALL BE PLACED IN 6" LAYERS (COMPACTED THICK-NESS) AND SHALL BE COMPACTED TO 98% OF MAXIMUM DENSITY AS DETERMINED BY AASHTO T-180

STAGE #1

THE PERMITTEE SHALL PROVIDE ADEQUATE COMPACTED FILL BENEATH THE HAUNCHES OF THE PIPE, USING MECHANICAL TAMPS SUITABLE FOR THIS PURPOSE. THIS COMPACTION APPLIES TO THE MATERIAL PLACED BENEATH THE HAUCHES OF THE PIPE AND ABOVE ANY BEDDING REQUIRED.

STAGE #2

THE PERMITTEE SHALL OBTAIN A WELL-COMPACTED BED AND FILL ALONG THE SIDES OF THE PIPE AND TO A POINT INDICATING THE TOP OF SUB-GRADE MATERIAL.

BASE AND BACKFILL MATE-RIALS SHALL BE EITHER OF THE SAME TYPE AND COMPO-SITION AS THE MATERIALS REMOVED, OR OF EQUAL OR GREATER STRUCTURAL ADEQUACY MATERIALS CONTAMINATED WITH DELETERIOUS SUBSTANCES DUR-ING EXCAVATION SHALL NOT BE

GENERAL NOTES:

REPLACED BASE MATERIAL OVER DITCH SHALL BE TWICE THE THICKNESS OF THE ORIGINAL

BASE MATERIAL SHALL BE PLACED IN TWO OR THREE LAYERS AND EACH LAYER THOROUGHLY ROLLED OR TAMPED TO THE SPECIFIED

ASPHALT CONCRETE PAVEMENT JOINTS SHALL BE MECHANI-CALLY SAWED.

SURFACE TREATED PAVEMENT JOINTS SHALL BE LAPPED AND FEATHERED. SURFACE MATERIAL WILL BE

LIMEROCK, CRUSHED CONCRETE BASES

CONSISTENT WITH THE EXISTING SURFACE.

6" LAYERS COMPACTED THICKNESS DENSITY REQUIREMENTS:

98% UNDER ROADWAY 95% OUTSIDE THE TRAVELED ROADWAY, SUCH AS INTERSECTIONS, CROSS-OVERS, TURNOUTS, ETC.

95% SHOULDER PAVEMENT METHOD AASHTO T-180

NOTE: A TEMPORARY ASHALT PATCH (1 1/2" MINIMUM) SHALL BE APPLIED SAME DAY AS ROAD IS CUT AND MAINTAINED 90 DAYS BEFORE PLACEMENT OF FINAL WEARING SURFACE.

TOWN OF PALM B PUBLIC WORKS DEPA		REPLACEMENT OF FLEXIBLE PAVEMENT FOR PERMITTED	DRAWING NO.
REVISIONS:	DATE:	PAVEMENT CUT	
		APPROVED: M. Bower	EFFECTIVE:
		TOWN ENGINEER	- 1 /1

TABLE 100


TABLE OF MATERIALS AND CONSTRUCTION STANDARDS RESIDENTIAL ACCESS AND LOCAL STREETS

COMPONENT	DECRIPTION	STANI	RUCTION DARDS IN PLACE)	NOTES		
(1)	MATERIALS	DEPTHS (2)	METHOD (3)			
А	TYPE II ASPHALTIC CONCRETE	1-1/2"	ONE (1)			
ASPH	TYPE S-3 ASPHALTIC CONCRETE	1-1/2"	TWO (2) EQ. LIFTS	TACK COAT REQUIRED WITH MULTIPLE LIFTS.		
	LIMEROCK	8"	COMPACTED	SEE DETAIL DRAWINGS FOR		
В	CRUSHED CONCRETE	8"	COMPACTED	PRIME COAT NOTATION		
С	SUBGRADE	12"	COMPACTED			

10102/161	CO DESCRIPTION COSTS CONTROL
(1)	A = PAVEMENT
1.1	B = BASE
	C = SUBGRADE

- (2) ALL DIMENSIONS REFER TO FINISHED THICKNESS.
- (3) COMPACTED TO AT LEAST 98% MAXIMUM DENSITY PER A.A.S.H.T.O. T-180.

TOWN OF PALM PUBLIC WORKS DEP		TABLE 100	DRAWING NO.		
REVISIONS:	DATE:				
		APPROVED: M. Bown	EFFECTIVE:		
		TOWN ENGINEER	- / 7 / 1		

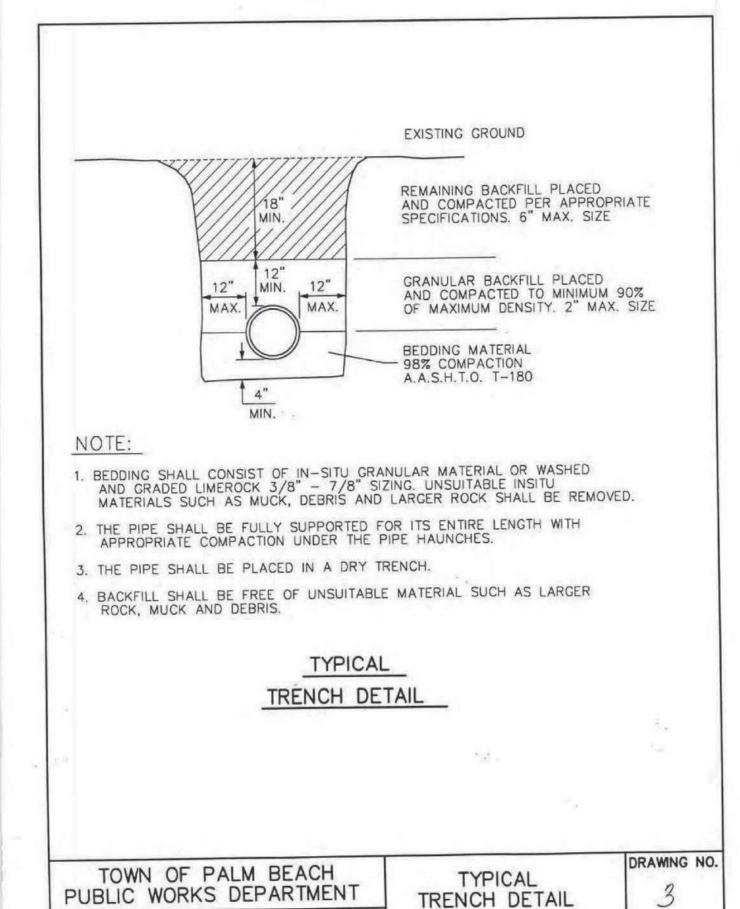

DATE:


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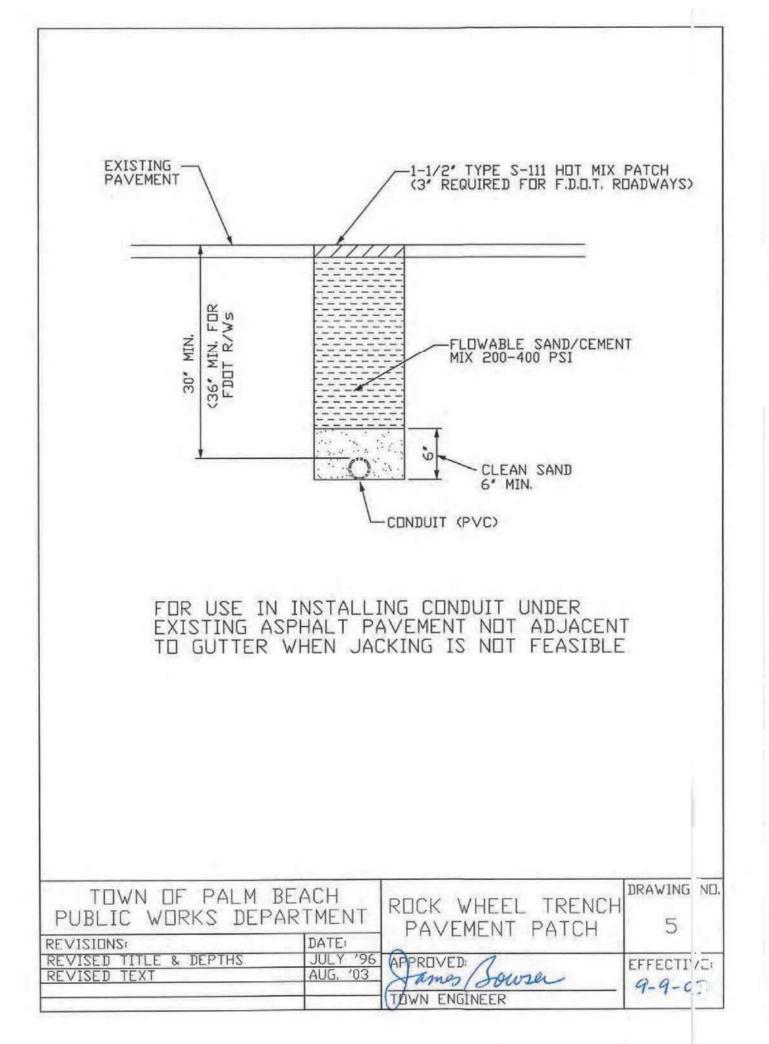
TOWN ENGINEER


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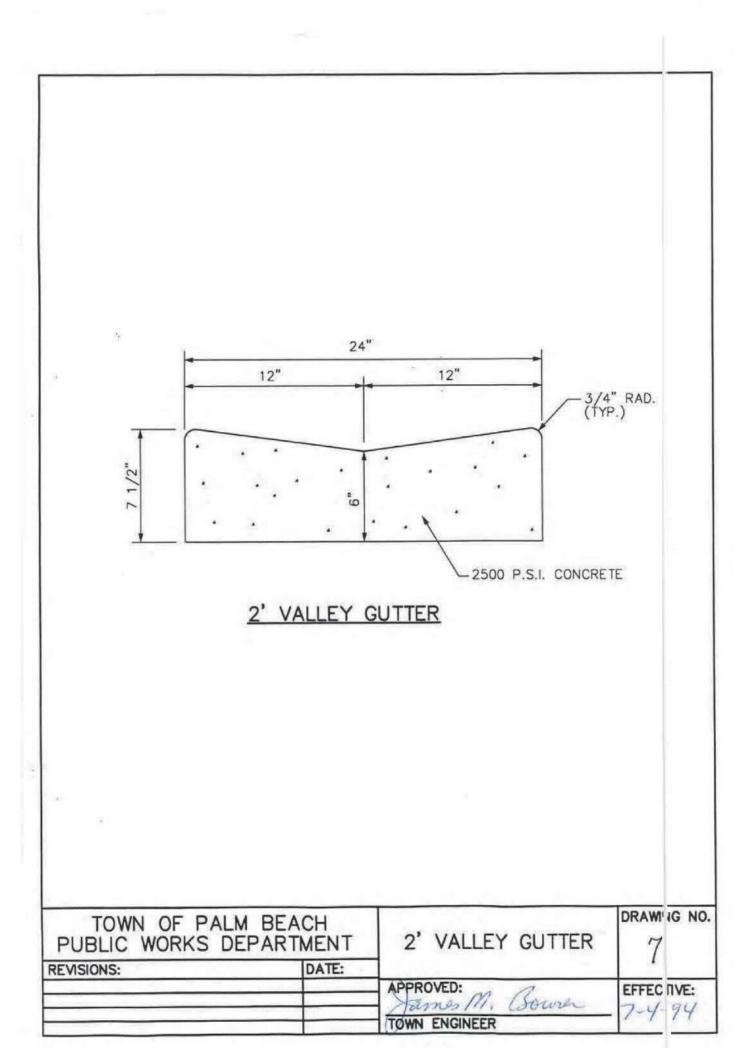
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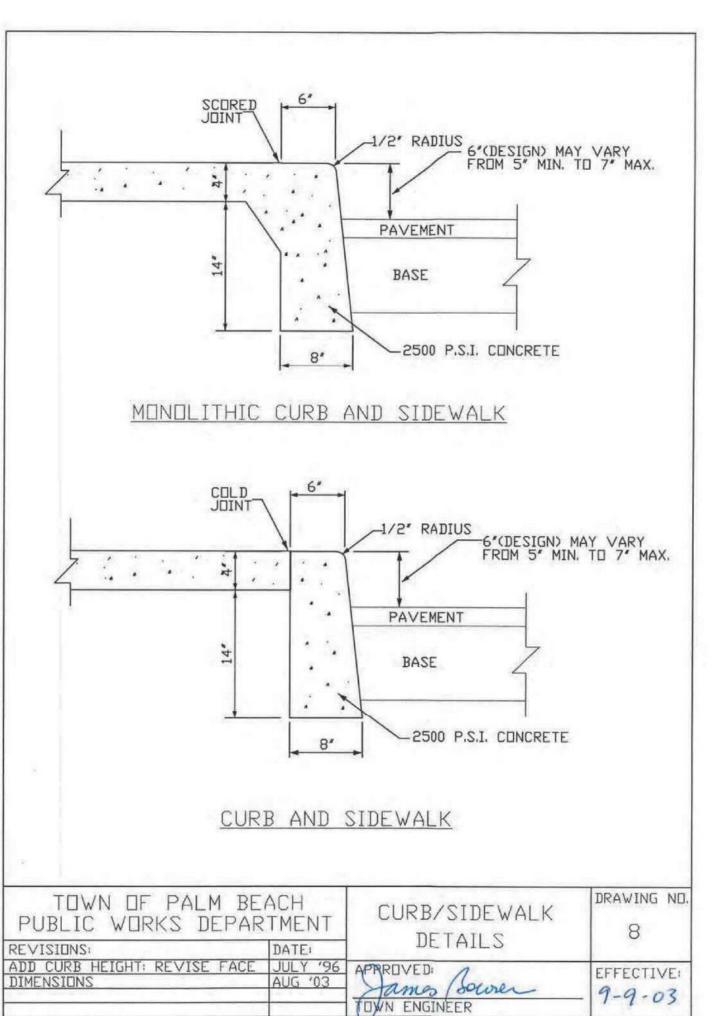
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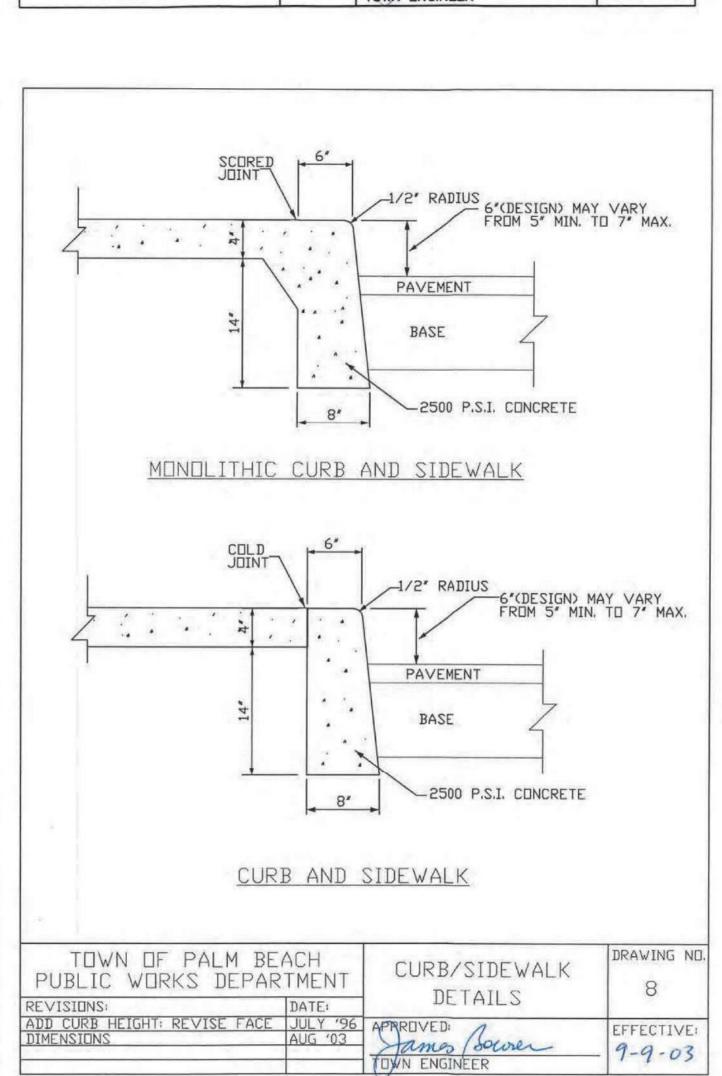








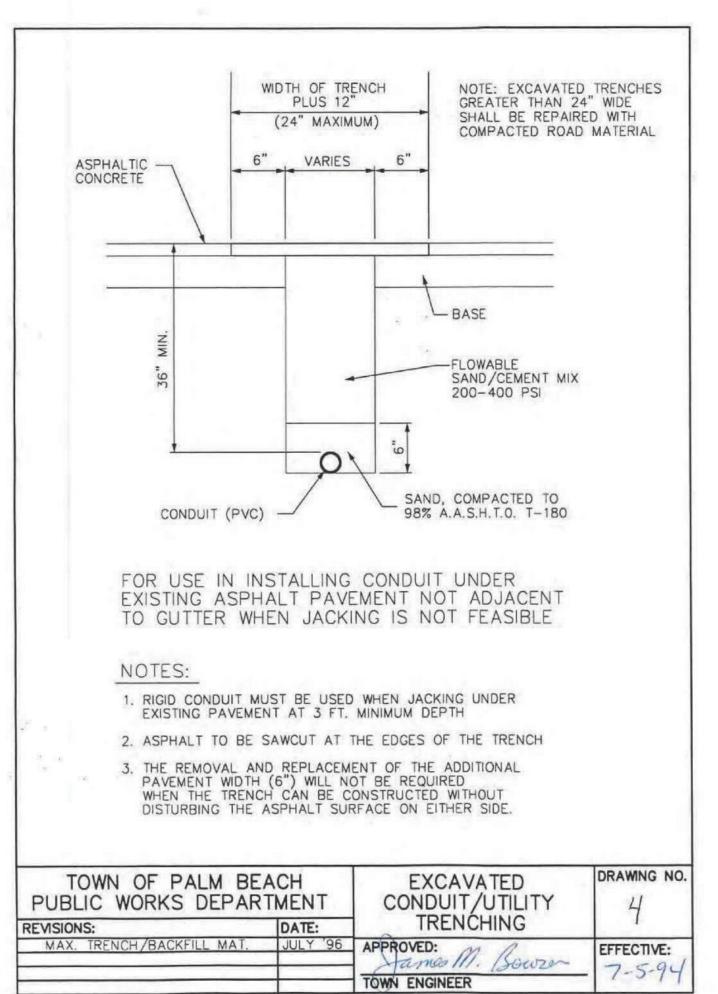


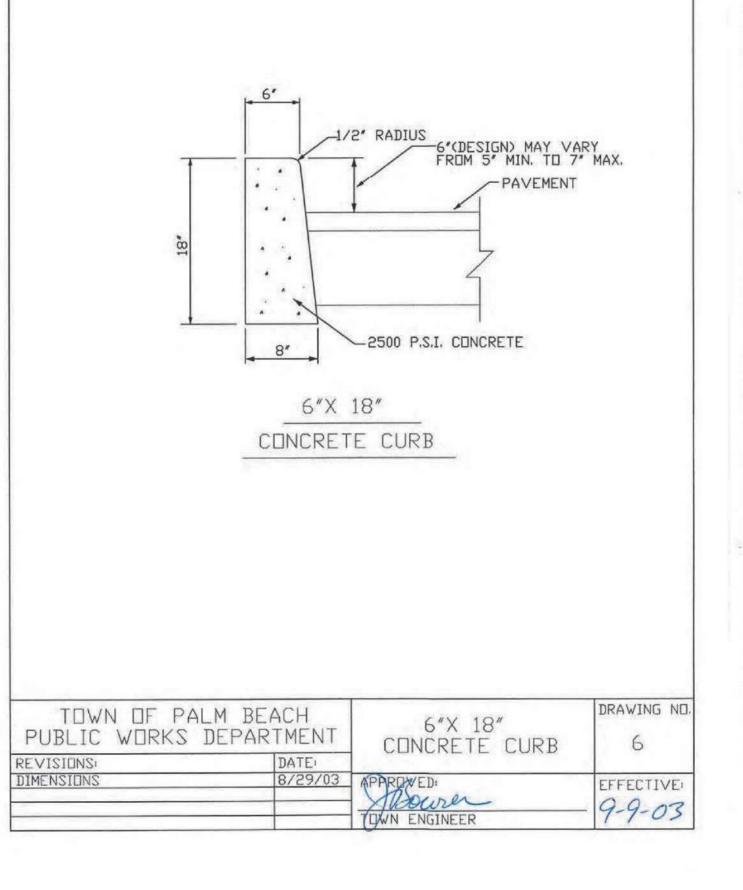

GRADIN G AVING, GRAD AND DRAINAC

LICENSE 675

AMBASSADOR EDGEWATER PREPARED FOR OKO GROUP

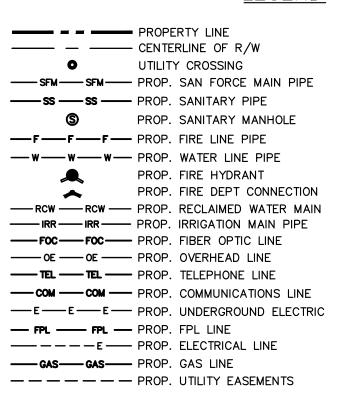

	EXIST SANITARY FORCE MAIN
—— ss —— ss ——	EXIST SANITARY PIPE
S	EXIST SANITARY MANHOLE
— F — F — F —	EXIST FIRE LINE PIPE
— w — w — w —	EXIST WATER PIPE
	EXIST FIRE HYDRANT
	EXIST FIRE DEPT CONNECTION
	EXIST WATER PIPE
IRR IRR	EXIST IRRIGATION MAIN PIPE
—— FOC —— FOC ——	EXIST FIBER OPTIC LINE
—— OE —— OE ——	EXIST OVERHEAD LINE
—— TEL —— TEL ——	EXIST TELEPHONE LINE
	EXIST COMMUNICATIONS LINE
—E—E—E—	EXIST UNDERGROUND ELECTRIC
— FPL — FPL —	EXIST FPL LINE
—————Е——	EXIST ELECTRICAL LINE
—— GAS—— GAS——	
	EXIST UTILITY EASEMENTS
	STORM PIPE (SEE PAVING,
—— STRM ——— STRM ——	GRADING & DRAINAGE PLANS)
	STORM AREA INLET
	STORM CURB INLET
(D)	STORM MANHOLF
	3.3

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SHEET NUMBER

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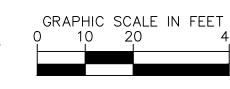
CALL 2 WORKING DAYS **BEFORE YOU DIG**

DIAL 811

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SUNSHINE STATE ONE CALL OF FLORIDA, INC.

SHEET C5.01 SHEET C5.02 SHEET C5.03 **EDGEWATER** 5-STORY BUILDING AMBASSADOR AMBASSADOR FFE: 13.00 NAVD 5-STORY 5-STORY BUILDING BUILDING FFE: 17.00 NAVD FFE: 17.00 — NA∀D — #,#,#.#.



<u>LEGEND</u>

	PROPERTY LINE
	CENTERLINE OF R/W
	UTILITY CROSSING
	PROP. SAN FORCE MAIN PIPE
——ss ——ss ——	PROP. SANITARY PIPE
S	PROP. SANITARY MANHOLE
—	PROP. FIRE LINE PIPE
www	PROP. WATER LINE PIPE
	PROP. FIRE HYDRANT
~	PROP. FIRE DEPT CONNECTION
	PROP. RECLAIMED WATER MAI
IRR IRR	PROP. IRRIGATION MAIN PIPE
——FOC——FOC——	PROP. FIBER OPTIC LINE
—— OE —— OE ——	PROP. OVERHEAD LINE
—— TEL —— TEL ——	PROP. TELEPHONE LINE
—— сом —— сом ——	PROP. COMMUNICATIONS LINE
<u>—Е—Е—Е—</u>	PROP. UNDERGROUND ELECTR
— FPL — FPL —	
	PROP. ELECTRICAL LINE
—— GAS—— GAS——	
	PROP. UTILITY EASEMENTS
	EXIST SANITARY FORCE MAIN
	EXIST SANITARY PIPE
S	EXIST SANITARY MANHOLE
	EXIST FIRE LINE PIPE
www	
	EXIST FIRE HYDRANT
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	EXIST WATER PIPE EXIST IRRIGATION MAIN PIPE
	EXIST FIBER OPTIC LINE
	EXIST PIBER OF THE LINE
	EXIST TELEPHONE LINE
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— FPL — FPL —	
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	CTODA DIDE (CEE DAVING
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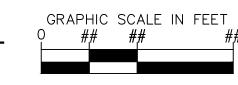
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	CENTERLINE OF R/W
	UTILITY CROSSING
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——ss ——ss ——	PROP. SANITARY PIPE
S	PROP. SANITARY MANHOLE
—-F—-F—	PROP. FIRE LINE PIPE
— w — w — w —	PROP. WATER LINE PIPE
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— сом — сом —	PROP. COMMUNICATIONS LINE
<u>—Е—Е—Е—</u>	PROP. UNDERGROUND ELECTR
— FPL — FPL —	PROP. FPL LINE
—————E——	PROP. ELECTRICAL LINE
GAS	PROP. GAS LINE
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— RCW — RCW —	EXIST WATER PIPE EXIST IRRIGATION MAIN PIPE
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- 24. THE TOWN OF PALM BEACH UTILITIES DIVISION MUST BE GIVEN AT LEAST 48 HOURS NOTIFICATION PRIOR TO ANY SHUT-DOWN AND/OR REMOVAL OF EXISTING WATER MAIN OR SANITARY SEWER LINES.
- 25. CITY MAINTAINED UTILITIES WILL NEED TO BE TESTED AND PROTECTED (IE. PAVED AT LEAST UP TO FIRST LIFT, IF NOT ROADWAY) PRIOR TO ISSUANCE OF CERTIFICATION OF OCCUPANCY.
- 26. LEAD FREE BRASS WATER WORKS PRODUCTS SHALL MEET THE REQUIREMENT OF ASNI/AWWA C800 AND THE MAXIMUM LEAD CONTENT OF S.3872 AND NSF 61 ANNEX G. THE MANUFACTURER'S DESIGNATION AS A LEAD FREE PRODUCT SHALL BE PERMANENTLY STAMPED OR CAST INTO THE PRODUCT'S BODY. EFFECTIVE JANUARY 1, 2013, ONLY LEAD FREE BRASS WATER WORKS PRODUCTS SHALL BE INSTALLED IN CONTACT WITH POTABLE WATER.
- 27. ALL PROPOSED BACKFLOW PREVENTERS AND DOUBLE DETECTOR CHECK VALVES SHALL BE USC CERTIFIED AND LEAD FREE.