SCOPE OF WORK

1. WE ARE PROPOSING TO CONSTRUCT A NEW BERMUDA STYLE, ONE-STORY SINGLE FAMILY RESIDENCE WITH A SWIMMING POOL. 2. THE EXISTING HOME AND POOL ON THE SITE WILL BE DEMOLISHED. 3. THE EXISTING PERIMETER CLUSIA HEDGE WILL REMAIN BUT ALL OTHER LANDSCAPING WILL BE REMOVED FOR NEW LANDSCAPING TO BE INSTALLED.

PROJECT DATA

FIRE SPRINKLERS DESIGN CRITERIA

PROPERTY INDEX NUMBER PROJECT ADDRESS BUILDING OCCUPANCY CLASSIFICATION BUILDING CONSTRUCTION TYPE NUMBER OF STORIES NUMBER OF DWELLING UNITS ZONING DISTRICT **ZONING OVERLAY** TOTAL NUMBER OF PARKING SPOTS LOT SIZE TOTAL FLOOR AREA W/ BASEMENT

50-43-43-03-11-000-0442 260 COLONIAL LN, PALM BEACH FL, 33480

9,710 SF 3,537 SF

YES/NO

APPLICABLE CODES BY JURISDICTION

CODE OF ORDINANCES TOWN OF PALM BEACH, FLORIDA FLORIDA BUILDING CODE LATEST EDITION **BUILDING CODE ENERGY CODE** FLORIDA BUILDING CODE LATEST EDITION MECHANICAL CODE FLORIDA BUILDING CODE LATEST EDITION

FLORIDA BUILDING CODE LATEST EDITION CHAPTER27 & PART VIII ELECTRICAL ELECTRICAL CODE FLORIDA BUILDING CODE LATEST EDITION PLUMBING CODE FLORIDA BUILDING CODE LATEST EDITION ACCESSIBILITY ACCESSIBILITY CODE FLORIDA FIRE PREVENTION CODE FIRE PROTECTION CODE

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DRAWING SHEET INDEX

ARCHITECTURAL

ARCHITECTURAL	
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A0.01	CONTEXT PHOTO KEY MAP
A0.02	CONTEXT STUDY - NORTH SIDE OF STREET
A0.03	CONTEXT STUDY - SOUTH SIDE OF STREET
A0.04	CONTEXT STUDY - SOUTH SIDE OF STREET (CONTINUED)
A0.05	EXISTING SITE PLAN
A0.06	PROPOSED ARCHITECTURAL SITE PLAN
A0.07	ZONING DIAGRAMS
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A1.10	ROOF PLAN
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A2.01	EXTERIOR ELEVATIONS 2
A2.02	EXTERIOR ELEVATIONS COLOR 1
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CIVIL	
C-1	SITE GRADING & DRAINAGE PLAN
EC-1	EROSION CONTROL PLAN

LANDSCAPE

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L1.1a	SITE COMPARISON PLAN
M-1	MATERIALS SHEET
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TLP-1	TRUCKING LOGISTICS
S-1	SCREENING PLAN
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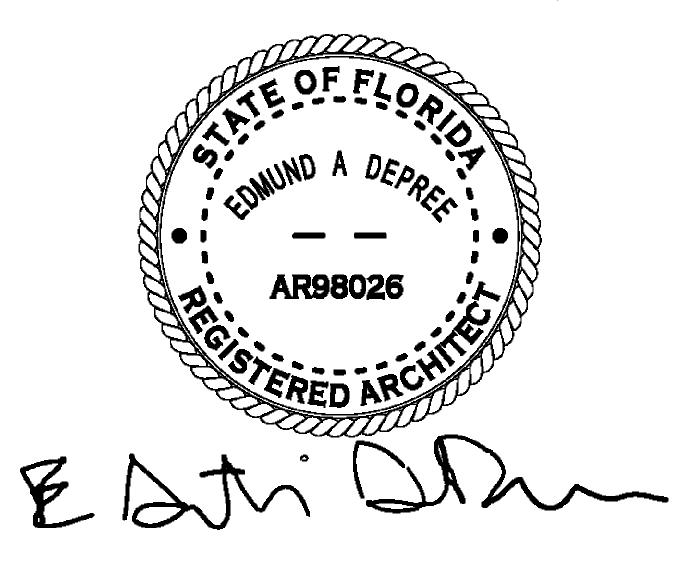
PROJECT TEAM MEMBERS

PROJECT TEAM MEMB	LNO			
OWNER	MEREDITH HUNT 260 COLONIAL LANE PALM BEACH, FL 33480	CONSULT_ADD6_discipline	CONSULT_ADD6_name CONSULT_ADD6_address	
ARCHITECT	NORTHWORKS ARCHITECTS & PLANNERS 214 BRAZILIAN AVE SUITE 200-H PALM BEACH, FL 33480	CONSULT_ADD7_discipline	CONSULT_ADD7_name CONSULT_ADD7_address	
LANDSCAPE	SMI LANDSCAPE ARCHITECTURE 140 ROYAL PALM WAY, SUITE 206 PALM BEACH, FL 33480	CONSULT_ADD8_discipline	CONSULT_ADD8_name CONSULT_ADD8_address	
INTERIOR DESIGN	CECE BOWMAN INTERIORS 214 BRAZILIAN AVE, #220 PALM BEACH, FL 33480	CONSULT_ADD9_discipline	CONSULT_ADD9_name CONSULT_ADD9_address	
CONSULT_ADD3_discipline	CONSULT_ADD3_name CONSULT_ADD3_address	CONSULT_ADD10_discipline	CONSULT_ADD10_name CONSULT_ADD10_address	
CONSULT_ADD4_discipline	CONSULT_ADD4_name CONSULT_ADD4_address	CONSULT_ADD10_discipline	CONSULT_ADD10_name CONSULT_ADD10_address	
CONSULT_ADD5_discipline	CONSULT_ADD5_name CONSULT_ADD5_address			

PROFESSIONAL CERTIFICATIONS

ARCHITECT'S STATEMENT

THIS IS TO CERTIFY THAT THESE PLANS WERE PREPARED UNDER MY PERSONAL SUPERVISION AND TO THE BEST OF MY KNOWLEDGE CONFORM TO LOCAL BUILDING CODE REQUIREMENTS.



AREA MAP



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Discipline & Drawing Number

2435 Project No.

Author Drawn By

Checker Checked By

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LOCATION PLAN

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PHOTOS KEY MAP
SCALE 1/32" = 1'-0"

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CONTEXT PHOTO KEY MAP

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1 - 205 COLONIAL LN





2- 215 COLONIAL LN 3- 245 COLONIAL LN








4- 249 COLONIAL LN 5- 255 COLONIAL LN 6- 270 COLONIAL LN







7- 249 COLONIAL LN 9- 270 COLONIAL LN 8- 255 COLONIAL LN

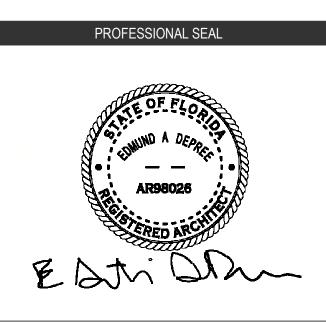

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CONTEXT STUDY - NORTH SIDE OF STREET

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10-216 COLONIAL LN





11-224 COLONIAL LN 12-230 COLONIAL LN







13- 242 COLONIAL LN 14- 248 COLONIAL LN 15- 260 COLONIAL LN - OWNER'S PROPERTY






17-270 COLONIAL LN



18- 292 COLONIAL LN

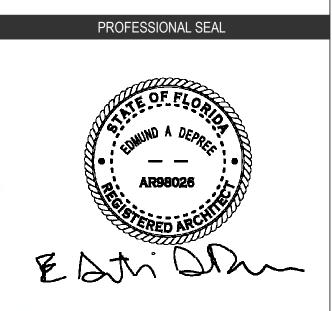

16-266 COLONIAL LN

CONTEXT STUDY - SOUTH SIDE OF STREET





19-300 COLONIAL LN 20- 1090 N OVEAN BLVD


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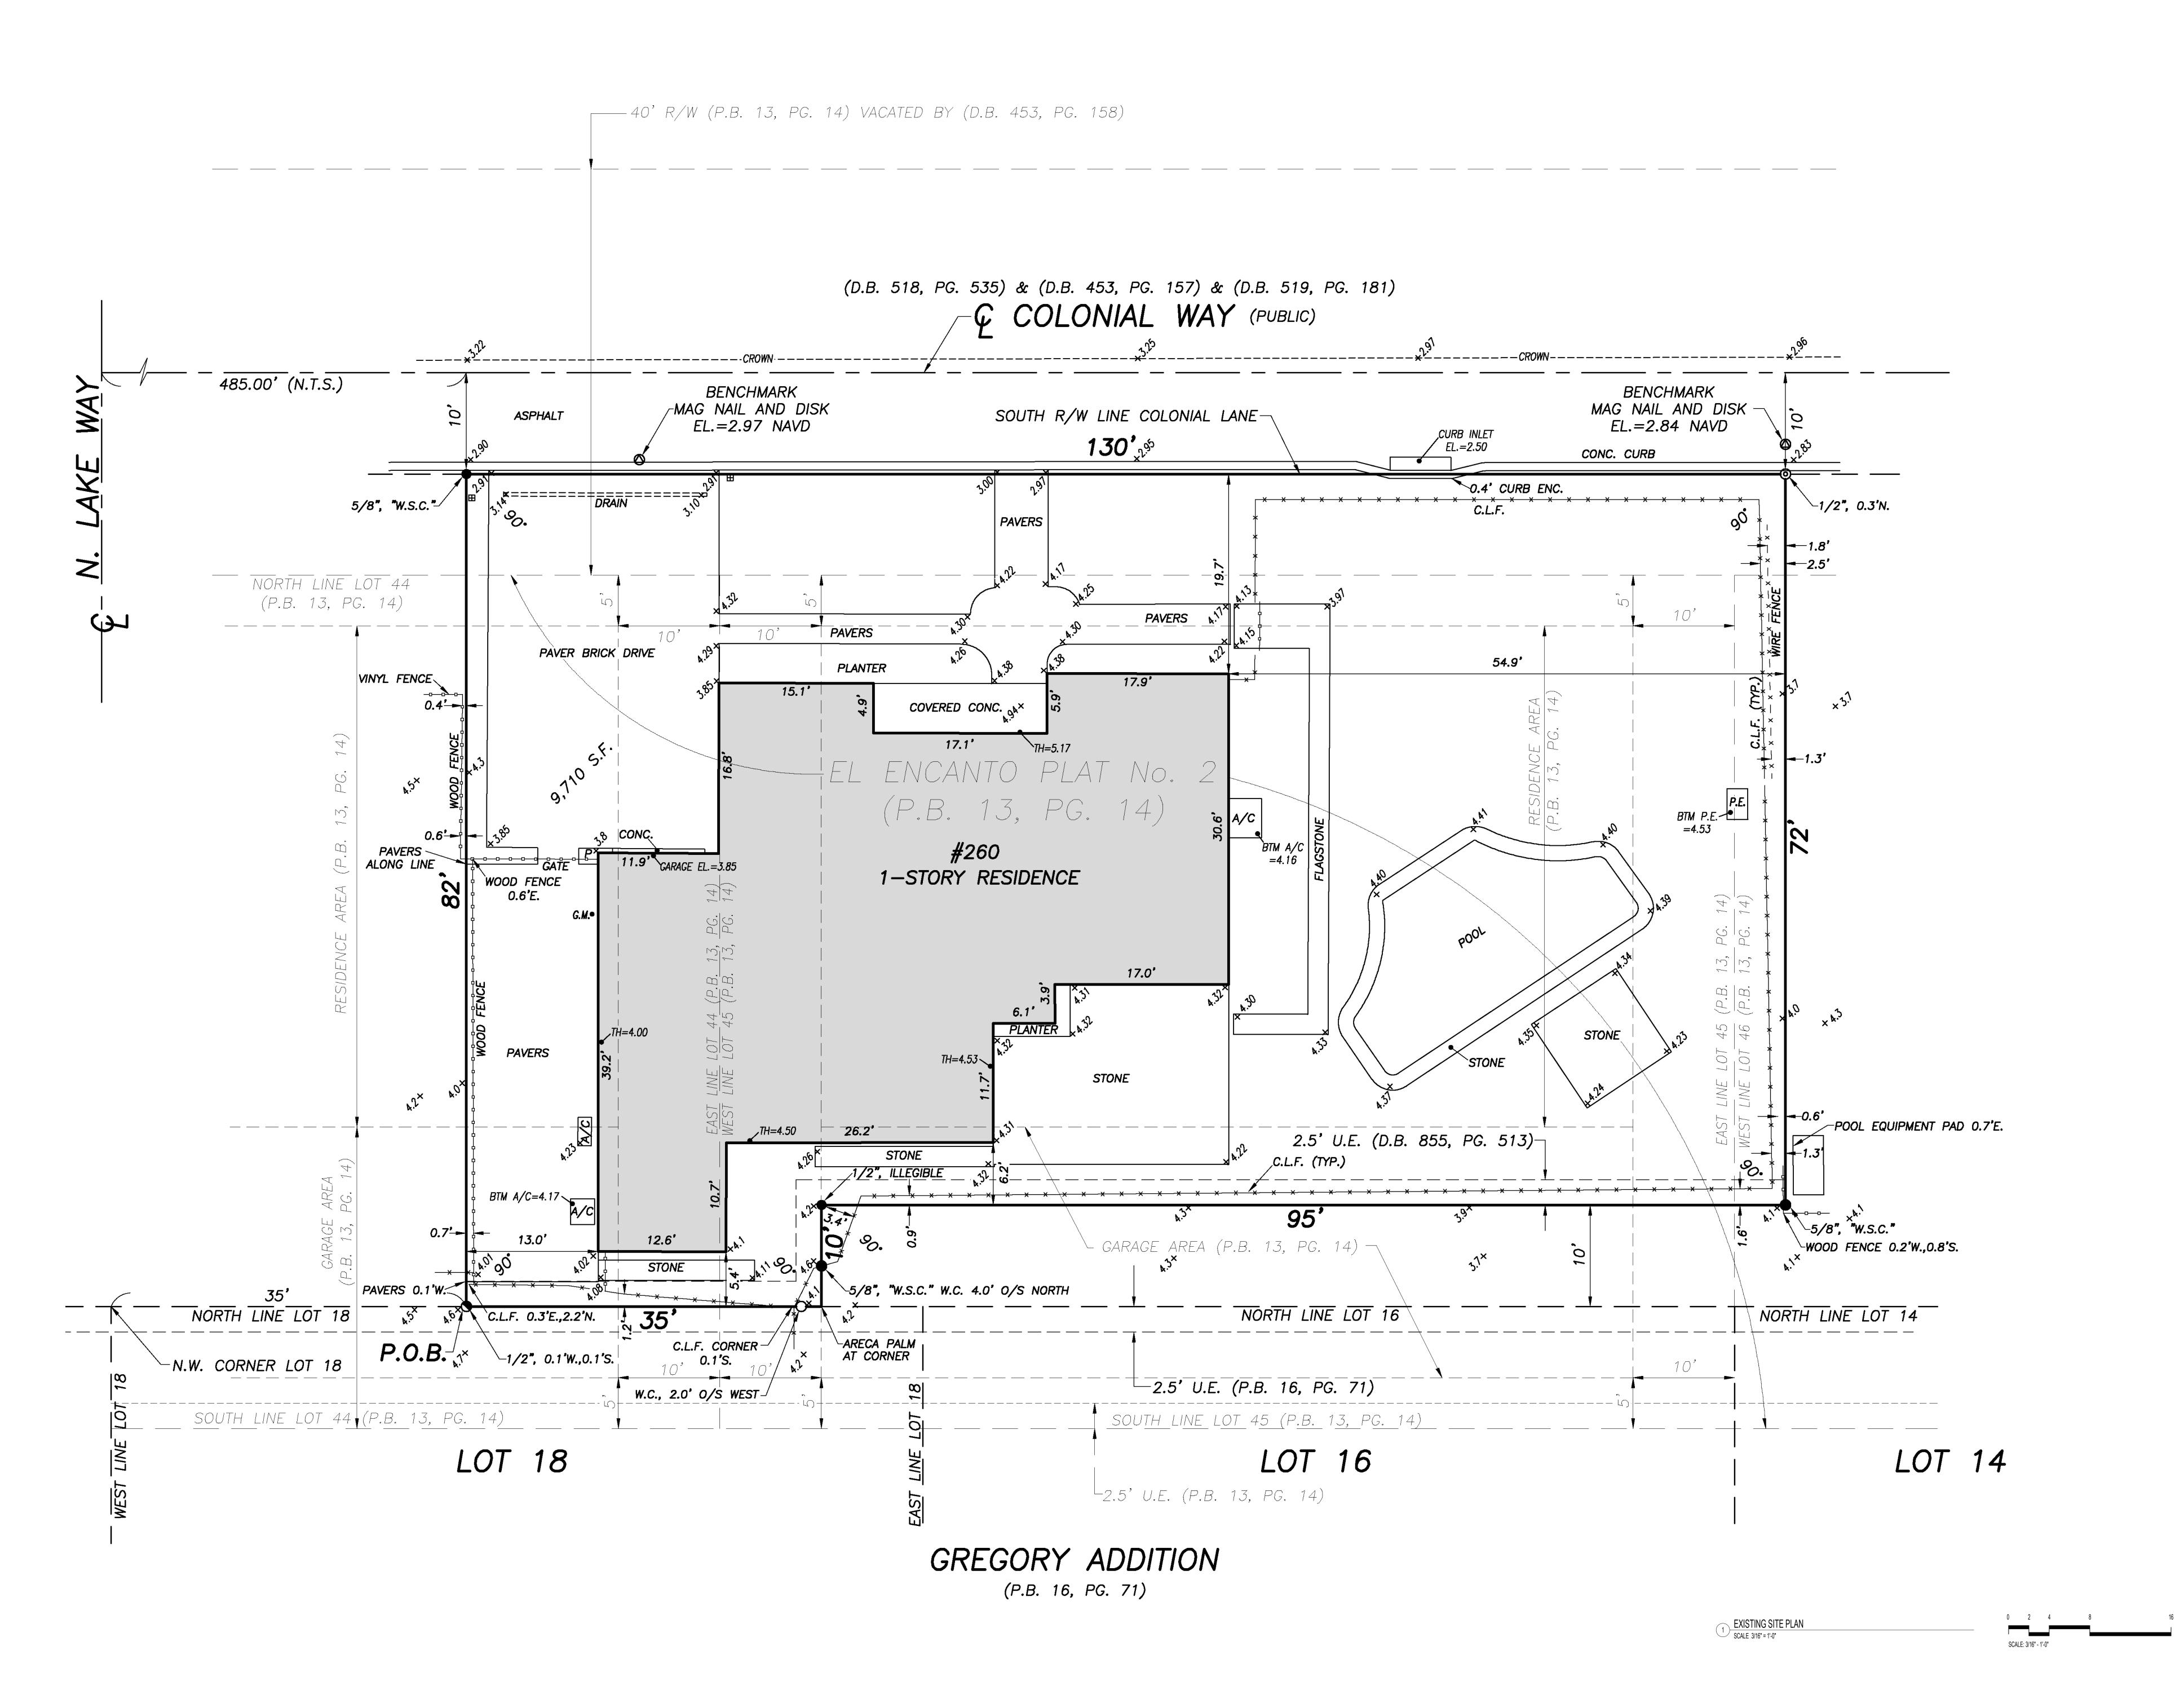
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CONTEXT STUDY - SOUTH SIDE OF STREET (CONTINUED)



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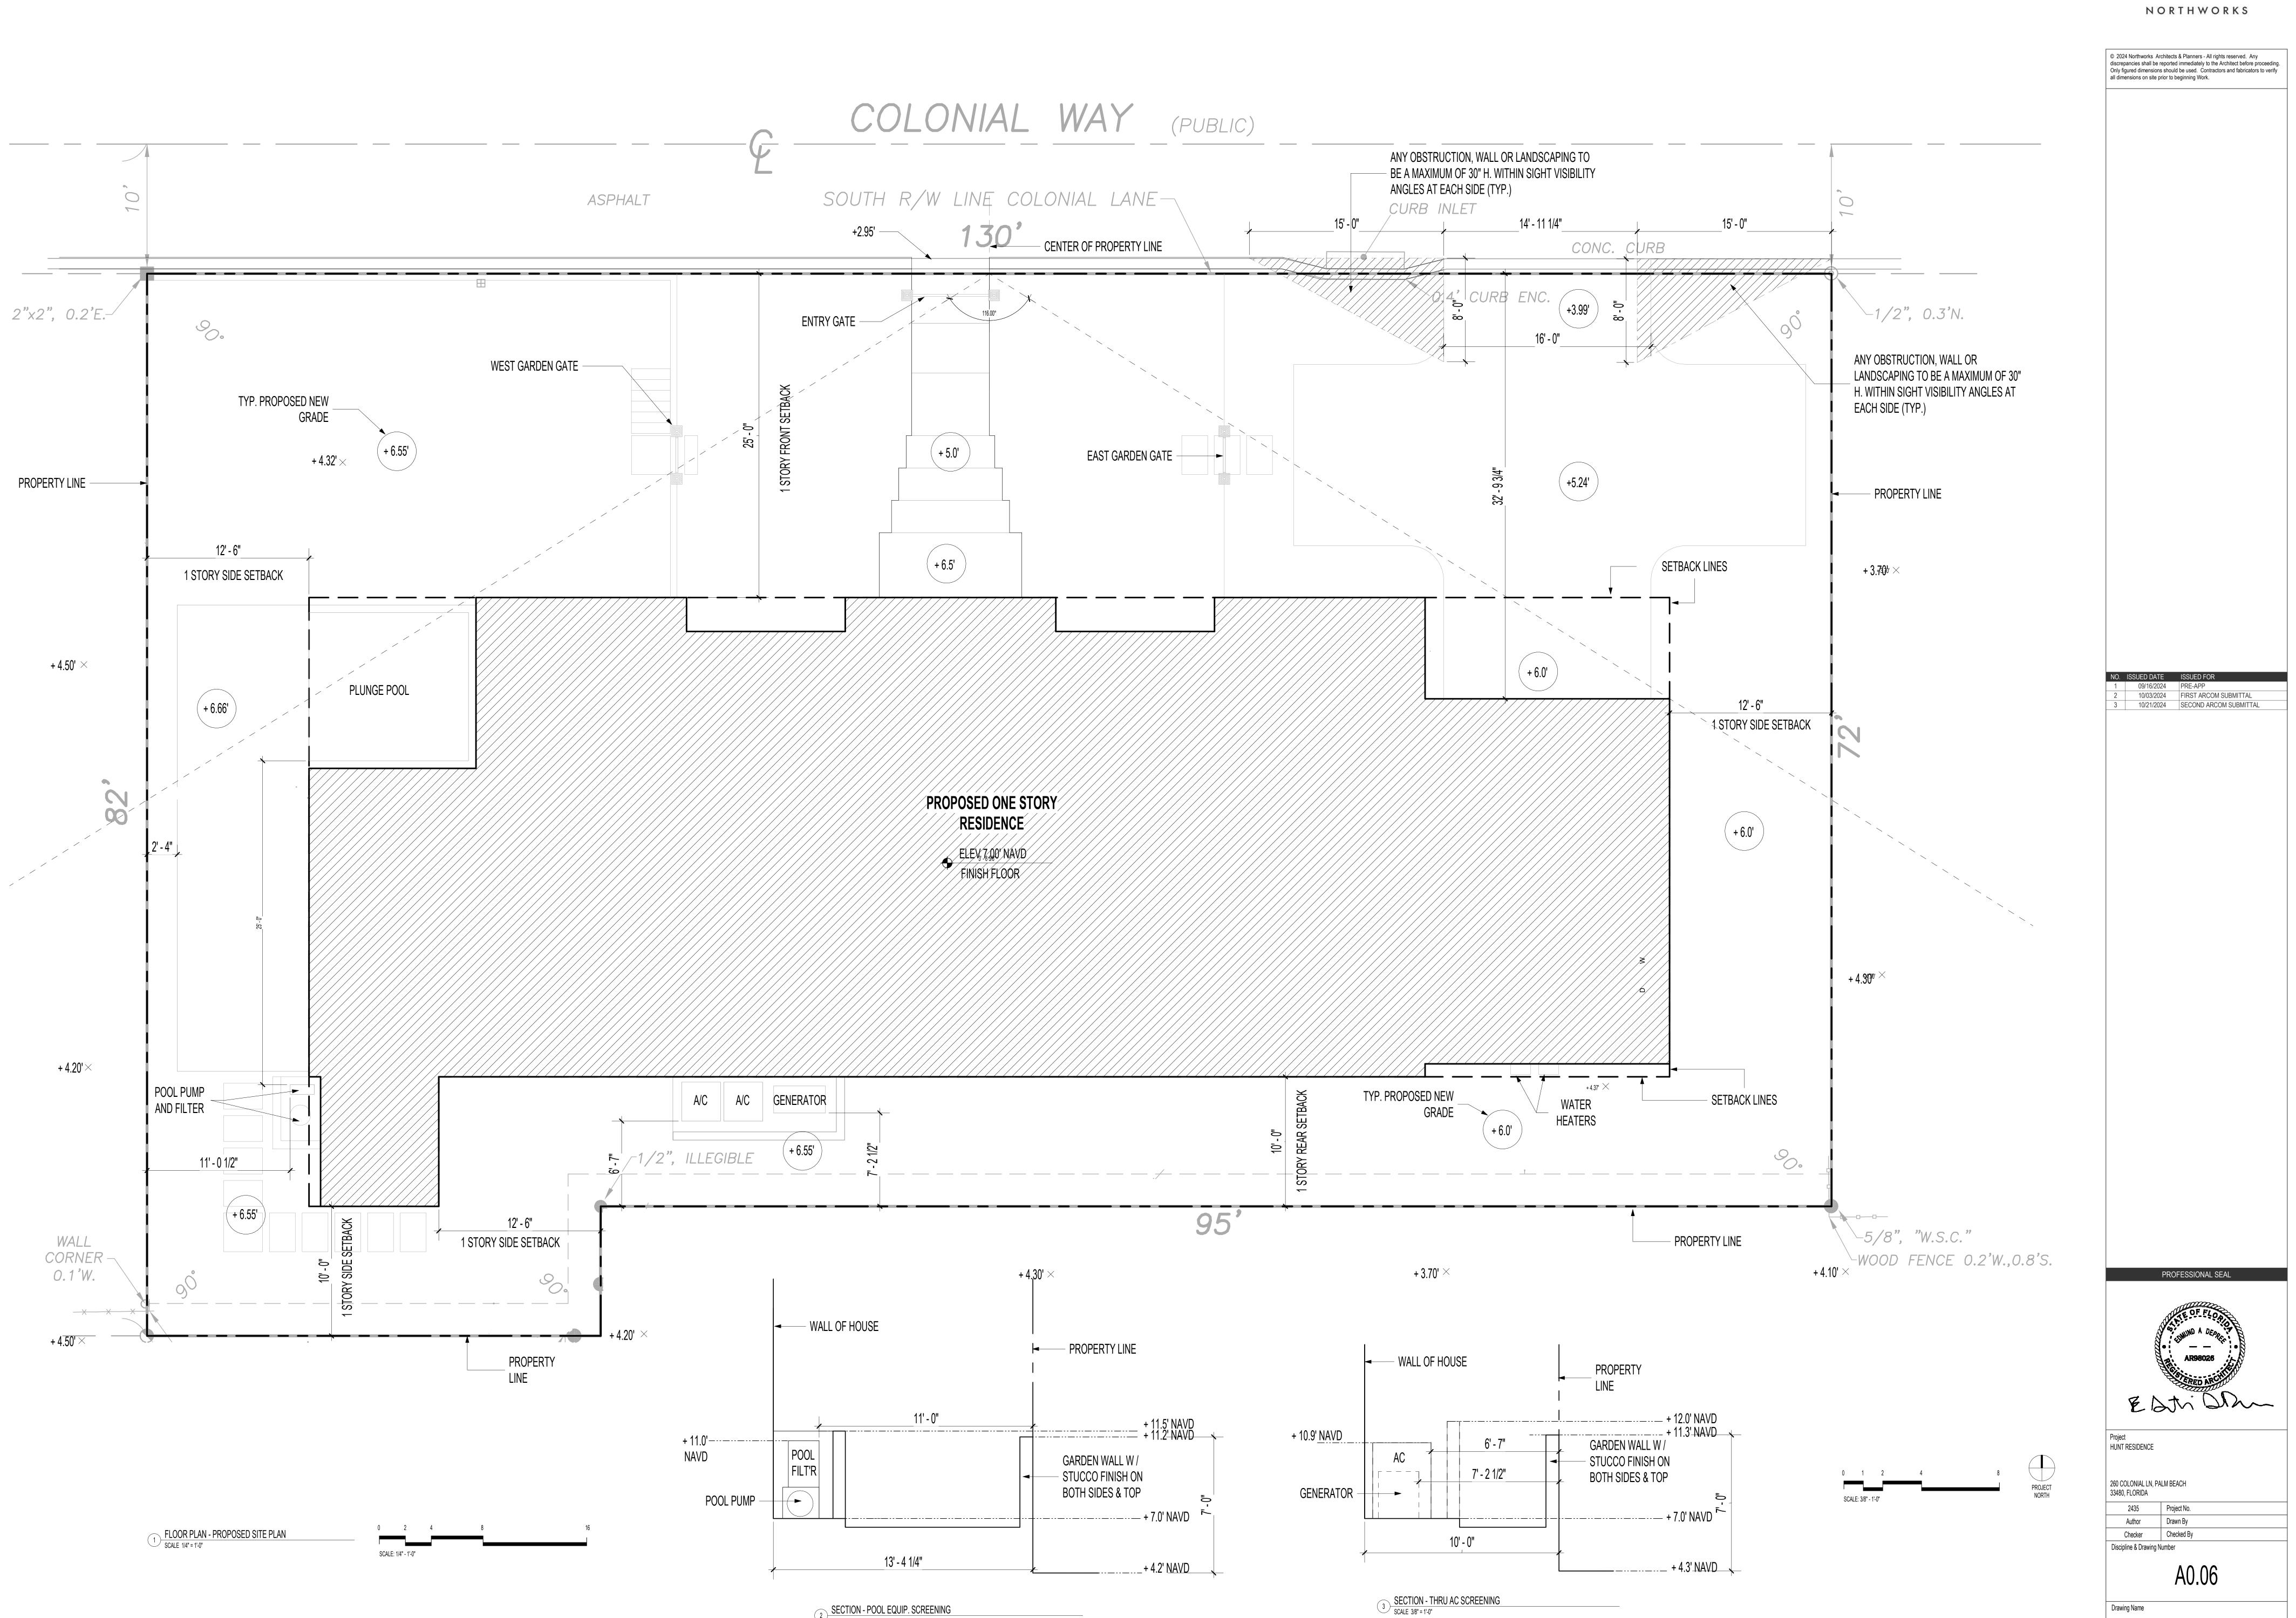
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EXISTING SITE PLAN



SECTION - POOL EQUIP. SCREENING

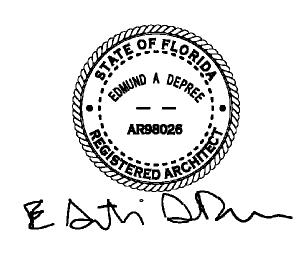
SCALE 3/8" = 1'-0"


PROPOSED ARCHITECTURAL SITE PLAN




CUBIC	CONTENT CALCULATIONS
ALLOWABLE CCR	39,132.3 CU.FT (4.029 CCR)
AREAS	CUBIC FEET
 A - 2,044.24 SQ B - 1,531.82 SQ 	•
OTAL	34,738.50
CCR	3.58

1	PROPERTY ADRESS	260 COLONIAL LN, PALM BEA	CH, FLORIDA	
2	ZONING DISTRICT	R-B		
3	LOT AERA (SQ. FT.)	9,710	1.4 1.44 1.44	1.4 2.55 3.55
4	LOT WIDTH (W) & DEPTH (D) (FT.)	W 130' D 72'	. 1. 11.	. 1. 11. 1
5	STRUCTURE TYPE	SINGLE - FAMILY	*	*
6	FEMA FLOOD ZONE DESIGNATION	AE (EL6)	\\\\\\\\\\\\\\\\\\\\\\\\\\\\\\\\\\\\\\	\ \ \ \ \ \ \ \ \ \ \ \ \ \ \ \ \ \ \
7	ZERO DATUM FOR POINT OF MEAS. (NAVD)	+7.0'		
8	CROWN OF ROAD (COR) (NAVD)	+3.25'		
9		REQUIRED/PERMITTED	EXISTING	PROPOSED
10	LOT COVERAGE (SQ. FT. AND %)	3,884.0 MAX (40%)	N/A	3, 537 (36.4%)
. 11	ENCLOSED SQUARE FOOTAGE		N/A	3, 537
12	FRONT YARD SETBACK	25.00 MIN.	N/A	25.00
13	SIDE YARD SETBACK (1 STORY)	12.50 MIN. (E & W)	N/A	12.50 (E & W)
14	SIDE YARD SETBACK (2 STORY)	N/A	N/A	N/A
15	REAR YARD SETBACK	10.00 MIN	N/A	10.00
16	ANGLE OF VISION (DEGREE)	116	N/A	116
17	BUILDING HEIGHT	14.00'	N/A	10.00'
18	OVERALL BUILDING HEIGHT	22.00'	N/A	18.781'
19	CUBIC CONTENT RATIO (CCR)	4.03		3.58
20	MAX. FILL ADDED TO SITE (FT)	1.875	N/A	1.7
21	FINISH FLOOR ELEVATION (FFE) (NAVD)	+6.00'	N/A	+700' NAVD
	BASE FLOOD ELEVATION (BFE) (NAVD)	+6.00'	N/A :	+6.00' NAVD
23	LANDSCAPE OPEN SPACE (LOS)	4,370 MIN. (45%)	N/A	4,562 SQ. FT. (47%)
24	PERIMETER (LOS)	2,185 MIN. (50%)	1,337	3,019
25	FRONT YARD (LOS)	1,300 MIN. (40%)	2,111	2,234
26	NATIVE PLANT SPÉCIES %	REFER LANDSCAPE DRA	AWINGS	
				_ ****

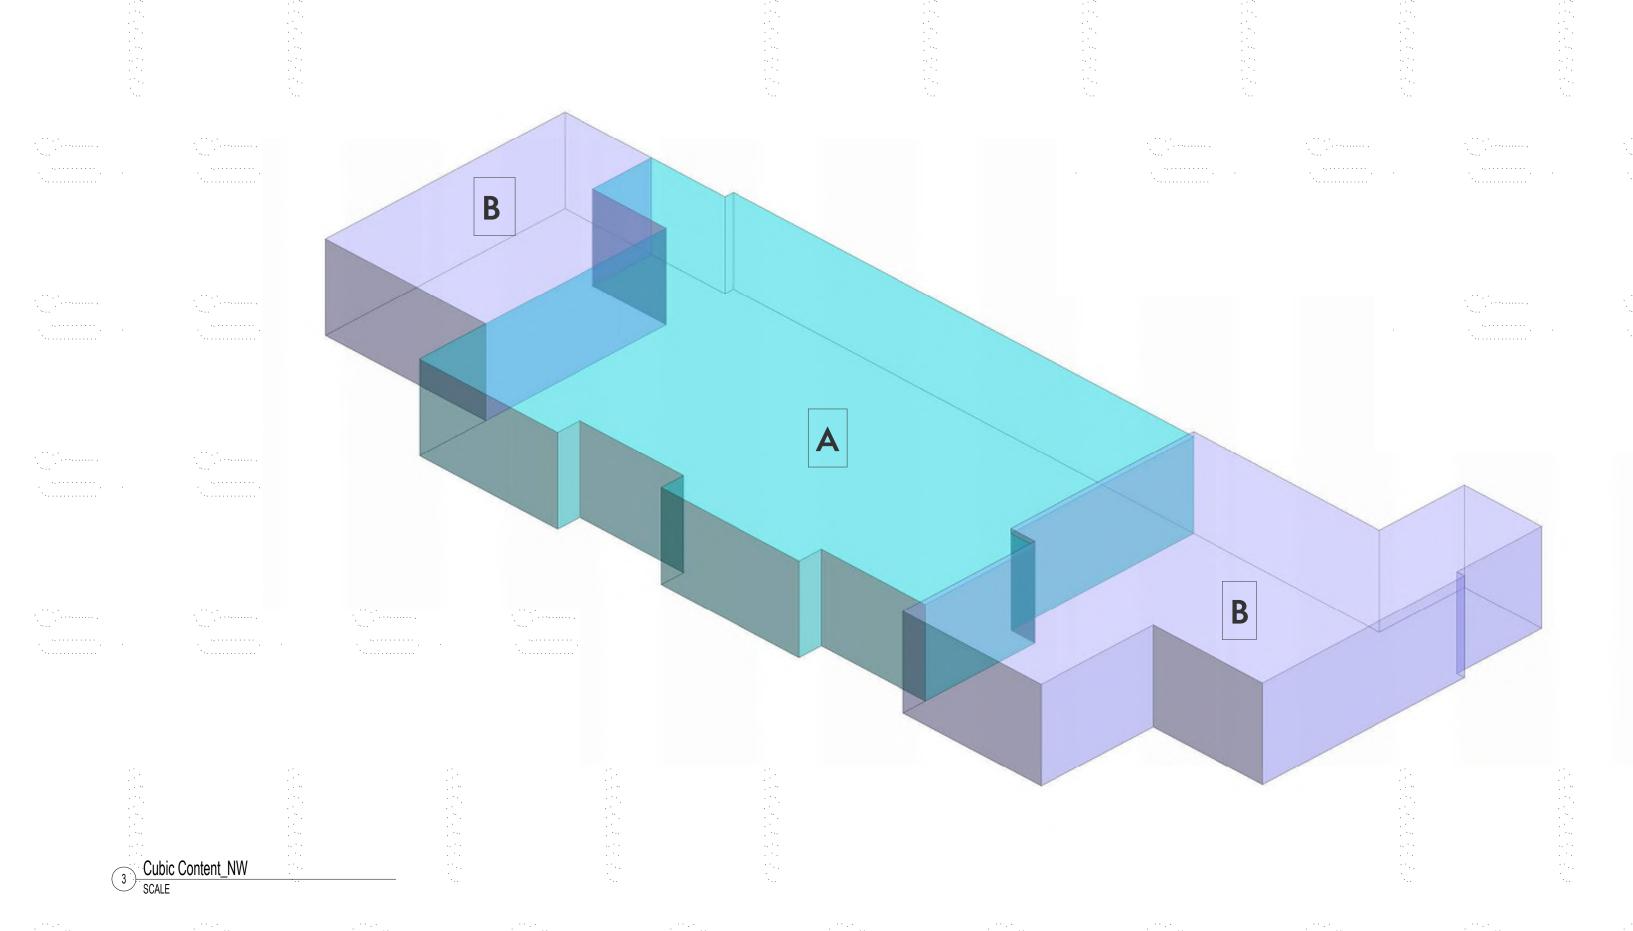

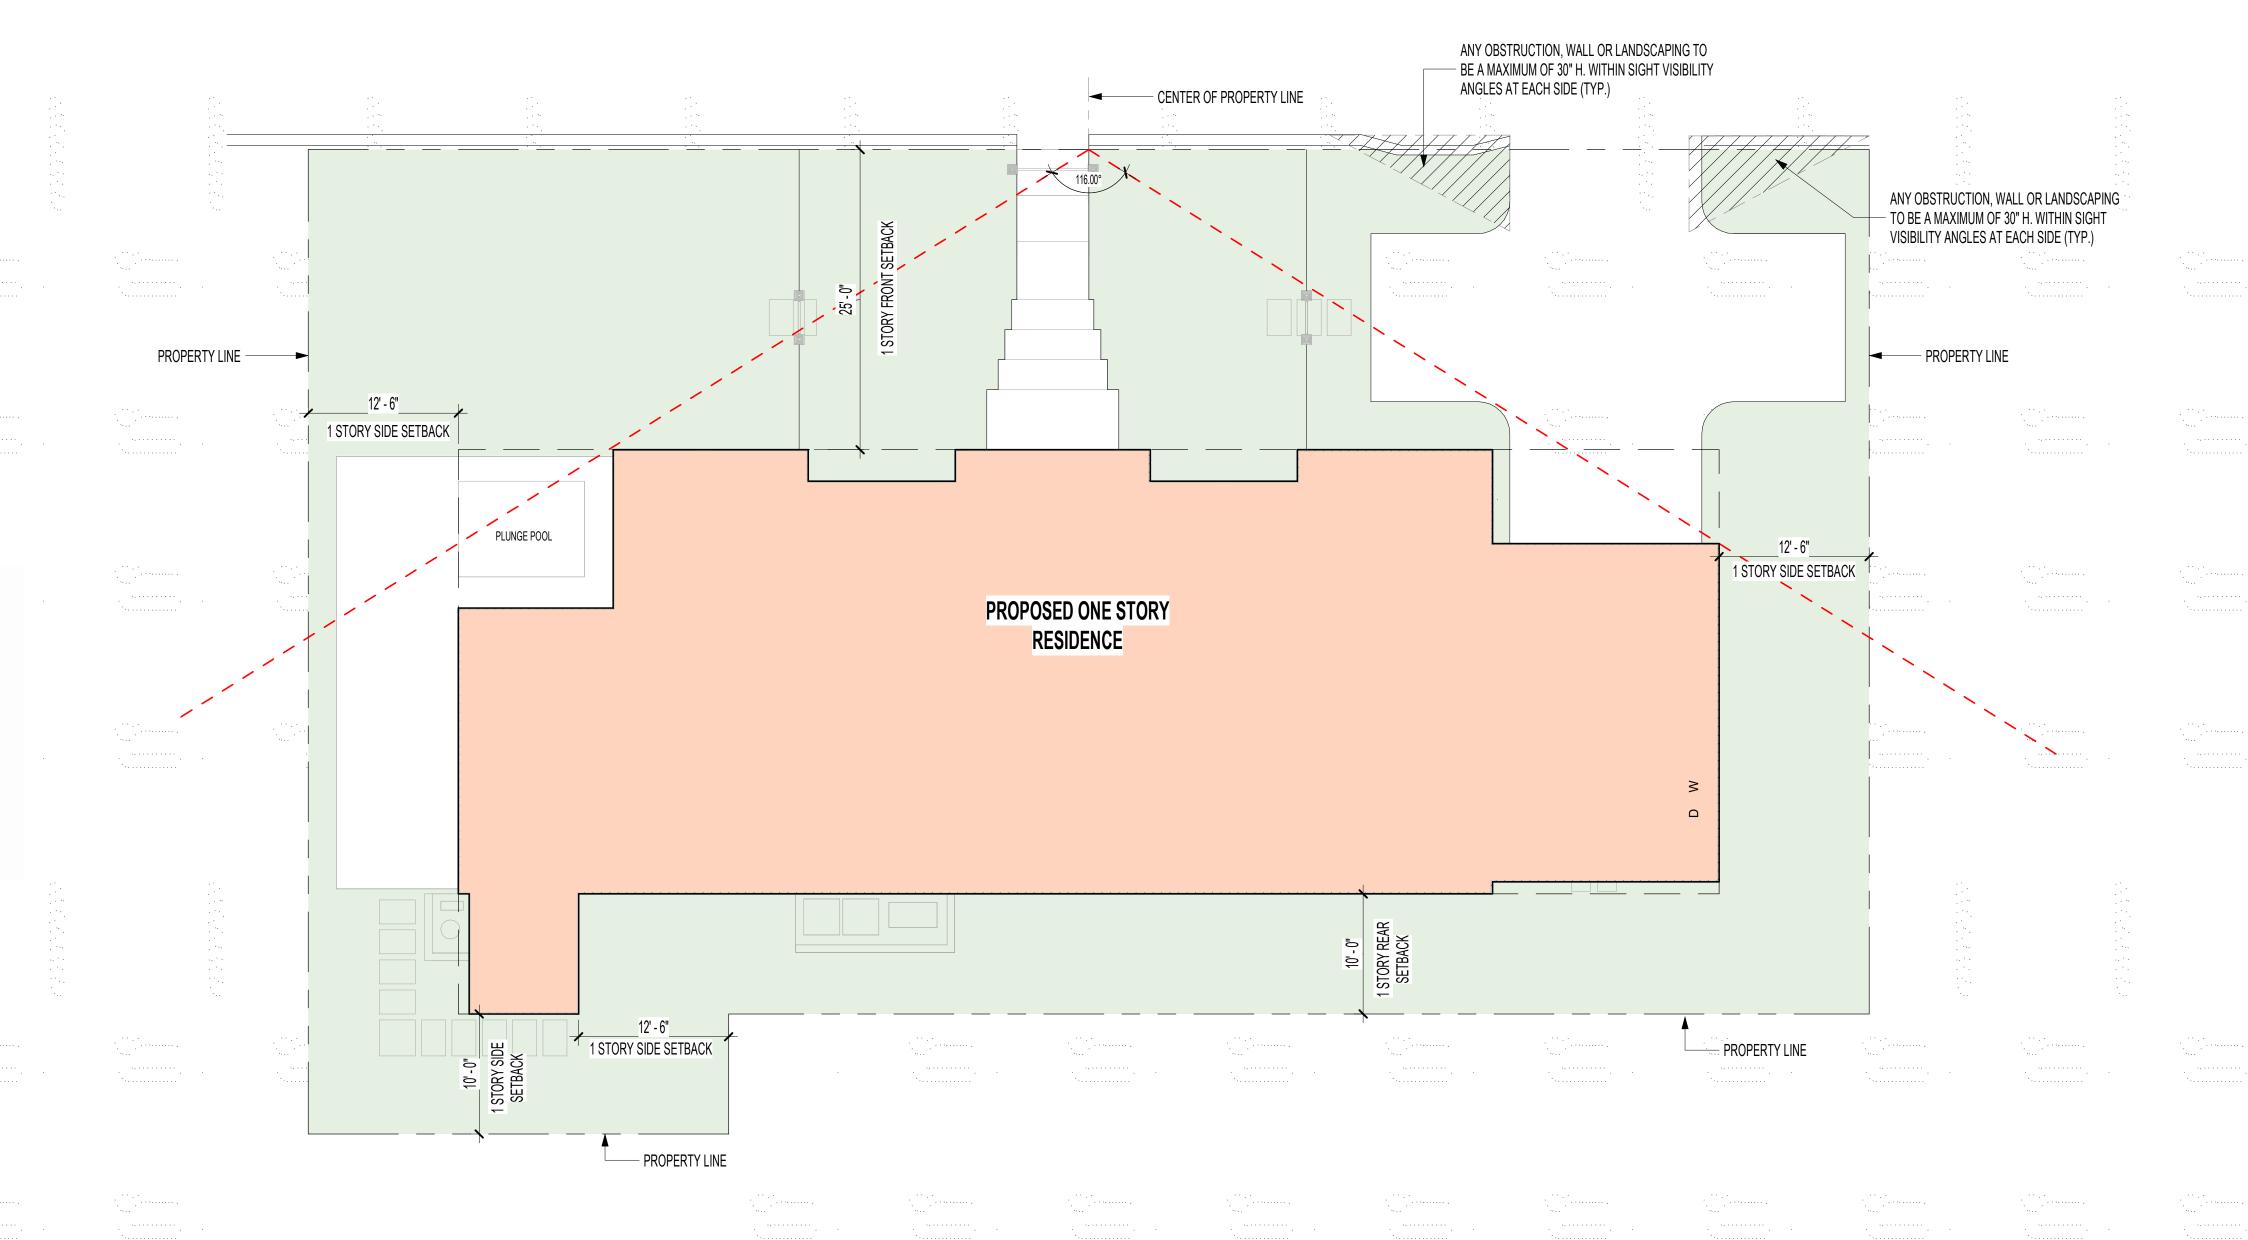

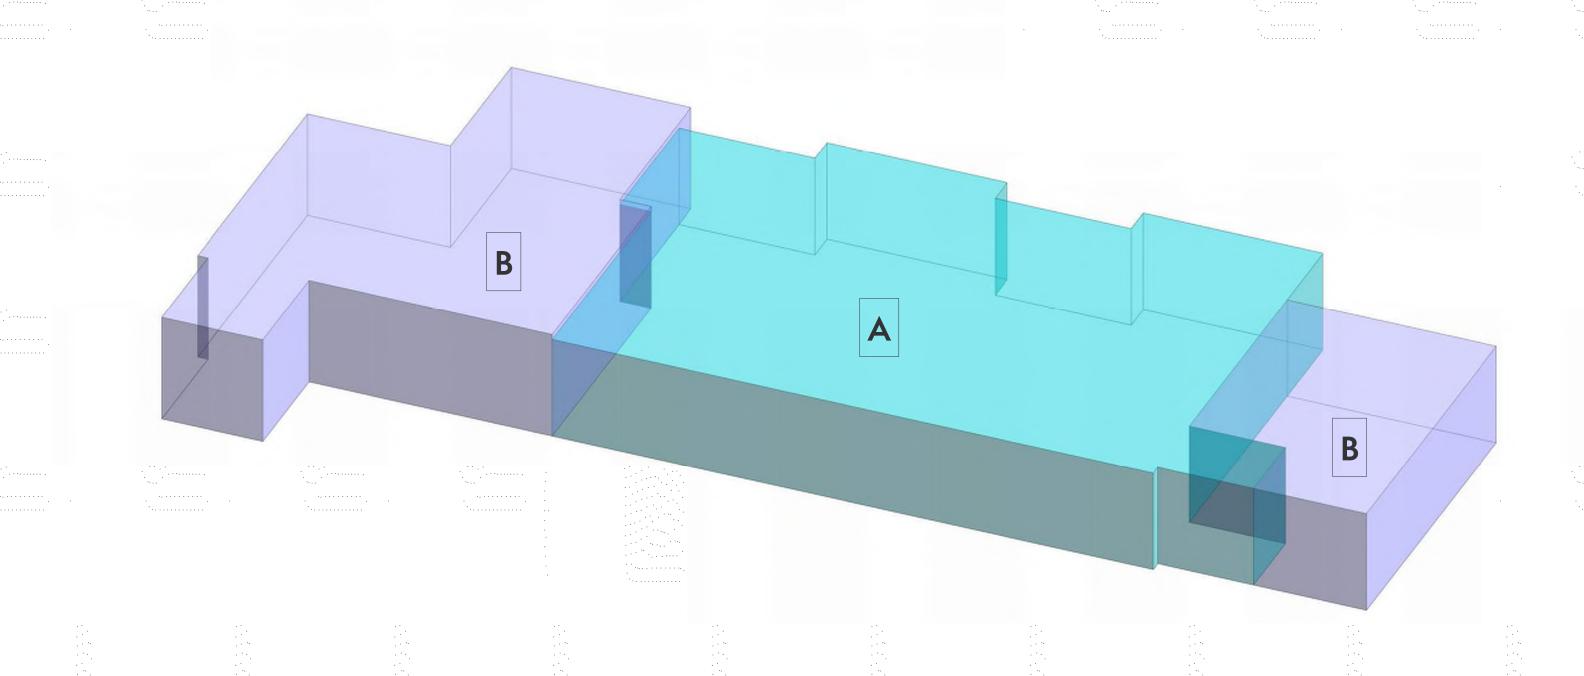

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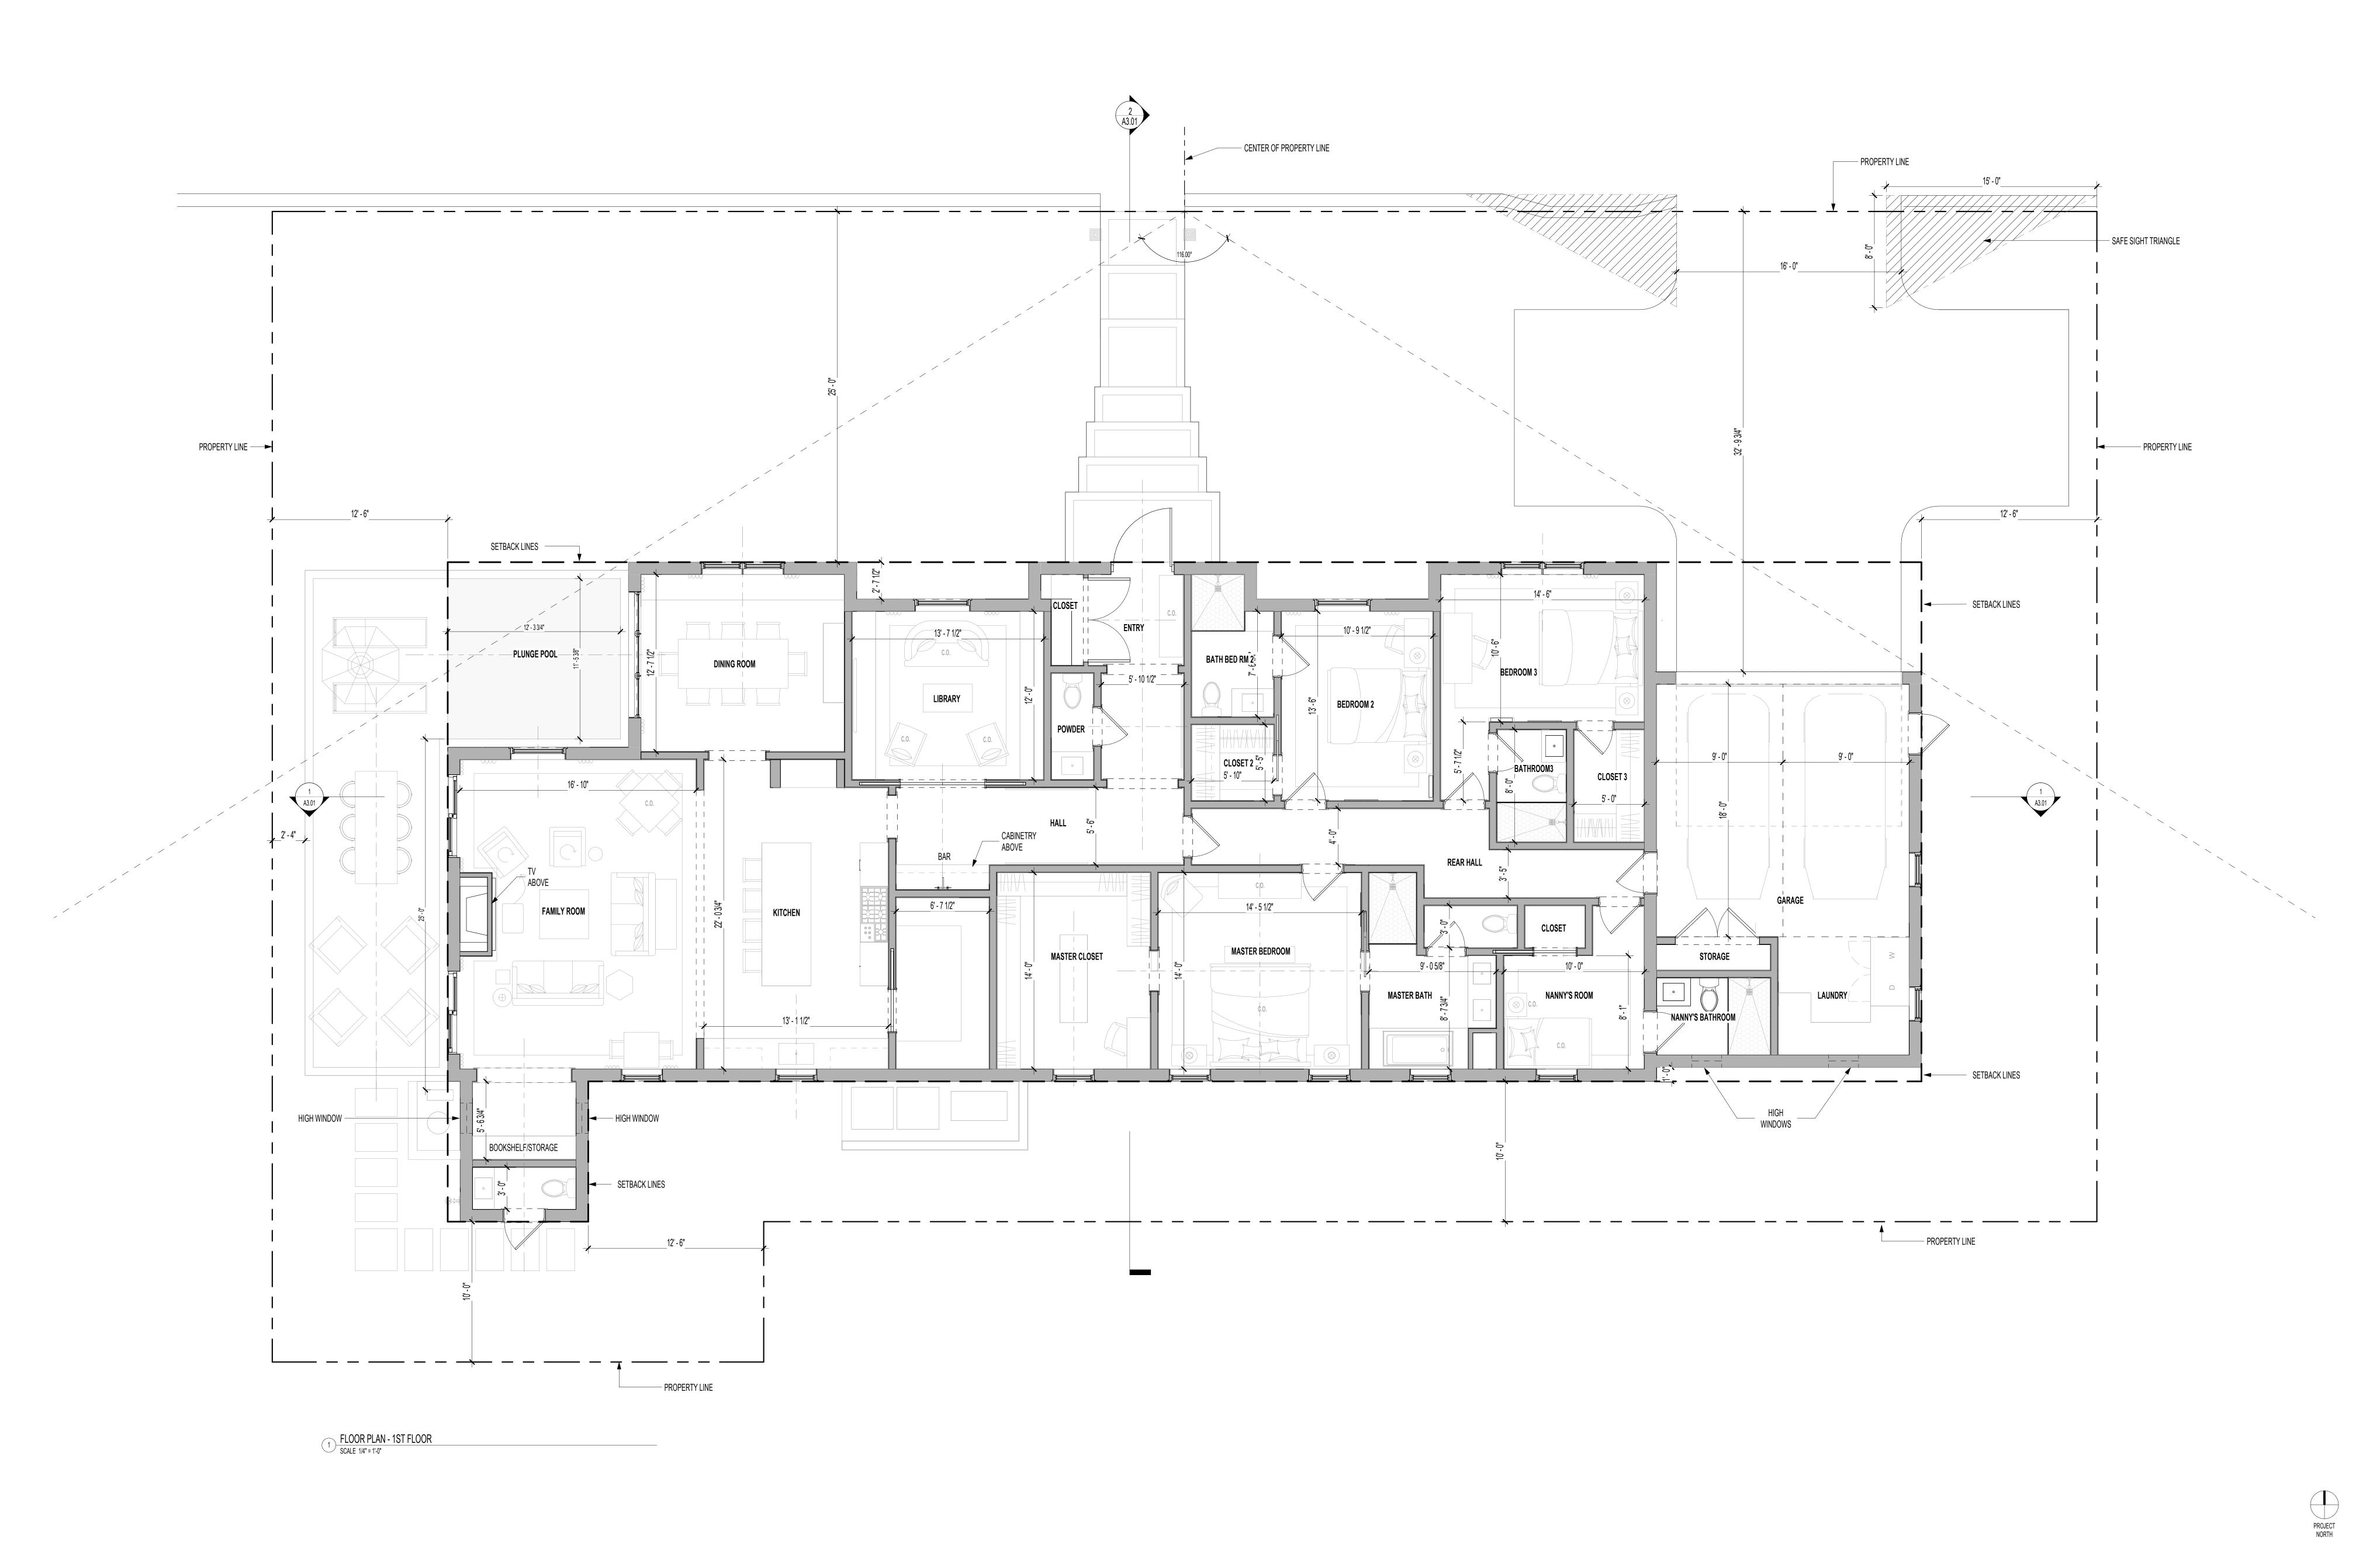
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ZONING DIAGRAMS





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CONSTRUCTION PLAN - 1ST FLOOR


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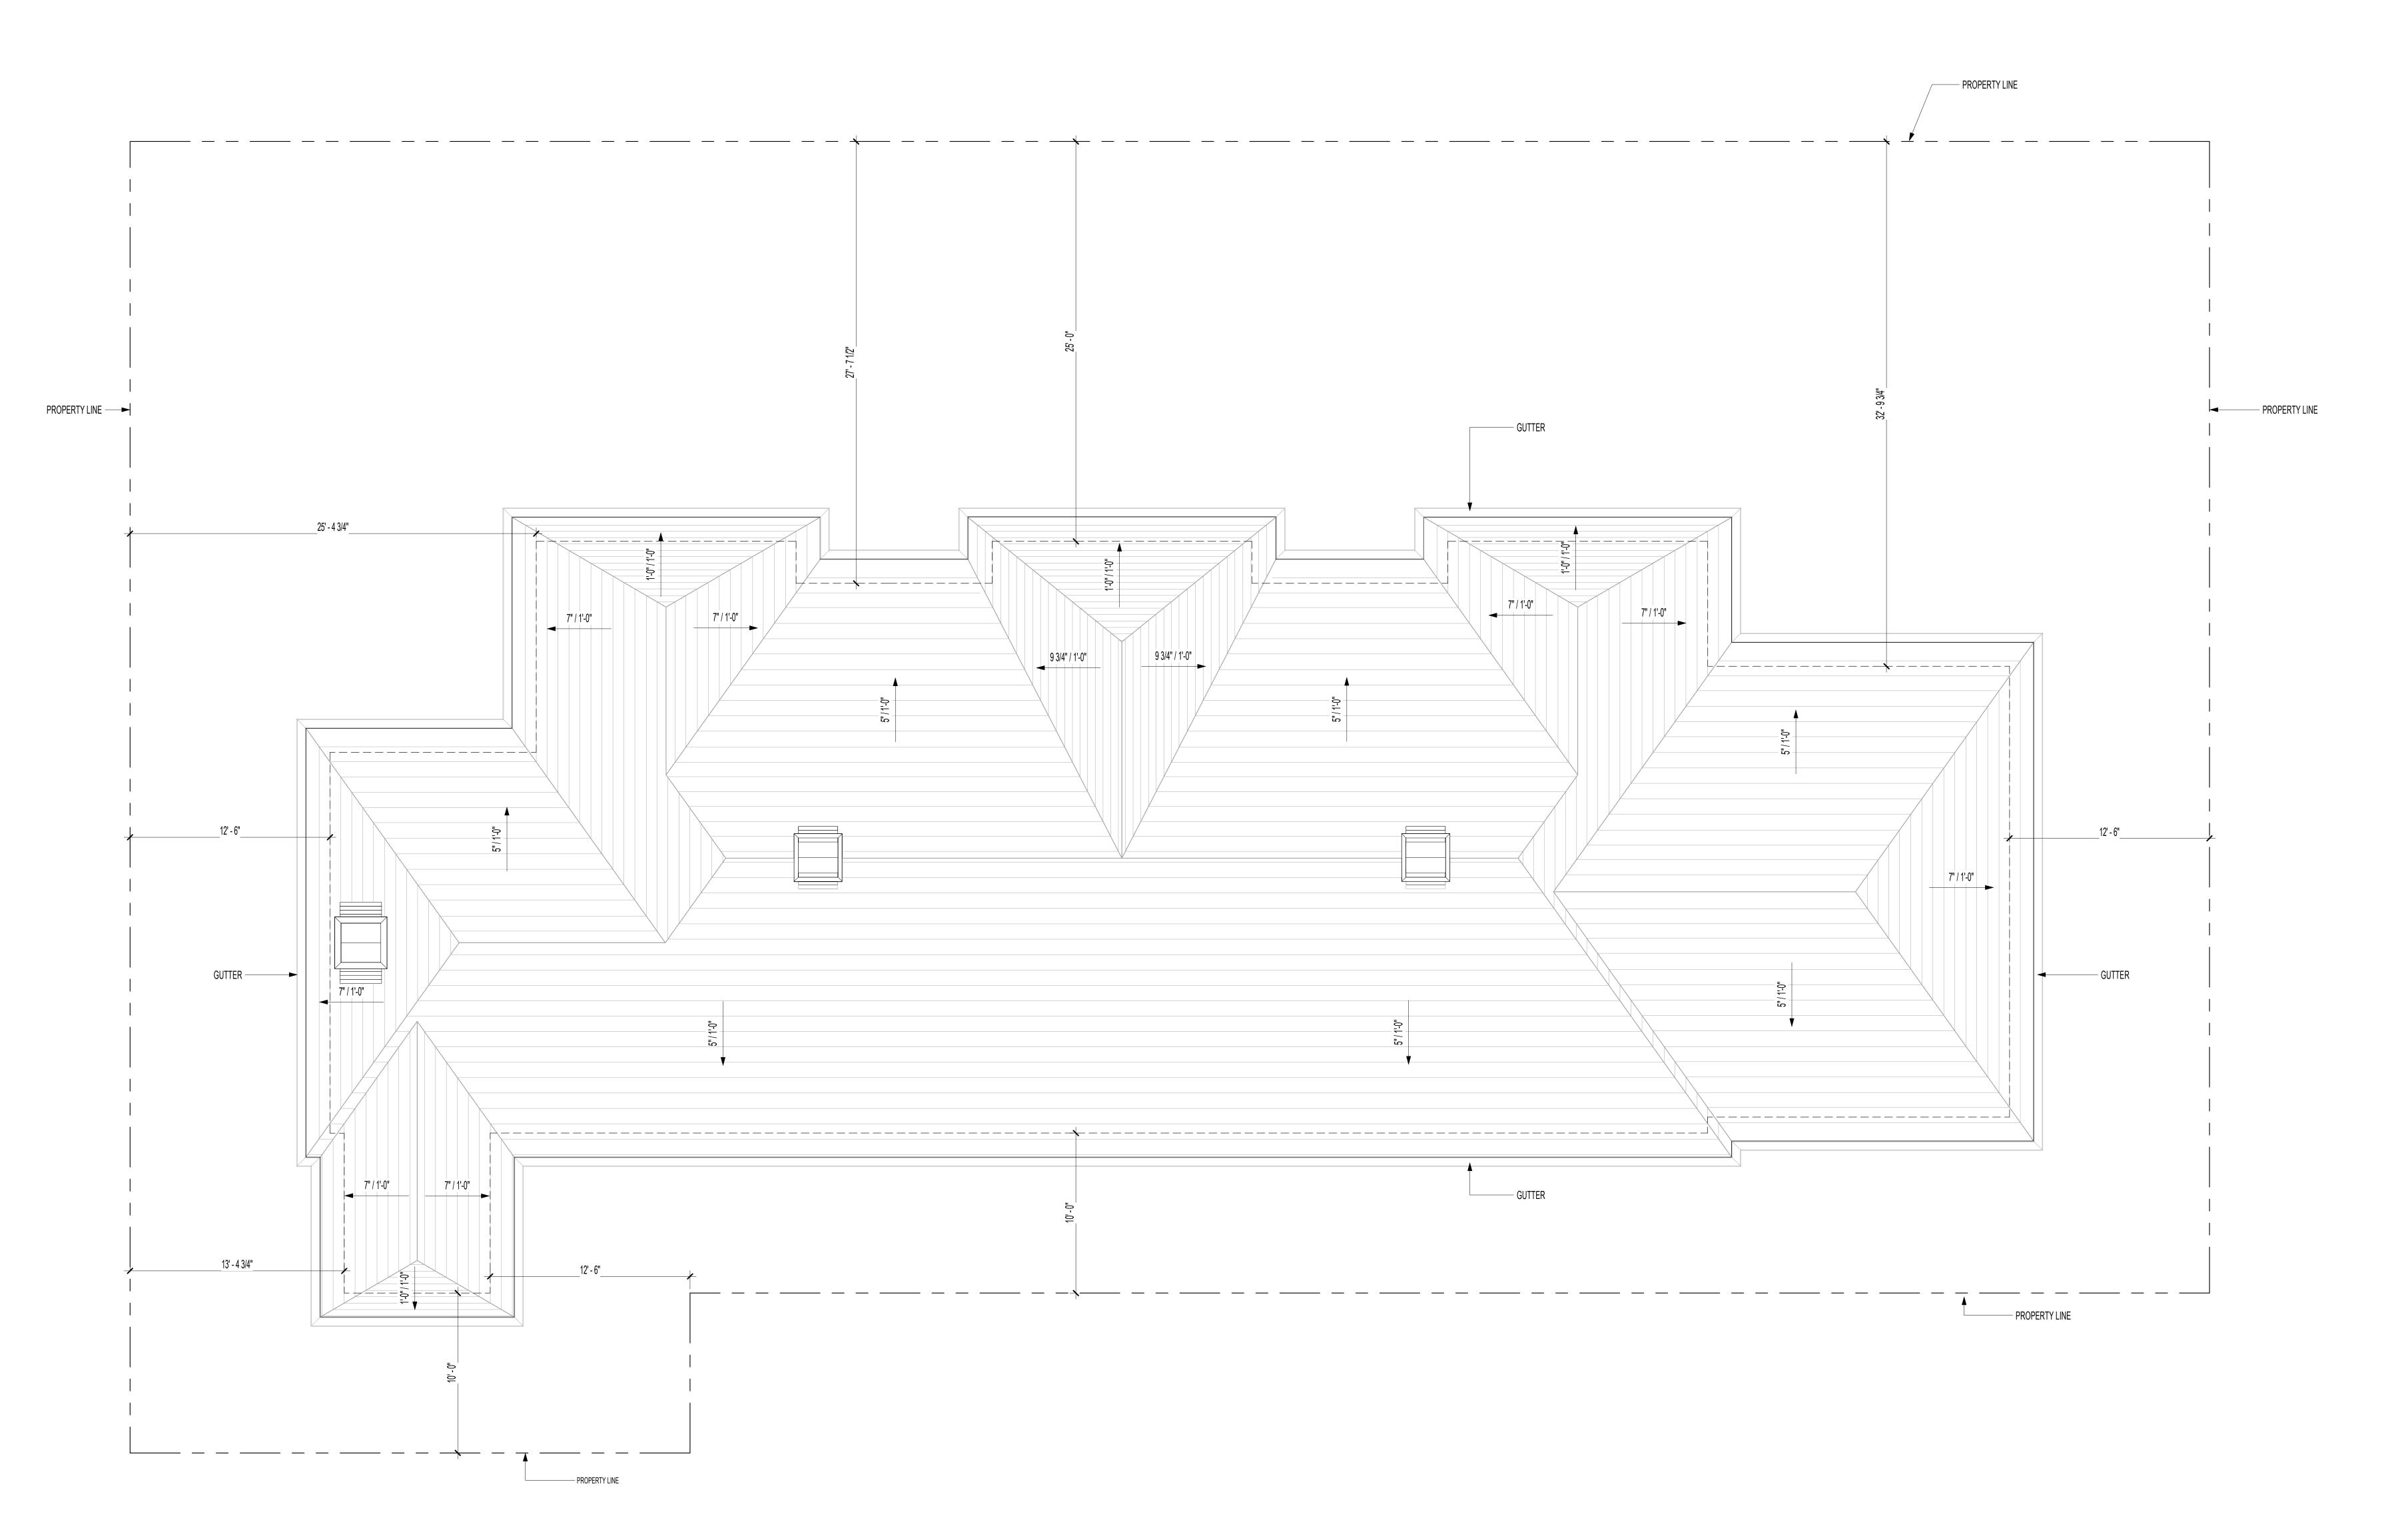
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e ROOF PLAN



FLOOR PLAN - ROOF PLAN


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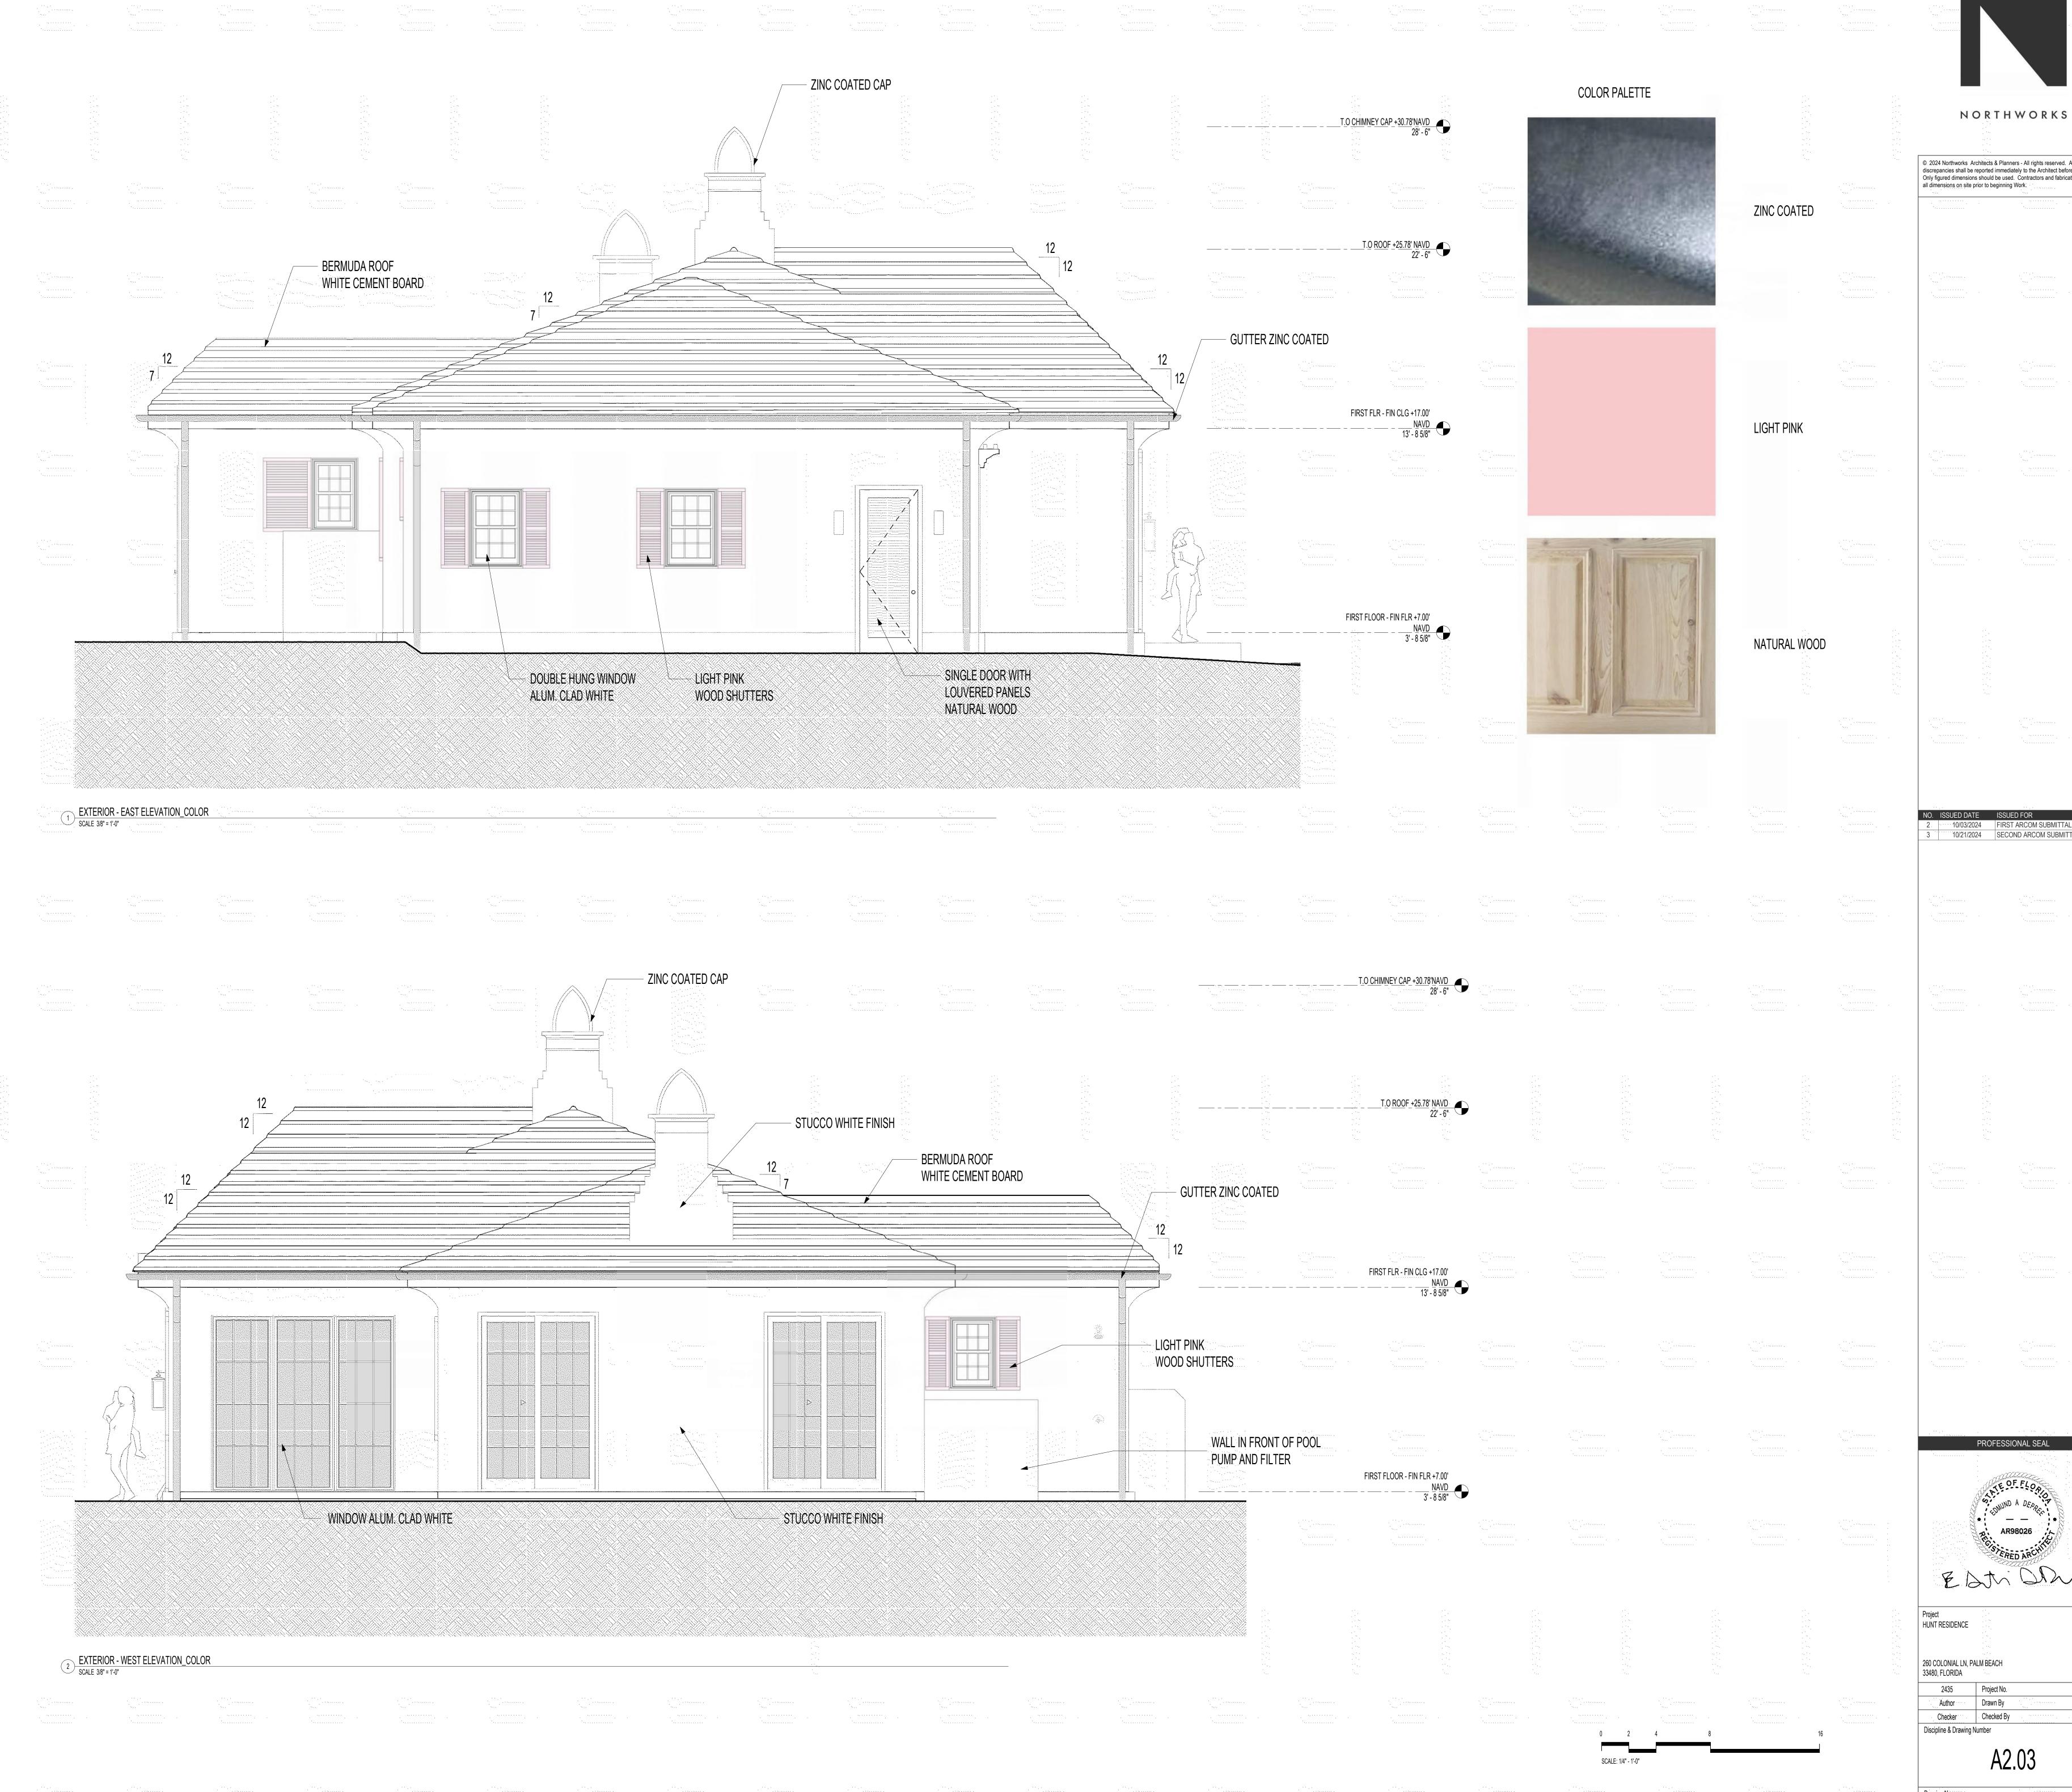
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EXTERIOR ELEVATIONS 2



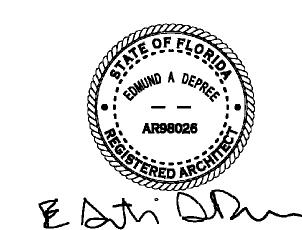

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EXTERIOR ELEVATIONS_COLOR 2

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4 EXISTING STREETSCAPE COLONIAL WAY - LOOKING NORTH
SCALE 3/32" = 1'-0"
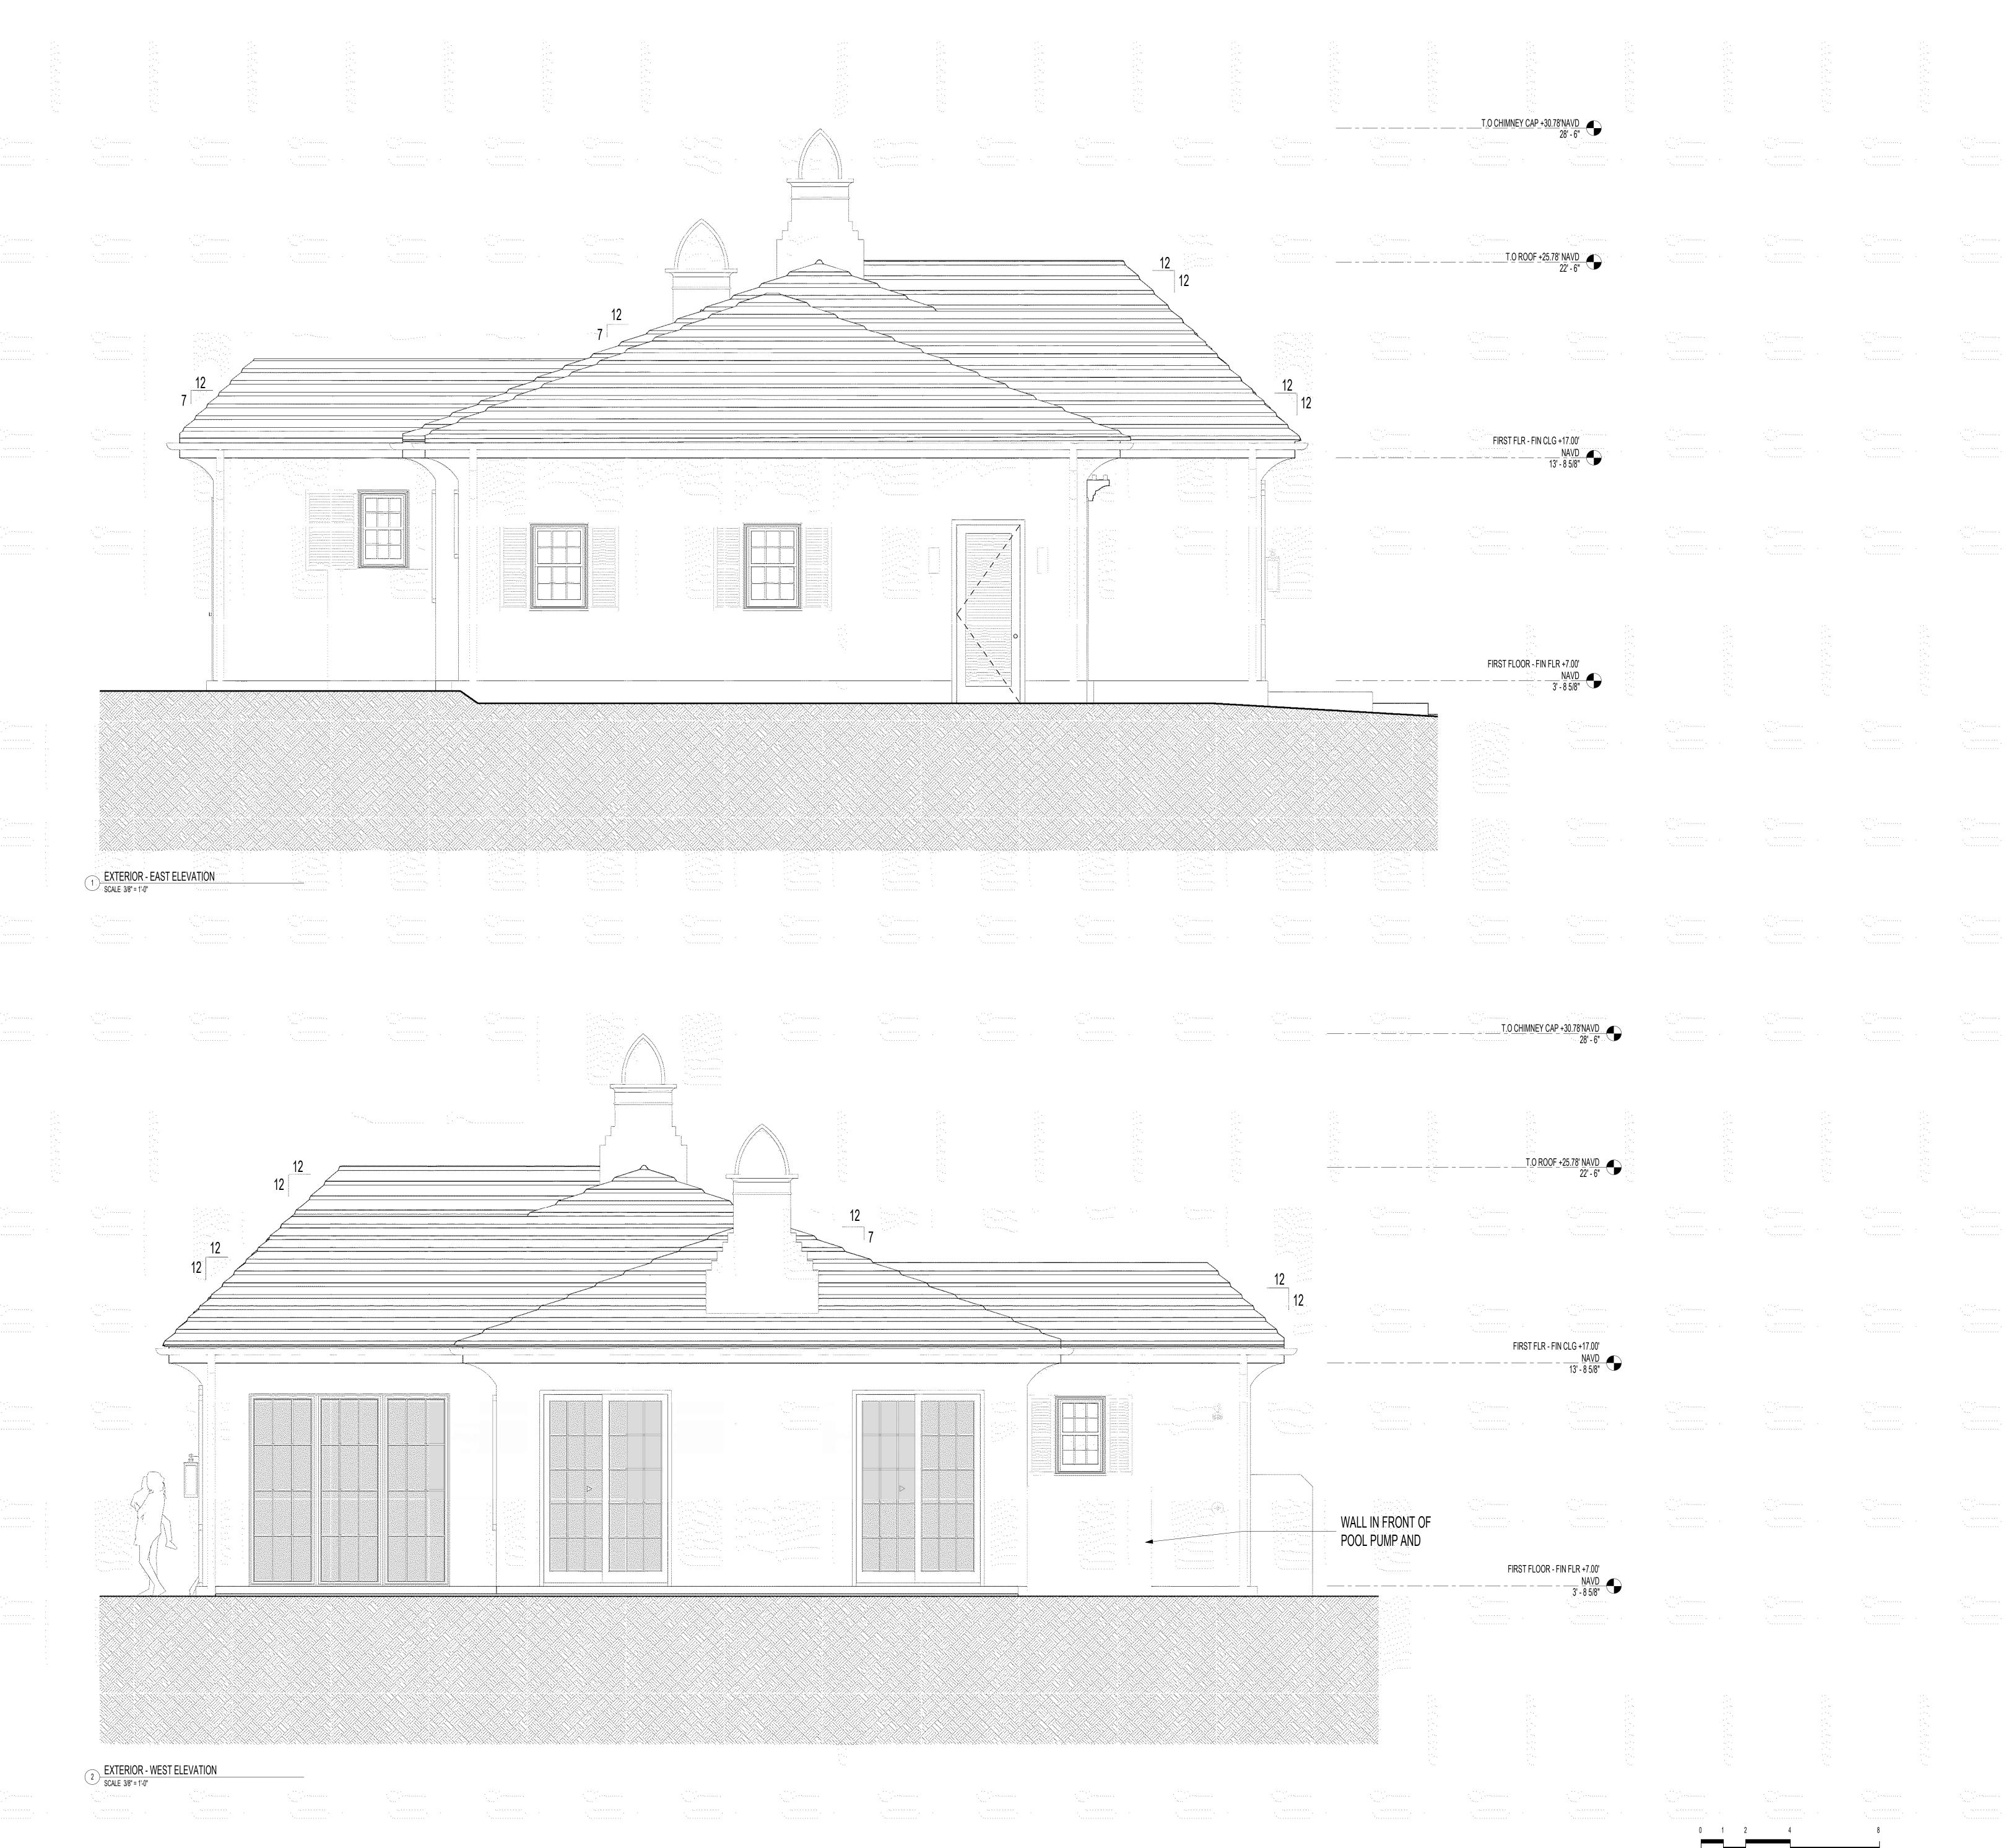
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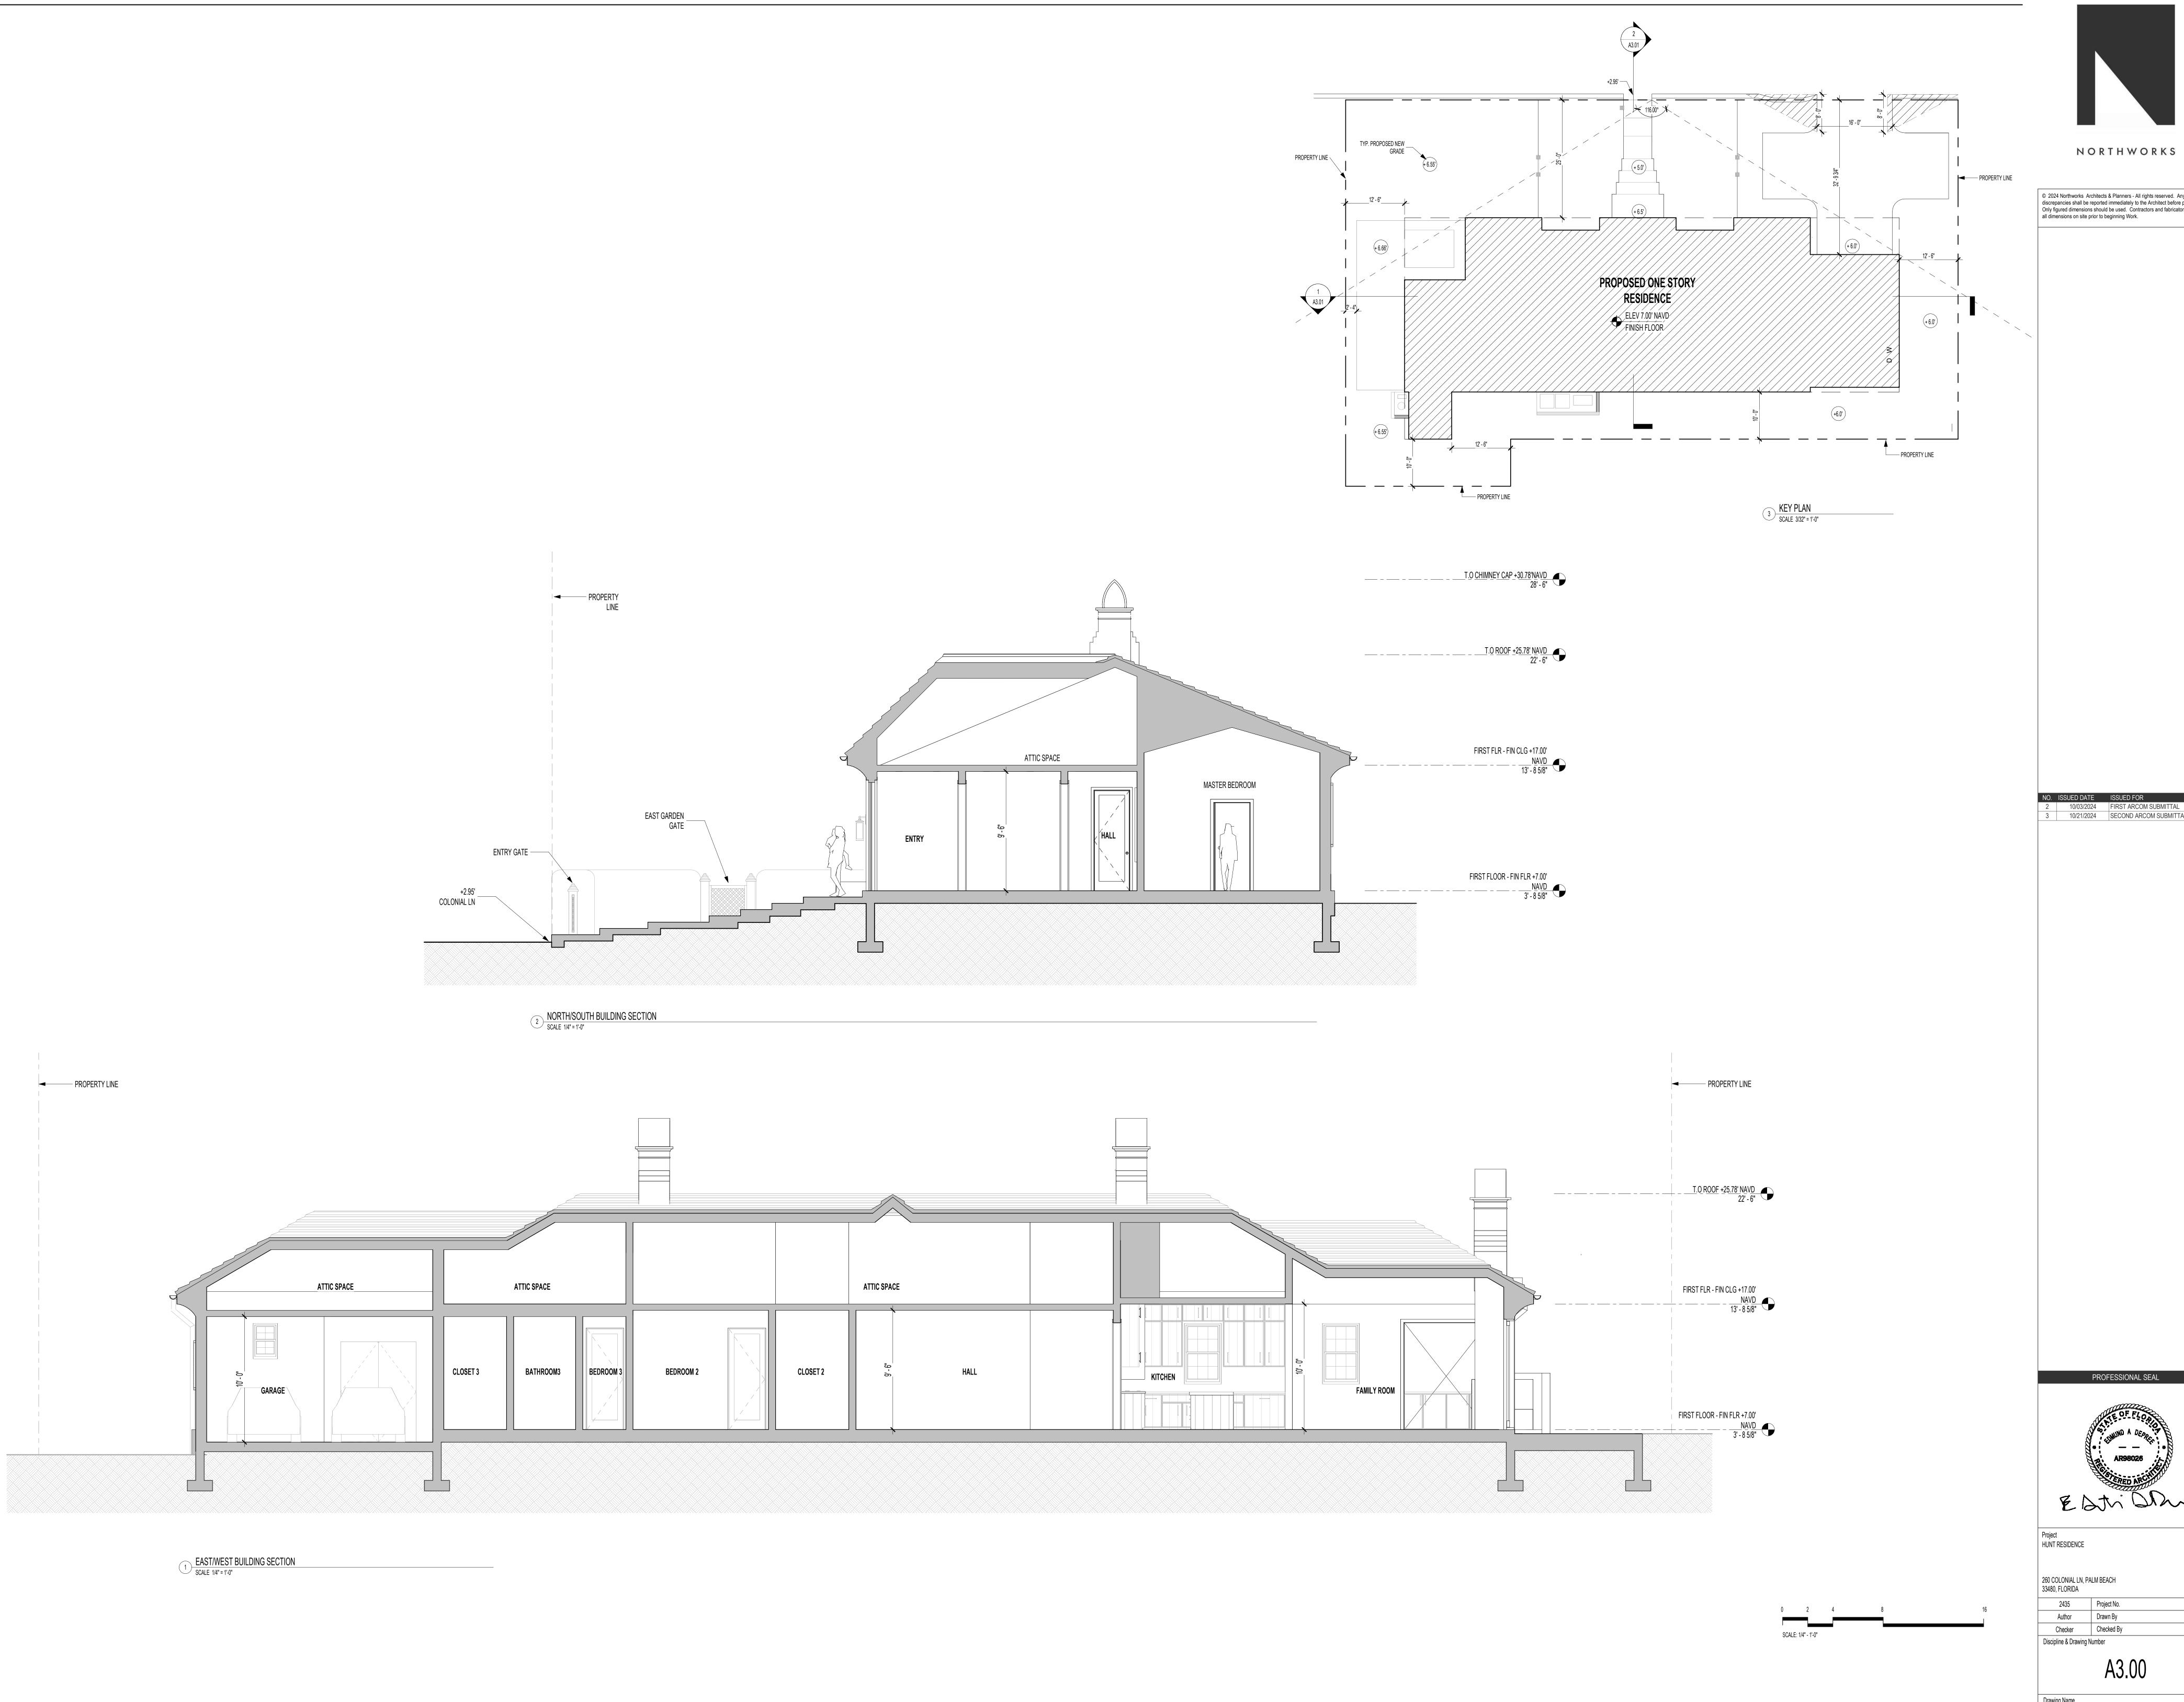
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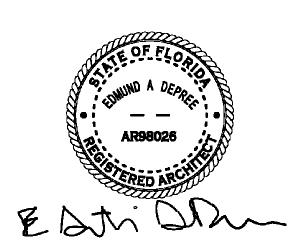
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g Name
STREETSCAPE ELEVATIONS



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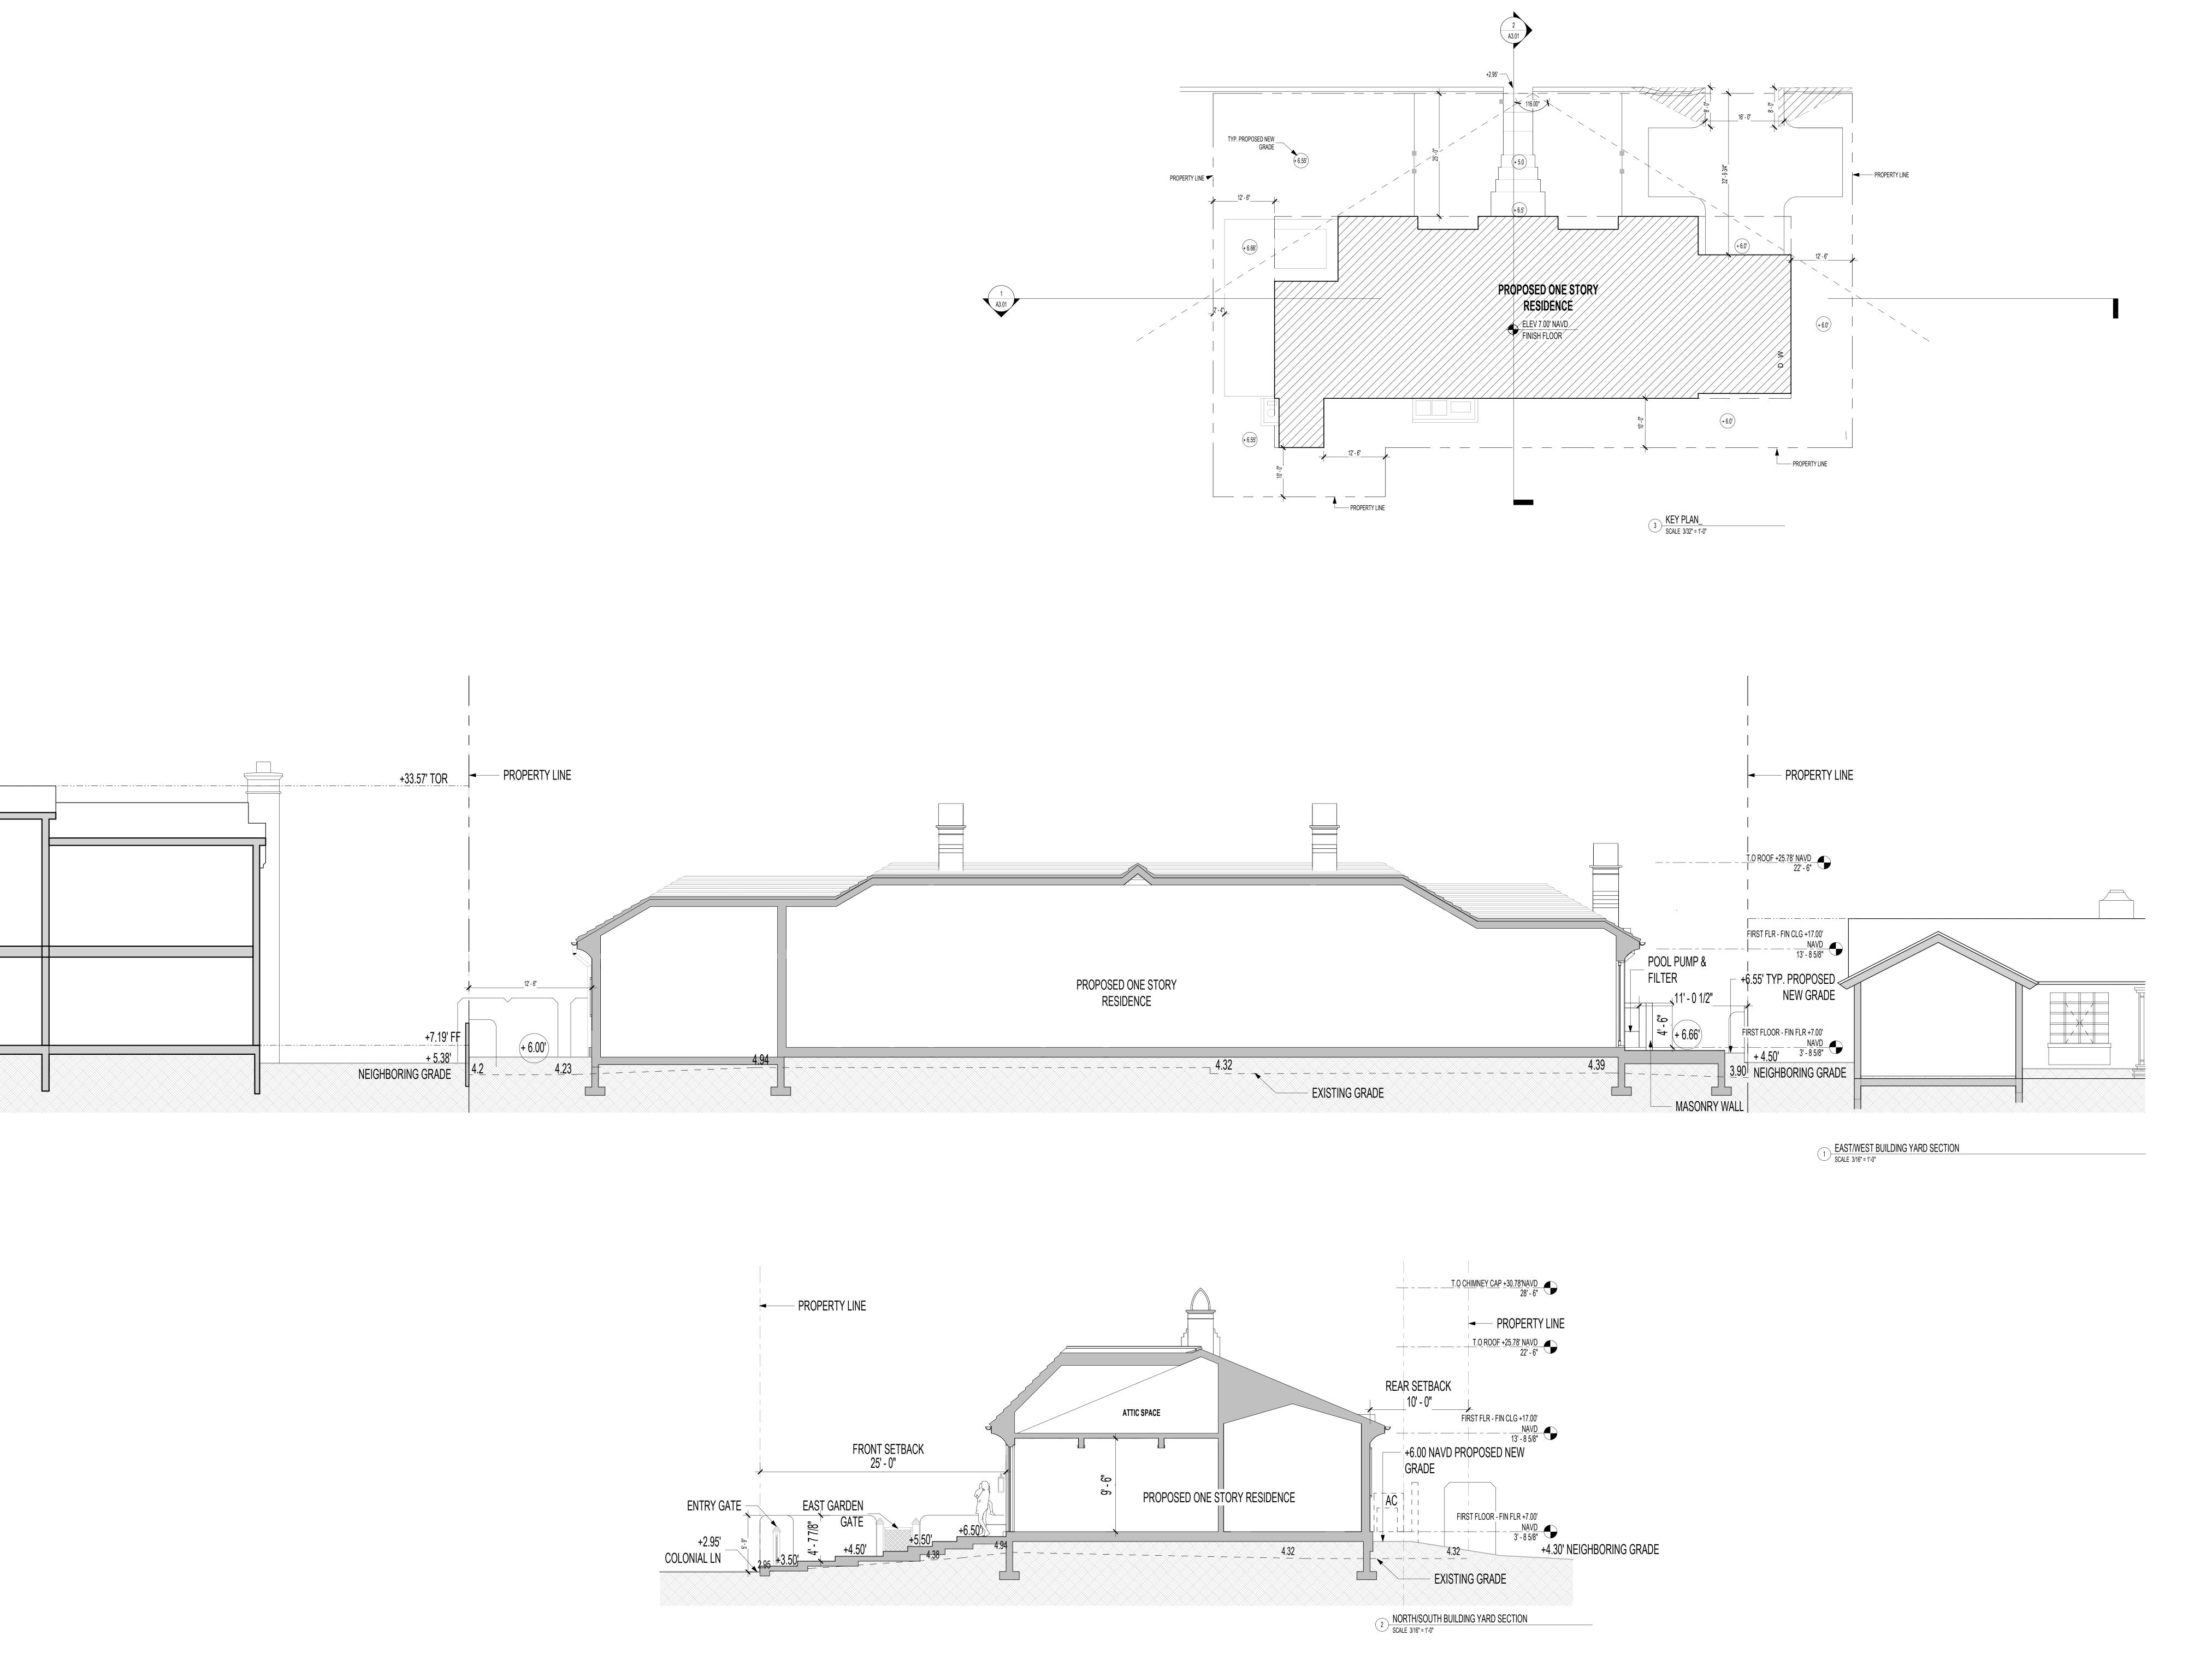
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BUILDING SECTIONS




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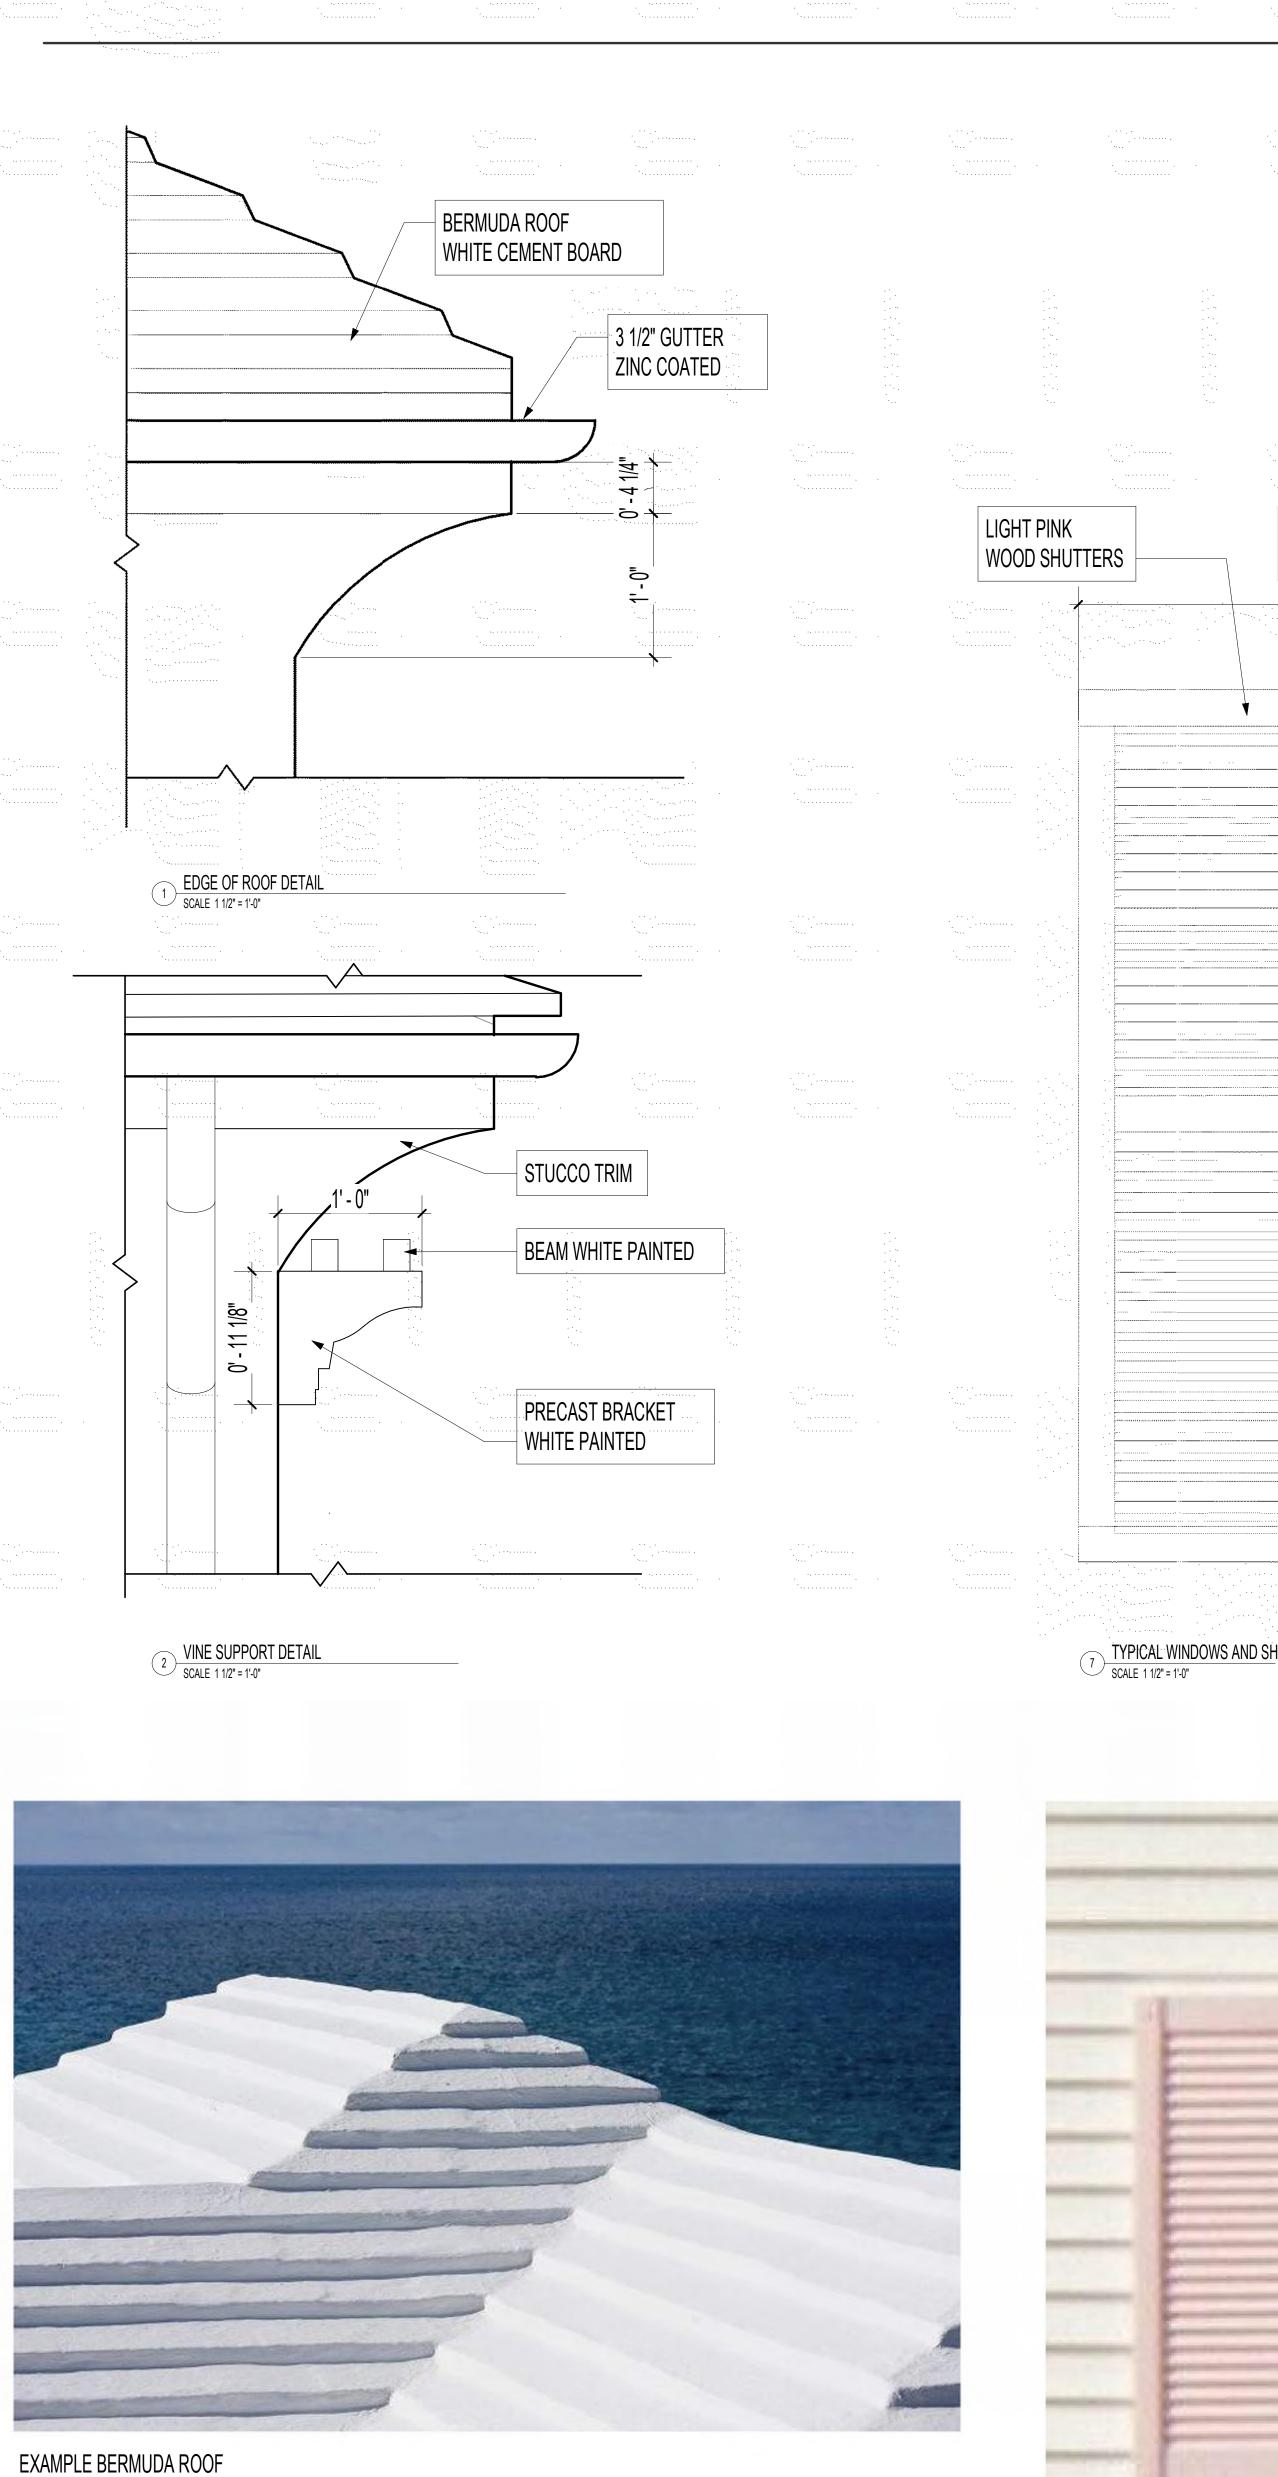
Author Drawn By


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YARD SECTIONS





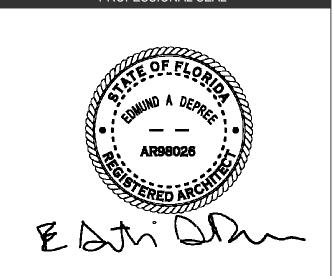



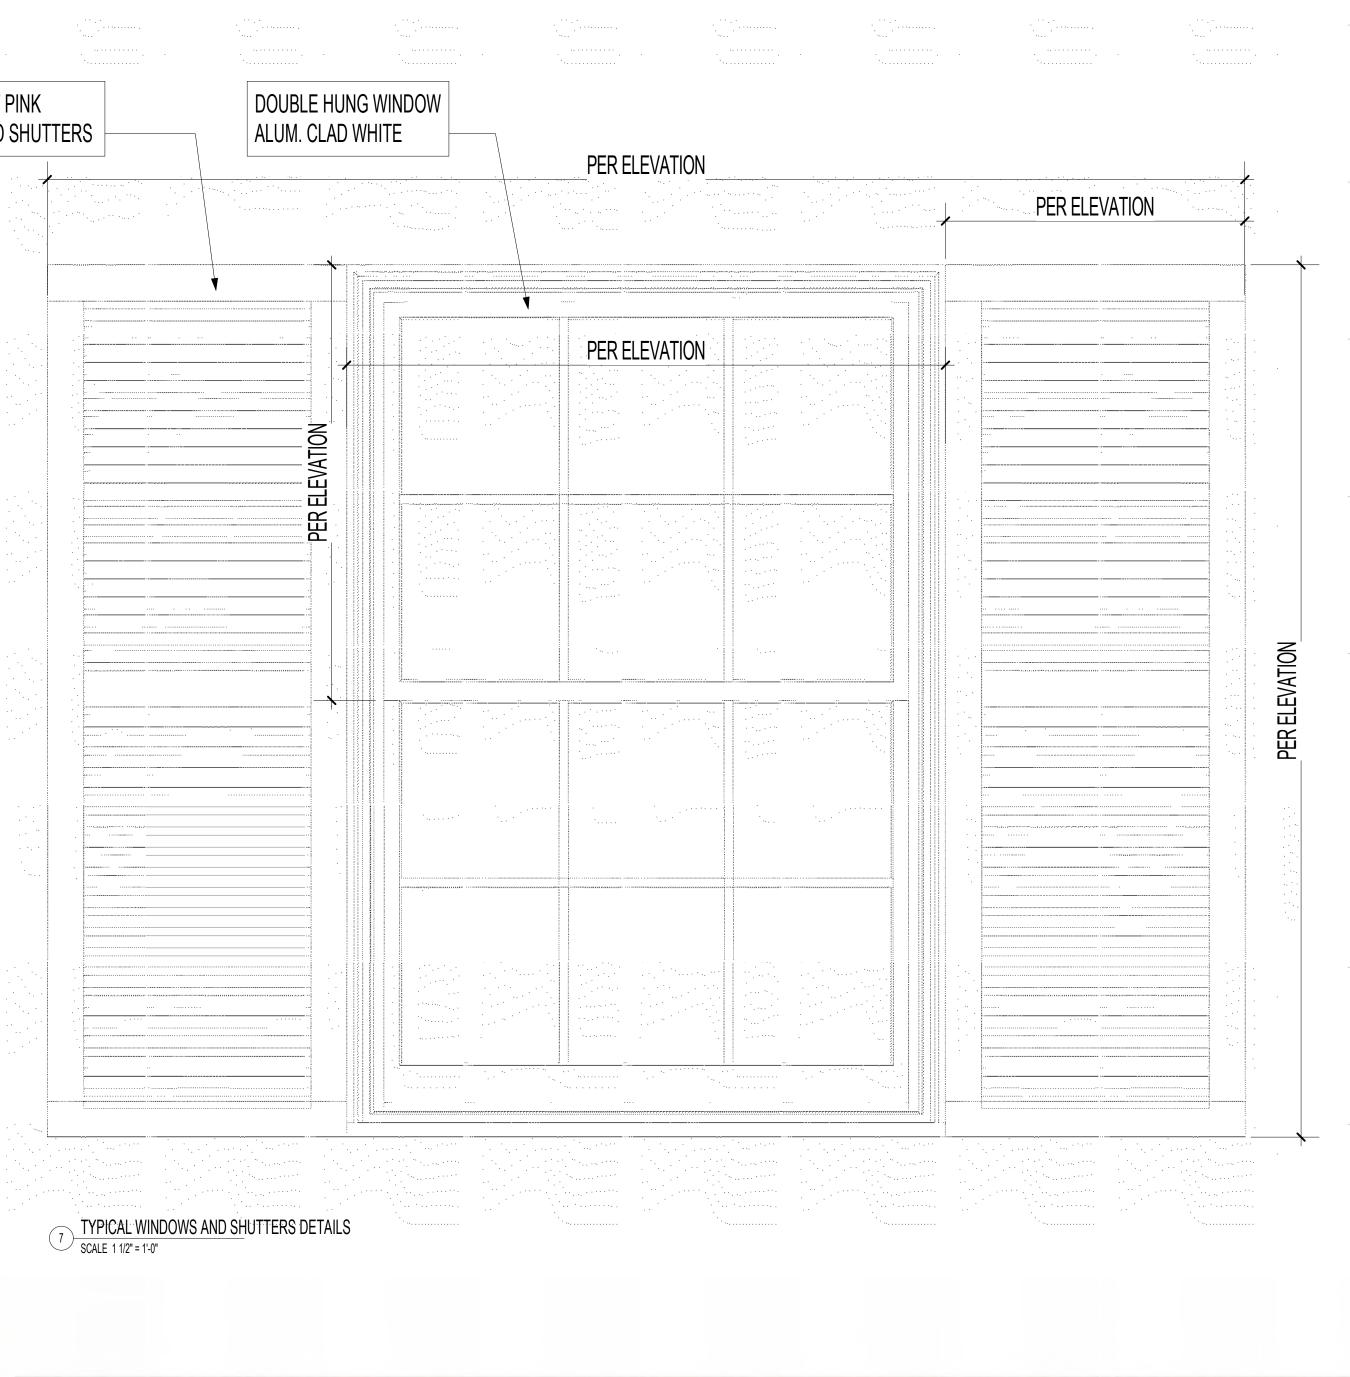



WOOD SHUTTERS



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NATURAL WOOD

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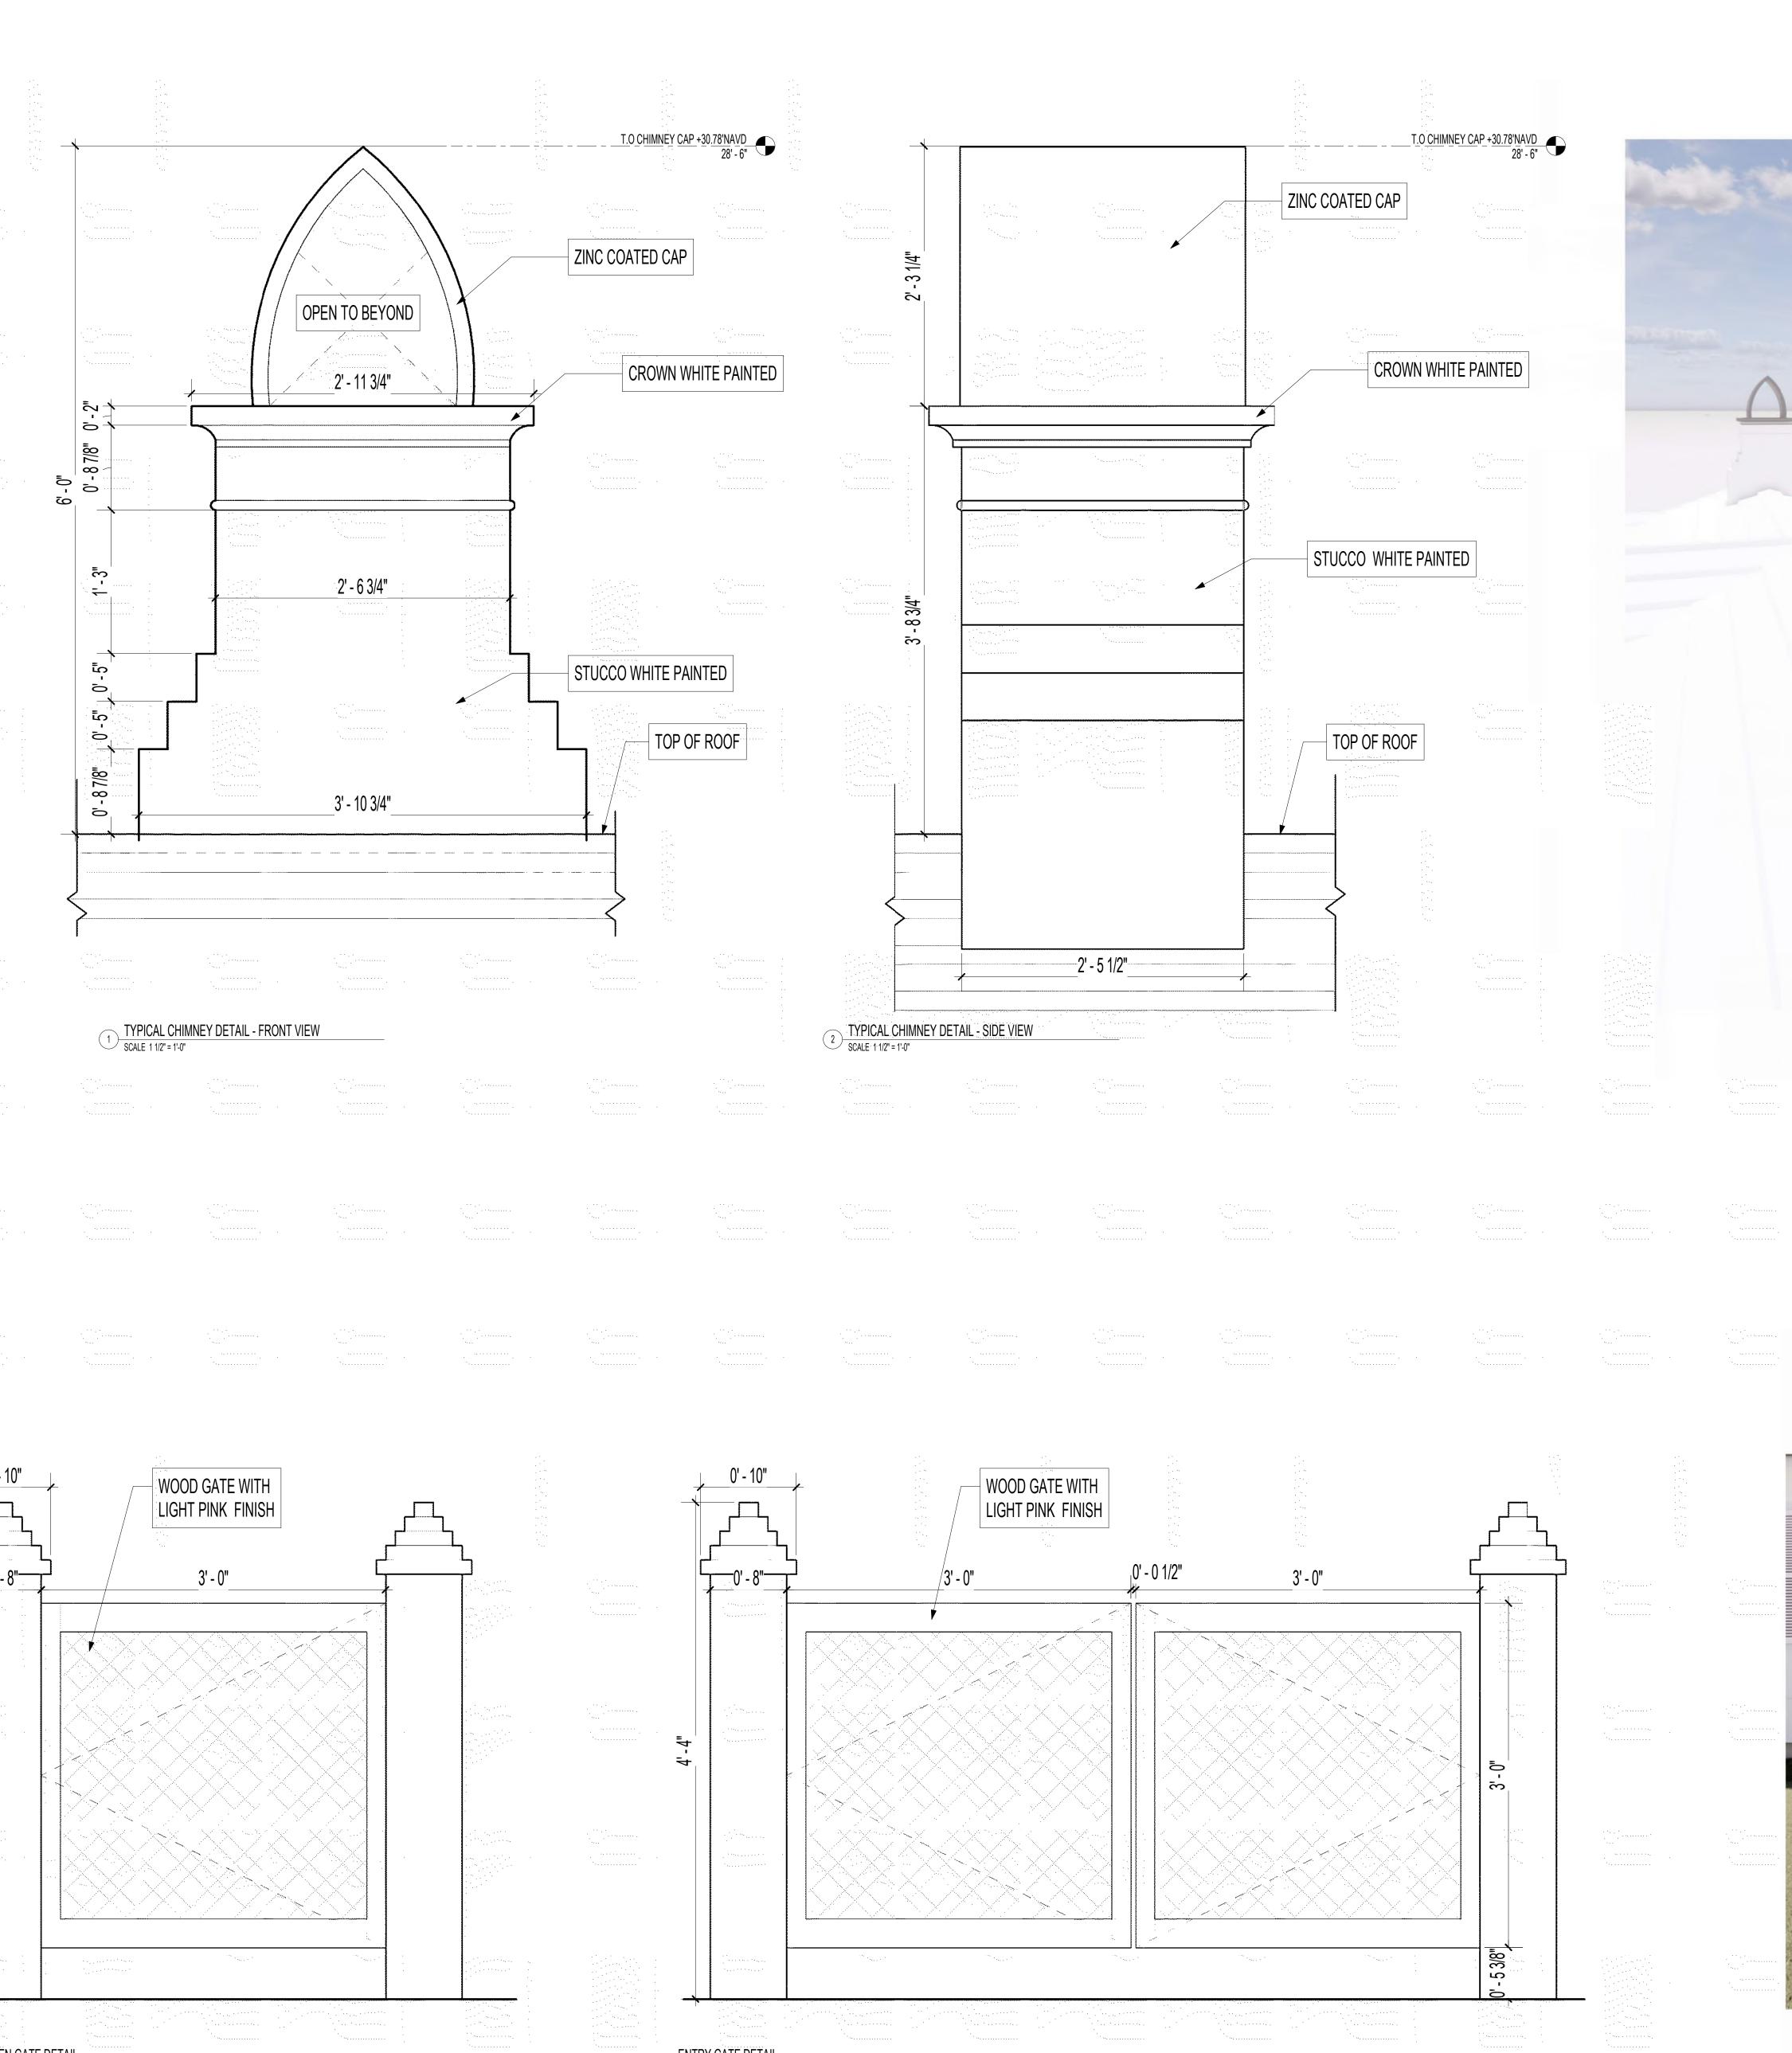
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BUILDING DETAILS - 1


EXAMPLE GUTTER ZINC COATED

EXAMPLE WINDOW AND LIGHT PINK SHUTTERS








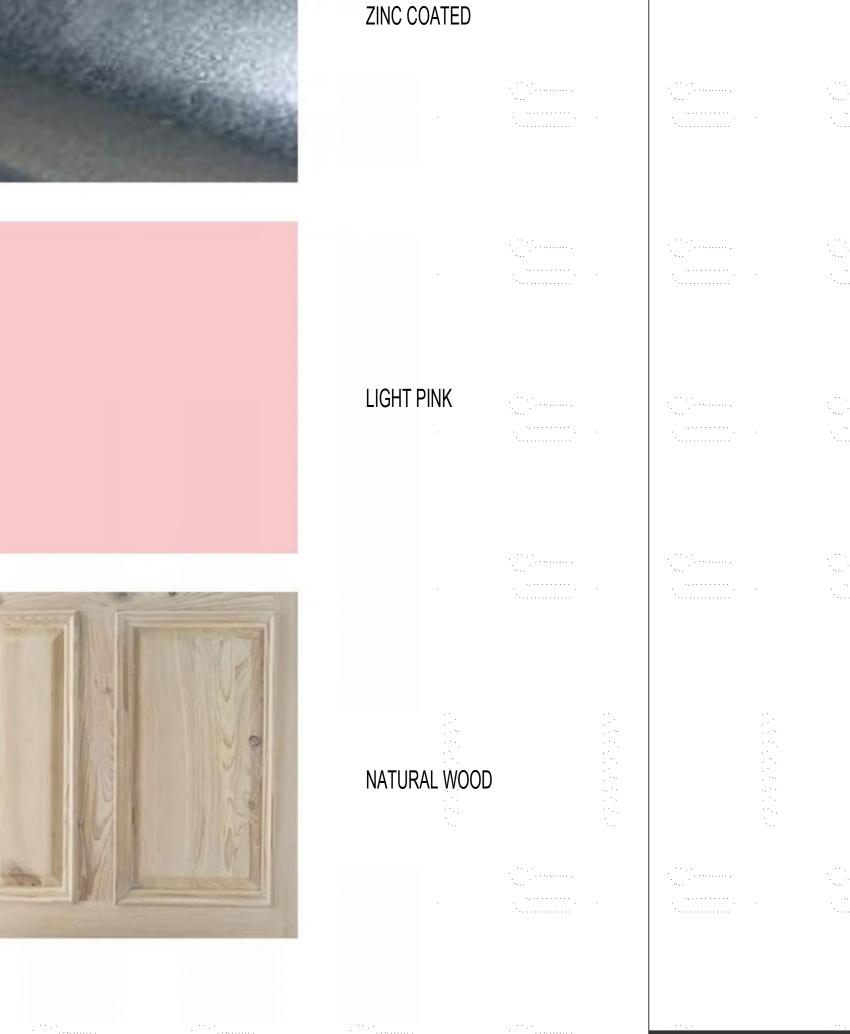

COLOR PALETTE



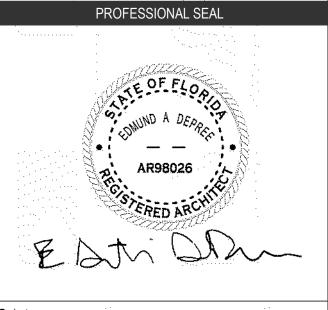

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BUILDING DETAILS - 2



NORTH VIEW WITH LANDSCAPE





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EXTERIOR RENDERINGS



SOUTH VIEW WITHOUT LANDSCAPING



EAST VIEW WITHOUT LANDSCAPING



WEST VIEW WITHOUT LANDSCAPING



SOUTH VIEW WITH LANDSCAPING



EAST VIEW WITH LANDSCAPING



WEST VIEW WITH LANDSCAPING



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EXTERIOR RENDERINGS

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EXTERIOR RENDERINGS

260 COLONIAL LN, PALM BEACH 33480, FLORIDA

STORMWATER RETENTION CALCULATIONS (BASIN A)

A. <u>SITE INFORMATION</u>

Total Property Area = 9,710 sq.ft.

Drainage Basin A Area = 5,789 sq.ft.

Drainage Area Impervious Surface = 2,918 sq.ft.

Drainage Area Pervious Surface = 2,871 sq.ft.

B. ESTIMATED STORMWATER RETENTION VOLUME

The retention volume is estimated using the Rational Method (Q=CiA)

C = 1.0 (impervious surface) C = 0.2 (pervious surface) i = 2 in/hr

Impervious Surface Runoff Volume: $1.0 \times 2 \text{ in/hr} \times 2.918 \text{ sq.ft.} \times 1 \text{ ft./12 in.} = 487 \text{ cu.ft.}$

Pervious Runoff Volume:

 $0.2 \times 2 \text{ in/hr} \times 2,871 \text{ sq.ft.} \times 1 \text{ ft./12 in.} = 96 \text{ cu.ft.}$

Total Volume to be Retained = 583 cu.ft.

C. PROPOSED EXFILTRATION TRENCH SIZING

= Total Length of Trench Provided W = Trench Width K = Hydraulic Conductivity = 0.00005 cfs/sq.ft./ft. of head

H2 = Depth to Water Table = 3.50 ft = 3.00 ftDU = Un-Saturated Trench Depth = 0.00 ftDS = Saturated Trench Depth

= 512 cu.ft. V = Volume Treated Exfiltration Trench #A-2

Total Length of Trench Provided Trench Width = 0.00005 cfs/sq.ft./ft. of head K = Hydraulic Conductivity = 3.50 ft H2 = Depth to Water Table

= 3.00 ftDU = Un-Saturated Trench Depth = 0.00 ftDS = Saturated Trench Depth V = Volume Treated = 538 cu.ft.

= 1,050 cu.ft. Total Volume Retained in Basin A

STORMWATER RETENTION CALCULATIONS (BASIN B)

A. <u>SITE INFORMATION</u>

Total Property Area = 9,710 sq.ft.

Drainage Basin B Area = 3,921 sq.ft.

Drainage Area Impervious Surface = 2,422 sq.ft.

Drainage Area Pervious Surface = 1,499 sq.ft.

B. ESTIMATED STORMWATER RETENTION VOLUME

The retention volume is estimated using the Rational Method (Q=CiA)

C = 1.0 (impervious surface) C = 0.2 (pervious surface) i = 2 in/hr

Impervious Surface Runoff Volume:

 $1.0 \times 2 \text{ in/hr} \times 2,422 \text{ sq.ft.} \times 1 \text{ ft./}12 \text{ in.} = 404 \text{ cu.ft.}$

Pervious Runoff Volume: $0.2 \times 2 \text{ in/hr} \times 1,499 \text{ sq.ft.} \times 1 \text{ ft./12 in.} = 50 \text{ cu.ft.}$

Total Volume to be Retained = 454 cu.ft.

C. PROPOSED EXFILTRATION TRENCH SIZING

DS = Saturated Trench Depth

V = Volume Treated


L = Total Length of Trench Provided = 39 ft W = Trench Width = 14 ft = 0.00005 cfs/sq.ft./ft. of head K = Hydraulic Conductivity H2 = Depth to Water Table = 1.50 ftDU = Un-Saturated Trench Depth = 1.00 ft

= 1.00 ft


= 459 cu.ft.

Notes:

- 1) Exfiltration trenches and storm piping to be protected from roots with a root barrier.
- 2) Roof drain downspouts are to be connected to the proposed drainage system. Contractor to provide engineer with downspout locations prior to installation of drainage system.
- 3) Exfiltration trench design uses an assumed value of hydraulic conductivity. Client may obtain a site specific test for hydraulic conductivity prior to exfiltration trench installation.
- 4) Contractor shall mill and overlay all roadway cuts a minimum of 50 ft. on either side of the excavation the entire width of each affected lane.
- 5) Contractor is responsible for installing and maintaining erosion control measures during construction.
- 6) Video inspection of storm drainage system required prior to installation of sod.

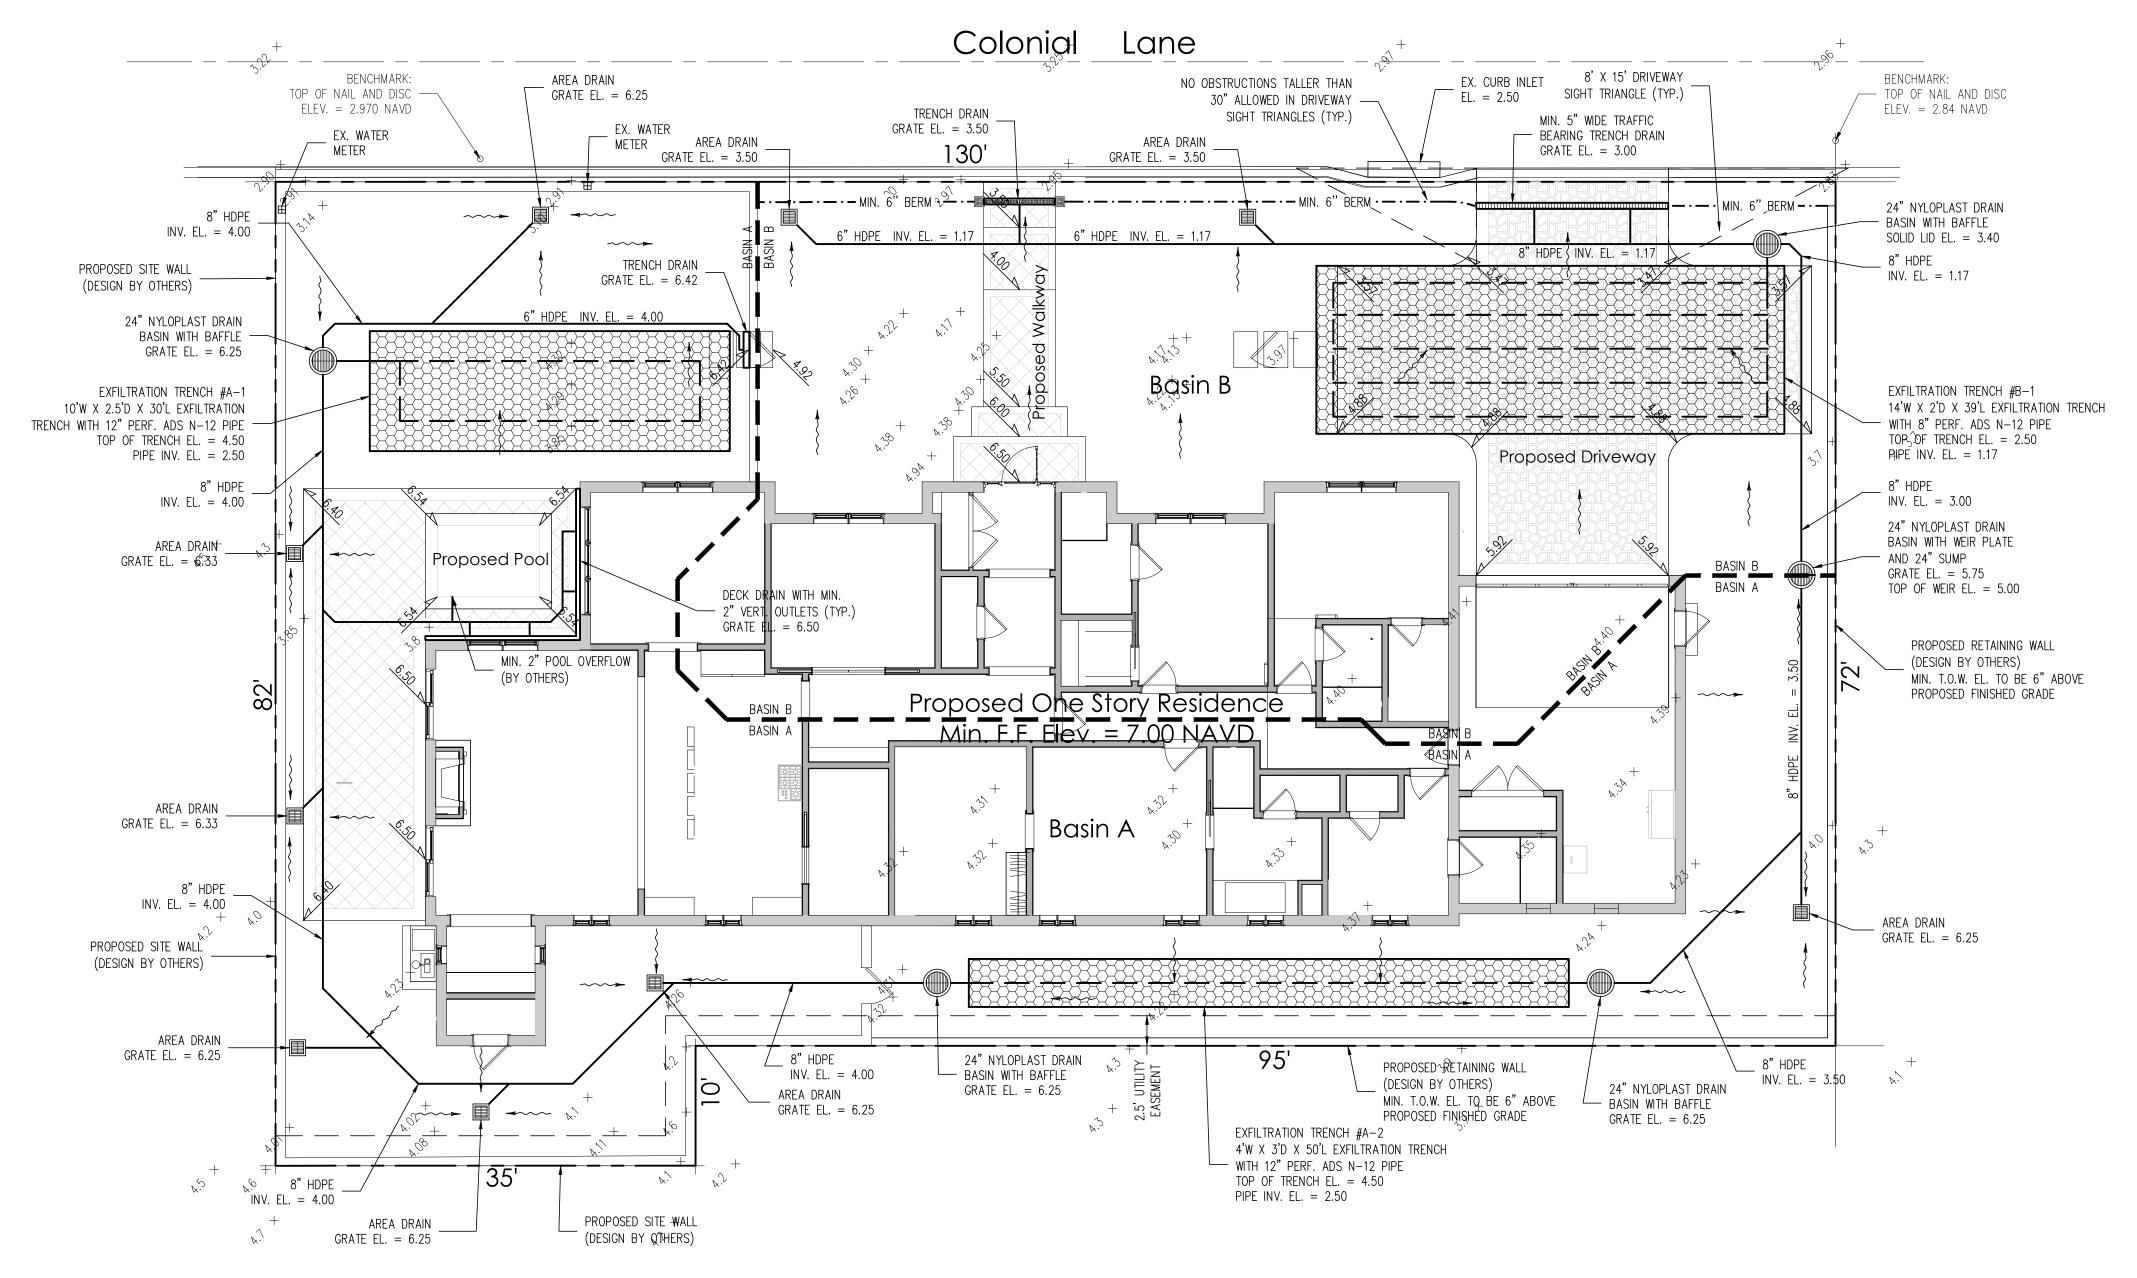

Legend EXISTING ELEVATION PER WALLACE SURVEYING CORP. (NAVD-88) PROPOSED ELEVATION (NAVD-88) ---7.00--- PROPOSED ELEVATION CONTOUR (NAVD-88) FLOW DIRECTION EXFILTRATION TRENCH AREA DRAIN 24" NYLOPLAST DRAIN BASIN WITH BAFFLE Scale: 1/8" = 1'-0"

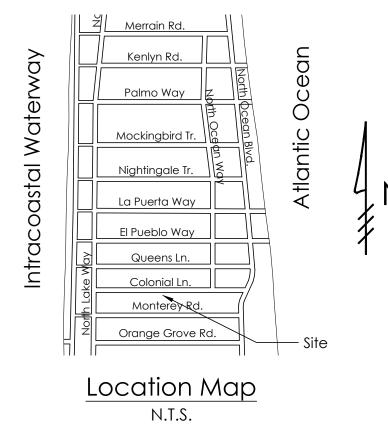



GRUBER CONSULTING **ENGINEERS**

West Palm Beach, FL 33401 **6** 561.312.2041 □ office@gruberengineers.com

2475 Mercer Avenue, Suite 305

48 HOURS BEFORE DIGGING, CALL 1-800-432-4770 SUNSHINE STATE ONE CALL OF FLORIDA, INC.

Contractor is responsible for obtaining location of existing utilities prior to commencement of construction activities.

Drainage | S Ш Ш S <u>|</u>

> OP **A**

PROJECT INFORMATION:

Project No. | 2024-0022 Issue Date 10/18/2024 Scale 1/8" = 1'-0"

REVISIONS:

CHAD M. GRUBER FLORIDA P.E. NO. 57466

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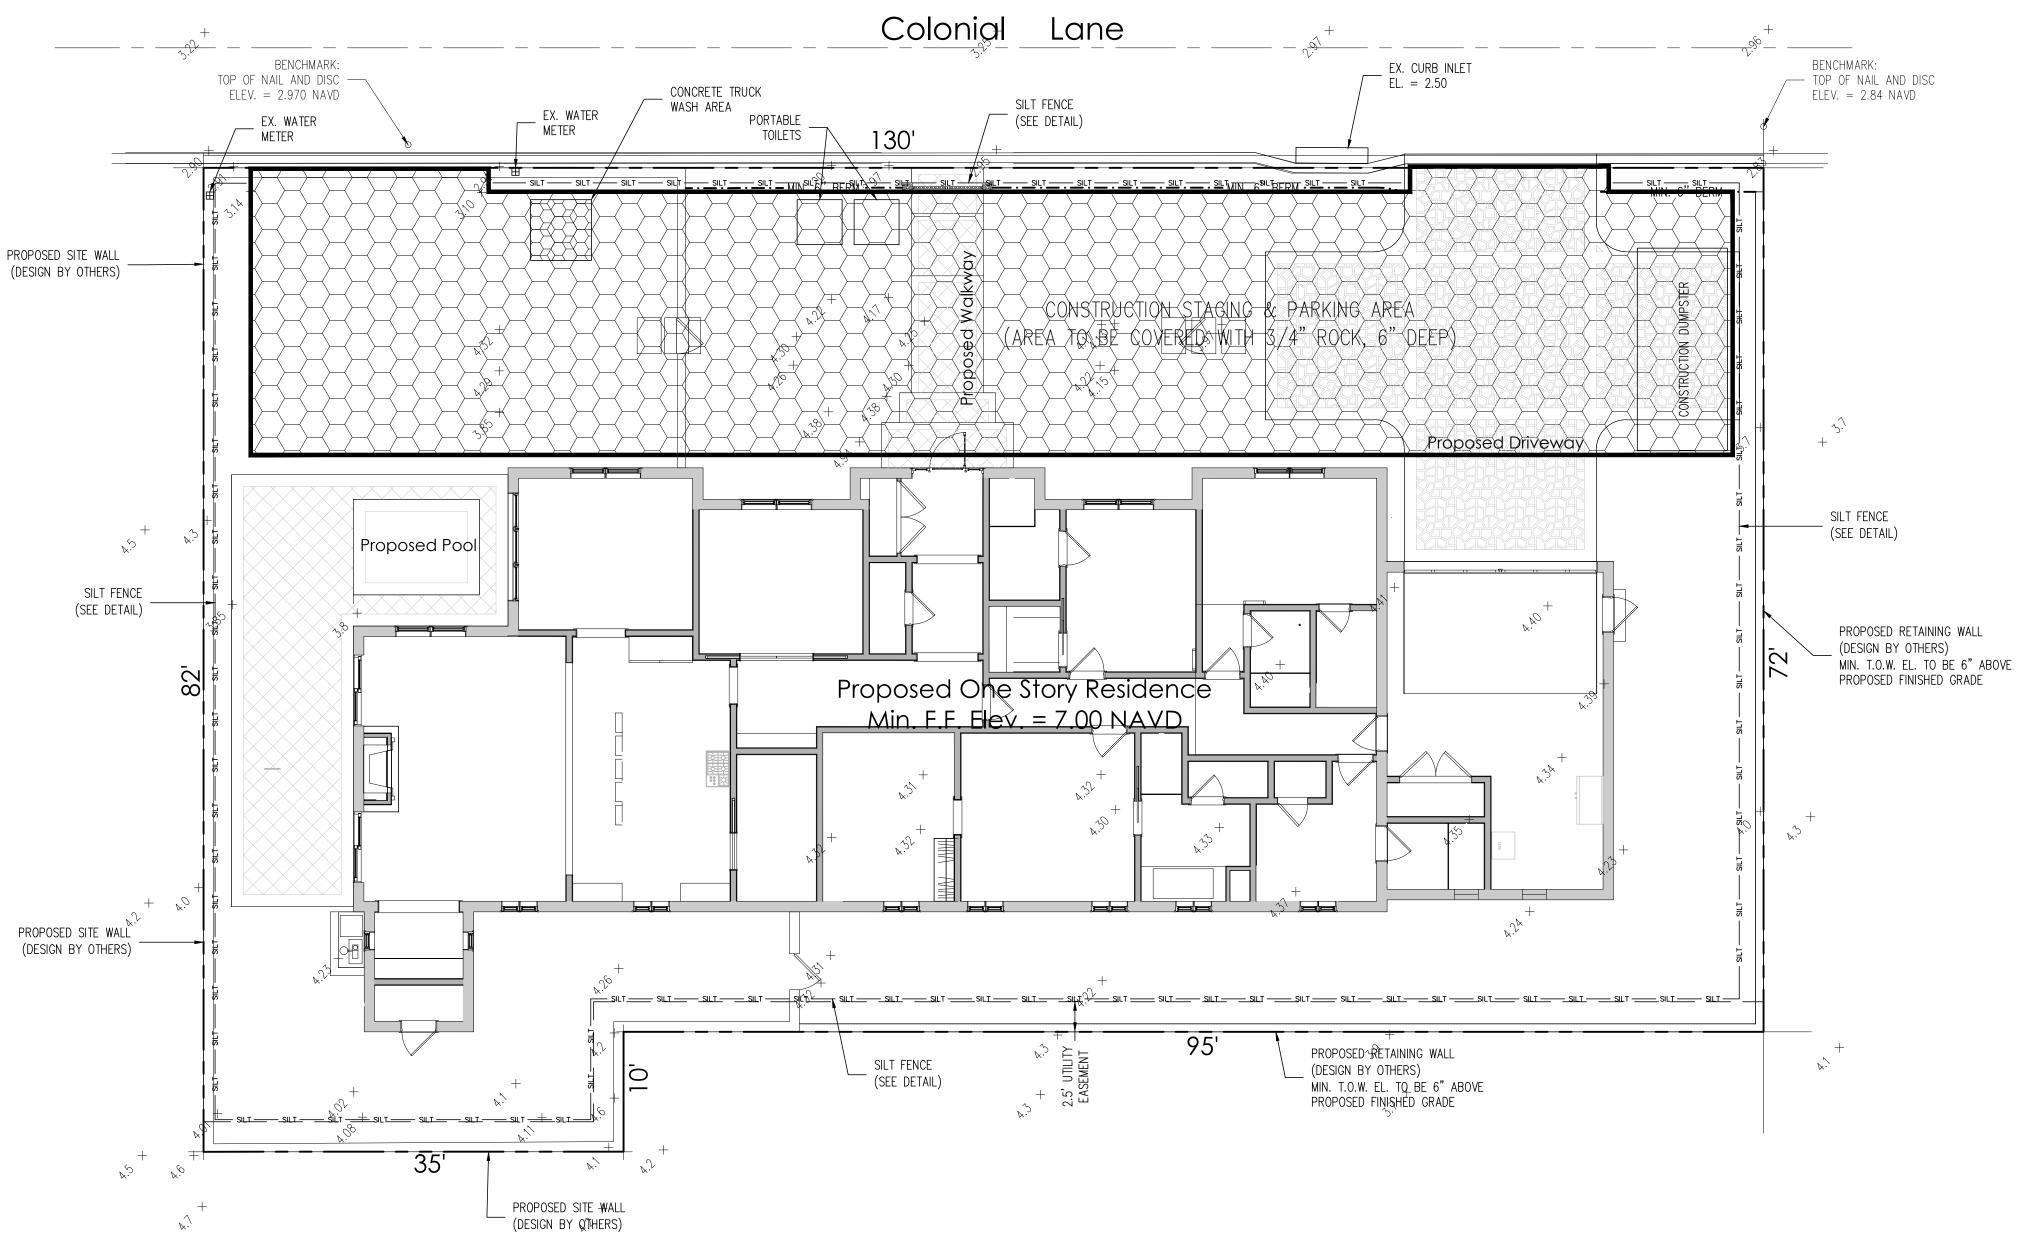
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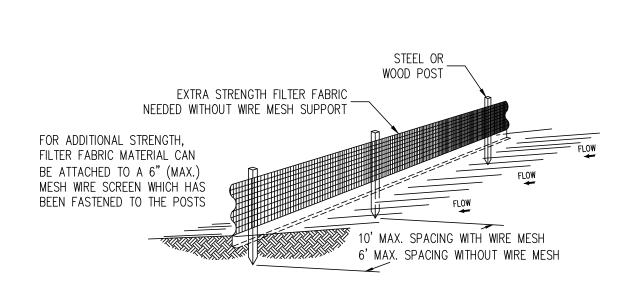
C-

Plan Background from Hardscape Plan by SMI Landscape Architecture Received 10/15/24

> ARC-24-0106 ZON-24-0063

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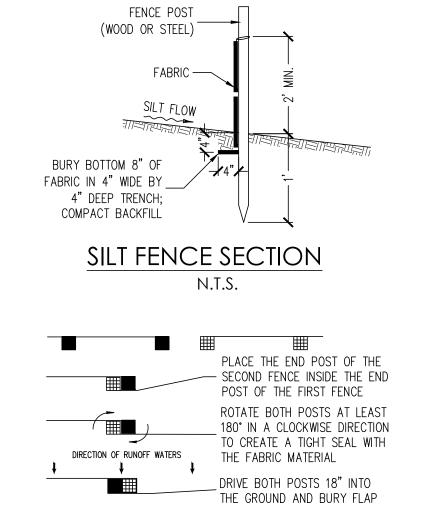


1) The height of a silt fence shall not exceed 36".

- 2) Filter fabric shall be purchased in a continuous roll cut to the length of the barrier to avoid the use of joints.
- 3) Posts shall be spaced a maximum of 10' apart at the barrier location and driven securely into the ground a minimum of 12". When extra strength fabric is used without the wire support fence, post spacing shall not exceed 6'.
- 4) A trench shall be excavated approximately 4" wide and 4" deep along the line of posts and upslope from the barrier.
- 5) When standard strength filter fabric is used, a wire mesh support fence shall be fastened securely to the upslope side of the posts using heavy duty wire staples at least 1" long, tie wires, or hog rings. The wire shall extend into the trench a minimum of
- 2" and shall not extend more than 36" above the original ground surface.
 6) The standard strength filter fabric shall be stapled or wired to the fence, and 8" of the fabric shall be extended into the trench. The fabric shall not extend more than 36" above the original ground surface.
 7) The trench shall be backfilled and the soil compacted over the

SILT FENCE DETAIL

N.T.S.



ATTACHING TWO SILT FENCES

N.T.S.




Notes:

1) Contractor is responsible for installing and maintaining erosion control measures during construction.

— SILT FENCE (SEE DETAIL)

2) Contractor to investigate condition of existing sewer service prior to building permit submittal. If existing service is cast iron, or in poor condition, service will be replaced to main per Town of Palm Beach standards.

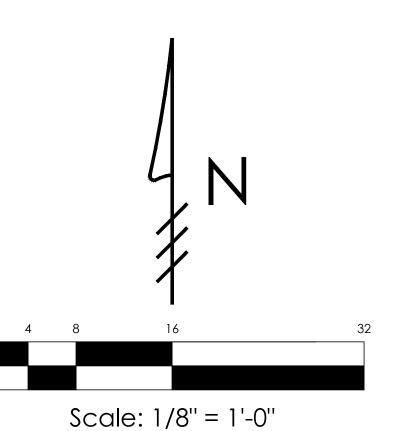

Mockingbird Tr. Nightingale Tr. La Puerta Way El Pueblo Way Monterey Rd Orange Grove Rd. Location Map

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 □ office@gruberengineers.com
 □ 48 HOURS BEFORE DIGGING

CALL 1-800-432-4770 SUNSHINE STATE ONE CALL OF FLORIDA, INC.

Contractor is responsible for obtaining location of existing utilities prior to commencement of construction activities.

RESIDENC

Δ_

PROJECT INFORMATION:

Project No. | 2024-0022 Issue Date 10/18/2024 Scale 1/8" = 1'-0"

REVISIONS:

Ω

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Plan by SMI Landscape Architecture

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The Hunt Residence


260 Colonial Lane Palm Beach, Florida

SHEET INDEX

Cover	
Site Plan	L1.1
Site Comparison Plan	L1.1a
Materials Sheet	M-1
Planting Plan	L2.1
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Neighboring Properties	NP-1
Trucking Logistics	TLP-1
Screening Plan	S-1

SMI

LANDSCAPE ARCHITECTURE
140 Royal Palm Way, Suite #206, Palm Beach, Florida 33480
Telephone: 561-655-9006
eMail: smila@bellsouth.net
FL registration #223

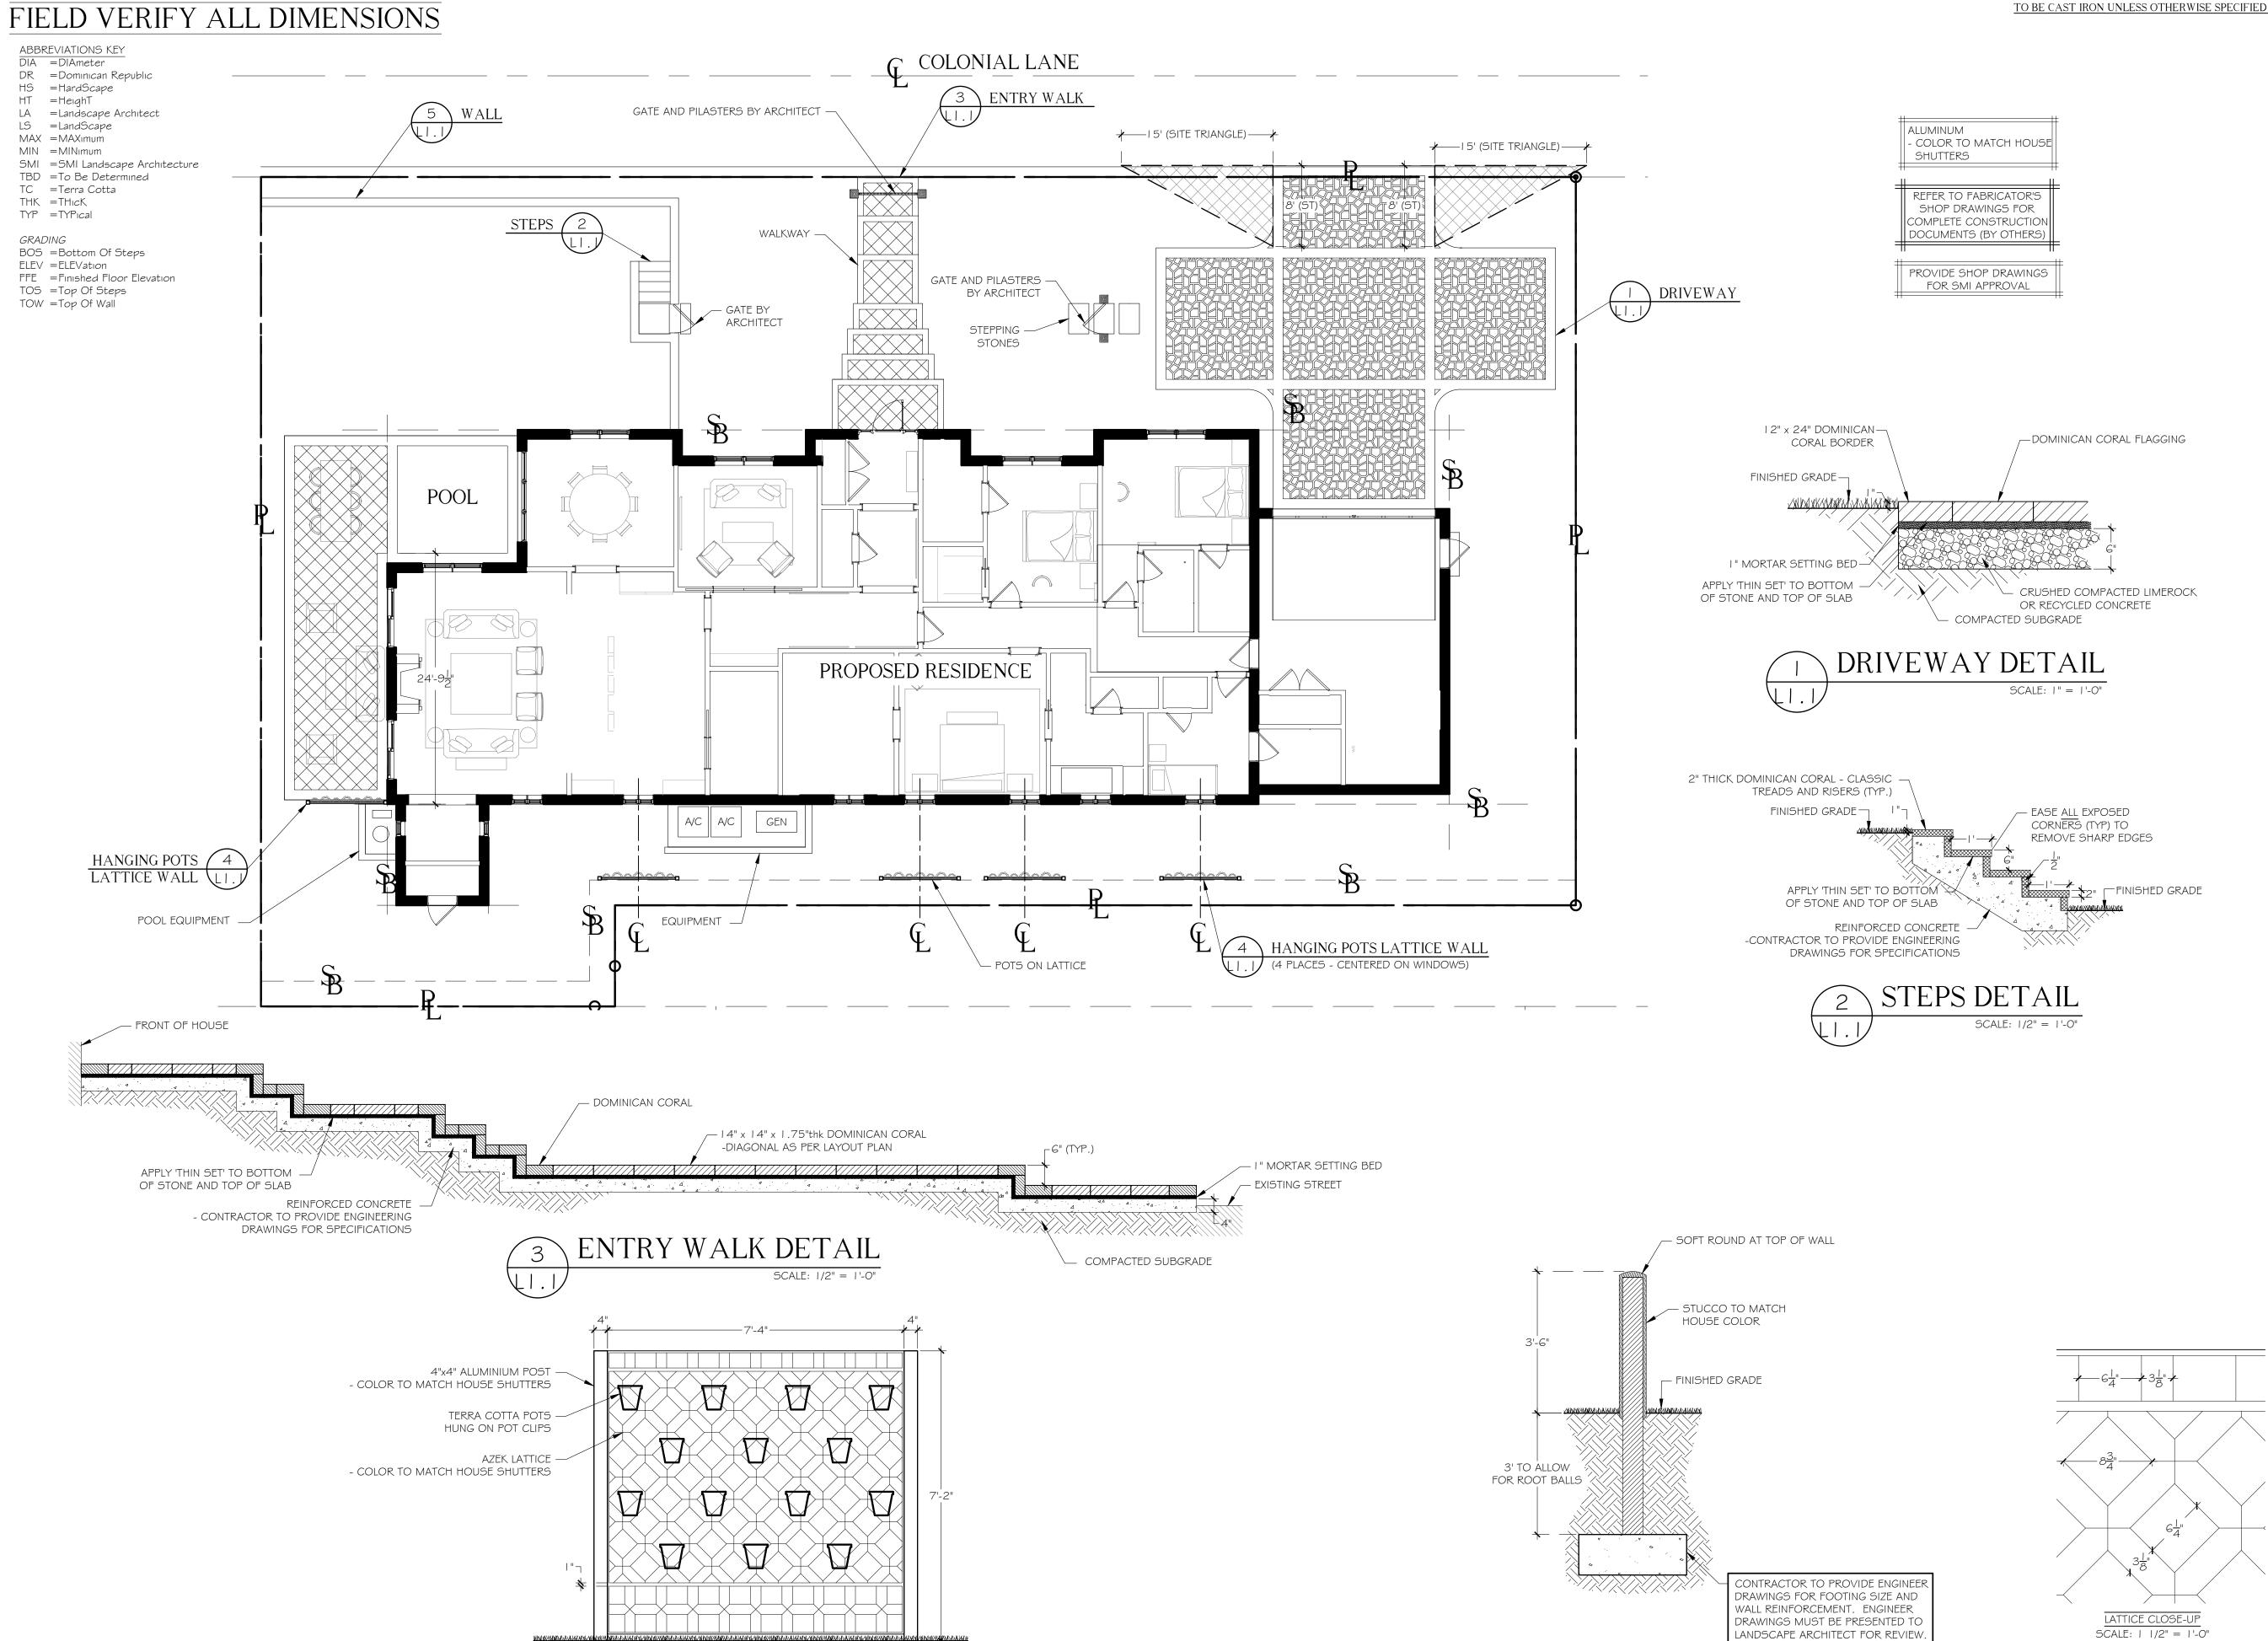

HANGING POTS LATTICE

WALL DETAIL

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260 Colonial Lane Palm Beach, Florida

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FOOTINGS FOR ALL STRUCTURES TO BE AT LEAST 3' BELOW GRADE TO ALLOW FOR PLANTINGS / ROOT BALLS

-DRIP IRRIGATION MAY ONLY BE USED IF SPECIFIED BY SMI OR IF REQUIRED BY MUNICIPALITY

- 3 10.21.2024 SECOND SUBMITTAL
- 2 10.03.2024 FIRST SUBMITTAL 1 09.16.2024 PRE-APPLICATION

DATE DESCRIPTION REVISIONS

SECOND SUBMITTAL

LANDSCAPE ARCHITECTURE 140 Royal Palm Way, Suite #206, Palm Beach, Florida 33480 Telephone: 561-655-9006 Fax: 561-655-9007 eMail: Office@smila.net www.smila.net FL registration #LA 13000223

TITLE Site Plan SCALE PROJECT NUMBER: 1/8" = 1'-0" 2402 DATE: CHECKED: PRJCT MNGR: 10.21.2024 CFV DRAWING NO.

SHEET 1 OF 2





LANDSCAPE ARCHITECT FOR REVIEW

SCALE: 1/2" = 1'-0"

TYPICAL WALL DETAIL

SMI TO APPROVE LAYOUT OF ALL HARDSCAPE MATERIAL PRIOR TO INSTALLATION

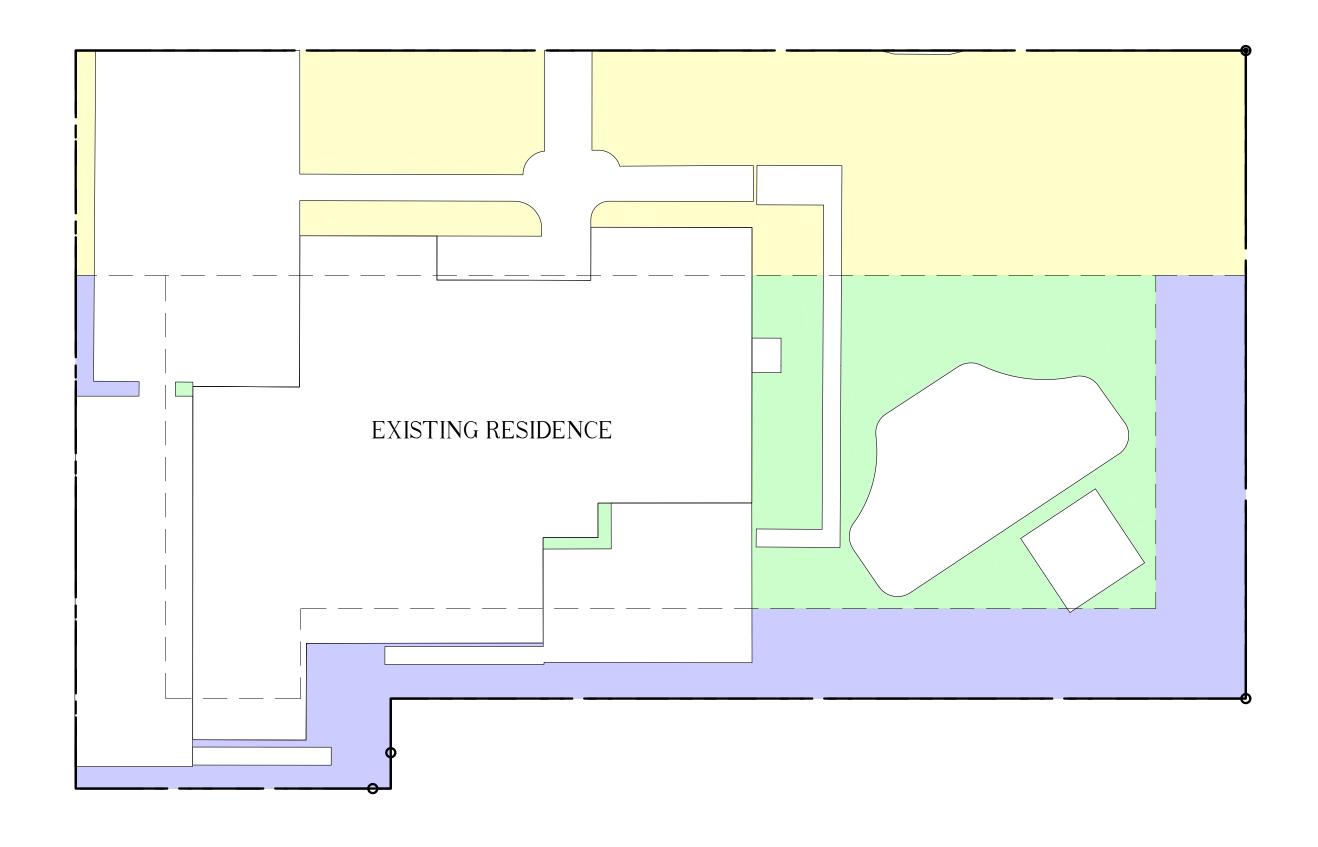

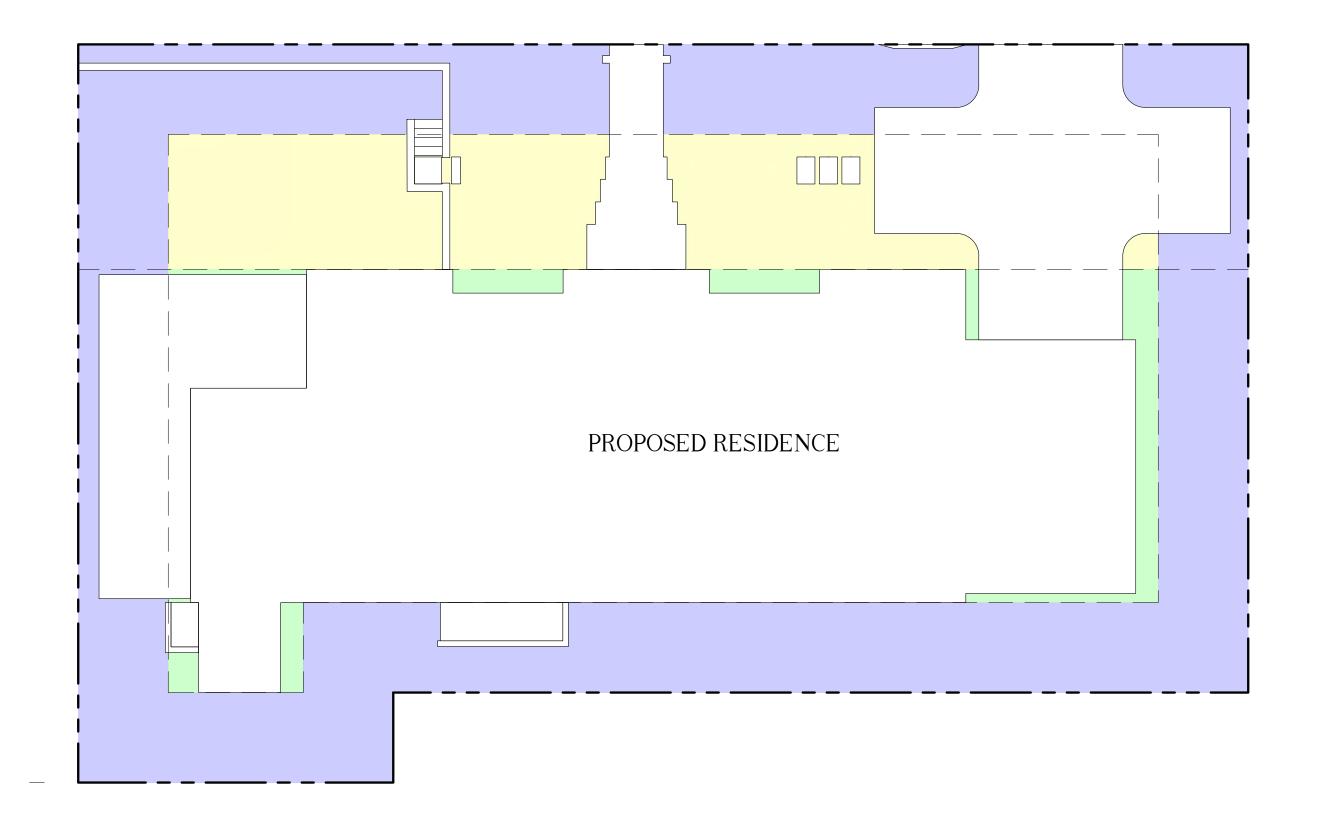

EXISTING SITE PLAN


PROPOSED SITE PLAN

Existing Color Key

Existing Site Pervious Existing Front Yard Pervious Existing Perimeter Pervious


Pervious / Impervious Calculations: RB							
Lot Size	Dwelling 1 Floor	Required Pervious Square Footage Percentage		Existing Pervious		Proposed Pervious	
9,711 sf	3,576 sf			Square Footage	Percentage	Square Footage	Percentage
	Overall Hardscape (Impervious) 1,735 sf		45%min (or Existing)	4,471	46%	4,400	45%
Front Yard Calculations 25' Setback Area Hardscape (Impervious) 3,250 sf 1,031 sf		1,300	40%min (or Existing)	2,111	65%	2,219	68%
Perimeter Hardscape 10' Offset from PL / Area Hardscape (Impervious) 3,840 sf 781 sf		2,185	50% of required open space shall be within 10' of property line	1,337	31%	3,059	70%

Proposed Color Key

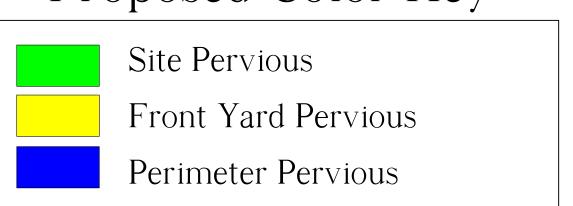

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ROOT BALLS -DRIP IRRIGATION MAY ONLY BE USED IF SPECIFIED BY SMI OR IF REQUIRED BY MUNICIPALITY

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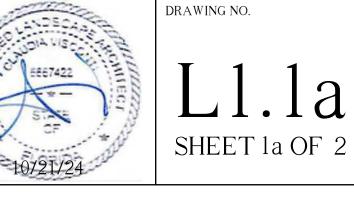
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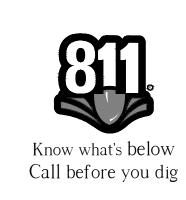
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Site Comparison Plan SCALE PROJECT NUMBER:

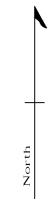3/32" = 1'-0" 2402 PRJCT MNGR: CHECKED: CFV CFV 10.21.2024







FIELD VERIFY ALL DIMENSIONS







ENTRY WALK

DOMINICAN CORAL



STEPS

DOMINICAN CORAL



TERRACE \$ POOL COPING

DOMINICAN CORAL



AZEK
COLOR: REFER TO ARCHITECT'S SHUTTER COLOR

ABBREVIATIONS KEY

DIA = DIAmeter

DR = Dominican Republic

HS = HardScape

HT = HeighT

LA = Landscape Architect

LS = LandScape

MAX = MAXimum

MIN = MINimum

SMI = SMI Landscape Architecture

TBD = To Be Determined

TBD =To Be Determing
TC =Terra Cotta
THK =THICK
TYP =TYPICAL

GRADING
BOS =Bottom Of Steps
ELEV =ELEVation
FFE =Finished Floor Elevation
TOS =Top Of Steps
TOW =Top Of Wall

LANDSCAPE ARCHITECT TO APPROVE
LAYOUT OF ALL HARDSCAPE MATERIAL
PRIOR TO INSTALLATION



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North

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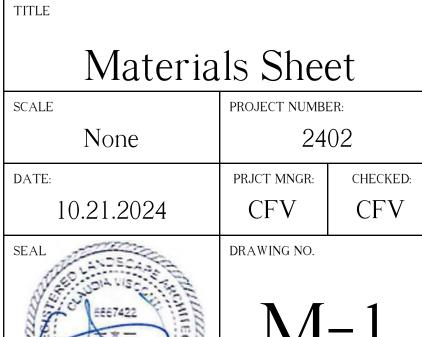
LANDSCAPE ARCHITECTURE

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Telephone: 561-655-9006 Fax: 561-655-9007


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SHEET 1 OF 3





SMI =SMI Landscape Architecture

SMI TO APPROVE STAKED LAYOUT OF ALL TREES AND PLANTING LAYOUT PRIOR TO INSTALLATION

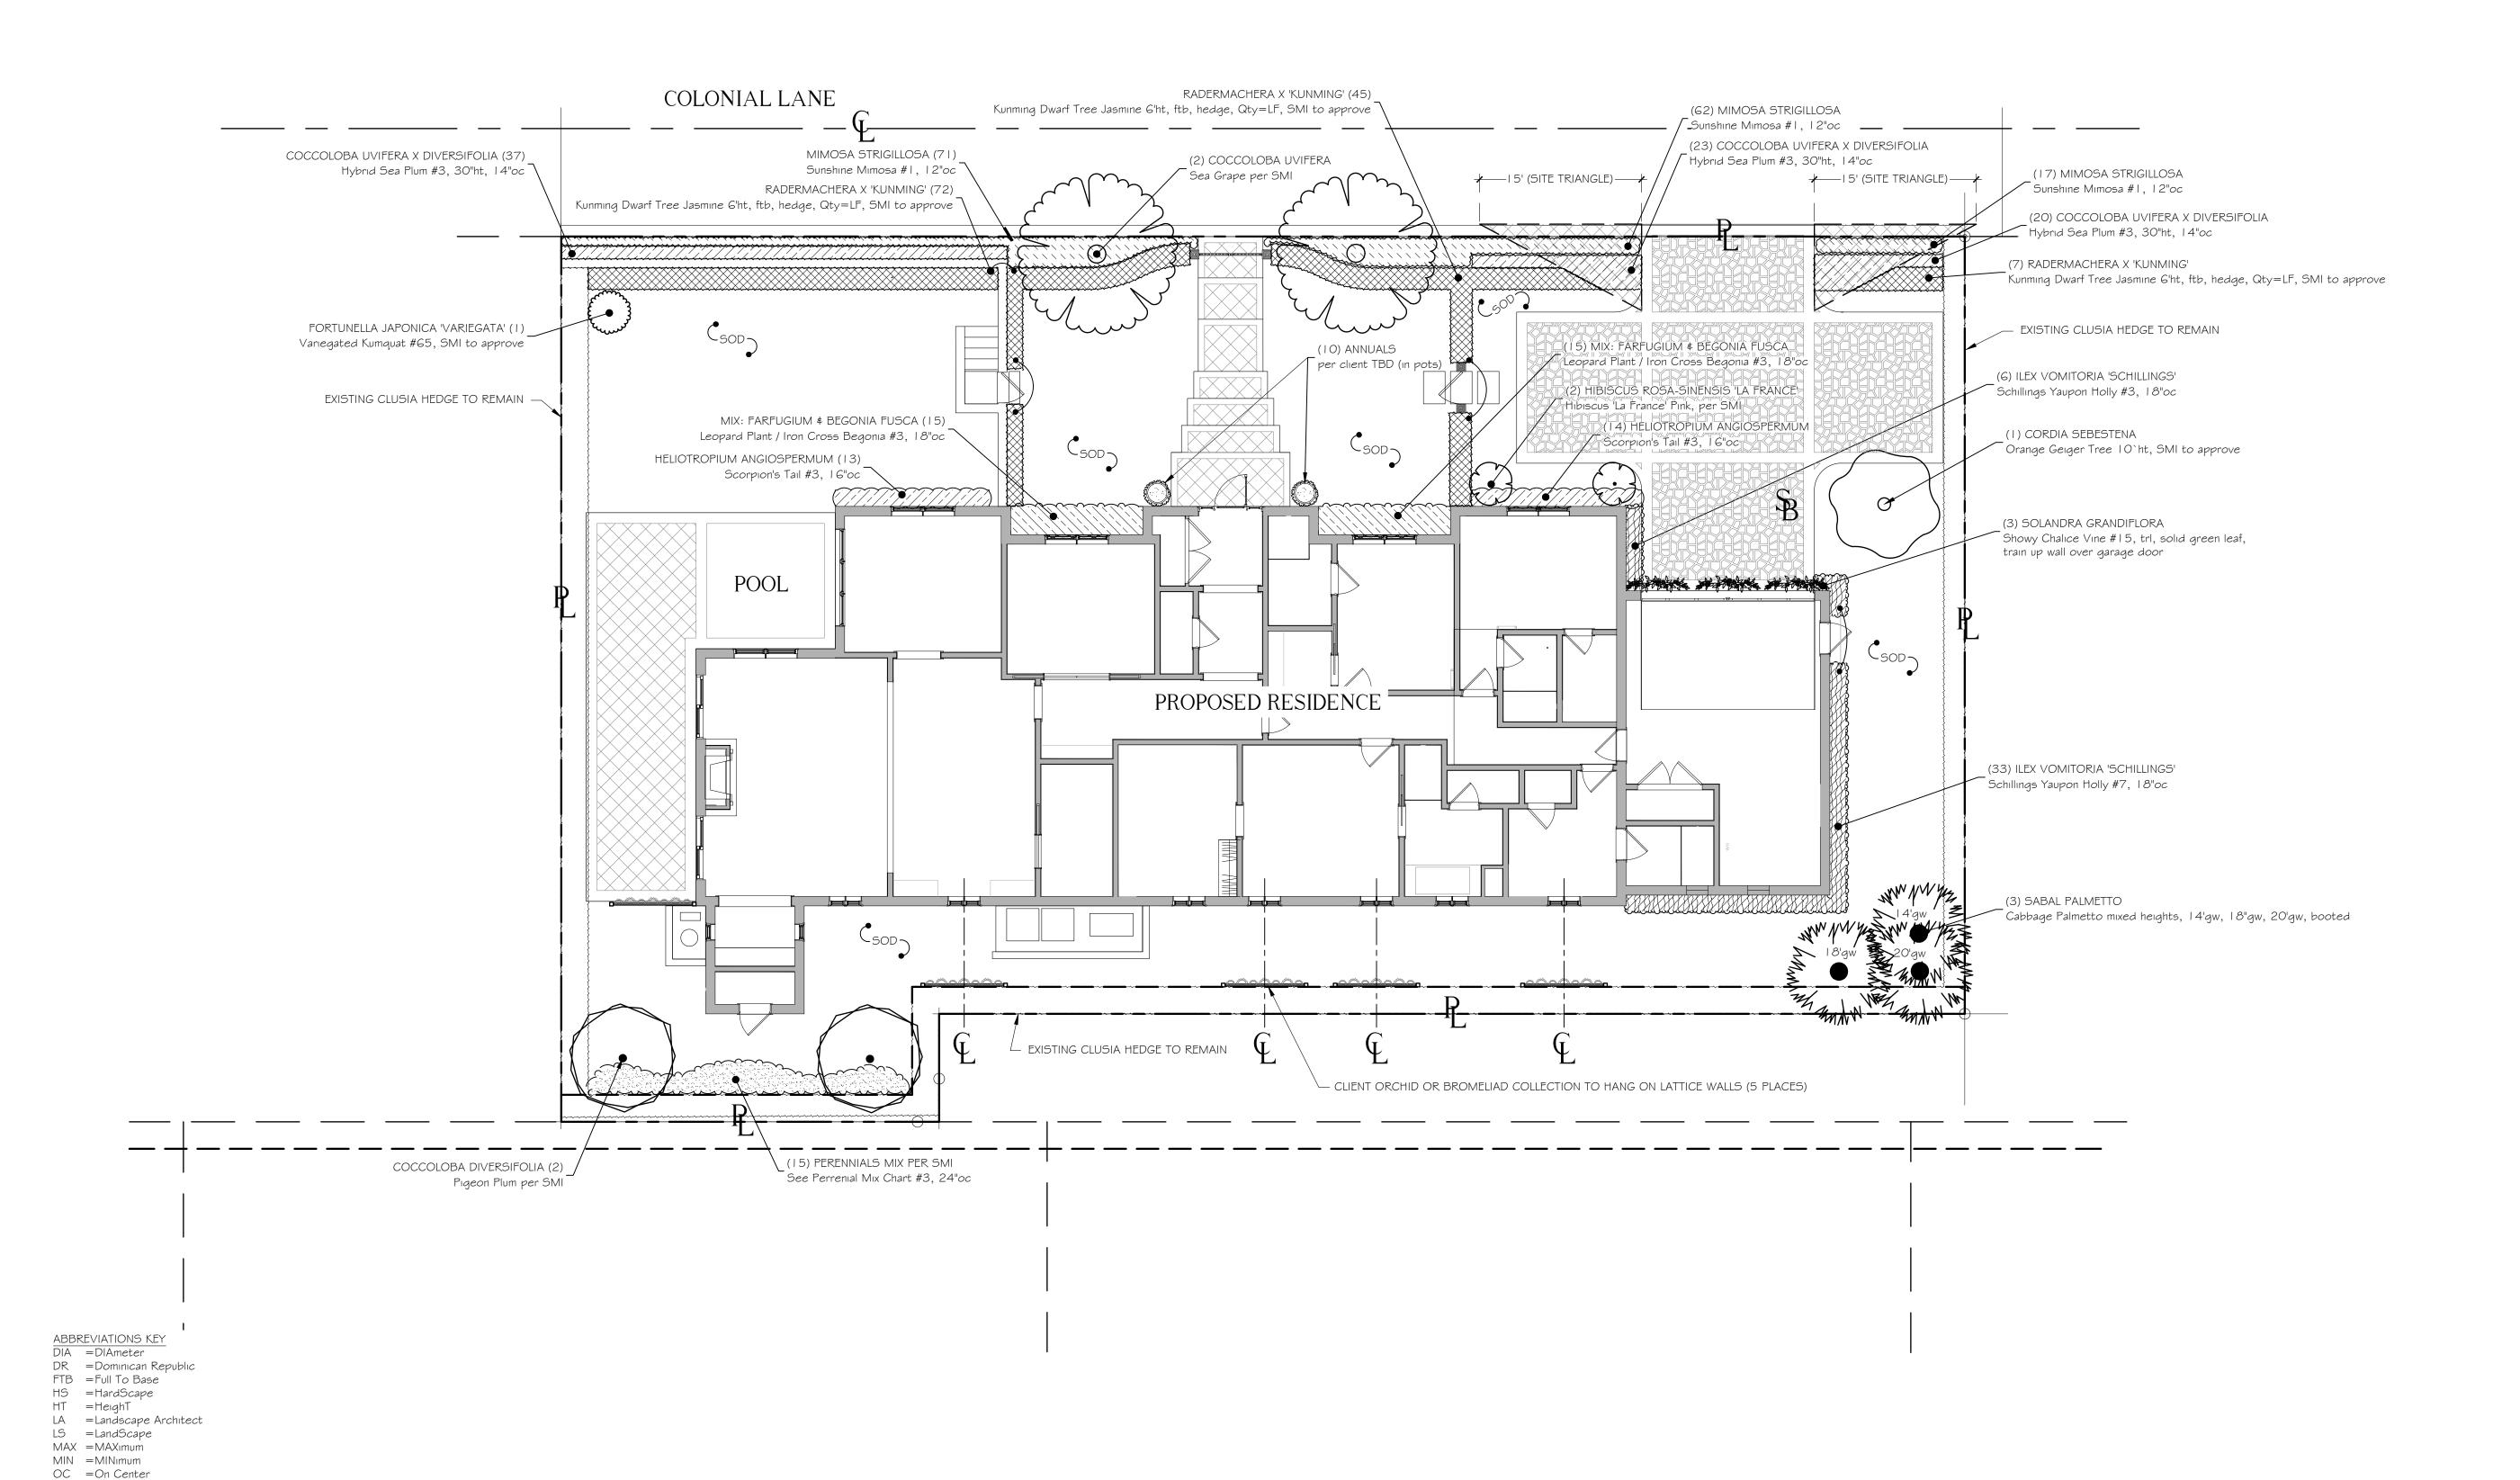ALL IRRIGATION, IRRIGATION EQUIPMENT AND

IRRIGATION BOXES TO BE CONCEALED

ALL PLANTING BEDS ABUTTING LAWN

TO HAVE METAL EDGE BORDER

SPP =SPecimen

STD =STandarD

TC =Terra Cotta THK =THICK

TRL =TReLlised

ELEV = ELEVation

TOS =Top Of Steps

TOW =Top Of Wall

TYP =TYPical

GRADING

TBD =To Be Determined

BOS =Bottom Of Steps

FFE =Finished Floor Elevation

Know what's below

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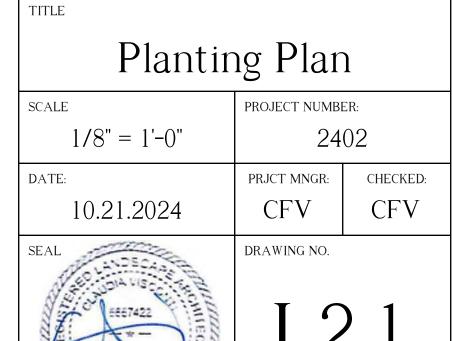
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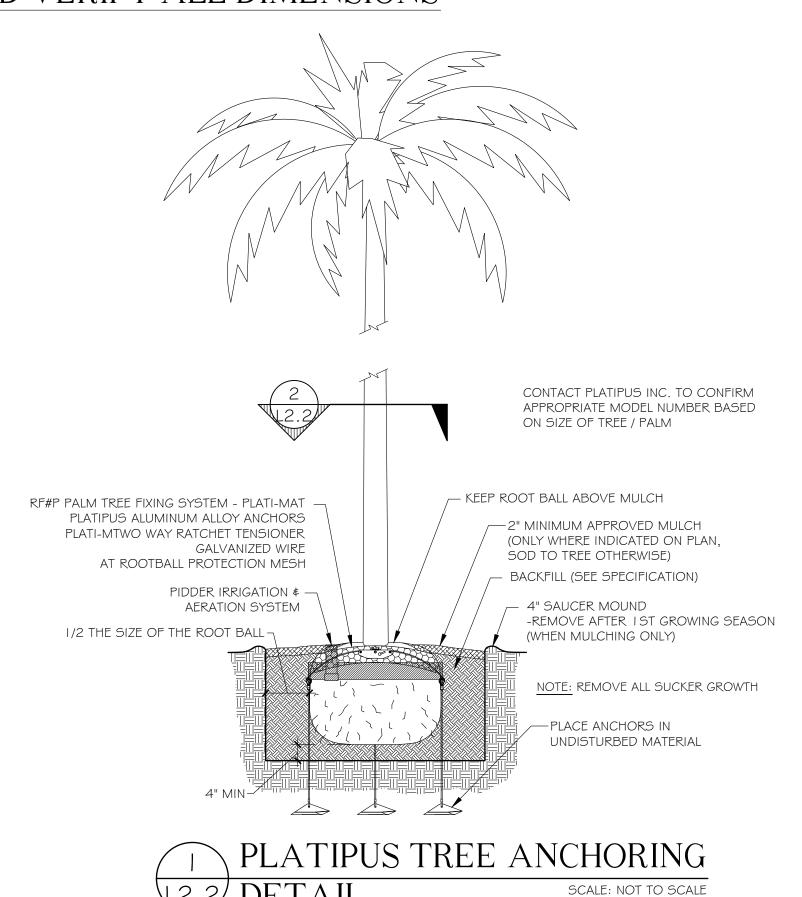
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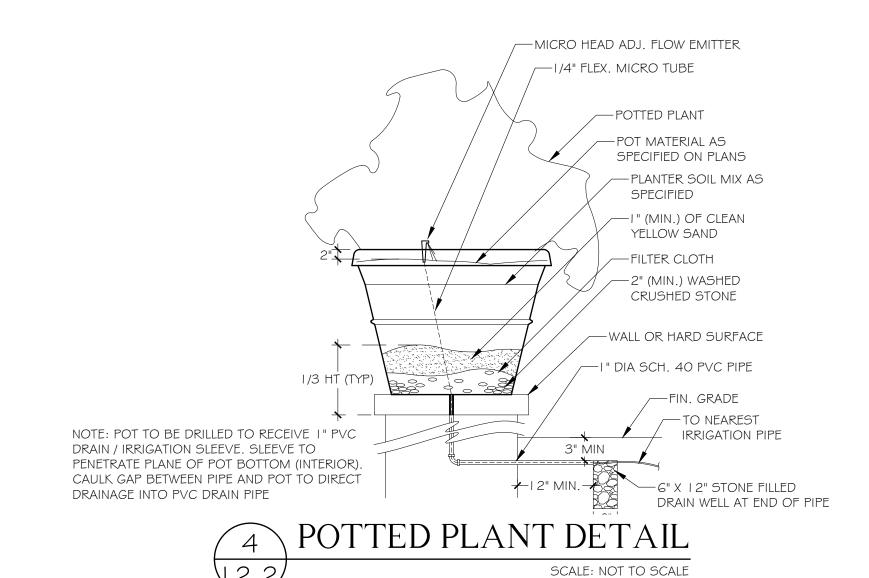





SHEET 1 OF 3

FIELD VERIFY ALL DIMENSIONS






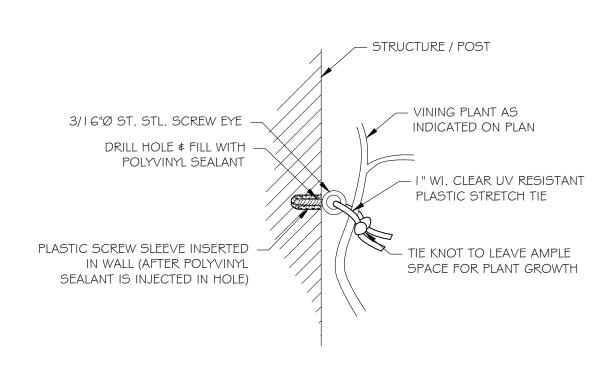


PIN TO WALL




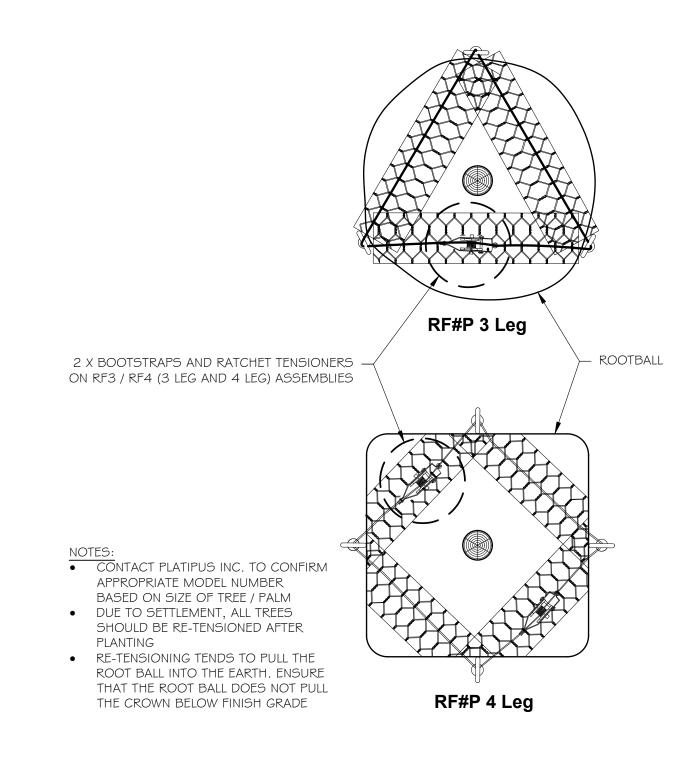


PLATIPUS ROOTBALL BOOTSTRAP

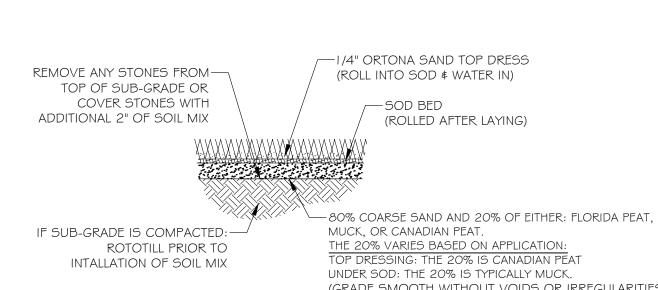




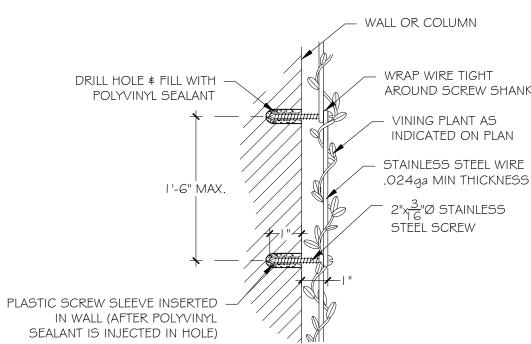

WIRE TO WALL

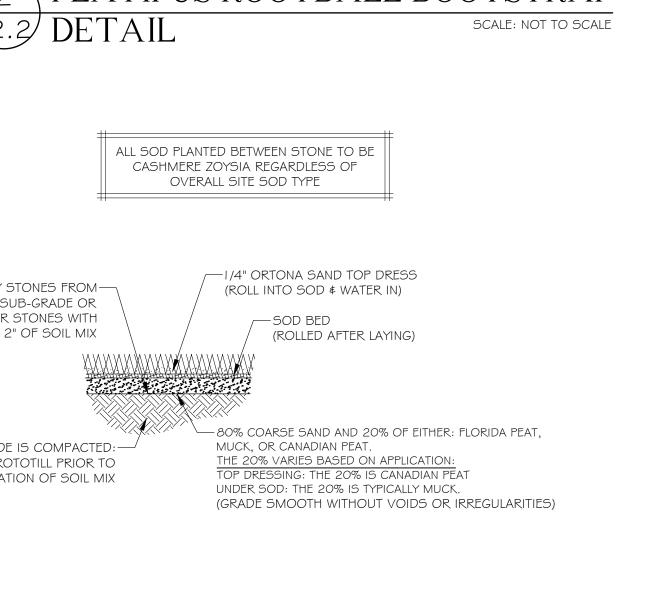

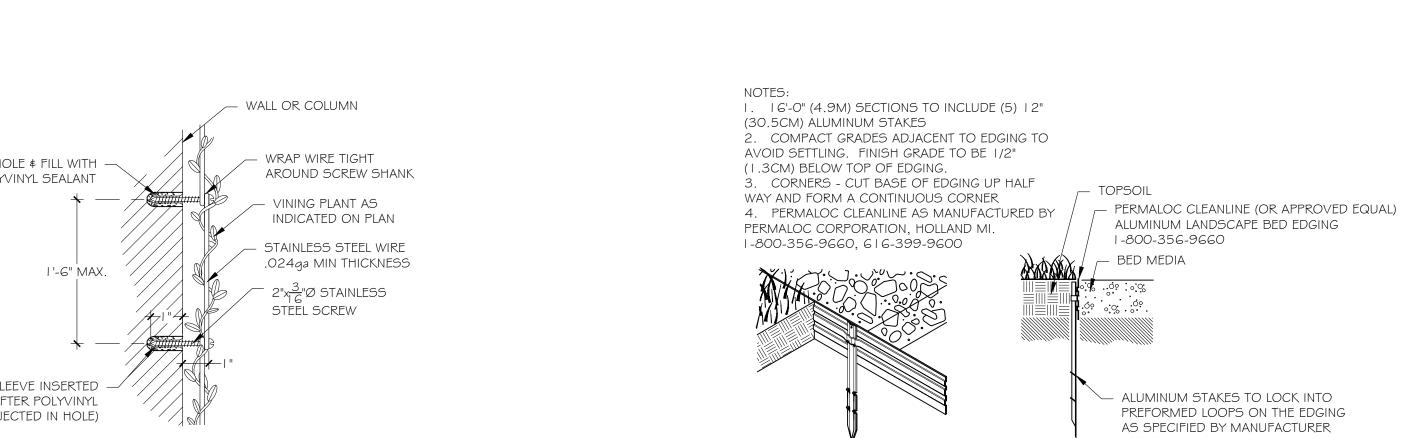


PLANT BED EDGING DETAIL

ANY/ALL TRACK DRAINS, TRENCH DRAINS AND DRAIN GRATES TO BE CAST IRON UNLESS OTHERWISE SPECIFIED BY SMI


> SMI TO APPROVE STAKED LAYOUT OF ALL TREES AND PLANTING LAYOUT PRIOR TO INSTALLATION

ALL IRRIGATION, IRRIGATION EQUIPMENT AND IRRIGATION BOXES TO BE CONCEALED

ALL PLANTING BEDS TO HAVE STEEL EDGE BORDER

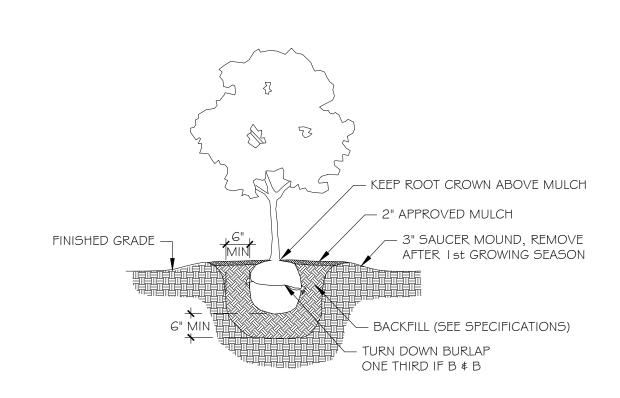



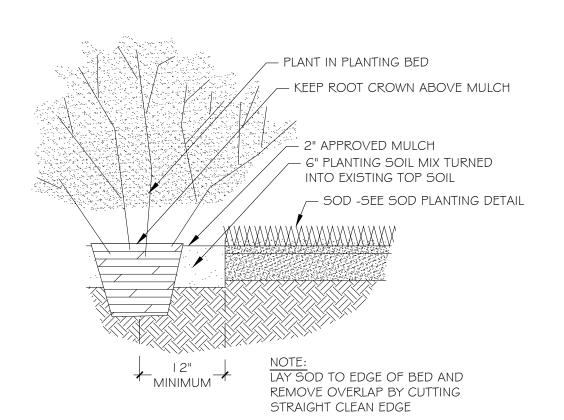



SCALE: NTS

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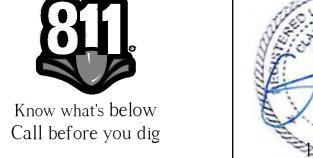
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SHEET 2 OF 3



GENERAL CONDITIONS

SCOPE:

I. THE MORK INCLUDED IN THESE SPECIFICATIONS SHALL CONSIST OF THE FURNISHING OF ALL LABOR, TOOLS, MATERIALS, PERMITS, ETC., NECESSARY FOR THE EXECUTION OF THE WORK AS HEREIN SPECIFIED AND SHOWN ON THE

2. THE LANDSCAPE CONTRACTOR SHALL INSTALL ALL MATERIAL IN ACCORDANCE WITH SOUND NURSERY PRACTICE AND SHALL PERFORM MAINTENANCE AND WATERING UNTIL FINAL COMPLETION AND ACCEPTANCE BY THE LANDSCAPE ARCHITECT.

EXAMINATION OF DRAWINGS AND SITE:

I. THE LANDSCAPE CONTRACTOR SHALL EXAMINE THE SITE AND FULLY ACQUAINT HIMSELF WITH ALL OF THE EXISTING CONDITIONS IN ORDER THAT NO MISUNDERSTANDING MAY AFTERWARDS ARISE AS TO THE CHARACTER OR AS TO THE EXTENT OF THE WORK TO BE DONE, AND LIKEWISE, IN ORDER TO ADVISE AND ACQUAINT HIMSELF WITH ALL PRECAUTIONS TO BE TAKEN IN ORDER TO AVOID INJURY TO PERSONS OR PROPERTY OF ANOTHER. NO ADDITIONAL COMPENSATION WILL BE GRANTED BECAUSE OF ANY UNUSUAL DIFFICULTIES THAT MAY BE ENCOUNTERED IN THE EXECUTION OR MAINTENANCE OF ANY PORTION OF THE WORK. ANY DISCREPANCIES, OR OMISSIONS OR DOUBTS AS TO MEANING SHALL BE COMMUNICATED TO THE LANDSCAPE ARCHITECT, WHO WILL MAKE ANY INTERPRETATIONS HE/SHE DEEMS NECESSARY

PLANT LIST:

I. ANY DISCREPANCY BETWEEN THE PLANT LIST AND THE DRAWINGS SHALL BE CONSIDERED AS CORRECT ON THE DRAWINGS.

PROTECTION OF PUBLIC AND PROPERTY:

I. THE LANDSCAPE CONTRACTOR SHALL PROTECT ALL MATERIALS AND WORK AGAINST INJURY FROM ANY CAUSE AND SHALL PROVIDE AND MAINTAIN ALL NECESSARY GUARDS FOR THE PROTECTION OF THE PUBLIC. HE SHALL BE HELD RESPONSIBLE FOR ANY DAMAGE OR INJURY TO A PERSON OR PROPERTY WHICH MAY OCCUR AS A RESULT OF HIS FAULT OR NEGLIGENCE IN THE EXECUTION OF THE WORK.

2. THE LANDSCAPE CONTRACTOR SHALL MAINTAIN WORKMAN'S COMPENSATION, COMPREHENSIVE GENERAL LIABILITY INSURANCE (\$1,000,000) AND PROPERTY DAMAGE INSURANCE (\$1,000,000.00). A COPY OF THE CERTIFICATE OF INSURANCE MUST BE FURNISHED TO OWNER.

GUARANTEE:

I. THE GUARANTEE PERIOD FOR ALL MATERIAL SHALL BEGIN AFTER FINAL APPROVAL BY LANDSCAPE ARCHITECT

2. ALL MATERIAL EXCEPT SOD SHALL BE GUARANTEED FOR ONE YEAR PROVIDED IT RECEIVES PROPER MAINTENANCE (AS PRESCRIBED BY THE LANDSCAPE CONTRACTOR) BY THE OWNER AND IS NOT DAMAGED OR DESTROYED BY HURRICANES OR OTHER CAUSES BEYOND THE CONTRACTOR'S

3. IT IS THE RESPONSIBILITY OF THE LANDSCAPE CONTRACTOR TO BRING TO THE ATTENTION OF THE LANDSCAPE ARCHITECT THE OWNERS NEGLECT TO PROVIDE PROPER CARE OF THE MATERIAL.

4. ALL REPLACEMENT COST OF GUARANTEED MATERIAL, INCLUDING EQUIPMENT, AND LABOR, SHALL BE THE RESPONSIBILITY OF THE CONTRACTOR

AWARD OF CONTRACT:

I. ONLY UNIT PRICE-INSTALLED BIDS FOR THE WORK WILL BE ACCEPTABLE. HOWEVER, THE OWNER RETAINS THE RIGHT TO DELETE PORTIONS OF THE WORK FROM THE CONTRACT AND/OR AWARD SEPARATE CONTRACTS FOR PHASES OF THE PROJECT. THE LANDSCAPE ARCHITECT RESERVES THE RIGHT TO REJECT ANY AND ALL BIDS WHEN SUCH REJECTIONS ARE IN THE INTEREST OF THE

EXECUTION OF THE WORK:

I. THE LANDSCAPE CONTRACTOR SHALL HAVE HIS LABOR CREMS CONTROLLED AND DIRECTED BY A LANDSCAPE FOREMAN WELL VERSED IN PLANT MATERIALS, PLANTING, READING OF BLUEPRINTS AND COORDINATION BETWEEN JOB AND NURSERY IN ORDER TO EXECUTE INSTALLATION RAPIDLY AND CORRECTLY.

MATER:

I. WATER SOURCE SHALL BE FURNISHED BY THE OWNER

2. IT IS THE RESPONSIBILITY OF THE LANDSCAPE CONTRACTOR TO COORDINATE HIS WORK WITH IRRIGATION CONTRACTOR.

3. ALL PLANT MATERIAL INSTALLED PRIOR TO THE INSTALLATION OF THE IRRIGATION SYSTEM SHALL BE WATERED WITH A TEMPORARY SYSTEM BY THE LANDSCAPE CONTRACTOR.

IRRIGATION:

-DRIP IRRIGATION MAY ONLY BE USED IF SPECIFIED BY SMI OR IF REQUIRED BY MUNICIPALITY

GRADING:

I. THE GENERAL CONTRACTOR SHALL BE RESPONSIBLE FOR ALL SUBGRADE OF LANDSCAPE AREAS UNLESS OTHERWISE SPECIFIED. THE TERM SUBGRADE SHALL BE DEFINED AS 4"-6" BELOW FINISH GRADE UNLESS OTHERWISE NOTED ON PLANS.

2. THE LANDSCAPE CONTRACTOR SHALL BE RESPONSIBLE FOR ALL FINISHED AND FINE GRADING WITHIN PLANTER BEDS AND THE FILLING OF PLANTER BOXES. THE LANDSCAPE CONTRACTOR SHALL REMOVE ALL EXCESS SOIL AND DEBRIS ACCUMULATED DURING HIS WORK.

3. THE SOD CONTRACTOR SHALL BE RESPONSIBLE FOR FINISH GRADE IN ALL SODDED AREAS, SEE SPECIFICATIONS RELATING TO SPECIES GROWERS.

> TO PROTECT AGAINST GANODERMA PALM FUNGUS ALWAYS REMOVE ALL PALM STUMPS FROM PROPERTY - STUMPS ACT AS HOSTS TO THIS DESTRUCTIVE LONG LIVED FUNGUS.

DIGGING

I. THE LANDSCAPE CONTRACTOR SHALL EXERCISE CARE IN DIGGING AND OTHER WORK SO AS NOT TO DAMAGE EXISTING WORK, INCLUDING UNDERGROUND AND OVERHEAD PIPES AND CABLES. SHOULD SUCH UNDERGROUND AND OVERHEAD OBSTRUCTIONS BE ENCOUNTERED WHICH INTERFERE WITH PLANTING, THE LANDSCAPE ARCHITECT OR THE OWNER'S AUTHORIZED REPRESENTATIVE SHALL BE CONSULTED AND WILL ADJUST THE LOCATION OF PLANTS TO CLEAR SUCH OBSTRUCTION OR MOVE THE OBSTRUCTION.

2. THE LANDSCAPE CONTRACTOR SHALL BE RESPONSIBLE FOR THE IMMEDIATE REPAIR OF ANY DAMAGE CAUSED BY HIS WORK. PLANTING PITS

I. EXCAVATE CIRCULAR PITS WITH VERTICAL SIDES FOR ALL PLANTS, EXCEPT FOR HEDGES AND PLANTS SPECIFICALLY DESIGNATED TO BE PLANTED IN BEDS. DIAMETER OF PITS OF TREES AND SHRUBS SHALL BE AT LEAST I/3 LARGER THAN THE DIAMETER OF THE BALL

2. EXCAVATE PLANTING PITS AND PLANTING BEDS, PREPARE FINE SUBGRADE THROUGHOUT ALL PITS AND BEDS, AND PLACE THE PLANTS TO BE PLANTED FOR APPROVAL BY LANDSCAPE ARCHITECT BEFORE INSTALLATION.

PRUNING

REMOVE DEAD AND BROKEN BRANCHES FROM ALL PLANT MATERIAL IMMEDIATELY. PRUNE TO RETAIN TYPICAL GROWTH HABIT OF INDIVIDUAL PLANTS WITH AS MUCH HEIGHT AND SPREAD AS IS PRACTICAL.

2. HEDGE MATERIALS TO BE PULLED IN, TIED AND TRIMMED TO VERTICAL AFTER INSTALLATION, WITH A FINISHED APPEARANCE UNLESS OTHERWISE NOTED.

TREE BRACING AND GUYING

REMEMBER TO CONSIDER SOIL CONDITIONS WHEN PLANTING TREES IN MADE UP GROUND AND THE NEED TO PLACE THE ANCHORS IN A UNDISTURBED MATERIAL. IF SO, YOU CAN ORDER 'ED' KITS (EXTRA DEPTH). TO ALLOW FOR THIS YOU MAY ALSO NEED A LONGER DRIVE ROD.

2. THE ANCHOR SHOULD BE DRIVEN TO THE FULL WORKING DEPTH USING A SUITABLE DRIVE ROD.

3. YOU MUST LOADLOCK THE ANCHORS PROPERLY INTO THEIR WORKING POSITION, BY APPLYING AN UPWARDS FORCE / LOAD ON THE WIRE TENDON.

4. IF THE ANCHORS ARE NOT LOADLOCKED PROPERLY, THE TREE WILL BECOME LOOSE WHEN THE FIRST WINDS ARRIVE.

5. PALM TREE ROOTBALLS MUST BE A MINIMUM OF 5'DIAMETER, PROPERLY ROOT WRAPPED AND OF SUFFICIENT STRENGTH AND PROPORTION TO SUPPORT A ROOTBALL FI XING METHOD. THE CORRECT PALM TREE KIT REQUIRED MUST BE SPECIFIED BY THE LANDSCAPE ARCHITECT ONCE THE ROOTBALL DIMENSIONS, TREE HEIGHT AND SAIL AREA OF THE TREE HAVE BEEN ESTABLISHED.

6.THE D-MAN CELLS / DEADMEN SHOULD BE INSTALLED AT LEAST 12" BELOW THE BASE OF THE ROOTBALL WITH THE SOIL COMPACTED ABOVE THE CELLS TO 60%, RIGHT UP TO THE NURSERY LINE.

7.IT IS NOT ADVISABLE TO USE STRAP SYSTEMS FOR CONTAINER GROWN STOCK (SEE PLATI-MAT SYSTEMS).

8. DUE TO SETTLEMENT OF THE TREE # AFTER WATERING RE-TENSIONING IS HIGHLY RECOMMENDED.

9. REFER TO MANUFACTURERS SPECIFICATIONS FOR COMPLETE INSTALLATION INSTRUCTIONS AT WWW.PLATIPUS.US.

IO. SMALL TREES SHALL BE GUYED IN THREE DIRECTIONS WITH THREE STRANDS OF NO. 12 GALVANIZED WIRE ATTACHED TO ANCHORS DRIVEN BELOW GRADE. WIRES WHICH COME IN CONTACT WITH THE TREE ARE TO BE ENCASED IN RUBBER

PLANT MATERIALS

I. NOMENCLATURE: PLANT NAMES SHALL CONFORM TO THE NAMES GIVEN IN HORTUS III AND IN STANDARDIZED PLANT NAMES, 2001, LATEST EDITION. PREPARED BY THE AMERICAN JOINT COMMITTEE ON HORTICULTURAL NOMENCLATURE. NAMES OF VARIETIES NOT INCLUDED THEREIN, CONFORM GENERALLY WITH NAMES ACCEPTED IN THE NURSERY TRADE.

2. QUALITY: PLANTS SHALL HAVE A HABIT OF GROWTH THAT IS NORMAL FOR THE SPECIES AND SHALL BE SOUND, HEALTHY, VIGOROUS AND FREE FROM INSECT PESTS, PLANT DISEASES AND INJURIES. TREES SHALL BE HEAVILY BRANCHED, OR IN PALMS, HEAVILY LEAFED. REQUIREMENTS FOR THE MEASUREMENT, BRANCHING GRADING, QUALITY, BALLING AND BURLAPPING OF PLANTS IN THE PLANT LISTS GENERALLY FOLLOW THE CODE OF STANDARDS CURRENTLY RECOMMENDED BY THE AMERICAN ASSOCIATION OF NURSERYMEN, INC., AND THE AMERICAN STANDARD FOR NURSERY STOCK. PLANT MATERIAL

GRADES SHALL CONFORM TO GRADES AND STANDARDS FOR NURSERY STOCK, STATE PLANT BOARD OF FLORIDA. PALMS WITH MARRED OR BURNED TRUNKS WILL NOT BE ACCEPTED. PLANTS WITH BROKEN, DAMAGED, OR INSUFFICIENT BALLS WILL BE REJECTED. ALL PLANTS SHALL BE FLORIDA FANCY.

3. SUBSTITUTIONS WILL BE PERMITTED ONLY UPON WRITTEN APPROVAL BY THE LANDSCAPE ARCHITECT.

PLANTING SOIL

SOIL BY 'ATLAS SOIL' OR APPROVED ALTERNATE

SHALL BE GRADED AS SPECIFIED ON THE DRAWINGS.

ALL PLANTING AREAS SHALL BE CLEANED OF ALL PLANT AND MATERIAL TWO MEEKS PRIOR TO INSTALLATION OF SOIL FOR REMOVAL OF ANY MEEDS.

GROUND COVER BEDS -REMOVE 6" OF EXISTING SOIL AND FILL WITH 4" OF 8270 MIX & TILL/MIX INTO EXISTING SOIL.

SHRUB BEDS -REMOVE 6" OF EXISTING SOIL AND FILL WITH A MIX OF 50% APPROVED SOIL \$ 50% EXISTING SOIL.

TREE PITS -REMOVE SOIL IN THE AMOUNT OF 1/2 LARGER THAN THE BALL OF THE TREE AND REPLACE WITH A MIX OF 50% APPROVED SOIL \$ 50% EXISTING SOIL.

PALMS -REMOVE SOIL IN THE AMOUNT OF 1/2 LARGER THAN THE BALL OF THE PALM AND REPLACE WITH APPROPRIATE SOIL AND CLEAN YELLOW SAND FREE

SOIL SPECS FOR PLANTING BEDS: ATLAS PEAT & SOIL 8270 MIX 20% can peat 25% fla peat

40% pine bark

<u>15% airlite</u>

SOIL SPECS FOR TREES AND LARGE SHRUBS: SMILA SOIL MIX (APPROVED SOIL) 50% Pinebark 40% Florida Peat 10% Coarse Sand

10lbs Dolomite per/Yard 18.5lbs TurfPro per/Yard 25 pounds Nutricote 18/6/8-360 P/yard <u>optional</u>.

I. SOLE SOURCE - FROM ATLAS PEAT & SOIL INC., P.O. BOX 3867, BOYNTON BEACH, FLORIDA, 33424-3867, (561) 734-7300

PLANTING SOIL NOT MEETING THESE REQUIREMENTS WILL NOT BE ACCEPTED.

I. SOIL FOR PLANTING TREES, SHRUBS AND GROUND COVER SHALL BE SMILA SOIL UNLESS OTHERWISE SPECIFIED ON THE DRAWINGS.

2. IT SHALL BE THE RESPONSIBILITY OF THE LANDSCAPE CONTRACTOR TO REMOVE ANY EXCESS SOIL AND DEBRIS FROM THE SITE. REFER TO THE GRADING PLAN AND GRADING SPECIFICATIONS.

3. LANDSCAPE ARCHITECT MAY REQUEST SOIL ANALYSIS FOR THE TESTING OF PLANTING SOIL UTILIZED BY THE SELECTED LANDSCAPE CONTRACTOR.

FERTILIZER

I. TREES USE ONE 21 GRAM AGRIFORM PLANTING TABLET PER 1/2" TRUNK DIAMETER. SPACE EQUALLY AROUND AT 2/3 DEPTH OF BALL

2. SHRUBS: AGRIFORM PLANTING TABLETS SHALL BE APPLIED PER THE MANUFACTURERS SUGGESTED APPLICATION RATES.

3. SOD USE FERTILIZER AS PER BELOW WITH TRACE ELEMENTS APPLIED AT THE RATE OF 15 LBS. PER 1000 SQ. FT. PRIOR TO LAYING SOD.

4. POWDERED MYCCHORIZAE MIX; DIE HARD, 'PLANT HEALTH' CARE OR EQUAL) AND LIQUID B-THRIVE (OR EQUAL) SHOULD BE ADDED TO ALL TREES, SHRUBS AND GROUND COVER PLANTING BEDS AS PER MANUFACTERES DIRECTIONS.

5. ALL TREES, SHRUBS, GROUND COVER AND SOD TO USE LESCO 13-3-13 FERTILIZER AS PER MANUFACTURERS SPECIFICATIONS

MULCH

ALL MULCH FOR THE PROJECT SHALL BE ATLAS GROW. MULCH SHALL BE APPLIED 2" IN TREES AND PALMS AS SPECIFIED, AND ALL PLANTING BEDS, HEDGE AND SHRUBS. KEEP CROWN OF ROOT BALL ABOVE

<u>BOYNTON BEACH, FLORIDA, 33424-3867, (561) 734-7300</u>

SOLE SOURCE - FROM ATLAS PEAT & SOIL INC., P.O. BOX 3867.

SUBMIT BAG TO LANDSCAPE ARCHITECT FOR APPROVALS.

SABAL PALMS

I. SABAL PALMS SHALL HAVE A MINIMUM TRUNK DIAMETER OF 12" MEASURED 2' ABOVE GROUND.

HEDGES

I. THE LANDSCAPE CONTRACTOR SHALL PROVIDE <u>FULL</u> MATERIAL TO PRODUCE A SOLID SCREEN FROM THE TOP OF HEDGE TO THE BASE OF HEDGE.

2. THE LANDSCAPE CONTRACTOR SHALL BE RESPONSIBLE TO ADD FILLERS TO THE HEDGE AS NEEDED TO PRODUCE A SOLID FULL TO BASE (F.T.B.), SCREEN TO BE INCLUDED IN THE CONTRACTED PRICE. 3. PLANT MATERIAL WITH WEAK OR THIN FOLIAGE WILL NOT BE ACCEPTED.

VINES

I. MATERIALS \$ INSTALLATION OF VINE SUPPORTS SHALL BE <u>INCLUDED</u> IN UNIT COST OF VINE SPECIFIED

SODDING

I. THE LANDSCAPE CONTRACTOR SHALL SOD ALL AREAS INDICATED AND NOTED ON THE DRAWINGS.

2. NO SODDING SHALL OCCUR UNTIL ALL AREAS TO BE SODDED ARE CLEARED OF ANY ROUGH GRASS, WEEDS, AND DEBRIS, THE GROUND BROUGHT TO AN EVEN GRADE AND SPECIFIED AMENDMENTS HAVE BEEN ADDED. SEE DETAILS FOR SPECIFIC AMENDMENTS AS PER SOD TYPE. ALL SODDED AREAS WILL BE TREATED WITH 'ROUNDUP' HERBICIDE PER MANUFACTURER'S SPECIFICATIONS AT LEAST TEN DAYS PRIOR TO SOD INSTALLATION.

3. THE SOD SHALL BE FIRM, TOUGH TEXTURE, HAVING A COMPACTED GROWTH OF GRASS WITH GOOD ROOT DEVELOPMENT. IT SHALL CONTAIN NO NOXIOUS WEEDS, OR ANY OTHER OBJECTIONABLE VEGETATION, FUNGUS, INSECTS OR DISEASE. PREPARATION OF AREAS SHALL BE PERFORMED WELL ENOUGH IN ADVANCE TO ALLOW SUFFICIENT TIME TO WORK PROPERLY. THE SOIL EMBEDDED IN THE SOD SHALL BE GOOD, CLEAN EARTH, FREE FROM STONES AND DEBRIS. THE SOD SHALL BE FREE FROM FUNGUS, VERMIN, AND OTHER DISEASES.

4. BEFORE BEING CUT AND LIFTED, THE SOD SHALL HAVE BEEN MOWED AT LEAST THREE TIMES WITH A LAWN MOMER, WITH THE FINAL MOWING NOT MORE THAN SEVEN DAYS BEFORE THE SOD IS CUT. THE SOD SHALL BE CAREFULLY CUT INTO UNIFORM DIMENSIONS.

5. SOLID SOD SHALL BE LAID WITH CLOSELY ABUTTING JOINTS WITH A TAMPED OR ROLLED EVEN SURFACE.

6. WATERING SHALL BE ACCOMPLISHED UNTIL ACCEPTANCE OF THE WORK BY THE LANDSCAPE ARCHITECT.

7. MAINTENANCE OF MATERIAL SHALL BE THE RESPONSIBILITY OF THE LANDSCAPE CONTRACTOR UNTIL FINAL APPROVAL OF LANDSCAPE ARCHITECT.

8. IT SHALL BE THE RESPONSIBILITY OF THE LANDSCAPE CONTRACTOR TO BRING THE SOD EDGE IN A NEAT, CLEAN MANNER TO THE EDGE OF ALL PAVING AND SHRUB AREAS. 9. SEE PLANS FOR DETAILS. RE: SOD VARIETIES

10. FOR SOD, APPLY DEPTH OF SOIL AS PER PLANTING DETAILS PAGE. REMOVE ANY STONES FROM TOP OF SUB-GRADE OR COVER STONES WITH ADDITIONAL 2" OF SOIL MIX.

II. ALL SOD AREA SHALL BE TREATED WITH 'ROUND UP' TWO WEEKS PRIOR TO INSTALLATION FOR REMOVAL OF ANY EXISTING OBJECTIONABLE PLANTS. DOSAGE AND APPLICATION PER MANUFACTURERS SPECIFICATIONS.

I. THE LANDSCAPE CONTRACTOR SHALL AT ALL TIMES KEEP THE PREMISES FREE FROM ACCUMULATIONS OF WASTE MATERIALS OR RUBBISH CAUSED BY HIS EMPLOYEES OR WORK. HE SHALL LEAVE ALL PAVED AREAS "BROOM CLEAN" WHEN COMPLETED WITH THE WORK.

2. MARKS AND DAMAGE TO EXISTING PAVING MATERIALS SHALL BE THE RESPONSIBILITY OF THE LANDSCAPE CONTRACTOR.

ALL PALMS, TREES, AND LARGE SPECIMEN PLANTS SHALL BE STAKED BY THE LANDSCAPE CONTRACTOR FOR LA APPROVAL OF LAYOUT AND LOCATIONS PRIOR TO INSTALLING SAME.

TREE STAKE PAINT FORMULA: BEHR PREMIUM PLUS EXT FLAT -ACCENT BASE (4670) OZ 48 96 THALO GREEN 09 0 04 0 YELLOW OXIDE 02 LAMP BLACK 00 0 0

SUBMIT SAMPLE

ANY/ALL TRACK DRAINS, TRENCH DRAINS AND DRAIN GRATES TO BE CAST IRON UNLESS OTHERWISE SPECIFIED BY SMI

PLANT LIST

All plants to be Florida Fancy

QTY	BOTANICAL NAME	COMMON NAME	SIZE	NATIVE
TREES	3			
2	Coccoloba diversifolia	Pigeon Plum	per SMI	Native
2	Coccoloba uvifera	Sea Grape	per SMI	Native
1	Cordia sebestena	Orange Geiger Tree	10`ht, SMI to approve	Native
1	Fortunella japonica 'Variegata'	Variegated Kumquat	#65, SMI to approve	Not Native
РАІ М	TREES			
3	Sabal palmetto	Cabbage Palmetto	mixed heights, 14'gw, 18"gw, 20'gw, booted	Native
QTY	BOTANICAL NAME	COMMON NAME	SIZE	NATIVE
SHRU	RS			
2	Hibiscus rosa-sinensis 'La France'	Hibiscus 'La France'	Pink, per SMI	Not Native
124 LF	Radermachera x 'Kunming'	Kunming Dwarf Tree Jasmine	6'ht, ftb, hedge, Qty=LF, SMI to approve	Not Native
\/INIE/[ESPALIER			-
3	Solandra grandiflora	Showy Chalice Vine	#15, trl, solid green leaf, train up wall over garage door	Not Native
SHDI I	B AREAS			•
<u> 31 11 (U</u> 10	Annuals	per client	#1, TBD, (in pots)	Not Native
80	Coccoloba uvifera x diversifolia	Hybrid Sea Plum	#3, 30"ht, 14"oc	Native
27	Heliotropium angiospermum	Scorpion's Tail	#3, 16"oc	Native
39	Ilex vomitoria 'Schillings'	Schillings Yaupon Holly	#7, 18"oc	Native
30	Mix: Farfugium & Begonia fusca	Leopard Plant / Iron Cross Begonia	#3, 18"oc	Not Native
15	Perennials Mix Per SMI	See Perrenial Mix Chart	#3, 24"oc	Not Native
<u>GROU</u> 150	ND COVERS Mimosa strigillosa	Sunshine Mimosa	#1, 12"oc	Native
130	I wiii iiosa sii iyiiiosa	Suristille Willillosa	π 1, 1∠ UC	INALIVE

PEI	RENNIAL MIX			
QTY	BOTANICAL NAME	COMMON NAME	SIZE	NATIVE
SHRL		Plus Clarichauser	#2 04llas	Not Native
3 3	Clerodendrum ugandense Rondeletia leucophylla	Blue Glorybower Panama Rose	#3, 24"oc #3, 24"oc	Not Native
3	Salvia x 'BBSAL01301'	Rockin'® Blue Suede Shoes Sage	#3, 24"oc	Not Native
3	Tabernaemontana divaricata 'Netty'	Netty Pinwheel Jasmine	#3, 24"oc	Not Native
J				

SMI TO APPROVE STAKED LAYOUT OF ALL TREES

AND PLANTING LAYOUT PRIOR TO INSTALLATION

ALL IRRIGATION, IRRIGATION EQUIPMENT AND

IRRIGATION BOXES TO BE CONCEALED

ANY / ALL IRRIGATION BOXES

ALL PLANTING BEDS TO HAVE STEEL EDGE BORDER

SMI TO APPROVE LOCATIONS OF

Residence

260 Colonial Lane Palm Beach, Florida

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BY SMI OR IF REQUIRED BY MUNICIPALITY

3 10.21.2024 SECOND SUBMITTAL

2 10.03.2024 FIRST SUBMITTAL 1 09.16.2024 PRE-APPLICATION

DATE DESCRIPTION REVISIONS

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LANDSCAPE ARCHITECTURE 140 Royal Palm Way, Suite #206, Palm Beach, Florida 33480 Fax: 561-655-9007 Telephone: 561-655-9006 eMail: Office@smila.net www.smila.net FL registration #LA 13000223

TITLE

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Planting Specifications


SCALE PROJECT NUMBER: NONE 2402 DATE: PRJCT MNGR: CHECKED: 10.21.2024 CFV



SHEET 3 OF 3

DRAWING NO.

ANY/ALL TRACK DRAINS, TRENCH DRAINS AND DRAIN GRATES
TO BE CAST IRON UNLESS OTHERWISE SPECIFIED BY SMI FIELD VERIFY ALL DIMENSIONS

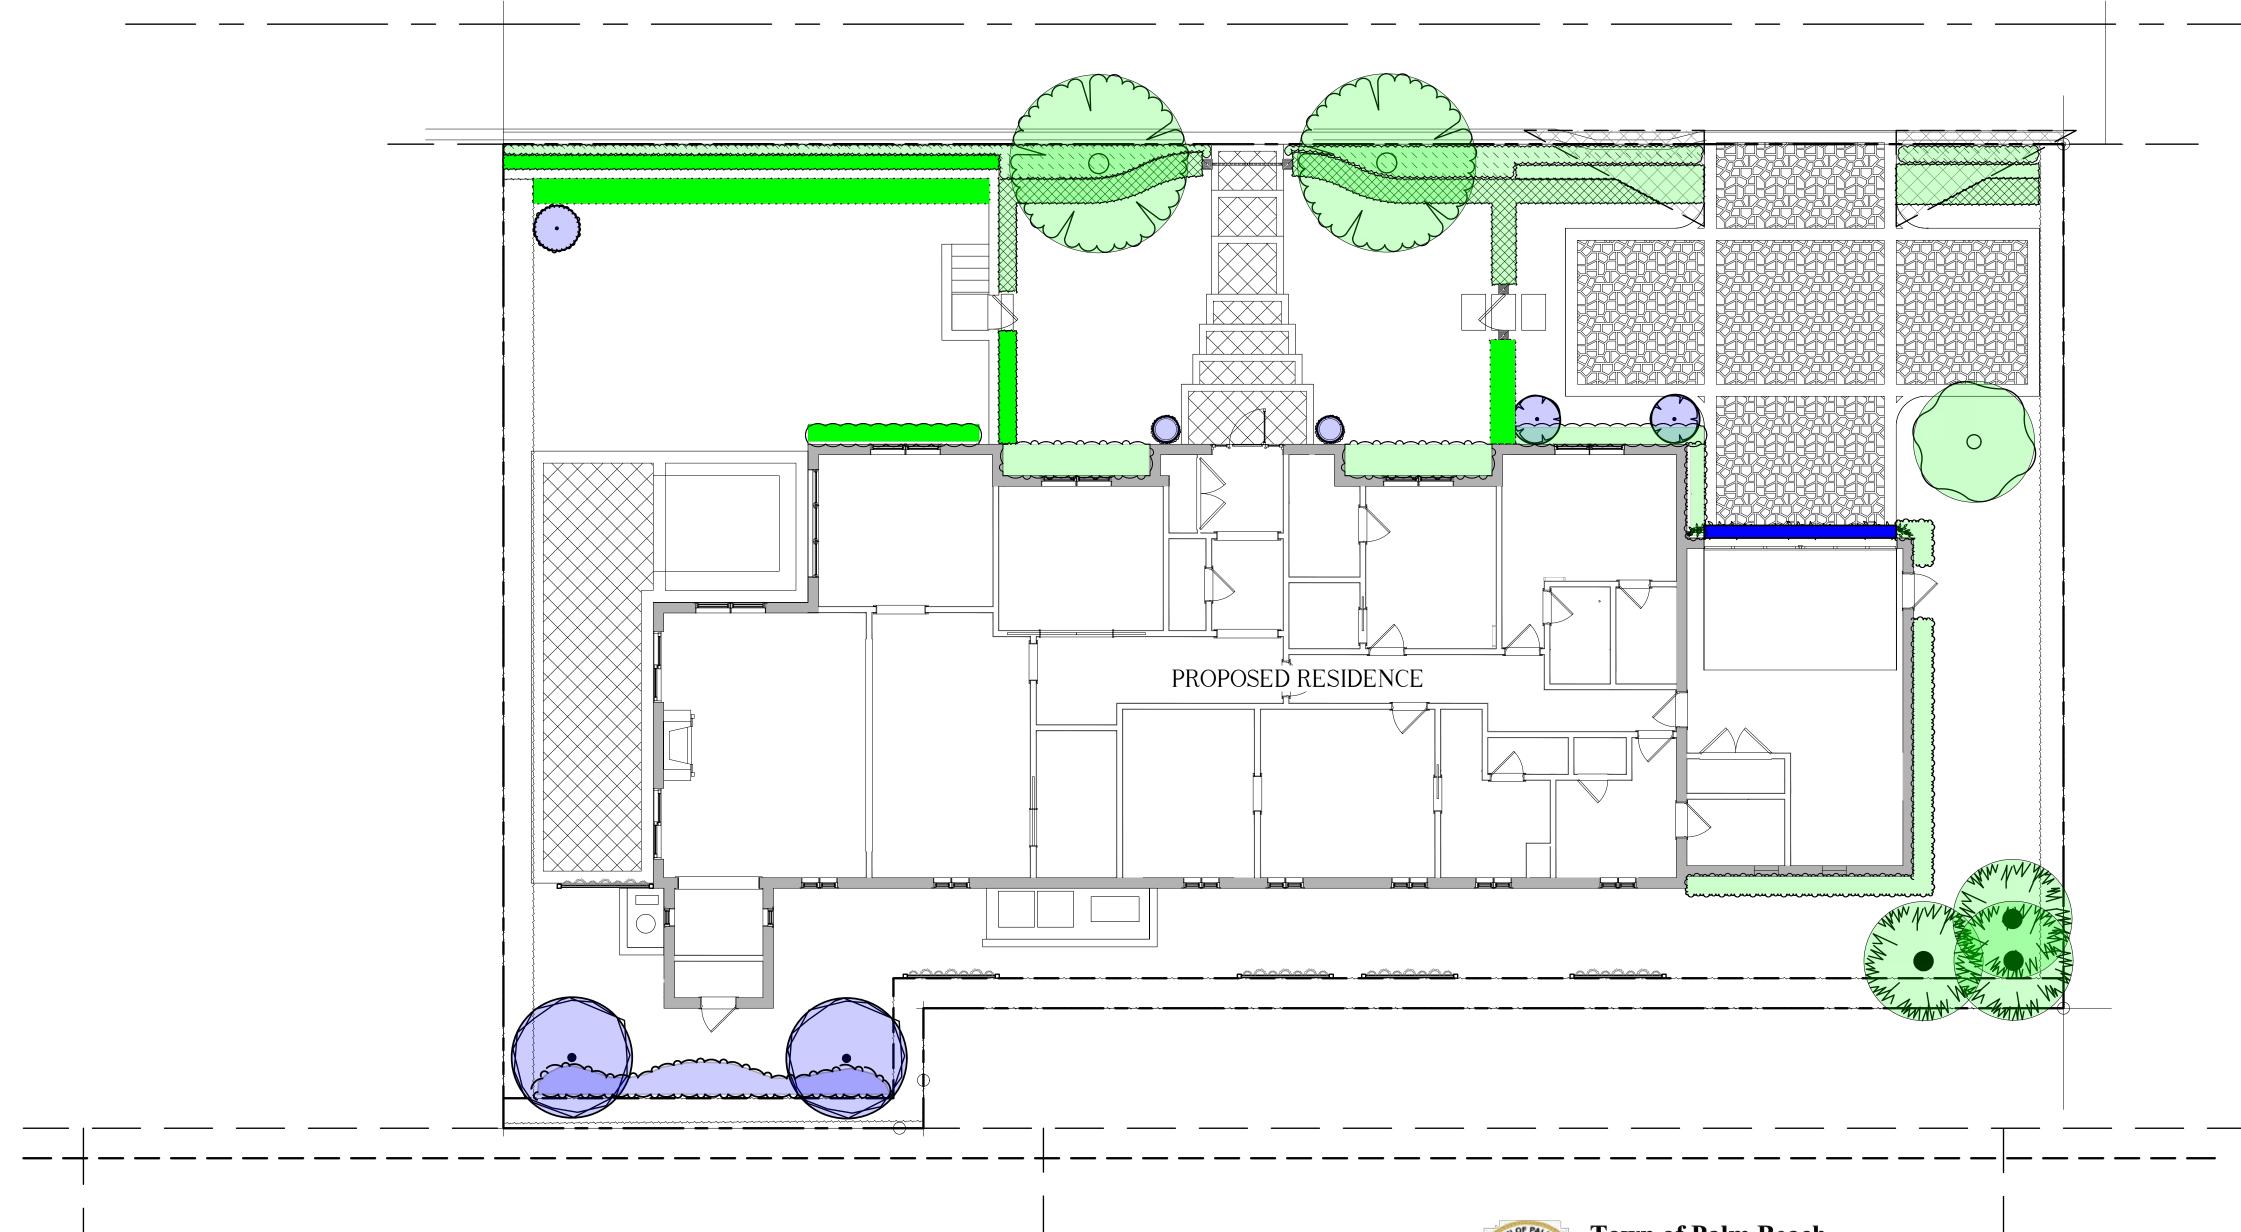

Native Coverage Calculations

Total coverage of new plantings.. . 2,130 sf (100%) Coverage by native plants. 1,112 sf (52.2%)

Newly planted non-native plant material

Newly planted native plant material

Areas not shown in color are either existing to remain, building, hardscape, or sod



Town of Palm Beach Planning Zoning and Building 360 S County Rd Palm Beach, FL 33480 www.townofpalmbeach.com

Line #	Landscape Legend				
1	Property Address:	260 Colonial Lane, Palm Beach, FL			
2	Lot Area (sq. ft.):	9,710 Sq. Ft.			
3		REQUIRED	PROPOSED		
4	Landscape Open Space (LOS) (Sq Ft and %)	4,325 Sq. Ft. (45% min.)	4,347 Sq. Ft. (45%)		
5	LOS to be altered (Sq FT and %)	N/A	9,710 Sq. Ft. (100%)		
6	Perimeter LOS (Sq Ft and %)	1,120 Sq. Ft. (50% min.)	1,866 Sq. Ft. (83%)		
7	Front Yard LOS (Sq Ft and %)	I,300 Sq. Ft. (40% min.)	2,234 Sq. Ft. (69%)		
8	Native Trees %	30% (number of trees)	83%		
9	Native Shrubs & Vines %	30% (number of shrubs & vines)	44%		
10	Native Groundcover %	30% (groundcover area)	100%		
To determine qualifying native vegetation use either:					

the Institute for Regional Conservation Natives for Your Neighborhood FL Statewide Plant List

the Florida Native Plant Society Native Plants for Your Area List

Note: Modification of >50% of existing landscape/greenscape are subject to minimum native plant requirements and must submit a landscape and irrigation plan for review.

This table shall be included on the landscape species index sheet as prepared by a licensed landscape architect and landscape openspace data shall be incorporated on to corresponding zoning legend. See Ord. 003-2023 REV BF 20230727

LANDSCAPE ARCHITECT TO APPROVE LAYOUT OF ALL HARDSCAPE MATERIAL PRIOR TO INSTALLATION



The Hunt Residence

260 Colonial Lane Palm Beach, Florida

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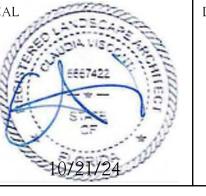
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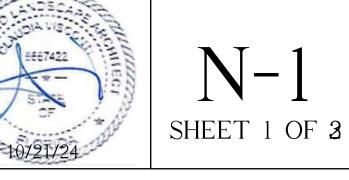
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TITLE Native Calculations SCALE PROJECT NUMBER: 1/8" = 1'-0" 2402 PRJCT MNGR: CHECKED: CFV 10.21.2024 CFV DRAWING NO.








ABBREVIATIONS KEY
DIA = DIAmeter DR = Dominican Republic

HS =HardScape

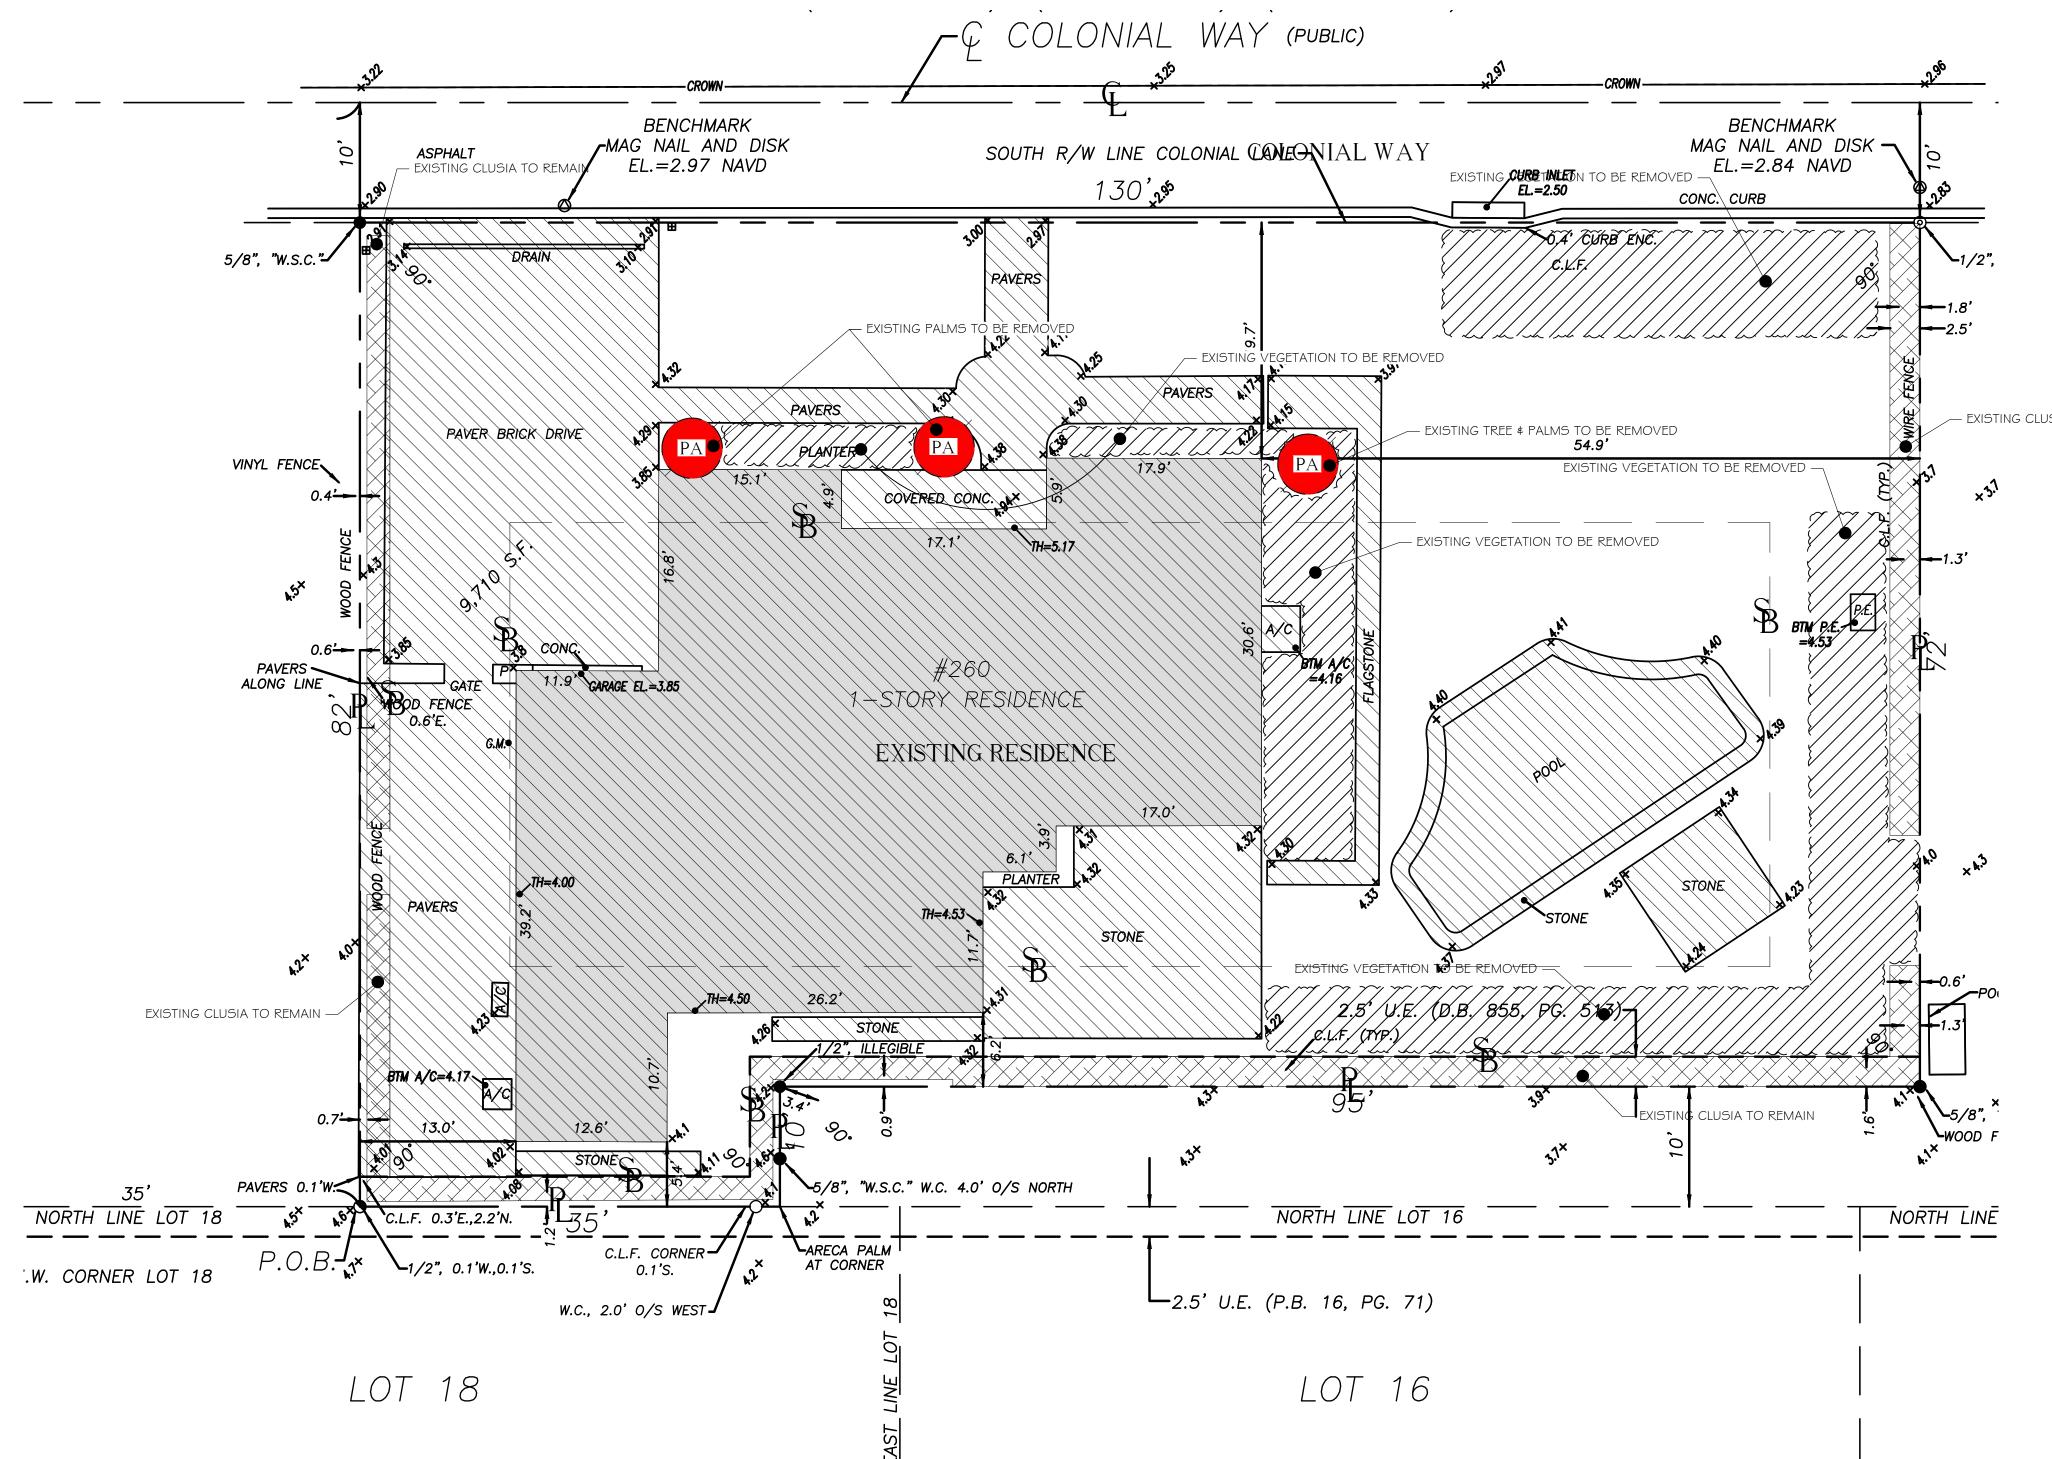

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DIA = DIAmeter DR = Dominican Republic HS =HardScape HT =HeighT

MAX = MAXımum MIN = MINimum

THK =THICK TYP =TYPIcal

GRADING

LA = Landscape Architect
LS = LandScape

TBD =To Be Determined TC =Terra Cotta

BOS =Bottom Of Steps

TOS =Top Of Steps TOW =Top Of Wall

ELEV =ELEVation

FFE =Finished Floor Elevation

SMI = SMI Landscape Architecture



·····Relocate









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The

Hunt

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ROOT BALLS

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NOTES:
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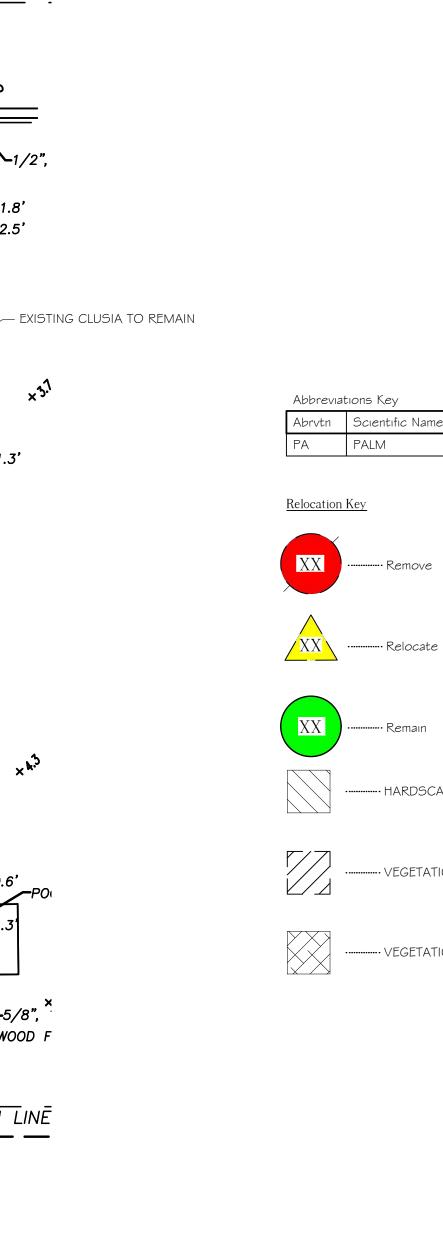
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SHEET 1 OF 2



Know what's below Call before you dig



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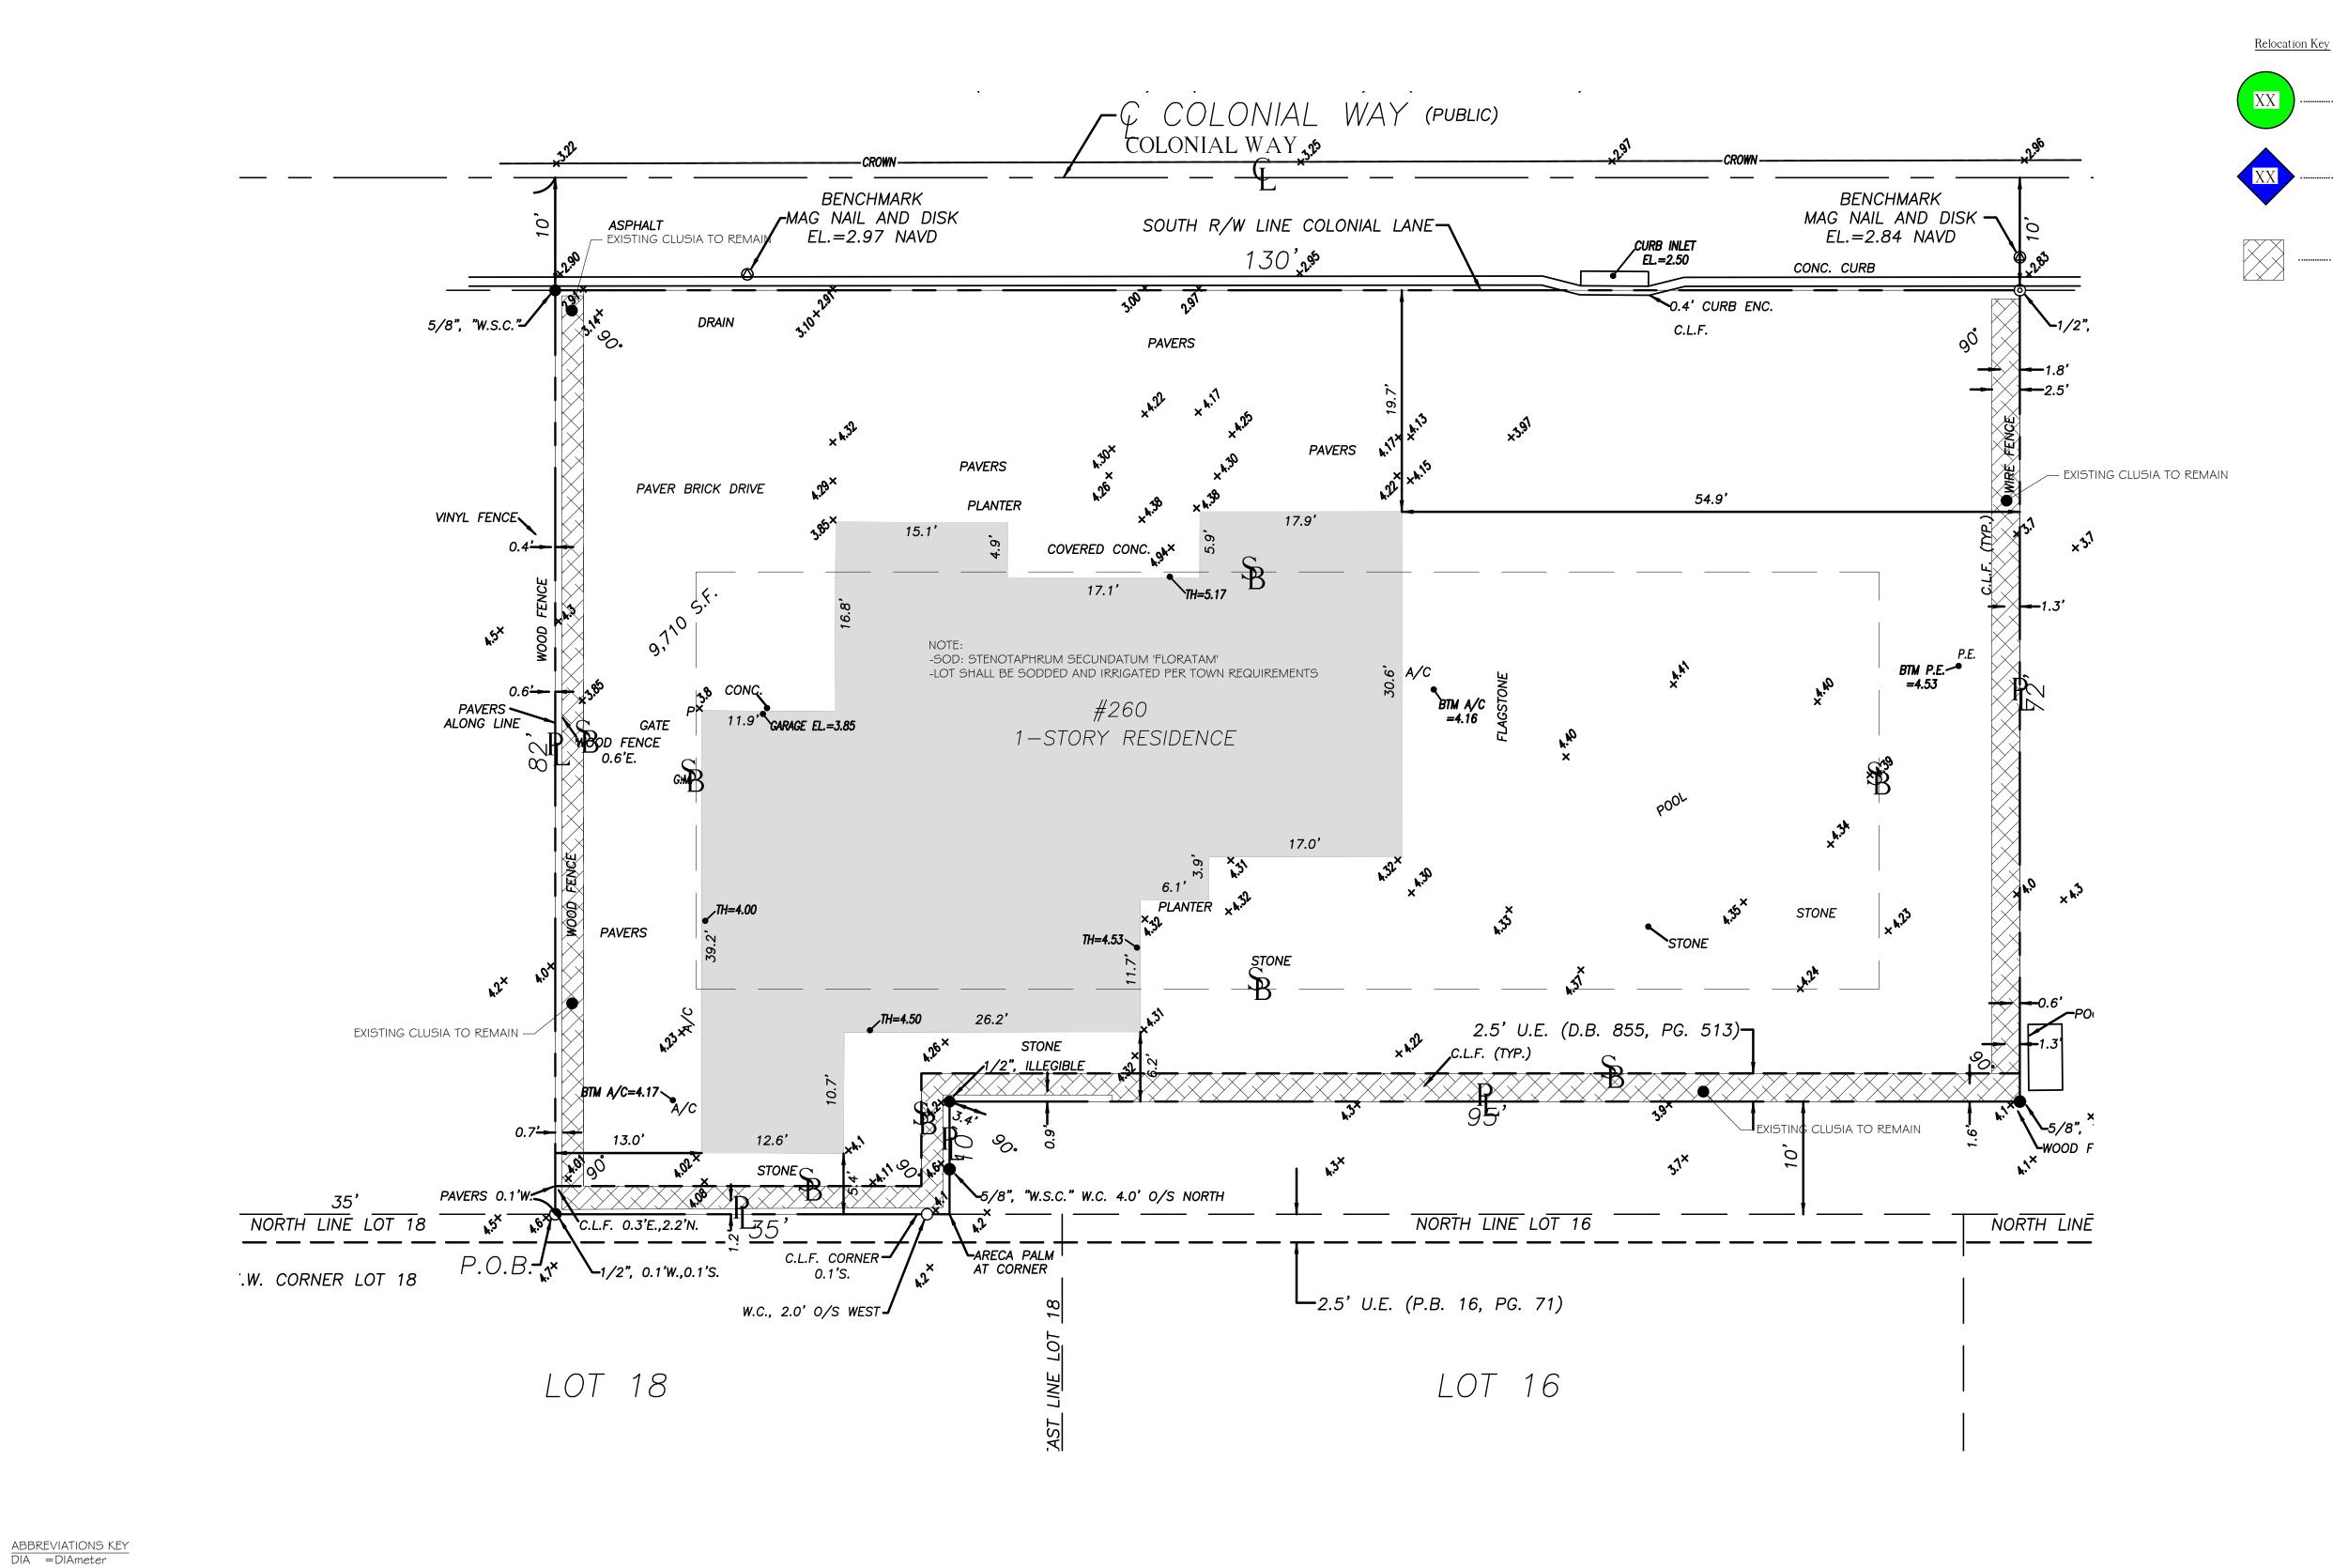
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GRADING

......VEGETATION TO REMAIN



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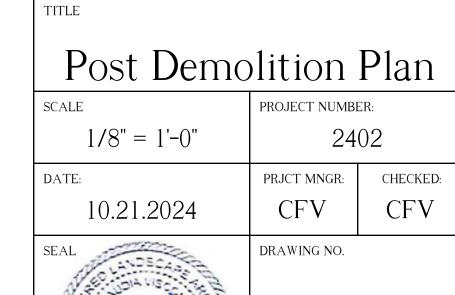
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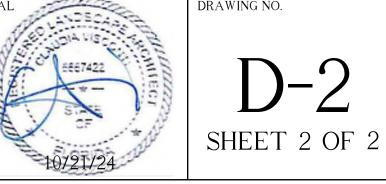
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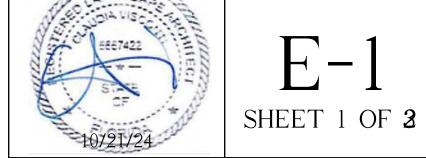
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TITLE North/South Elevation View SCALE PROJECT NUMBER:

AS NOTED 2402 PRJCT MNGR: CHECKED: 10.21.2024 CFV DRAWING NO.





ANY/ALL TRACK DRAINS, TRENCH DRAINS AND DRAIN GRATES
TO BE CAST IRON UNLESS OTHERWISE SPECIFIED BY SMI FIELD VERIFY ALL DIMENSIONS









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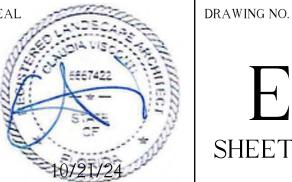
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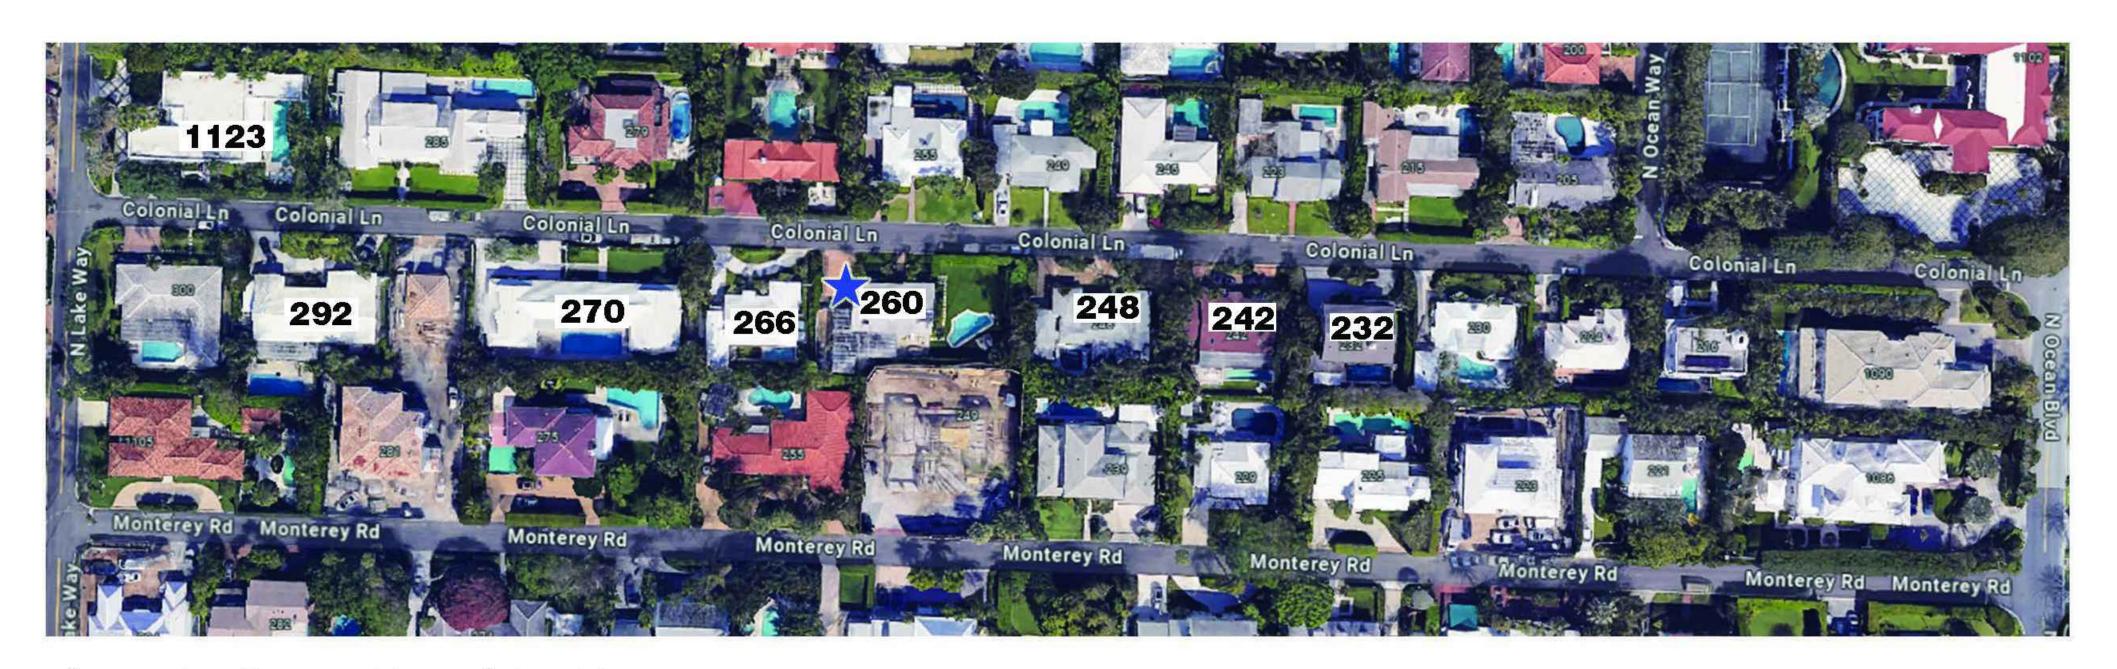
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TITLE			
East/West E	levation	View	
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AS NOTED	24	2402	
DATE:	PRJCT MNGR:	CHECKED:	
10.21.2024	CFV	CFV	



SHEET 2 OF 2



Surrounding Property Map - Colonial Lane



Subject Property -260 Colonial



270 Colonial



266 Colonial



292 Colonial



242 Colonial



232 Colonial



248 Colonial



1123 N lake Way

The Hunt Residence

260 Colonial Lane Palm Beach, Florida

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NOTES: -FOOTINGS FOR ALL STRUCTURES TO BE AT LEAST 3' BELOW GRADE TO ALLOW FOR PLANTINGS / ROOT BALLS
-DRIP IRRIGATION MAY ONLY BE USED IF SPECIFIED
BY SMI OR IF REQUIRED BY MUNICIPALITY

- 3 10.21.2024 SECOND SUBMITTAL 2 10.03.2024 FIRST SUBMITTAL
- 1 09.16.2024 PRE-APPLICATION

DATE DESCRIPTION REVISIONS

SECOND SUBMITTAL

S M I

LANDSCAPE ARCHITECTURE 140 Royal Palm Way, Suite #206, Palm Beach, Florida 33480 Telephone: 561-655-9006 Fax: 561-655-9007 eMail: Office@smila.net www.smila.net FL registration #LA 13000223

TITLE




2402 None PRJCT MNGR: CHECKED: CFV 10.21.2024 CFV DRAWING NO.

SHEET 1 OF 2






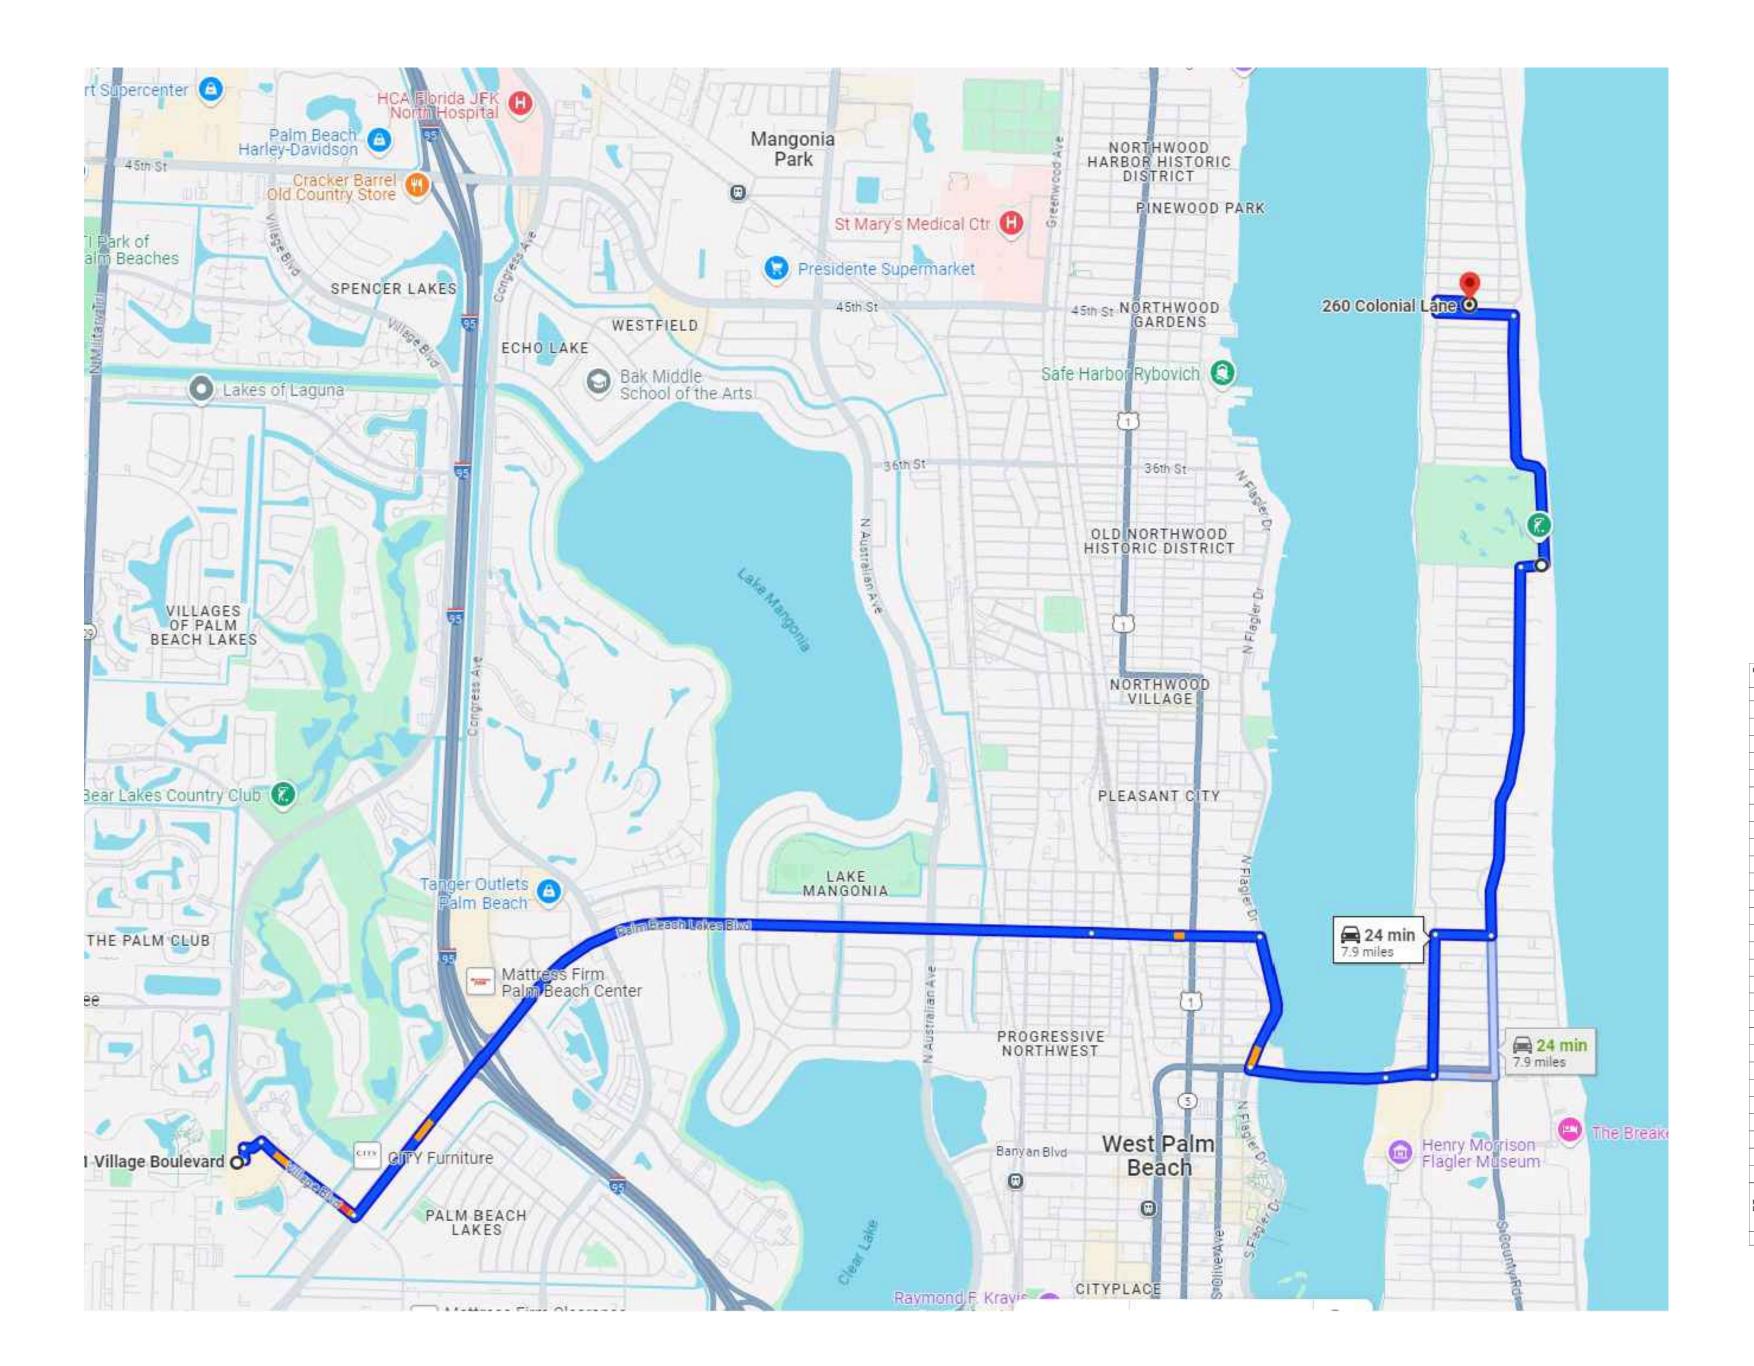

Proposed Route Map for Truck Traffic

- A. Roadways: Deliveries and workers will be using the Flagler Memorial Bridge. Head east on Palm Beach Lakes Blvd to Bradley PI in Palm Beach, Continue on Bradley PI. Take N Lake Way, Country Club Rd and N Lake Way to Colonial Ln Turn left onto Bradley Pl, turn right onto Dunbar Rd, turn left at the 1st cross street onto N County Rd, turn right onto Country Club Rd Country Club Rd turns left and becomes N Ocean Blvd, turn left onto Monterey Rd, turn right onto N Lake Way Turn right onto Colonial Ln, Destination will be on the right.
- B. Maximum truck length= 48 feet
- C. Total number of estimated deliveries generated by project= 32

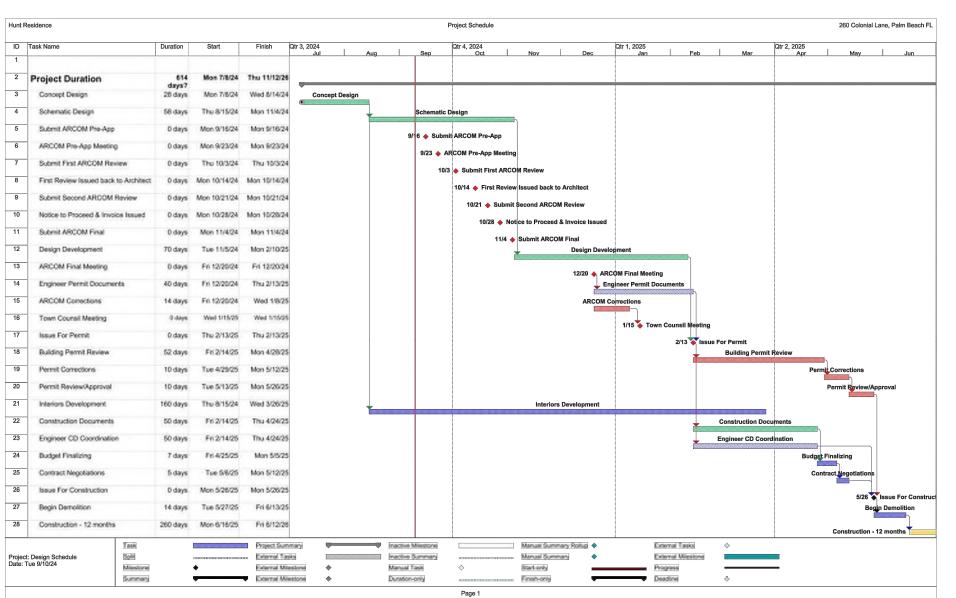

ABBREVIATIONS KEY DIA = DIAmeter

DR = Dominican Republic HS =HardScape

HT =HeighT

LA = Landscape Architect LS =LandScape

 $MAX = MAX_{imum}$ MIN = MINimum

SMI = SMI Landscape Architecture

TBD =To Be Determined TC =Terra Cotta

THK =THICK TYP =TYPical

GRADING

BOS =Bottom Of Steps ELEV = ELEVation

FFE = Finished Floor Elevation TOS =Top Of Steps TOW =Top Of Wall

LANDSCAPE ARCHITECT TO APPROVE LAYOUT OF ALL HARDSCAPE MATERIAL PRIOR TO INSTALLATION



The Hunt Residence

260 Colonial Lane Palm Beach, Florida



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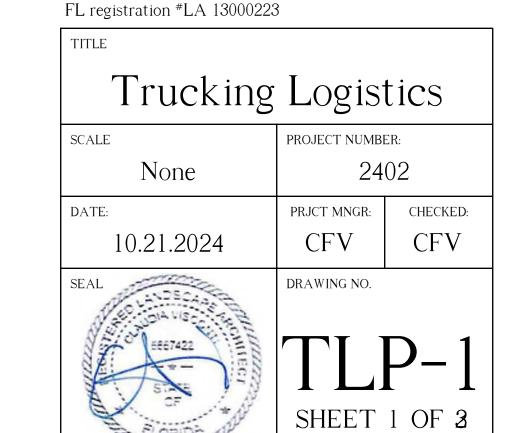
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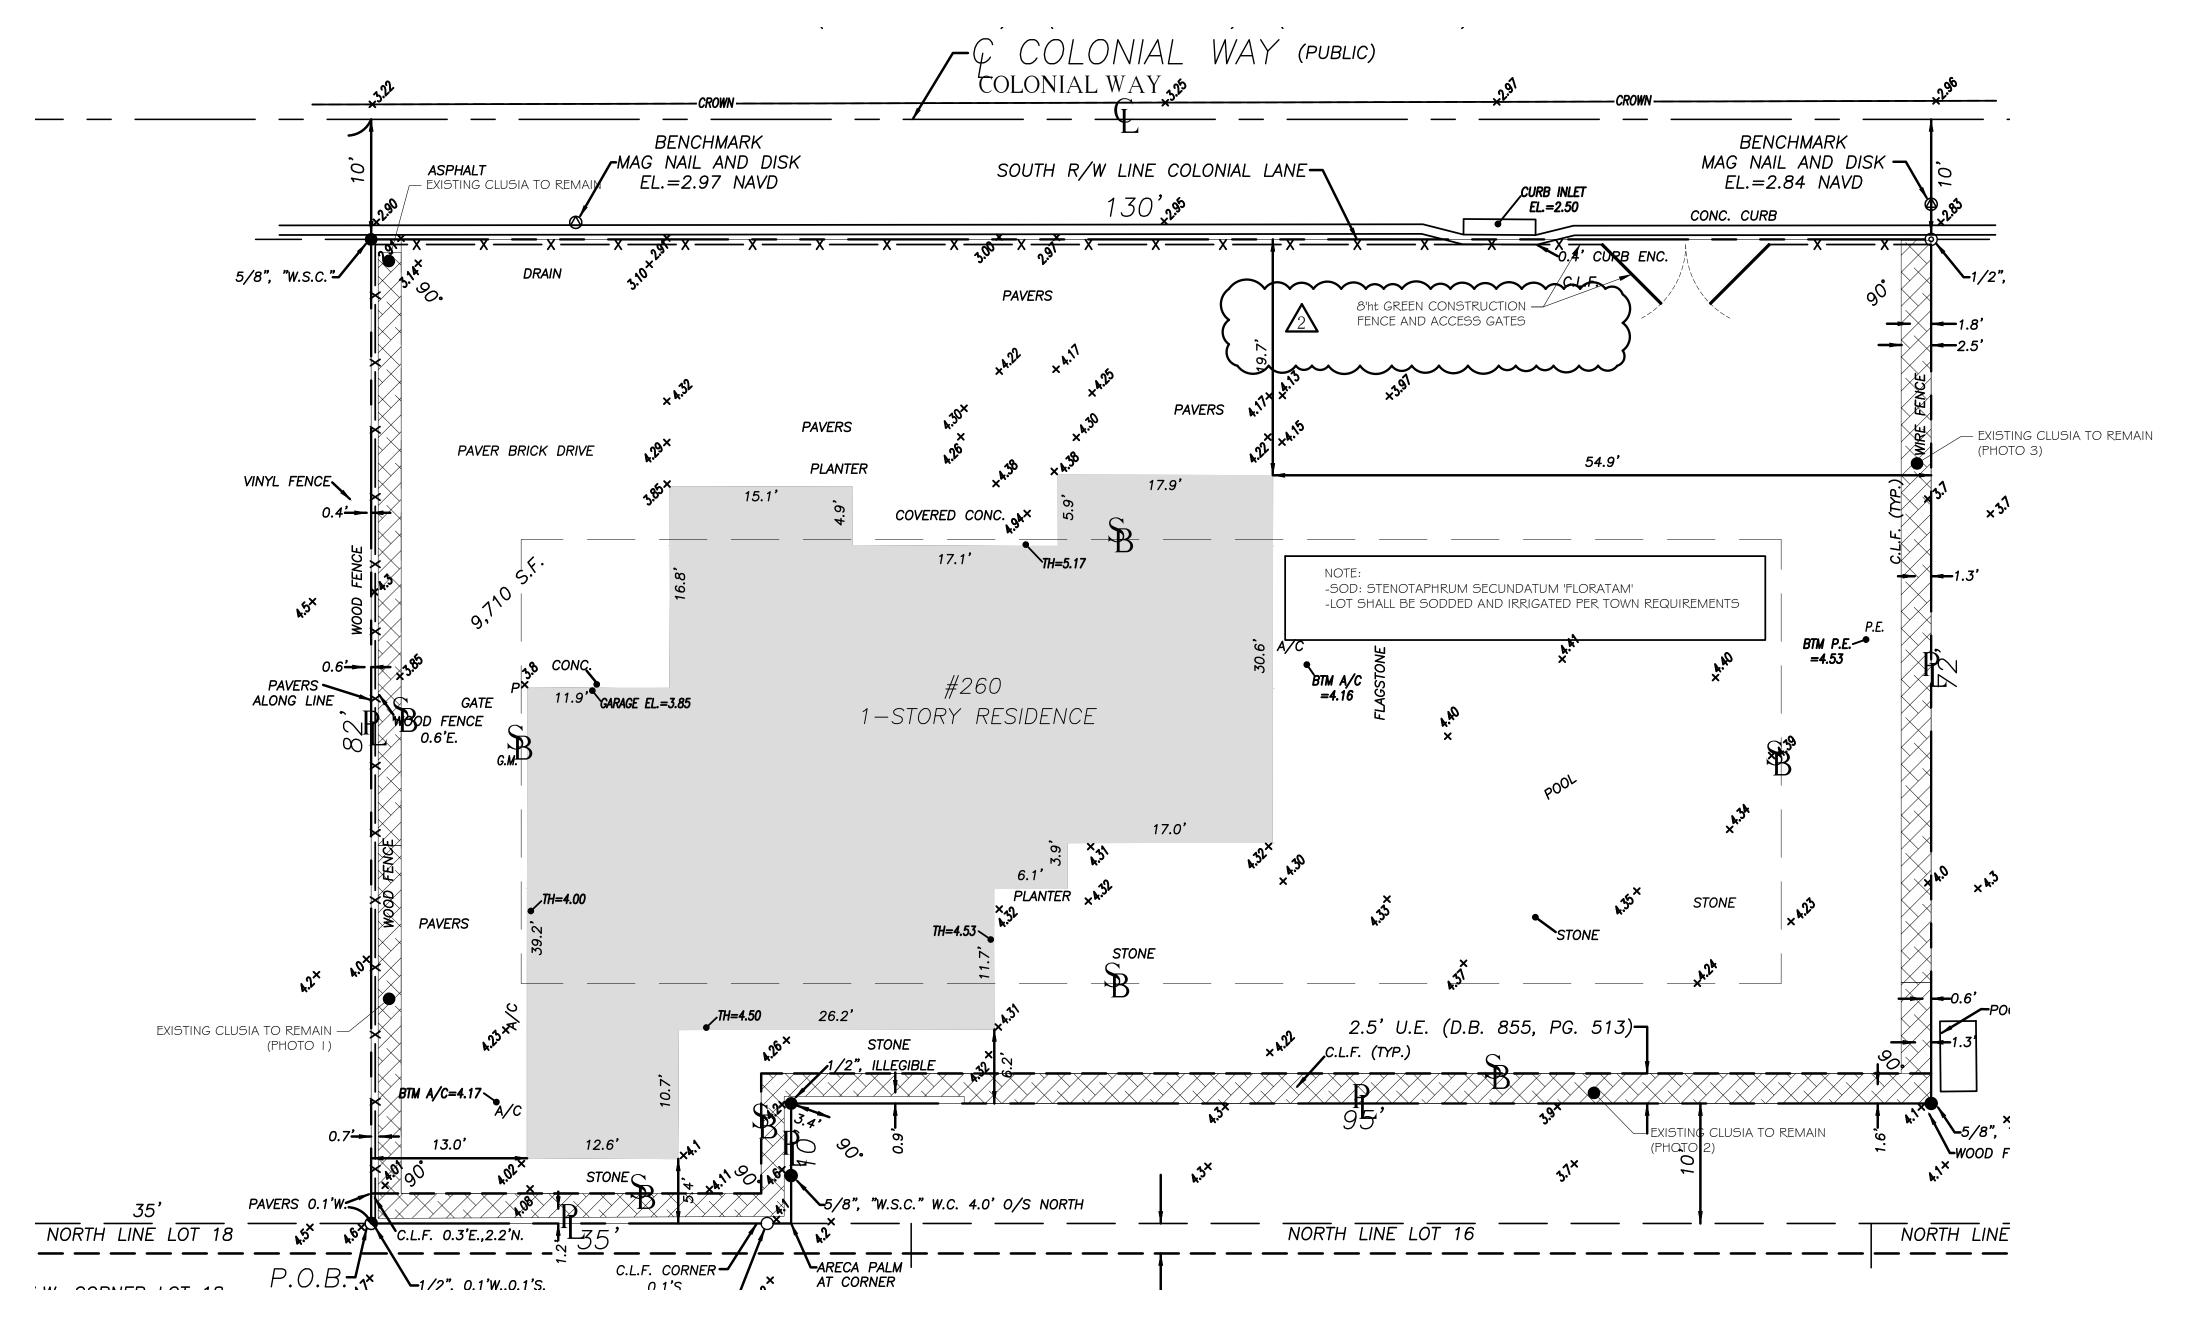
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Relocation Key







WEST SIDE



SOUTH SIDE



PHOTO 3

EAST SIDE

LANDSCAPE ARCHITECT TO APPROVE LAYOUT OF ALL HARDSCAPE MATERIAL PRIOR TO INSTALLATION



The Hunt Residence

260 Colonial Lane Palm Beach, Florida

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- 3 10.21.2024 SECOND SUBMITTAL 2 10.03.2024 FIRST SUBMITTAL 1 09.16.2024 PRE-APPLICATION
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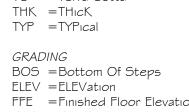
REVISIONS

SECOND SUBMITTAL

LANDSCAPE ARCHITECTURE 140 Royal Palm Way, Suite #206, Palm Beach, Florida 33480 Telephone: 561-655-9006 Fax: 561-655-9007 eMail: Office@smila.net www.smila.net FL registration #LA 13000223

Screen	ing Pla	n
SCALE 1/8" = 1'-0"	PROJECT NUMBI	er: 02
DATE: 10.21.2024	PRJCT MNGR:	снескед: CFV
SEAL	DRAWING NO.	






ABBREVIATIONS KEY
DIA = DIAmeter DR = Dominican Republic

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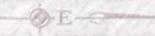
MIN = MINimum

SMI = SMI Landscape Architecture


TBD = To Be Determined



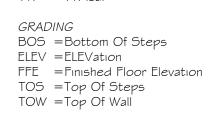





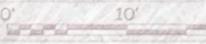



LEGEND = ARC LENGTH = AIR CONDITIONING = ACCESS EASEMENT = ALSO KNOWN AS ASPH. = ASPHALT BLDG. = BUILDING —— 40' R/W (P.B. 13, PG. 14) VACATED BY (D.B. 453, PG. 158) B.M. = BENCHMARK B.O.C. = BACK OF CURB B.O.W. = BACK OF WALK (C) = CALCULATED = CABLE ANTENNA TELEVISION = CHORD BEARING = CONCRETE BLOCK STRUCTURE C.C.C.L. = COASTAL CONSTRUCTION CONTROL LINE CH = CHORD SCALE: 1"=10' C.L.F. = CHAIN LINK FENCE (D.B. 518, PG. 535) & (D.B. 453, PG. 157) & (D.B. 519, PG. 181) = CLEAR −Ç COLONIAL WAY (PUBLIC) = CORRUGATED METAL PIPE = CONCRETE = DESCRIPTION DATUM = DEED BOOK = DRAINAGE EASEMENT 485.00' (N.T.S.) D.E. BENCHMARK **BENCHMARK** = DRILL HOLE -MAG NAIL AND DISK MAG NAIL AND DISK SOUTH R/W LINE COLONIAL LANE ASPHALT = DRIVEWAY D/W EL.=2.97 NAVD EL.=2.84 NAVD = ELEVATION 130' EL.=2.50 = ENCROACHMENT = EDGE OF PAVEMENT 0.4' CURB ENC. E.O.W. = EDGE OF WATER 5/8", "W.S.C." ~1/2", 0.3'N. ESM'T = EASEMENT = FINISH FLOOR FND. = FOUND F.O.C. = FACE OF CURB NORTH LINE LOT 44 G.M.= GAS METER = INVERT (P.B. 13, PG. 14) I.T.W.C.D. = INDIAN TRAIL WATER CONTROL DISTRICT PAVERS_ PAVERS = LIMITED ACCESS EASEMENT = LICENSE BOARD PAVER BRICK DRIVE 54.9' L.W.D.D. = LAKE WORTH DRAINAGE DISTRICT PLANTER VINYL FENCE = FIELD MEASUREMENT M.H. = MANHOLE COVERED CONC. αk^{\times} property. M.H.W.L. = MEAN HIGH WATER LINE = MEAN LOW WATER LINE N.A.V.D. = NORTH AMERICAN VERTICAL DATUM N.G.V.D. = NATIONAL GEODETIC VERTICAL DATUM N.P.B.C.I.D.= NORTHERN PALM BEACH COUNTY IMPROVEMENT DISTRICT = NOT TO SCALE = OVERALL BTM A/C = OVERHEAD UTILITY LINE ALONG LINE = OFFICIAL RECORD BOOK 1-STORY RESIDENCE WOOD FENCE = OFFSET O/S = PLANTER = PLAT DATUM = PLAT BOOK = PALM BEACH COUNTY 17.0' = POINT OF CURVATURE = POINT OF COMPOUND CURVATURE = POOL EQUIPMENT PG. = PAGE = POINT OF INTERSECTION **PAVERS** = PART OF STONE = POINT OF BEGINNING P.O.B. = POINT OF COMMENCEMENT P.O.C. = POINT OF REVERSE CURVATURE POOL EQUIPMENT PAD 0.7'E. P.R.M. = PERMANENT REFERENCE MONUMENT 2.5' U.E. (D.B. 855, PG. 513)-PROP. = PROPOSED C.L.F. (TYP.) _1/2<u>",</u> ILLEGIBLE = POINT OF TANGENCY PVM'T = PAVEMENT BTM A/C=4.17 \ (R) = RADIAL `_5/8", ^"W.S.C." = RADIUS RGE. = RANGE GARAGE AREA (P.B. 13, PG. 14) \wood FENCE 0.2'W.,0.8'S. = ROAD PLAT BOOK R/W = RIGHT OF WAY -5/8", "W.S.C." W.C. 4.0' O/S NORTH = SURVEY DATUM NORTH LINE LOT 16 NORTH LINE LOT 18 NORTH LINE LOT 14 = SETBACK SEC. = SECTION ARECA PALM AT CORNER C.L.F. CORNER -= SUBDIVISION `−1/2", 0.1'W.,0.1'S. 0.1**'**S. = SQUARE FEET S.F.W.M.D. = SOUTH FLORIDA WATER W.C., 2.0' O/S WEST-MANAGEMENT DISTRICT S.I.R.W.C.D= SOUTH INDIAN RIVER WATER <u>SOUTH LINE LOT 45 (P.B. 13, PG.</u> SOUTH LINE LOT $44 \downarrow (P.B. 13, PG. 14)$ CONTROL DISTRICT = STATE ROAD LOT 18 LOT 14 STA. = STATION STY. = STORY ^L2.5' U.E. (P.B. 13, PG. 14) = THRESHOLD ELEVATION T.O.B. = TOP OF BANK T.O.C. = TOP OF CURB GREGORY ADDITION TWP. = TOWNSHIP TYP. = TYPICAL (P.B. 16, PG. 71) U/C = UNDER CONSTRUCTION U.E. = UTILITY EASEMENT U.R. = UNRECORDED = WITNESS CORNER W.C. = WATER MANAGEMENT EASEMENT W.M.E. W.M.M.E. = WATER MANAGEMENT MAINTENANCE EASEMENT = WATER MANAGEMENT TRACT W.M.T. = BASELINE = CENTERLINE = CENTRAL ANGLE/DELTA FLOOD ZONE: This property is located in Flood Zone AE (EL 6), according to F.I.R.M. (Flood Insurance Rate Map) No. 12099C 0393F, dated 10/05/2017 = CONCRETE MONUMENT FOUND (AS NOTED) = CONCRETE MONUMENT SET (LB #4569) = ROD & CAP FOUND (AS NOTED) 1. All information regarding record easements, adjoiners, and other documents that might affect the quality of title to tract shown hereon was gained from commitment number 1062-4765839 = 5/8" ROD & CAP SET (LB #4569) issued by First American Title Insurance Company, dated May 13, 2020. This office has made no search of the Public Records. = IRON PIPE FOUND (AS NOTED) Elevations shown hereon, if any, are in feet and decimal parts thereof and are based on NAVD-88. The expected accuracy of the elevations shown hereon is 0.03' for the hard surface = IRON ROD FOUND (AS NOTED) elevations (shown thus x 0.00) and 0.1' (shown thus x 0.0) for the soft surface elevations. Elevations shown hereon are U.S. survey feet unless otherwise noted. = NAIL FOUND Description furnished by client or client's agent. = NAIL & DISK FOUND (AS NOTED) 4. Unless presented in digital form with electronic seal and electronic signature this survey must bear the signature and the original raised seal of a Florida licensed surveyor or mapper this = MAG NAIL & DISK SET (LB #4569) drawing, sketch, plat or map is for informational purposes only and is not valid. **CERTIFICATION:** = PROPERTY LINE This survey cannot be transferred or assigned without the specific written permission of Wallace Surveying Corporation. Certificate of Authorization Number LB4569. = UTILITY POLE Except as shown, underground and overhead improvements are not located. Underground foundations not located. = FIRE HYDRANT The survey sketch shown hereon does not necessarily contain all of the information obtained or developed by the undersigned surveyor in his field work, office work or research. 5J-17, Florida Administrative Code pursuant to Section 472.027, Florida Statutes, = WATER METER No responsibility is assumed by this surveyor for the construction of improvements, from building ties shown on this survey. effective September 1, 1981. Revisions shown hereon do not represent a "survey update" unless otherwise noted. = WATER VALVE 10. All dates shown within the revisions block hereon are for interoffice filing use only and in no way affect the date of the field survey stated herein. DATE OF LAST FIELD SURVEY: 10/25/2023 = LIGHT POLE 11. In some instances, graphic representations have been exaggerated to more clearly illustrate the relationships between physical improvements and/or lot lines. In all cases, dimensions shown = PINE TREE shall control the location of the improvements over scaled positions.

12. It is a violation of Rule 5J-17 of the Florida Administrative Code to alter this survey without the express prior written consent of the Surveyor. Additions and/or deletions made to the face of this


13. The ownership of fences, perimeter walls and/or hedges shown hereon are not known and thus are not listed as encroachments. Fences, hedges and/or perimeter walls are shown in their

survey will make this survey invalid.

14. The expected horizontal accuracy of the information shown hereon is +/- 0.10'.

relative position to the boundary.

= SABAL PALM

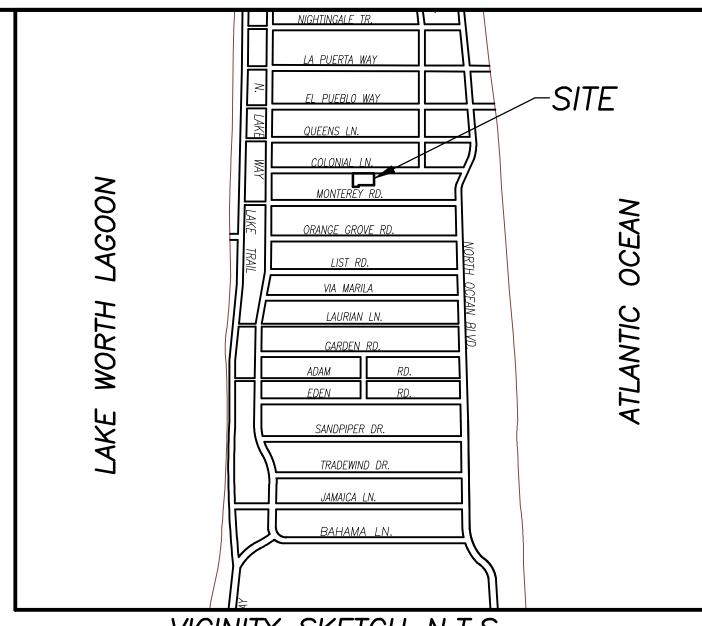

VICINITY SKETCH N.T.S.

BOUNDARY SURVEY FOR: MEREDITH E. HUNT AND MATTHEW DEATLEY

This survey is made specifically and only for the following parties for the purpose of a closing on the surveyed

Meredith E. Hunt and Matthew DeAtley First American Title Insurance Company Kochman & Ziska, PLC

The undersigned surveyor assumes no responsibility or liability for any other purpose or to any other party other than stated above.

PROPERTY ADDRESS: 260 Colonial Lane

Palm Beach, FL 33480

LEGAL DESCRIPTION:

All that tract or parcel of land beginning at a point in the North line of Lot Eighteen, as shown on the Plat of GREGORY ADDITION TO THE TOWN OF PALM BEACH, FLORIDA, on file in the Office of the Clerk of the Circuit Court of Palm Beach County, Florida, in Plat Book 16, Page 71, which point is 35 feet Easterly from the Northwesterly corner of said

thence in an Easterly direction, along the Northerly line of said Lot 18 for a distance of 35 feet; thence at right angles running in a Northerly direction for a distance of 10 feet to a point;

thence at right angles and running in an Easterly direction along a line parallel to the Northerly line of Lot 18, 16 and 14

of said **GREGORY ADDITION**, for a distance of 95 feet to a point; thence at right angles and running in a Northerly direction for a distance of 72 feet to a point in the South side of

thence in a Westerly direction along the South side of Colonial Lane for a distance of 130 feet to a point;


thence at right angles running in a Southerly direction for a distance of 82 feet to the **POINT OF BEGINNING**.

		TITLE COMMITMEN	IT REVIEW			
CLIENT: MEREDITH E. HUNT AND MATTHEW DEATLEY		COMMITMENT NO.: 1062-4765839 DATE: MAY 13, 2020		2020		
REVIEWED BY:	CRAIG L. WALLACE	JOB NO. : 16-1490.3				
B2 ITEM NO.	DOCUMENT	DESCRIPTION	AFFECTS AND PLOTTED	AFFECTS AND NOT PLOTT- ABLE	NOT	NOT A SURVEY MATTER
1 TO 8	N/A	Standard Exceptions				•
9	N/A	Any Lien				•
10a	PB 13, PG 14	Plat of EL ENCANTO PLAT NO. 2	•			
10b	DB 453, PG 158	Ordinance by the Town of Palm Beach (abandonment of 40' right-of- way)	•			
10c	DB 453, PG 157	Resolution by the Town of Palm Beach	•			
10d	DB 518, PG 535	Dedication of the perpetual use by the public	•			
10e	DB 519, PG 181	Quit Claim Deed	•			
11	DB 855, PG 513	Perpetual easement for utility purposes	•			

0/25/23 SURVEY AND TIE-IN UPDATE B.M./M.B. 16-1490.4 PB354/63 06/09/20 SURVEY AND TIE-IN UPDATE B.M./M.B. 16-1490.3 PB294/38 2/17/16 SURVEY AND TIE-IN UPDATE J.C./M.B. 16-1490.2 PB232/24

BOUNDARY SURVEY FOR:

MEREDITH E. HUNT AND MATTHEW DEATLEY

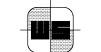

IFILE SURVEYING CORP. LICENSED BUSINESS & 4569

5553 VILLAGE BOULEVARD, WEST PALM BEACH, FLORIDA 33407 * (561) 640-4551 FIELD: B.M. J□B N□., 16-1490 F.B. PB226 PG. 41 OFFICE: M.B. DWG. NO. 16-1490 8/11/16 C'K'Dı C.W. REF: 16-1490.DWG

I HEREBY ATTEST that the survey shown hereon conforms to the Standards of Practice set forth by the Florida Board of Professional Surveyors and Mappers adopted in Rule

Craig L. Wallace Professional Surveyor and Mapper Florida Certificate No. 3357