
# 345 BRAZILIAN AVENUE PALM BEACH, FLORIDA COA-24-0019

#### TABLE OF CONTENTS


# LANDSCAPE L-1 LANDSCAPE/HARDSCAPE COVER SHEET L-2 EXISTING CONDITIONS AND LANDSCAPE/HARDSCAPE DEMOLITION PLAN L-3 EXISTING SITE PHOTOGRAPHS L-4 EXISTING SITE PHOTOGRAPHS L-5 EXISTING SITE PHOTOGRAPHS L-6 CONSTRUCTION SCREENING PLAN L-7 CONSTRUCTION STAGING PLAN L-8 TRUCK LOGISTICS PLAN L-9 LANDSCAPE PLAN RENDERING L-10 LANDSCAPE AND LANDSCAPE LIGHTING PLAN L-11 PROPOSED LANDSCAPE ELEVATIONS L-12 PLANT LIST L-13 PLANTING DETAILS AND SPECIFICATIONS

L-15 LANDSCAPE OPEN SPACE DIAGRAMS

# SITE LOCATION MAP

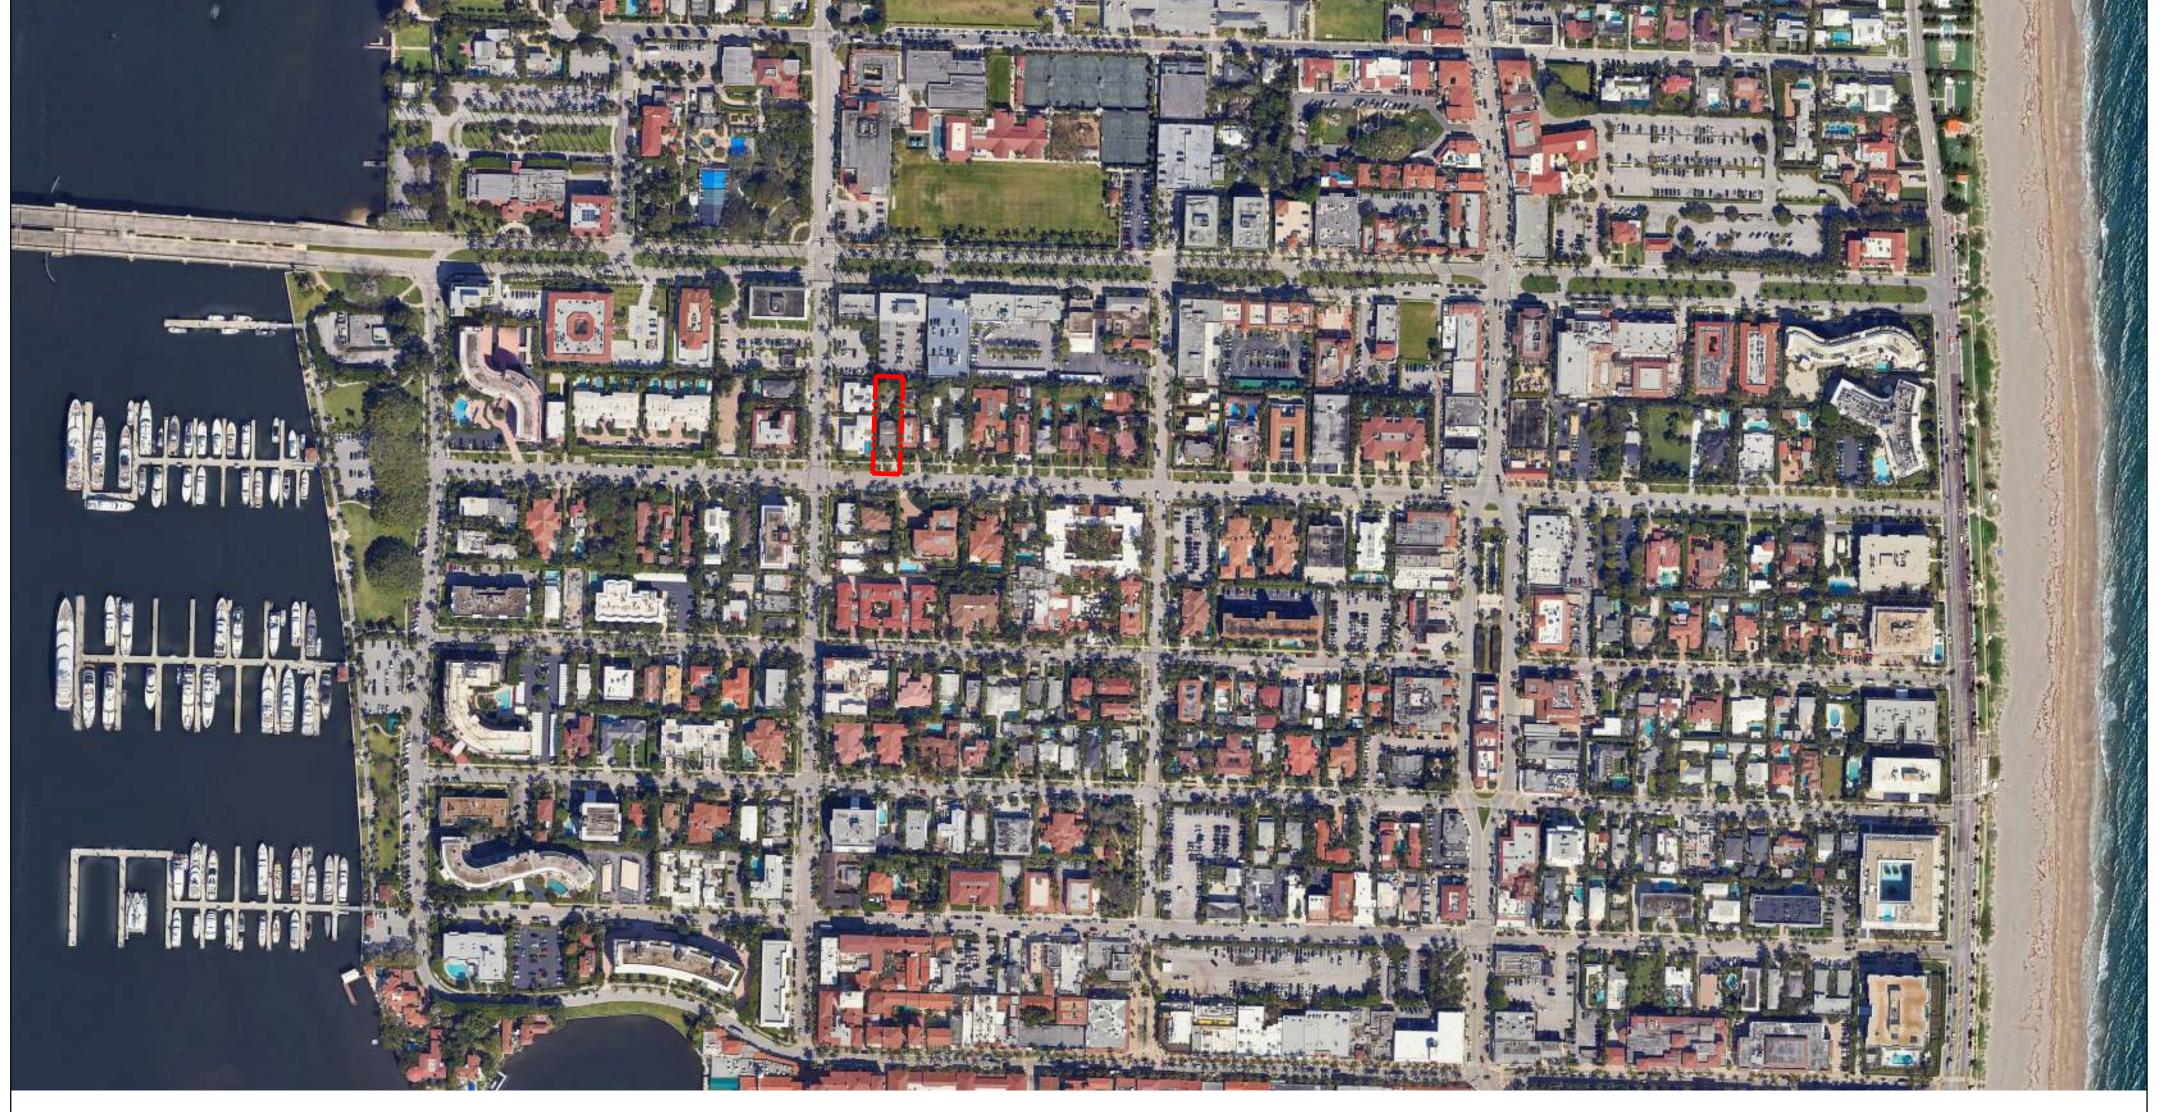

345 BRAZILIAN AVENUE PALM BEACH, FL 33480

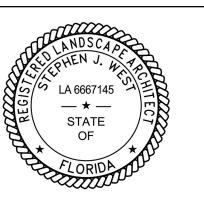

Digitally signed by Stephen J West Date: 2024.10.02 14:57:41 -04'00' PARKER · YANNETTE design group, inc.

LANDSCAPE ARCHITECTURE PLANNING • GRAPHICS

4425 Military Trail, Suite 202


Juniter Florida 33458

Telephone: (561) 747-50 Fax: (561) 747-2041 Email: mail@pydg.com

IOUS RESIDENOE

ATE: 2024.02.27 RAWN BY: SJW/JML OB NO.: 24-021 CALE: N/A LENAME: Valerious 05

r REVISIONS: 9.4.24 First Submittal 9.20.24 Second Submittal

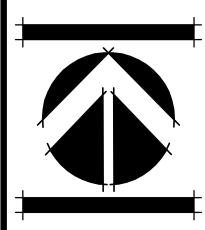

SHEET:

## Existing Plant Symbol Key




Existing tree/palm to remain



Existing tree/palm to be removed



Existing tree/palm to be relocated on site

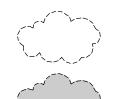

Existing vegetation to remain

Existing vegetation to be removed

Existing Plant Key

AM = Adonidia merrillii / Christmas Palm CG = Clusia guttifera / Small Leaf Clusia

CM = Caryota mitis / Fishtail Palm

DL = Dypsis lutescens / Areca Palm DS = Dombeya 'Seminole' / Dombeya

FIC = Ficus species FM = Ficus microcarpa / Cuban Laurel

NE = Noronhia emarginata / Madagascar Olive

PE = Ptychosperma elegans / Alexander Palm

PM = Podocarpus macrophyllus / Yew RE = Rhapis excelsa / Lady Palm

RM = Ravenala madagarscariensis / Travelers Tree

UNK = Unidentified Tree

#### **Existing Plant Removal List**

\_QTY\_

Caryota mitis / Fishtail Palm  $\mathsf{DL}$ Dypsis lutescens / Areca Palm

FIC Ficus species

Noronhia emarginata / Madagascar Olive

Ptychosperma elegans / Alexander Palm Ravenala madagarscariensis / Travelers Tree

UNK Unidentified Tree

#### Note:

SYM

CONSTRUCTION ACTIVITY SHALL BE SCREENED FROM ADJACENT PROPERTIES AND PUBLIC STREETS THROUGH THE USE OF CONSTRUCTION SCREENS, FENCES, GATES AND/OR VEGETATION PER TOWN CODE. CONSTRUCTION SCREENING SHALL BE INSTALLED PRIOR TO DEMOLITION AND REMAIN FOR THE DURATION OF THE PROJECT. PORTIONS OF CONSTRUCTION SCREENING MAY BE REMOVED WHEN NECESSARY TO COMPLETE CONSTRUCTION ACTIVITIES AND NEW VEGETATION OR SCREENING IS INSTALLED IMMEDIATELY UPON COMPLETION OF SAID WORK.



PARKER •YANNETT design group, inc.


LANDSCAPE ARCHITECTURE PLANNING • GRAPHICS

4425 Military Trail, Suite 202 Jupiter, Florida 33458

Telephone:(561) 747-5069 Fax: (561) 747-2041 Email: mail@pydg.com

License #LA0001347

DATE: 2024.02.27 DRAWN BY: SJW/JML JOB NO.: 24-021 SCALE: 1" = 10'-0" FILENAME: Valerious 05

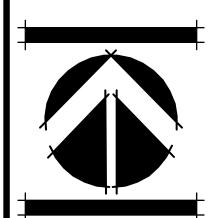



# EXISTING VIEW FROM BRAZILIAN AVENUE



EXISTING CABANA AND POOL



EXISTING VIEW FROM BRAZILIAN AVENUE




EXISTING RESIDENCE AND POOL

design group, inc.


LANDSCAPE ARCHITECTURE PLANNING • GRAPHICS 4425 Military Trail, Suite 202 Jupiter, Florida 33458

Telephone:(561) 747-5069 Fax: (561) 747-2041 Email: mail@pydg.com


License #LA0001347

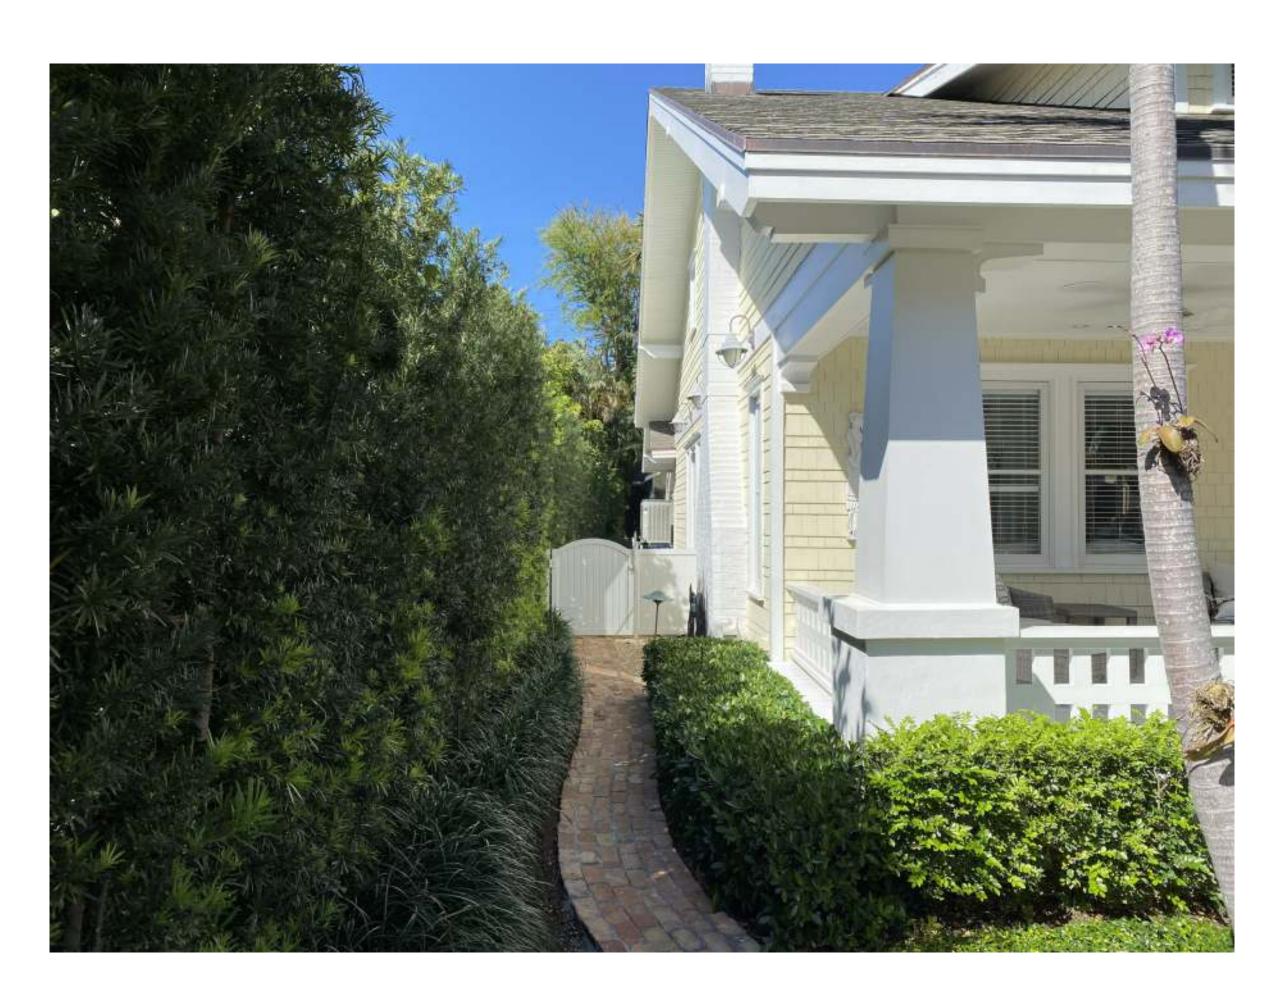


EXISTING WEST SIDE YARD

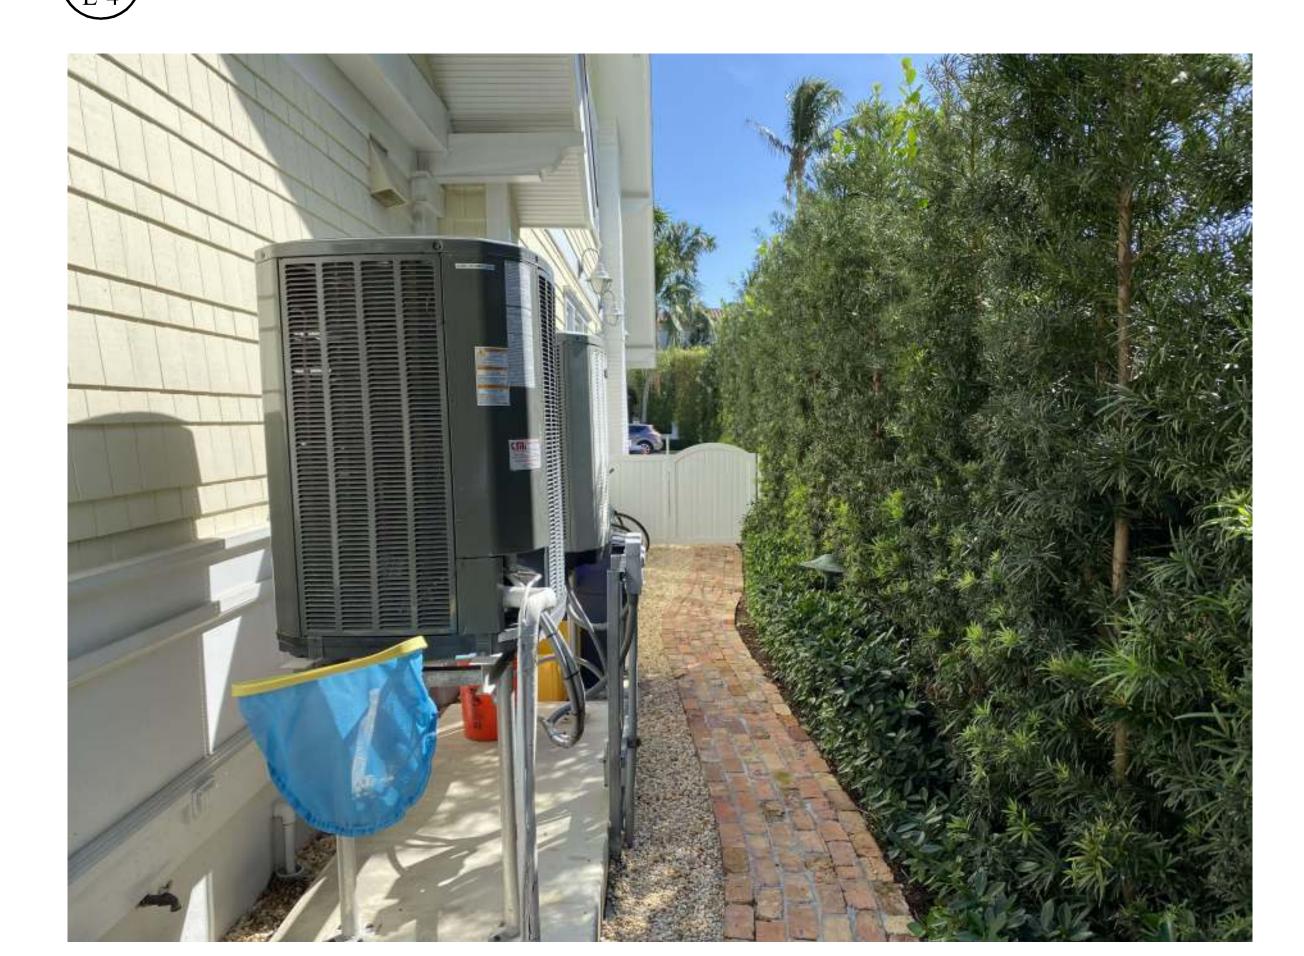

EXISTING WEST SIDE YARD

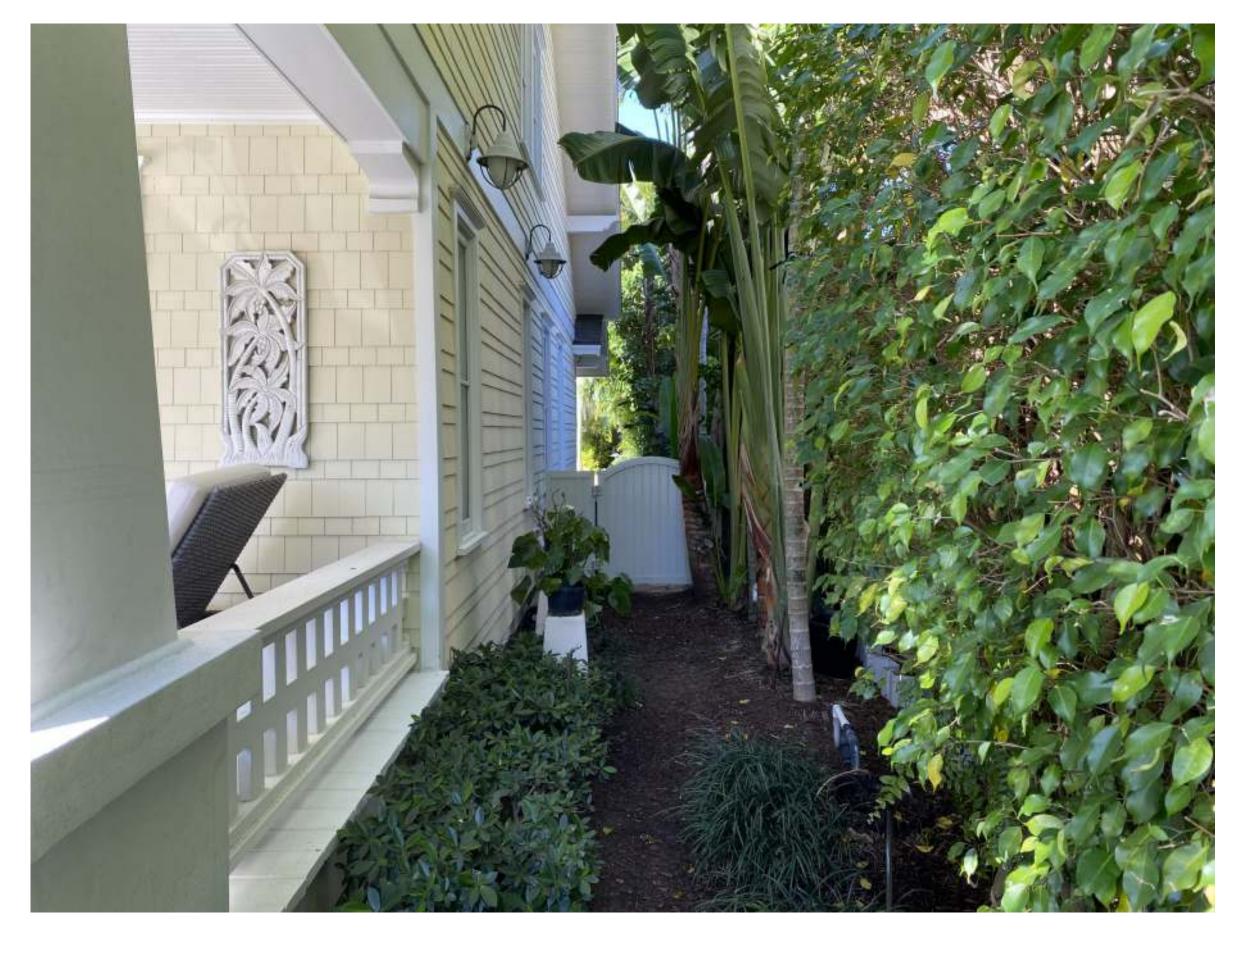

EXISTING EAST SIDE YARD

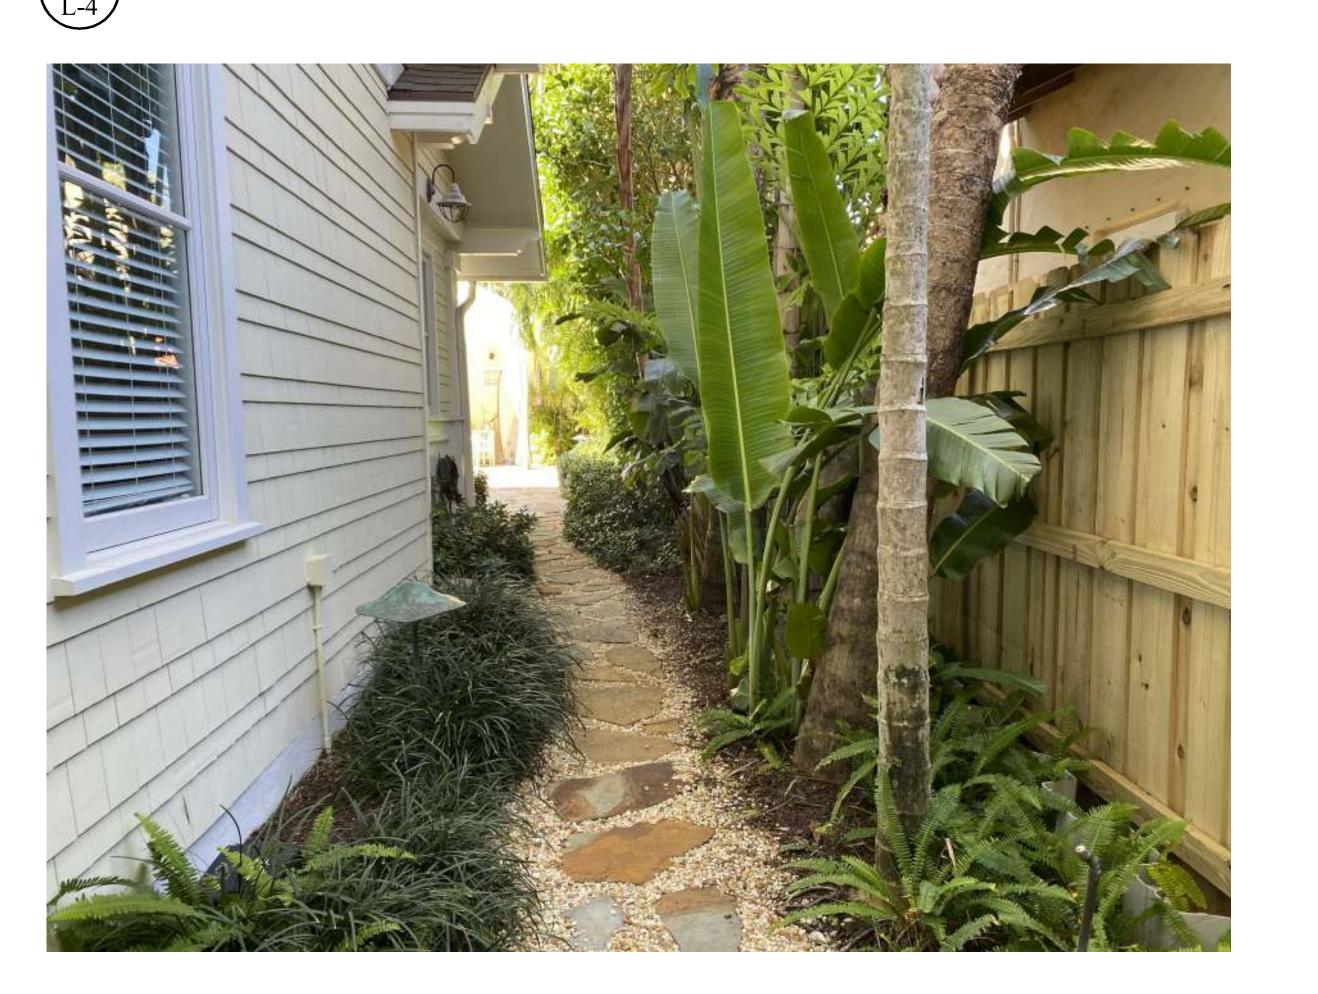


EXISTING EAST SIDE YARD


design group, inc.

LANDSCAPE ARCHITECTURE PLANNING • GRAPHICS 4425 Military Trail, Suite 202 Jupiter, Florida 33458


Telephone:(561) 747-5069 Fax: (561) 747-2041 Email: mail@pydg.com License #LA0001347

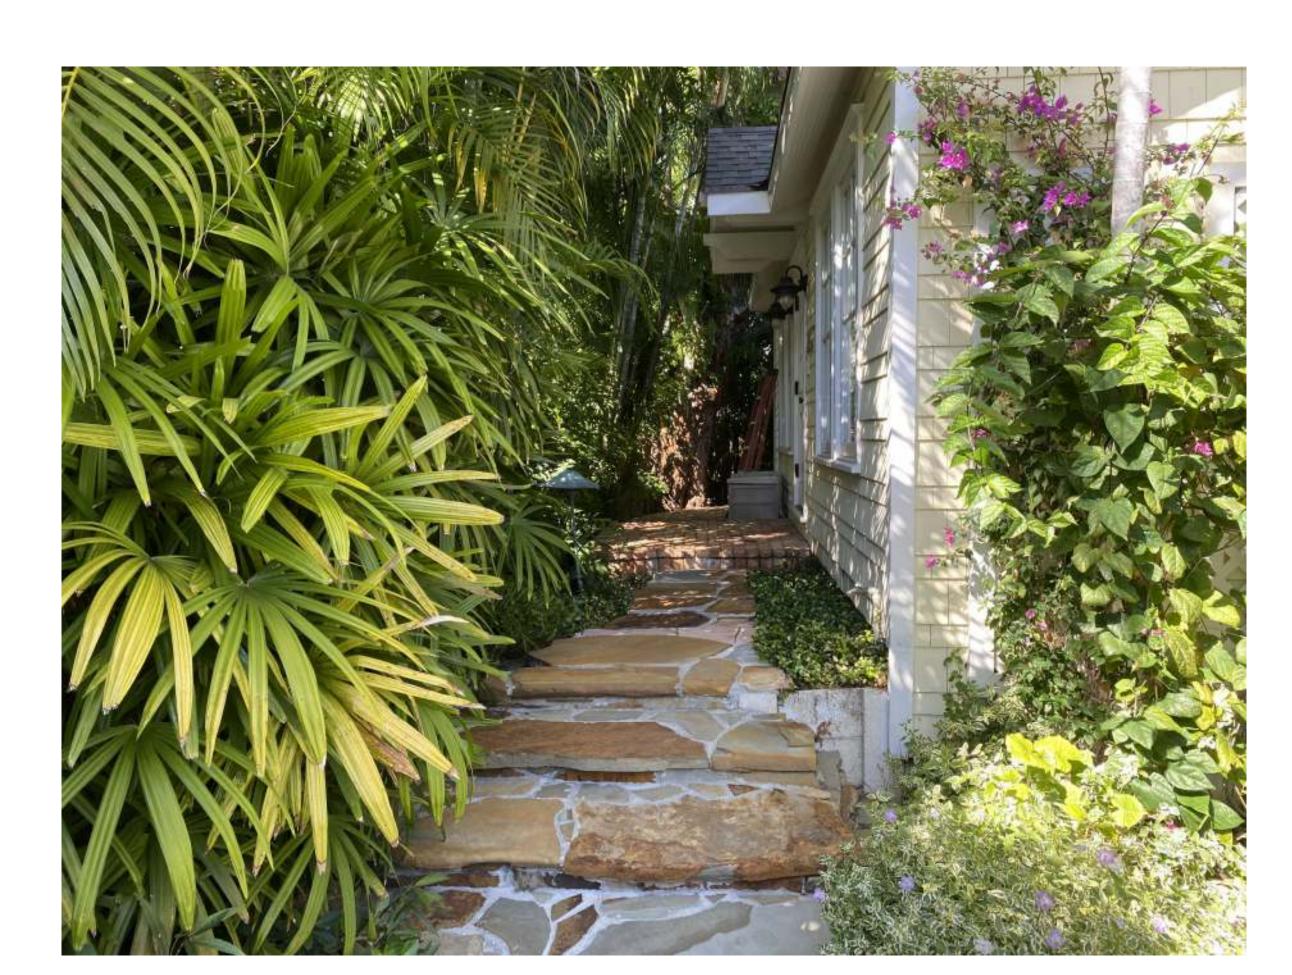

EXISTING WEST SIDE YARD

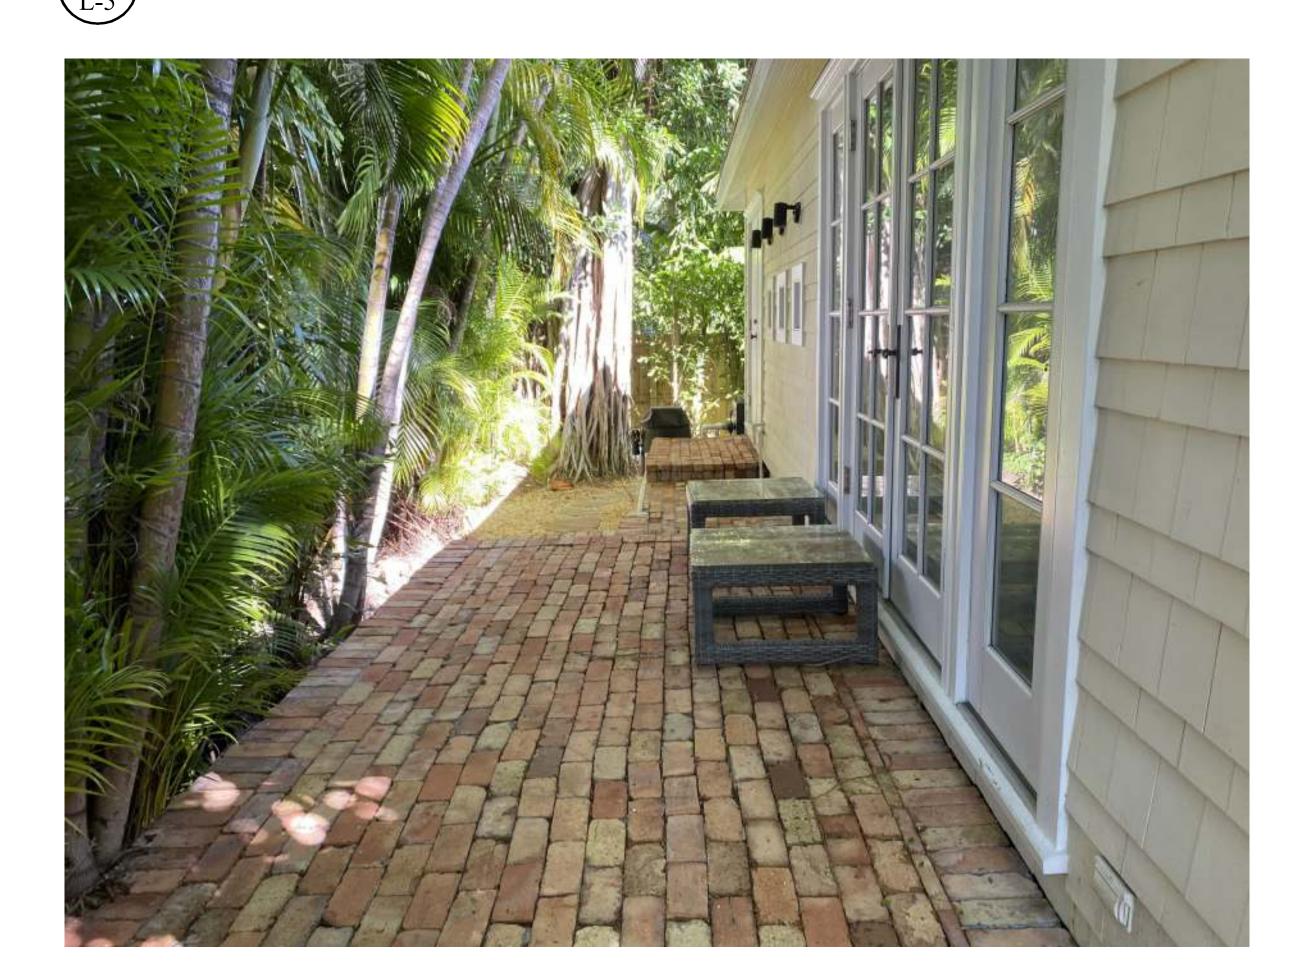

EXISTING REAR BUFFER

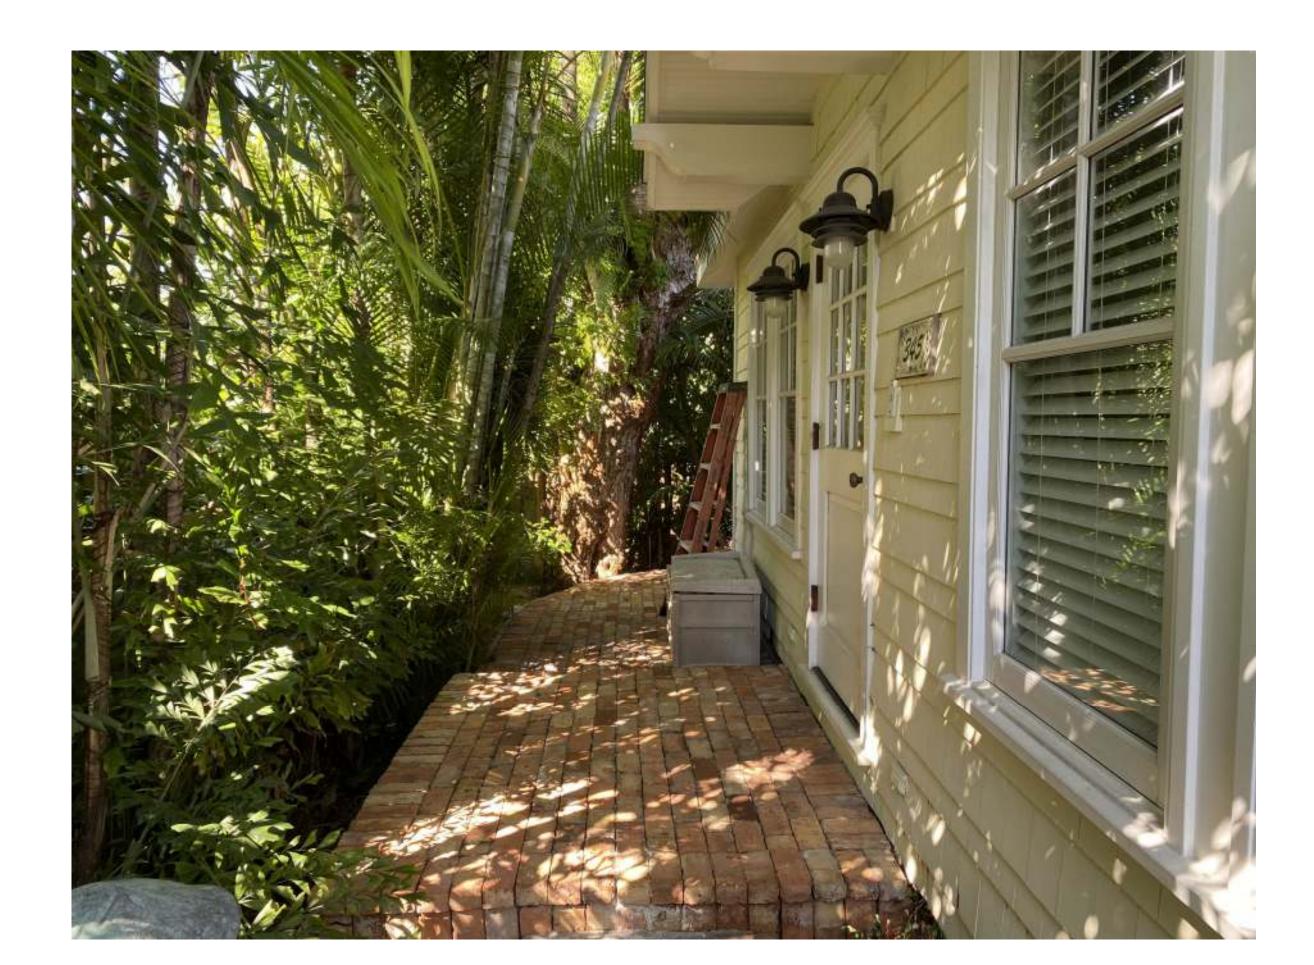

EXISTING WEST SIDE YARD



EXISTING EAST SIDE YARD

design group, inc.

LANDSCAPE ARCHITECTURE PLANNING • GRAPHICS 4425 Military Trail, Suite 202 Jupiter, Florida 33458

Telephone:(561) 747-5069 Fax: (561) 747-2041 Email: mail@pydg.com

License #LA0001347

# Existing Plant Symbol Key



Existing tree/palm to remain for const. buffering. Shall be removed when necessary to complete construction



Existing vegetation to remain for const. buffering.
Shall be removed when necessary to complete construction

# **Existing Plant Key**

AM = Adonidia merrillii / Christmas Palm CG = Clusia guttifera / Small Leaf Clusia

CM = Caryota mitis / Fishtail Palm

DL = Dypsis lutescens / Areca Palm

DS = Dombeya 'Seminole' / Dombeya

FIC = Ficus species FM = Ficus microcarpa / Cuban Laurel

NE = Noronhia emarginata / Madagascar Olive

PE = Ptychosperma elegans / Alexander Palm

PM = Podocarpus macrophyllus / Yew RE = Rhapis excelsa / Lady Palm

RM = Ravenala madagarecariensis / Travelers Tree

UNK = Unidentified Tree

#### Construction Screening Note:

CONSTRUCTION ACTIVITY SHALL BE SCREENED FROM ADJACENT PROPERTIES AND PUBLIC STREETS THROUGH THE USE OF CONSTRUCTION SCREENS, FENCES, GATES AND/OR VEGETATION PER TOWN CODE. CONSTRUCTION SCREENING SHALL BE INSTALLED PRIOR TO DEMOLITION AND REMAIN FOR THE DURATION OF THE PROJECT. PORTIONS OF CONSTRUCTION SCREENING MAY BE REMOVED WHEN NECESSARY TO COMPLETE CONSTRUCTION ACTIVITIES AND NEW VEGETATION OR SCREENING IS INSTALLED IMMEDIATELY UPON COMPLETION OF SAID WORK.






EXISTING WEST BUFFER




 $\widehat{C}$  EXISTING REAR BUFFER

L-6

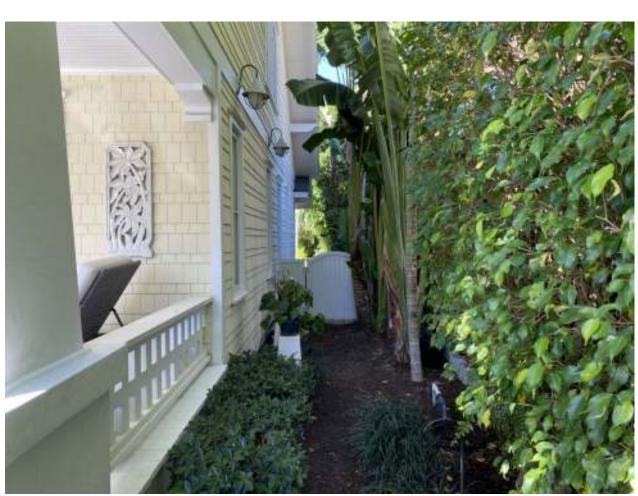

D EXISTING EAST BUFFER

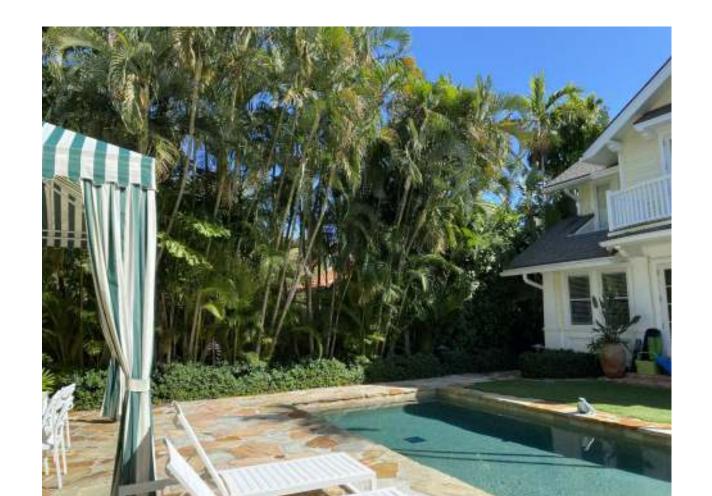

**EXISTING EAST BUFFER** 

.-6



PARKER •YANNETTI design group, inc.

LANDSCAPE ARCHITECTURE PLANNING • GRAPHICS

4425 Military Trail, Suite 202

Jupiter, Florida 33458

Telephone:(561) 747-5069 Fax: (561) 747-2041 Email: mail@pydg.com License #LA0001347

ALTROQUO RTOUDE BRAZILIAN AVENUE M BEACH, FLORIDA

DATE: 2024.02.27


DRAWN BY: SJW/JML

JOB NO.: 24-021

SCALE: 1" = 10'-0"

FILENAME: Valerious 05

REVISIONS: 9.4.24 First Submittal 9.20.24 Second Submittal

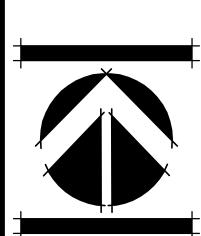

SHEET:

L-6


BRAZILIAN AVENUE

PARKER • YANNETTE design group, inc.

LANDSCAPE ARCHITECTURE PLANNING • GRAPHICS 4425 Military Trail, Suite 202 Jupiter, Florida 33458

Telephone:(561) 747-5069 Fax: (561) 747-2041 Email: mail@pydg.com License #LA0001347

DATE: 2024.02.27 DRAWN BY: SJW/JML JOB NO.: 24-021 SCALE: |" = 10'-0" FILENAME: Valerious 05

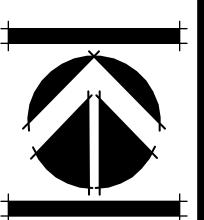

iorth 🔵

## PRELIMINARY CONSTRUCTION SCHEDULE

LANDMARKS PRESERVATION COMMISSION (LPC) MEETING	NOVEMBER 20, 2024
PERMIT DRAWING PREPARATION AND PERMIT REVIEW	DECEMBER 2024 - JANUARY 2025
MOBILIZATION AND DEMOLITION	1 MONTH - COMMENCE FEBRUARY 2025
SITE/BUILDING PREPARATION	1 MONTH
DELIVERIES AND CONCRETE POURS	1 MONTH
FINISHES	2 MONTHS
LANDSCAPE AND HARDSCAPE INSTALLATION	2 MONTHS
FINAL INSPECTIONS	2 MONTHS
CLOSE-OUT	NOVEMBER 2025

## Truck Logistics

- A. Roadways: Deliveries and workers will access Palm Beach by heading east on Okeechobee Boulevard over the Royal Park Bridge. Then head South on Cocoanut Row. Turn East onto Brazilian Avenue. The subject property is on the North side of the road.
- B. Maximum truck length = 30'
- C. Estimated number of deliveries generated by this project = 50

PARKER · YANNETTE


design group, inc.

LANDSCAPE ARCHITECTURE PLANNING • GRAPHICS

4425 Military Trail, Suite 202

Jupiter, Florida 33458

Telephone:(561) 747-5069 Fax: (561) 747-2041 Email: mail@pydg.com License #LA0001347

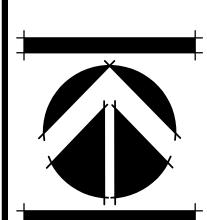

SHEET:

PARKER •YANNETTE design group, inc.

LANDSCAPE ARCHITECTURE PLANNING • GRAPHICS 4425 Military Trail, Suite 202 Jupiter, Florida 33458

Telephone:(561) 747-5069 Fax: (561) 747-2041 Email: mail@pydg.com License #LA0001347

SATURN AVENUE

DATE: 2024.02.27


DRAWN BY: SJW/JML

JOB NO.: 24-021

SCALE: 1" = 10'-0"

FILENAME: Valerious 05

REVISIONS: 9.424 First Submittal 9.20.24 Second Submittal

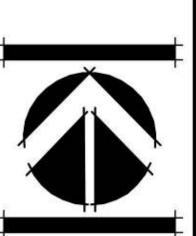

SHEET:

# Existing Plant Symbol Key



Existing tree/palm to remain




Existing tree/palm to be removed



Existing tree/palm to be relocated on site



Existing vegetation to remain

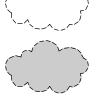

Existing vegetation to be removed

#### **Existing Plant Key**

AM = Adonidia merrillii / Christmas Palm CG = Clusia guttifera / Small Leaf Clusia

CM = Caryota mitis / Fishtail Palm

DL = Dypsis lutescens / Areca Palm

DS = Dombeya 'Seminole' / Dombeya

FIC = Ficus species

FM = Ficus microcarpa / Cuban Laurel NE = Noronhia emarginata / Madagascar Olive

PE = Ptychosperma elegans / Alexander Palm PM = Podocarpus macrophyllus / Yew

RE = Rhapis excelsa / Lady Palm RM = Ravenala madagarscariensis / Travelers Tree

UNK = Unidentified Tree

PARKER • YANNETTI design group, inc.


LANDSCAPE ARCHITECTURE PLANNING • GRAPHICS 4425 Military Trail, Suite 202 Jupiter, Florida 33458

Telephone:(561) 747-5069 Fax: (561) 747-2041 Email: mail@pydg.com License #LA0001347

DRAWN BY: SJW/JML JOB NO.: 24-021 SCALE: 1" = 10'-0"

REVISIONS: 9.4.24 First Submittal 9.20.24 Second Submittal

FILENAME: Valerious 05

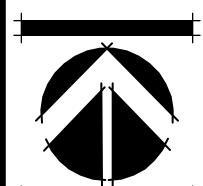

ACCENT LIGHT

WAC 6041

ACCENT LIGHT

# Landscape Lighting Specifications

SYM QTY SPECIFICATION

CAST BRASS ACCENT LIGHT: WAC 5011-27BBR 12V 8W LED, 60° WIDE FLOOD

CAST BRASS ACCENT LIGHT: WAC 5011-27BBR 12V 8W LED, 40° MEDIUM FLOOD

CAST BRASS PATH LIGHT: WAC 6041-27BBR 12V 6.5W LED, TIKI PATH LIGHT

LANDSCAPE LIGHTING DATA:

TOTAL LOT AREA = 9,000 SQ. FT. (0.207 ACRES)

TOTAL LIGHT FIXTURES = 31 TOTAL FIXTURES PER ACRE: 150 (150 MAX.)

TOTAL WATTS PROPOSED (LED) = 2225 WATTS

TOTAL WATTS PER ACRE (LED) = 1,015 WATTS/ACRE (5,000 WATTS/ACRE MAX.) TOTAL WATTS PROPOSED (HALOGEN / INCANDESCENT EQUIVALENT) = 914.5 WATTS

TOTAL WATTS PER ACRE (HALOGEN / INCANDESCENT EQUIVALENT) = 4,708 WATTS/ACRE (5,000 WATTS/ACRE MAX.)


#### LANDSCAPE LIGHTING NOTES:

- MOUNT ALL ABOVE GROUND FIXTURES ON M6000-STAKE. - INSTALL ALL LOW YOLTAGE WIRING IN CONDUIT MINIMUM 12" BELOW GRADE.

- ALL FIXTURES SHALL BE 6'-0" MINIMUM FROM SWIMMING POOL OR OTHER BODY OF WATER. - ALL FIXTURES WITHIN 10'-0" OF POOL SHALL HAVE A TRANSFORMER BASE AND GFCI PROTECTION.

- NO FIXTURE SHALL EXCEED 80 WATTS.

- NO LIGHT BULB OR FIXTURE SHALL BE VISIBLE FROM OUTSIDE OF THE PROPERTY - NO MORE THAN  $1\!\!{}_2$  FOOT-CANDLE OF LIGHT SHALL BE REFLECTED OFF OF THE PROPERTY.

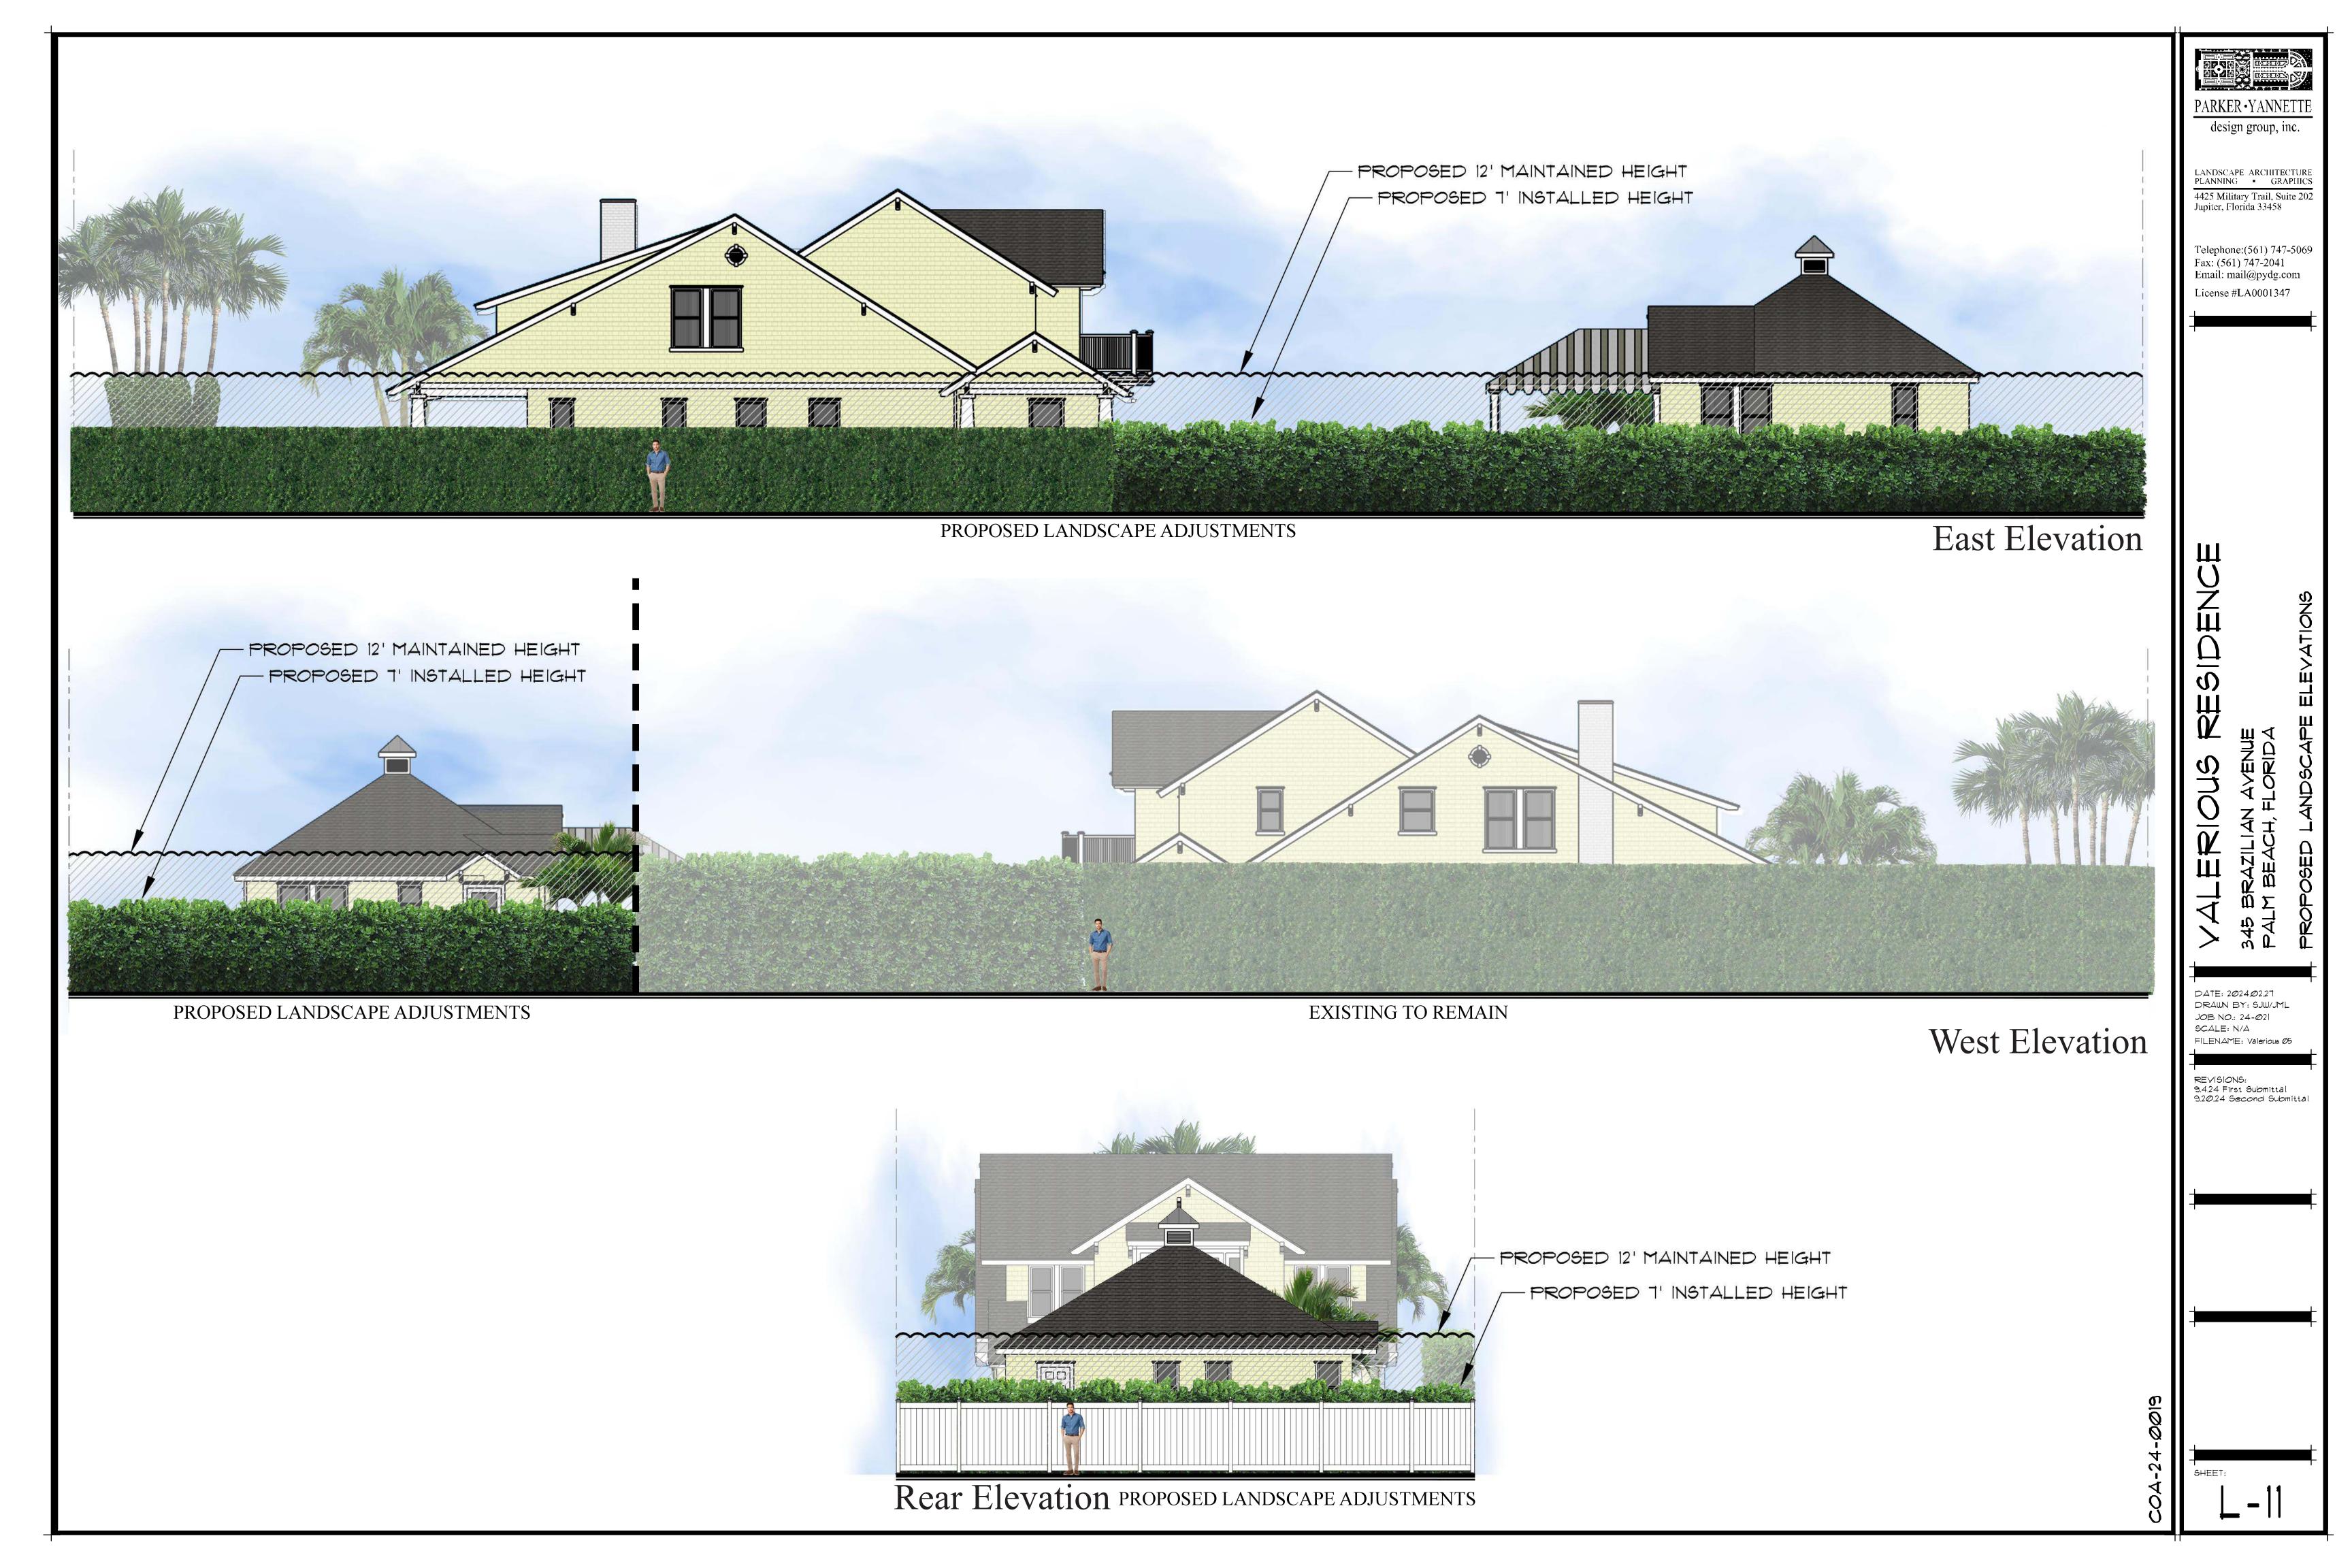

# Plant List

SYM	_QTY_	NAME	SPECIFICATIONS				
PALMS							
AM	1	Adonidia merrillii / Christmas Palm	10' ht., triple stem, full frond				
SHRUBS and VINES							
CGT	52	Clusia guttifera / Small Leaf Clusia	25 gal., $7' \times 3^{1/2}'$ , full to base				
CV	21	Codiaeum variegatum 'Excellent'	3 gal., 20" x 18", full				
FGI	98	Ficus 'Green Island' / Green Island Ficus	3 gal., 12" x 12", full				
$\perp$ M	20	Liriope muscari / Liriope	3 gal., 16" x 16", full				
PM3	16	Podocarpus macrophyllus / Yew	7 gal., 36" x 18", full to base				
	48	Podocarpus macrophyllus / Yew	25 gal., 7' x 30", full to base				
RB	24	Ruellia brittoniana / Mexican Bluebell	3 gal., 22" x 22", full				
MISCELLANEOUS							
MULCH		Chocolate Brown	3" depth, 100% coverage in all plant beds				
SOD		Zeon Zoysia or alternate approved by Landscape Architect	Solid sod, laid tight, rolled for compaction Fine grade and install 80/20 mix of 80% coarse sand and 20% Canadian peat, 2"-3" thick over existing soil prior to laying sod				



#### **Town of Palm Beach**

Planning Zoning and Building 360 S County Rd Palm Beach, FL 33480 www.townofpalmbeach.com

Line #	Landscape Legend			
1	Property Address:	345 Brazilian Avenue		
2	Lot Area (sq. ft.):	9,000 sq. ft.		
3		REQUIRED	PROPOSED	
4	Landscape Open Space (LOS) (Sq Ft and %)	4,050 sq. ft. / 45%	3,767 sq. ft. / 41.9%	
5	LOS to be altered (Sq FT and %)	N/A	1,814sq. ft. / 49.1%	
6	Perimeter LOS (Sq Ft and %)	2,025 sq. ft. / 50%	2,909 sq. ft. / 71.8%	
7	Front Yard LOS (Sq Ft and %)	500 sq. ft. / 40%	659 sq. ft. / 52.7%	
8	Native Trees %	30% (number of trees)	N/A	
9	Native Shrubs & Vines %	30% (number of shrubs & vines)	N/A	
10	Native Groundcover %	30% (groundcover area)	N/A	

To determine qualifying native vegetation use either:

the Institute for Regional Conservation Natives for Your Neighborhood FL Statewide Plant List

DADVED VANNETTE

PARKER • YANNETTI design group, inc.

LANDSCAPE ARCHITECTURE PLANNING • GRAPHICS

4425 Military Trail, Suite 202
Jupiter, Florida 33458

Telephone:(561) 747-5069 Fax: (561) 747-2041 Email: mail@pydg.com License #LA0001347

> ALERIOUS RESIDENC 45 BRAZILIAN AVENUE

FILENAME: Valerious 05

REVISIONS:
9.4.24 First Submittal
9.20.24 Second Submittal

DATE: 2*0*24.02.27 DRAWN BY: SJW/JML

JOB NO.: 24-021 SCALE: N/A

--SHEET

### Plant Specifications

SPECIES AND SIZE shall conform to those indicated on the drawings. Nomenclature shall conform to STANDARDIZED PLANT NAMES, current edition. All nursery stock shall be in accordance with Grades and Standards for Nursery Plants Parts [ 4 il, latest edition published by the Florida Department of Agriculture and Consumer Services. All plants not otherwise specified as being Florida Fancy or Specimen, shall be Florida Grade Number I or better as determined by the Florida Division of Plant Industry. Specimen means an exceptionally heavy, symmetrical, tightly knit plant, so trained or favored in its development that first appearance is unquestionable and outstandingly superior in form, number of branches, compactness and symmetry.

#### GENERAL REQUIREMENTS

All plants shall be freshly dug, sound, healthy, vigorous, well branched, and free of disease and insect eggs and larvae, and shall have adequate root systems. Trees for planting rows shall be uniform in size and shape. All materials shall be subject to approval by the Landscape Architect. Where any requirements are omitted from the plant list, the plants furnished shall be normal for the variety. Plants shall be pruned prior to delivery only upon the approval of the Landscape Architect.

#### CONTAINER GROWN STOCK

All container grown material shall be healthy, vigorous, well rooted plants, and established in the container in which they are sold. The plants shall have tops which are good quality and in a healthy growing condition. An established container grown plant shall be grown in that container sufficiently long enough for the new fibrous roots to have developed so that the root mass will retain its shape and hold together when removed from the container. Plant root bound in containers are unacceptable.

#### MEASUREMENTS

Height shall be measured from ground to the average height of canopy. Spread shall be measured to the end of branching equally around the crown from the center of the trunk. Measurements are not to include any terminal growth. Single trunk trees shall be free of "V' crotches that could be points of weak limb structure or disease infestation.

Shrubs: Heights shall be measured from the ground to the average points where mature plant growth stops. Spread shall be measured to the end of branching equally around the shrub mass. Measurements are not to include any terminal growth.

Palms: Clear Trunk (C.T.), shall be measured from the ground at the time of installation to the point where the mature aged trunk joins the immature or green portion of the trunk or the head.

Overall height (O.H.), shall be measured from the ground at the time of installation to a point three quarters the length of the unopened bud. Palms with marred or burned trunks will not be accepted.

#### SOIL

Planting soil for use in preparing backfill for plant pits shall be added at a rate of seventy-five (75%) percent to twenty-five (25%) percent existing soil. This soil mix shall be used in all plant pits except Sabal palms which shall be backfilled with clean sand. Planting soil shall be a fertile, friable natural topsoil or loamy character. It shall contain forty (40) to fifty (50) percent decomposed organic matter and shall be free from heavy clay, stones, lime, plants, roots or other foreign materials or noxious grasses (such as Bermuda or nut grass) and noxious weeds. It shall not contain toxic substances which may be harmful to plant growth.

#### COMMERCIAL FERTILIZER

Two fertilizer shall be used in all types of plantings, except palms. Granular fertilizer shall be uniform in composition, dry and free flowing. This fertilizer shall be delivered to the site in the original unopened bags, each bearing the Manufacturer's statement of analysis, and shall meet the following requirements: sixteen (16%) percent nitrogen, seven (7%) percent phosphorus, twelve (12%) percent potassium, plus iron. Tablet fertilizer ('Agriform' or equal) in 21 gram size shall meet the following requirements: twenty (20%) percent nitrogen, ten (10%) percent phosphorous, five (5%) percent potassium.

#### The two fertilizers will be applied at the following rates:

PLANT SIZE 16-7-12 "AGRIFORM" TABLET (21 Grame)

1 gal.	1/4 ال	1
3 gal.	1/3 lb.	2
7-15 gal.	1/2 lb.	4
1"-6" caliper	2 lbs/1" caliper	2/1' caliper
6" and larger	3 lbs/l' caliper	2/1" caliper

"Florida East Coast Palm Special' will be applied to all palms at installation at a rate of 1/2 lb. per inch of trunk caliper unless otherwise specified.


#### Mulch material

SUBSTITUTIONS

Mulch material shall be three (3) inches of shredded melaleuca mulch (sterilized and free of seeds) or approved equal, moistened at the time of application to prevent wind displacement.


No substitutions of plant material types or size will be allowed without written consent of the Landscape Architect. B4B material will not be accepted as substitute for container grown material unless previously approved. Alternate substitutions shall be indicated in bid.

### Planting Details

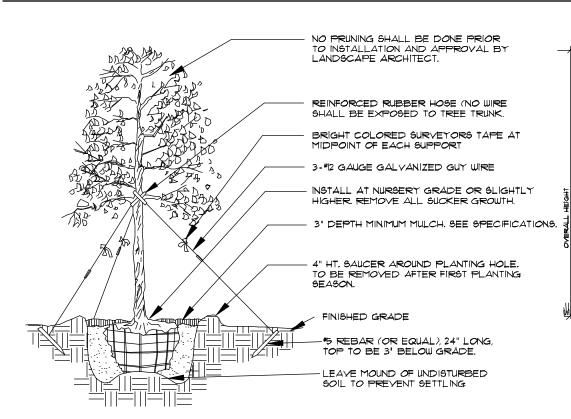


#### Tree Planting

SEE SPECIFICATIONS FOR BACKFILL MIXTURE AND FERTILIZATION
 BRACING - SPECIAL SITE CONDITIONS MAY REQUIRE MODIFICATION TO BRACING TECHINQUE.
LANDSCAPE CONTRACTOR WILL ADEQUATELY BRACE (OR WIRE) ALL TREES TO PREVENT
EXCESSIVE MOVEMENT & MAINTAIN A VERTICAL POSITION.

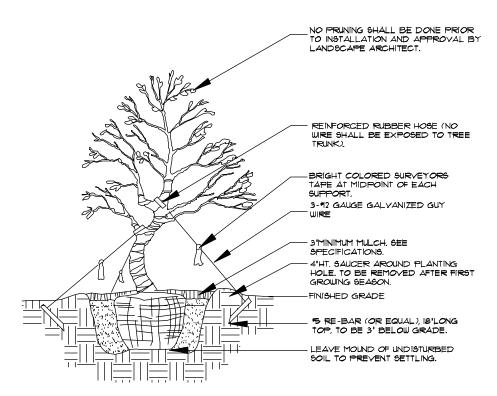

# Irregular & Multi-Stem Tree Planting FOR TREES 6'-14'HT.

NOTES:
SEE SPECIFICATIONS FOR BACKFILL MIXTURES AND FERTILIZATION.
SEACING-SPECIAL SITE CONDITIONS MAY REQUIRE MODIFICATION TO BRACING TECHNIQUE. LANDSCAPE CONTRACTOR WILL ADEQUATELY BRACE (OR WIRE) ALL TREES TO PREVENT EXCESSIVE MOVEMENT AND MAINTAIN A VERTICAL POSITION.

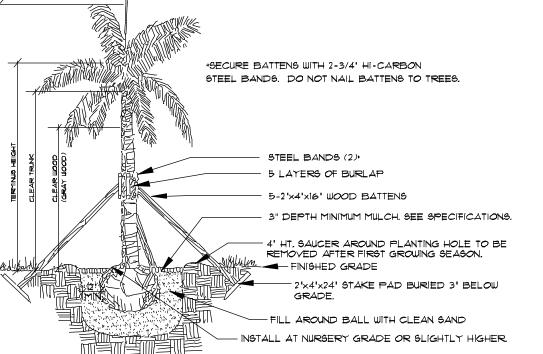


#### Palm Planting

APPLIES TO: ROYAL PALMS, QUEEN PALMS, ALEXANDER PALMS, MANILA PALMS.


\* SEE SPECIFICATIONS FOR BACKFILL MIXTURE AND FERTILIZATION

\* BRACING: SPECIAL SITE CONDITIONS MAY REQUIRE MODIFICATION TO BRACING TECHNIQUE. LANDSCAPE CONTRACTOR WILL ADEQUATELY BRACE ALL PALMS TO PREVENT EXCESSIVE MOVEMENT AND MAINTAIN A VERTICAL POSITION.

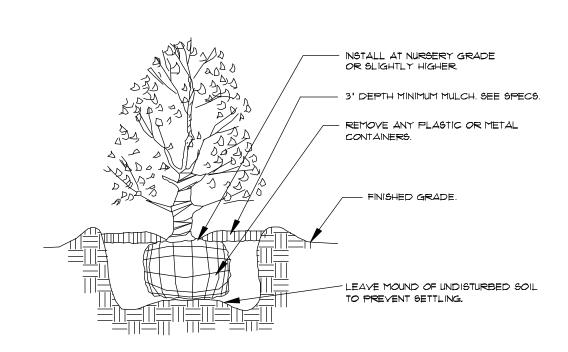

#### Shrub Planting


\* SEE SPECIFICATIONS FOR BACKFILL MIXTURE AND FERTILIZATION.

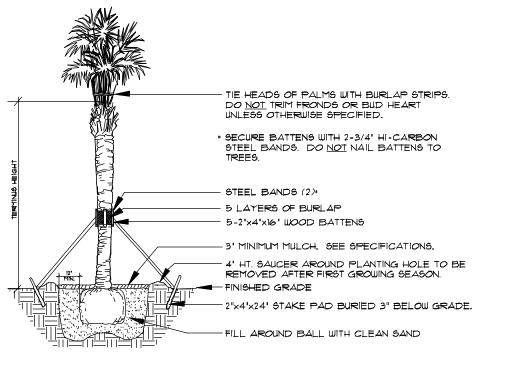

#### Palm Planting

APPLIES TO: SABAL PALMS, WASHINGTON PALMS, CANARY ISLAND DATE PALMS, SENEGAL DATE PALMS

• SEE SPECIFICATIONS FOR BACKFILL MIXTURE AND FERTILIZATION

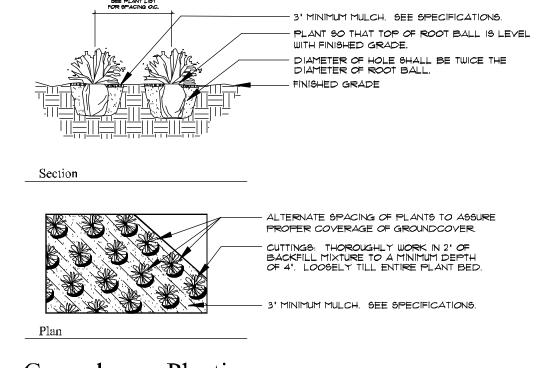

#### Groundcover Planting

· SEE SPECIFICATIONS FOR BACKFILL MIXTURE AND FERTILIZATION.

#### Notes

- Prior to the installation of any plant material all existing and imported soils shall be tested and amended to meet the soil specifications and specific plant needs as shown on this plan.
- All plant material, unless specified as being Florida Fancy or Specimen, shall be Florida Grade Number 1 or better as determined by the Florida Division of Plant Industry.
- All plant materials and sod shall have an automatic irrigation system providing 100% coverage. Said system shall consist of an automatic or electronic sensing device or switch that will override the irrigation cycle of the sprinkler system when adequate rainfall has occurred.

   Maintain positive drainage away from residence.
- All plant material shall be planted, fertilized and mulched as per the Plant Details and Plant Specifications noted on this plan.
- Landscape Contractor shall research plans and contact appropriate agencies to determine location of utilities and obstructions prior to commencing work. Any utilities or unanticipated obstructions shall be reported immediately to the Landscape Architect.
- Landscape Contractor will be responsible for obtaining all necessary permits, licenses, inspections, and insurance as required by the State and local agencies.
- Invasive species, including Brazilian Pepper, Australian Pine, Melaleuca, Snake Plant, Scaevola and Earleaf Acacia shall be eradicated in the development area and removed from the site.

DARKER VANNETTE

design group, inc.

LANDSCAPE ARCHITECTURE PLANNING • GRAPHICS

4425 Military Trail, Suite 202

Jupiter, Florida 33458

Telephone:(561) 747-5069 Fax: (561) 747-2041 Email: mail@pydg.com License #LA0001347

AALEROOUS RESIDENCE

S45 BRAZILIAN AVENUE

PALM BEACH, FLORIDA

DRAWN BY: SJW/JML

FILENAME: Valerious 05

9.4.24 First Submittal

9.20.24 Second Submittal


JOB NO: 24-021

SCALE: N/A

REVISIONS:

2A-24-0019

<u>L</u>-13

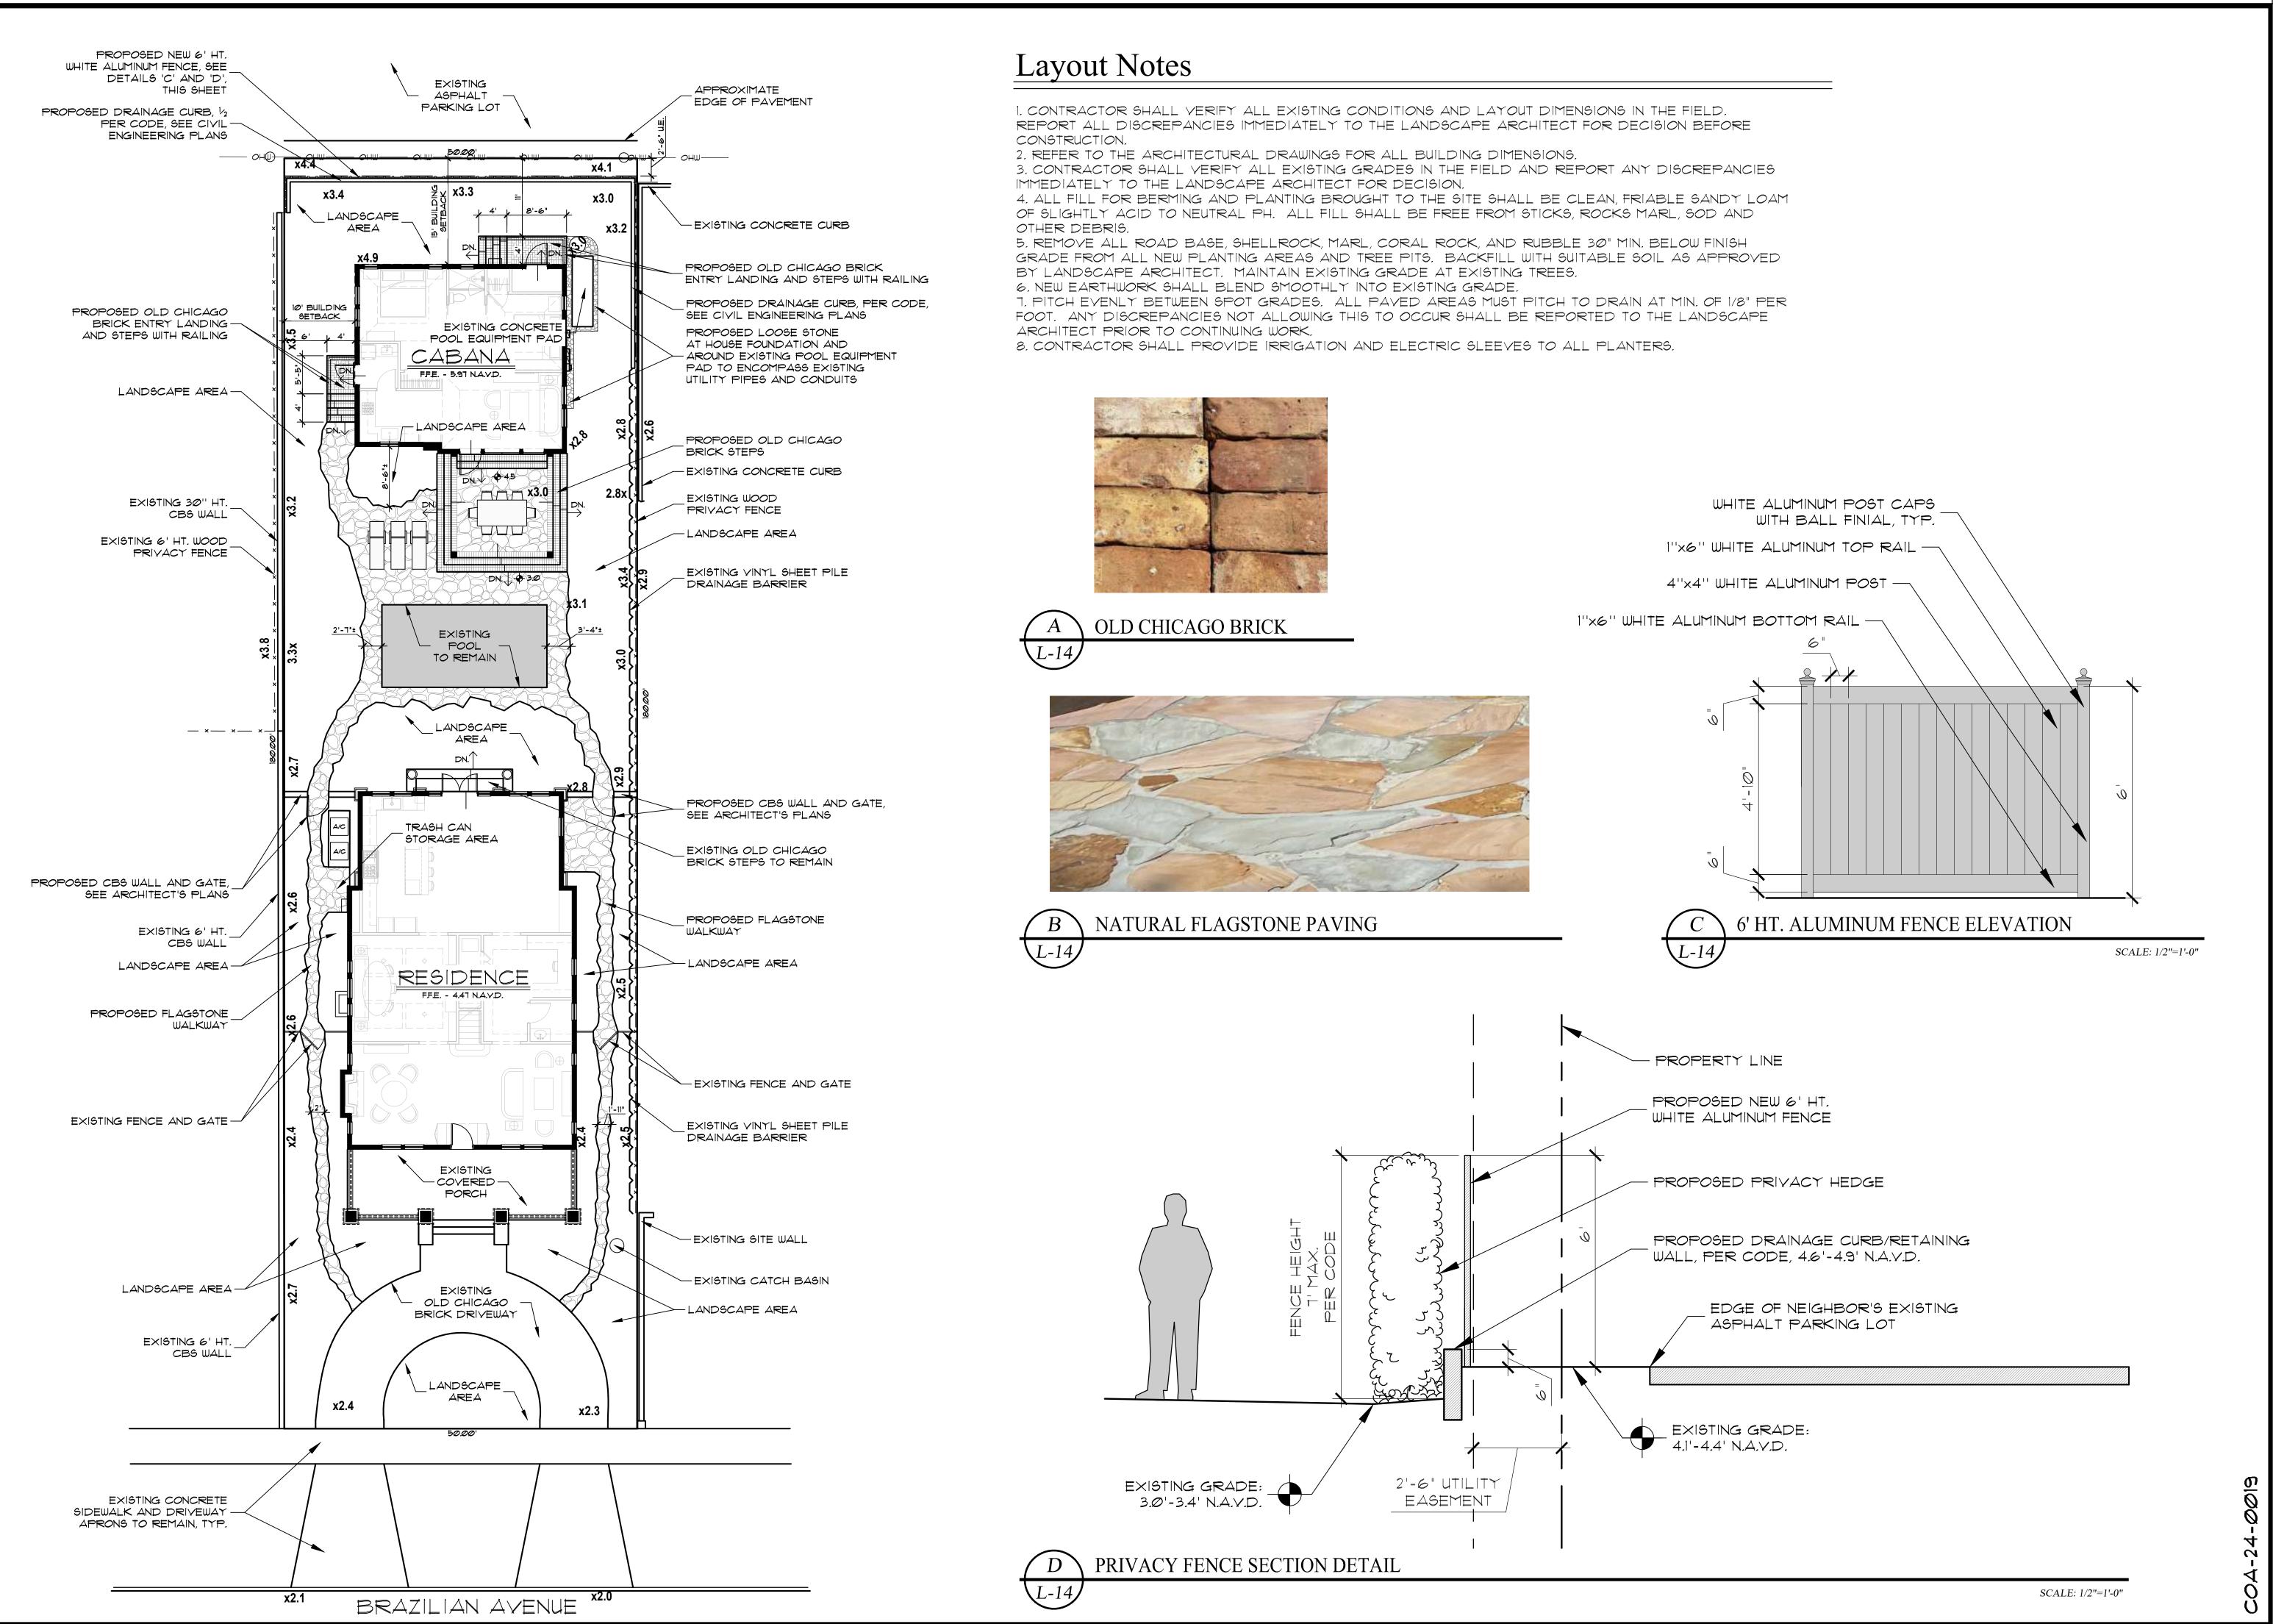

PARKER • YANNET design group, inc.


LANDSCAPE ARCHITECTURE PLANNING • GRAPHICS 4425 Military Trail, Suite 202 Jupiter, Florida 33458

Telephone:(561) 747-5069 Fax: (561) 747-2041 Email: mail@pydg.com


License #LA0001347

DATE: 2024.02.27 DRAWN BY: SJW/JML JOB NO.: 24-021 SCALE: 1" = 10'-0" FILENAME: Valerious 05

REVISIONS: 9.4.24 First Submittal 9.20.24 Second Submittal

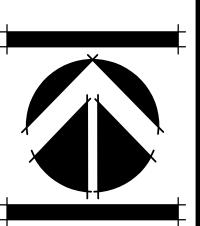

. **- |4** 

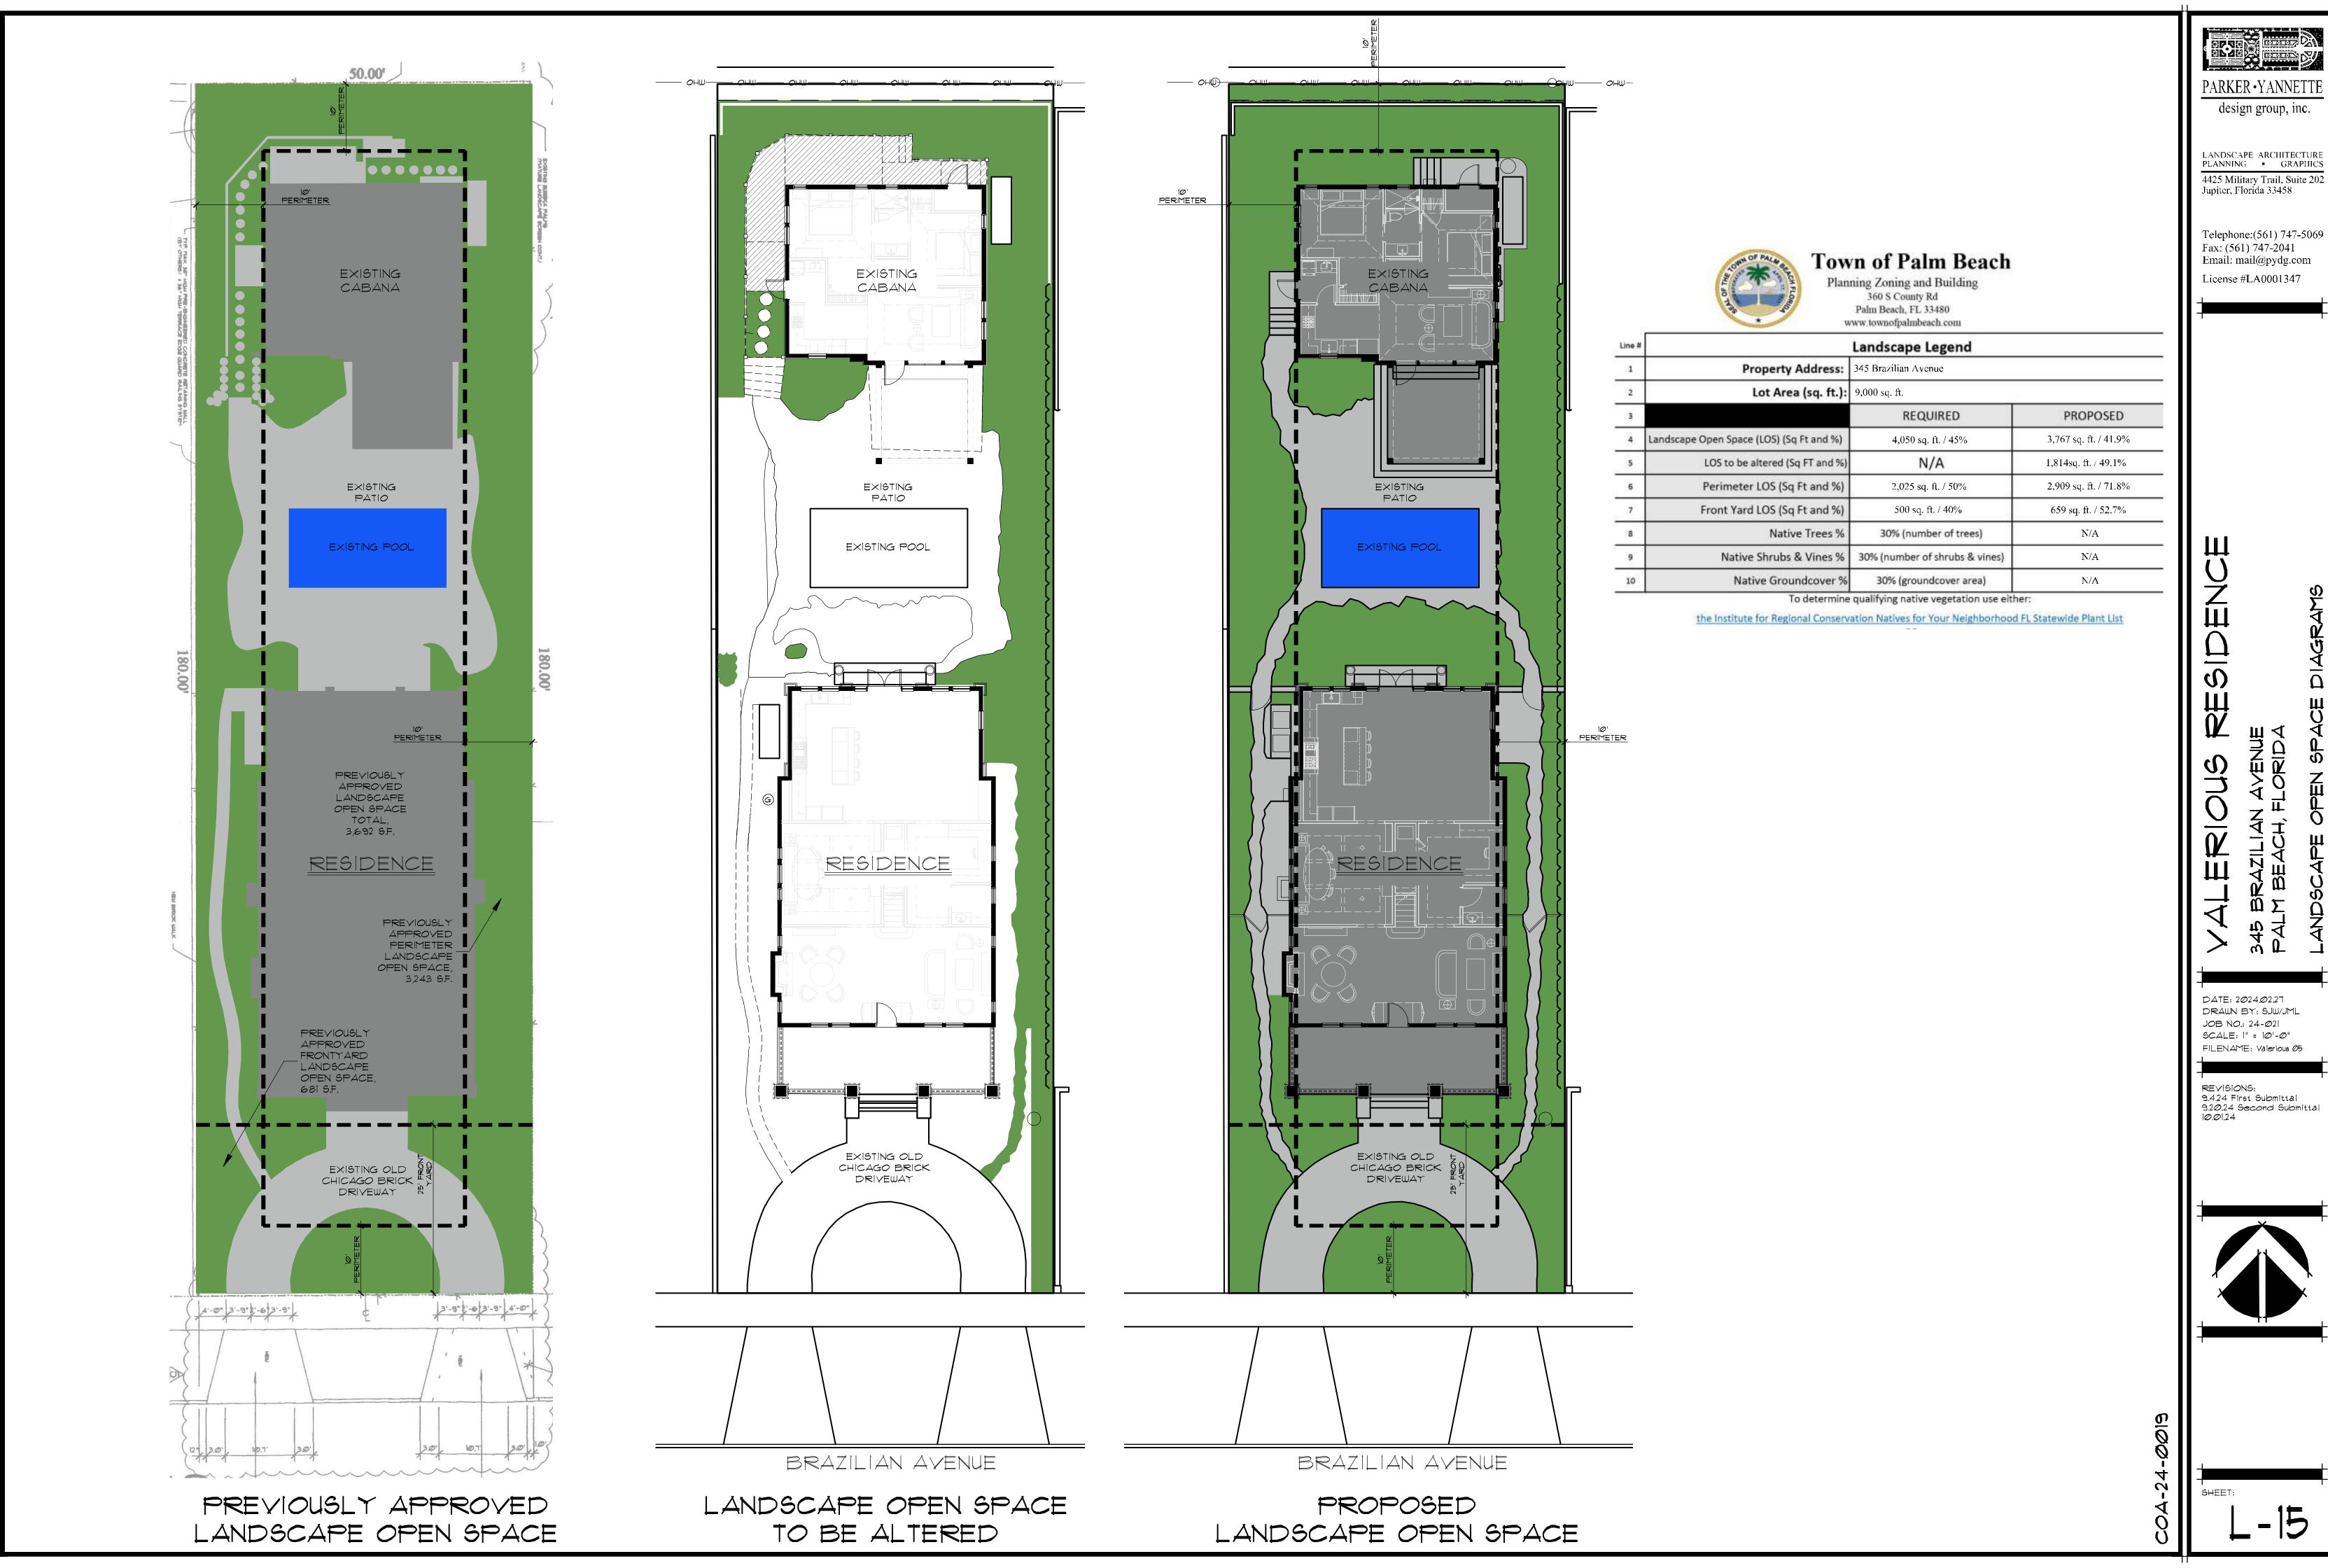

design group, inc.

LANDSCAPE ARCHITECTURE PLANNING • GRAPHICS

Telephone:(561) 747-5069

