

JACQUELINE ALBARRAN, P REGISTERED ARCHITECT 1170

REVISIONS:

SHEET NUMBER:

DATE: 05-10-24 JOB # 0451

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SURVEY

BOUNDARY, TOPOGRAPHIC AND EASEMENT SURVEY

ARCHITECT:

SKA Architect + Planner

Attn: Jacqueline Albarran 324 Royal Palm Way Suite 227

Palm Beach, Fl 33480 (561) 655 - 7676

LANDSCAPE ARCHITECT


SMI Landscape Architecture Inc. Attn: Jorge Sanchez 140 Royal Palm Way Suite 206

Palm Beach, FI 33480 (561) 655-9006

CONSULTING SURVEYORS:

Wallace Surveying

5553 Village Blvd. West Palm Beach, FL 33407 (561) 640-4551

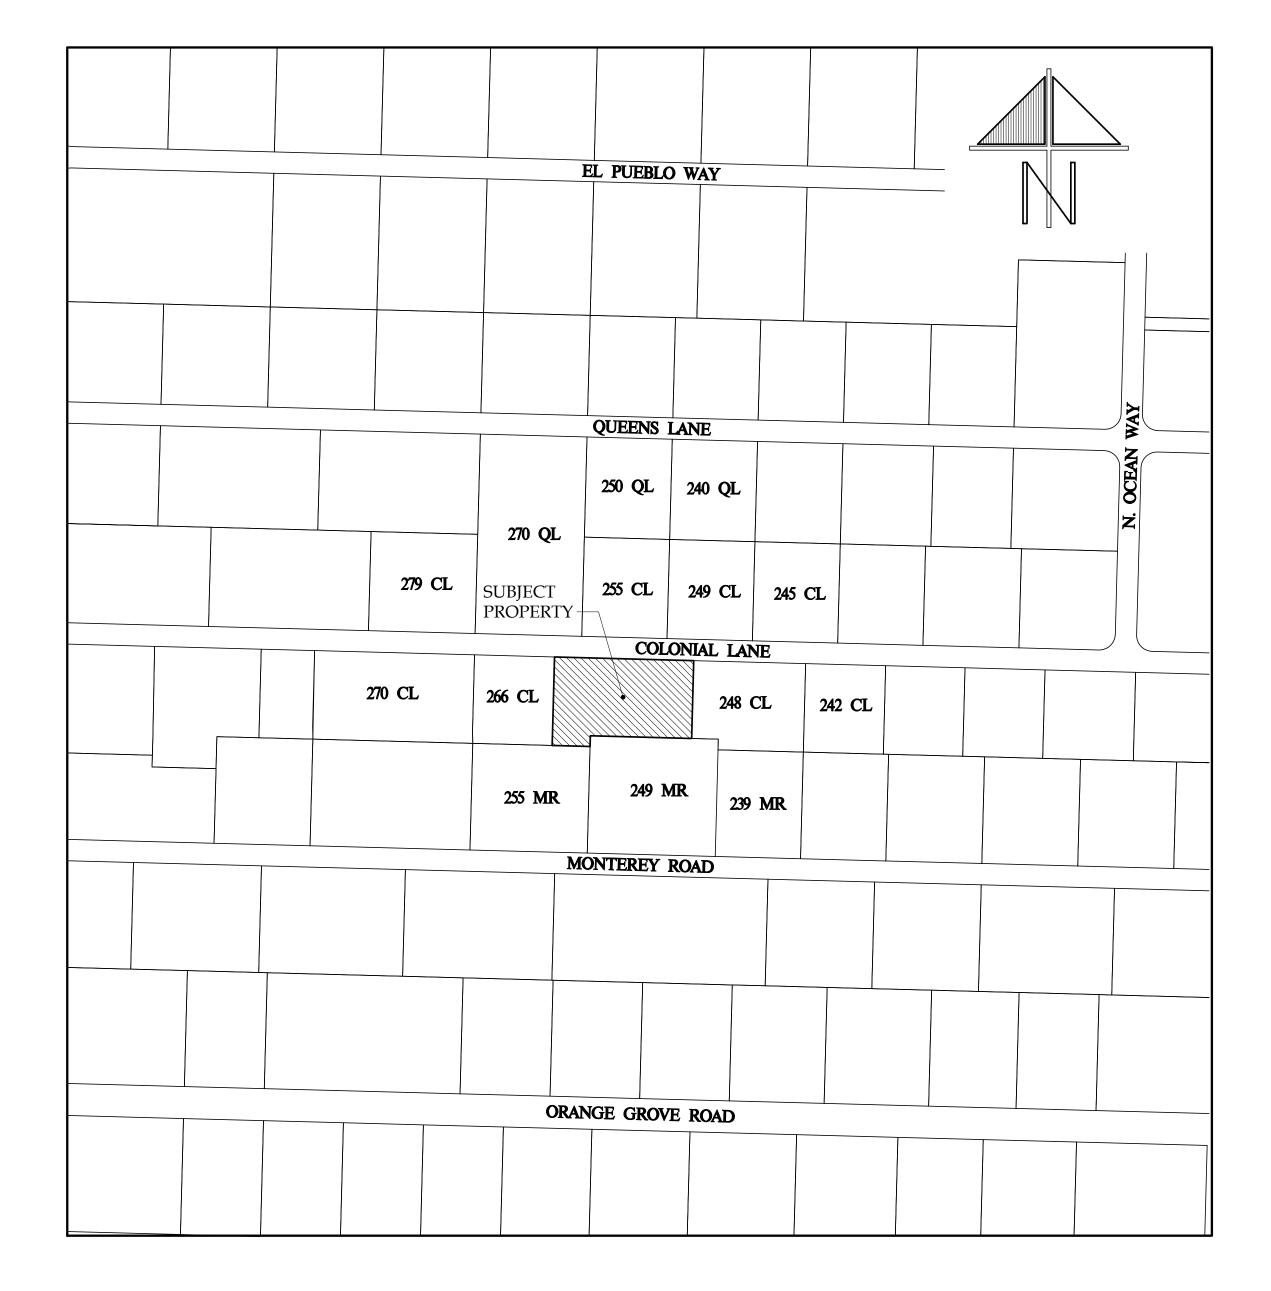



SCOPE OF WORK

- WE ARE PROPOSING TO CONSTRUCT A NEW ONE—STORY BERMUDA STYLE SINGLE FAMILY RESIDENCE WITH A SWIMMING POOL.
- AN EXISTING HOUSE AND POOL ON THE SITE WILL BE DEMOLISHED.
- THE EXISTING PERIMETER CLUSIA HEDGE WILL REMAIN. ALL OTHER LANDSCAPING WILL BE REMOVED AND NEW LANDSCAPING WILL BE INSTALLED.
- A VARIANCE IS BEING REQUESTED TO CONSTRUCT THE POOL WITH A 5' REAR SETBACK IN LIEU OF THE REQUIRED 10' SETBACK.
- A SPECIAL EXCEPTION IS REQUIRED DUE TO AN EXISTING LOT DEPTH OF 72' AND 82' IN LIEU OF THE MINIMUM REQUIRED 100' DEPTH.

Line #	ZONING LEGEND				
1	PROPERTY ADDRESS	260 COLONIAL LN. PALM BEACH, FLORIDA			
2	ZONING DISTRICT	R-B			
3	LOT AREA (SQ. FT.)	9,710			
4	LOT WIDTH (W) & DEPTH (D) (FT.)	9,710			
5	STRUCTURE TYPE	SINGLE-FAMILY			
6	FEMA FLOOD ZONE DESIGNATION	AE (EL 6)	AE (EL 6)		
7	ZERO DATUM FOR POINT OF MEAS. (NAVD)	+7.0'			
8	CROWN OF ROAD (COR) (NAVD)	+3.25'			
9		REQUIRED/PERMITTED	EXISTING	PROPOSED	
10	LOT COVERAGE (SQ. FT. AND %)	3,884.0 MAX. (40%)	N/A	3,398.37 (35%)	
11	ENCLOSED SQUARE FOOTAGE		N/A	3,171	
12	FRONT YARD SETBACK	25.00 MIN.	N/A	25.00	
13	SIDE YARD SETBACK (1 STORY)	12.50 MIN. (E & W)	N/A	12.50 (E & W)	
14	SIDE YARD SETBACK (2 STORY)	N/A	N/A	N/A	
15	REAR YARD SETBACK	10.00 MIN.	N/A	10.00	
16	ANGLE OF VISION (DEGREE)	112	N/A	112	
17	BUILDING HEIGHT	14.00'	N/A	10.00'	
18	OVERALL BUILDING HEIGHT	22.00'	N/A	19.125'	
19	CUBIC CONTENT RATIO (CCR)	4.03	N/A	3.24	
20	MAX. FILL ADDED TO SITE (FT.)	1.875	N/A	1.66	
21	FINISH FLOOR ELEVATION (FFE) (NAVD)	+7.00' NAVD	N/A	+7.00' NAVD	
22	BASE FLOOD ELEVATION (BFE) (NAVD)	+7.00' NAVD	N/A	+7.00' NAVD	
23	LANDSCAPE OPEN SPACE (LOS)	4,370 MIN. (45%)	N/A	4,392 SQ. FT. (45%	
24	PERIMETER (LOS)	2,185 MIN. (50%)	N/A	2,934 SQ. FT. (67%	
25	FRONT YARD (LOS)	1,300 MIN. (40%)	N/A	1,827 SQ. FT. (56%	



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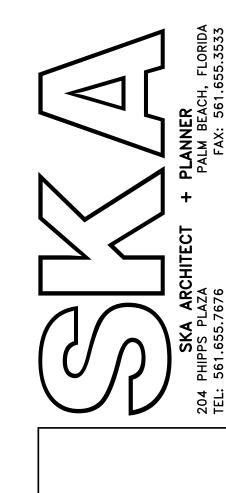
FINAL SHEARING:

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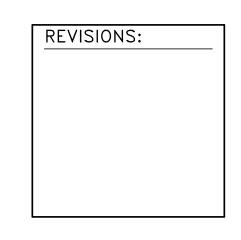




HUNT RESIDENCE
260 COLONIAL LANE



JACQUELINE ALBARRAN, PA REGISTERED ARCHITECT 11701



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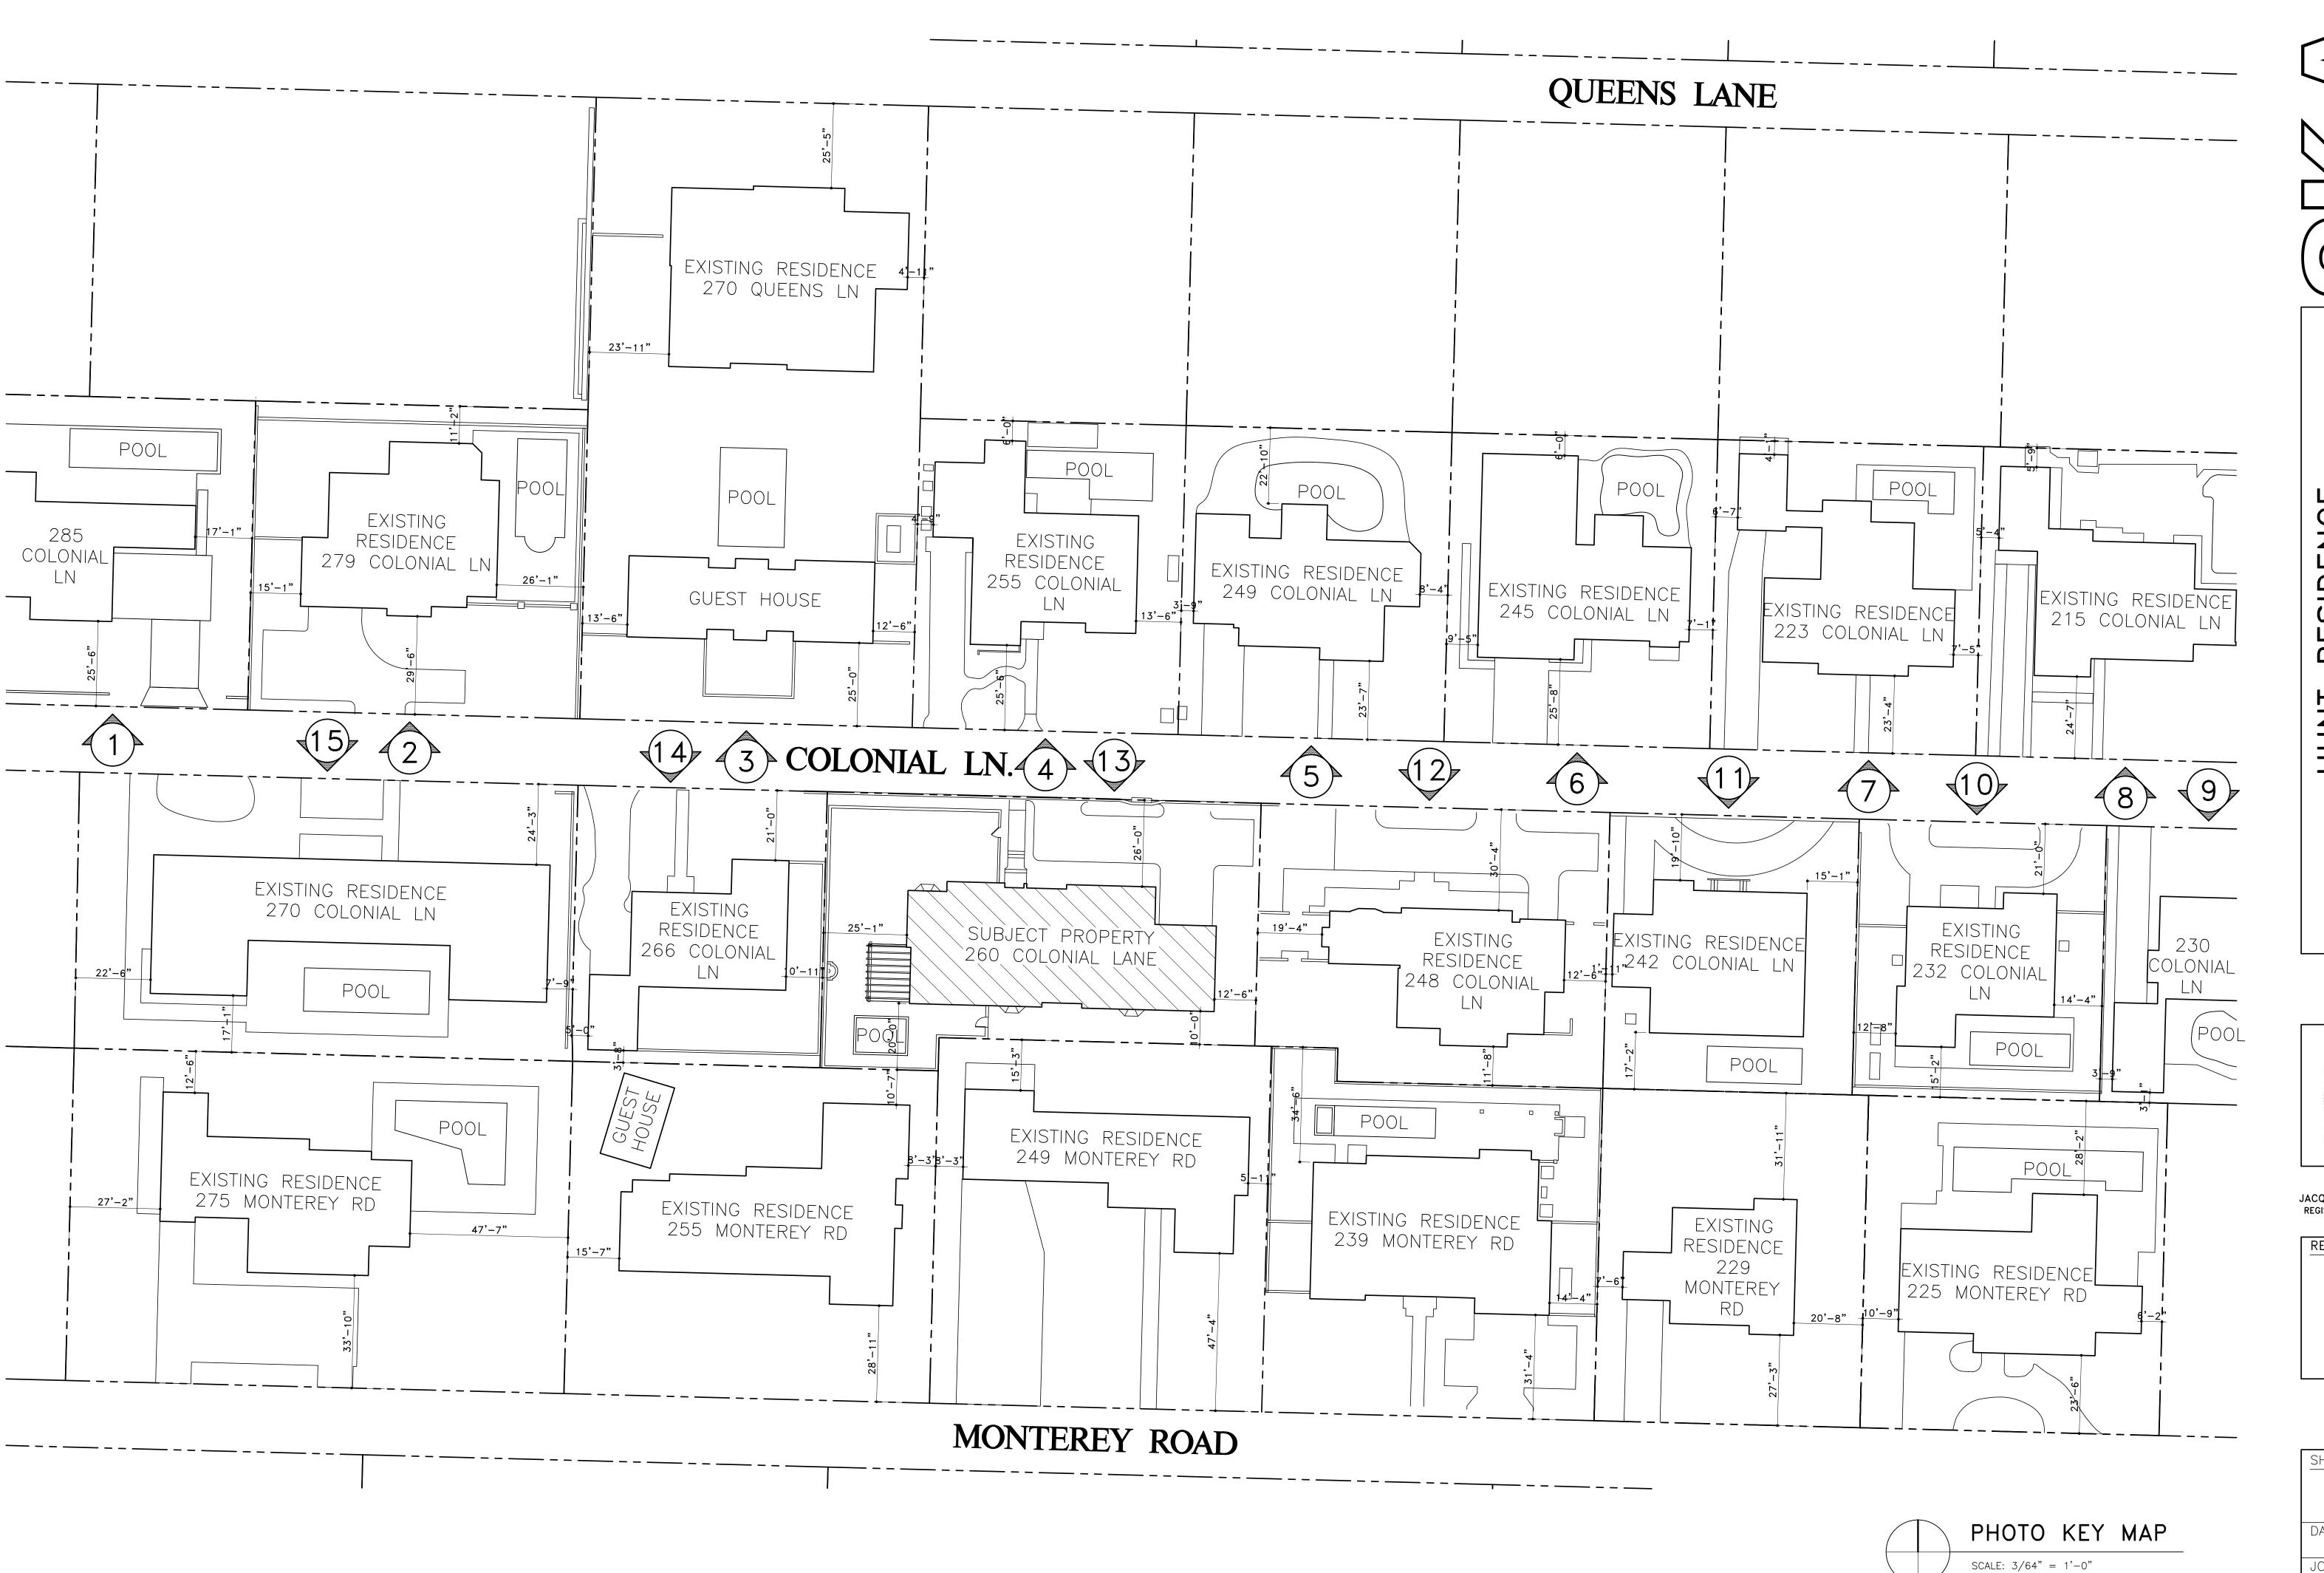
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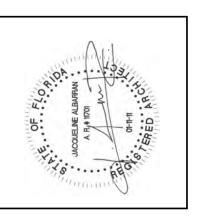
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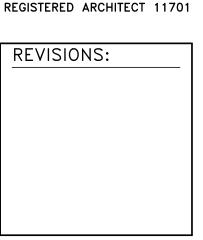


SKA ARCHITECT + PLANNER
204 PHIPPS PLAZA PALM BEACH, FLORIDA

HUNT RESIDENCE
260 COLONIAL LANE
PAIM RFACH FIORIDA



JACQUELINE ALBARRAN, PA REGISTERED ARCHITECT 11701



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A 1.2

DATE:

05-10-24

JOB #





1 - 285 COLONIAL LANE

NEIGHBORING PROPERTIES (NORTH SIDE OF STREET)

2 - 279 COLONIAL LANE



3 - 270 COLONIAL LANE



4 - 255 COLONIAL LANE



5 - 249 COLONIAL LANE

NEIGHBORING PROPERTIES (NORTH SIDE OF STREET)

6 - 245 COLONIAL LANE



7 - 223 COLONIAL LANE



8 - 215 COLONIAL LANE





9 - 230 COLONIAL LANE

NEIGHBORING PROPERTIES (SOUTH SIDE OF STREET)

10 - 232 COLONIAL LANE



11 - 242 COLONIAL LANE



12 - 248 COLONIAL LANE





13 - SUBJECT PROPERTY TO BE DEMOLISHED

NEIGHBORING PROPERTIES (SOUTH SIDE OF STREET)

14 - 266 COLONIAL LANE



15 - 270 COLONIAL LANE



16 - 281 MONTEREY ROAD


DATE: 05-10-24 JOB # 0451

GENERAL NOTE:

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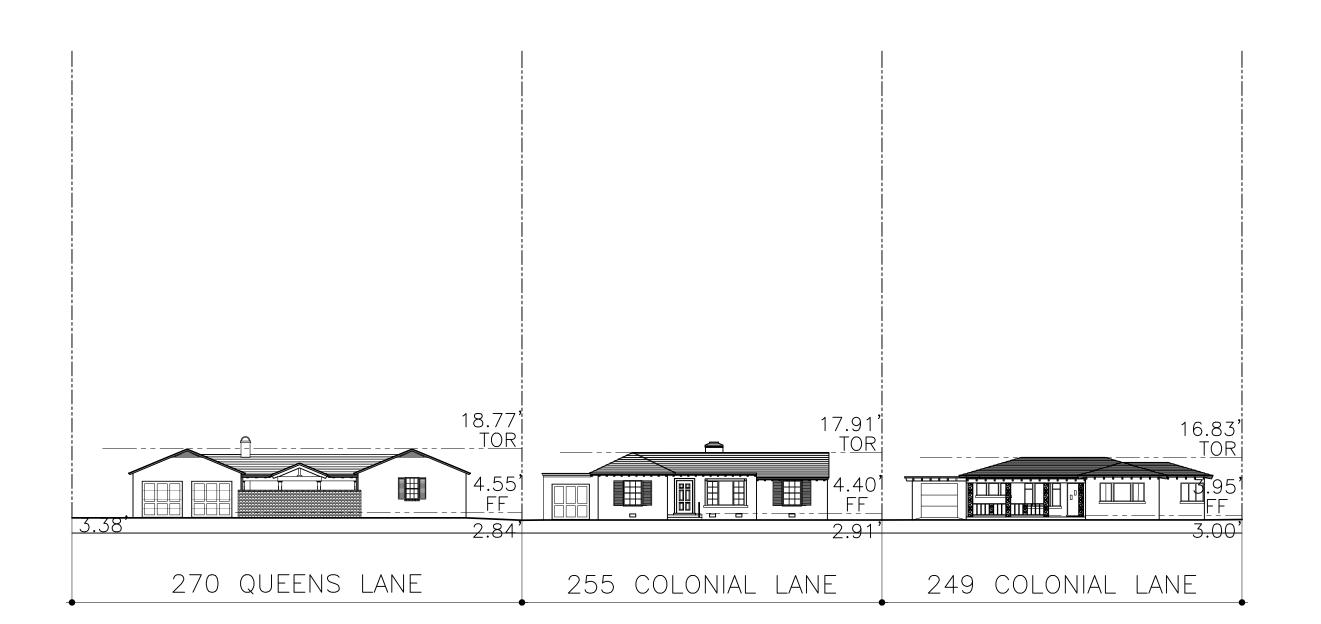
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ALL CONSTRUCTION TO BE ACCORDING TO CURRENT LOCAL CODES: FBC 8th EDITION 2023.



PROPOSED STREETSCAPE COLONIAL WAY (LOOKING SOUTH)

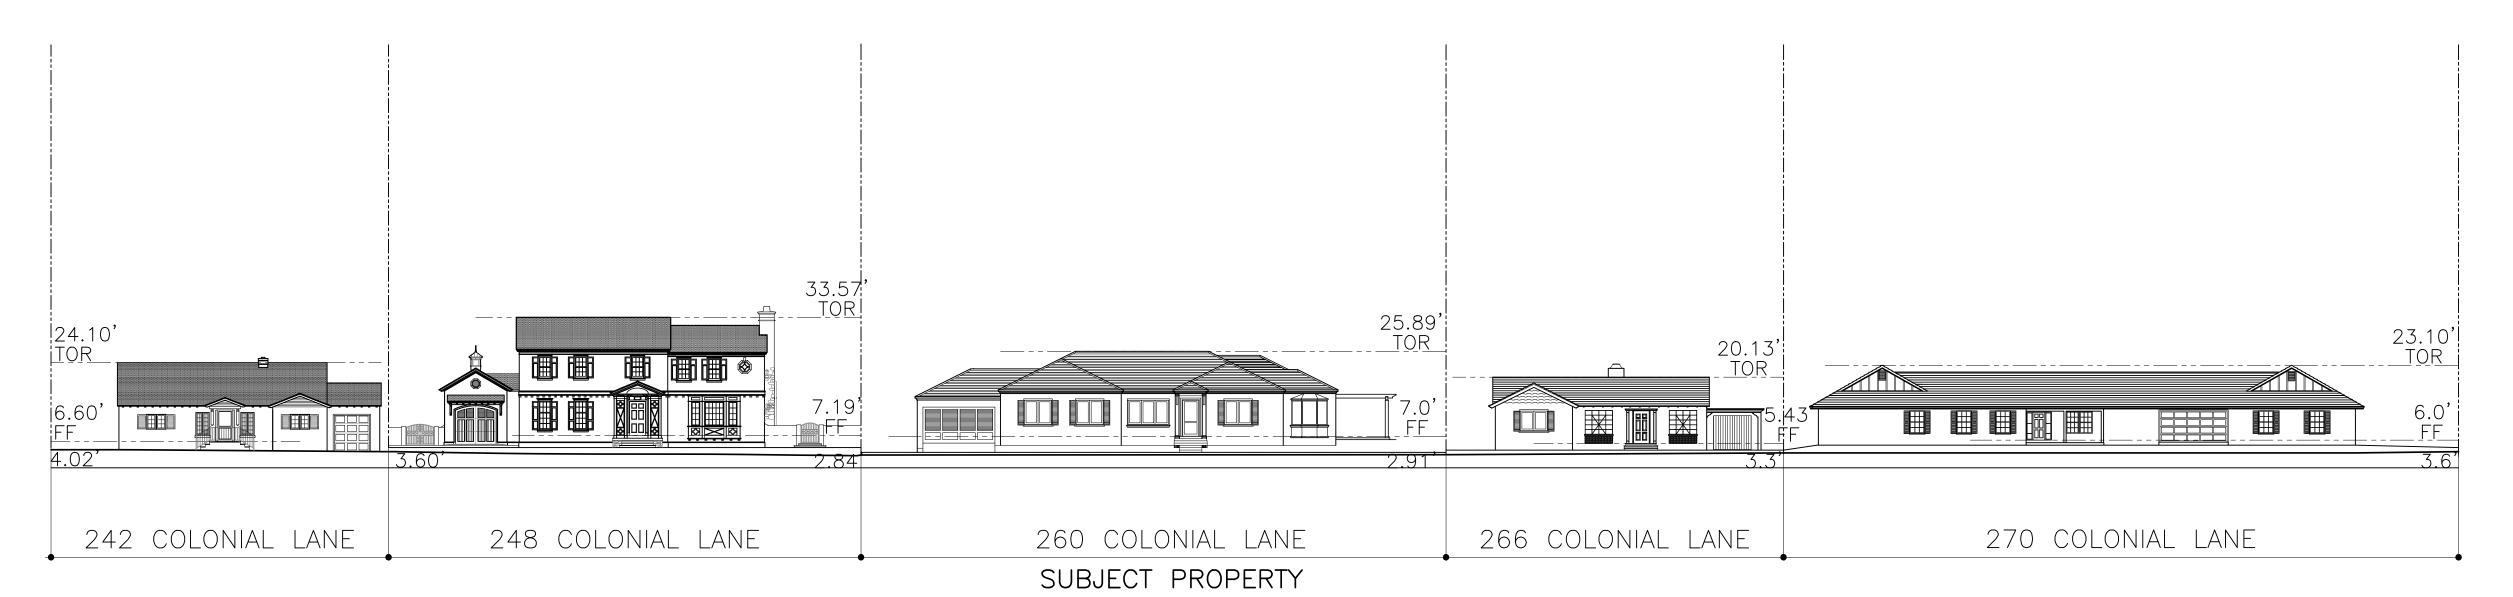SCALE: 3/64" = 1'-0"



EXISTING STREETSCAPE COLONIAL WAY (LOOKING NORTH)

SCALE: 3/64" = 1'-0"

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SKA ARCHITECT + PLANNER
324 ROYAL PALM WAY, SUITE 227, PALM BEACH, FLORIDA

HUNT J 260 CC PALM BE,

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GENERAL NOTE:

-EROSION CONTROL TO BE ACCORDING TO TOWN CODE CH. 66 S. 66-443. -CONSTRUCTION MATERIAL STORAGE AND PARKING TO BE ACCORDING TO "RIGHT OF WAY" STAND. MANUAL, PAGE XII.2 -LANDSCAPING TO MEET TOWN CODES WITH RESPECT TO PLANTINGS IN "RIGHT OF WAY", EASEMENTS AND/OR SIGHT TRIANGLES.
-LANDSCAPING WILL CONFORM TO GRADING DRAINAGE RETENTION.

BLACK MESH
SCREENING


GENERAL EROSION CONTROL NOTES:

-EXISTING FENCING AND HEDGES TO REMAIN DURING CONSTRUCTION

- EXISTING GROUND


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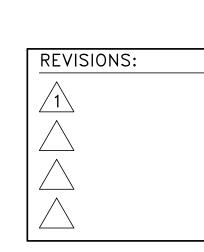
PROPOSED FLOOR PLAN

SCALE: 1/4" = 1'-0"

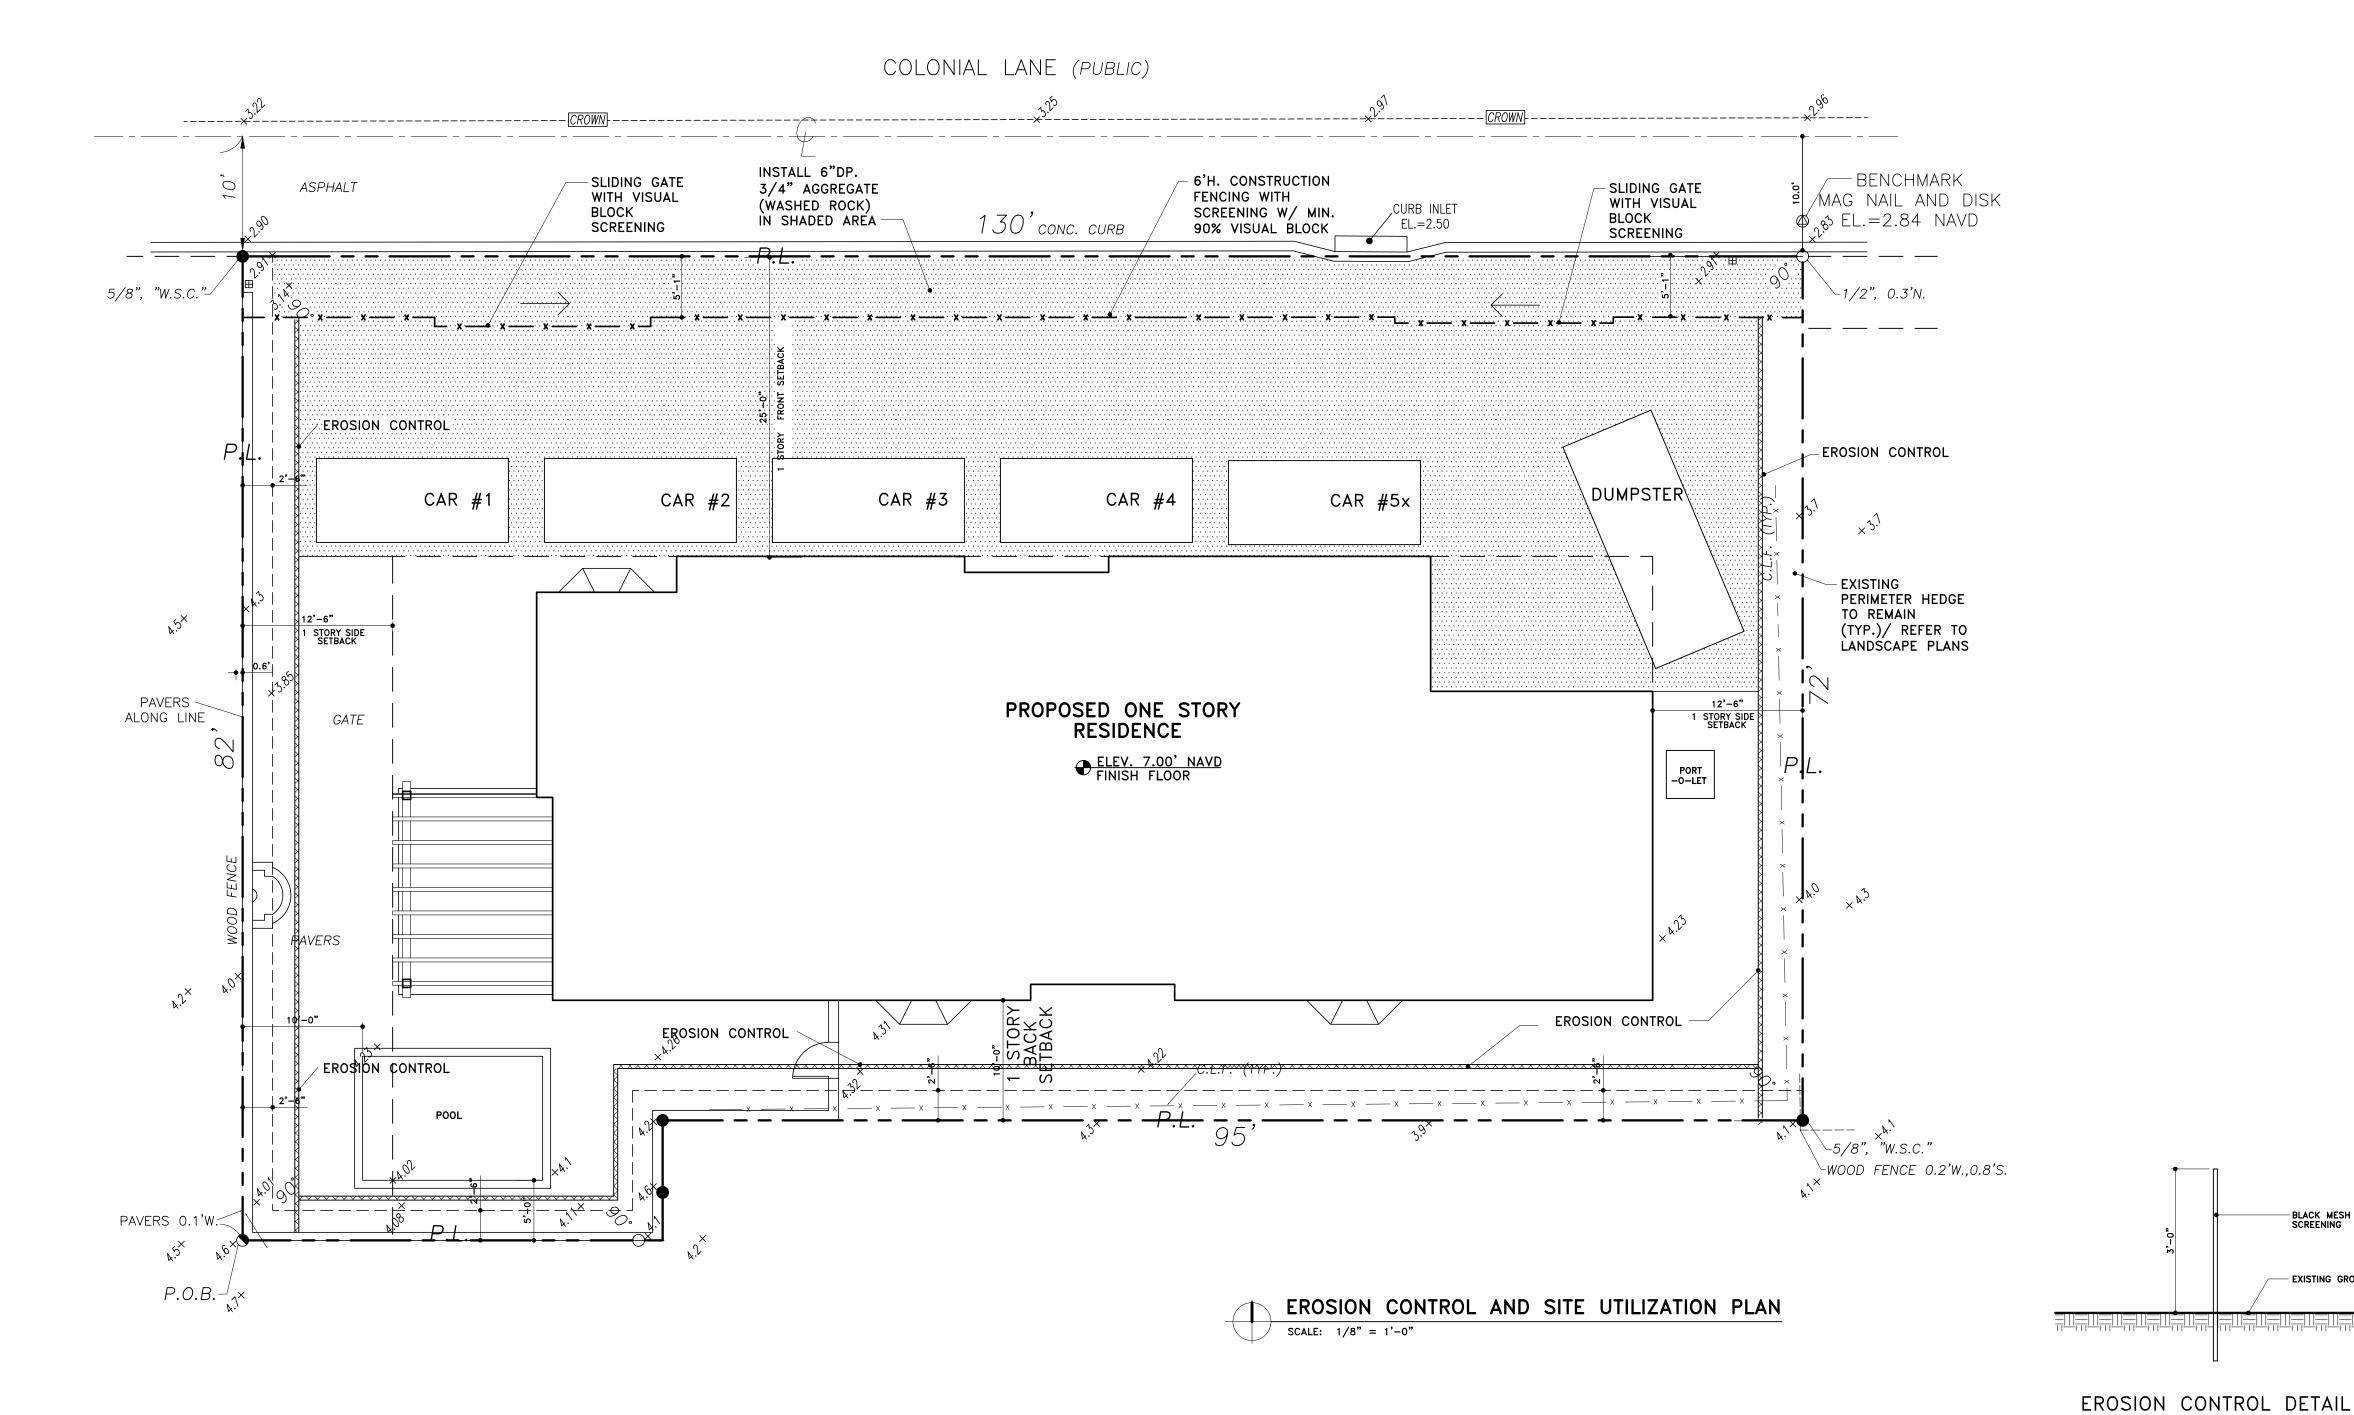



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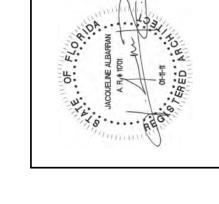


PROPOSED NORTH, EAST, WEST & SOUTH ELEVATIONS

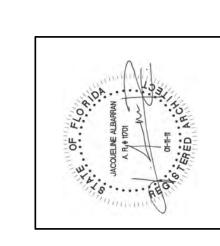SCALE: 1/4" = 1'-0"

PROPOSED WEST ELEVATION

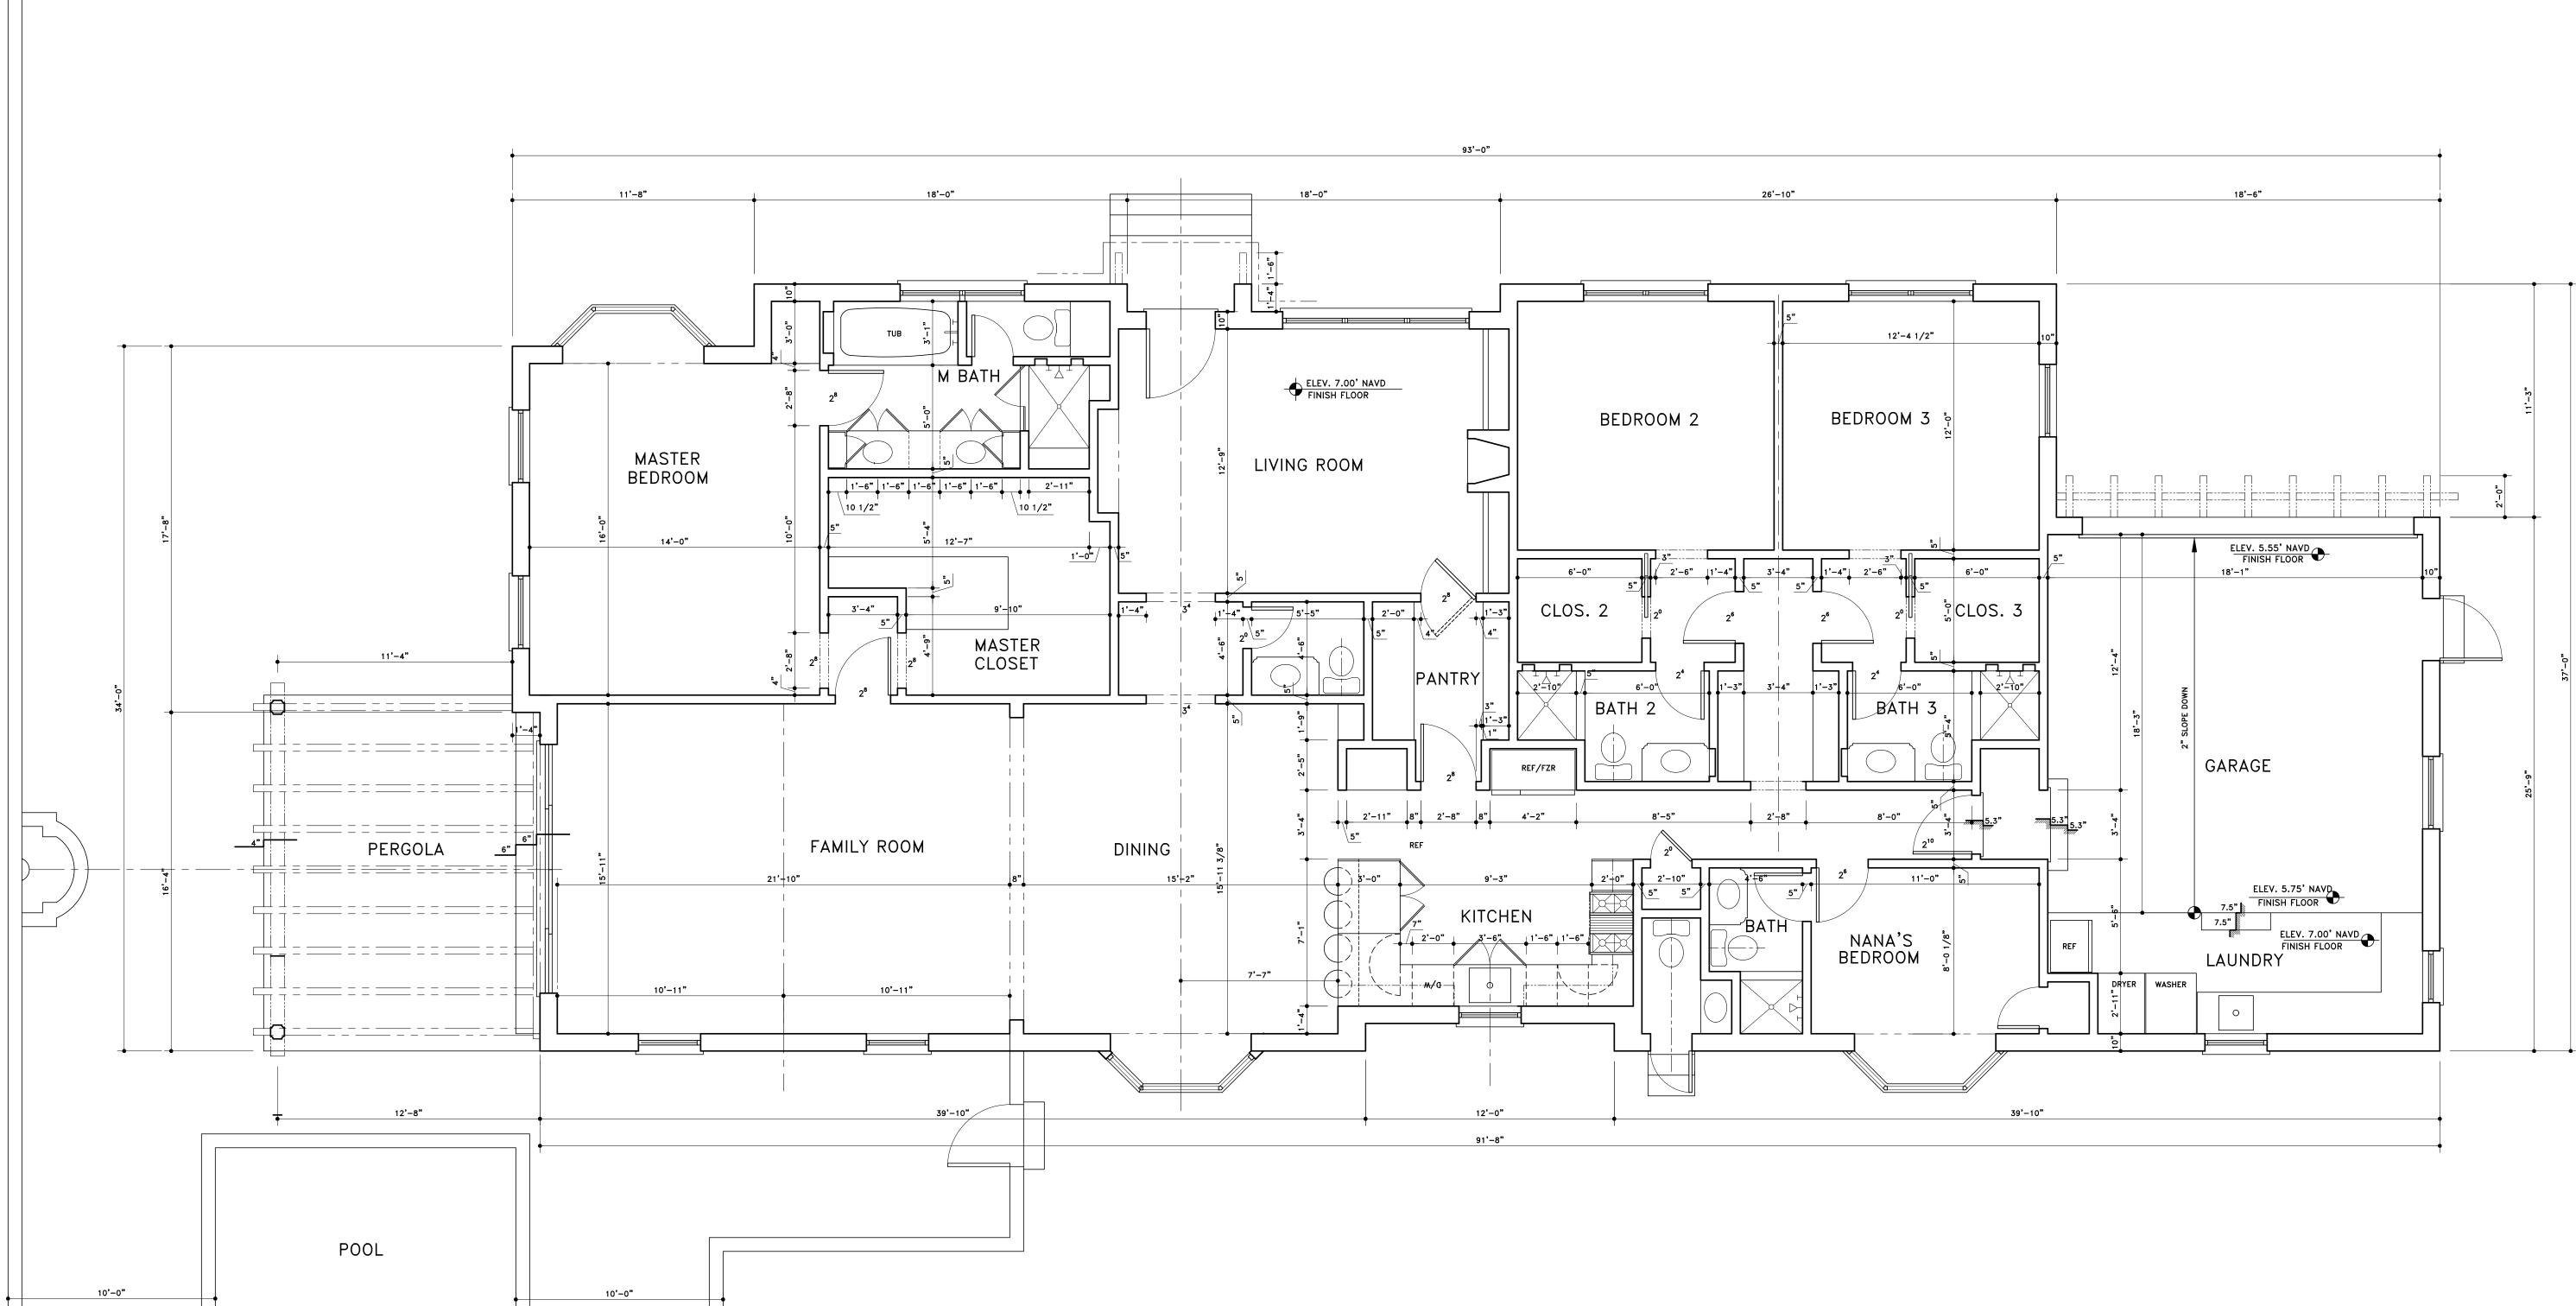SCALE: 1/4" = 1'-0"

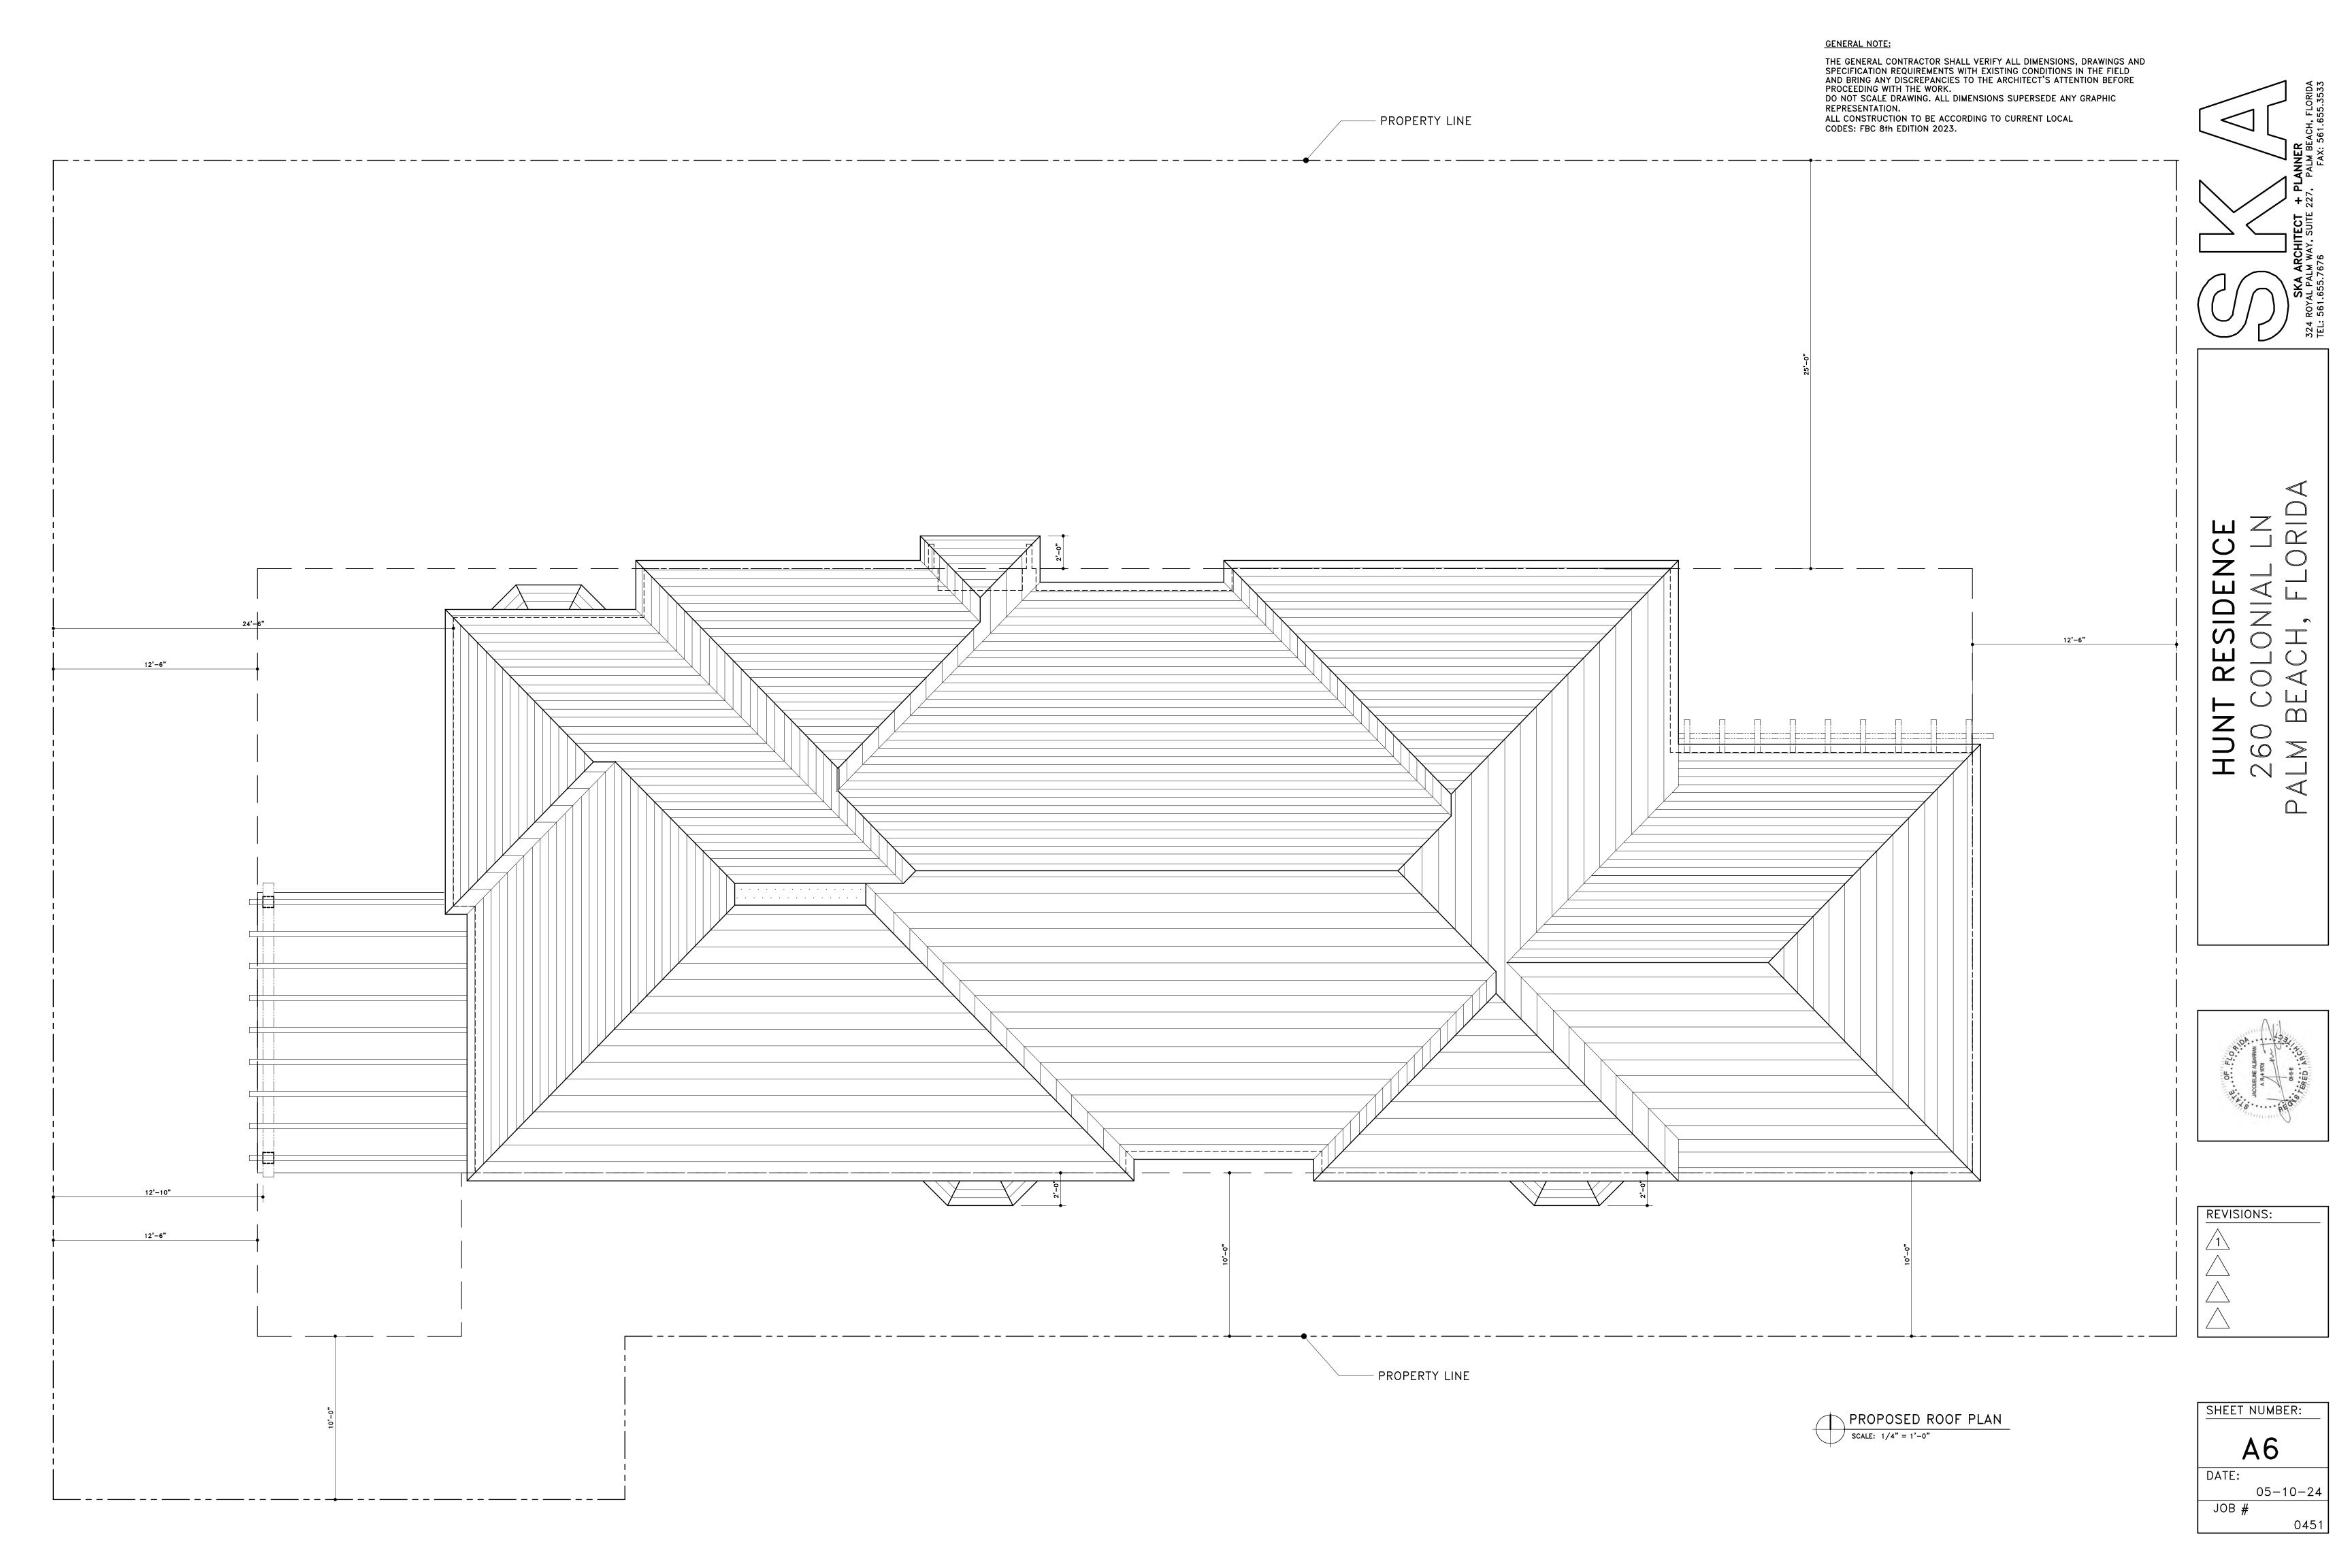

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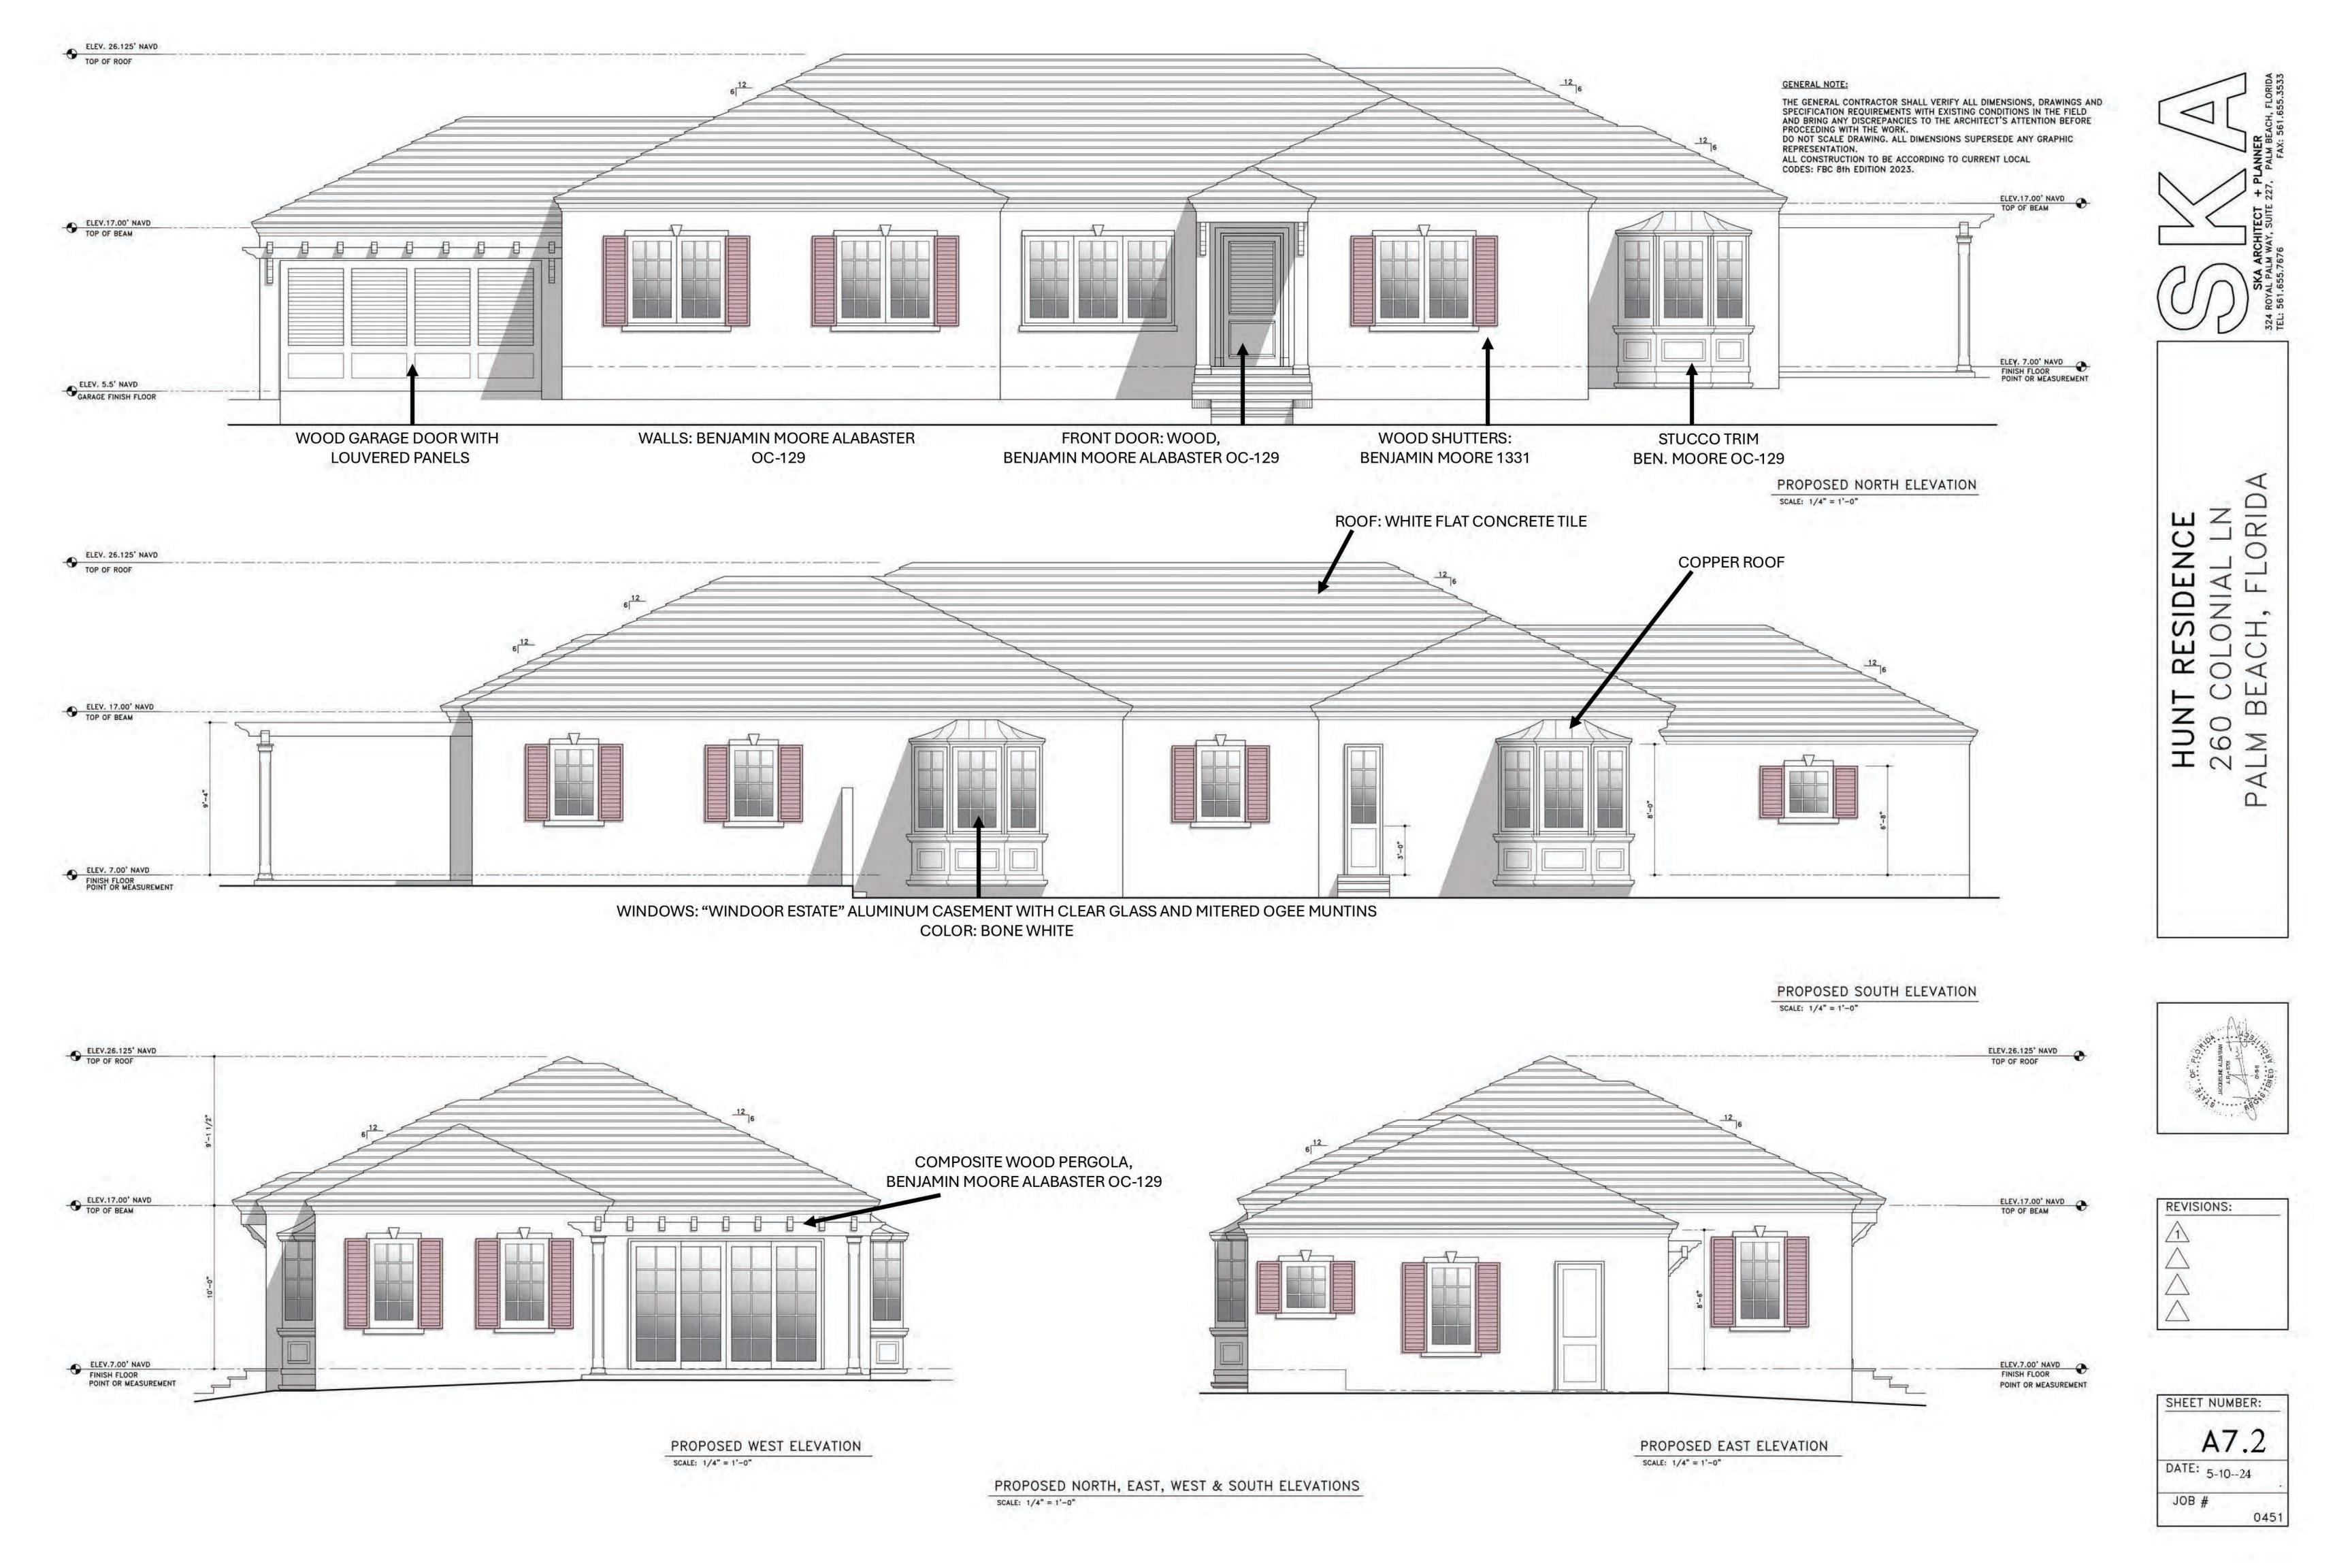
05-10-24


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PROPOSED EAST ELEVATION


SCALE: 1/4" = 1'-0"








HUNT RESIDENCE 260 COLONIAL LN PALM BEACH, FLORIDA

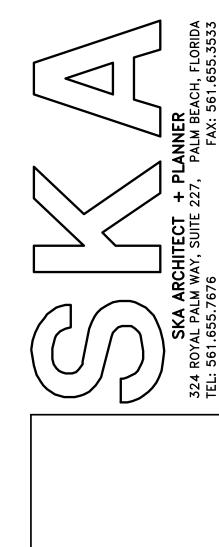

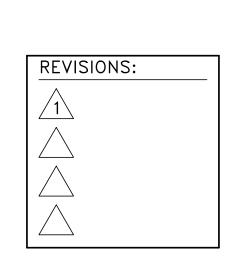


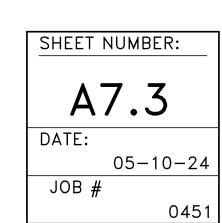


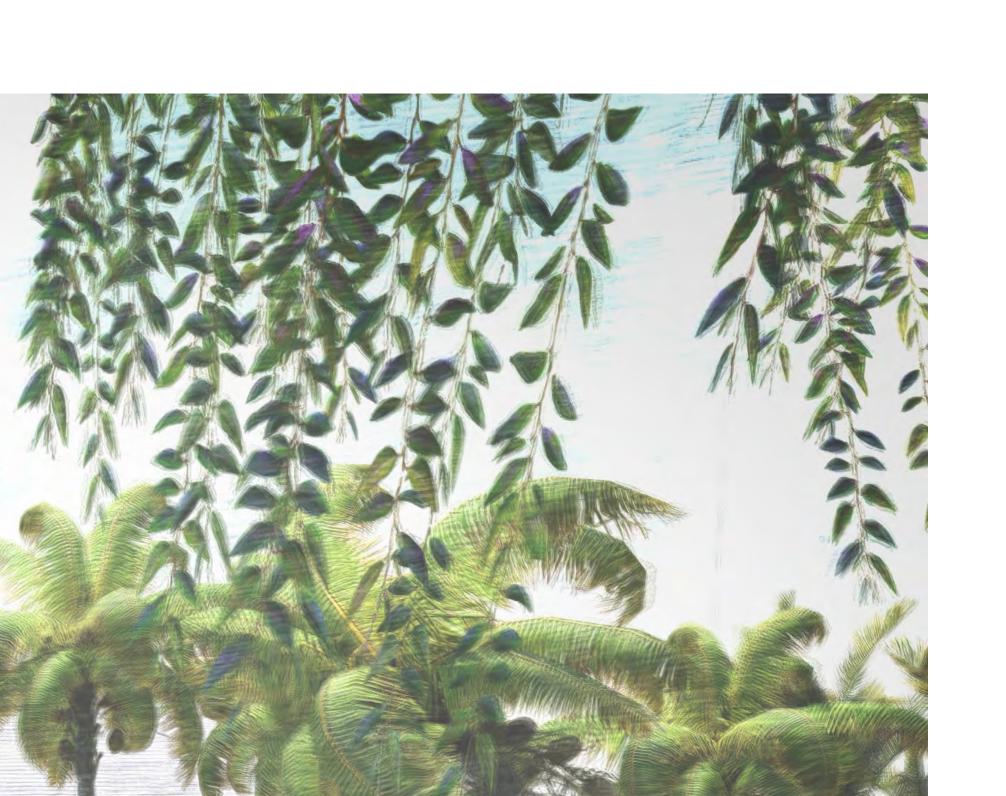


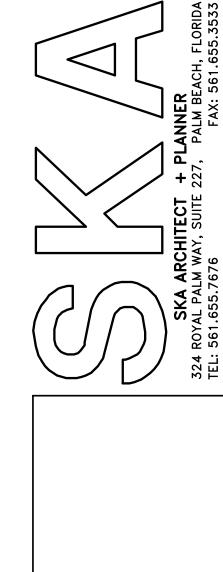


HUNT RESIDENCE 260 COLONIAL LN PALM BEACH, FLORIDA

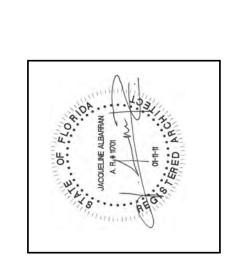

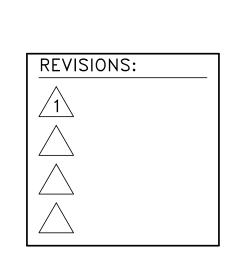

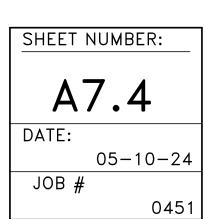


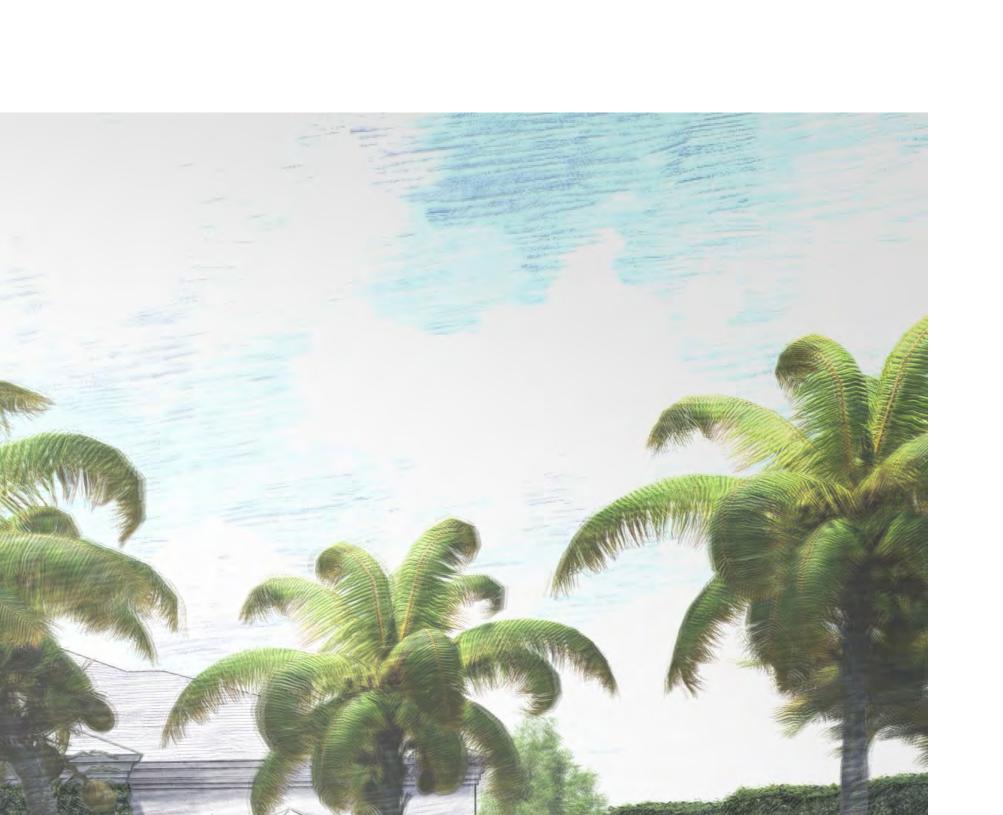


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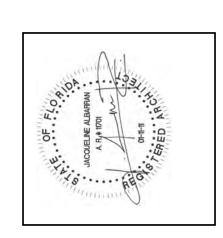





NORTH-SOUTH SITE SECTION

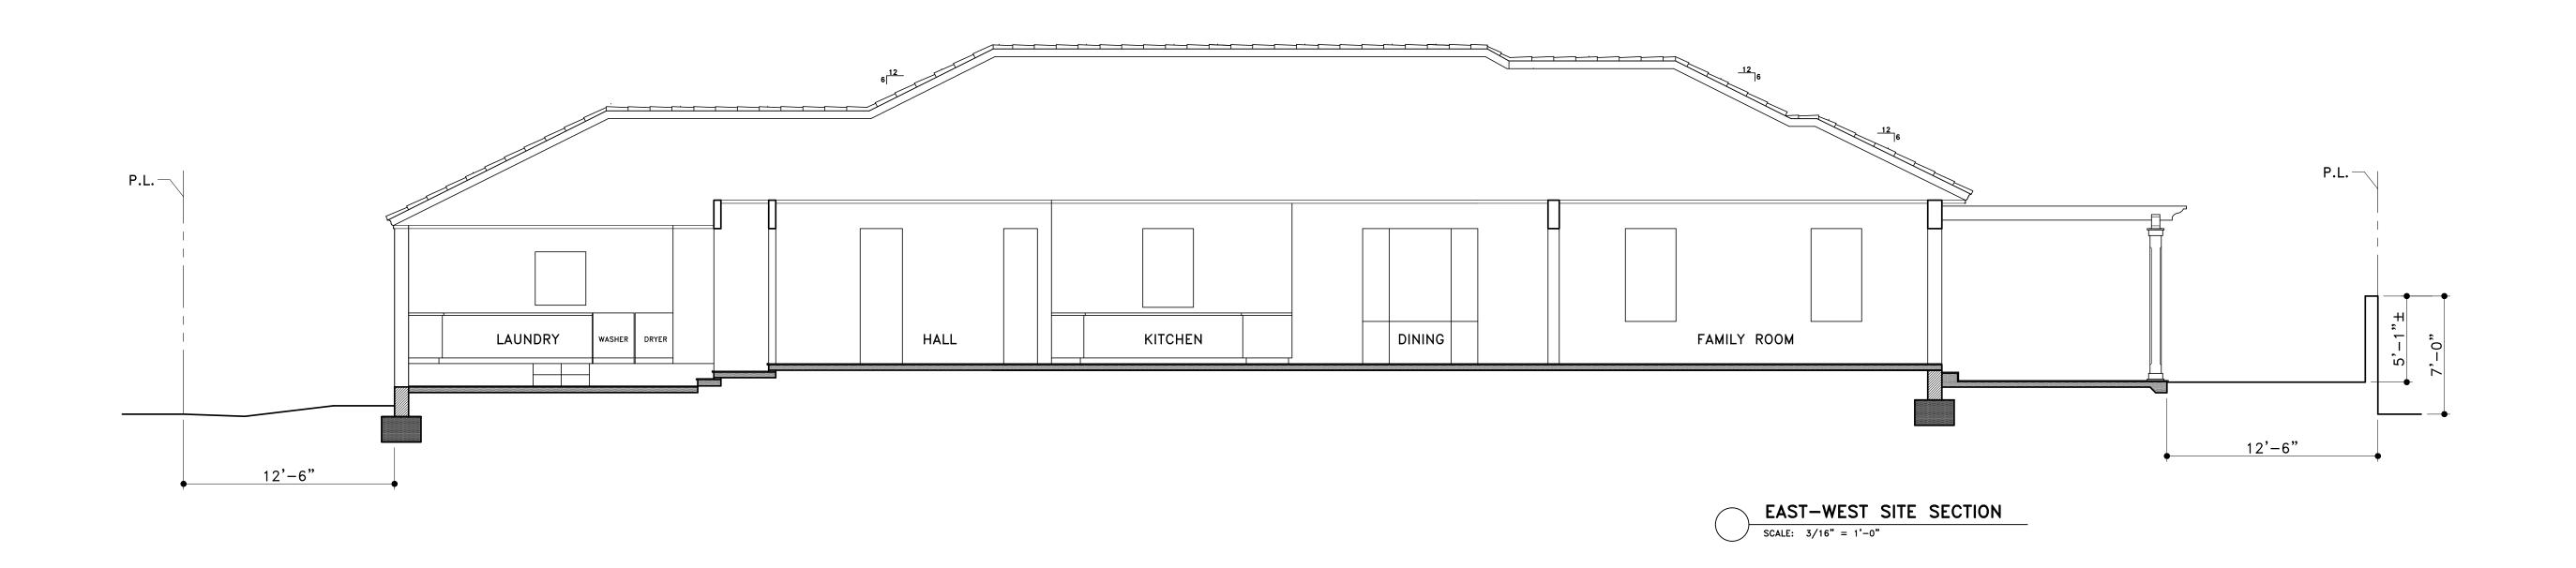SCALE: 3/16" = 1'-0"

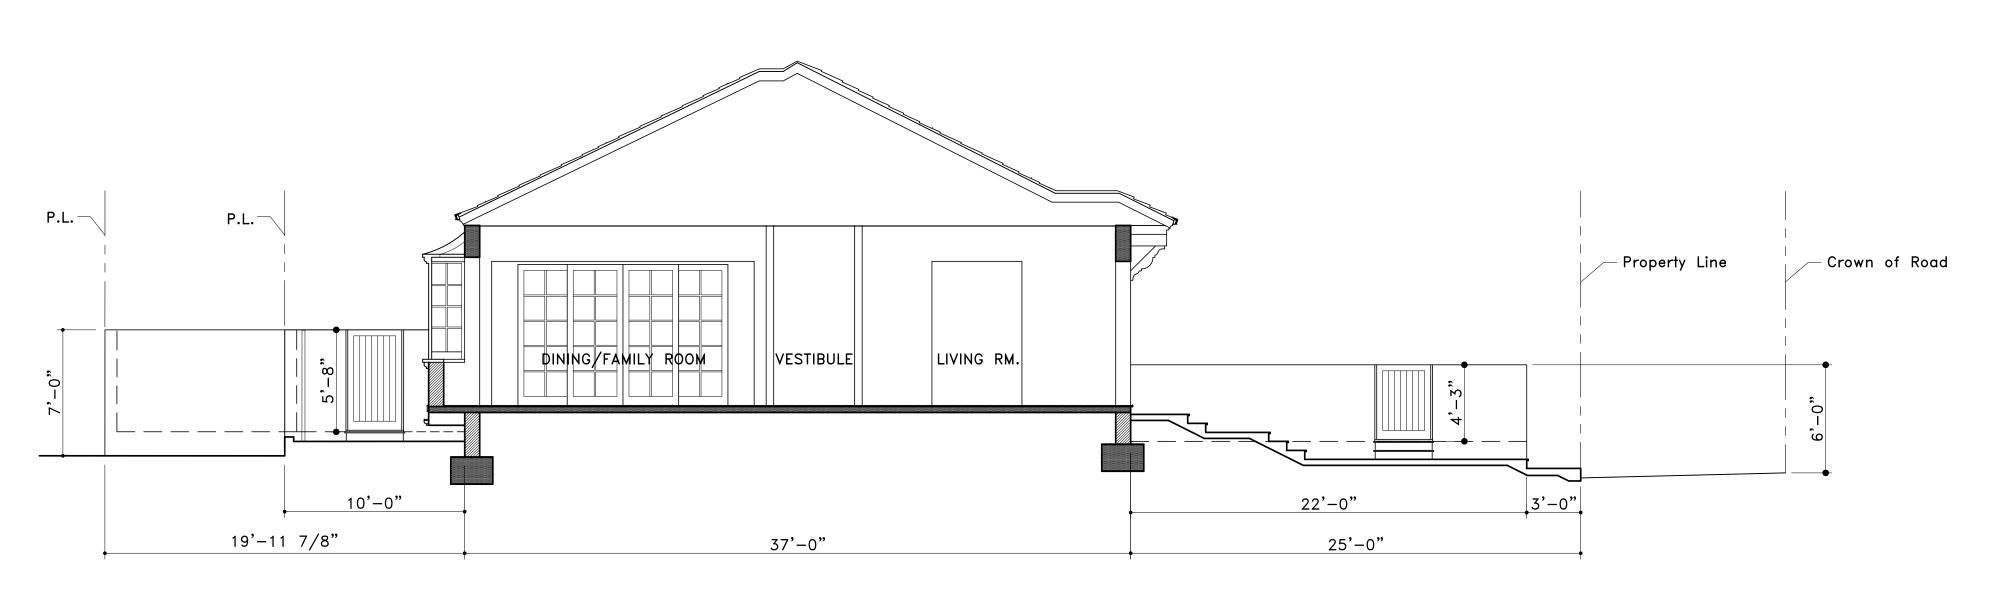




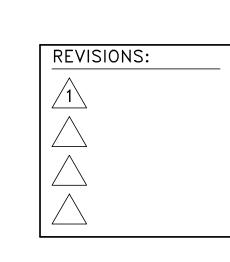


SHEET NUMBER: DATE: 05-10-24 JOB # 0451 DETAIL AT FRONT ENTRANCE

SCALE: 3" = 1'-0"

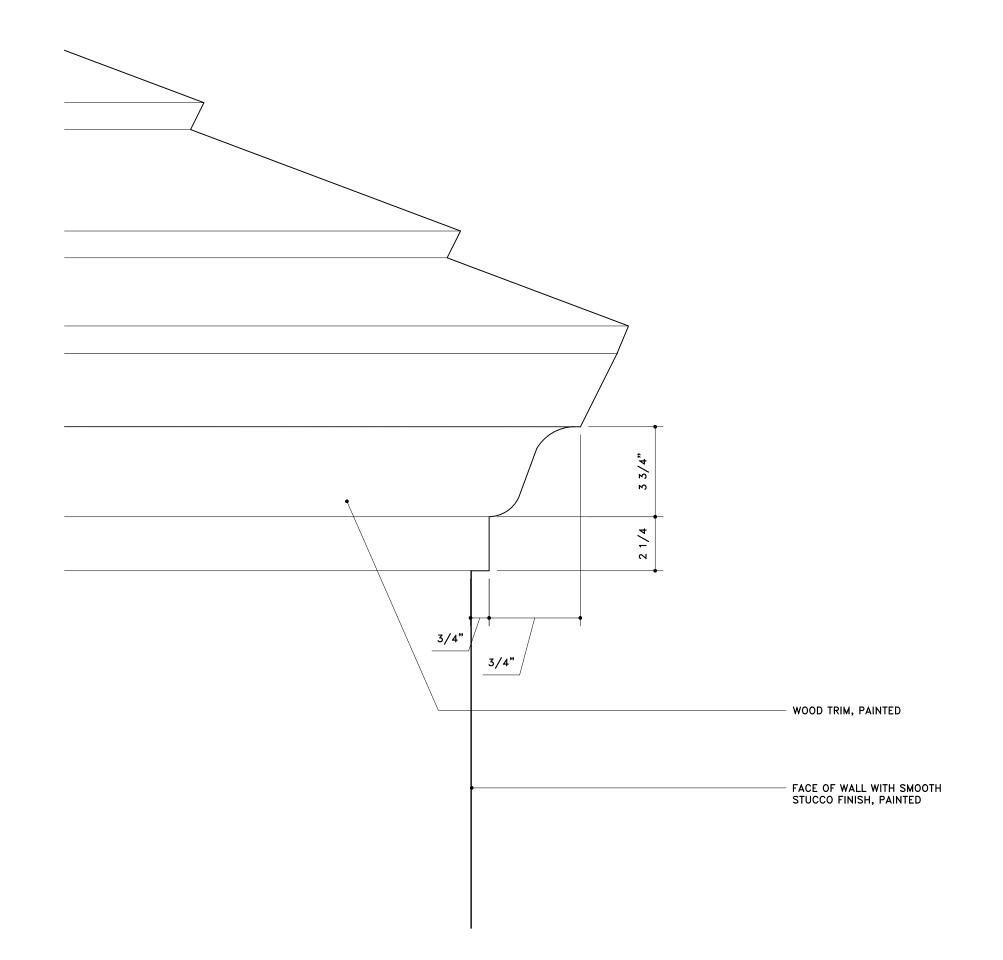


DETAIL AT EDGE OF ROOF

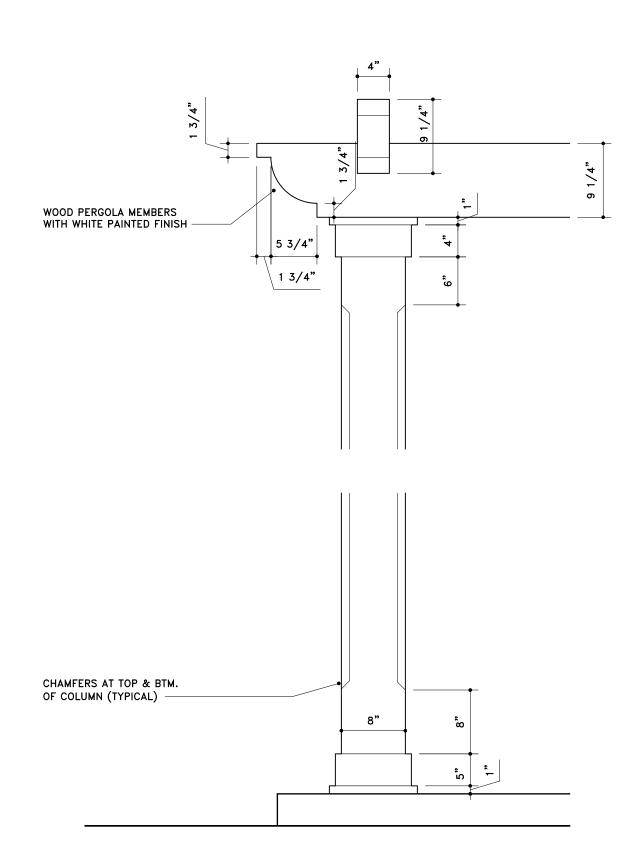

3 DETAIL AT PERGOLA—FRONT VIEW

SCALE: 1" = 1'-0"

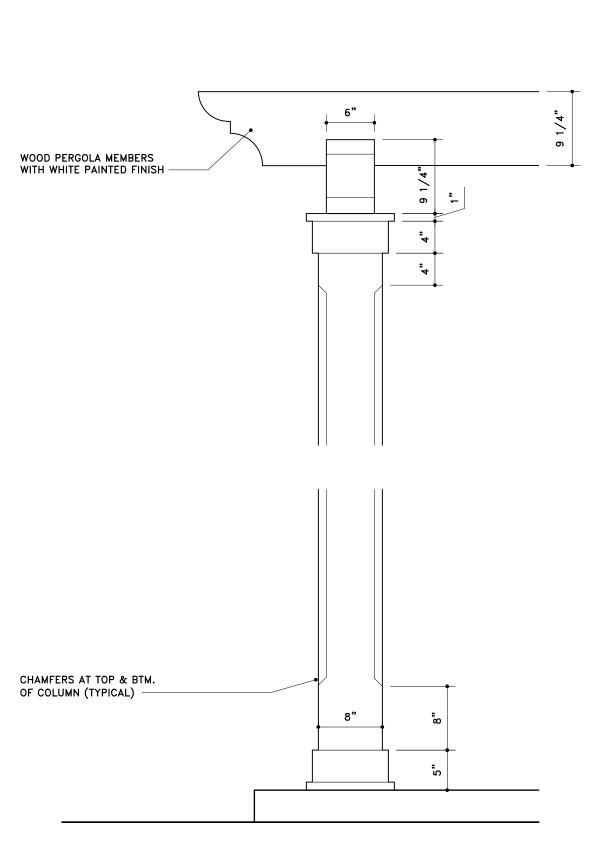

DETAIL AT PERGOLA-SIDE VIEW

SCALE: 1" = 1'-0"

GENERAL NOTE:


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CBS WALL W/ SMOOTH STUCCO FINISH, PAINTED WHITE HARDWOOD GATE WITH WHITE PAINTED FINISH — STEP STEP

> TYPICAL GARDEN GATE SCALE: 1" = 1'-0"





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CUBIC CONTENT CALCULATIONS		
ALLOWABLE CCR 3	9,091 CU.FT. (4.03 CCR)	
AREAS	CUBIC FEET	
A - 2,667.7 SQ. FT. @ 10.0	26,677.0	
B - 476.4 SQ. FT. @ 8.5'	4,049.4	
C - 3 x 12.0 SQ. FT. @ 8.0	288.0	
D - 221.1 SQ. FT. @ 9.33'	2,062.9	
SUBTOTAL	33,077.3	
LESS 5% FOR OPEN COVERED A	REAS (1,653.9)	
TOTAL	31,423.4	
CCR	3.24	


GENERAL NOTE:

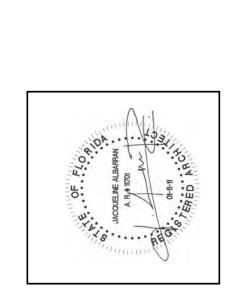CUBIC CONTENT - LOOKING SW


SCALE: NTS

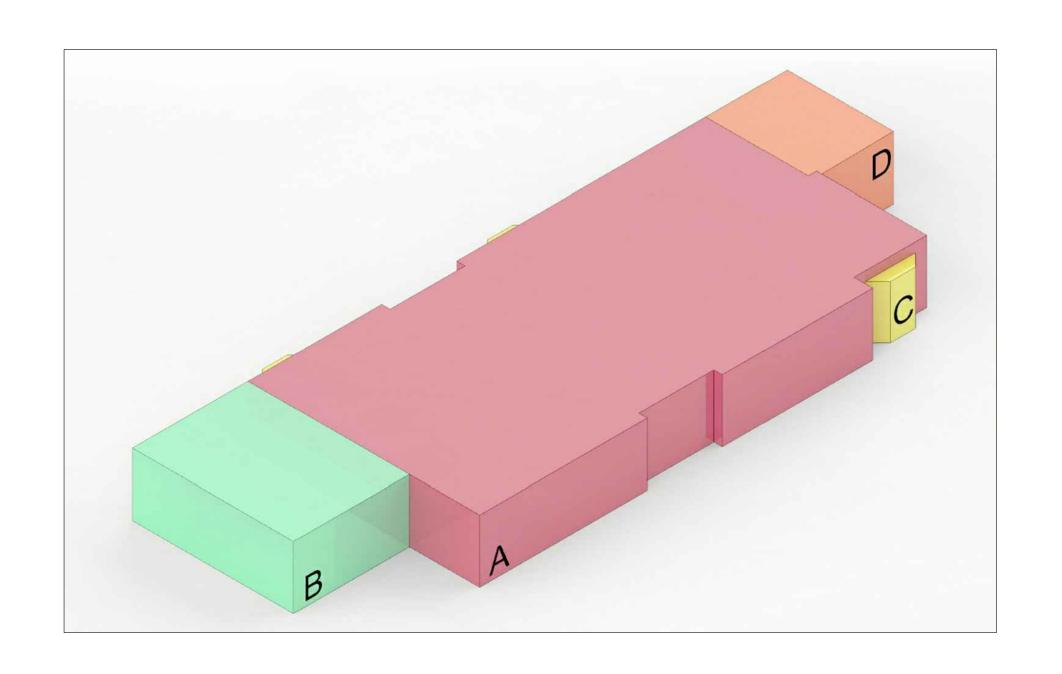CUBIC CONTENT - LOOKING NE

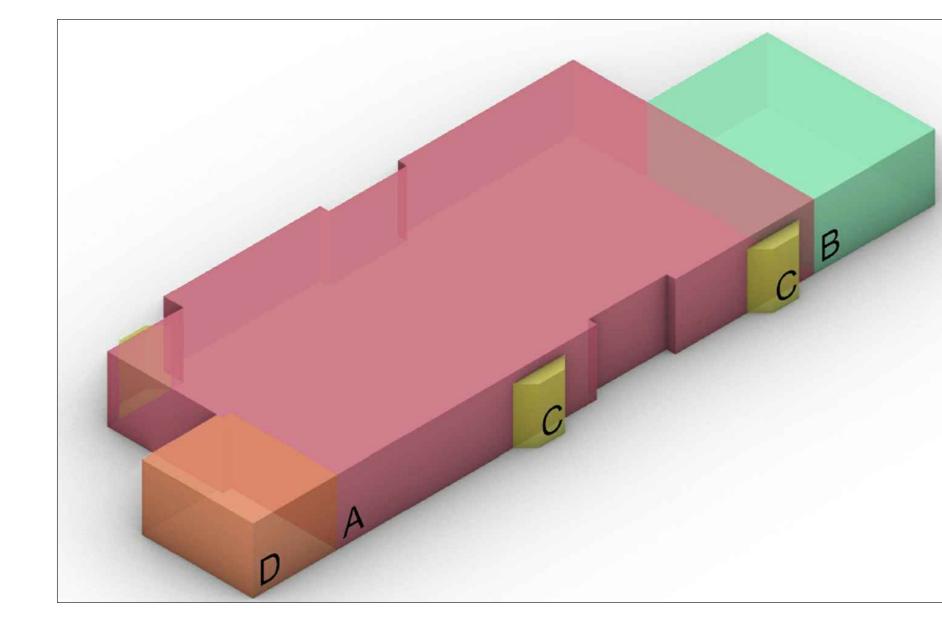
SCALE: NTS

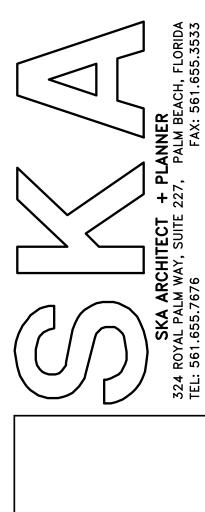

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JACQUELINE ALBARRAN, PA REGISTERED ARCHITECT 11701

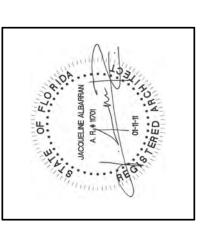

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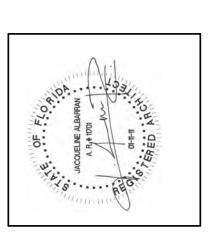
M5 M6 M7 M8 M9 M10 M11 M12 M13 M14 M15 M16 M17
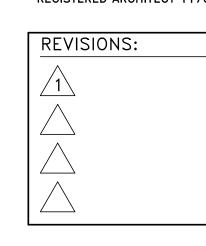
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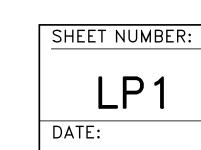
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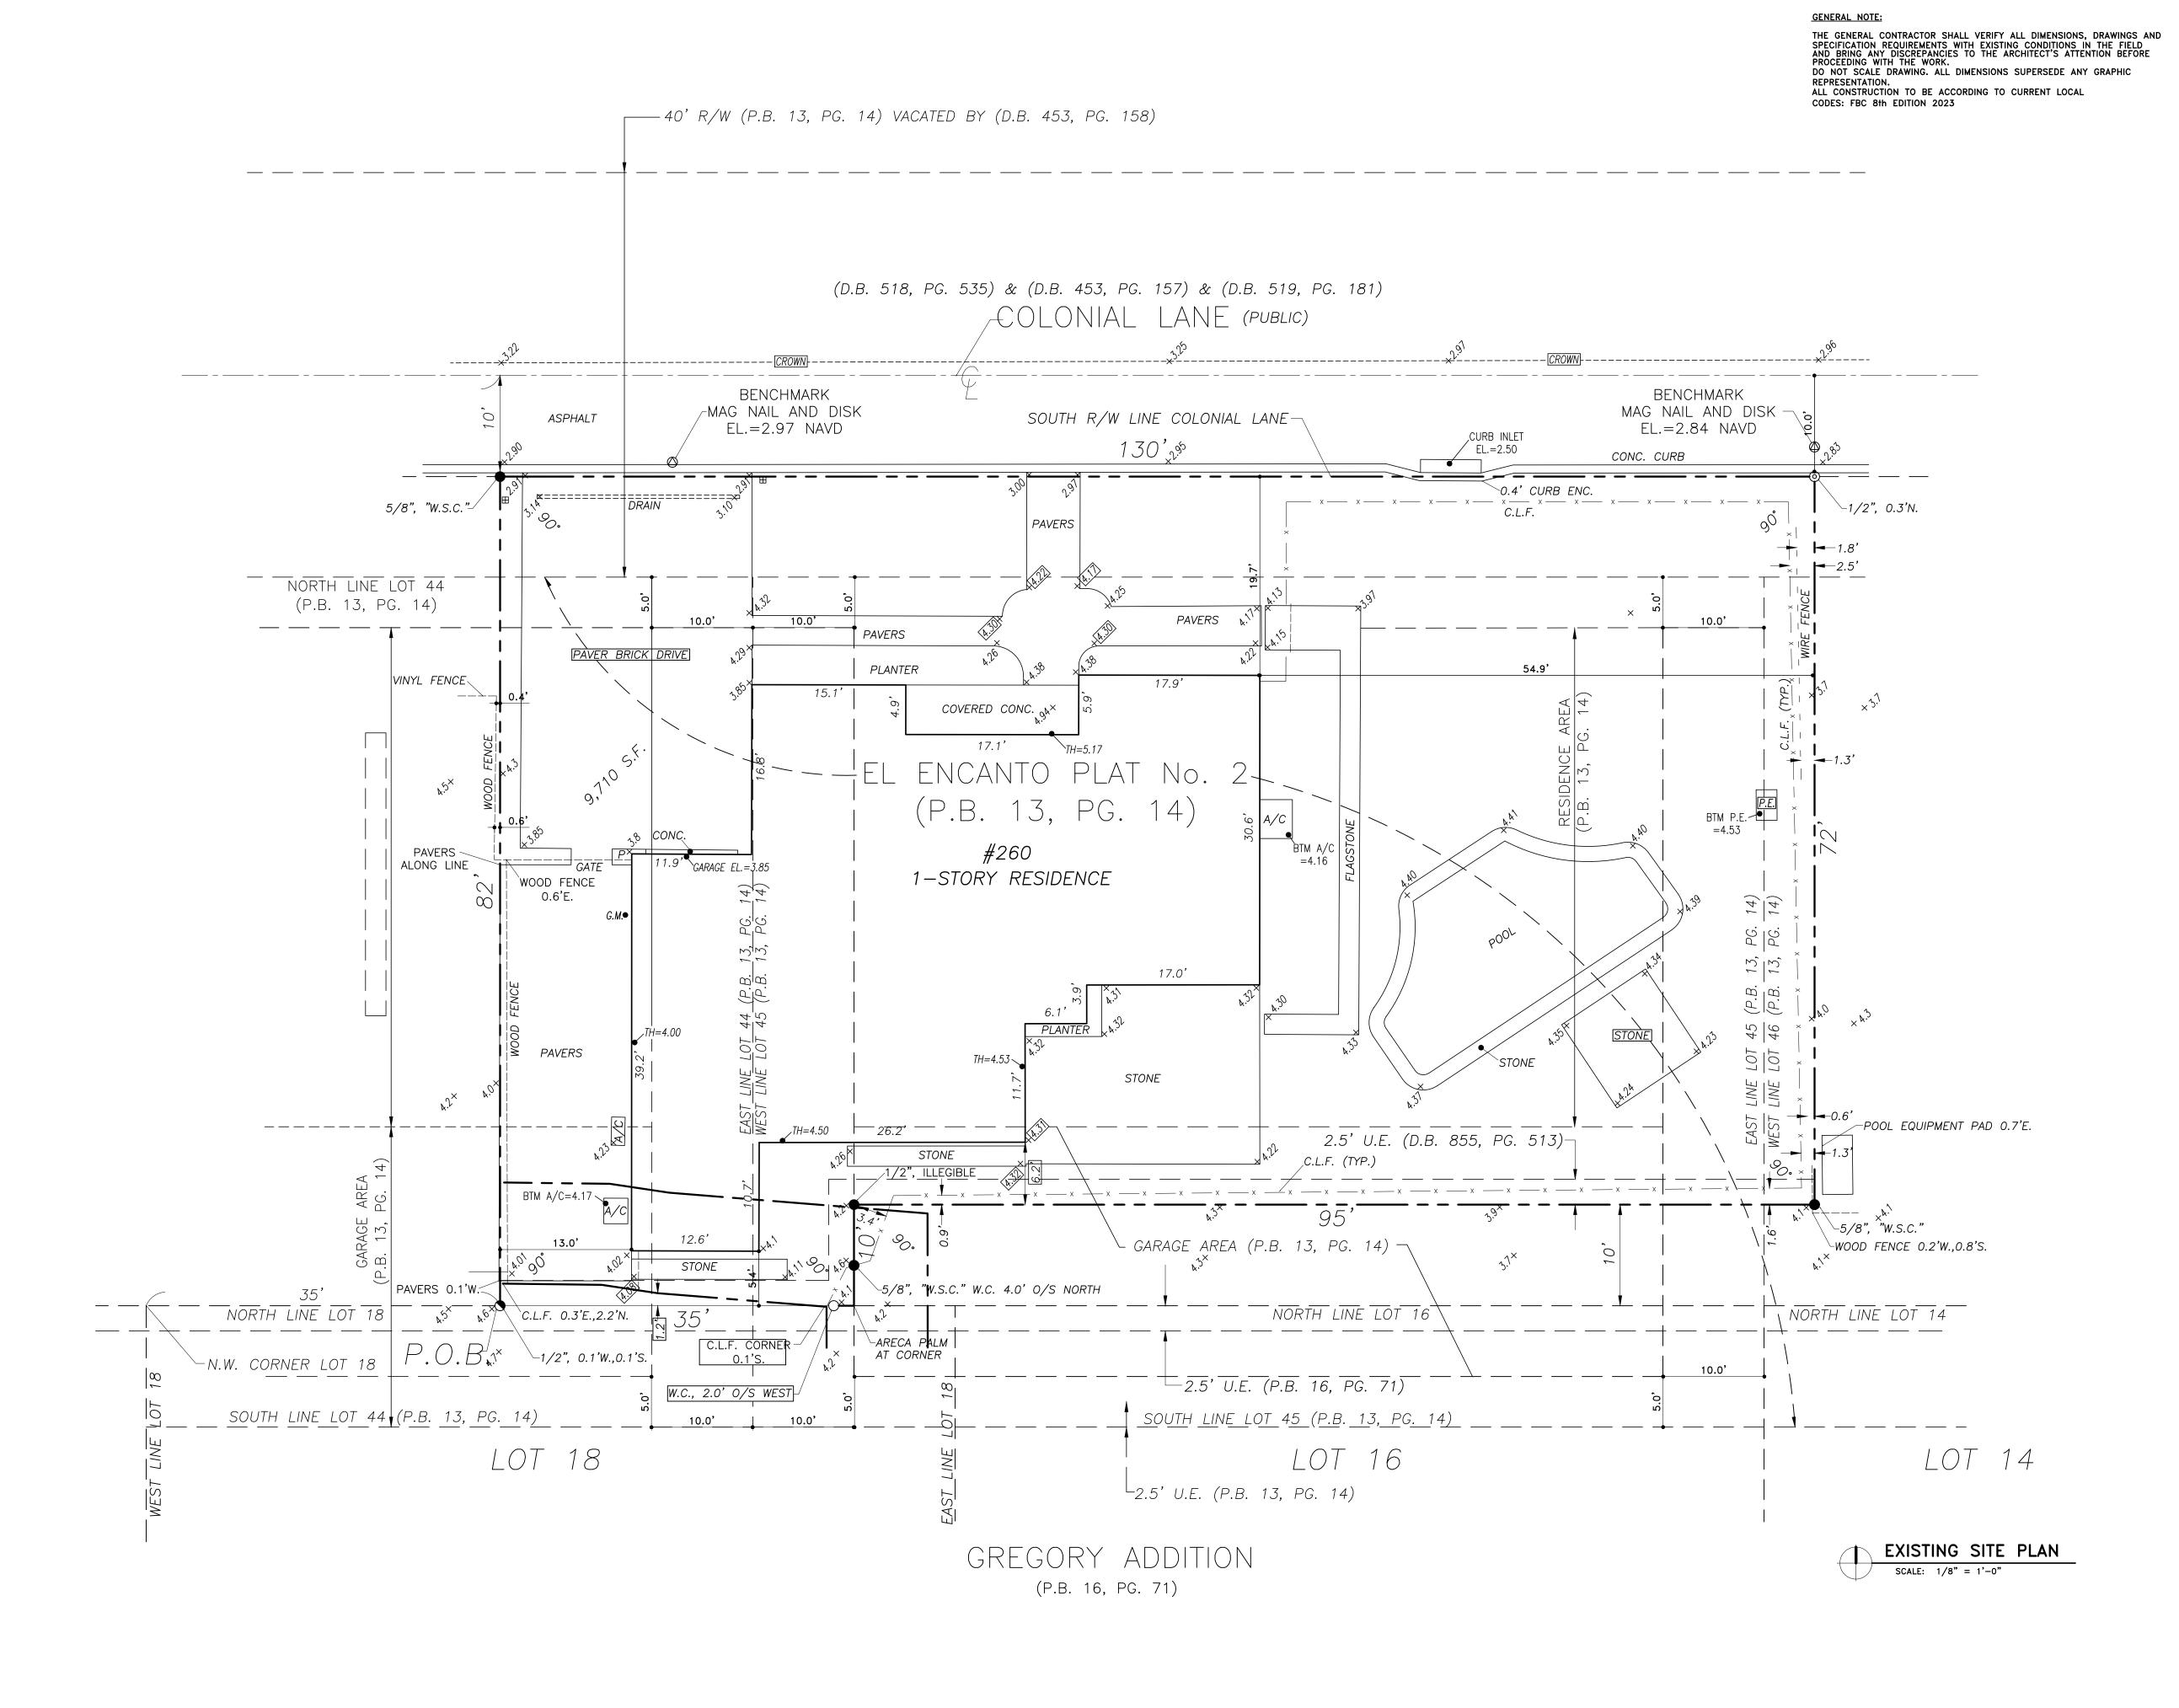


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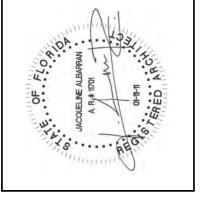
LOGISTICS PLAN AND CONSTRUCTION TIMELINE



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Ex1.1

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HUNT RESIDENCE 260 COLONIAL LN. ALM BEACH, FLORIDA

REVISIONS:

SITE DEMOLITION PLAN

SCALE: 1/8" = 1'-0"


GENERAL NOTE:

Ex1.2

DATE: 5-10-24

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STORMWATER RETENTION CALCULATIONS

A. <u>SITE INFORMATION</u>

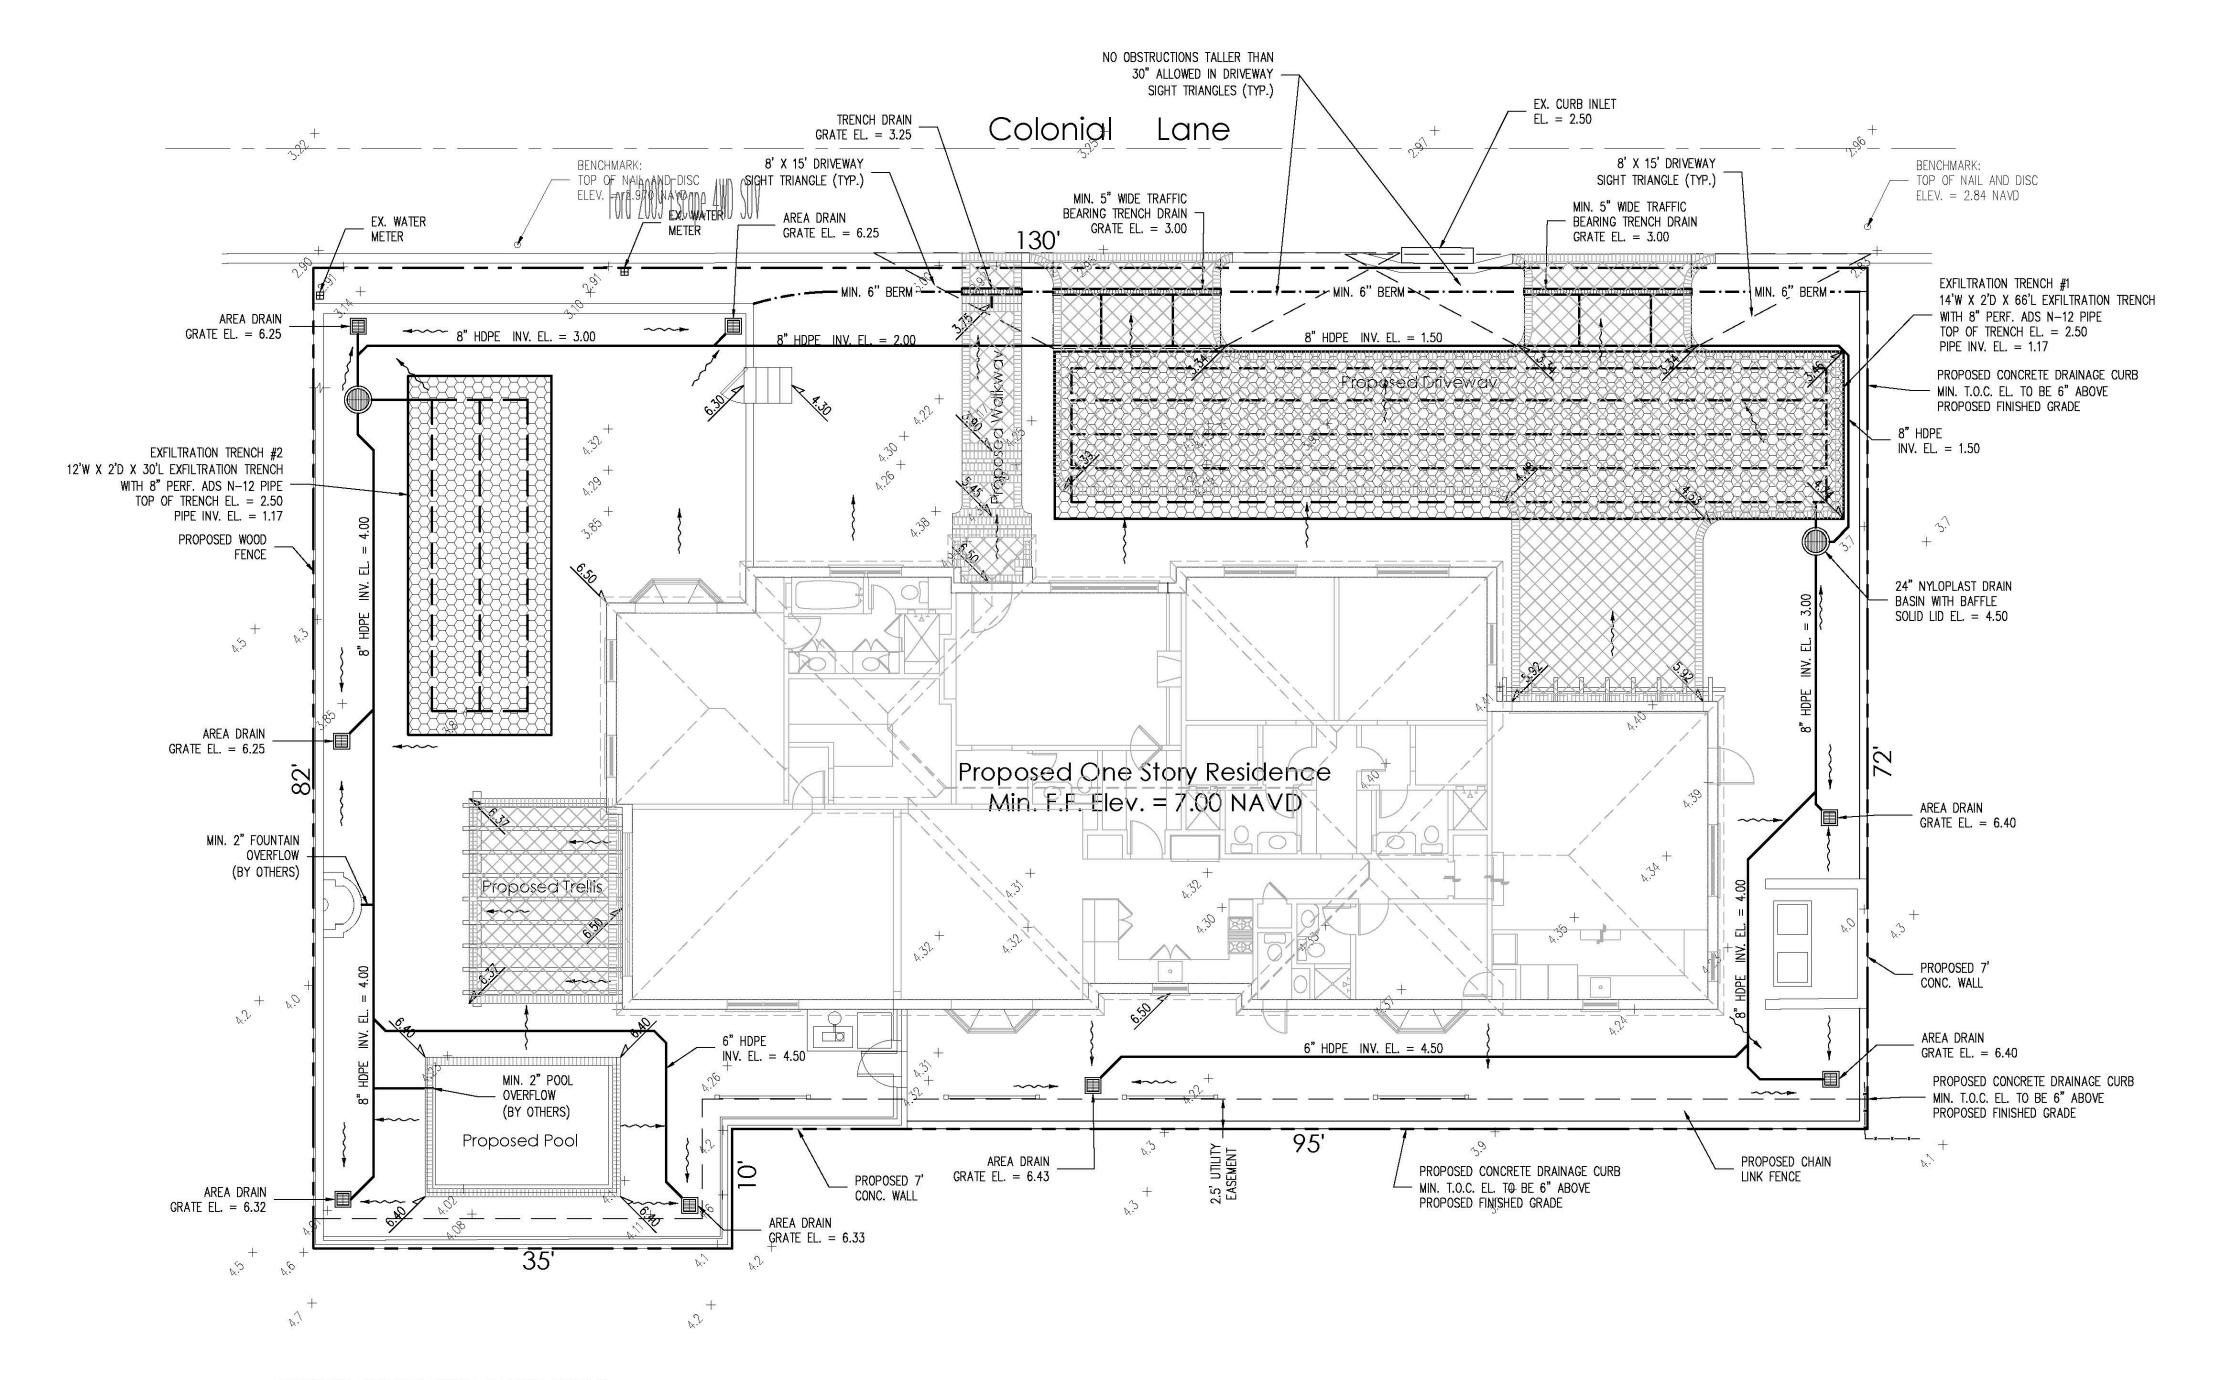Total Property Area = 9,710 sq.ft.

Drainage Area Impervious Surface = 5,340 sq.ft.

Drainage Area Pervious Surface = 4,370 sq.ft.*

*Minimum required by zoning code without a variance.

B. **ESTIMATED STORMWATER RETENTION VOLUME**

The retention volume is estimated using the Rational Method (Q=CiA)

C = 1.0 (impervious surface) C = 0.2 (pervious surface)

i = 2 in/hr

Impervious Surface Runoff Volume: $1.0 \times 2 \text{ in/hr} \times 5,340 \text{ sq.ft.} \times 1 \text{ ft./12 in.} = 890 \text{ cu.ft.}$

Pervious Runoff Volume:

 $0.2 \times 2 \text{ in/hr} \times 4,370 \text{ sq.ft.} \times 1 \text{ ft./12 in.} = 146 \text{ cu.ft.}$

Total Volume to be Retained = 1,036 cu.ft.

Trench #1

= 1.00 ft

= 778 cu.ft.

L = Total Length of Trench Provided = 30 ft

= 12 ft W = Trench Width K = Hydraulic Conductivity

H2 = Depth to Water Table = 1.50 ft DU = Un-Saturated Trench Depth = 1.00 ft

6) Video inspection of storm drainage system required

Notes:

from roots with a root barrier.

of drainage system.

installation.

2) Roof drain downspouts are to be connected to the

3) Exfiltration trench design uses an assumed value of

4) Contractor shall mill and overlay all roadway cuts a

entire width of each affected lane.

prior to installation of sod.

minimum of 50 ft. on either side of the excavation the

5) Contractor is responsible for installing and maintaining

erosion control measures during construction.


proposed drainage system. Contractor to provide

engineer with downspout locations prior to installation

hydraulic conductivity. Client may obtain a site specific

test for hydraulic conductivity prior to exfiltration trench

Total Volume Retained in Trenches = 1,085 cu.ft.

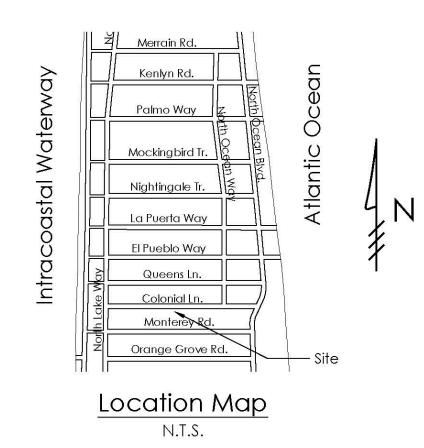

Legend



EXISTING ELEVATION PER WALLACE SURVEYING CORP. (NAVD-88)

PROPOSED ELEVATION (NAVD-88)


---7.00--- PROPOSED ELEVATION CONTOUR (NAVD-88)

FLOW DIRECTION

EXFILTRATION TRENCH

AREA DRAIN

24" NYLOPLAST DRAIN BASIN WITH BAFFLE

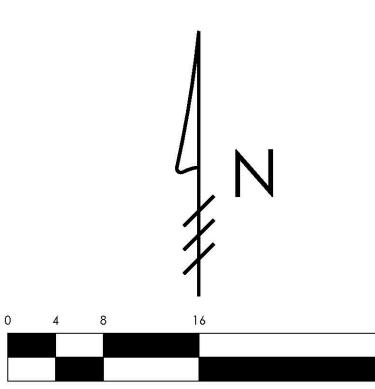

Scale: 1/8" = 1'-0"

Grading & Drainage Plan tual Site

SIDEN

GRUBER

6 561.312.2041

CONSULTING

2475 Mercer Avenue, Suite 305 West Palm Beach, FL 33401

□ office@gruberengineers.com

48 HOURS BEFORE DIGGING,

CALL 1-800-432-4770

CALL OF FLORIDA, INC.

Contractor is responsible for

obtaining location of existing

utilities prior to commencement of construction activities.

SUNSHINE STATE ONE

ENGINEERS

Δ

PROJECT INFORMATION: Project No. | 2024-0022

Issue Date 05/10/2024

1/8" = 1'-0"

Scale

REVISIONS:

CHAD M. GRUBER

FLORIDA P.E. NO. 57466 Digitally signed by Chad M

* No. 57466 * Gruber ∰ Date: 2024.05.08 17:29:55 -04'00'

signed and sealed by Chad M. Gruber on the date adjacent to the seal using a SHA authentication code. Printed copies of this document are not considered signed and sealed and the SHA authentication code must be verified on any electronic copies.

SHEET NUMBER:

ARC-24-004 ZON-24-005

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Plan Background from Hardscape Plan by SMI Landscape Architecture Received 5/7/24

C. PROPOSED EXFILTRATION TRENCH SIZING 1) Exfiltration trenches and storm piping to be protected

Total Length of Trench Provided = 66 ft = 14 ft W = Trench Width Hydraulic Conductivity = 0.00005 cfs/sq.ft./ft. of head = 1.50 ft H2 = Depth to Water Table

DU = Un-Saturated Trench Depth = 1.00 ft DS = Saturated Trench Depth

V = Volume Treated

Trench #2


= 0.00005 cfs/sq.ft./ft. of head

= 1.00 ft DS = Saturated Trench Depth = 307 cu.ft. V = Volume Treated

SCALE: 1/2" = 1'-0"

The Hunt Residence

260 Colonial Lane Palm Beach, Florida

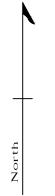

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FOOTINGS FOR ALL STRUCTURES TO BE AT LEAST 3' BELOW GRADE TO ALLOW FOR PLANTINGS / ROOT BALLS

-DRIP IRRIGATION MAY ONLY BE USED IF SPECIFIED BY SMI OR IF REQUIRED BY MUNICIPALITY

4 05.10.2024 FINAL SUBMITTAL 3 04.29.2024 SECOND SUBMITTAL 2 04.11.2024 FIRST SUBMITTAL

1 04.01.2024 PRE-APPLICATION

Call before you dig

DATE DESCRIPTION REVISIONS

FINAL SUBMITTAL

LANDSCAPE ARCHITECTURE 140 Royal Palm Way, Suite #206, Palm Beach, Florida 33480 Telephone: 561-655-9006 Fax: 561-655-9007 eMail: Office@smila.net www.smila.net FL registration #LA 13000223

TITLE Site Plan SCALE PROJECT NUMBER: 1/8" = 1'-0" 2402 DATE: CHECKED: PRJCT MNGR: CFV 05.10.2024 DRAWING NO.

SHEET 1 OF 1

FIELD VERIFY ALL DIMENSIONS



DRIVEWAY

SHELL CONCRETE PAVER



ENTRY WALK

SHELL CONCRETE PAVER



STEPS

DOMINICAN CORAL







AZEK
COLOR: REFER TO ARCHITECT'S SHUTTER COLOR

LANDSCAPE ARCHITECT TO APPROVE LAYOUT OF ALL HARDSCAPE MATERIAL PRIOR TO INSTALLATION



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260 Colonial Lane Palm Beach, Florida

North

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NOTES: -FOOTINGS FOR ALL STRUCTURES TO BE AT LEAST

BY SMI OR IF REQUIRED BY MUNICIPALITY

3' BELOW GRADE TO ALLOW FOR PLANTINGS / ROOT BALLS -DRIP IRRIGATION MAY ONLY BE USED IF SPECIFIED

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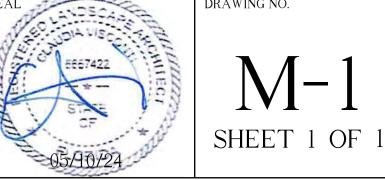
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SMI

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140 Royal Palm Way, Suite #206, Palm Beach, Florida 33480
Telephone: 561-655-9006 Fax: 561-655-9007
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TITLE		
Materia	ls She	et
SCALE	PROJECT NUMBI	ER:
None	24	02
DATE:	PRJCT MNGR:	CHECKED
05.10.2024	CFV	CFV
SEAL	DRAWING NO.	





ABBREVIATIONS KEY
DIA = DIAmeter
DR = Dominican Republic

MAX = MAXImum


HS = HardScape
HT = HeighT
LA = Landscape Architect
LS = LandScape


MIN = MINimum

SMI = SMI Landscape Architecture

TBD = To Be Determined

SMI TO APPROVE LAYOUT OF ALL HARDSCAPE MATERIAL PRIOR TO INSTALLATION

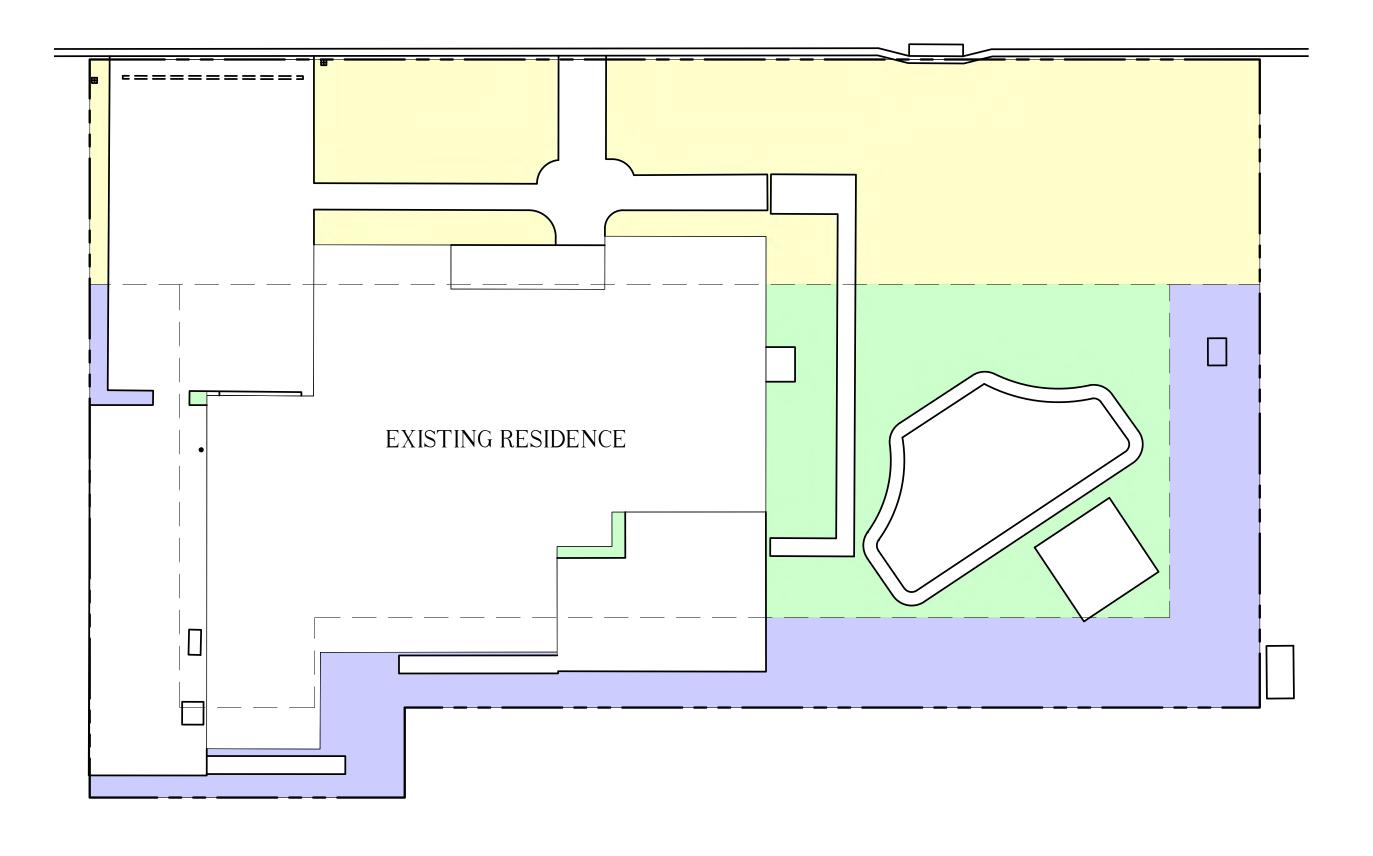

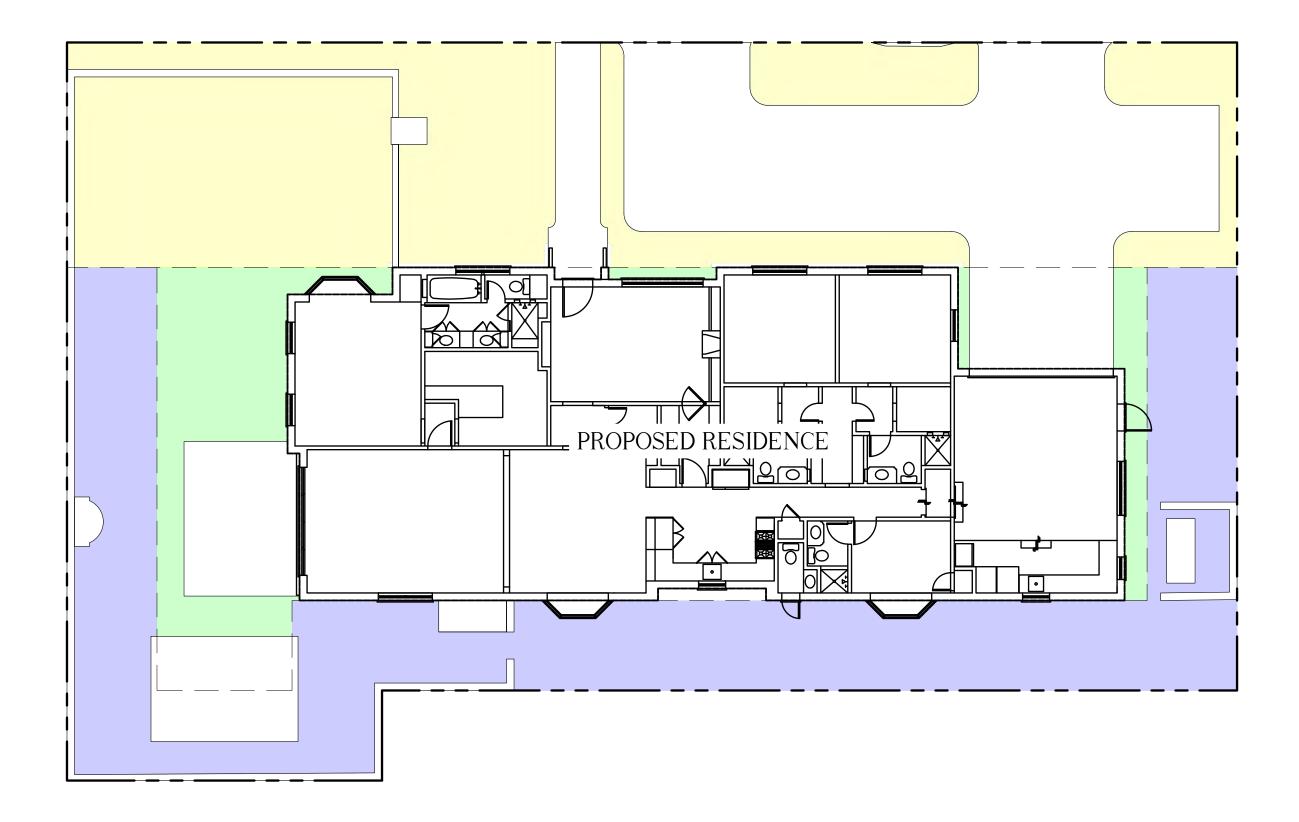


EXISTING SITE PLAN

PROPOSED SITE PLAN

Existing Color Key



Proposed Color Key

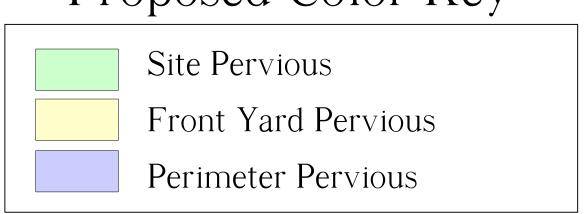

Pervious / Impervious Calculations: RB							
Lot Size Dwelling 1 Floor		Require	Required Pervious		ervious	Proposed F	Pervious
9,710 sf	3,173 sf	Square Footage	Percentage	Square Footage	Percentage	Square Footage	Percentage
Overall Hardsca	ape (Impervious)	4,370	45%min (or Existing)	4,471	46%	4,392	45%
Front Yard Calculations							
25' Setback Area	Hardscape (Impervious)	1,300	40%min (or Existing)	2,111	65%	1,827	56%
3,250 sf	1,423 sf						
Perimeter Hardscape 10' Offset from PL / Area Hardscape (Impervious)			50% of required open				
		2,185 space shall be within	1,337	31%	2,934	67%	
3,840 sf	906 sf		10' of property line				

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ROOT BALLS -DRIP IRRIGATION MAY ONLY BE USED IF SPECIFIED

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The

Hunt

Residence

260 Colonial Lane

Palm Beach, Florida

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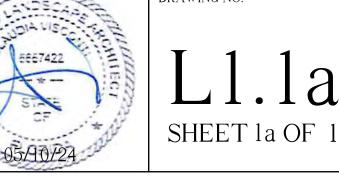
FINAL SUBMITTAL

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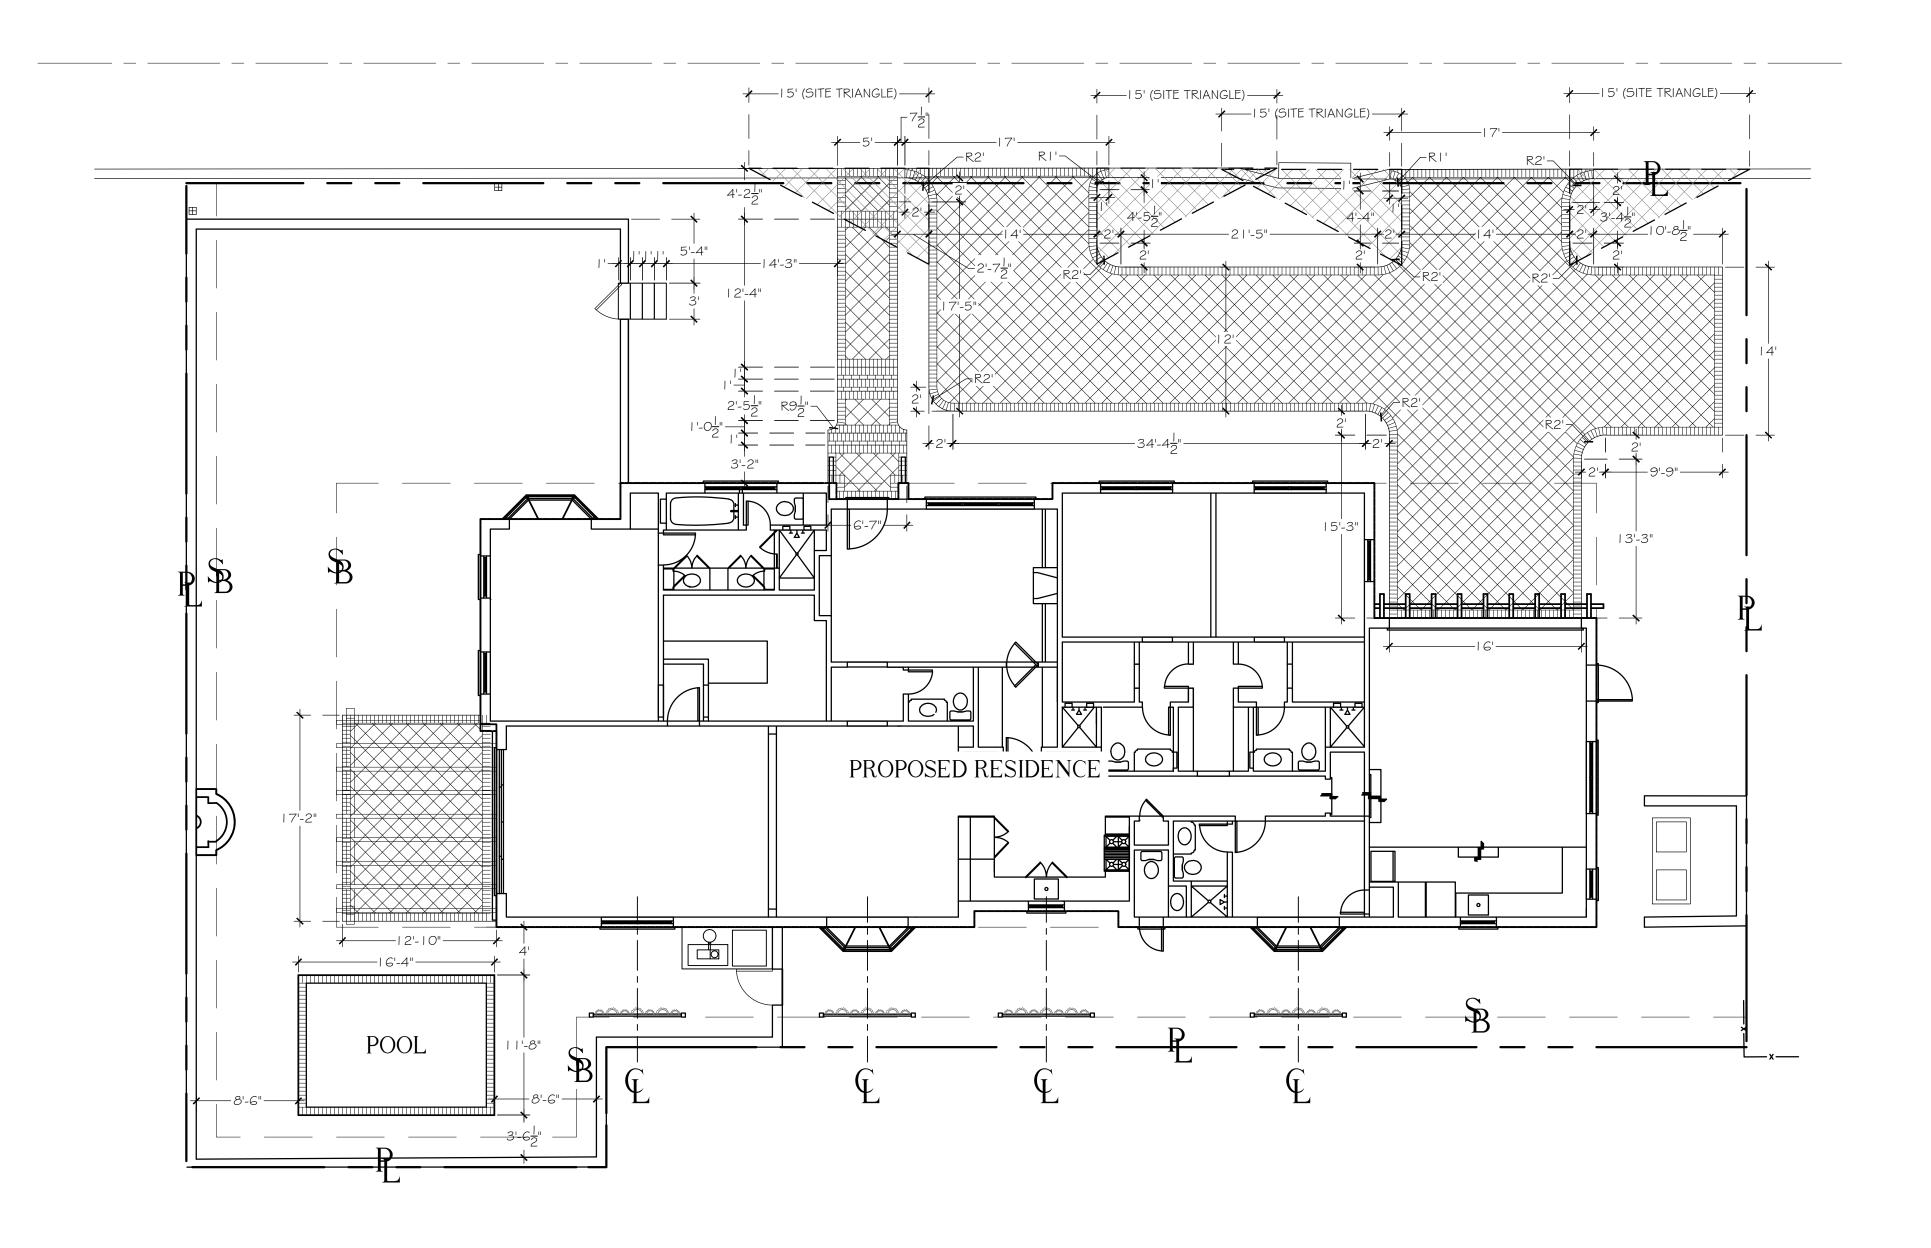
Site Comparison Plan				
SCALE	PROJECT NUMBER:			
3/32" = 1'-0"	24	02		
DATE:	PRJCT MNGR:	CHECKED.		

CFV CFV 05.10.2024 DRAWING NO.









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SMI =SMI Landscape Architecture TBD =To Be Determined


TC =Terra Cotta THK =THICK
TYP =TYPICAL

GRADING

BOS =Bottom Of Steps
ELEV =ELEVation
FFE =Finished Floor Elevation
TOS =Top Of Steps
TOW =Top Of Wall

The Hunt Residence

260 Colonial Lane Palm Beach, Florida

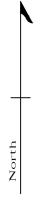

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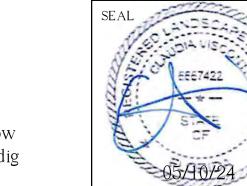
LANDSCAPE ARCHITECTURE 140 Royal Palm Way, Suite #206, Palm Beach, Florida 33480 Telephone: 561-655-9006 Fax: 561-655-9007 eMail: Office@smila.net www.smila.net FL registration #LA 13000223

TITLE

Layout Plan

SCALE PROJECT NUMBER: 1/8" = 1'-0" 2402 DATE: PRJCT MNGR: CHECKED: 05.10.2024 CFV DRAWING NO.

SHEET 2 OF 1





SMI TO APPROVE LAYOUT OF ALL HARDSCAPE MATERIAL PRIOR TO INSTALLATION



Surrounding Property Map - Colonial Lane



Subject Prpoerty -260 Colonial



270 Colonial



266 Colonial



292 Colonial



242 Colonial



232 Colonial



248 Colonial



1123 N lake Way



The Hunt Residence

260 Colonial Lane Palm Beach, Florida

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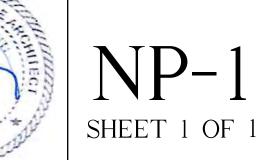
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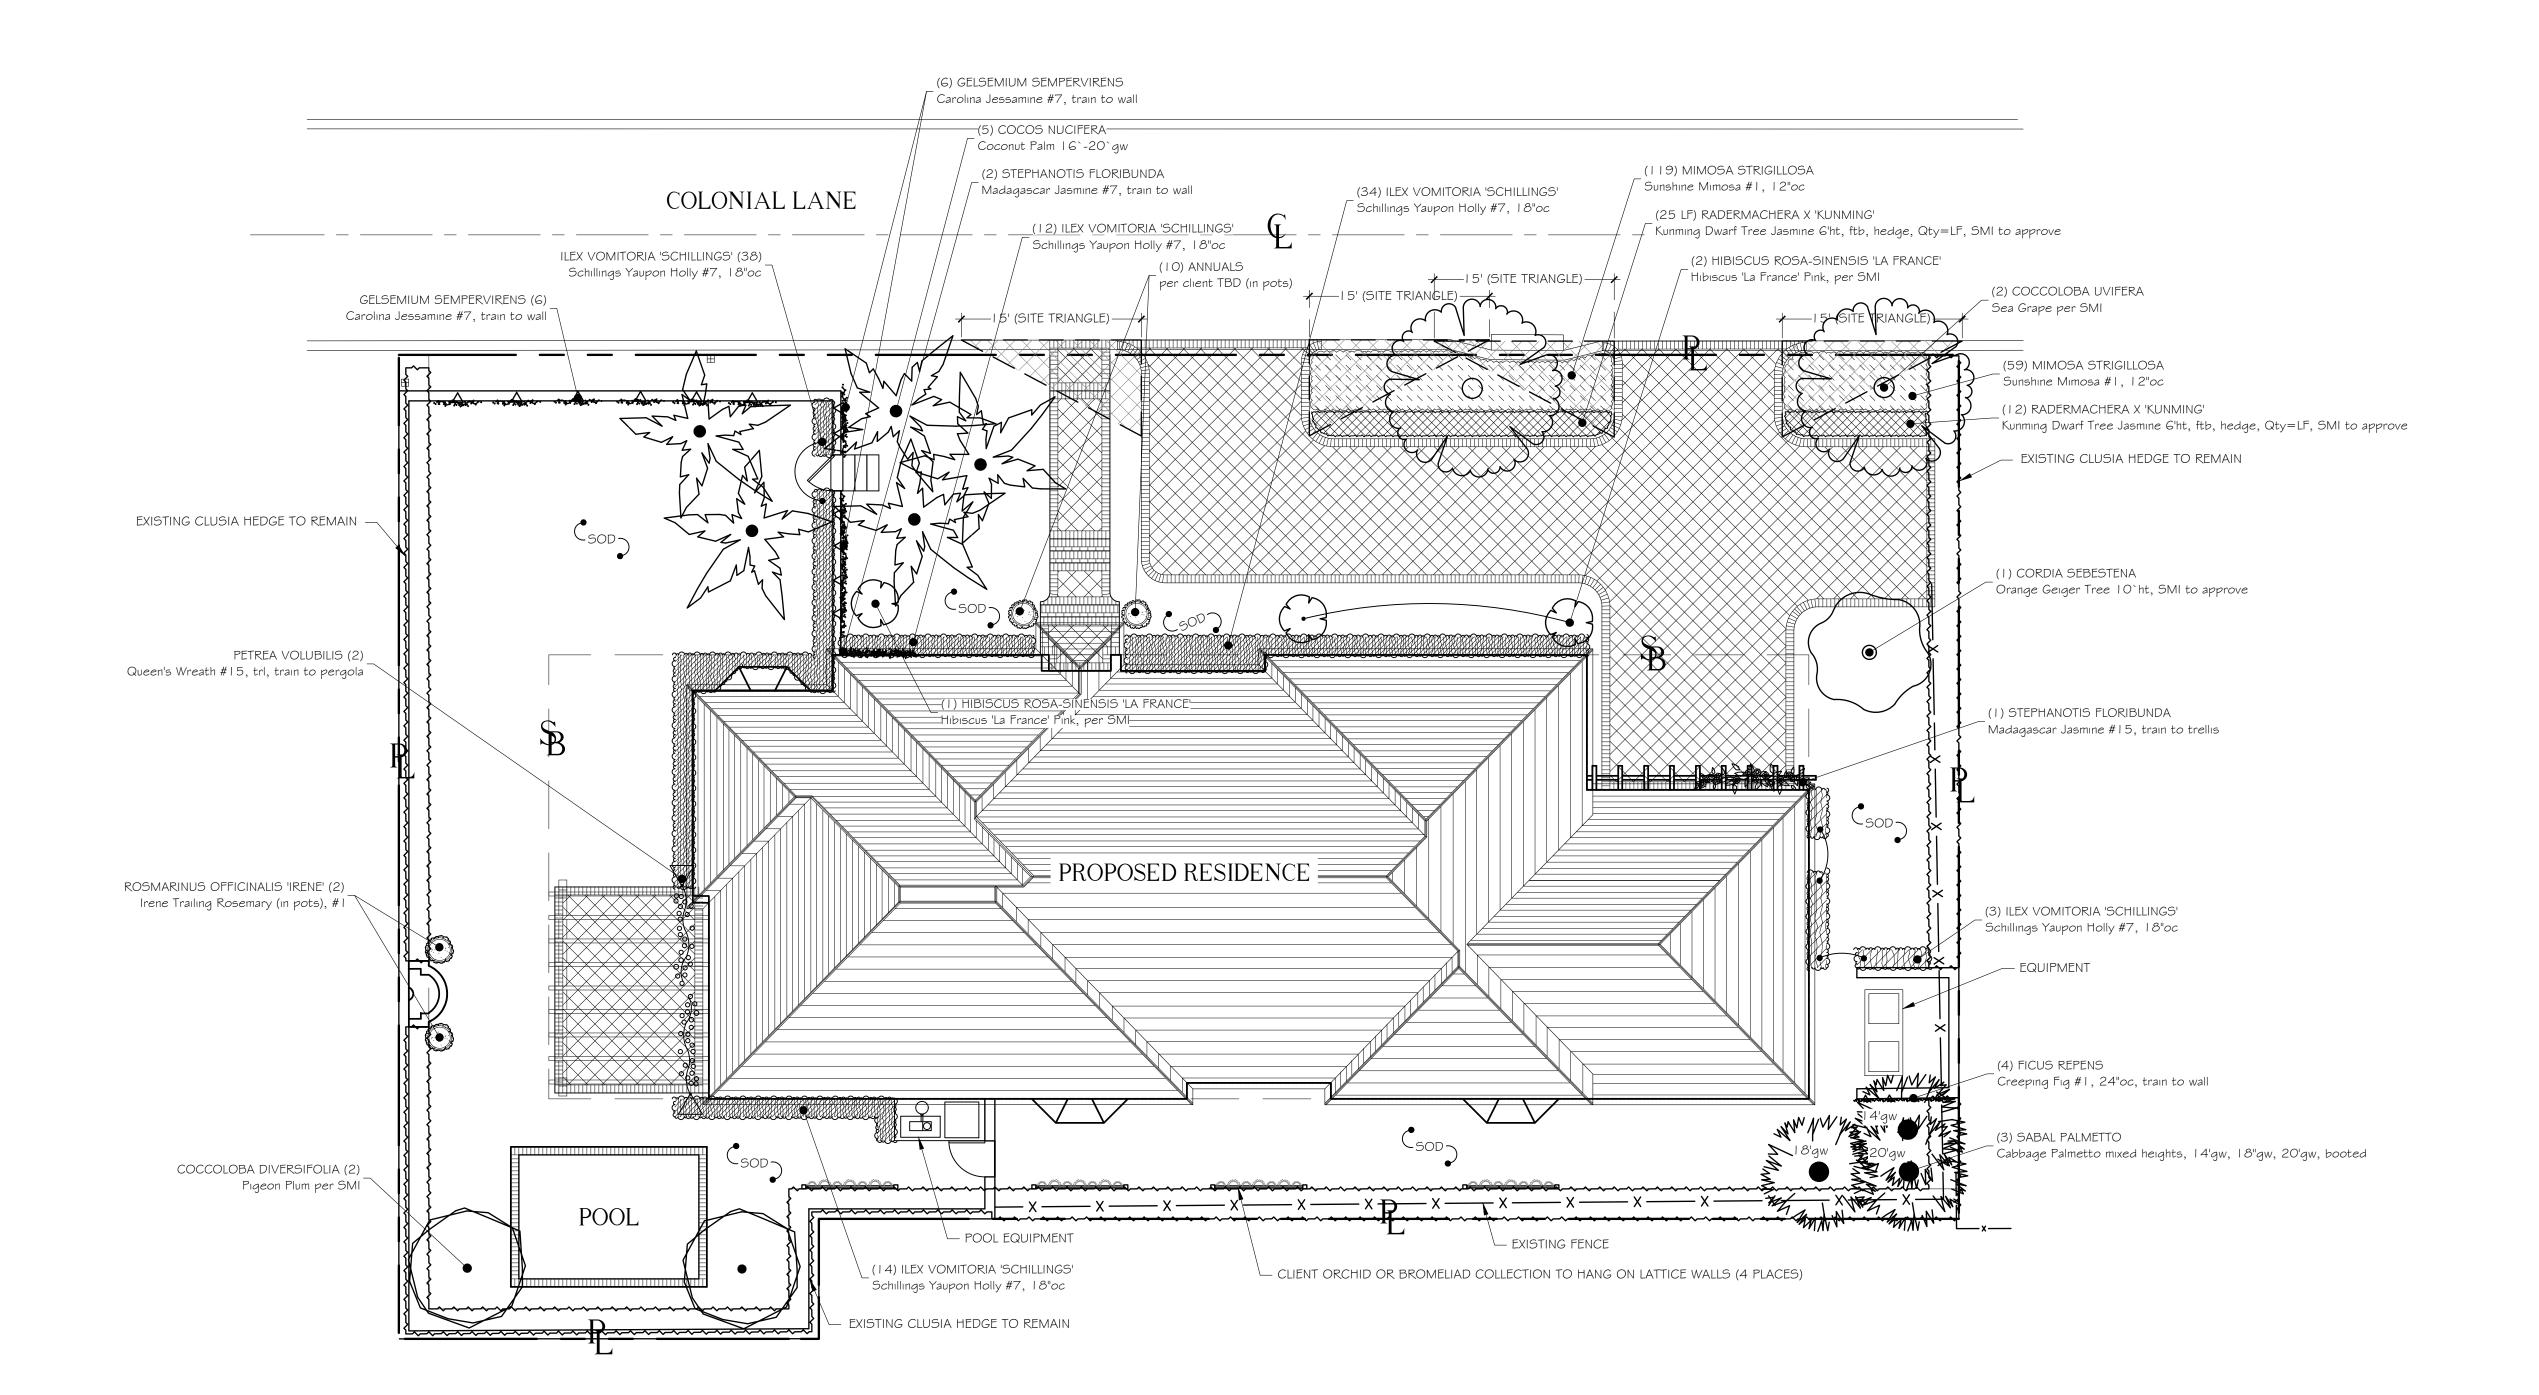
FL registration #LA 13000223

Neighboring Properties

SCALE	PROJECT NUMBER:		
None	24	02	
DATE:	PRJCT MNGR:	CHECKED:	
05.10.2024	CFV	CFV	
SEAL	DRAWING NO.		







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DIA = DIAmeter DR = Dominican Republic

FTB =Full To Base

HS =HardScape HT =HeighT

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GRADING

BOS =Bottom Of Steps

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TOS =Top Of Steps TOW =Top Of Wall

SMI TO APPROVE STAKED LAYOUT OF ALL TREES AND PLANTING LAYOUT PRIOR TO INSTALLATION


ALL IRRIGATION, IRRIGATION EQUIPMENT AND IRRIGATION BOXES TO BE CONCEALED

ALL PLANTING BEDS ABUTTING LAWN TO HAVE METAL EDGE BORDER



The Hunt Residence

260 Colonial Lane Palm Beach, Florida

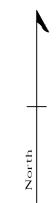

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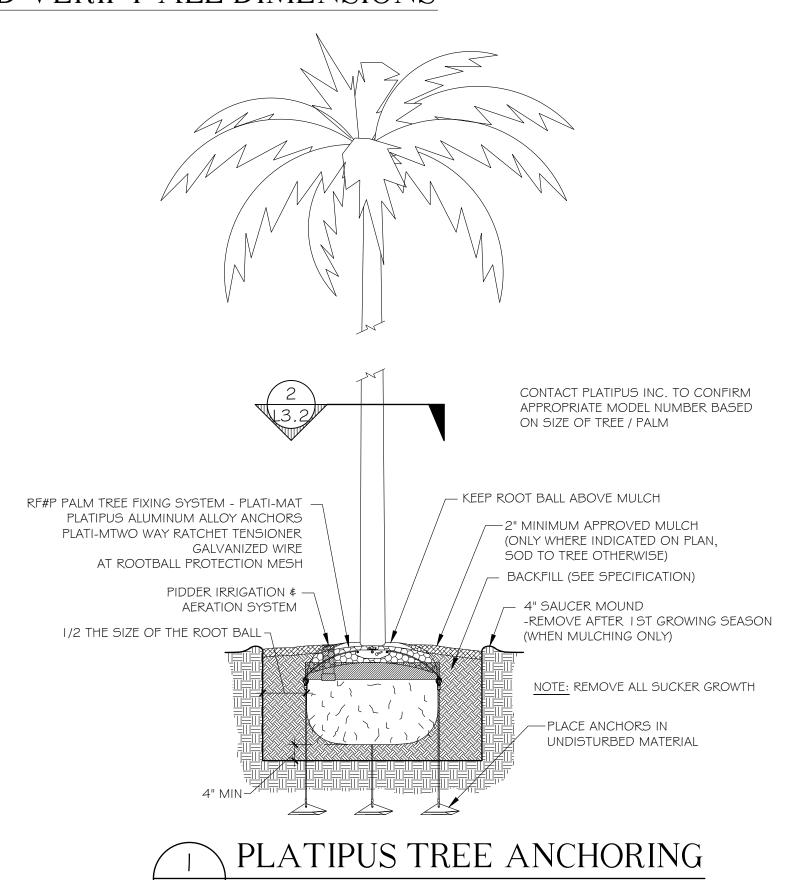
1 04.01.2024 PRE-APPLICATION DATE DESCRIPTION


REVISIONS FINAL SUBMITTAL


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FIELD VERIFY ALL DIMENSIONS






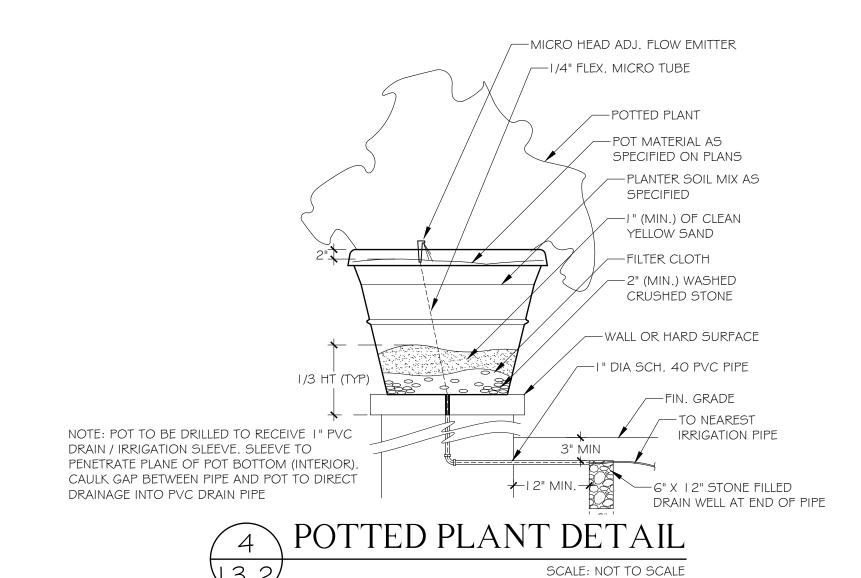


PIN TO WALL

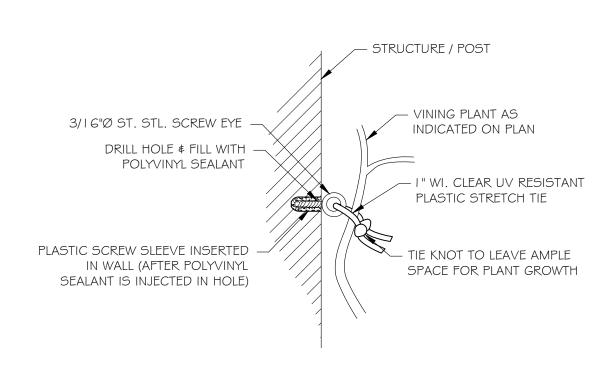

SCALE: NOT TO SCALE

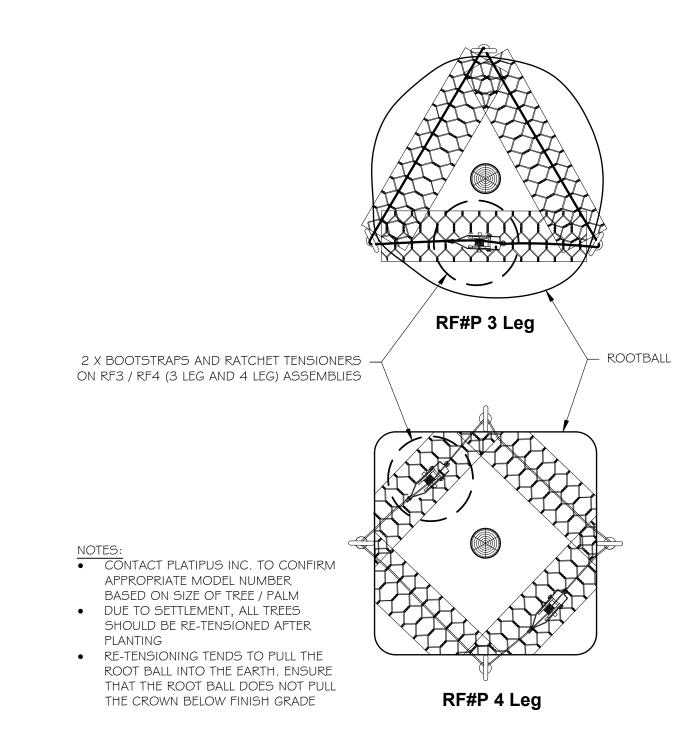

PLATIPUS ROOTBALL BOOTSTRAP 13.2 DETAIL SCALE: NOT TO SCALE

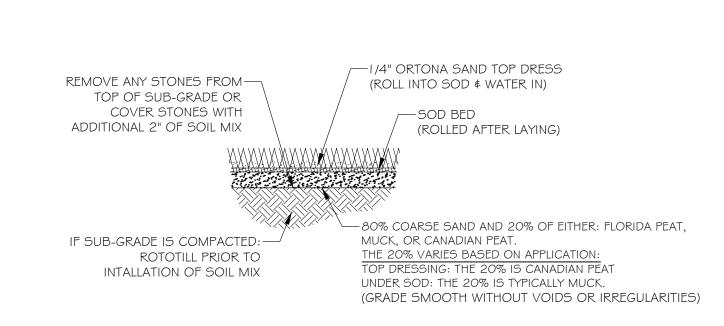


ALL SOD PLANTED BETWEEN STONE TO BE


CASHMERE ZOYSIA REGARDLESS OF

OVERALL SITE SOD TYPE



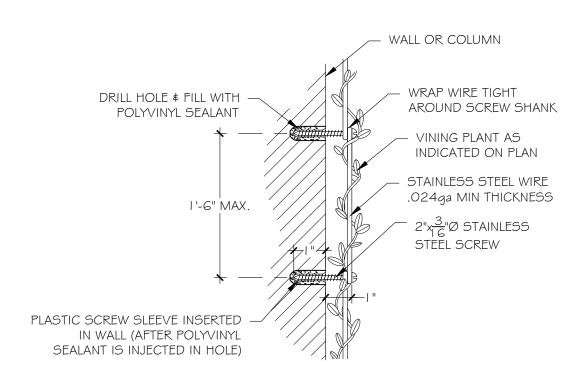

WIRE TO WALL

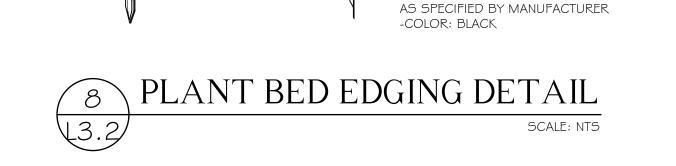

1. 16'-0" (4.9M) SECTIONS TO INCLUDE (5) 12"

2. COMPACT GRADES ADJACENT TO EDGING TO

4. PERMALOC CLEANLINE AS MANUFACTURED BY

AVOID SETTLING. FINISH GRADE TO BE 1/2"

3. CORNERS - CUT BASE OF EDGING UP HALF

WAY AND FORM A CONTINUOUS CORNER

PERMALOC CORPORATION, HOLLAND MI.

1-800-356-9660, 616-399-9600

(30.5CM) ALUMINUM STAKES


(1.3CM) BELOW TOP OF EDGING

ANY/ALL TRACK DRAINS, TRENCH DRAINS AND DRAIN GRATES
TO BE CAST IRON UNLESS OTHERWISE SPECIFIED BY SMI


SMI TO APPROVE STAKED LAYOUT OF ALL TREES AND PLANTING LAYOUT PRIOR TO INSTALLATION

ALL IRRIGATION, IRRIGATION EQUIPMENT AND IRRIGATION BOXES TO BE CONCEALED

ALL PLANTING BEDS TO HAVE STEEL EDGE BORDER

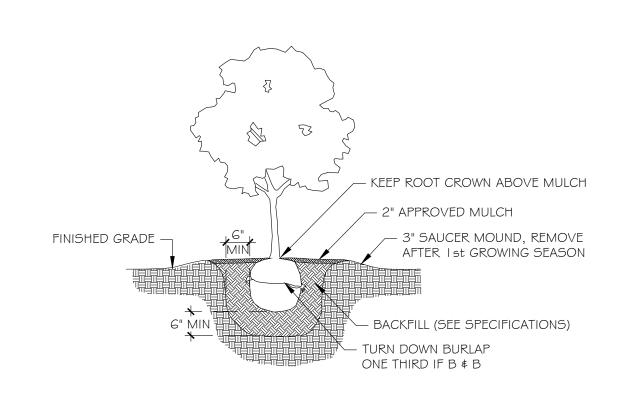

3 SHRUB PLANTING DETAIL SCALE: NOT TO SCALE

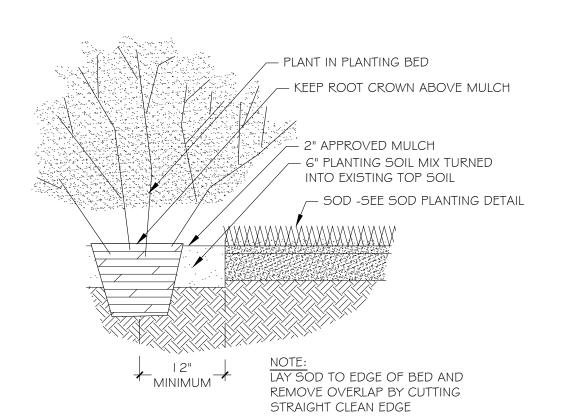



PERMALOC CLEANLINE (OR APPROVED EQUAL)

ALUMINUM LANDSCAPE BED EDGING

- ALUMINUM STAKES TO LOCK INTO

PREFORMED LOOPS ON THE EDGING

1-800-356-9660

BED MEDIA

The Hunt Residence

260 Colonial Lane Palm Beach, Florida

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ROOT BALLS

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SHEET 2 OF 3



FIELD VERIFY ALL DIMENSIONS PLANTING SPECIFICATIONS

PLEASE FURNISH FLORIDA CERTIFIED LANDSCAPE CONTACTORS (FCLC) REGISTRATION NUMBER WITH PROPOSAL.

GENERAL CONDITIONS

SCOPE:

I. THE MORK INCLUDED IN THESE SPECIFICATIONS SHALL CONSIST OF THE FURNISHING OF ALL LABOR, TOOLS, MATERIALS, PERMITS, ETC., NECESSARY FOR THE EXECUTION OF THE WORK AS HEREIN SPECIFIED AND SHOWN ON THE

2. THE LANDSCAPE CONTRACTOR SHALL INSTALL ALL MATERIAL IN ACCORDANCE WITH SOUND NURSERY PRACTICE AND SHALL PERFORM MAINTENANCE AND WATERING UNTIL FINAL COMPLETION AND ACCEPTANCE BY THE LANDSCAPE ARCHITECT.

EXAMINATION OF DRAWINGS AND SITE:

I. THE LANDSCAPE CONTRACTOR SHALL EXAMINE THE SITE AND FULLY ACQUAINT HIMSELF WITH ALL OF THE EXISTING CONDITIONS IN ORDER THAT NO MISUNDERSTANDING MAY AFTERWARDS ARISE AS TO THE CHARACTER OR AS TO THE EXTENT OF THE WORK TO BE DONE, AND LIKEWISE, IN ORDER TO ADVISE AND ACQUAINT HIMSELF WITH ALL PRECAUTIONS TO BE TAKEN IN ORDER TO AVOID INJURY TO PERSONS OR PROPERTY OF ANOTHER. NO ADDITIONAL COMPENSATION WILL BE GRANTED BECAUSE OF ANY UNUSUAL DIFFICULTIES THAT MAY BE ENCOUNTERED IN THE EXECUTION OR MAINTENANCE OF ANY PORTION OF THE WORK. ANY DISCREPANCIES, OR OMISSIONS OR DOUBTS AS TO MEANING SHALL BE COMMUNICATED TO THE LANDSCAPE ARCHITECT, WHO WILL MAKE ANY INTERPRETATIONS HE/SHE DEEMS NECESSARY.

PLANT LIST:

I. ANY DISCREPANCY BETWEEN THE PLANT LIST AND THE DRAWINGS SHALL BE CONSIDERED AS CORRECT ON THE DRAWINGS.

PROTECTION OF PUBLIC AND PROPERTY

I. THE LANDSCAPE CONTRACTOR SHALL PROTECT ALL MATERIALS AND WORK AGAINST INJURY FROM ANY CAUSE AND SHALL PROVIDE AND MAINTAIN ALL NECESSARY GUARDS FOR THE PROTECTION OF THE PUBLIC. HE SHALL BE HELD RESPONSIBLE FOR ANY DAMAGE OR INJURY TO A PERSON OR PROPERTY WHICH MAY OCCUR AS A RESULT OF HIS FAULT OR NEGLIGENCE IN THE EXECUTION OF THE WORK.

2. THE LANDSCAPE CONTRACTOR SHALL MAINTAIN WORKMAN'S COMPENSATION, COMPREHENSIVE GENERAL LIABILITY INSURANCE (\$1,000,000) AND PROPERTY DAMAGE INSURANCE (\$1,000,000.00). A COPY OF THE CERTIFICATE OF INSURANCE MUST BE FURNISHED TO OWNER.

GUARANTEE:

I. THE GUARANTEE PERIOD FOR ALL MATERIAL SHALL BEGIN AFTER FINAL APPROVAL BY LANDSCAPE ARCHITECT

2. ALL MATERIAL EXCEPT SOD SHALL BE GUARANTEED FOR ONE YEAR PROVIDED IT RECEIVES PROPER MAINTENANCE (AS PRESCRIBED BY THE LANDSCAPE CONTRACTOR) BY THE OWNER AND IS NOT DAMAGED OR DESTROYED BY HURRICANES OR OTHER CAUSES BEYOND THE CONTRACTOR'S

3. IT IS THE RESPONSIBILITY OF THE LANDSCAPE CONTRACTOR TO BRING TO THE ATTENTION OF THE LANDSCAPE ARCHITECT THE OWNERS NEGLECT TO PROVIDE PROPER CARE OF THE MATERIAL.

4. ALL REPLACEMENT COST OF GUARANTEED MATERIAL, INCLUDING EQUIPMENT, AND LABOR, SHALL BE THE RESPONSIBILITY OF THE CONTRACTOR

AWARD OF CONTRACT:

I. ONLY UNIT PRICE-INSTALLED BIDS FOR THE WORK WILL BE ACCEPTABLE. HOMEVER, THE OWNER RETAINS THE RIGHT TO DELETE PORTIONS OF THE WORK FROM THE CONTRACT AND/OR AWARD SEPARATE CONTRACTS FOR PHASES OF THE PROJECT. THE LANDSCAPE ARCHITECT RESERVES THE RIGHT TO REJECT ANY AND ALL BIDS WHEN SUCH REJECTIONS ARE IN THE INTEREST OF THE

EXECUTION OF THE WORK:

I. THE LANDSCAPE CONTRACTOR SHALL HAVE HIS LABOR CREMS CONTROLLED AND DIRECTED BY A LANDSCAPE FOREMAN WELL VERSED IN PLANT MATERIALS, PLANTING, READING OF BLUEPRINTS AND COORDINATION BETWEEN JOB AND NURSERY IN ORDER TO EXECUTE INSTALLATION RAPIDLY AND CORRECTLY.

MATER:

I. WATER SOURCE SHALL BE FURNISHED BY THE OWNER

2. IT IS THE RESPONSIBILITY OF THE LANDSCAPE CONTRACTOR TO COORDINATE HIS WORK WITH IRRIGATION CONTRACTOR.

3. ALL PLANT MATERIAL INSTALLED PRIOR TO THE INSTALLATION OF THE IRRIGATION SYSTEM SHALL BE WATERED WITH A TEMPORARY SYSTEM BY THE LANDSCAPE CONTRACTOR.

IRRIGATION:

-DRIP IRRIGATION MAY ONLY BE USED IF SPECIFIED BY SMI OR IF REQUIRED BY MUNICIPALITY

GRADING:

I. THE GENERAL CONTRACTOR SHALL BE RESPONSIBLE FOR ALL SUBGRADE OF LANDSCAPE AREAS UNLESS OTHERWISE SPECIFIED. THE TERM SUBGRADE SHALL BE DEFINED AS 4"-6" BELOW FINISH GRADE UNLESS OTHERWISE NOTED ON PLANS.

2. THE LANDSCAPE CONTRACTOR SHALL BE RESPONSIBLE FOR ALL FINISHED AND FINE GRADING WITHIN PLANTER BEDS AND THE FILLING OF PLANTER BOXES. THE LANDSCAPE CONTRACTOR SHALL REMOVE ALL EXCESS SOIL AND DEBRIS ACCUMULATED DURING HIS WORK.

3. THE SOD CONTRACTOR SHALL BE RESPONSIBLE FOR FINISH GRADE IN ALL SODDED AREAS. SEE SPECIFICATIONS RELATING TO SPECIES GROWERS.

> TO PROTECT AGAINST GANODERMA PALM FUNGUS ALWAYS REMOVE ALL PALM STUMPS FROM PROPERTY - STUMPS ACT AS HOSTS TO THIS DESTRUCTIVE LONG LIVED FUNGUS.

DIGGING

I. THE LANDSCAPE CONTRACTOR SHALL EXERCISE CARE IN DIGGING AND OTHER WORK SO AS NOT TO DAMAGE EXISTING WORK, INCLUDING UNDERGROUND AND OVERHEAD PIPES AND CABLES. SHOULD SUCH UNDERGROUND AND OVERHEAD OBSTRUCTIONS BE ENCOUNTERED WHICH INTERFERE WITH PLANTING, THE LANDSCAPE ARCHITECT OR THE OWNER'S AUTHORIZED REPRESENTATIVE SHALL BE CONSULTED AND WILL ADJUST THE LOCATION OF PLANTS TO CLEAR SUCH OBSTRUCTION OR MOVE THE OBSTRUCTION.

2. THE LANDSCAPE CONTRACTOR SHALL BE RESPONSIBLE FOR THE IMMEDIATE REPAIR OF ANY DAMAGE CAUSED BY HIS WORK. PLANTING PITS

I. EXCAVATE CIRCULAR PITS WITH VERTICAL SIDES FOR ALL PLANTS, EXCEPT FOR HEDGES AND PLANTS SPECIFICALLY DESIGNATED TO BE PLANTED IN BEDS. DIAMETER OF PITS OF TREES AND SHRUBS SHALL BE AT LEAST 1/3 LARGER THAN THE DIAMETER OF THE BALL

2. EXCAVATE PLANTING PITS AND PLANTING BEDS, PREPARE FINE SUBGRADE THROUGHOUT ALL PITS AND BEDS, AND PLACE THE PLANTS TO BE PLANTED FOR APPROVAL BY LANDSCAPE ARCHITECT BEFORE INSTALLATION.

PRUNING

I. REMOVE DEAD AND BROKEN BRANCHES FROM ALL PLANT MATERIAL IMMEDIATELY. PRUNE TO RETAIN TYPICAL GROWTH HABIT OF INDIVIDUAL PLANTS WITH AS MUCH HEIGHT AND SPREAD AS IS PRACTICAL.

2. HEDGE MATERIALS TO BE PULLED IN TIED AND TRIMMED TO VERTICAL AFTER INSTALLATION, WITH A FINISHED APPEARANCE UNLESS OTHERWISE NOTED.

TREE BRACING AND GUYING

REMEMBER TO CONSIDER SOIL CONDITIONS WHEN PLANTING TREES IN MADE UP GROUND AND THE NEED TO PLACE THE ANCHORS IN A UNDISTURBED MATERIAL. IF SO, YOU CAN ORDER 'ED' KITS (EXTRA DEPTH). TO ALLOW FOR THIS YOU MAY ALSO NEED A LONGER DRIVE ROD.

2. THE ANCHOR SHOULD BE DRIVEN TO THE FULL WORKING DEPTH USING A SUITABLE DRIVE ROD.

3. YOU MUST LOADLOCK THE ANCHORS PROPERLY INTO THEIR WORKING POSITION, BY APPLYING AN UPWARDS FORCE / LOAD ON THE WIRE TENDON.

4. IF THE ANCHORS ARE NOT LOADLOCKED PROPERLY, THE TREE WILL BECOME LOOSE WHEN THE FIRST WINDS ARRIVE.

5. PALM TREE ROOTBALLS MUST BE A MINIMUM OF 5'DIAMETER, PROPERLY ROOT WRAPPED AND OF SUFFICIENT STRENGTH AND PROPORTION TO SUPPORT A ROOTBALL FI XING METHOD. THE CORRECT PALM TREE KIT REQUIRED MUST BE SPECIFIED BY THE LANDSCAPE ARCHITECT ONCE THE ROOTBALL DIMENSIONS,

6.THE D-MAN CELLS / DEADMEN SHOULD BE INSTALLED AT LEAST 12" BELOW THE BASE OF THE ROOTBALL WITH THE SOIL COMPACTED ABOVE THE CELLS TO 60%, RIGHT UP TO THE NURSERY LINE.

TREE HEIGHT AND SAIL AREA OF THE TREE HAVE BEEN ESTABLISHED.

7.IT IS NOT ADVISABLE TO USE STRAP SYSTEMS FOR CONTAINER GROWN STOCK (SEE PLATI-MAT SYSTEMS).

8. DUE TO SETTLEMENT OF THE TREE & AFTER WATERING RE-TENSIONING IS HIGHLY RECOMMENDED.

9. REFER TO MANUFACTURERS SPECIFICATIONS FOR COMPLETE INSTALLATION INSTRUCTIONS AT WWW.PLATIPUS.US.

IO. SMALL TREES SHALL BE GUYED IN THREE DIRECTIONS WITH THREE STRANDS OF NO. 12 GALVANIZED WIRE ATTACHED TO ANCHORS DRIVEN BELOW GRADE. WIRES WHICH COME IN CONTACT WITH THE TREE ARE TO BE ENCASED IN RUBBER

PLANT MATERIALS

. NOMENCLATURE: PLANT NAMES SHALL CONFORM TO THE NAMES GIVEN IN HORTUS III AND IN STANDARDIZED PLANT NAMES, 2001, LATEST EDITION. PREPARED BY THE AMERICAN JOINT COMMITTEE ON HORTICULTURAL NOMENCLATURE. NAMES OF VARIETIES NOT INCLUDED THEREIN, CONFORM GENERALLY WITH NAMES ACCEPTED IN THE NURSERY TRADE.

2. QUALITY: PLANTS SHALL HAVE A HABIT OF GROWTH THAT IS NORMAL FOR THE SPECIES AND SHALL BE SOUND, HEALTHY, VIGOROUS AND FREE FROM INSECT PESTS, PLANT DISEASES AND INJURIES. TREES SHALL BE HEAVILY BRANCHED, OR IN PALMS, HEAVILY LEAFED. REQUIREMENTS FOR THE MEASUREMENT, BRANCHING GRADING, QUALITY, BALLING AND BURLAPPING OF PLANTS IN THE PLANT LISTS GENERALLY FOLLOW THE CODE OF STANDARDS CURRENTLY RECOMMENDED BY THE AMERICAN ASSOCIATION OF NURSERYMEN, INC., AND THE AMERICAN STANDARD FOR NURSERY STOCK. PLANT MATERIAL SHALL BE GRADED AS SPECIFIED ON THE DRAWINGS.

GRADES SHALL CONFORM TO GRADES AND STANDARDS FOR NURSERY STOCK, STATE PLANT BOARD OF FLORIDA. PALMS WITH MARRED OR BURNED TRUNKS WILL NOT BE ACCEPTED. PLANTS WITH BROKEN, DAMAGED, OR INSUFFICIENT BALLS WILL BE REJECTED. ALL PLANTS SHALL BE FLORIDA FANCY.

3. SUBSTITUTIONS WILL BE PERMITTED ONLY UPON WRITTEN APPROVAL BY THE LANDSCAPE ARCHITECT

PLANTING SOIL

SOIL BY 'ATLAS SOIL' OR APPROVED ALTERNATE

ALL PLANTING AREAS SHALL BE CLEANED OF ALL PLANT AND MATERIAL TWO WEEKS PRIOR TO INSTALLATION OF SOIL FOR REMOVAL OF ANY WEEDS.

GROUND COVER BEDS -REMOVE 6" OF EXISTING SOIL AND FILL WITH 4" OF 8270 MIX & TILL/MIX INTO EXISTING SOIL.

SHRUB BEDS -REMOVE 6" OF EXISTING SOIL AND FILL WITH A MIX OF 50% APPROVED SOIL \$ 50% EXISTING SOIL.

TREE PITS -REMOVE SOIL IN THE AMOUNT OF 1/2 LARGER THAN THE BALL OF THE TREE AND REPLACE WITH A MIX OF 50% APPROVED SOIL \$ 50% EXISTING SOIL.

PALMS -REMOVE SOIL IN THE AMOUNT OF 1/2 LARGER THAN THE BALL OF THE PALM AND REPLACE WITH APPROPRIATE SOIL AND CLEAN YELLOW SAND FREE OF WEEDS. SOIL SPECS FOR TREES AND LARGE SHRUBS: SMILA SOIL MIX (APPROVED SOIL)

SOIL SPECS FOR PLANTING BEDS: ATLAS PEAT & SOIL 8270 MIX 20% can peat 25% fla peat 40% pine bark 15% airlite

50% Pinebark 40% Florida Peat 10% Coarse Sand 10lbs Dolomite per/Yard 18.51bs TurfPro per/Yard 25 pounds Nutricote 18/6/8-360 P/yard <u>optional</u>

I. SOLE SOURCE - FROM ATLAS PEAT & SOIL INC., P.O. BOX 3867, BOYNTON BEACH, FLORIDA, 33424-3867, (561) 734-7300

SOIL UNLESS OTHERWISE SPECIFIED ON THE DRAWINGS.

PLANTING SOIL NOT MEETING THESE REQUIREMENTS WILL NOT BE ACCEPTED. I. SOIL FOR PLANTING TREES, SHRUBS AND GROUND COVER SHALL BE SMILA

2. IT SHALL BE THE RESPONSIBILITY OF THE LANDSCAPE CONTRACTOR TO REMOVE ANY EXCESS SOIL AND DEBRIS FROM THE SITE. REFER TO THE GRADING PLAN AND GRADING SPECIFICATIONS.

3. LANDSCAPE ARCHITECT MAY REQUEST SOIL ANALYSIS FOR THE TESTING OF PLANTING SOIL UTILIZED BY THE SELECTED LANDSCAPE CONTRACTOR.

FERTILIZER

I. TREES USE ONE 21 GRAM AGRIFORM PLANTING TABLET PER I/2" TRUNK DIAMETER. SPACE EQUALLY AROUND AT 2/3 DEPTH OF BALL

2. SHRUBS: AGRIFORM PLANTING TABLETS SHALL BE APPLIED PER THE MANUFACTURERS SUGGESTED APPLICATION RATES.

3. SOD USE FERTILIZER AS PER BELOW WITH TRACE ELEMENTS APPLIED AT THE RATE OF 15 LBS. PER 1000 SQ. FT. PRIOR TO LAYING SOD.

4. POWDERED MYCCHORIZAE MIX; DIE HARD, 'PLANT HEALTH' CARE OR EQUAL) AND LIQUID B-THRIVE (OR EQUAL) SHOULD BE ADDED TO ALL TREES, SHRUBS AND GROUND COVER PLANTING BEDS AS PER MANUFACTERES DIRECTIONS.

5. ALL TREES, SHRUBS, GROUND COVER AND SOD TO USE LESCO 13-3-13 FERTILIZER AS PER MANUFACTURERS SPECIFICATIONS

ALL MULCH FOR THE PROJECT SHALL BE ATLAS GROW. MULCH SHALL BE APPLIED 2" IN TREES AND PALMS AS SPECIFIED, AND ALL PLANTING BEDS, HEDGE AND SHRUBS. KEEP CROWN OF ROOT BALL ABOVE

SOLE SOURCE - FROM ATLAS PEAT & SOIL INC., P.O. BOX 3867, BOYNTON BEACH, FLORIDA, 33424-3867, (561) 734-7300

SUBMIT BAG TO LANDSCAPE ARCHITECT FOR APPROVALS.

SABAL PALMS

I. SABAL PALMS SHALL HAVE A MINIMUM TRUNK DIAMETER OF 12" MEASURED 2' ABOVE GROUND.

HEDGES

I. THE LANDSCAPE CONTRACTOR SHALL PROVIDE <u>FULL</u> MATERIAL TO PRODUCE A SOLID SCREEN FROM THE TOP OF HEDGE TO THE BASE OF HEDGE.

2. THE LANDSCAPE CONTRACTOR SHALL BE RESPONSIBLE TO ADD FILLERS TO THE HEDGE AS NEEDED TO PRODUCE A SOLID FULL TO BASE (F.T.B.), SCREEN TO BE INCLUDED IN THE CONTRACTED PRICE. 3. PLANT MATERIAL WITH WEAK OR THIN FOLIAGE WILL NOT BE ACCEPTED

VINES

I. MATERIALS & INSTALLATION OF VINE SUPPORTS SHALL BE INCLUDED IN UNIT COST OF VINE SPECIFIED

I. THE LANDSCAPE CONTRACTOR SHALL SOD ALL AREAS INDICATED AND NOTED ON THE DRAWINGS.

2. NO SODDING SHALL OCCUR UNTIL ALL AREAS TO BE SODDED ARE CLEARED OF ANY ROUGH GRASS, WEEDS, AND DEBRIS, THE GROUND BROUGHT TO AN EVEN GRADE AND SPECIFIED AMENDMENTS HAVE BEEN ADDED. SEE DETAILS FOR SPECIFIC AMENDMENTS AS PER SOD TYPE. ALL SODDED AREAS WILL BE TREATED WITH 'ROUNDUP' HERBICIDE PER MANUFACTURER'S SPECIFICATIONS AT LEAST TEN DAYS PRIOR TO SOD INSTALLATION.

3. THE SOD SHALL BE FIRM, TOUGH TEXTURE, HAVING A COMPACTED GROWTH OF GRASS WITH GOOD ROOT DEVELOPMENT. IT SHALL CONTAIN NO NOXIOUS WEEDS, OR ANY OTHER OBJECTIONABLE VEGETATION, FUNGUS, INSECTS OR DISEASE. PREPARATION OF AREAS SHALL BE PERFORMED WELL ENOUGH IN ADVANCE TO ALLOW SUFFICIENT TIME TO WORK PROPERLY. THE SOIL EMBEDDED IN THE SOD SHALL BE GOOD, CLEAN EARTH, FREE FROM STONES AND DEBRIS. THE SOD SHALL BE FREE FROM FUNGUS, VERMIN, AND OTHER DISEASES.

4. BEFORE BEING CUT AND LIFTED, THE SOD SHALL HAVE BEEN MOWED AT LEAST THREE TIMES WITH A LAWN MOMER, WITH THE FINAL MOWING NOT MORE THAN SEVEN DAYS BEFORE THE SOD IS CUT. THE SOD SHALL BE CAREFULLY CUT INTO UNIFORM DIMENSIONS.

5. SOLID SOD SHALL BE LAID WITH CLOSELY ABUTTING JOINTS WITH A TAMPED OR ROLLED EVEN SURFACE.

CLEAN UP

I. THE LANDSCAPE CONTRACTOR SHALL AT ALL TIMES KEEP THE PREMISES

HIS EMPLOYEES OR WORK. HE SHALL LEAVE ALL PAVED AREAS "BROOM

2. MARKS AND DAMAGE TO EXISTING PAVING MATERIALS SHALL BE THE

ALL PALMS, TREES, AND LARGE SPECIMEN PLANTS SHALL BE STAKED BY THE

LANDSCAPE CONTRACTOR FOR LA APPROVAL OF LAYOUT AND LOCATIONS

OZ 48 96

01 09

0 00 0

04 0

CLEAN" WHEN COMPLETED WITH THE WORK.

TREE STAKE PAINT FORMULA:

PRIOR TO INSTALLING SAME.

THALO GREEN

LAMP BLACK

SUBMIT SAMPLE

YELLOW OXIDE

RESPONSIBILITY OF THE LANDSCAPE CONTRACTOR.

BEHR PREMIUM PLUS EXT FLAT -ACCENT BASE (4670)

02

FREE FROM ACCUMULATIONS OF WASTE MATERIALS OR RUBBISH CAUSED BY

6. WATERING SHALL BE ACCOMPLISHED UNTIL ACCEPTANCE OF THE WORK BY THE LANDSCAPE ARCHITECT

7. MAINTENANCE OF MATERIAL SHALL BE THE RESPONSIBILITY OF THE LANDSCAPE CONTRACTOR UNTIL FINAL APPROVAL OF LANDSCAPE ARCHITECT.

8. IT SHALL BE THE RESPONSIBILITY OF THE LANDSCAPE CONTRACTOR TO BRING THE SOD EDGE IN A NEAT, CLEAN MANNER TO THE EDGE OF ALL PAVING AND SHRUB AREAS 9. SEE PLANS FOR DETAILS. RE: SOD VARIETIES

IO. FOR SOD, APPLY DEPTH OF SOIL AS PER PLANTING DETAILS PAGE. REMOVE ANY STONES FROM TOP OF SUB-GRADE OR COVER STONES WITH ADDITIONAL 2" OF SOIL MIX.

II. ALL SOD AREA SHALL BE TREATED WITH 'ROUND UP' TWO WEEKS PRIOR TO INSTALLATION FOR REMOVAL OF ANY EXISTING OBJECTIONABLE PLANTS. DOSAGE AND APPLICATION PER MANUFACTURERS SPECIFICATIONS.

PLANT LIST

All plants to be Florida Fancy

QTY	BOTANICAL NAME	COMMON NAME	SIZE	NOTES
	-			
TREE				1
2	Coccoloba diversifolia	Pigeon Plum	per SMI	Not Native
2	Coccoloba uvifera	Sea Grape	per SMI	Native
5	Cocos nucifera	Coconut Palm	16`-20`gw	Not Native
1	Cordia sebestena	Orange Geiger Tree	10`ht, SMI to approve	Native
РАІ М	TREES			
3	Sabal palmetto	Cabbage Palmetto	mixed heights, 14'gw, 18"gw, 20'gw, booted	Native
SHRL	JBS			
3	Hibiscus rosa-sinensis 'La France'	Hibiscus 'La France'	Pink, per SMI	Not Native
37	Radermachera x 'Kunming'	Kunming Dwarf Tree Jasmine	6'ht, ftb, hedge, Qty=LF, SMI to	Not Native
			approve	
VINE/	ESPALIER		approve	
	ESPALIER Ficus repens	Creeping Fig	#1, 24"oc, train to wall	Not Native
4		Creeping Fig Carolina Jessamine	1	Not Native
4 12	Ficus repens		#1, 24"oc, train to wall	
4 12 2	Ficus repens Gelsemium sempervirens	Carolina Jessamine	#1, 24"oc, train to wall #7, train to wall	Native
VINE/ 4 12 2 1	Ficus repens Gelsemium sempervirens Petrea volubilis	Carolina Jessamine Queen's Wreath	#1, 24"oc, train to wall #7, train to wall #15, trl, train to pergola	Native Not Native
4 12 2 1 2	Ficus repens Gelsemium sempervirens Petrea volubilis Stephanotis floribunda Stephanotis floribunda	Carolina Jessamine Queen's Wreath Madagascar Jasmine	#1, 24"oc, train to wall #7, train to wall #15, trl, train to pergola #15, train to trellis	Native Not Native Not Native
4 12 2 1 2 SHRU	Ficus repens Gelsemium sempervirens Petrea volubilis Stephanotis floribunda	Carolina Jessamine Queen's Wreath Madagascar Jasmine Madagascar Jasmine	#1, 24"oc, train to wall #7, train to wall #15, trl, train to pergola #15, train to trellis #7, train to wall	Native Not Native Not Native
4 12 2 1 2 SHRU	Ficus repens Gelsemium sempervirens Petrea volubilis Stephanotis floribunda Stephanotis floribunda JB AREAS Annuals	Carolina Jessamine Queen's Wreath Madagascar Jasmine Madagascar Jasmine per client	#1, 24"oc, train to wall #7, train to wall #15, trl, train to pergola #15, train to trellis #7, train to wall #1, TBD, (in pots)	Native Not Native Not Native Not Native
4 12 2 1 2 SHRU 10	Ficus repens Gelsemium sempervirens Petrea volubilis Stephanotis floribunda Stephanotis floribunda JB AREAS	Carolina Jessamine Queen's Wreath Madagascar Jasmine Madagascar Jasmine	#1, 24"oc, train to wall #7, train to wall #15, trl, train to pergola #15, train to trellis #7, train to wall	Native Not Native Not Native Not Native Not Native
4 12 2 1 2	Ficus repens Gelsemium sempervirens Petrea volubilis Stephanotis floribunda Stephanotis floribunda JB AREAS Annuals Ilex vomitoria 'Schillings'	Carolina Jessamine Queen's Wreath Madagascar Jasmine Madagascar Jasmine per client Schillings Yaupon Holly	#1, 24"oc, train to wall #7, train to wall #15, trl, train to pergola #15, train to trellis #7, train to wall #1, TBD, (in pots) #7, 18"oc	Native Not Native Not Native Not Native Not Native Native Native
4 12 2 1 2 SHRU 10 112 2	Ficus repens Gelsemium sempervirens Petrea volubilis Stephanotis floribunda Stephanotis floribunda JB AREAS Annuals Ilex vomitoria 'Schillings' Rosmarinus officinalis 'Irene'	Carolina Jessamine Queen's Wreath Madagascar Jasmine Madagascar Jasmine per client Schillings Yaupon Holly Irene Trailing Rosemary	#1, 24"oc, train to wall #7, train to wall #15, trl, train to pergola #15, train to trellis #7, train to wall #1, TBD, (in pots) #7, 18"oc (in pots), #1	Native Not Native Not Native Not Native Not Native Not Native Native Native

Residence 260 Colonial Lane

Palm Beach, Florida

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-FOOTINGS FOR ALL STRUCTURES TO BE AT LEAST 3' BELOW GRADE TO ALLOW FOR PLANTINGS / ROOT BALLS

-DRIP IRRIGATION MAY ONLY BE USED IF SPECIFIED

BY SMI OR IF REQUIRED BY MUNICIPALITY

4 05.10.2024 FINAL SUBMITTAL 3 04.29.2024 SECOND SUBMITTAL 2 04.11.2024 FIRST SUBMITTAL

1 04.01.2024 PRE-APPLICATION DATE DESCRIPTION

REVISIONS FINAL SUBMITTAL

LANDSCAPE ARCHITECTURE 140 Royal Palm Way, Suite #206, Palm Beach, Florida 33480 Telephone: 561-655-9006 Fax: 561-655-9007 eMail: Office@smila.net www.smila.net

TITLE

Planting Specifications

SCALE PROJECT NUMBER: NONE 2402 DATE: CHECKED: PRJCT MNGR 05.10.2024 CFV DRAWING NO.




FL registration #LA 13000223

SHEET 3 OF 3

ALL IRRIGATION, IRRIGATION EQUIPMENT AND IRRIGATION BOXES TO BE CONCEALED SMI TO APPROVE LOCATIONS OF ANY / ALL IRRIGATION BOXES Know what's below ALL PLANTING BEDS TO HAVE STEEL EDGE BORDER Call before you dig

SMI TO APPROVE STAKED LAYOUT OF ALL TREES

AND PLANTING LAYOUT PRIOR TO INSTALLATION

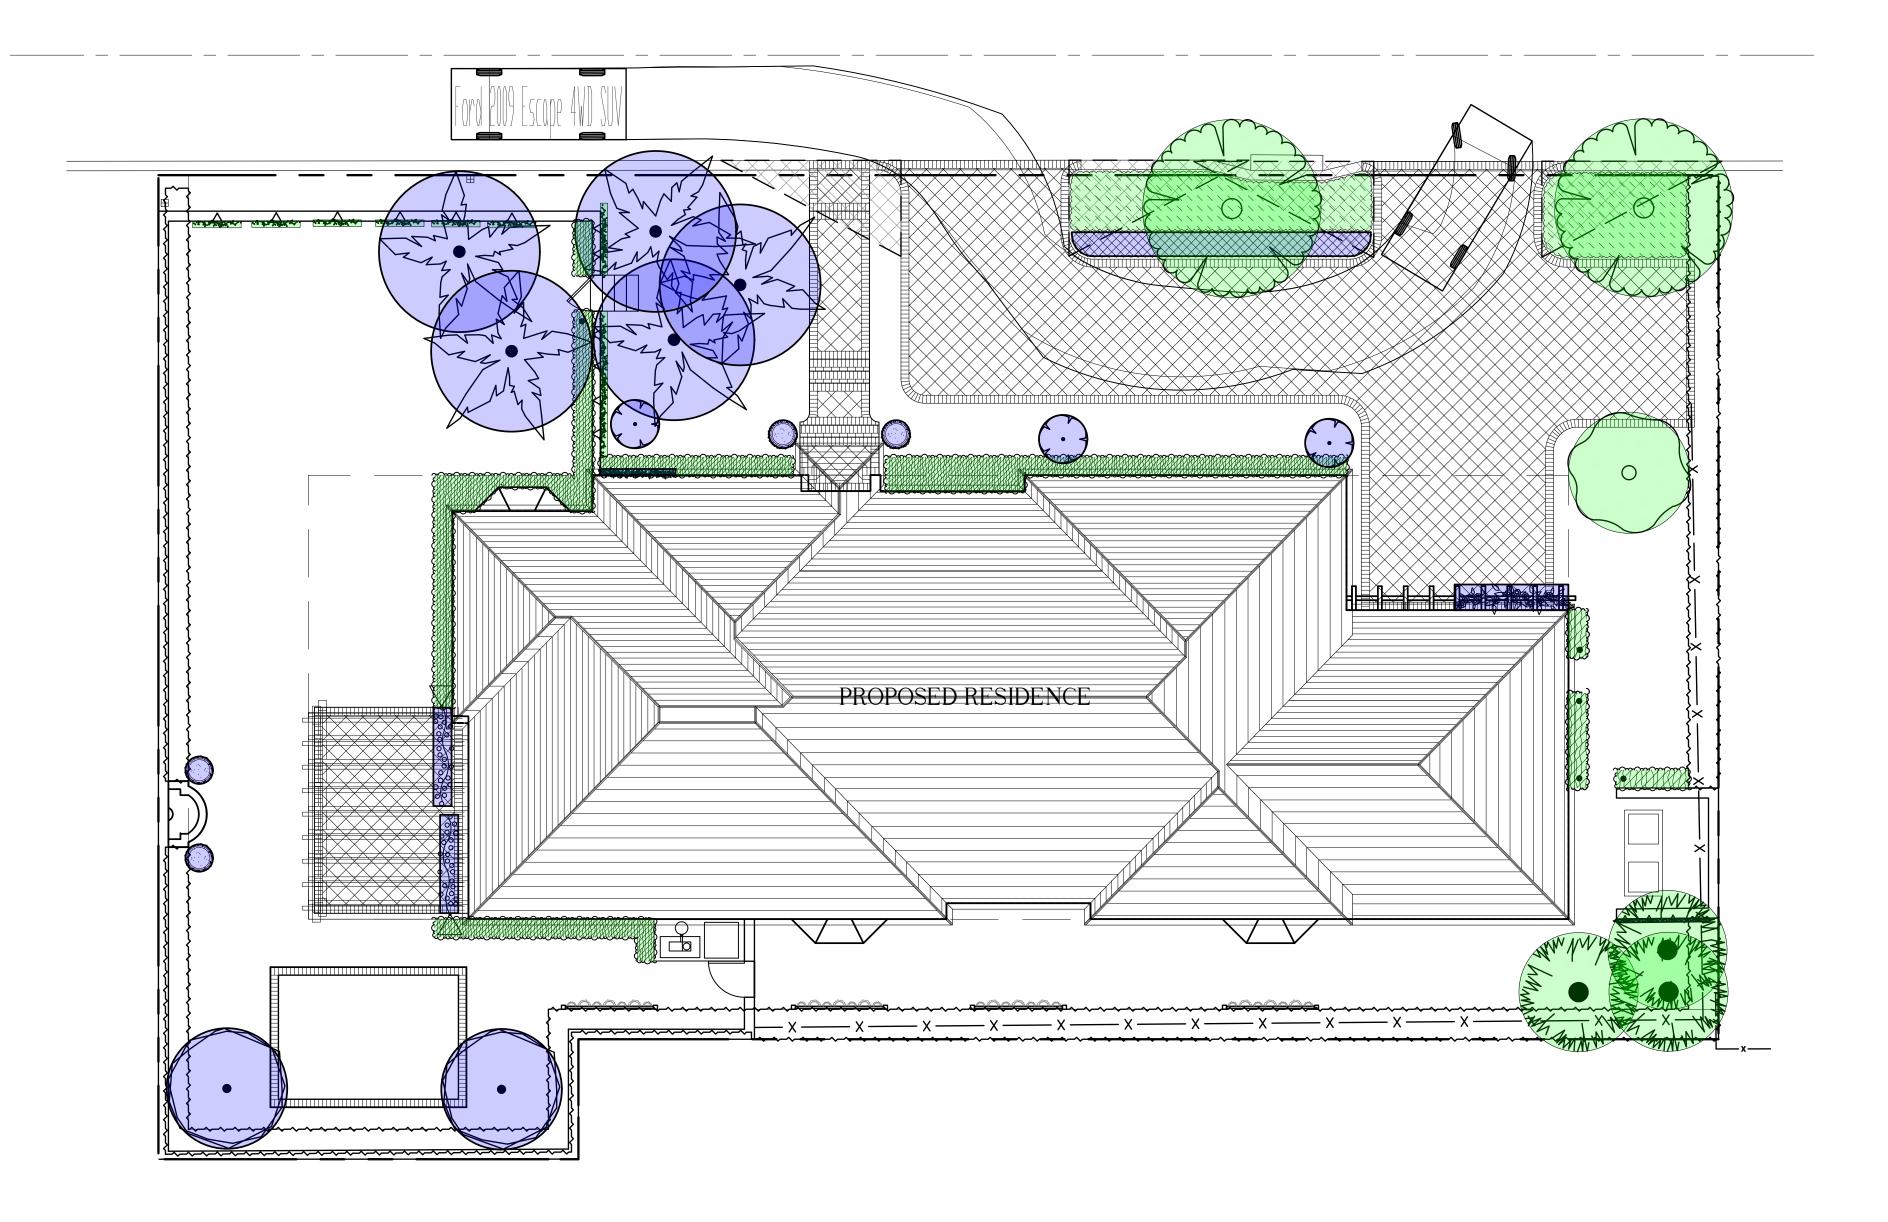

Native Coverage Calculations

Total coverage of new plantings.. . 2,130 sf (100%) 1,112 sf (52.2%) Coverage by native plants.

Newly planted non-native plant material

Newly planted native plant material

Areas not shown in color are either existing to remain, building, hardscape, or sod



Town of Palm Beach Planning Zoning and Building 360 S County Rd Palm Beach, FL 33480 www.townofpalmbeach.com

ine #	Landscape Legend		
1	Property Address:	260 Colonial Lane, Palm Beach, FL 9,710 Sq. Ft.	
2	Lot Area (sq. ft.):		
3		REQUIRED	PROPOSED
4	Landscape Open Space (LOS) (Sq Ft and %)	4,370 Sq. Ft. (45% min.)	4,370 Sq. Ft. (45%)
5	LOS to be altered (Sq FT and %)	N/A	9,710 Sq. Ft. (100%)
6	Perimeter LOS (Sq Ft and %)	2,185 Sq. Ft. (50% min.)	2,934 Sq. Ft. (65%)
7	Front Yard LOS (Sq Ft and %)	1,300 Sq. Ft. (40% min.)	1,827 Sq. Ft. (58%)
8	Native Trees %	30% (number of trees)	30%
9	Native Shrubs & Vines %	30% (number of shrubs & vines)	83%
10	Native Groundcover %	30% (groundcover area)	100%

the Institute for Regional Conservation Natives for Your Neighborhood FL Statewide Plant List

the Florida Native Plant Society Native Plants for Your Area List

Note: Modification of >50% of existing landscape/greenscape are subject to minimum native plant requirements and must submit a landscape and irrigation plan for review.

This table shall be included on the landscape species index sheet as prepared by a licensed landscape architect and landscape openspace data shall be incorporated on to corresponding zoning legend. See Ord. 003-2023 REV BF 20230727

LANDSCAPE ARCHITECT TO APPROVE LAYOUT OF ALL HARDSCAPE MATERIAL PRIOR TO INSTALLATION



The Hunt Residence

260 Colonial Lane Palm Beach, Florida



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TITLE	
Native Ca	lculations
SCALE	PROJECT NUMBER:
1/8" = 1'-0"	2402

PRJCT MNGR: CHECKED: CFV 05.10.2024 DRAWING NO.



SHEET 1 OF 1



GRADING BOS =Bottom Of Steps ELEV =ELEVation FFE = Finished Floor Elevation

TOW =Top Of Wall

ABBREVIATIONS KEY
DIA = DIAmeter DR = Dominican Republic

HS =HardScape

TOS =Top Of Steps







SOUTH ELEVATION SCALE: N.T.S

ABBREVIATIONS KEY
DIA = DIAmeter DR = Dominican Republic HS =HardScape HT =HeighT LA =Landscape Architect LS =LandScape MAX =MAXImum
MIN =MINImum SMI =SMI Landscape Architecture TBD =To Be Determined TC =Terra Cotta THK =THICK TYP =TYPical

GRADING BOS =Bottom Of Steps ELEV =ELEVation FFE =Finished Floor Elevation TOS =Top Of Steps TOW =Top Of Wall



LANDSCAPE ARCHITECT TO APPROVE

LAYOUT OF ALL HARDSCAPE MATERIAL

PRIOR TO INSTALLATION



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NOTES:
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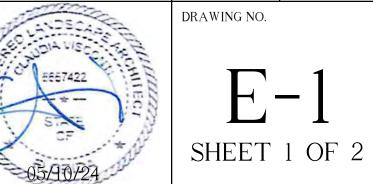
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North/South Elevation View

SCALE PROJECT NUMBER: 2402 AS NOTED DATE: PRJCT MNGR: CHECKED: CFV 05.10.2024 DRAWING NO.











ABBREVIATIONS KEY
DIA = DIAmeter DR = Dominican Republic HS =HardScape HT = HeighT
LA = Landscape Architect
LS = LandScape MAX = MAXImum MIN = MINimum

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LANDSCAPE ARCHITECT TO APPROVE LAYOUT OF ALL HARDSCAPE MATERIAL PRIOR TO INSTALLATION



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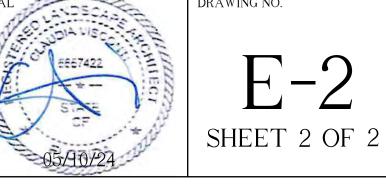
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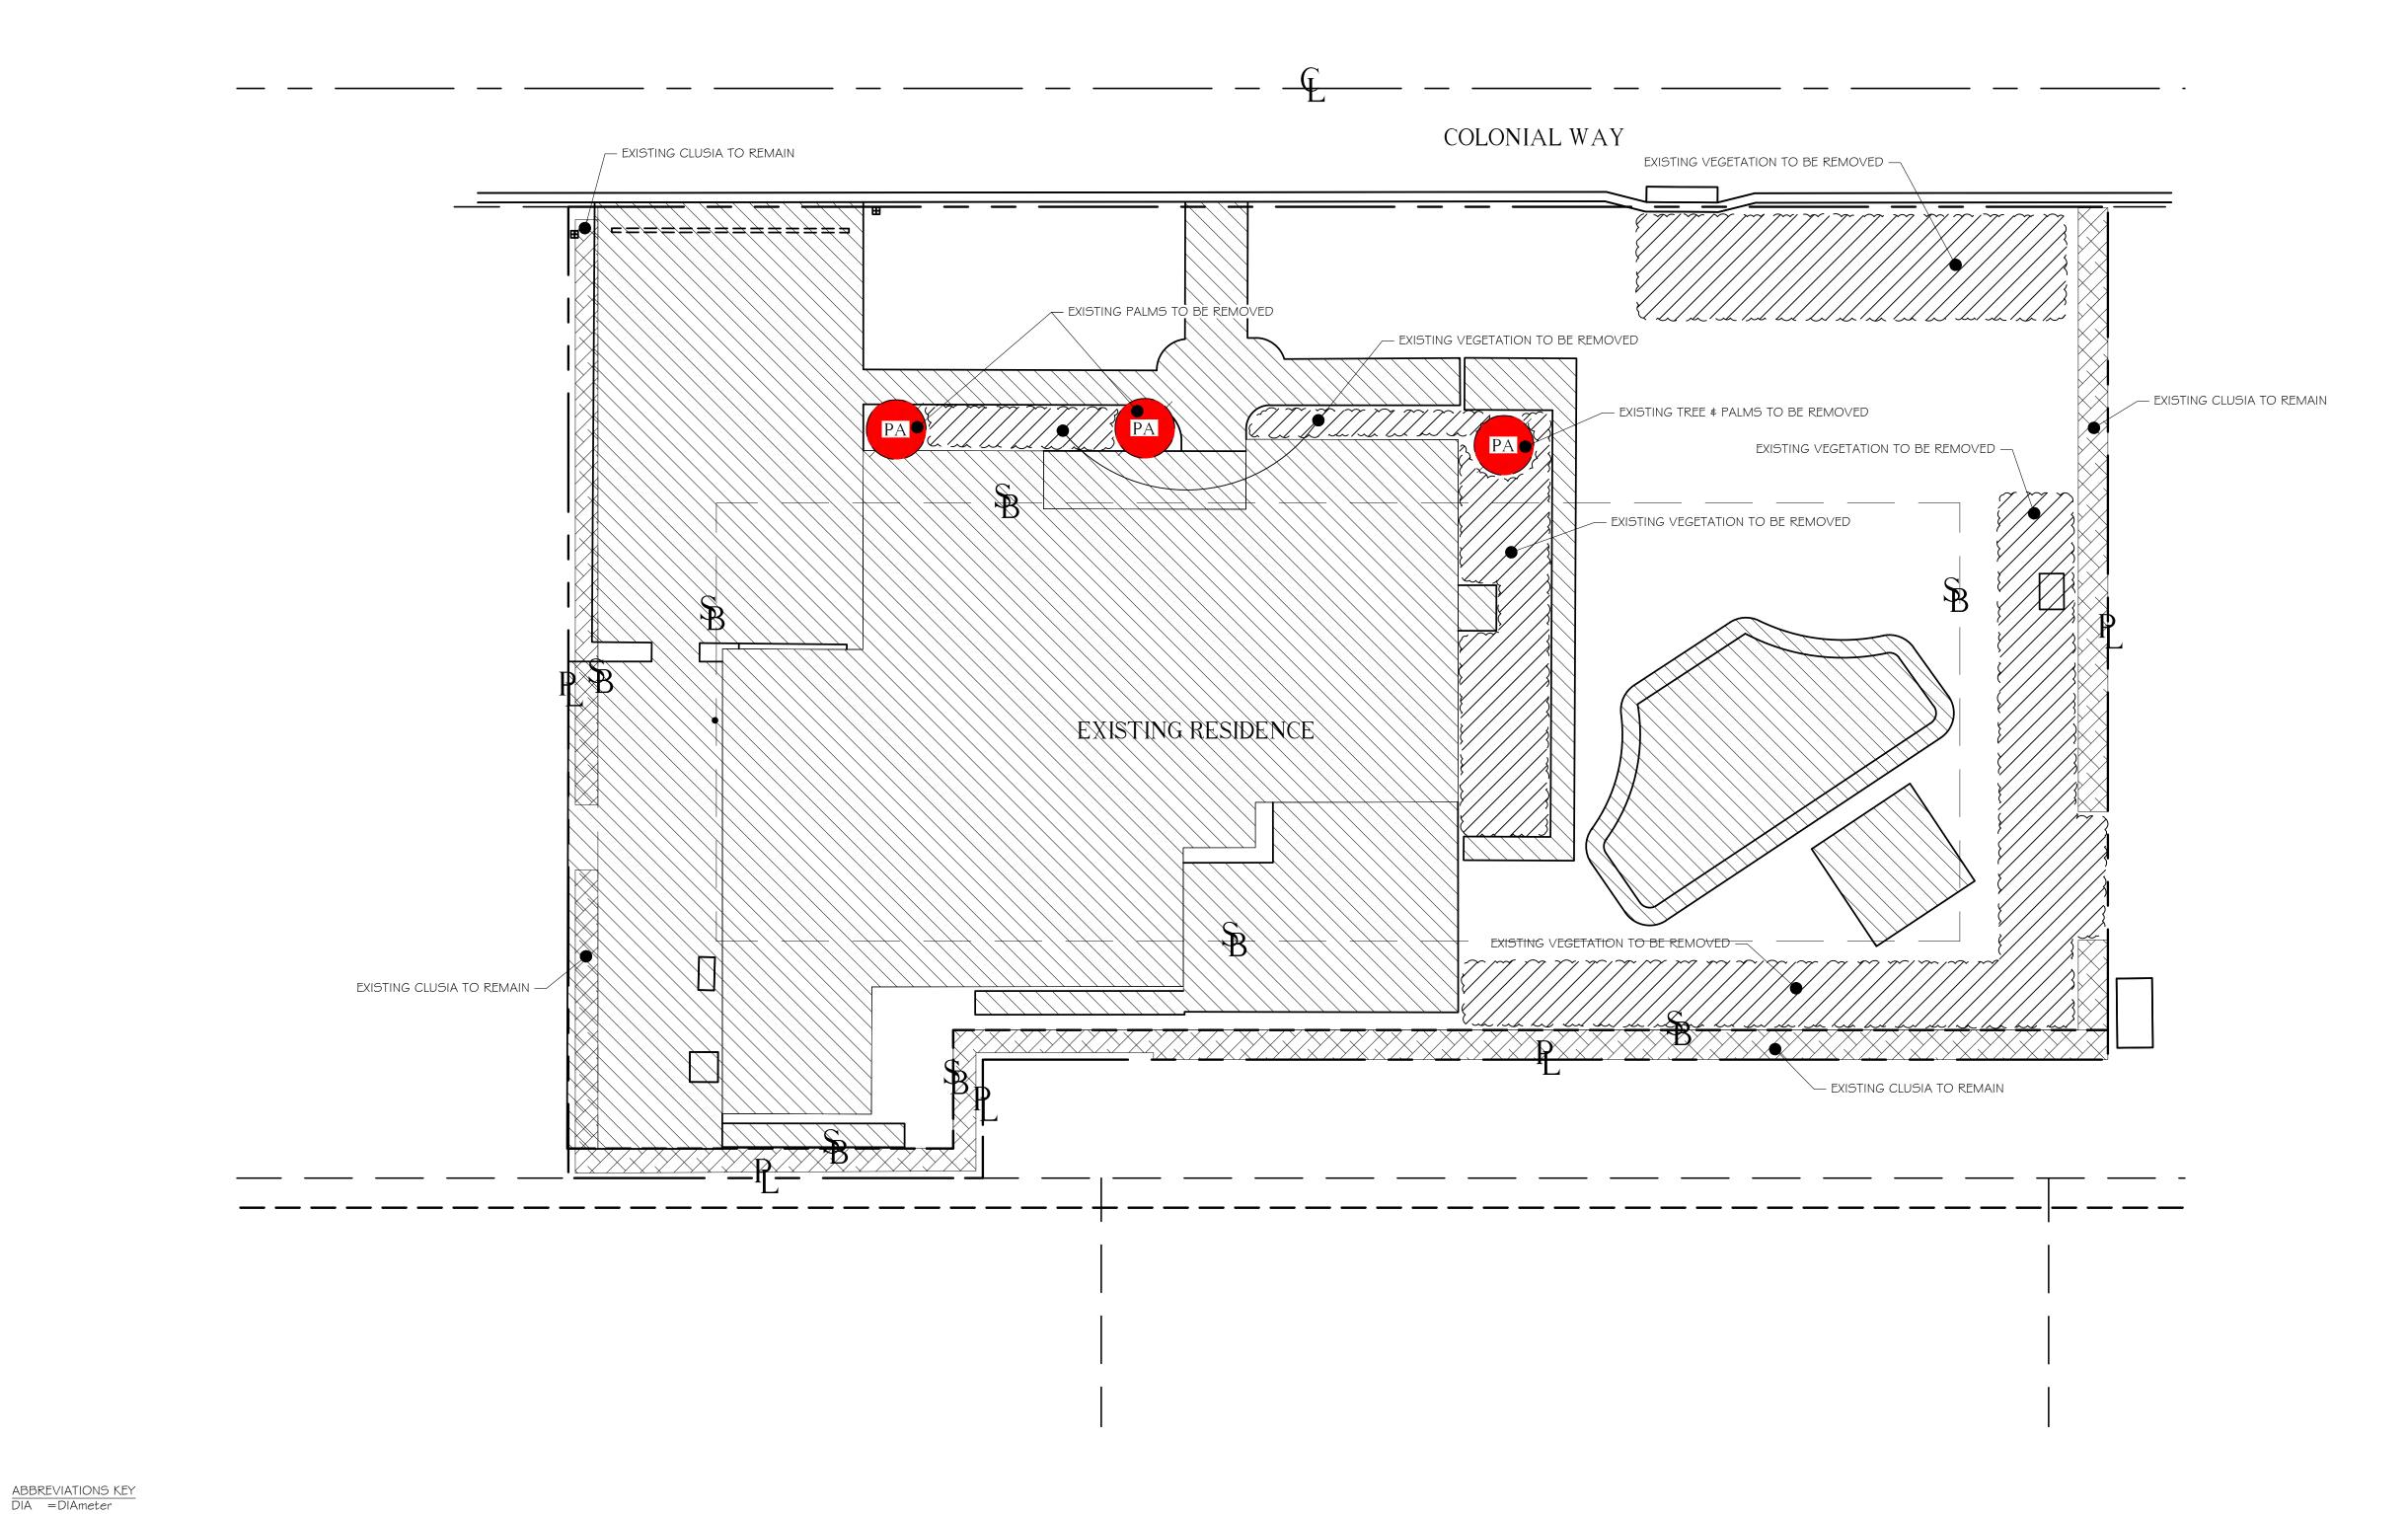
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TITLE East/West Elevation View

SCALE PROJECT NUMBER: 2402 AS NOTED PRJCT MNGR: CHECKED: 05.10.2024 CFV DRAWING NO.





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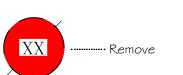
GRADING

Abbreviations Key

Abrvtn Scientific Name

Relocation K

PA PALM





·Relocate









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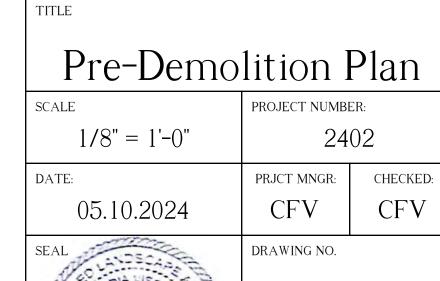
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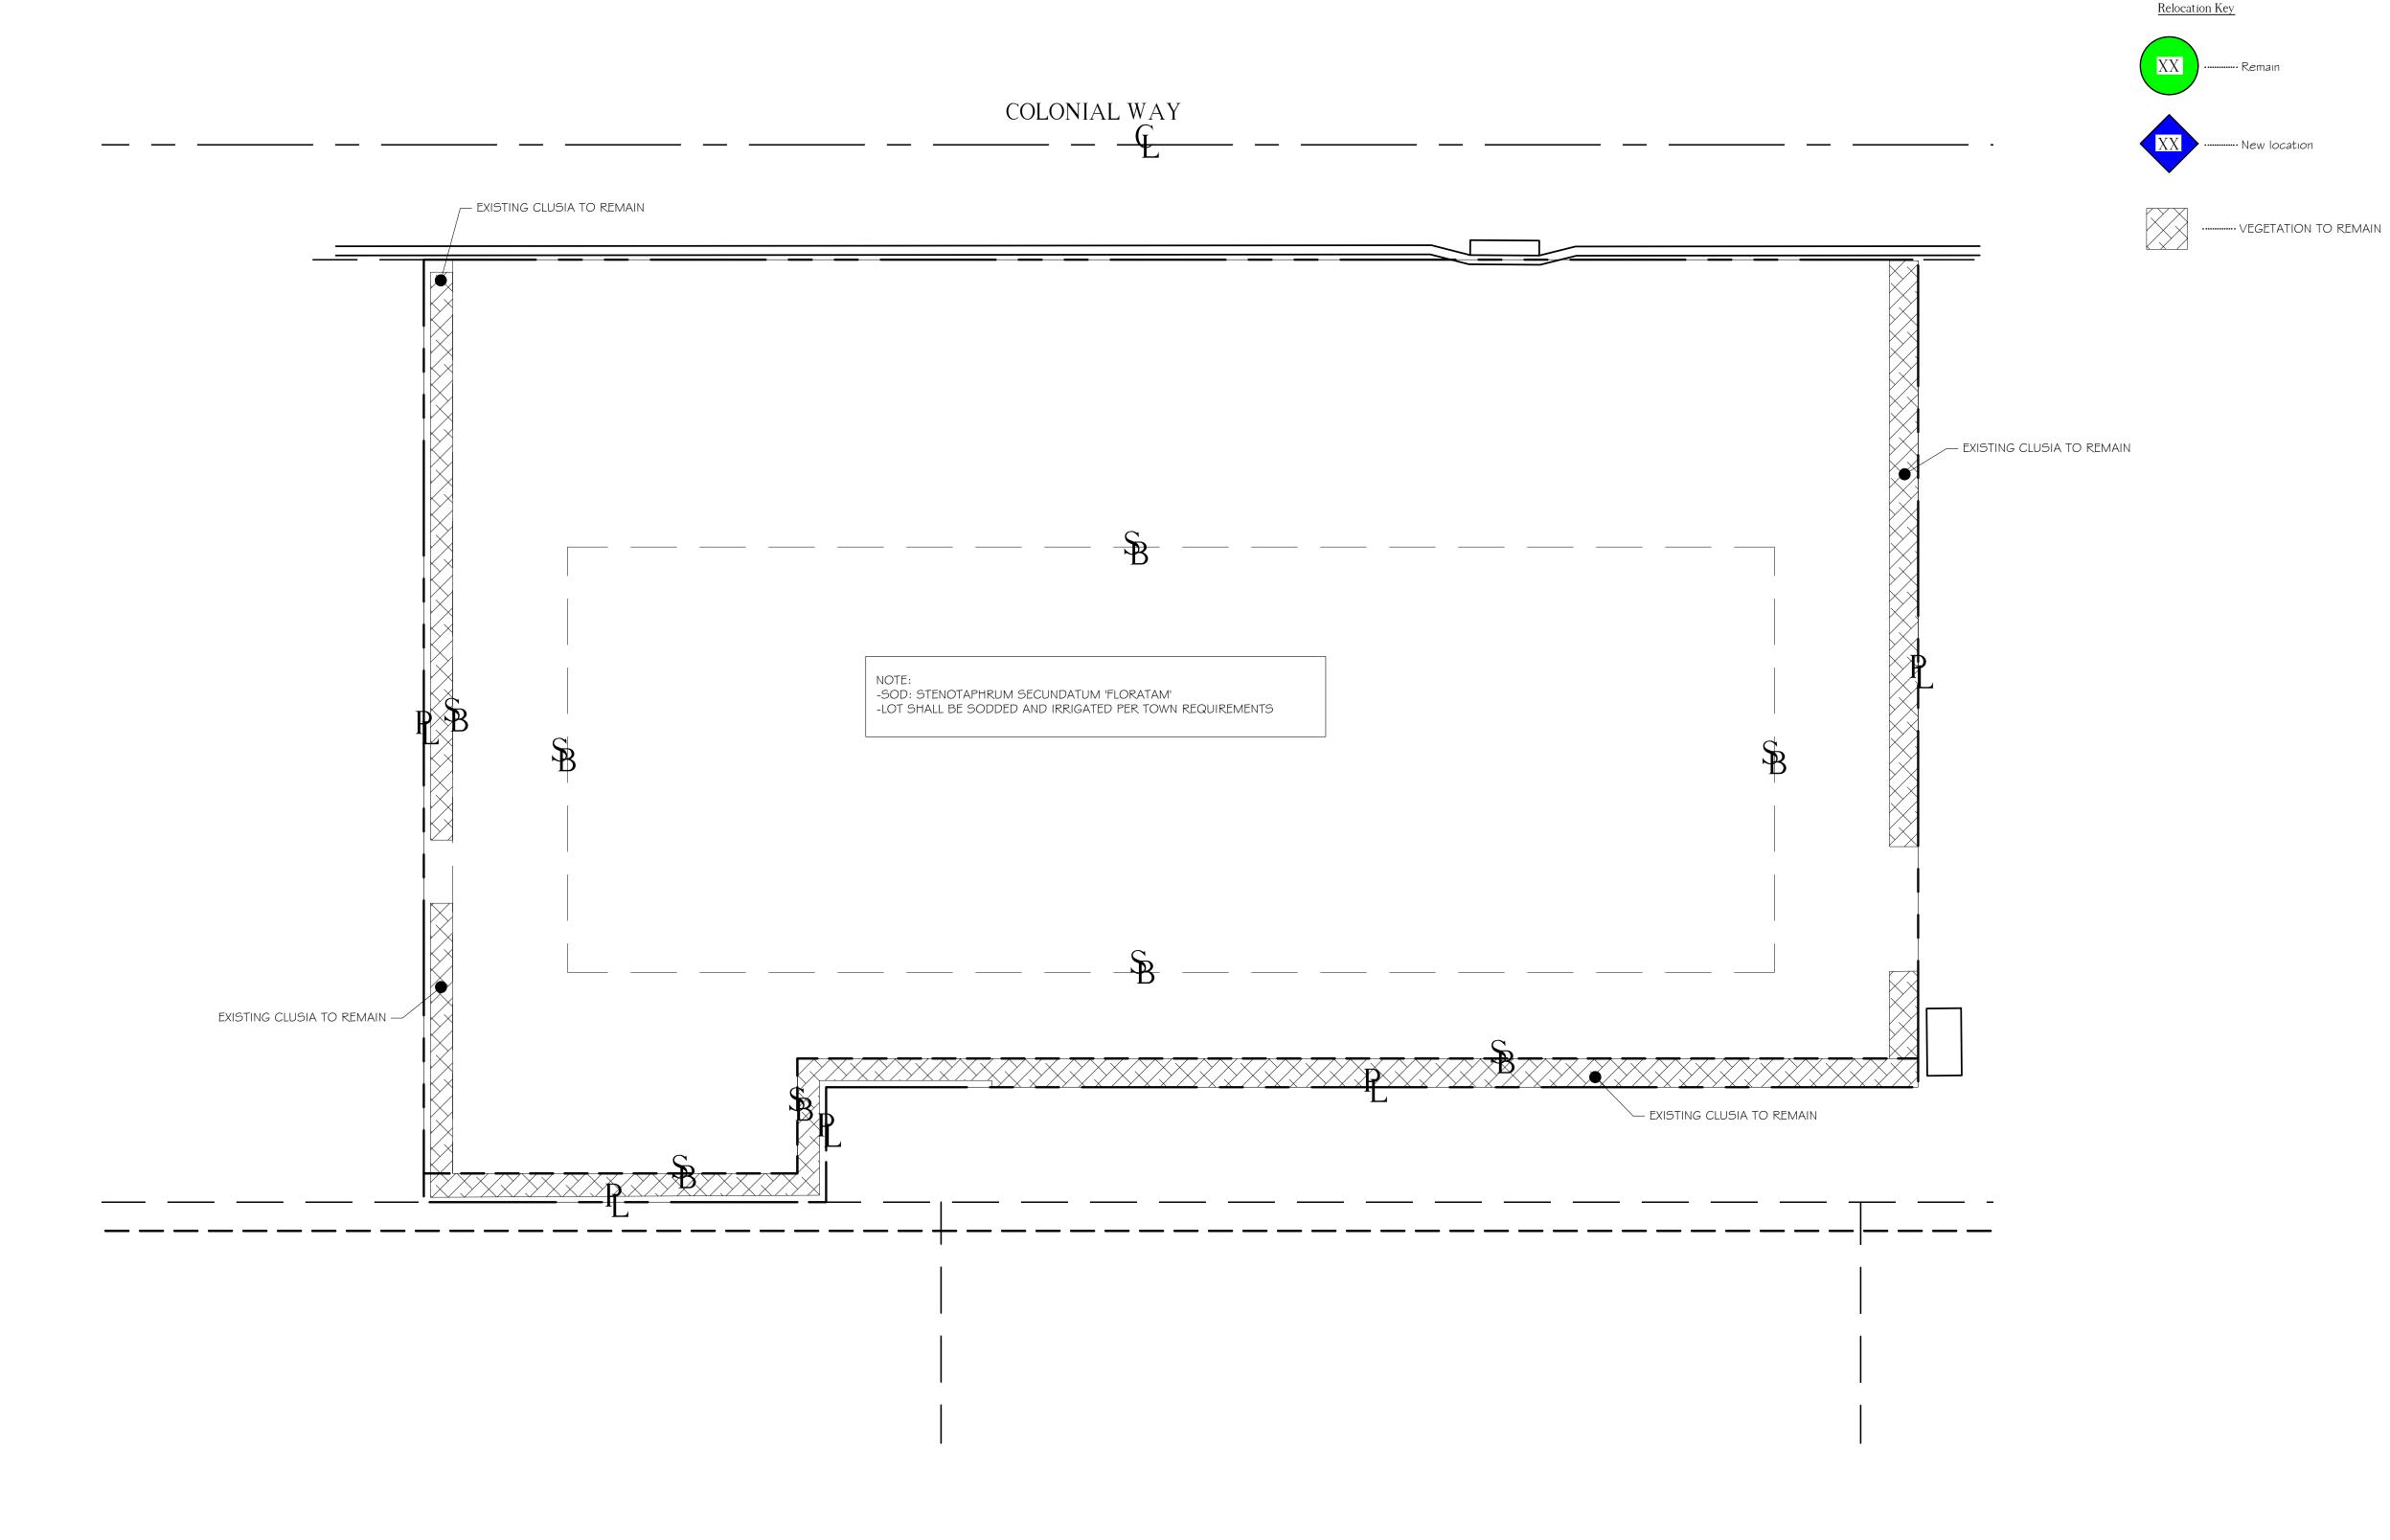
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SHEET 1 OF 2







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LANDSCAPE ARCHITECT TO APPROVE LAYOUT OF ALL HARDSCAPE MATERIAL PRIOR TO INSTALLATION



The Hunt Residence

260 Colonial Lane Palm Beach, Florida

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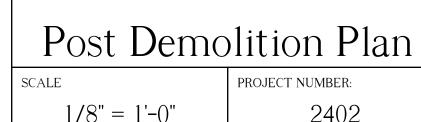
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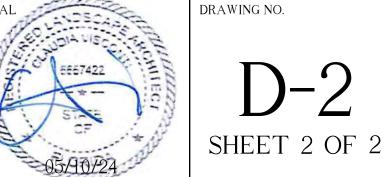
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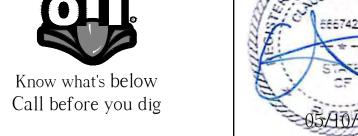
LANDSCAPE ARCHITECTURE 140 Royal Palm Way, Suite #206, Palm Beach, Florida 33480 Telephone: 561-655-9006 Fax: 561-655-9007 eMail: Office@smila.net www.smila.net FL registration #LA 13000223

TITLE



1/8" = 1'-0" 2402 DATE: PRJCT MNGR: CHECKED: 05.10.2024 CFV






Relocation Key







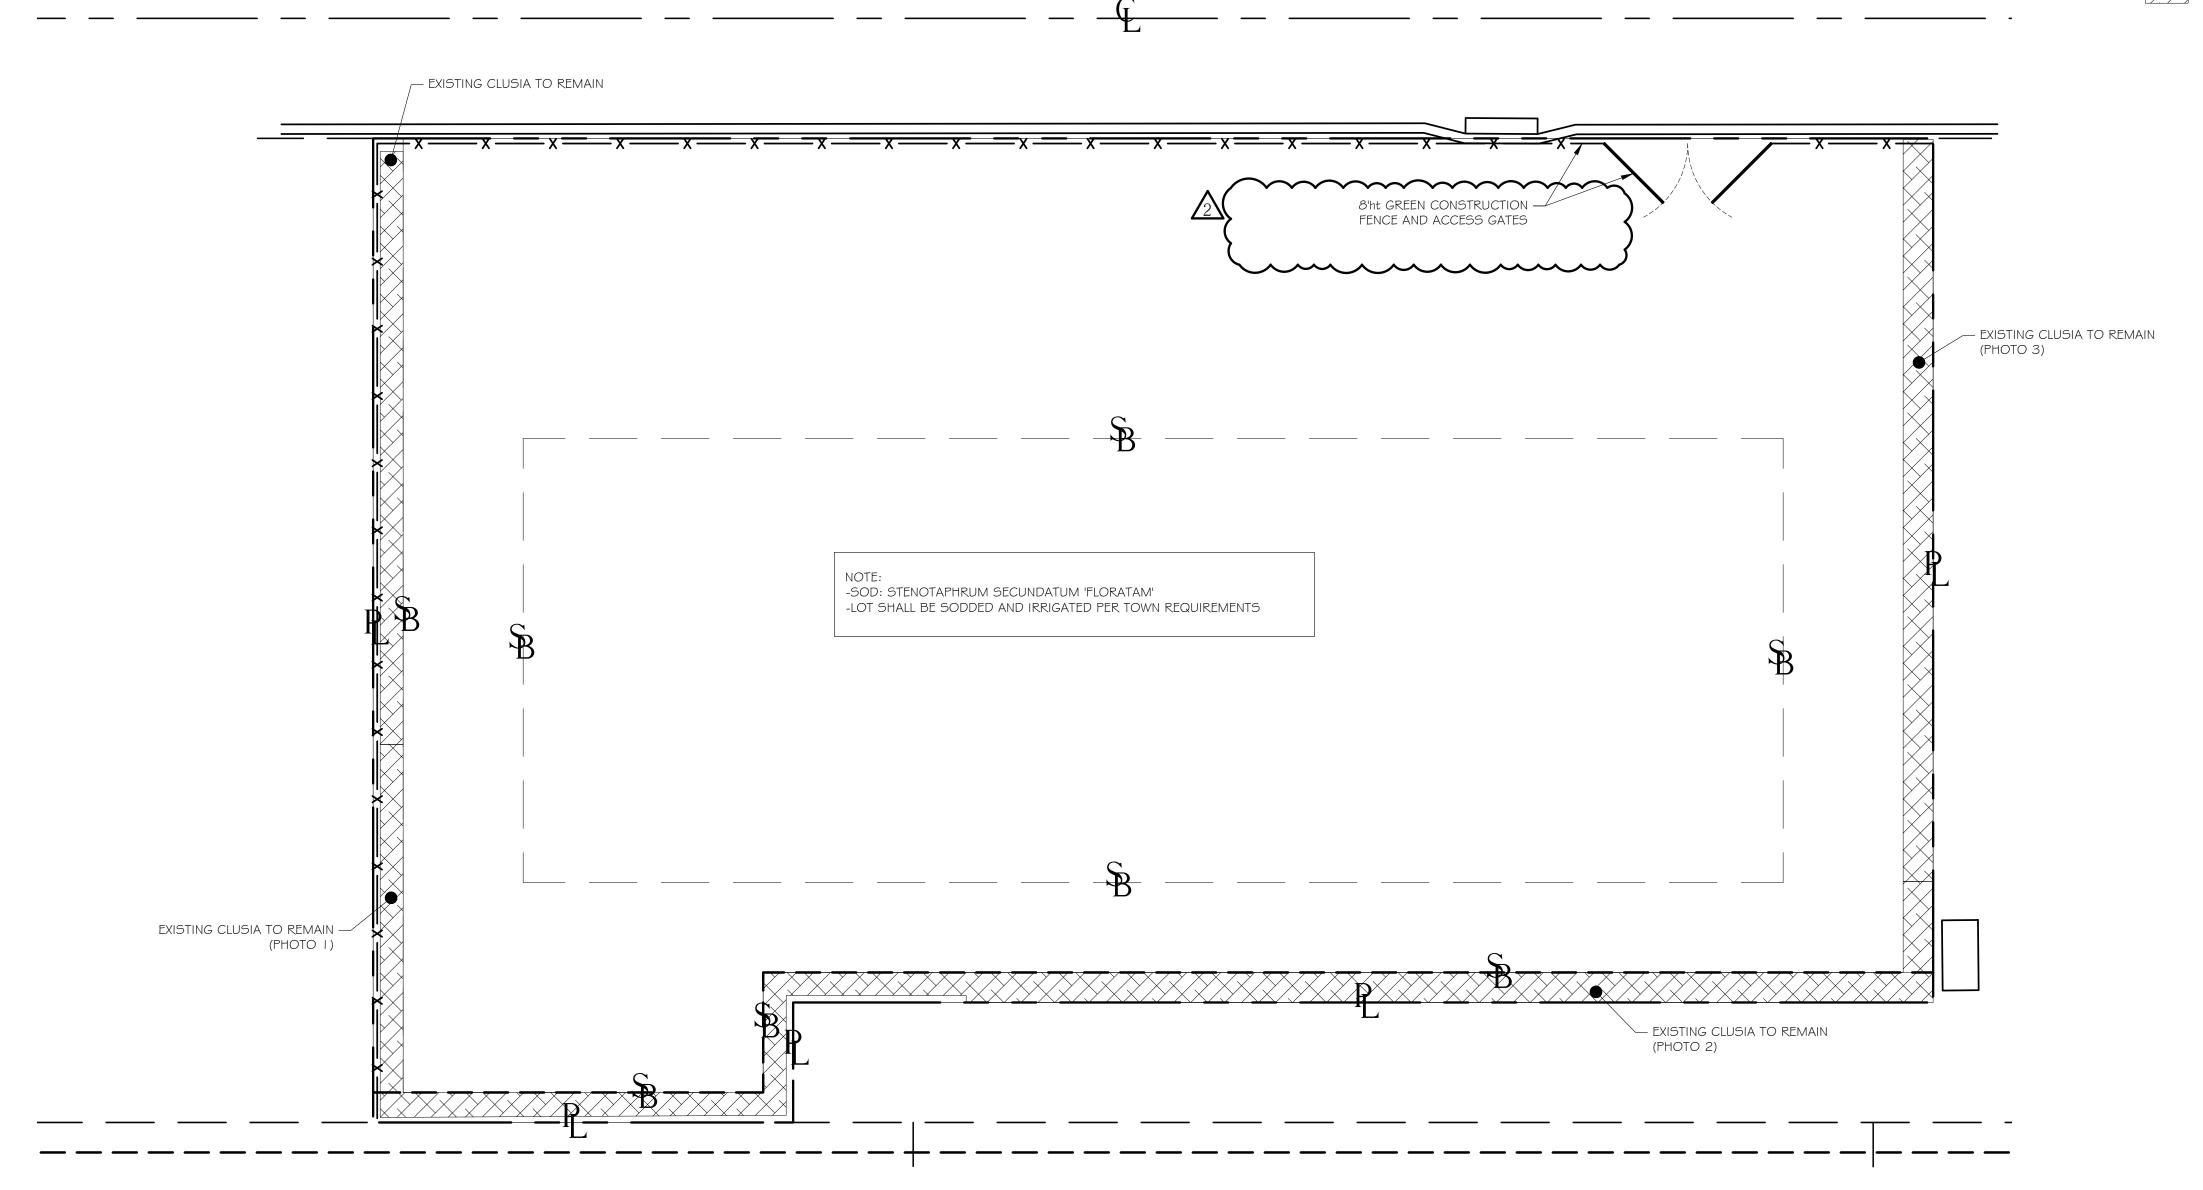

COLONIAL WAY



WEST SIDE

PHOTO 2

SOUTH SIDE



PHOTO 3

EAST SIDE

LANDSCAPE ARCHITECT TO APPROVE LAYOUT OF ALL HARDSCAPE MATERIAL PRIOR TO INSTALLATION



The Hunt Residence

260 Colonial Lane Palm Beach, Florida

SMI Landscape Architecture, LLC. shall retain all common law, statutory and other reserved rights, including the copyright for these drawings. These drawings shall not be used by the recipients or others except by agreement in writing and with appropriate compensation, waiver of claims, and indemnification to SMI Landscape Architecture, LLC.

-FOOTINGS FOR ALL STRUCTURES TO BE AT LEAST 3' BELOW GRADE TO ALLOW FOR PLANTINGS / ROOT BALLS

-DRIP IRRIGATION MAY ONLY BE USED IF SPECIFIED BY SMI OR IF REQUIRED BY MUNICIPALITY

4 05.10.2024 FINAL SUBMITTAL


3 04.29.2024 SECOND SUBMITTAL 2 04.11.2024 FIRST SUBMITTAL 1 04.01.2024 PRE-APPLICATION

DATE DESCRIPTION REVISIONS

FINAL SUBMITTAL

LANDSCAPE ARCHITECTURE 140 Royal Palm Way, Suite #206, Palm Beach, Florida 33480 Telephone: 561-655-9006 Fax: 561-655-9007 eMail: Office@smila.net www.smila.net FL registration #LA 13000223

TITLE		
Screeni	ng Pla	n
SCALE	PROJECT NUMB	ER:
1/8" = 1'-0"	24	02
DATE:	PRJCT MNGR:	CHECKED:
05.10.2024	CFV	CFV
SEAL SEAL SEAL SEAL SEAL SEAL SEAL SEAL	DRAWING NO.	1
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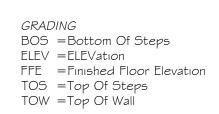


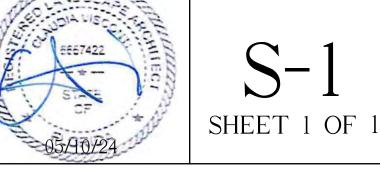

ABBREVIATIONS KEY
DIA = DIAmeter
DR = Dominican Republic

HS = HardScape
HT = HeighT
LA = Landscape Architect
LS = LandScape

MAX = MAXImum




MIN = MINimum


SMI = SMI Landscape Architecture

TBD = To Be Determined

LEGEND

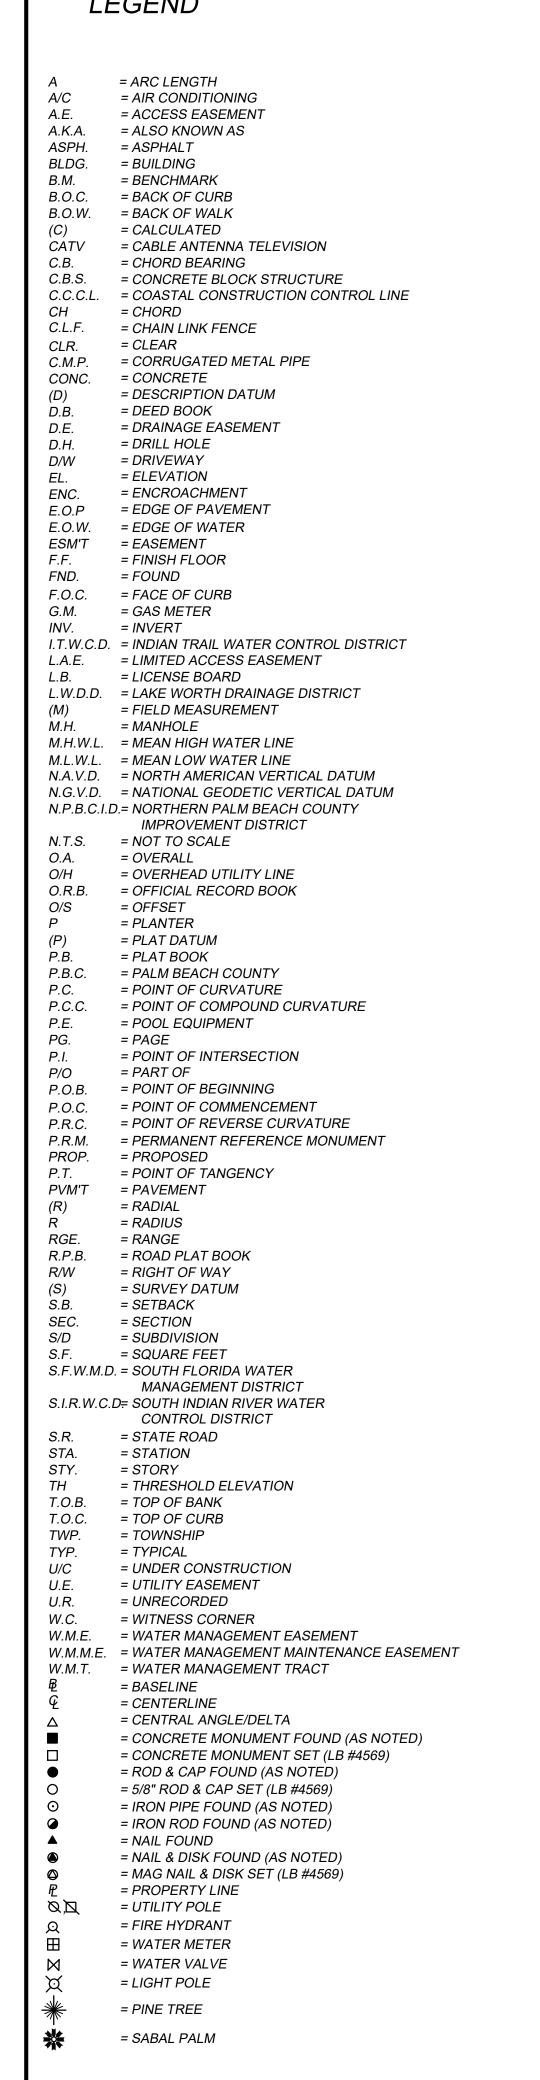

—— 40' R/W (P.B. 13, PG. 14) VACATED BY (D.B. 453, PG. 158) (D.B. 518, PG. 535) & (D.B. 453, PG. 157) & (D.B. 519, PG. 181) −Ç COLONIAL WAY (PUBLIC)

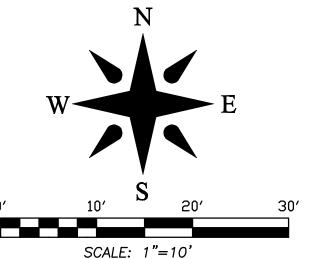

485.00' (N.T.S.) BENCHMARK **BENCHMARK** -MAG NAIL AND DISK MAG NAIL AND DISK SOUTH R/W LINE COLONIAL LANE ASPHALT EL.=2.97 NAVD EL.=2.84 NAVD 130' EL.=2.50 0.4' CURB ENC. 5/8", "W.S.C." ~1/2", 0.3'N. NORTH LINE LOT 44 (P.B. 13, PG. 14) PAVERS_ PAVERS PAVER BRICK DRIVE 54.9' PLANTER VINYL FENCE COVERED CONC. αk^{\times} 13, PG. 14) BTM A/C ALONG LINE 1-STORY RESIDENCE WOOD FENCE 17.0' **PAVERS** POOL EQUIPMENT PAD 0.7'E. _ _ _ _ _ _ _ 2.5' U.E. (D.B. 855, PG. 513)-C.L.F. (TYP.) _1/2<u>",</u> ILLEGIBLE BTM A/C=4.17 _5/8", ^"W.S.C." GARAGE AREA (P.B. 13, PG. 14) \wood fence 0.2'\w.,0.8'\s. -5/8", "W.S.C." W.C. 4.0' O/S NORTH NORTH LINE LOT 16 NORTH LINE LOT 18 NORTH LINE LOT 14 ARECA PALM AT CORNER C.L.F. CORNER -0.1**'**S. igspace 2.5' U.E. (P.B. 16, PG. 71) W.C., 2.0' O/S WEST-<u> SOUTH LINE LOT 44√(P.B. 13, PG. 14)</u> LOT 18

LA PUERTA WAY NOO VIA MARILA LAURIAN LN. SAMPPIPER DR TRAD<u>EWIND</u> DR.

VICINITY SKETCH N.T.S.

BOUNDARY SURVEY FOR: MEREDITH E. HUNT AND MATTHEW DEATLEY

This survey is made specifically and only for the following parties for the purpose of a closing on the surveyed property.

Meredith E. Hunt and Matthew DeAtley First American Title Insurance Company Kochman & Ziska, PLC

The undersigned surveyor assumes no responsibility or liability for any other purpose or to any other party other than stated above.

PROPERTY ADDRESS: 260 Colonial Lane

Palm Beach, FL 33480

LEGAL DESCRIPTION:

All that tract or parcel of land beginning at a point in the North line of Lot Eighteen, as shown on the Plat of GREGORY ADDITION TO THE TOWN OF PALM BEACH, FLORIDA, on file in the Office of the Clerk of the Circuit Court of Palm Beach County, Florida, in Plat Book 16, Page 71, which point is 35 feet Easterly from the Northwesterly corner of said

thence in an Easterly direction, along the Northerly line of said Lot 18 for a distance of 35 feet; thence at right angles running in a Northerly direction for a distance of 10 feet to a point;

thence at right angles and running in an Easterly direction along a line parallel to the Northerly line of Lot 18, 16 and 14 of said GREGORY ADDITION, for a distance of 95 feet to a point; thence at right angles and running in a Northerly direction for a distance of 72 feet to a point in the South side of

thence in a Westerly direction along the South side of Colonial Lane for a distance of 130 feet to a point;

thence at right angles running in a Southerly direction for a distance of 82 feet to the POINT OF BEGINNING.

TITLE COMMITMENT REVIEW MEREDITH E. HUNT | COMMITMENT NO.: 1062-4765839 | DATE: MAY 13, 2020 AND MATTHEW DEATLEY REVIEWED BY: CRAIG L. WALLACE JOB NO.: 16-1490.3 B2 ITEM NO. | DOCUMENT | DESCRIPTION |AFFECTS|AFFECTS| DOES | NOT A AND NOT | NOT | SURVEY |PLOTTED| PLOTT- |AFFECT|MATTER Plat of EL ENCANTO PLAT NO. 2 PB 13, PG 14 DB 453, PG 158 Ordinance by the Town of Palm Beach (abandonment of 40' right-of-DB 453, PG 157 Resolution by the Town of Palm Dedication of the perpetual use by Quit Claim Deed DB 855, PG 513 Perpetual easement for utility

FLOOD ZONE: This property is located in Flood Zone AE (EL 6), according to F.I.R.M. (Flood Insurance Rate Map) No. 12099C 0393F, dated 10/05/2017

1. All information regarding record easements, adjoiners, and other documents that might affect the quality of title to tract shown hereon was gained from commitment number 1062-4765839

GREGORY ADDITION

(P.B. 16, PG. 71)

¹2.5' U.E. (P.B. 13, PG. 14)

issued by First American Title Insurance Company, dated May 13, 2020. This office has made no search of the Public Records.

Elevations shown hereon, if any, are in feet and decimal parts thereof and are based on NAVD-88. The expected accuracy of the elevations shown hereon is 0.03' for the hard surface elevations (shown thus x 0.00) and 0.1' (shown thus x 0.0) for the soft surface elevations. Elevations shown hereon are U.S. survey feet unless otherwise noted.

drawing, sketch, plat or map is for informational purposes only and is not valid.

4. Unless presented in digital form with electronic seal and electronic signature this survey must bear the signature and the original raised seal of a Florida licensed surveyor or mapper this

This survey cannot be transferred or assigned without the specific written permission of Wallace Surveying Corporation. Certificate of Authorization Number LB4569.

Except as shown, underground and overhead improvements are not located. Underground foundations not located. The survey sketch shown hereon does not necessarily contain all of the information obtained or developed by the undersigned surveyor in his field work, office work or research.

No responsibility is assumed by this surveyor for the construction of improvements, from building ties shown on this survey. Revisions shown hereon do not represent a "survey update" unless otherwise noted.

10. All dates shown within the revisions block hereon are for interoffice filing use only and in no way affect the date of the field survey stated herein.

11. In some instances, graphic representations have been exaggerated to more clearly illustrate the relationships between physical improvements and/or lot lines. In all cases, dimensions shown shall control the location of the improvements over scaled positions.

12. It is a violation of Rule 5J-17 of the Florida Administrative Code to alter this survey without the express prior written consent of the Surveyor. Additions and/or deletions made to the face of this survey will make this survey invalid.

13. The ownership of fences, perimeter walls and/or hedges shown hereon are not known and thus are not listed as encroachments. Fences, hedges and/or perimeter walls are shown in their relative position to the boundary.

14. The expected horizontal accuracy of the information shown hereon is +/- 0.10'.

Description furnished by client or client's agent.



CERTIFICATION: I HEREBY ATTEST that the survey shown hereon conforms to the Standards of Practice set forth by the Florida Board of Professional Surveyors and Mappers adopted in Rule 5J-17, Florida Administrative Code pursuant to Section 472.027, Florida Statutes, effective September 1, 1981.

DATE OF LAST FIELD SURVEY: 10/25/2023



0/25/23 SURVEY AND TIE-IN UPDATE B.M./M.B. 16-1490.4 PB354/63 06/09/20 SURVEY AND TIE-IN UPDATE B.M./M.B. 16-1490.3 PB294/38 2/17/16 SURVEY AND TIE-IN UPDATE J.C./M.B. 16-1490.2 PB232/24

BOUNDARY SURVEY FOR:

MEREDITH E. HUNT AND MATTHEW DEATLEY



IFILIFICE SURVEYING

5553 VILLAGE BOULEVARD, WEST PALM BEACH, FLORIDA 33407 * (561) 640-4551

JOB NO. 16-1490 B.M. F.B. PB226 PG. 41 OFFICE M.B. 8/11/16 DWG. ND. 16-1490 C'K'Dı C.W. REF: 16-1490.DWG