

# <sup>E</sup>MIRAFLORES DRIVE

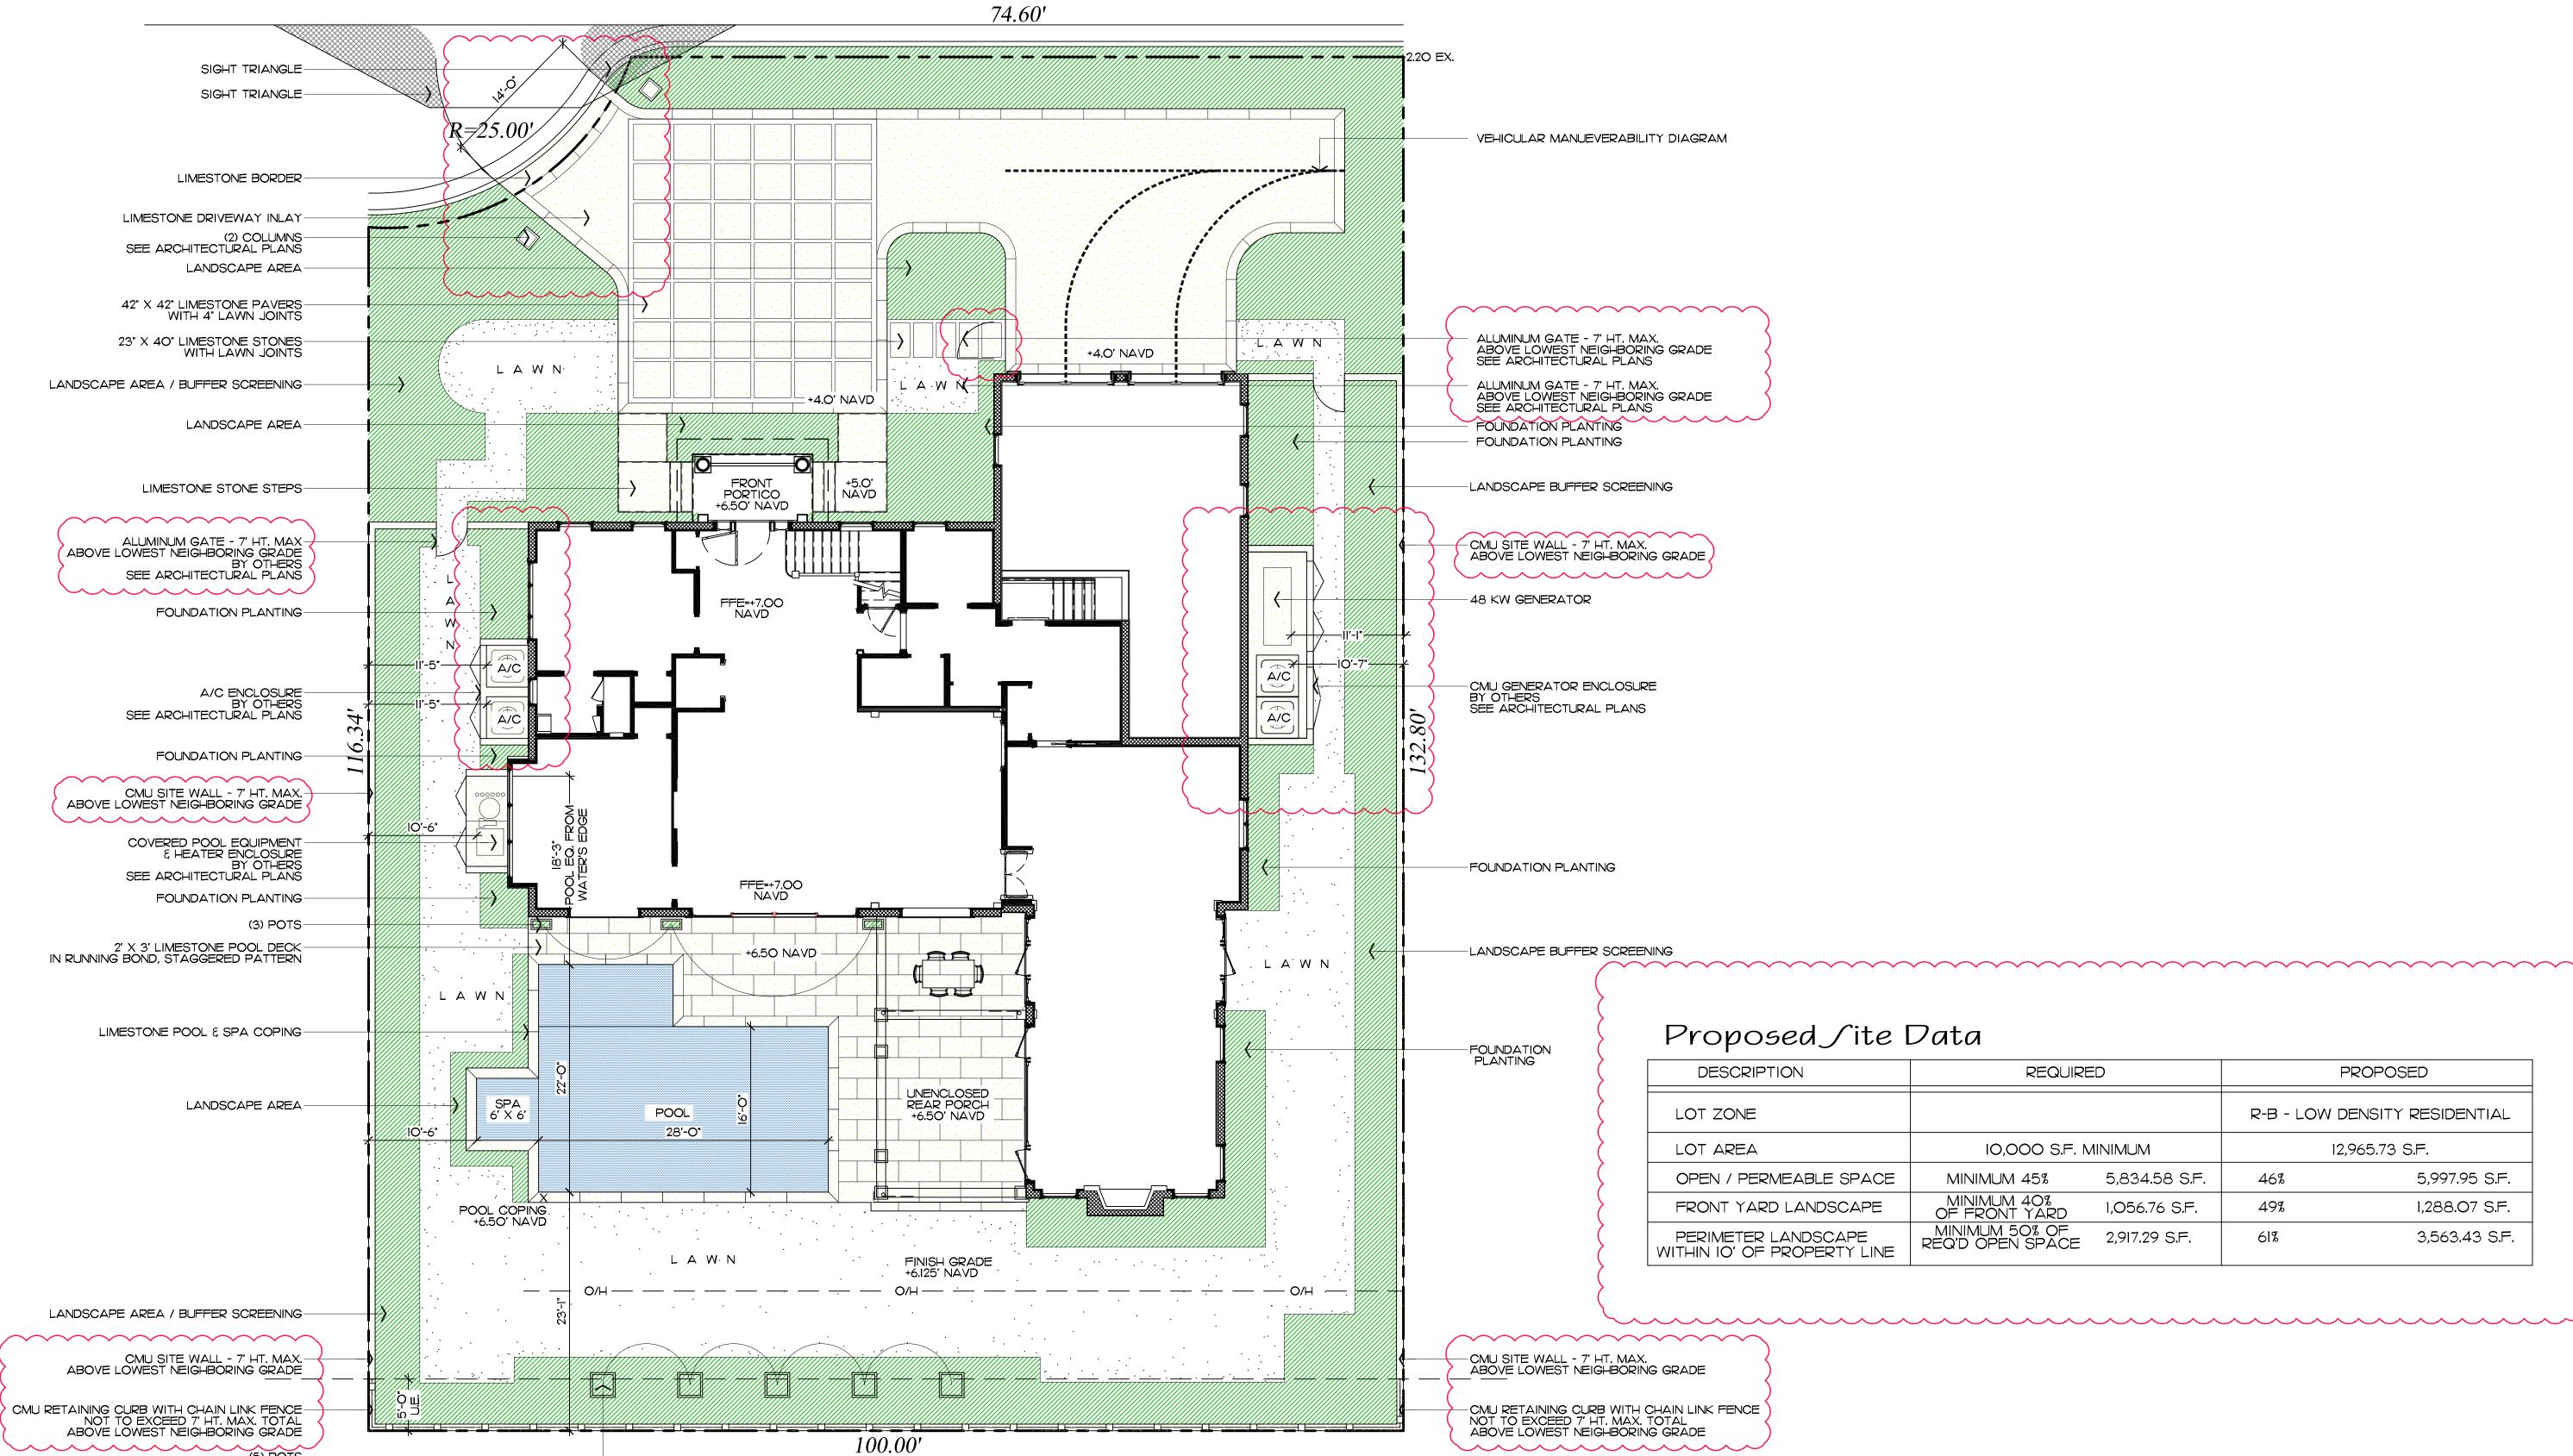

(5) POTS-



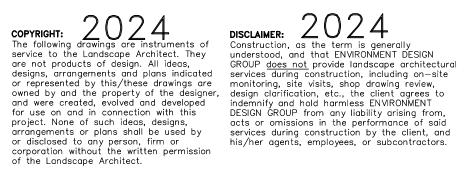



+1.30 NAVD \_\_\_\_\_ \_ \_\_\_

— — +1.45 NAVD




Scale IN FEET O'

## RECEIVED By yfigueroa at 12:38 pm, Apr 08, 2024



 $\triangleleft$  $\mathcal{O}$  $\Box$  $\mathcal{O}$  $\bigcirc$ 2 side  $\mathbf{C}$  $\mathcal{O}$ Δ  $\mathcal{O}$  $\geq$ Ŋ  $\frown$  $\nabla$  $\sim$ fl  $\mathbf{N}$  $\mathcal{O}$ 2  $\mathcal{O}$ 4 -----• Δ Δ • ----- •  $\leq$  $\frown$  $\square$  $\frown$ 

l				
REQUIRE	D	PROPOSED		
		R-B - LOW DE	ENSITY RESIDENTIAL	
10,000 S.F. N	IINIMUM	12,9	965.73 S.F.	
MUM 45%	5,834.58 S.F.	46%	5,997.95 S.F.	
MUM 40% PONT YARD	1,056.76 S.F.	49%	1,288.07 S.F.	
UM 50% OF OPEN SPACE	2,917.29 S.F.	61%	3,563.43 S.F.	
		•		

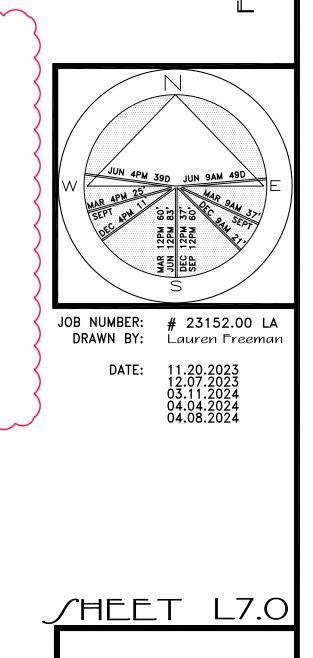

AREA IN SQ.FT.

24

64 sf.

ARC-24-009

16'

8'

## Legend




## IMPERVIOUS AREA (HOUSE/STRUCTURE) IMPERVIOUS AREA (HARDSCAPE)

PERVIOUS AREA / OPEN SPACE


IMPERVIOUS AREA / WATER FEATURE



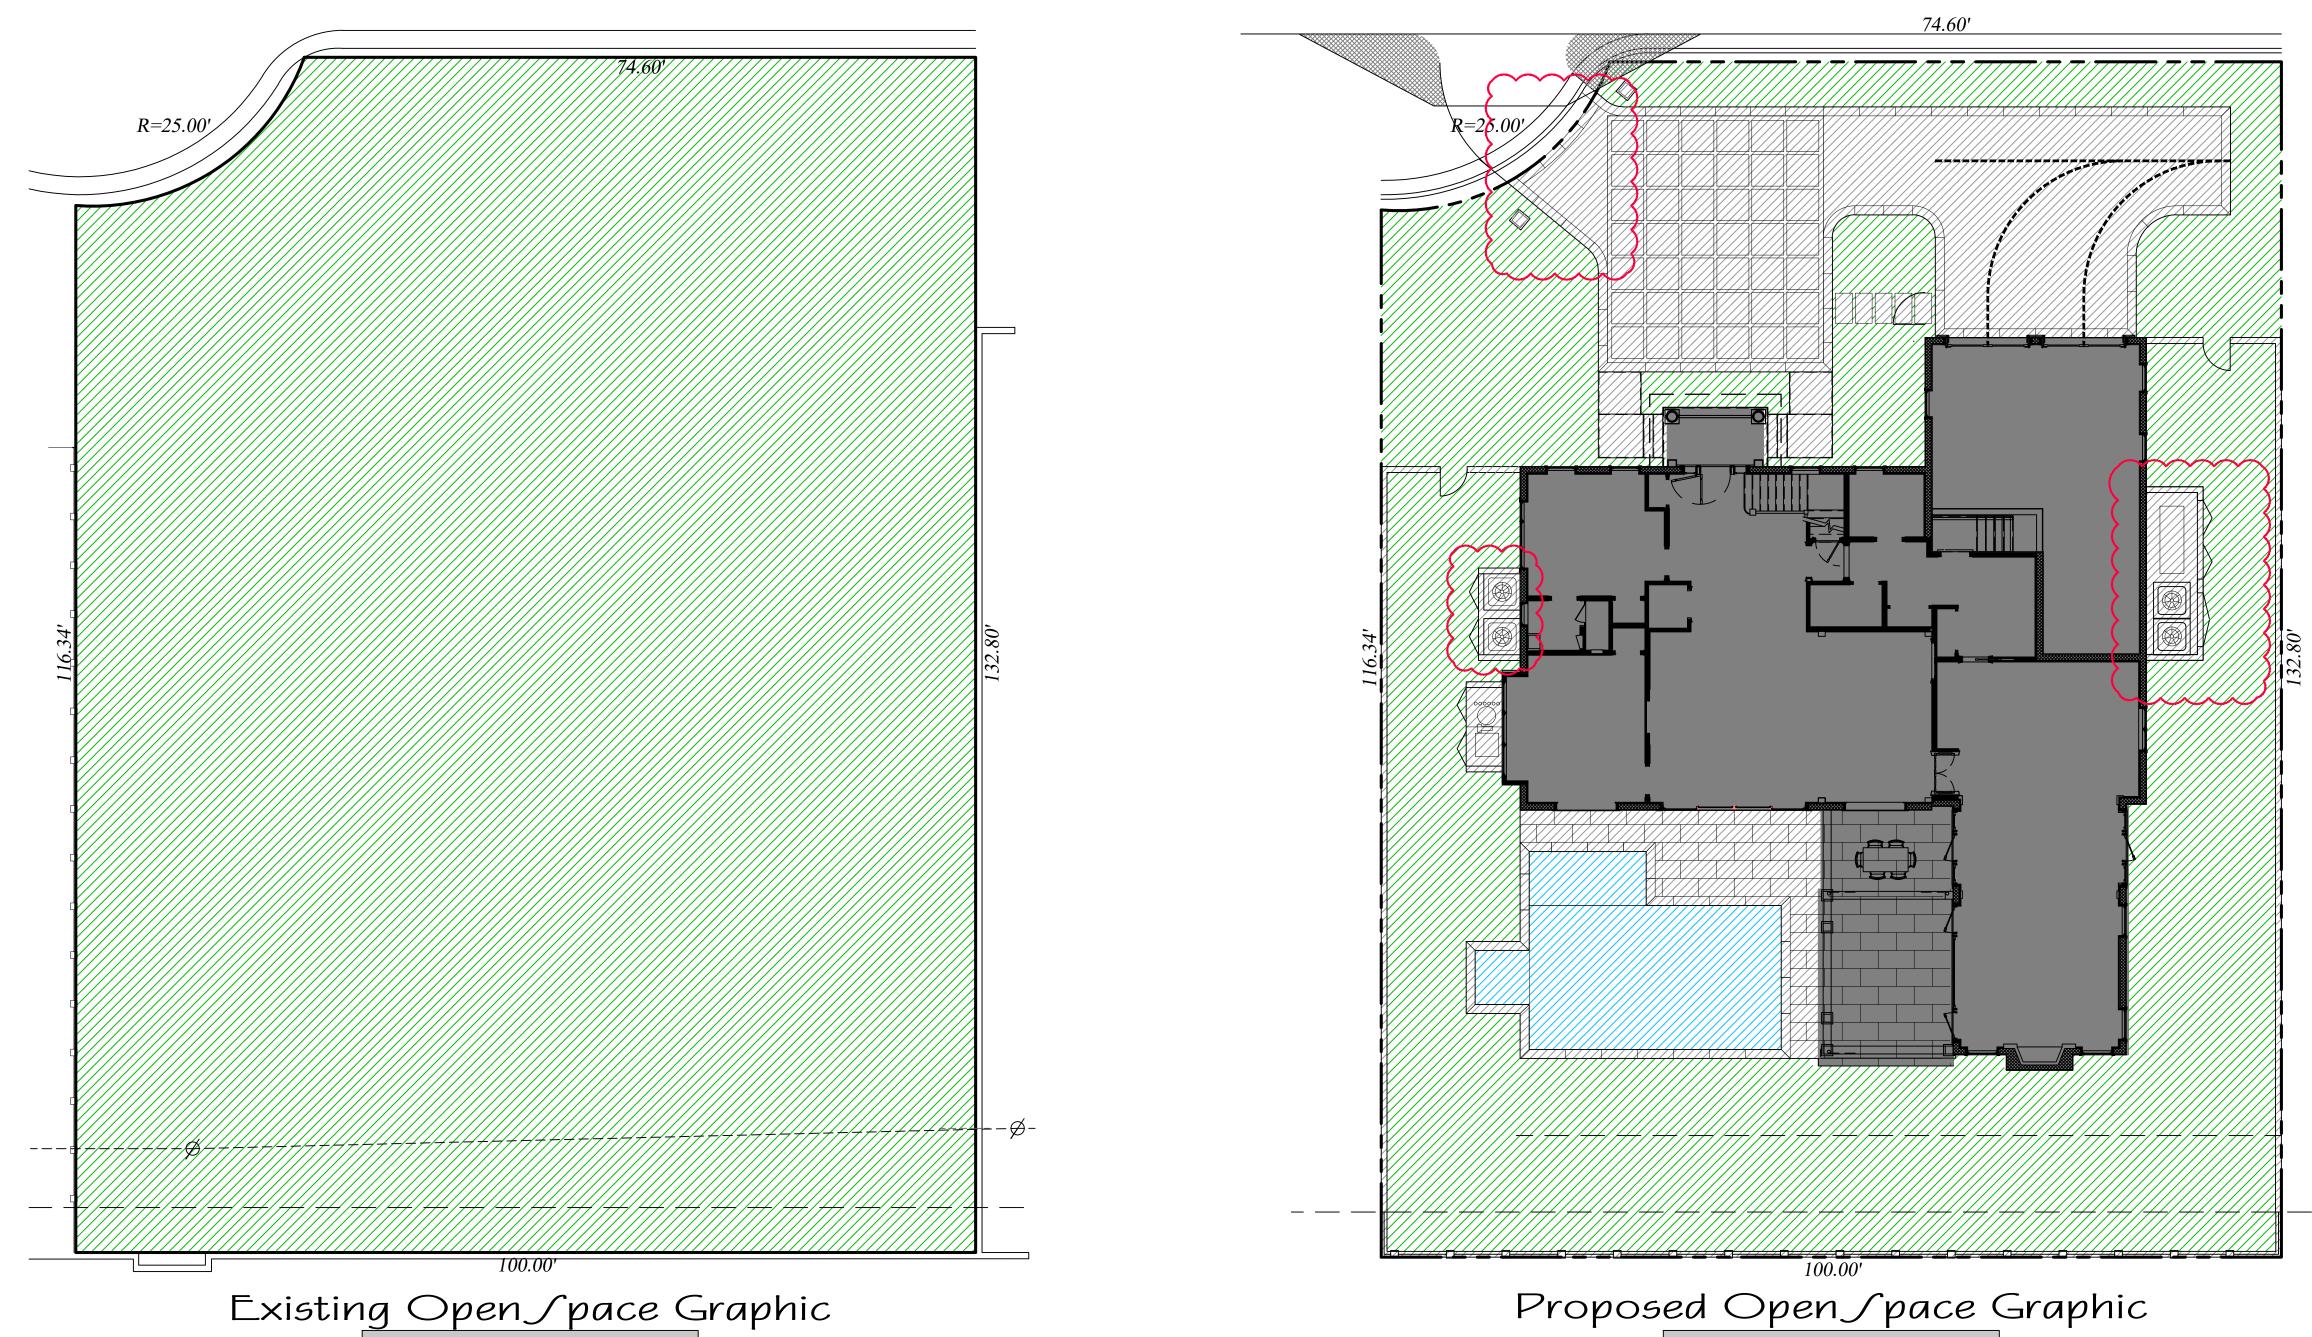

### Existing ſite Data

DESCRIPTION	REQUIRE	Ð	EXISTING		
LOT ZONE			R-B - LOW DE	ENSITY RESIDENTIAL	
LOT AREA	10,000 S.F. N	1INIMUM	12,965.73 S.F.		
OPEN / PERMEABLE SPACE	MINIMUM 45%	5,834.58 S.F.	100%	12,965.73 S.F.	
FRONT YARD LANDSCAPE	MINIMUM 40% OF FRONT YARD	1,056.76 S.F.	100%	2,641.90 S.F.	
PERIMETER LANDSCAPE WITHIN 10' OF PROPERTY LINE	MINIMUM 50% OF REQ'D OPEN SPACE	2,917.29 S.F.	718	4,157.13 S.F.	

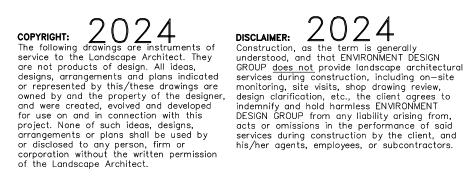







<sup>L</sup> MIRAFLORES DRIVE

DESCRIPTION	REQUIRE	Ð	PROPOSED	
LOT ZONE			R-B - LOW D	ENSITY RESIDENTIAL
LOT AREA	IO,000 S.F. MINIMUM		12,965.73 S.F.	
OPEN / PERMEABLE SPACE	MINIMUM 45%	5,834.58 S.F.	46%	5,997.95 S.F.
FRONT YARD LANDSCAPE	MINIMUM 40% OF FRONT YARD	1,056.76 S.F.	49%	1,288.07 S.F.
PERIMETER LANDSCAPE WITHIN 10' OF PROPERTY LINE	MINIMUM 50% OF REQ'D OPEN SPACE	2,917.29 S.F.	61%	3,563.43 S.F

# Scale IN FEET: 3/32"=1'-0"

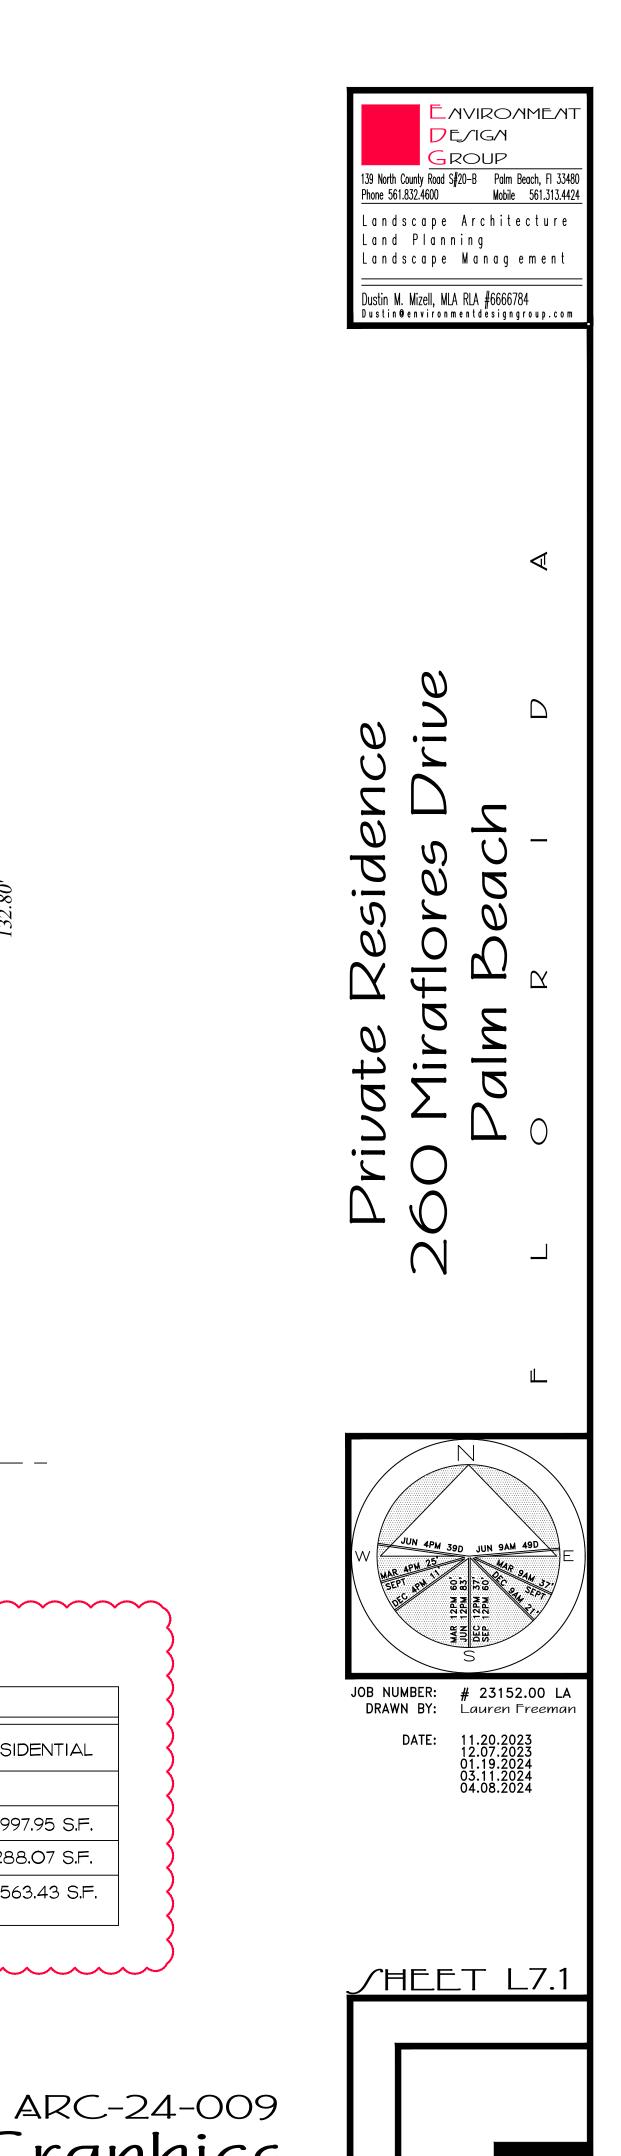

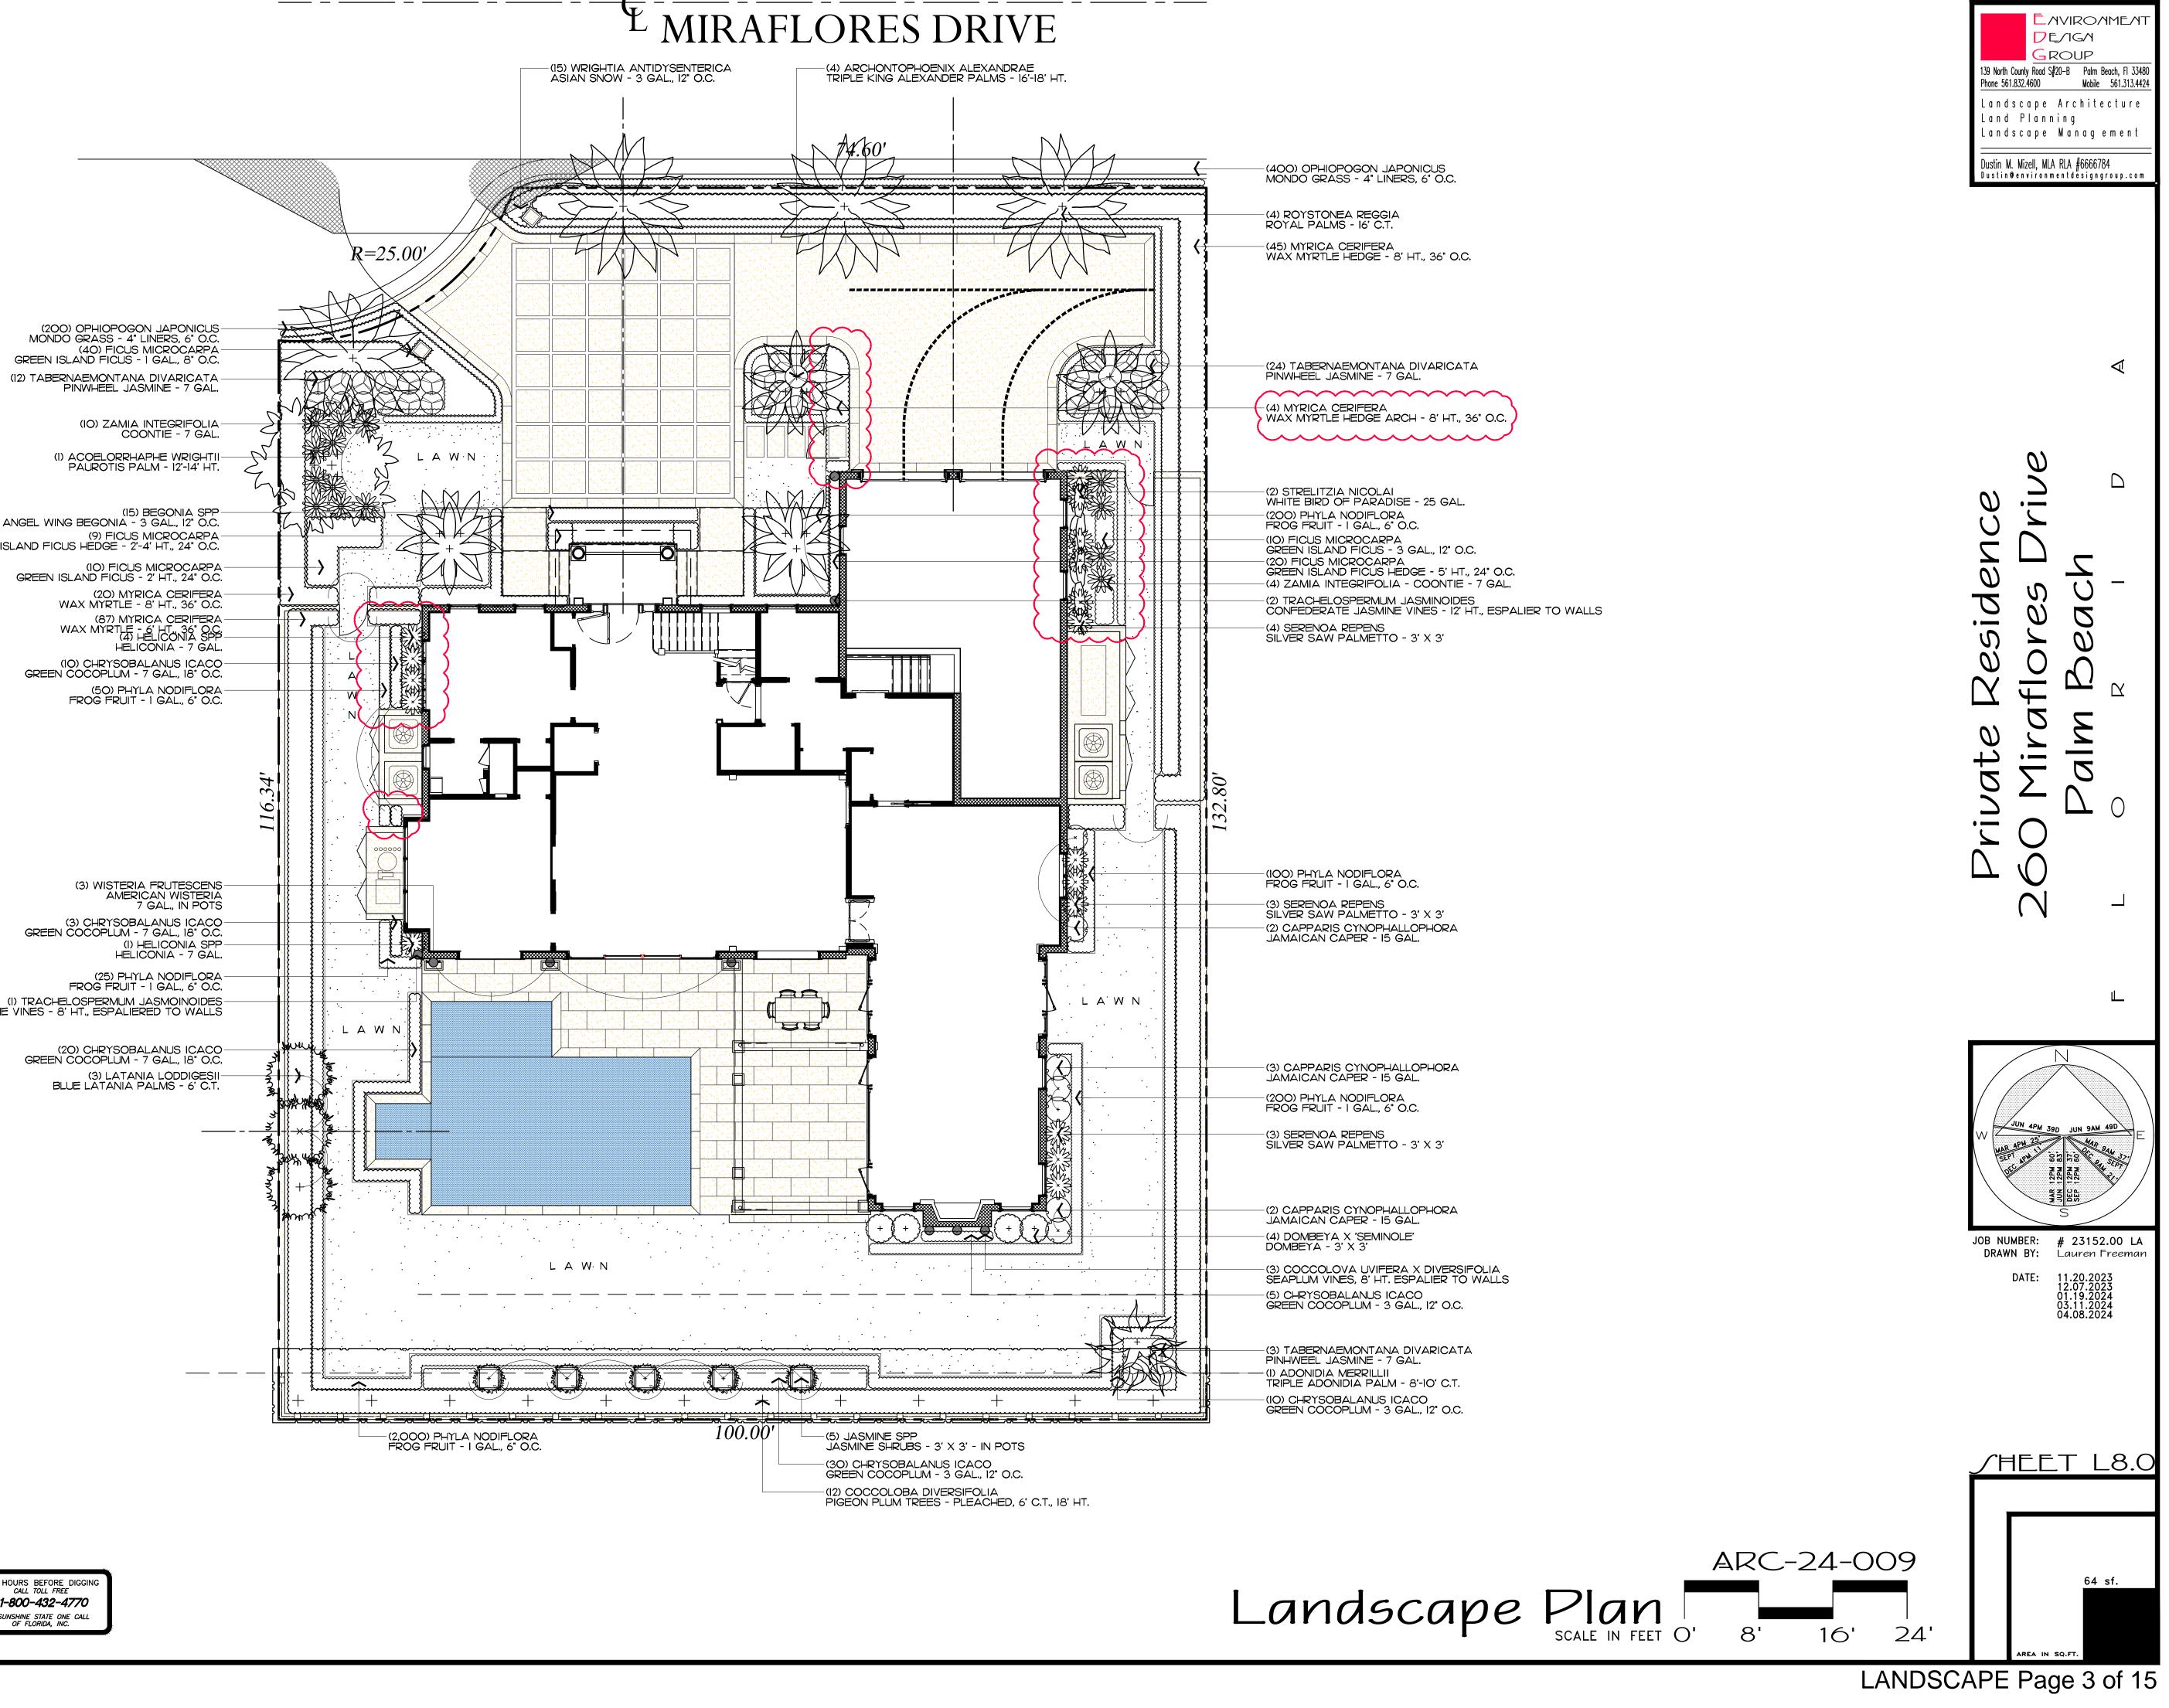

(15) BEGONIA SPP-PINK ANGEL WING BEGONIA - 3 GAL., 12" O.C. (9) FICUS MICROCARPA-GREEN ISLAND FICUS HEDGE - 2'-4' HT., 24" O.C. (IO) FICUS MICROCARPA-GREEN ISLAND FICUS - 2' HT., 24" O.C. (20) MYRICA CERIFERA


> (87) MYRICA CERIFERA WAX MYRTLE - 6' HT. 36" O.C. (4) HELICONIA SPP HELICONIA - 7 GAL. (10) CHRYSOBALANUS ICACO-GREEN COCOPLUM - 7 GAL., 18" O.C. (50) PHYLA NODIFLORA FROG FRUIT - I GAL., 6" O.C.


> > (3) WISTERIA FRUTESCENS AMERICAN WISTERIA 7 GAL., IN POTS

(3) CHRYSOBALANUS ICACO-GREEN COCOPLUM - 7 GAL., 18" O.C. (1) HELICONIA SPP HELICONIA - 7 GAL.

(25) PHYLA NODIFLORA FROG FRUIT - I GAL., 6" O.C. (I) TRACHELOSPERMUM JASMOINOIDES CONFEDERATE JASMINE VINES - 8' HT., ESPALIERED TO WALLS

> (20) CHRYSOBALANUS ICACO-GREEN COCOPLUM - 7 GAL., 18" O.C. (3) LATANIA LODDIGESII-BLUE LATANIA PALMS - 6' C.T.

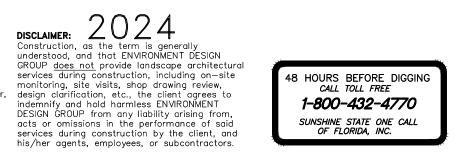

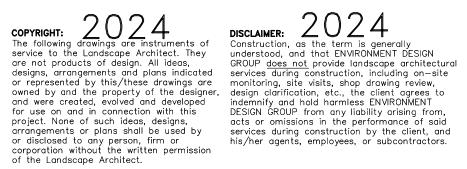


Trees					Shru	ıbs & Vines	)			139 North County Road S Phone 561.832.4600
SYMBOL	PLANT NAME	QTY.	DESCRIPTION	NATIVE	SYMBOL/KEY	PLANT NAME	QTY.	DESCRIPTION	NATIVE	Landscape Land Plan Landscape
+ + +	COCCOLOBA DIVERSIFOLIA PIGEON PLUM TREE	6	6' С.Т., 18' НТ. PLEACHED	YES		BEGONIA SPP PINK ANGEL WING BEGONIA	15	3 GAL., 12" O.C.	NO	Dustin M. Mizell, Dustin Øenviro
					x ce	CAPPARIS CYNOPHALLOPHORA JAMAICAN CAPER	7	15 GAL.	YES	
	TOTAL TREES: NATIVE SPECIES:	6 6 (100%)				CHRYSOBALANUS ICACO GREEN COCOPLUM	45	3 GAL., 12" O.C.	YES	
					, en	COCCOLOBA X DIVERSIFOLIA SEA PLUM VINES	3	8' HT., ESPALIER TO WALLS	YES	
<u> </u>					den + de	DOMBEYA X 'SEMINOLE' DOMBEYA	4	3' X 3'	NO	
Palm	5					FICUS MICROCARPA GREEN ISLAND FICUS	20 39	3 GAL., 12" O.C. 2'-5' HT., 24" O.C.	NO	
SYMBOL/KEY	PLANT NAME	QTY.	DESCRIPTION	NATIVE	+	GARDENIA JASMINOIDES GARDENIA STANDARD	2	6' HT., IN POTS	NO	
ALL	ACOELORRHAPHE WRIGHTII PAUROTIS PALM	1	12'-14' HT.	YES	ANNA ANNA ANNA ANNA ANNA ANNA ANNA ANN	HELICONIA SPP HELICONIA	4	7 GAL.	NO	0
Eurour History	ADONIDIA MERRILLI TRIPLE ADONIDIA PALM	1	8'-10' C.T.	NO		MYRICA CERIFERA WAX MYRTLE HEDGE	687	8' HT., 36" O.C. 6' HT., 36" O.C.	YES	$\tilde{\mathcal{O}}$
•	ARCHONTOPHOENIX ALEXANDRAE	4	16'-18' HT.	NO		JASMINE SPP JASMINE SHRUBS	5	3' X 3', IN POTS	NO	ž C
	TRIPLE KING ALEXANDER PALMS				ANN AND AND AND AND AND AND AND AND AND	SERENOA REPENS SILVER SAW PALMETTO	IO	3' X 3'	YES	de
	LATANIA LODDIGESII LATANIA PALMS	3	6' C.T.	NO	27MV	STRELITZIA NICOLAI WHITE BIRD OF PARADISE	2	25 GAL.	NO	Si.
	ROYSTONEA REGGIA ROYAL PALMS	4	16' C.T.	NO	$\sum$	TABERNAEMONTANA DIVARICATA	20	7 GAL.	NO	С С С
-W/2						PINWHEEL JASMINE SHRUBS TRACHELOSPERMUM JASMINOIDES		8' HT., ESP. TO WALLS	NO	0
						CONFEDERATE JASMINE VINES	2	12' HT., ESP. TO WALLS 12' HT., ESP. TO WALLS		άt Υi
	-					WRIGHTIA ANTIDYSENTERICA ASIAN SNOW	65	3 GAL., 12" O.C.	NO	
Grou	ndcovers				X X X X X X X X X X X X X X X X X X X	ZAMIA INTEGRIFOLIA	17	7 GAL.	YES	
SYMBOL/KEY	PLANT NAME	QTY.	DESCRIPTION	NATIVE	ZVV2					$\sim$
	FICUS MICROCARPA GREEN ISLAND FICUS	40	I GAL., 8" O.C.	NO		TOTAL: NATIVE SPECIES:	416 237 (57%)			
	OPHIOPOGON JAPONICUS MONDO GRASS	600	4" LINERS, 6" O.C.	NO	~~~~~~~~~~~~~~~~~~~~~~~~~~~~~~~~~~~~~~~			~~~~~~~~~~~~~~~~~~~~~~~~~~~~~~~~~~~~~~~		
(	PHYLA NODIFLORA	2,575	4" LINERS, 6" O.C.	YES				}		<b></b>
	FROGFRUIT				TOWN OF F	Town of Palm Beach		Ś		
	TOTAL: NATIVE SPECIES:	3,215 2,575 (80.1%)			SEN. OF TH	Planning Zoning and Building 360 S County Rd Palm Beach, FL 33480		3		
						www.townofpalmbeach.com		}		
					Prop	Landscape Legenderty Address:260 Mira	flores			
	n & Mulch				Lot	: Area (sq. ft.): 12965.7				JOB NUMBER: DRAWN BY: DATE:
SYMBOL/KEY	PLANT NAME	QTY.	DESCRIPTION		Landscape Open Space (LC	REQUIRED           DS) (Sq Ft and %)         5834.58 SF	PROPOSED 5,997.95 S.F. (4	46%)		DAIL:
						red (Sq FT and %) N/A	N/A			
LAWN	DIAMOND ZOYSIA LAWN	AS NEEDED				OS (Sq Ft and %) 2917.29 (50% REQ.D LOS)	3577.70 SF (619			
PLANTING BED	SHREDDED EUCALYPTUS MULCH	AS NEEDED	MULCH ALL BEDS 3" MIN. DEPTH		Front Yard LO	OS (Sq Ft and %)         1056.76 SF (40%)           Native Trees %         30%	1,288.07 S.F. (4 100%	+9%)		
						rubs & Vines % 30%	57%			<u>/he</u> e
					Native	Groundcover % 30	80.10%	}		
awings are instruments of andscape Architect. They s of design. All ideas, ments and plans indicated Bischart	2024 and that ENVIRONMENT DESIGN anot provide landscape architectural							}	ARC-24-009	
by this/these drawings are monitoring, the property of the designer, design clariti ed, evolved and developed indemnify an in connection with this DESIGN GRO f such ideas, designs, acts or omi	site visits, shop drawing review, fication, etc., the client agrees to dh dhold harmless ENVIRONMENT UP from any liability arising from, ssions in the performance of said <i>CALL TOLL FREE</i> <b>1-800-432-4770</b> <i>SUNSHINE STATE ONE CALL</i>				~~~~~~~~~~~~~~~~~~~~~~~~~~~~~~~~~~~~~~~			Plant	ARC-24-009 Schedule	
plans shall be used by services dur	ing construction by the client, and <b>OF FLORIDA, INC.</b>								,	

Trees					Shru	ıbs & Vines	)			□         □         SYMBOL	PLANT NAME	QTY.	DESCRIPTION	NATIVE	SYMBOL/KEY	PLANT NAME	QTY.	DESCRIPTION	NATIVE	Landscape Architecture Land Planning Landscape Management
+ + +	COCCOLOBA DIVERSIFOLIA PIGEON PLUM TREE	6	6' C.T., 18' HT. PLEACHED	YES		BEGONIA SPP PINK ANGEL WING BEGONIA	15	3 GAL., 12" O.C.	NO	Dustin M. Mizell, MLA RLA #66666784 Dustin@environmentdesigngroup.co
		<i>.</i>			x z z	CAPPARIS CYNOPHALLOPHORA JAMAICAN CAPER	7	15 GAL.	YES	
	TOTAL TREES: NATIVE SPECIES:	6 6 (100%)				CHRYSOBALANUS ICACO GREEN COCOPLUM	45	3 GAL., 12" O.C.	YES	
					and the second s	COCCOLOBA X DIVERSIFOLIA SEA PLUM VINES	3	8' HT., ESPALIER TO WALLS	YES	
						DOMBEYA X 'SEMINOLE' DOMBEYA	4	3' X 3'	NO	
Palm	5					FICUS MICROCARPA GREEN ISLAND FICUS	20 39	3 GAL., 12" O.C. 2'-5' HT., 24" O.C.	NO	$\triangleleft$
SYMBOL/KEY	PLANT NAME	QTY.	DESCRIPTION	NATIVE	( + )	GARDENIA JASMINOIDES GARDENIA STANDARD	2	6' HT., IN POTS	NO	
5	ACOELORRHAPHE WRIGHTII PAUROTIS PALM	I	12'-14' HT.	YES	ANN	HELICONIA SPP HELICONIA	4	7 GAL.	NO	$\delta$
Lunder	ADONIDIA MERRILLI TRIPLE ADONIDIA PALM	I	8'-10' C.T.	NO		MYRICA CERIFERA WAX MYRTLE HEDGE	68	8' HT., 36" O.C. 6' HT., 36" O.C.	YES	
٨		4	16'-18' HT.	NO	and	JASMINE SPP JASMINE SHRUBS	5	3' X 3', IN POTS	NO	$z^{2}$
	ARCHONTOPHOENIX ALEXANDRAE TRIPLE KING ALEXANDER PALMS				XXXXXXXXXXXXXXXXXXXXXXXXXXXXXXXXXXXXXX	SERENOA REPENS SILVER SAW PALMETTO	10	3' X 3'	YES	de - 70 -
	LATANIA LODDIGESII LATANIA PALMS	3	6' C.T.	NO		STRELITZIA NICOLAI WHITE BIRD OF PARADISE	2	25 GAL.	NO	esi 070 090
	ROYSTONEA REGGIA ROYAL PALMS	4	16' C.T.	NO		TABERNAEMONTANA DIVARICATA PINWHEEL JASMINE SHRUBS	20	7 GAL.	NO	
						TRACHELOSPERMUM JASMINOIDES CONFEDERATE JASMINE VINES	 2	8' HT., ESP. TO WALLS 12' HT., ESP. TO WALLS	NO	ate Airc aln
					{	WRIGHTIA ANTIDYSENTERICA ASIAN SNOW	65	3 GAL., 12" O.C.	NO	
Grou	ndcovers				ANNY ANNY	ZAMIA INTEGRIFOLIA	17	7 GAL.	YES	
SYMBOL/KEY	PLANT NAME	QTY.	DESCRIPTION	NATIVE	ZINS	COONTIE				$\neg$
	FICUS MICROCARPA GREEN ISLAND FICUS	40	I GAL., 8" O.C.	NO		TOTAL: NATIVE SPECIES:	416 237 (57%)			
[]	OPHIOPOGON JAPONICUS MONDO GRASS	600	4" LINERS, 6" O.C.	NO			~~~~~~			L
	PHYLA NODIFLORA FROGFRUIT	2,575	4" LINERS, 6" O.C.	YES	IN OF I	Town of Dolm Dooch				
	TOTAL: NATIVE SPECIES:	3,215 2,575 (80.1%)			AL OF THE	Town of Palm Beach Planning Zoning and Building 360 S County Rd				
						Palm Beach, FL 33480 www.townofpalmbeach.com		}		
					Prop	Landscape Legend           erty Address:         260 Mirat	flores	<b>}</b>		
	1 & Mulch					Area (sq. ft.): 12965.7				JOB NUMBER: # 23152.00 L DRAWN BY: Lauren Freema
						REQUIRED	PROPOS	<b>\</b>		DATE: 11.20.2023 12.07.2023 01.19.2024 03.11.2024 04.08.2024
SYMBOL/KEY	PLANT NAME	QTY.	DESCRIPTION	-	Landscape Open Space (LC LOS to be alte	DS) (Sq Ft and %)         5834.58 SF           red (Sq FT and %)         N/A	5,997.95 S.F N/A	. (46%)		04.08.2024
	DIAMOND ZOYSIA LAWN	AS NEEDED	SOD PALLETS	_	Perimeter LO		3577.70 SF			
PLANTING BED	SHREDDED EUCALYPTUS MULCH	AS NEEDED	MULCH ALL BEDS 3" MIN. DEPTH				1,288.07 S.F			
						Native Trees %30%rubs & Vines %30%	100% 57%	}		<u>/HEET L8.</u>
					Native	Groundcover % 30	80.10%	6		
na drawings are instruments of Construction	2024 as the term is generally and that ENVIRONMENT DESIGN							$\langle$	ARC - 74 - 009	
rangements and plans indicated services durin nted by this/these drawings are monitoring, si and the property of the designer, design clarific created, evolved and developed indemnify and	not provide landscape architectural g construction, including on-site ite visits, shop drawing review, tation, etc., the client agrees to hold harmless ENVIRONMENT P from any liability arising from,				h				arc-24-009 Schedule	
ne of such ideas, designs, acts or omiss ts or plans shall be used by services durin	is construction by the client, and ts, employees, or subcontractors.									

SYMBOL/KEY	PLANT N	JAME	QTY.	DESCRIPTION
		ROCARPA SLAND FICUS	40	1 GAL., 8" O.C.
	OPHIOPOG MONDO	GON JAPONICUS GRASS	600	4" LINERS, 6" O.C.
	PHYLA NO FROGFR		2,575	4" LINERS, 6" O.C.
		TOTAL: NATIVE SPECIES:	3,215 2,575 (80.1%)	

SYMBOL/KEY	PLANT NAME	QTY.	DESCRIPTION
LAWN	DIAMOND ZOYSIA LAWN	AS NEEDED	SOD PALLETS
PLANTING BED	SHREDDED EUCALYPTUS MULCH	AS NEEDED	MULCH ALL BEDS 3" MIN. DEPTH




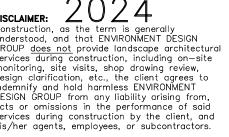



Shrubs & Vines						
SYMBOL/KEY	PLANT	NAME	QTY.	DESCRIPTION	NATIVE	Landscape Architecture Land Planning
()	BEGONIA		15	3 GAL., 12" O.C.	NO	Landscape Management  Dustin M. Mizell, MLA RLA #66666784 Dustin@environmentdesigngroup.com
(× ¢	CAPPAR	NGEL WING BEGONIA IS CYNOPHALLOPHORA	7	15 GAL.	YES	bustin e en viron mentue sign group, com
	CHRYSO	CAN CAPER BALANUS ICACO	45	3 GAL., 12" O.C.	YES	
	COCCOL	OBA X DIVERSIFOLIA	3	8' HT., ESPALIER TO WALLS	YES	
\$ + }		UM VINES A X 'SEMINOLE'	4	3' X 3'	NO	
Contract of the second	DOMBE FICUS M	YA ICROCARPA	20	3 GAL., 12" O.C.	NO	
	GREEN	ISLAND FICUS	20 39 2	2'-5' HT., 24" O.C.	NO	$\bigtriangledown$
+		A JASMINOIDES NIA STANDARD	2	6' HT., IN POTS		
XXXXXXXXXXXXXXXXXXXXXXXXXXXXXXXXXXXXXX	HELICON HELICC		4	7 GAL.	NO	$\tilde{o}$
		CERIFERA YRTLE HEDGE	689	8' HT., 36" O.C. 6' HT., 36" O.C.	YES	
20 + 20 20 + 20 20 + 20 20 + 20 20	JASMINE JASMIN	SPP IE SHRUBS	5	3' X 3', IN POTS	NO	ž D z
ANNA ANA		A REPENS SAW PALMETTO	IO	3' X 3'	YES	act act
		ZIA NICOLAI BIRD OF PARADISE	2	25 GAL.	NO	esi ore oec
		AEMONTANA DIVARICATA EL JASMINE SHRUBS	20	7 GAL.	NO	
	TRACHE	LOSPERMUM JASMINOIDES DERATE JASMINE VINES	5 I 2	8' HT., ESP. TO WALLS 12' HT., ESP. TO WALLS	NO	ate Airo alm
	WRIGHTI. ASIAN	A ANTIDYSENTERICA SNOW	65	3 GAL., 12" O.C.	NO	
X XXXXXXXXXXXXXXXXXXXXXXXXXXXXXXXXXXXX		NTEGRIFOLIA	17	7 GAL.	YES	
		TOTAL: NATIVE SPECIES:	416 237 (57%)			• •
OF F	Plan	<b>n of Palm Beach</b> ning Zoning and Building 360 S County Rd Palm Beach, FL 33480 www.townofpalmbeach.com <b>Landscape Legend</b>	<u> </u>			
Prop	erty Address:		iraflores			
Lot	: Area (sq. ft.):	12965	5.73 SF	}		JOB NUMBER: # 23152.00 LA DRAWN BY: Lauren Freeman
		REQUIRED	PROPOSE	<b>\</b>		DATE: 11.20.2023 12.07.2023 01.19.2024 03.11.2024 04.08.2024
Landscape Open Space (LO		5834.58 SF	5,997.95 S.F.	(46%)		04.08.2024
	red (Sq FT and %) OS (Sq Ft and %)		N/A 3577.70 SF (	<u> </u>		
	95 (Sq Ft and %)		1,288.07 S.F.			
Native Trees %30%		100%				
Native Sh	rubs & Vines %	30%	57%			<u>/HEET L8.1</u>
Native	Groundcover %	30	80.10%			
				Ş		
					ARC-24-009	
				Plant	/chedule	

## LANDSCAPE Page 4 of 15

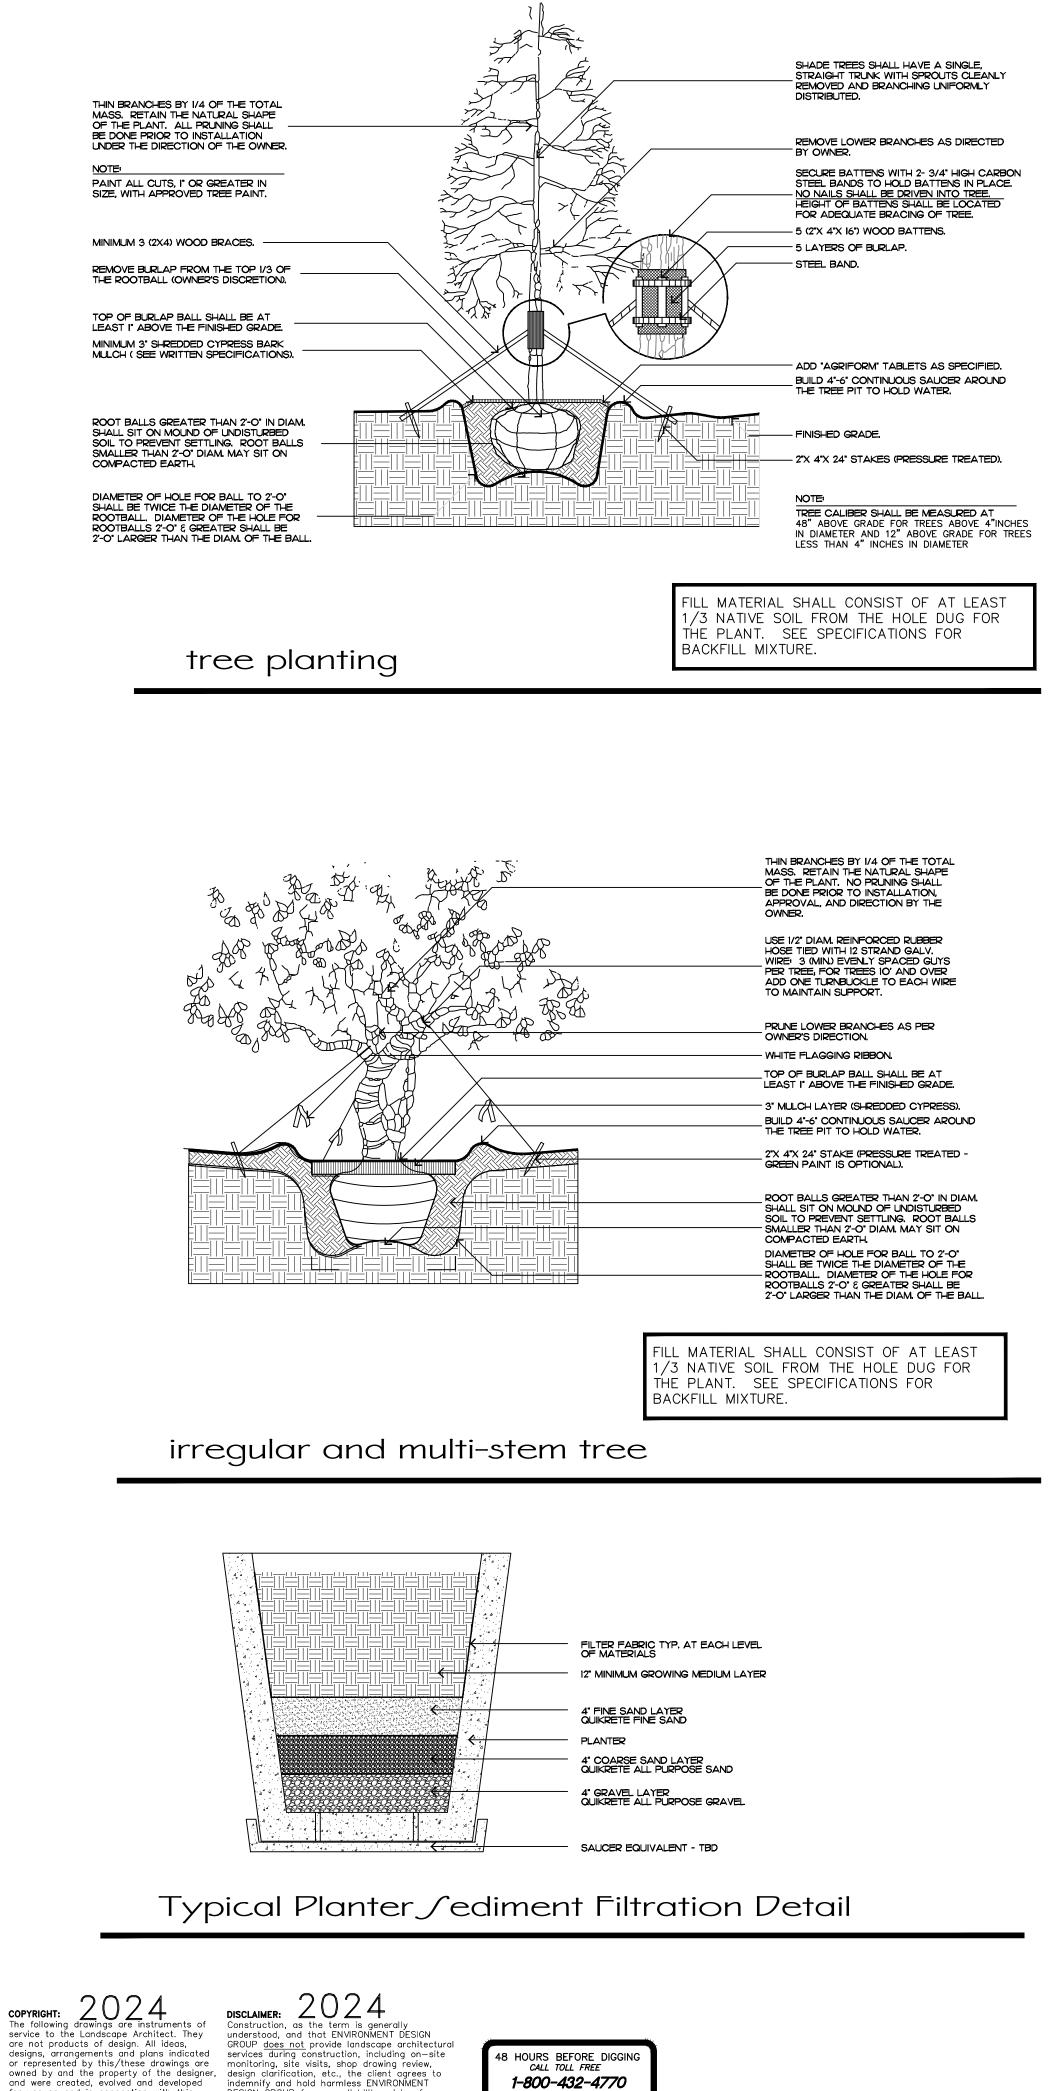


project. None of such ideas, designs, arrangements or plans shall be used by or disclosed to any person, firm or corporation without the written permission of the Landscape Architect.

for use on and in connection with this

DESIGN GROUP from any liability arising from, acts or omissions in the performance of said services during construction by the client, and his/her agents, employees, or subcontractors.

1-800-432-4770 SUNSHINE STATE ONE CALL OF FLORIDA, INC.

## Planting Details & Specifications

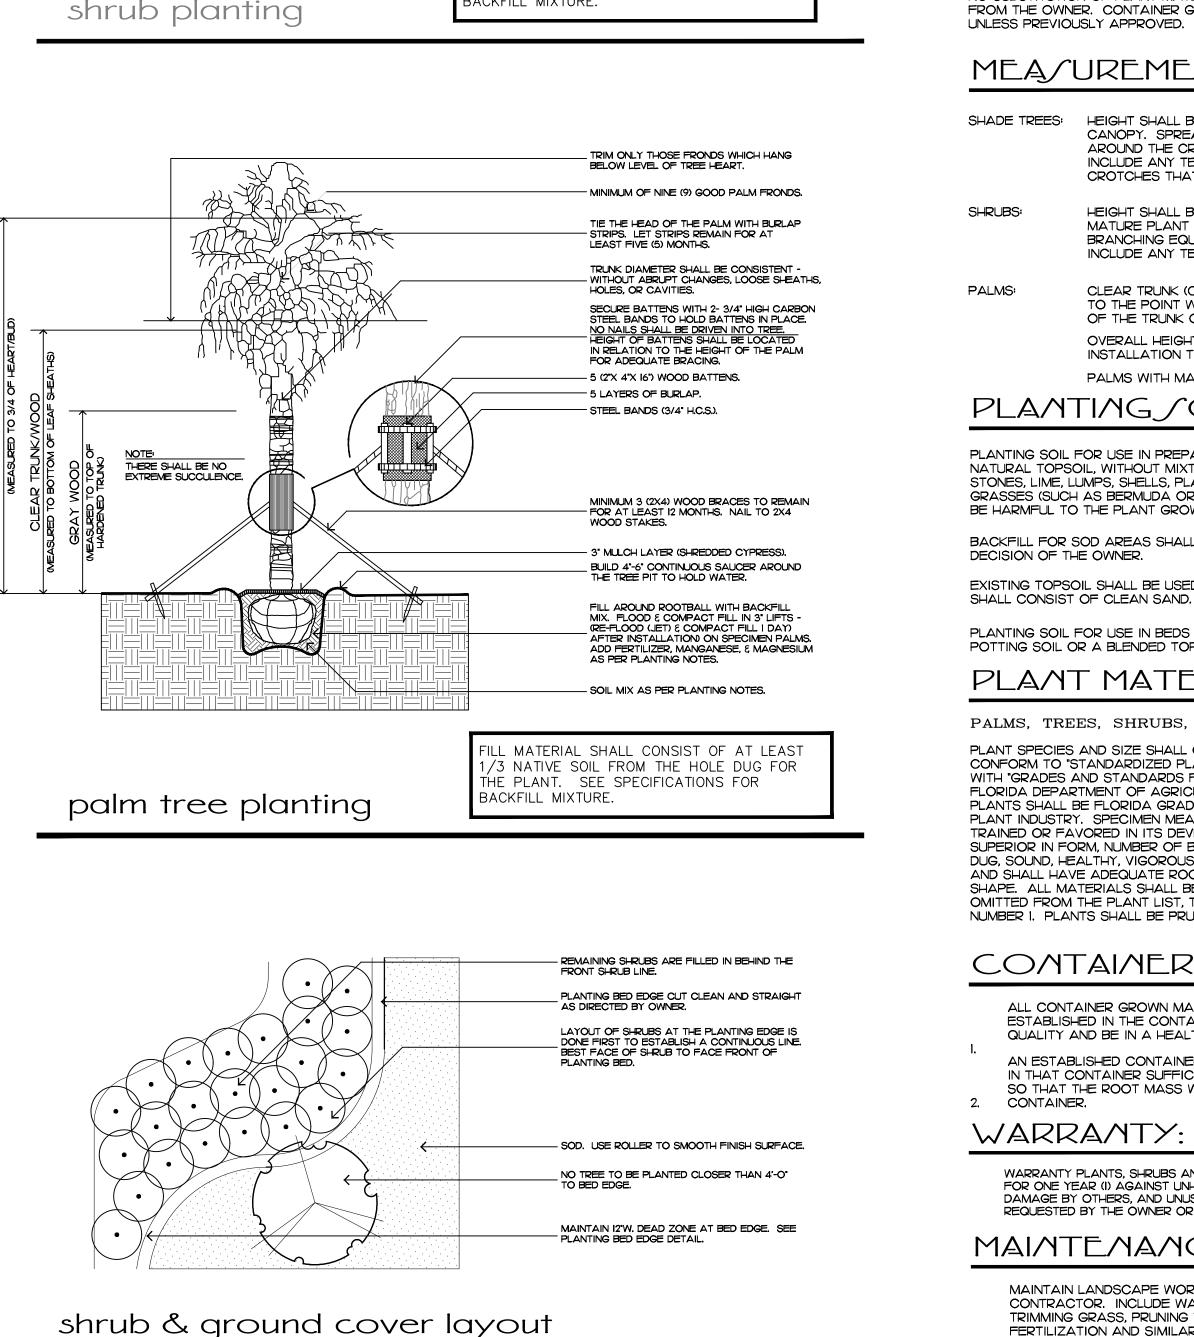

PRUNE SHRUBS AT OWNER'S DIRECTION.

- PRUNE ALL SHRUBS TO ACHIEVE A UNIFORM MASS.

\_ TOP OF BURLAP BALL SHALL BE AT LEAST I 1/2" ABOVE THE FIN, GRADE,

THE TREE PIT TO HOLD WATER.

COMPACTED EARTH.

ILL MATERIAL SHALL CONSIST OF AT LEAST

/3 NATIVE SOIL FROM THE HOLE DUG FOR

THE PLANT. SEE SPECIFICATIONS FOR

BACKFILL MIXTURE.

3" MULCH LAYER (SHREDDED CYPRESS).

BUILD 4"-6" CONTINUOUS SAUCER AROUND

ROOT BALLS GREATER THAN 2-O' IN DIAM. SHALL SIT ON MOUND OF UNDISTURBED - SOIL TO PREVENT SETTLING. ROOT BALLS SMALLER THAN 2-O' DIAM. MAY SIT ON

DIAMETER OF HOLE FOR BALL TO 2'-O'

SHALL BE TWICE THE DIAMETER OF THE - ROOTBALL, DIAMETER OF THE HOLE FOR ROOTBALLS 2'-O' & GREATER SHALL BE

2'-O' LARGER THAN THE DIAM. OF THE BALL

## JUB/TITUTION/:

## MEA/UREMENT/:

NO SUBSTITUTION OF PLANT MATERIAL TYPES OR SIZES WILL BE ALLOWED WITHOUT WRITTEN AUTHORIZATION FROM THE OWNER. CONTAINER GROWN MATERIAL WILL NOT BE ACCEPTED AS SUBSTITUTE FOR BEB MATERIAL UNLESS PREVIOUSLY APPROVED. INTENDED SUBSTITUTIONS SHALL BE SPELLED OUT IN BID.

PRIOR TO LAYING.

## Planting Notes COMMERCIAL FERTILIZER:

FERTILIZER SHALL BE COMPLETELY ORGANIC, IT SHALL BE UNIFORM IN COMPOSITION, DRY AND FREE FLOWING. THIS FERTILIZER SHALL BE DELIVERED TO THE SITE IN THE ORIGINAL UNOPENED BAGS, EACH BEARING THE MANUFACTURER'S STATEMENT OF ANALYSIS, AND SHALL MEET THE FOLLOWING REQUIREMENTS:

SIX PERCENT (6%) POTASSIUM

SIX PERCENT (6%) NITROGEN SIX PERCENT (6%) PHOSPHOROUS

FERTILIZER SHALL BE APPLIED TO ALL SHRUBS (1/3 LB. PER 3 GAL. POT, 1/4 LB. PER 1 GAL. POT) AND GROUNDCOVER. THE SAME FERTILIZER MIXTURE SHALL BE USED ON SOD AT A RATE OF 15 LBS. PER 1000 SQUARE FEET. A FOURTEEN PERCENT (14%) NITROGEN, FOURTEEN PERCENT (14%) PHOSPHOROUS AND FOURTEEN PERCENT (14%) POTASSIUM IS REQUIRED ON ALL TREES AND SHRUBS OVER 5'-O" IN HEIGHT (1/2 LB, PER 5'-O" OF SPREAD). AGRIFORM TABLETS WITH TWENTY PERCENT (20%) NITROGEN. TEN PERCENT (10%) PHOSPHOROUS, FIVE PERCENT (5%) POTASSIUM IN 21 GRAM SIZES SHALL BE APPLIED ALONG WITH THE FERTILIZER PROCESS (I WITH I GAL. PLANTS, 2 WITH 3 GAL. PLANTS AND 2 TABLETS PER I" OF TREE TRUNK CALIPER). BACK FILL HALFWAY UP THE ROOT BALL, PLACE ABOUT ONE INCH (I") FROM ROOT TIPS. MAGNESIUM SULFATE SHALL BE APPLIED TO ALL PALMS AT INSTALLATION AT A RATE OF 1/2 LB. PER INCH OF TRUNK CALIPER. MANGANESE SHALL BE APPLIED AT THE SAME RATE.

MULCH: MULCH MATERIAL SHALL BE SHREDDED CYPRESS MULCH OR APPROVED EQUAL, MOISTENED AT THE TIME OF APPLICATION TO PREVENT WIND DISPLACEMENT. MULCH SHALL BE APPLIED TO A MINIMUM 3" DEPTH IN PLANTING BEDS.

 $\int OD$ :

CLEAR TRUNK (C.T.) - SHALL BE MEASURED FROM THE GROUND AT TIME OF INSTALLATION TO THE POINT WHERE THE MATURE AGED TRUNK JOINS THE IMMATURE OR GREEN PORTION OF THE TRUNK OR HEAD. OVERALL HEIGHT (O.A.) - SHALL BE MEASURED FROM THE GROUND AT THE TIME OF INSTALLATION TO THE AVERAGE FROND HEIGHT. PALMS WITH MARRED OR BURNED TRUNKS WILL NOT BE ACCEPTED.

PLANTING / OIL AND BACKFILL:

THE SOD SHALL BE FREE FROM WEEDS, FUNGUS, INSECTS AND DISEASES OF ANY KIND, CLEAN, STRONGLY ROOTED, UNIFORMLY SIZED STRIPS, MACHINE STRIPPED NOT MORE THAN TWENTY-FOUR (24) HOURS

> HEIGHT SHALL BE MEASURED FROM GROUND TO THE AVERAGE BRANCH HEIGHT OF CANOPY. SPREAD SHALL BE MEASURED TO THE END OF THE BRANCHING EQUALLY AROUND THE CROWN FROM THE CENTER OF THE TRUNK. MEASUREMENTS ARE NOT TO INCLUDE ANY TERMINAL GROWTH. SINGLE TRUNK TREES SHALL BE FREE OF "V" CROTCHES THAT COULD BE POINTS OF WEAK LIMB STRUCTURE OR DISEASE INFESTATION.

HEIGHT SHALL BE MEASURED FROM THE GROUND TO THE AVERAGE POINT WHERE MATURE PLANT GROWTH STOPS. SPREAD SHALL BE MEASURED TO THE END OF BRANCHING EQUALLY AROUND THE SHRUB MASS. MEASUREMENT AREA NOT TO INCLUDE ANY TERMINAL GROWTH.

PLANTING SOIL FOR USE IN PREPARING BACKFILL FOR PLANT PITS SHALL BE A FERTILE, FRIABLE AND NATURAL TOPSOIL, WITHOUT MIXTURE OF SUBSOIL MATERIALS, AND SHALL BE FREE FROM HEAVY CLAY, STONES, LIME, LUMPS, SHELLS, PLANTS, ROOTS OR OTHER FOREIGN MATERIALS, WEEDS, OR NOXIOUS GRASSES (SUCH AS BERMUDA OR NUT GRASS), IT SHALL NOT CONTAIN TOXIC SUBSTANCES WHICH MAY BE HARMFUL TO THE PLANT GROWTH.

BACKFILL FOR SOD AREAS SHALL BE SUBJECT TO LESSER STANDARDS AT THE DISCRETION AND

EXISTING TOPSOIL SHALL BE USED IN ALL PLANT MATERIAL PITS EXCEPT SABAL PALMS WHERE THE SOIL

PLANTING SOIL FOR USE IN BEDS FOR ANNUALS AND/OR PERENNIALS SHALL CONTAIN ONE-THIRD (1/3) POTTING SOIL OR A BLENDED TOPSOIL, TILL INTO TOP 10" - 12" OF SOIL WITH A TIME-RELEASE FERTILIZER.

## PLANT MATERIAL /:

PALMS, TREES, SHRUBS, GROUNDCOVERS AND VINES

PLANT SPECIES AND SIZE SHALL CONFORM TO THOSE INDICATED ON THE DRAWINGS. NOMENCLATURE SHALL CONFORM TO "STANDARDIZED PLANT NAMES", 1942 EDITION. ALL NURSERY STOCK SHALL BE IN ACCORDANCE WITH "GRADES AND STANDARDS FOR NURSERY PLANTS PARTS I & II", LATEST EDITION PUBLISHED BY THE FLORIDA DEPARTMENT OF AGRICULTURE AND CONSUMER SERVICES. UNLESS SPECIFIED OTHERWISE, ALL PLANTS SHALL BE FLORIDA GRADE NUMBER I OR BETTER AS DETERMINED BY THE FLORIDA DIVISION OF PLANT INDUSTRY. SPECIMEN MEANS AN EXCEPTIONALLY HEAVY, SYMMETRICAL TIGHTLY KNIT PLANT, SO TRAINED OR FAVORED IN ITS DEVELOPMENT THAT FIRST APPEARANCE IS UNQUESTIONABLE AND OUTSTANDINGLY SUPERIOR IN FORM, NUMBER OF BRANCHES, COMPACTNESS AND SYMMETRY. ALL PLANTS SHALL BE FRESHLY DUG, SOUND, HEALTHY, VIGOROUS, WELL BRANCHED AND FREE OF DISEASE AND INSECT EGGS AND LARVAE AND SHALL HAVE ADEQUATE ROOT SYSTEMS. TREES FOR PLANTING ROWS SHALL BE UNIFORM IN SIZE AND SHAPE. ALL MATERIALS SHALL BE SUBJECT TO APPROVAL BY THE OWNER. WHERE REQUIREMENTS ARE OMITTED FROM THE PLANT LIST, THE PLANTS FURNISHED SHALL BE NORMAL FOR THE VARIETY AND FLORIDA NUMBER I. PLANTS SHALL BE PRUNED PRIOR TO DELIVERY ONLY UPON THE APPROVAL OF THE OWNER.

### CONTAINER GROWN/TOCK:

ALL CONTAINER GROWN MATERIAL SHALL BE HEALTHY, VIGOROUS, WELL-ROOTED PLANTS AND ESTABLISHED IN THE CONTAINER IN WHICH THEY ARE SOLD. THE PLANTS SHALL HAVE TOPS OF GOOD QUALITY AND BE IN A HEALTHY GROWING CONDITION.


AN ESTABLISHED CONTAINER GROWN PLANT SHALL BE TRANSPLANTED INTO A CONTAINER AND GROWN IN THAT CONTAINER SUFFICIENTLY LONG ENOUGH FOR THE NEW FIBROUS ROOTS TO HAVE DEVELOPED SO THAT THE ROOT MASS WILL RETAIN ITS SHAPE AND HOLD TOGETHER WHEN REMOVED FROM THE

PLANT MATERIAL.


NARRANTY PLANTS, SHRUBS AND GROUNDCOVERS FOR A PERIOD OF NINETY (90) DAYS: TREES  $\xi$  PALMS FOR ONE YEAR (I) AGAINST UNHEALTHY CONDITION, EXCEPT AS MAY RESULT FROM NEGLECT BY OWNER, DAMAGE BY OTHERS, AND UNUSUAL PHENOMENA BEYOND INSTALLER'S CONTROL. REPLACE AT TIME REQUESTED BY THE OWNER OR LANDSCAPE ARCHITECT

MAINTENANCE:

MAINTAIN LANDSCAPE WORK UNTIL THE LETTER OF SUBSTANTIAL COMPLETION BY THE GENERAL CONTRACTOR. INCLUDE WATERING, WEEDING, CULTIVATING, RESTORATION OF GRADE, MOWING AND TRIMMING GRASS, PRUNING TREES AND SHRUBS, PROTECTION FROM INSECTS AND DISEASES, FERTILIZATION AND SIMILAR OPERATIONS AS NEEDED TO ENSURE NORMAL GOOD HEALTH FOR LIVE

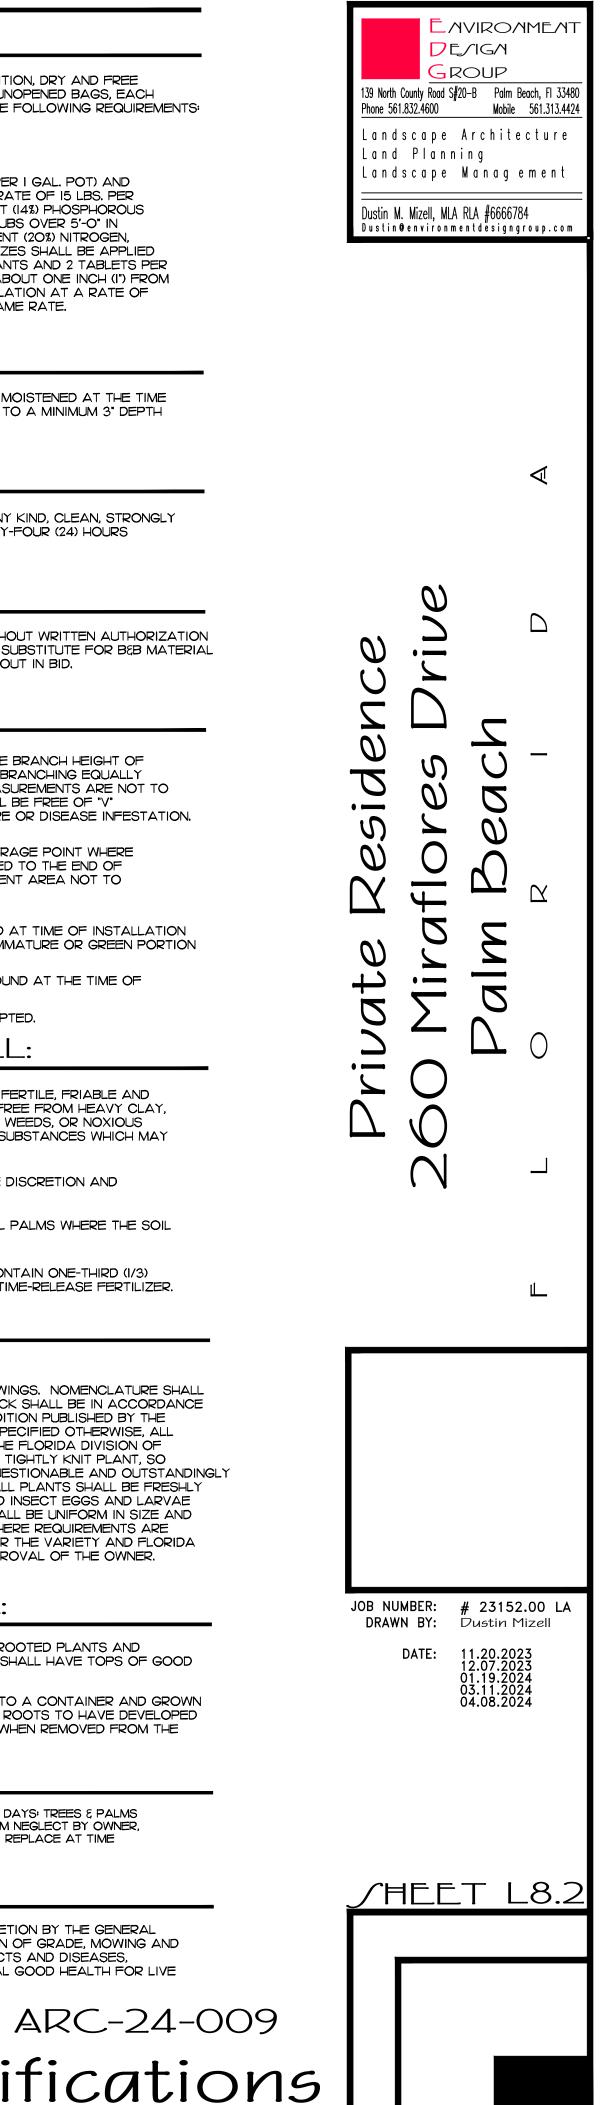



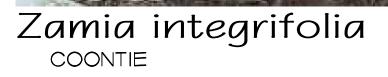



Begonia spp. PINK BEGONIA



Archontophoenix alexandrae TRIPLE KING ALEXANDER PALM



Coccoloba uvifera x diversifolia SEA PLUM VINES

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Strelitzia nicolai WHITE BIRD OF PARADISE



Gardenia jasminoides gardenia standard tree



Wrightia antidysenterica



Acoelorrhaphe wrightii PAUROTIS PALM



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JOB NUMBER: # 23152.00 LA DRAWN BY: Lauren Freeman

DATE:

01.19.2024 03.11.2024 04.08.2024

DE/IGM 

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 Road
 \$#20-B
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Landscape Architecture Land Planning Landscape Management

Dustin M. Mizell, MLA RLA #6666784 Dustin@environmentdesigngroup.com

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Trachelospermum jasminoides CONFEDERATE JASMINE VINES



Ficus microcarpa GREEN ISLAND FICUS



Capparis cynophallophora JAMAICAN CAPER

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Dombeya x seminole



Latania loddigessi LATANIA PALM





Adonidia merrillii TRIPLE ADONIDIA PALM



JOB NUMBER: # 23152.00 LA DRAWN BY: Lauren Freeman

01.19.2024 03.11.2024 04.08.2024

DATE:

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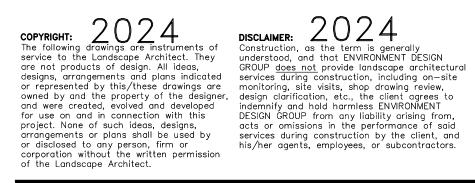


Heliconia spp





Coccoloba diversifolia PIGEON PLUM TREE



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Roystonea reggia ROYAL PALMS




Tabernaemontana divaricata PINWHEEL JASMINE



SILVER SAW PALMETTO




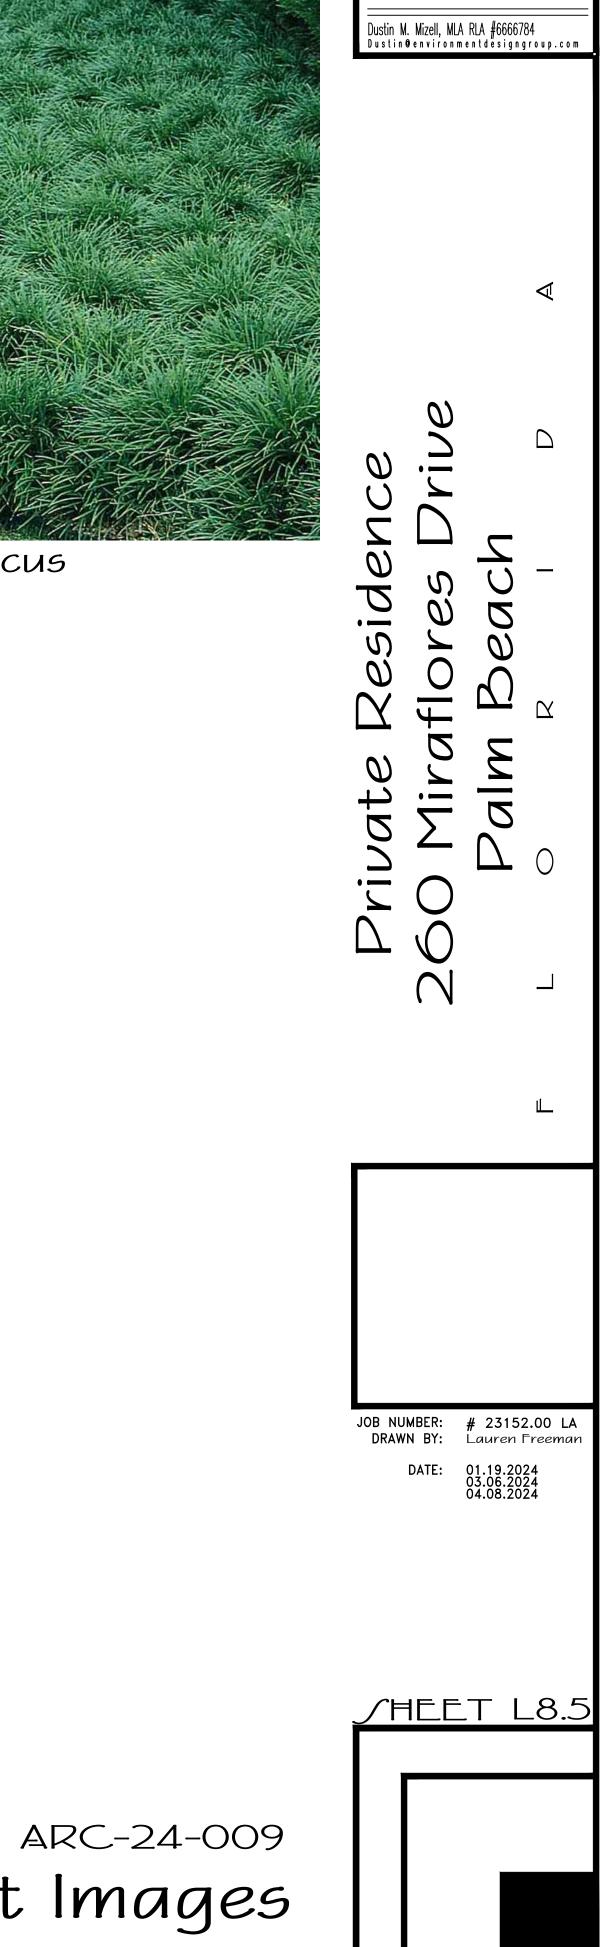


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# <sup>A</sup>MIRAFLORES DRIVE



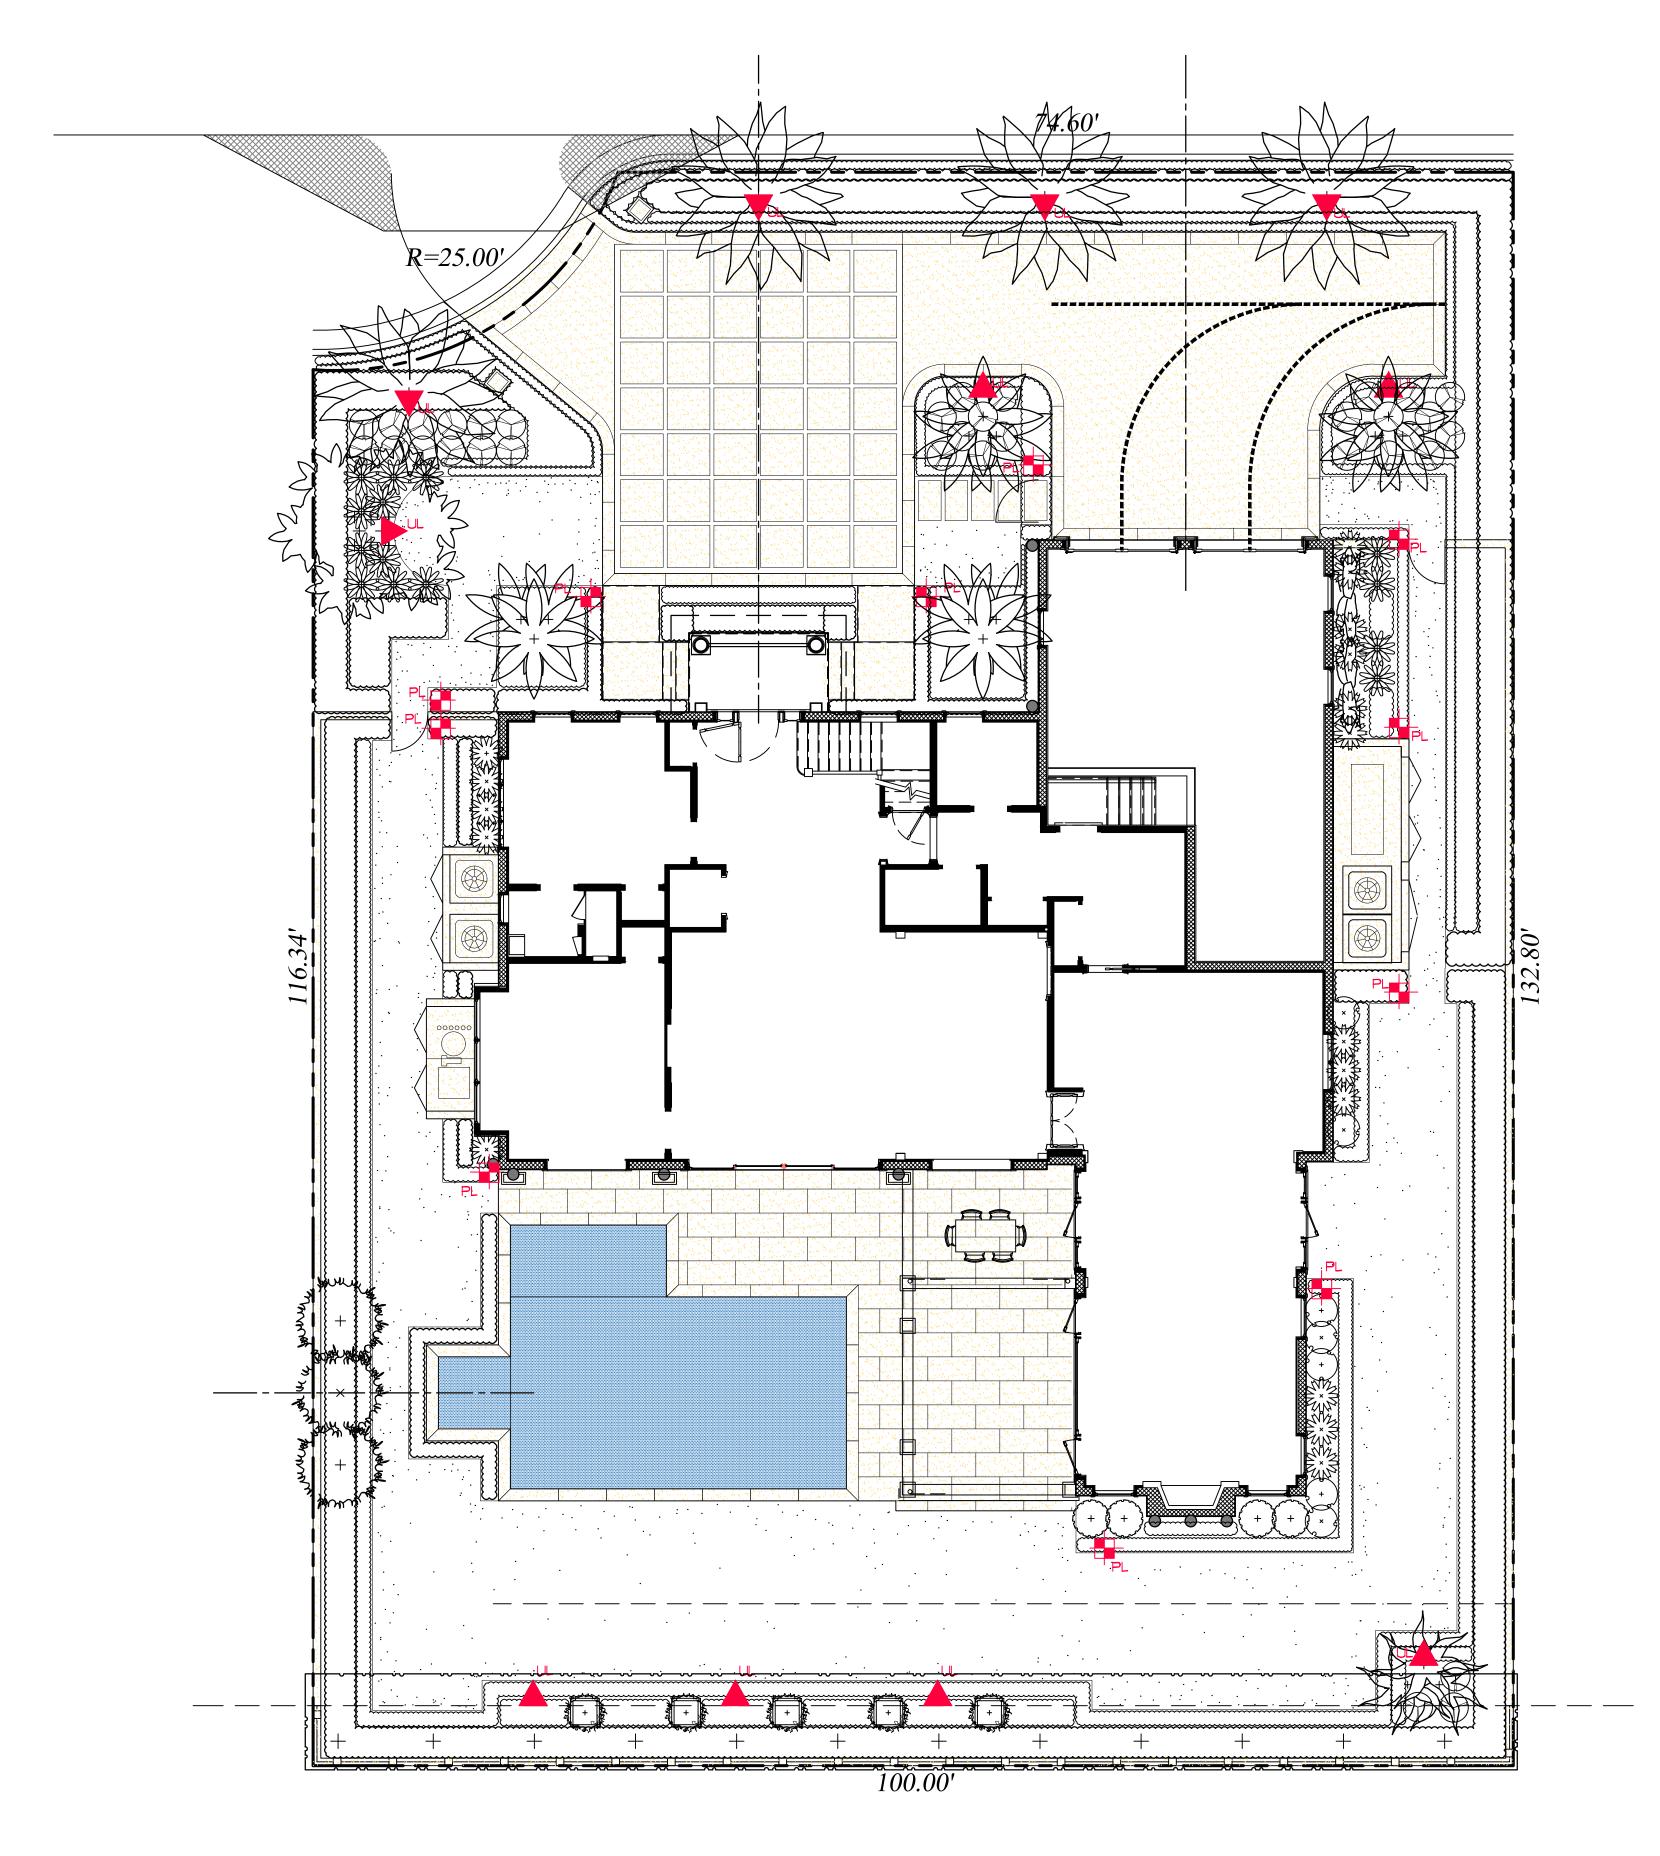

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SYMBOL	DESCRIPTION	QTY
	<u>UPLIGHT</u> - AURORALIGHT - HSLI6-R TELLURIDE BRASS - 3 WATTS - LED 3000K	11
🕂 PL	<u>PATH LIGHT</u> - AURORALIGHT - LPL8 - CORONA BRASS FINISH - 4.5 WATTS - LED 3000K	11

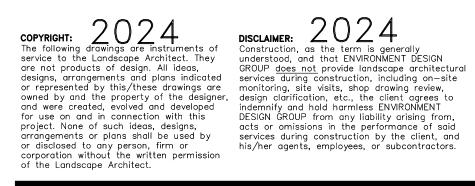

UP LIGHT

# Landscape Lighting Plan

## Lighting *S*chedule




PATH LIGHT

8'


16'

24'

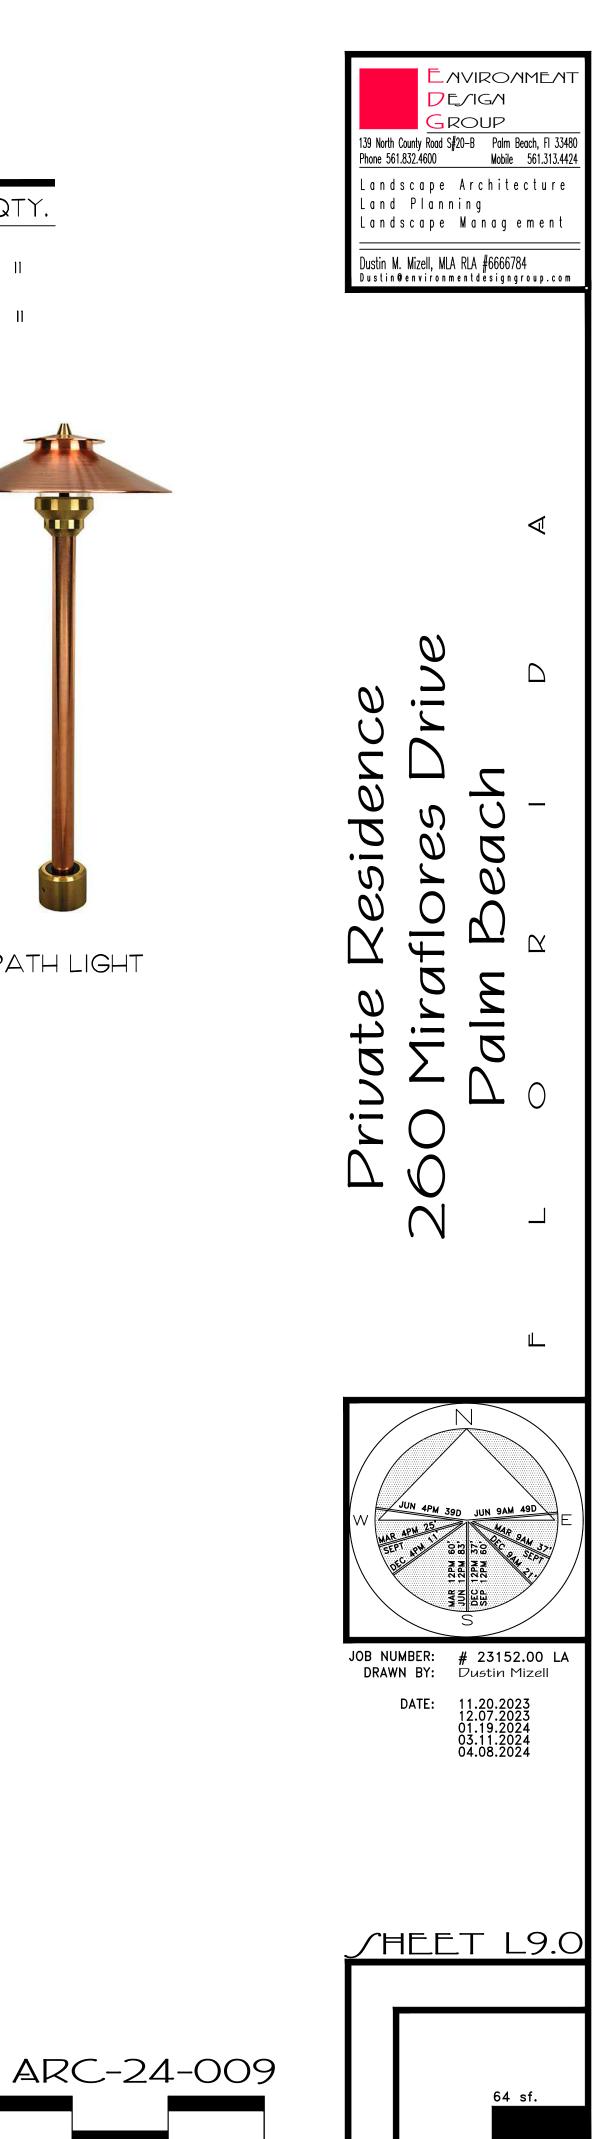

LANDSCAPE Page 9 of 15


REA IN SQ.FT.

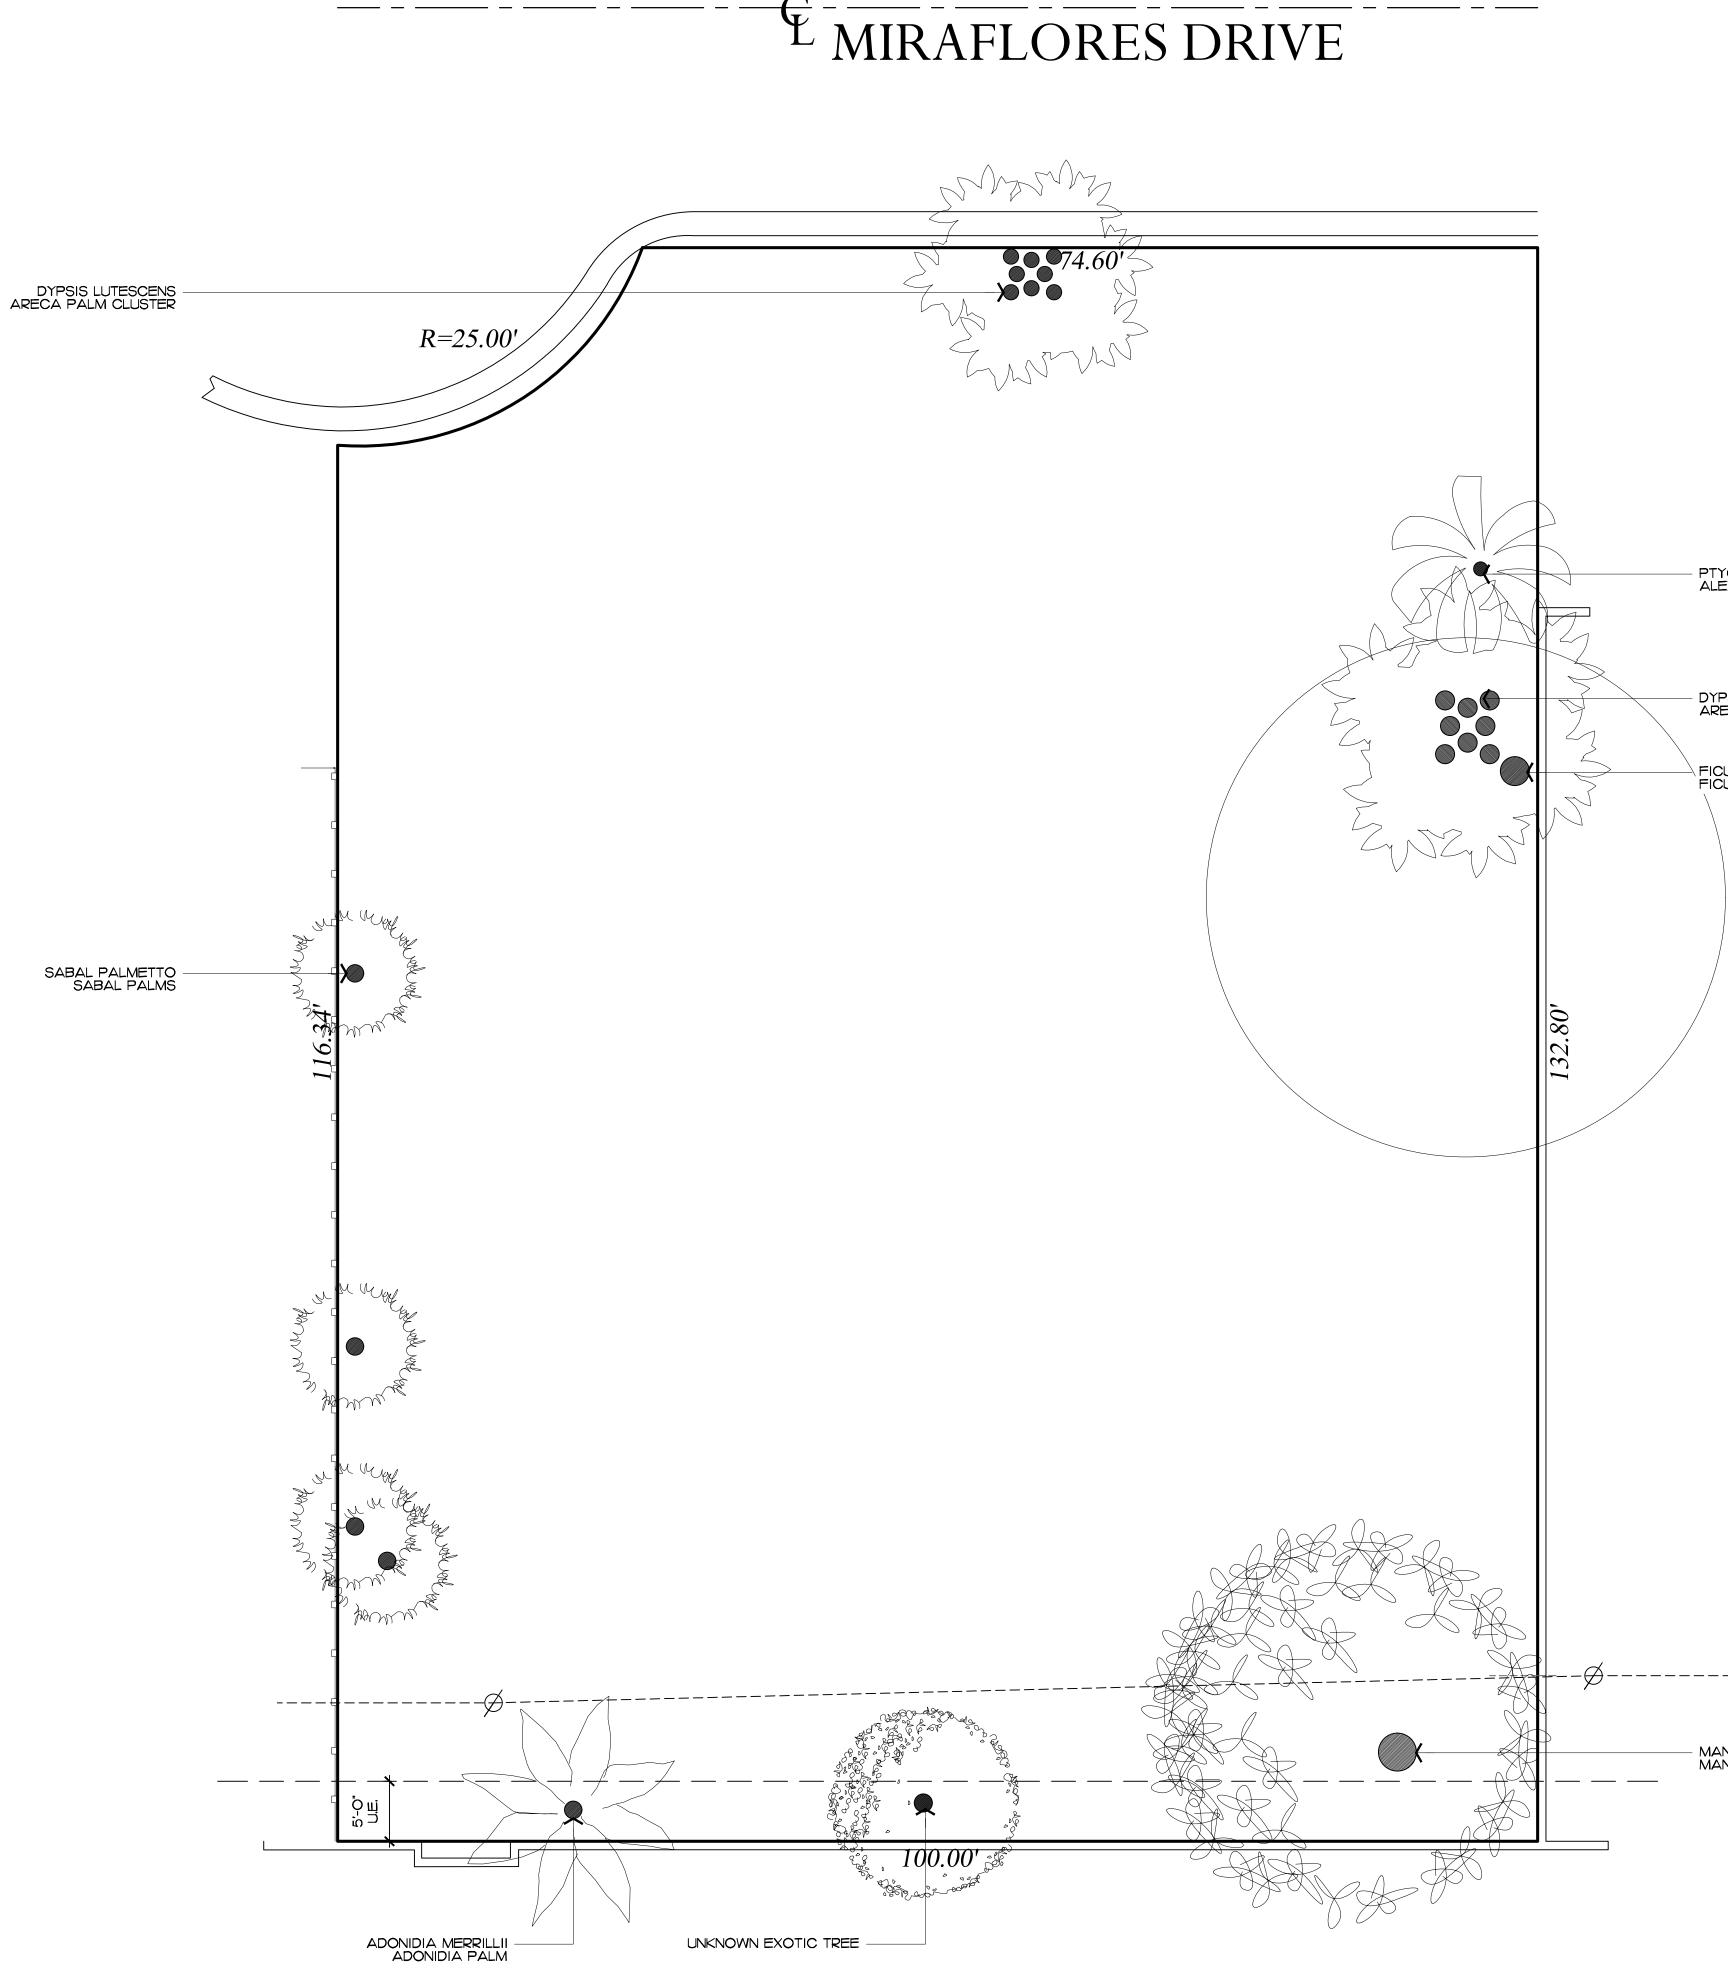


Survive to the Landscape Architect. They are not products of design. All ideas, or represented by this/these drawings are owned by and the property of the designer, and were created, evolved and developed for use on and in connection with this project. None of such ideas, designs, arrangements or plans shall be used by or disclosed to any person, firm or corporation without the written permission of the Landscape Architect.

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Existing Vegetation Inventory & Action Plan

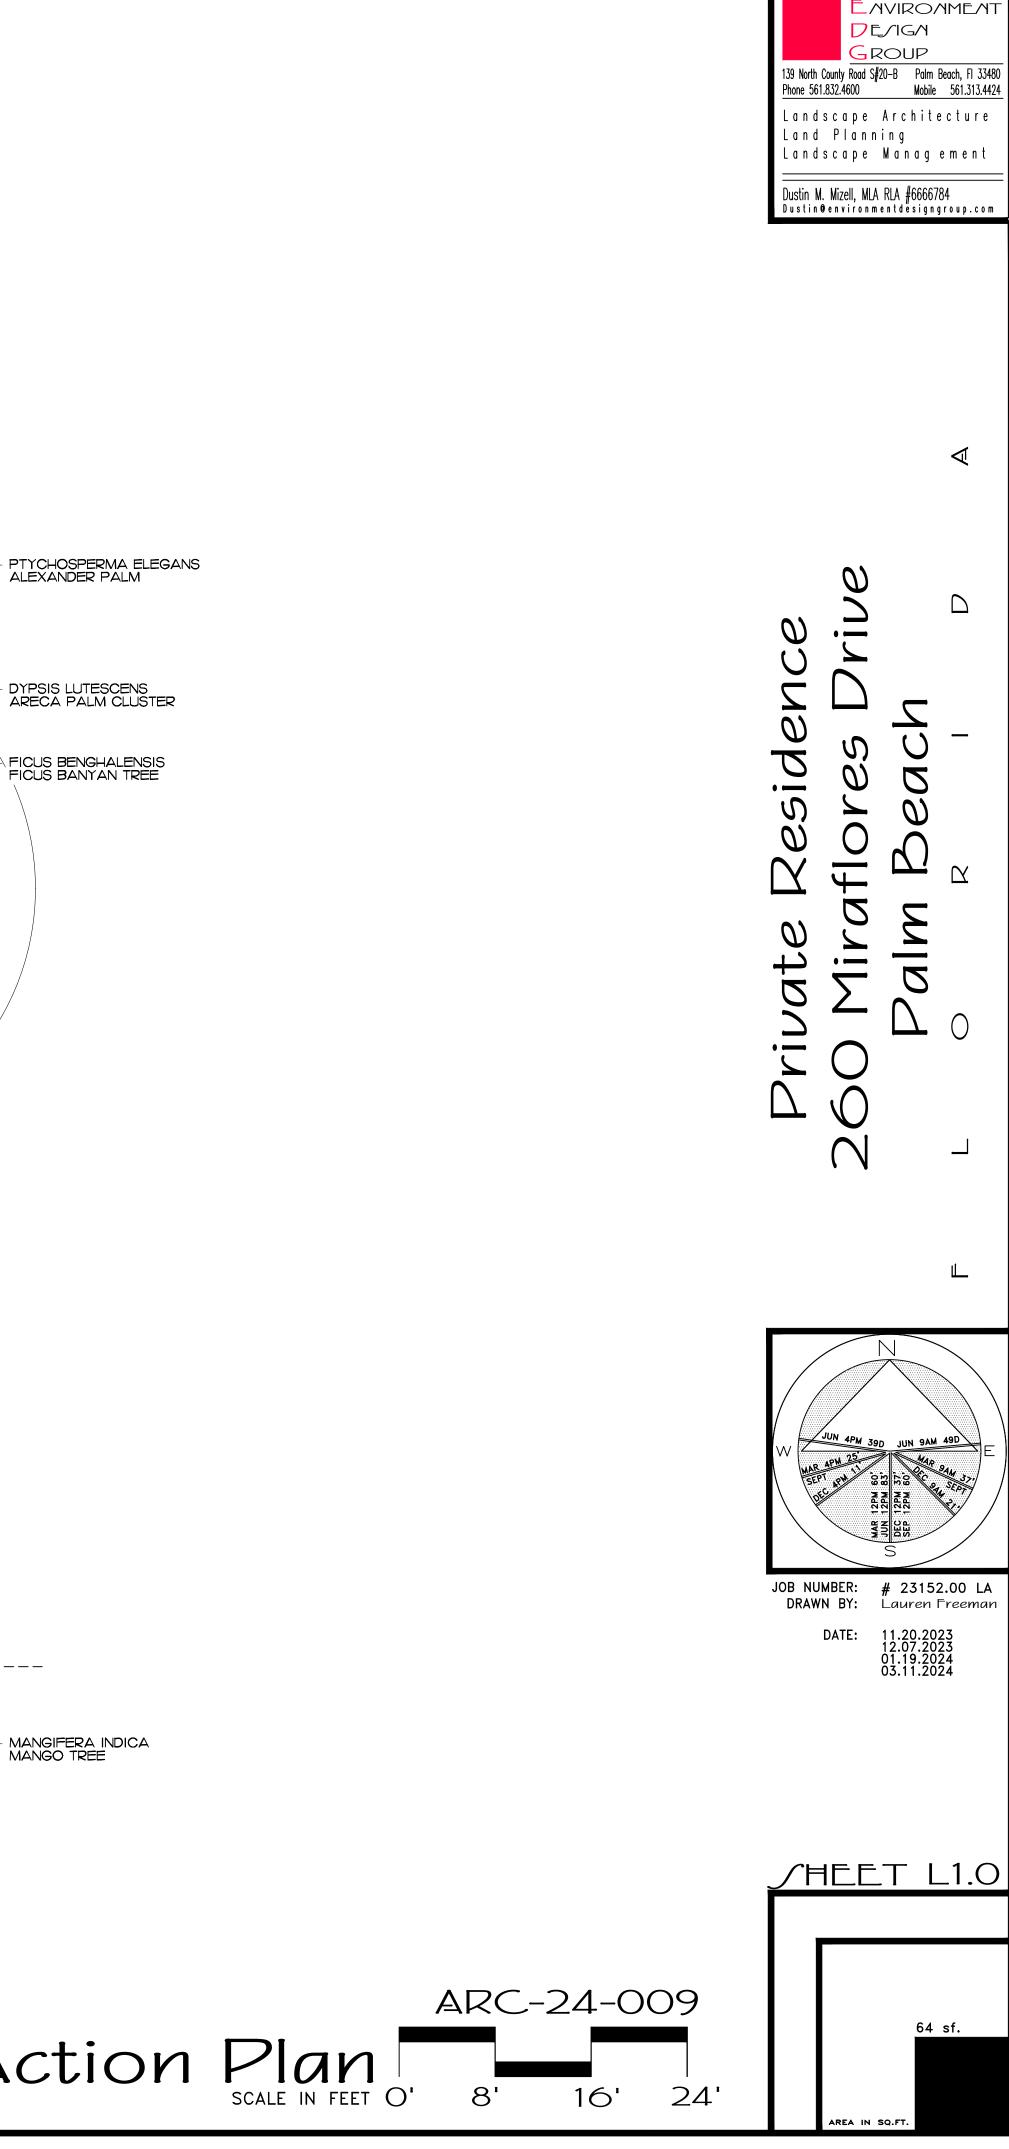


LANDSCAPE Page 10 of 15

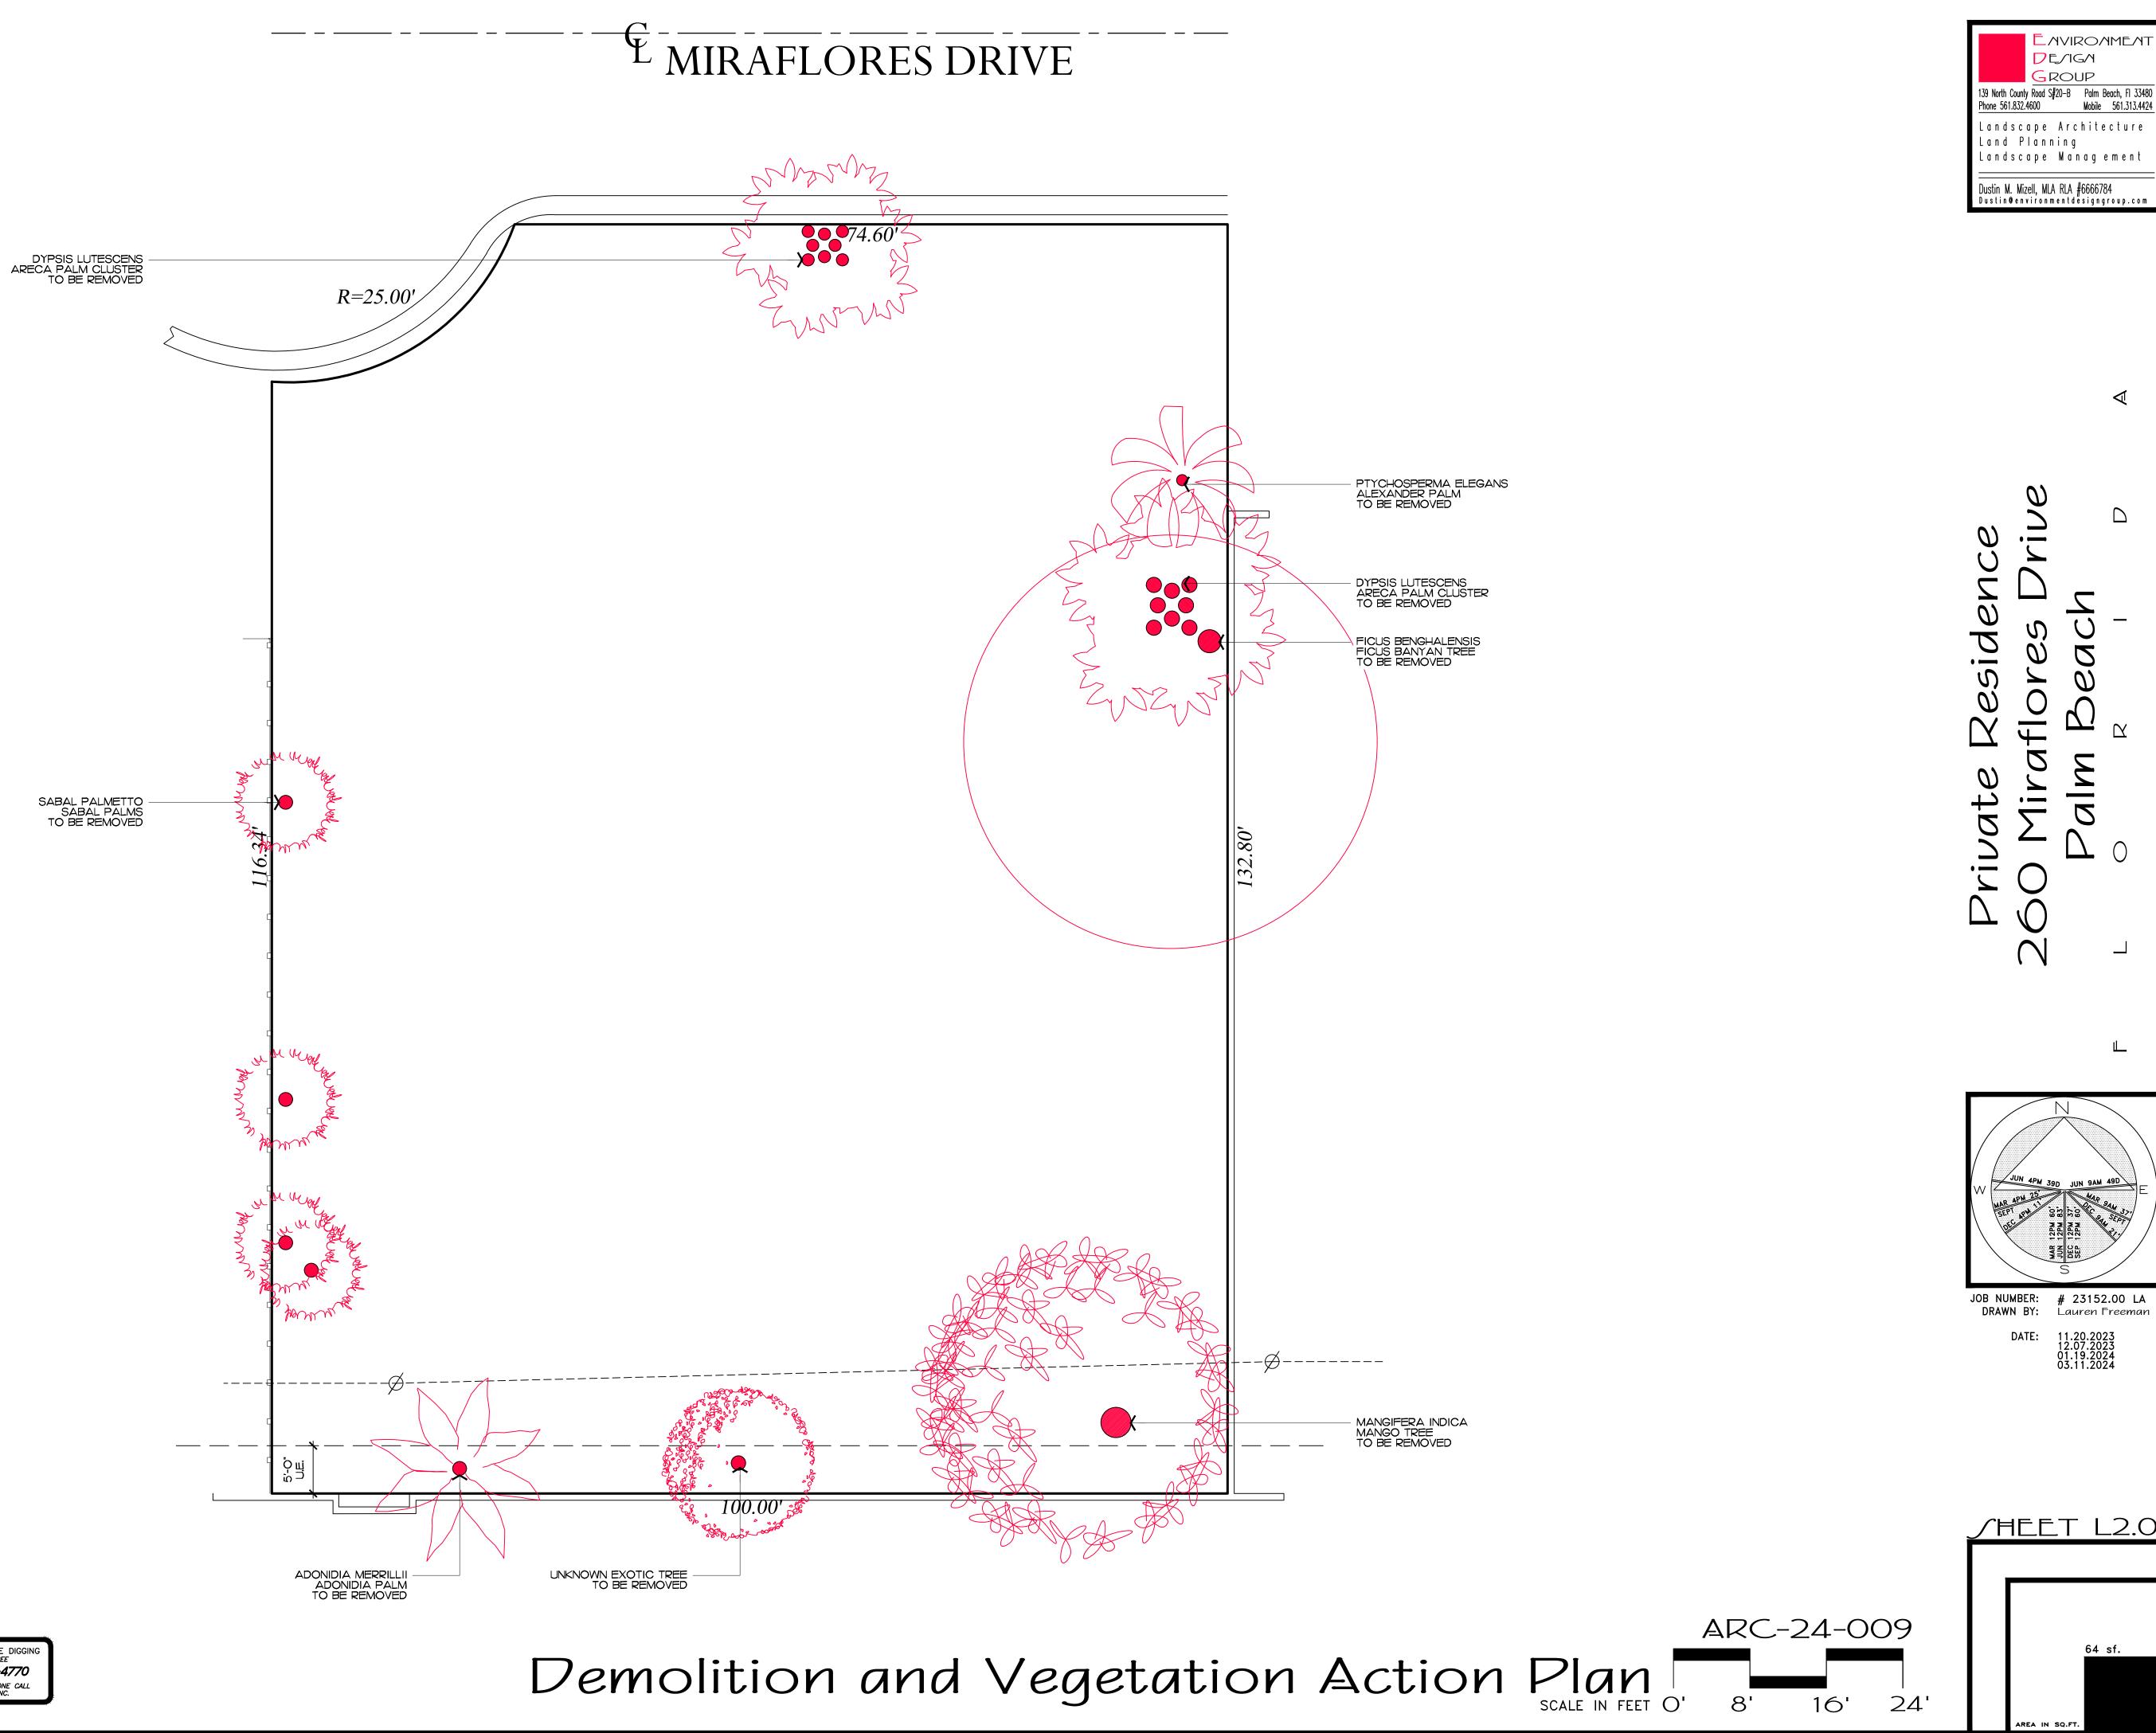

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LANDSCAPE Page 11 of 15



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LANDSCAPE Page 12 of 15

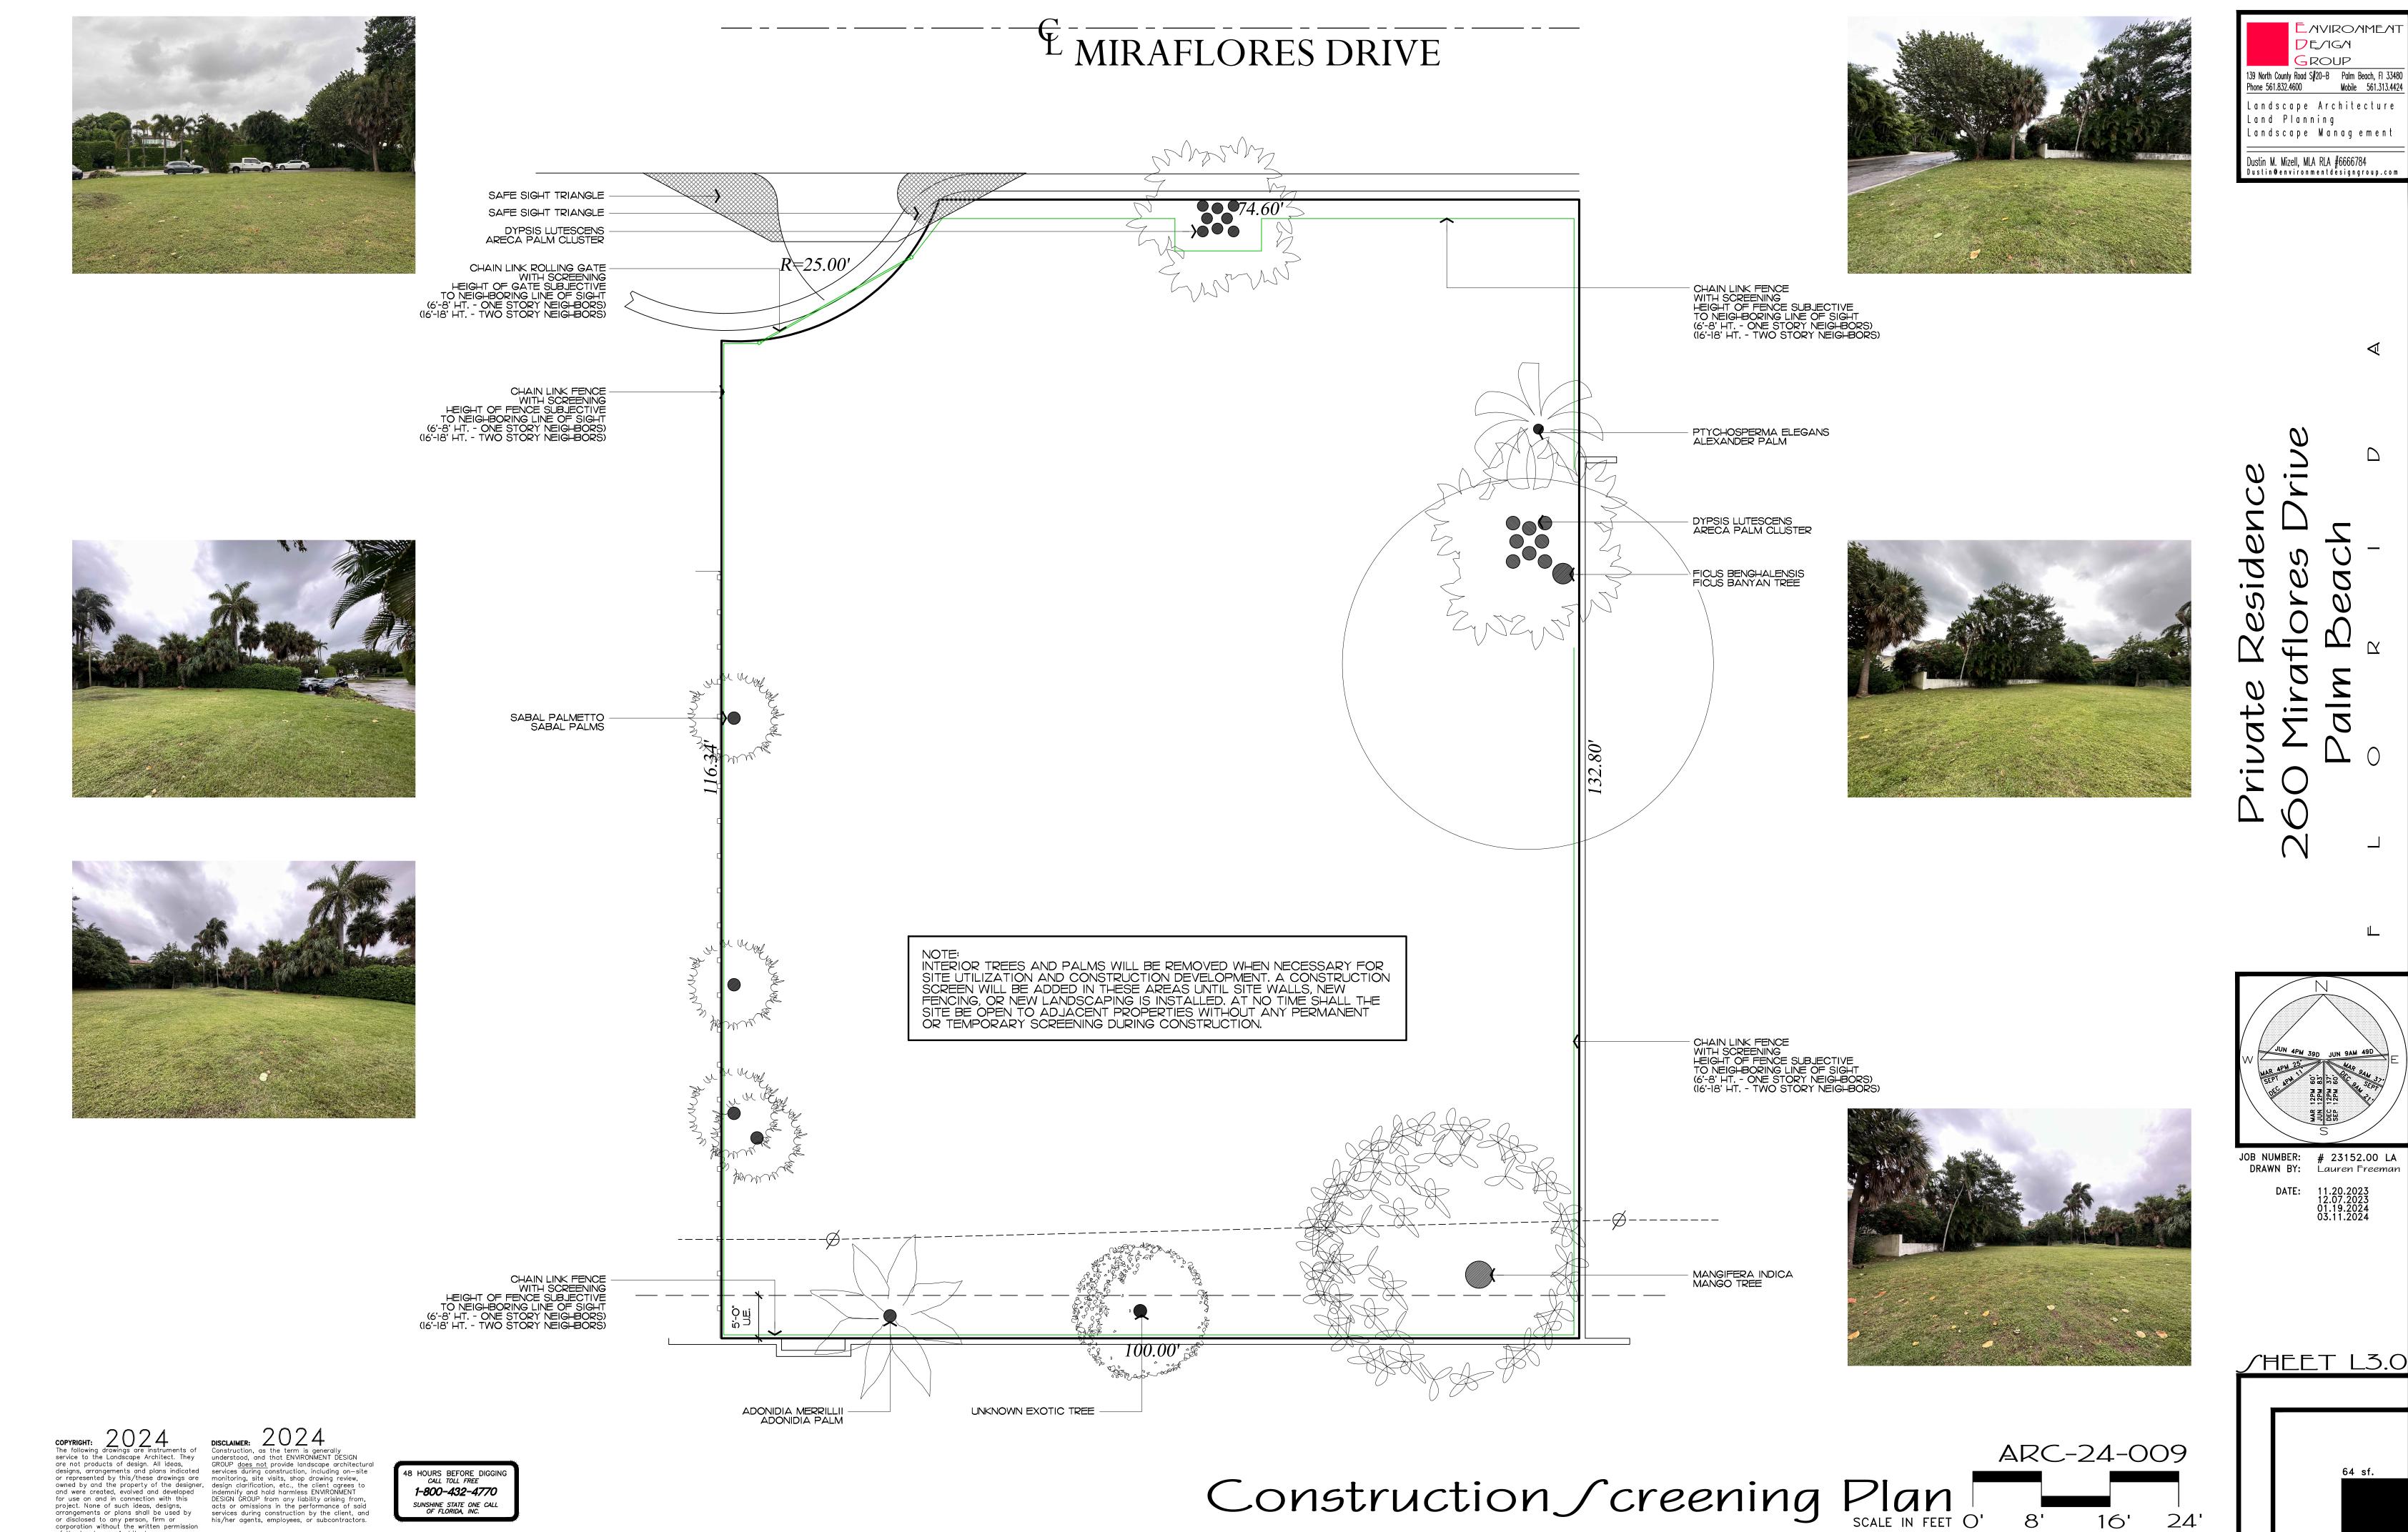
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## Existing North Buffer



## Existing East Buffer




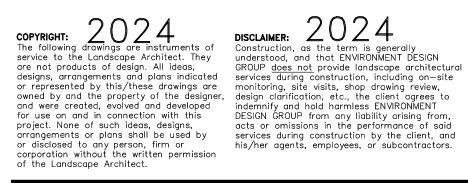

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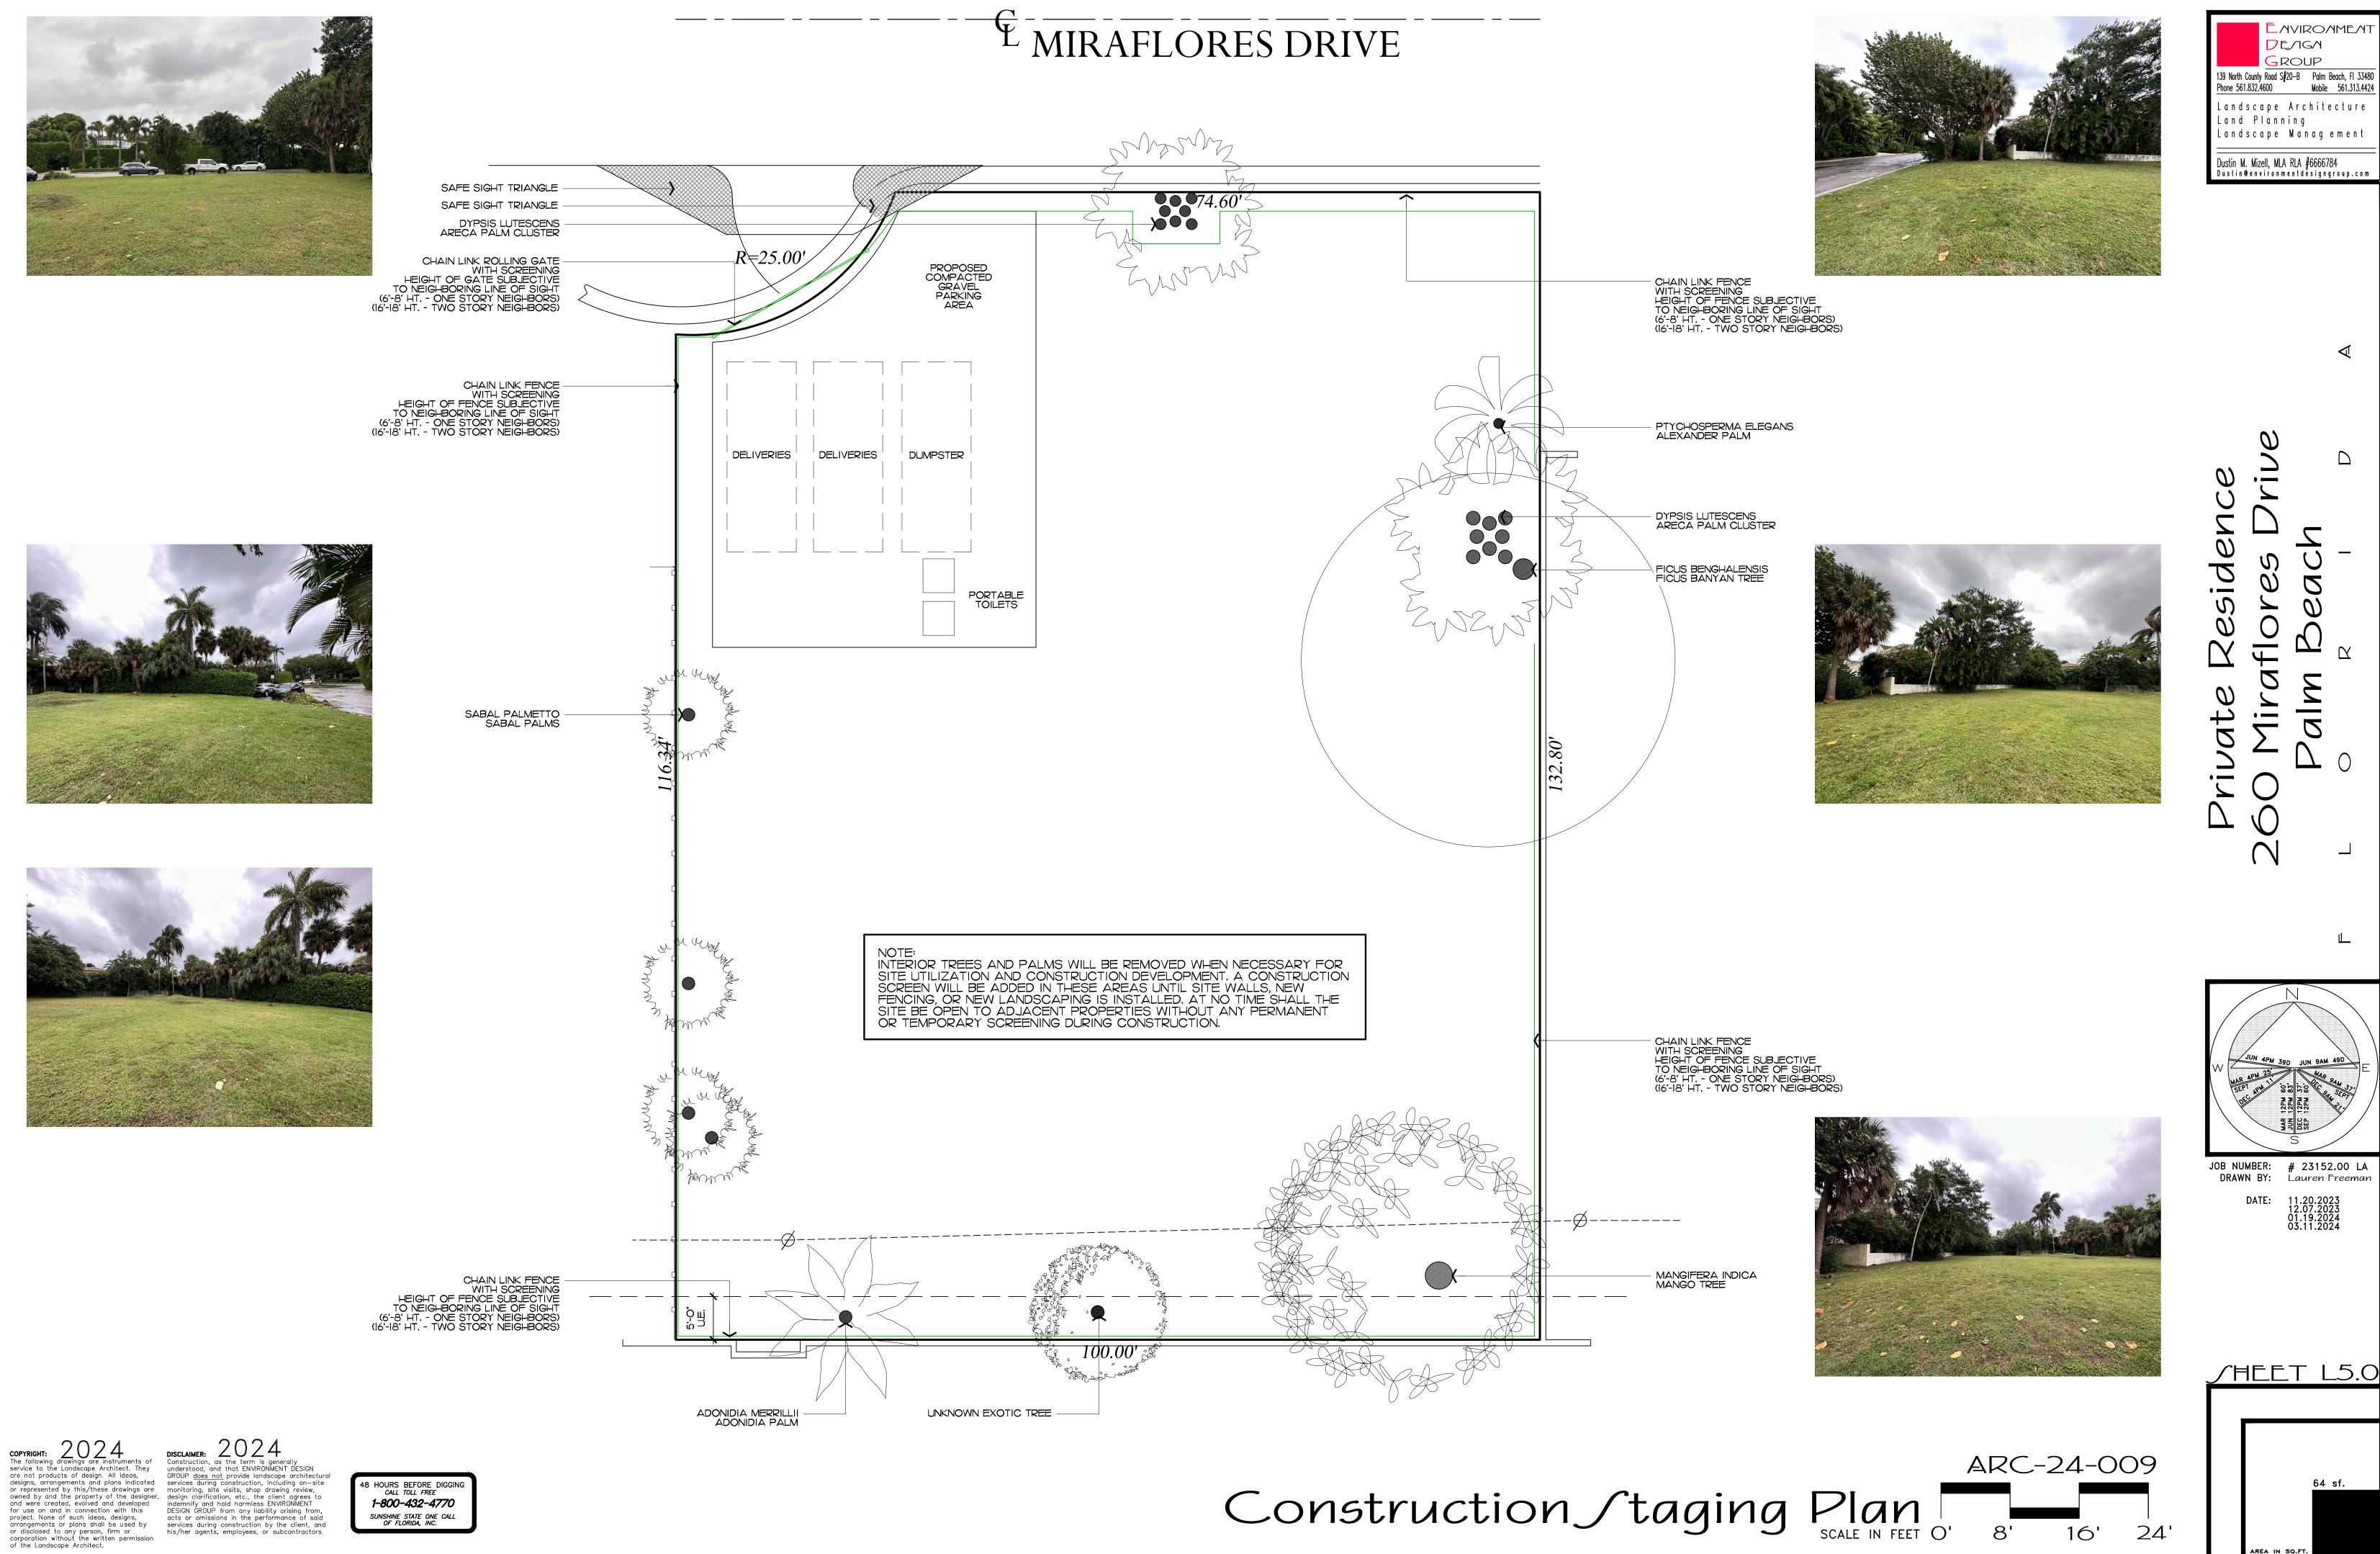


Existing South Buffer

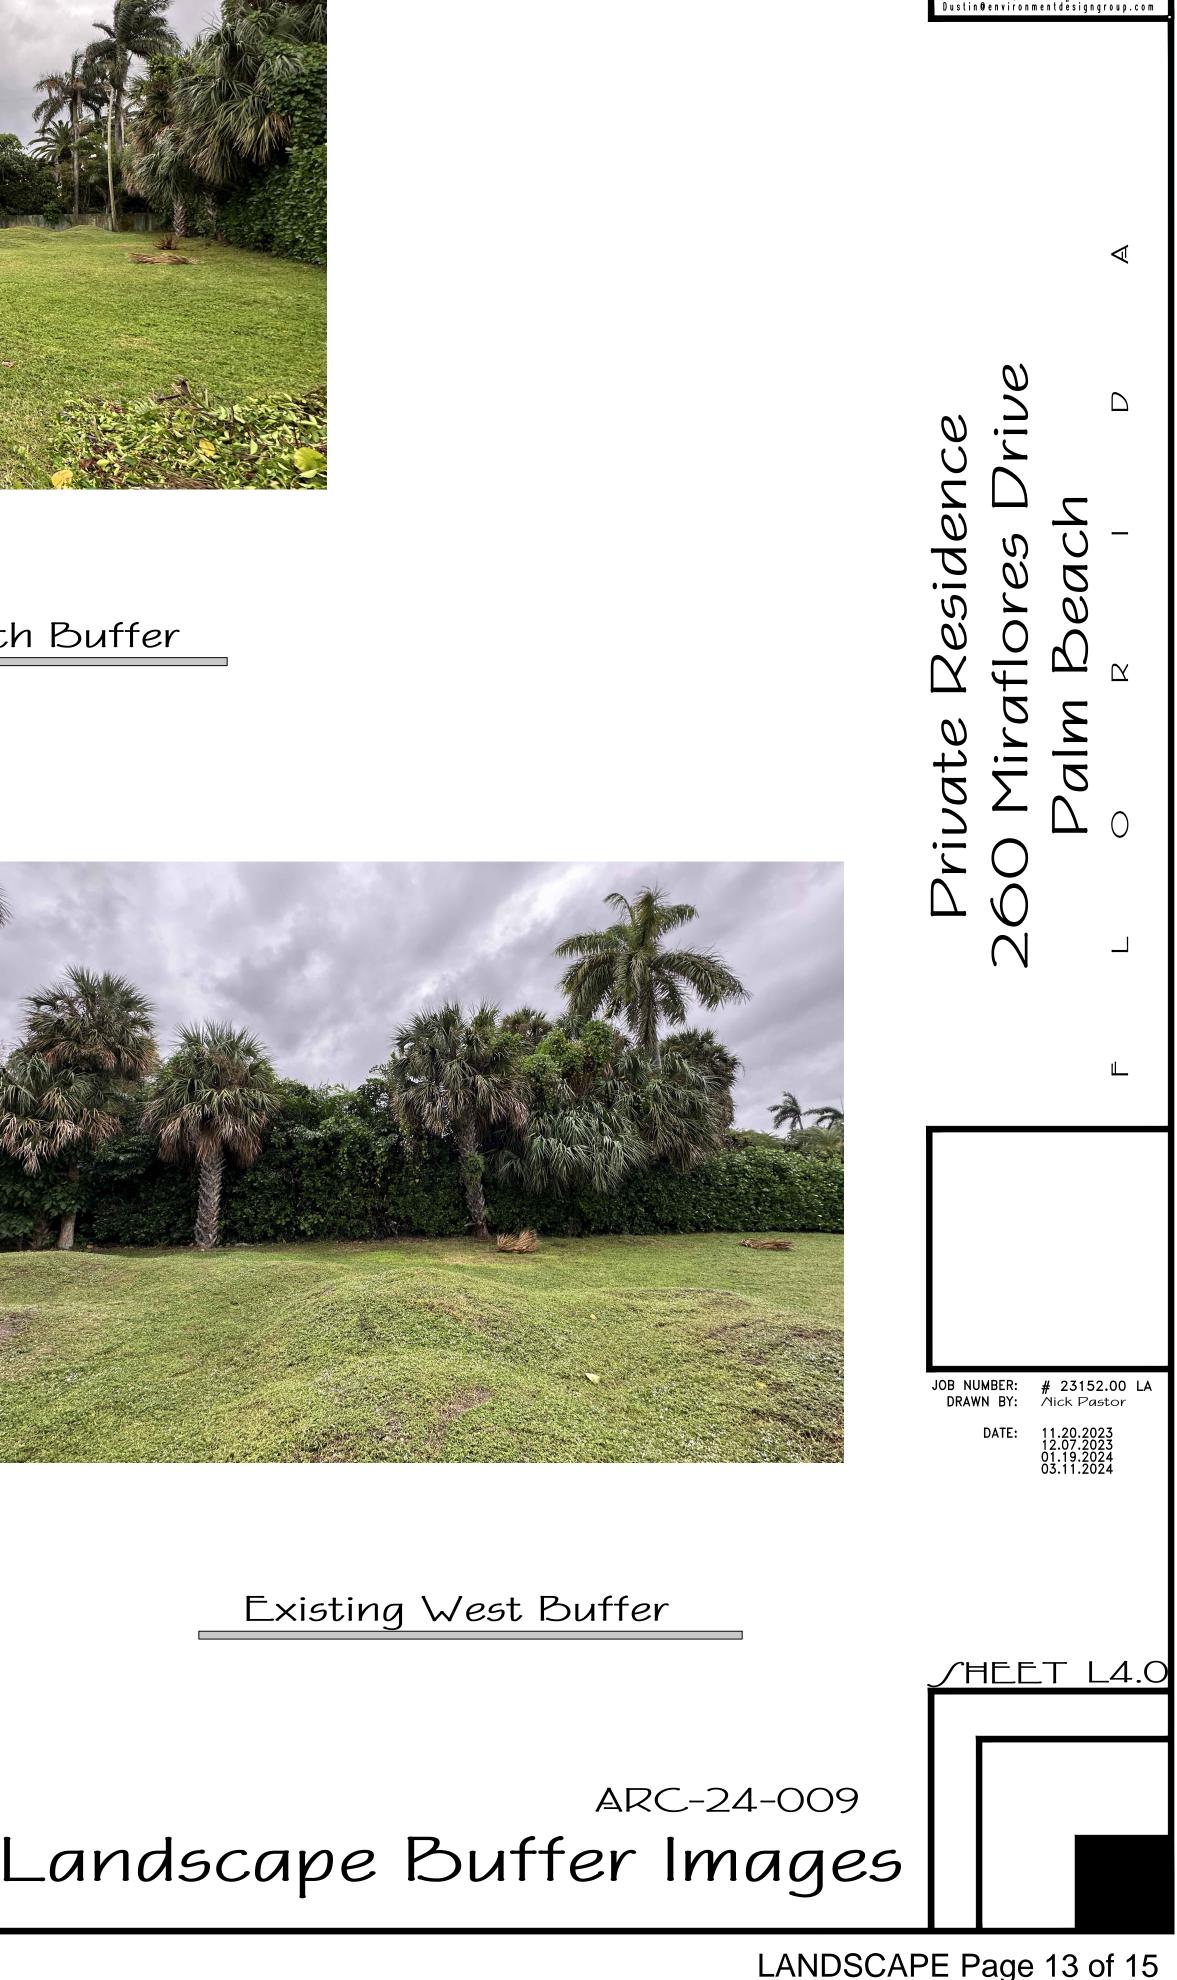

AVIROAMEA


DE/IG/1 GROUP







REA IN SQ.FT.

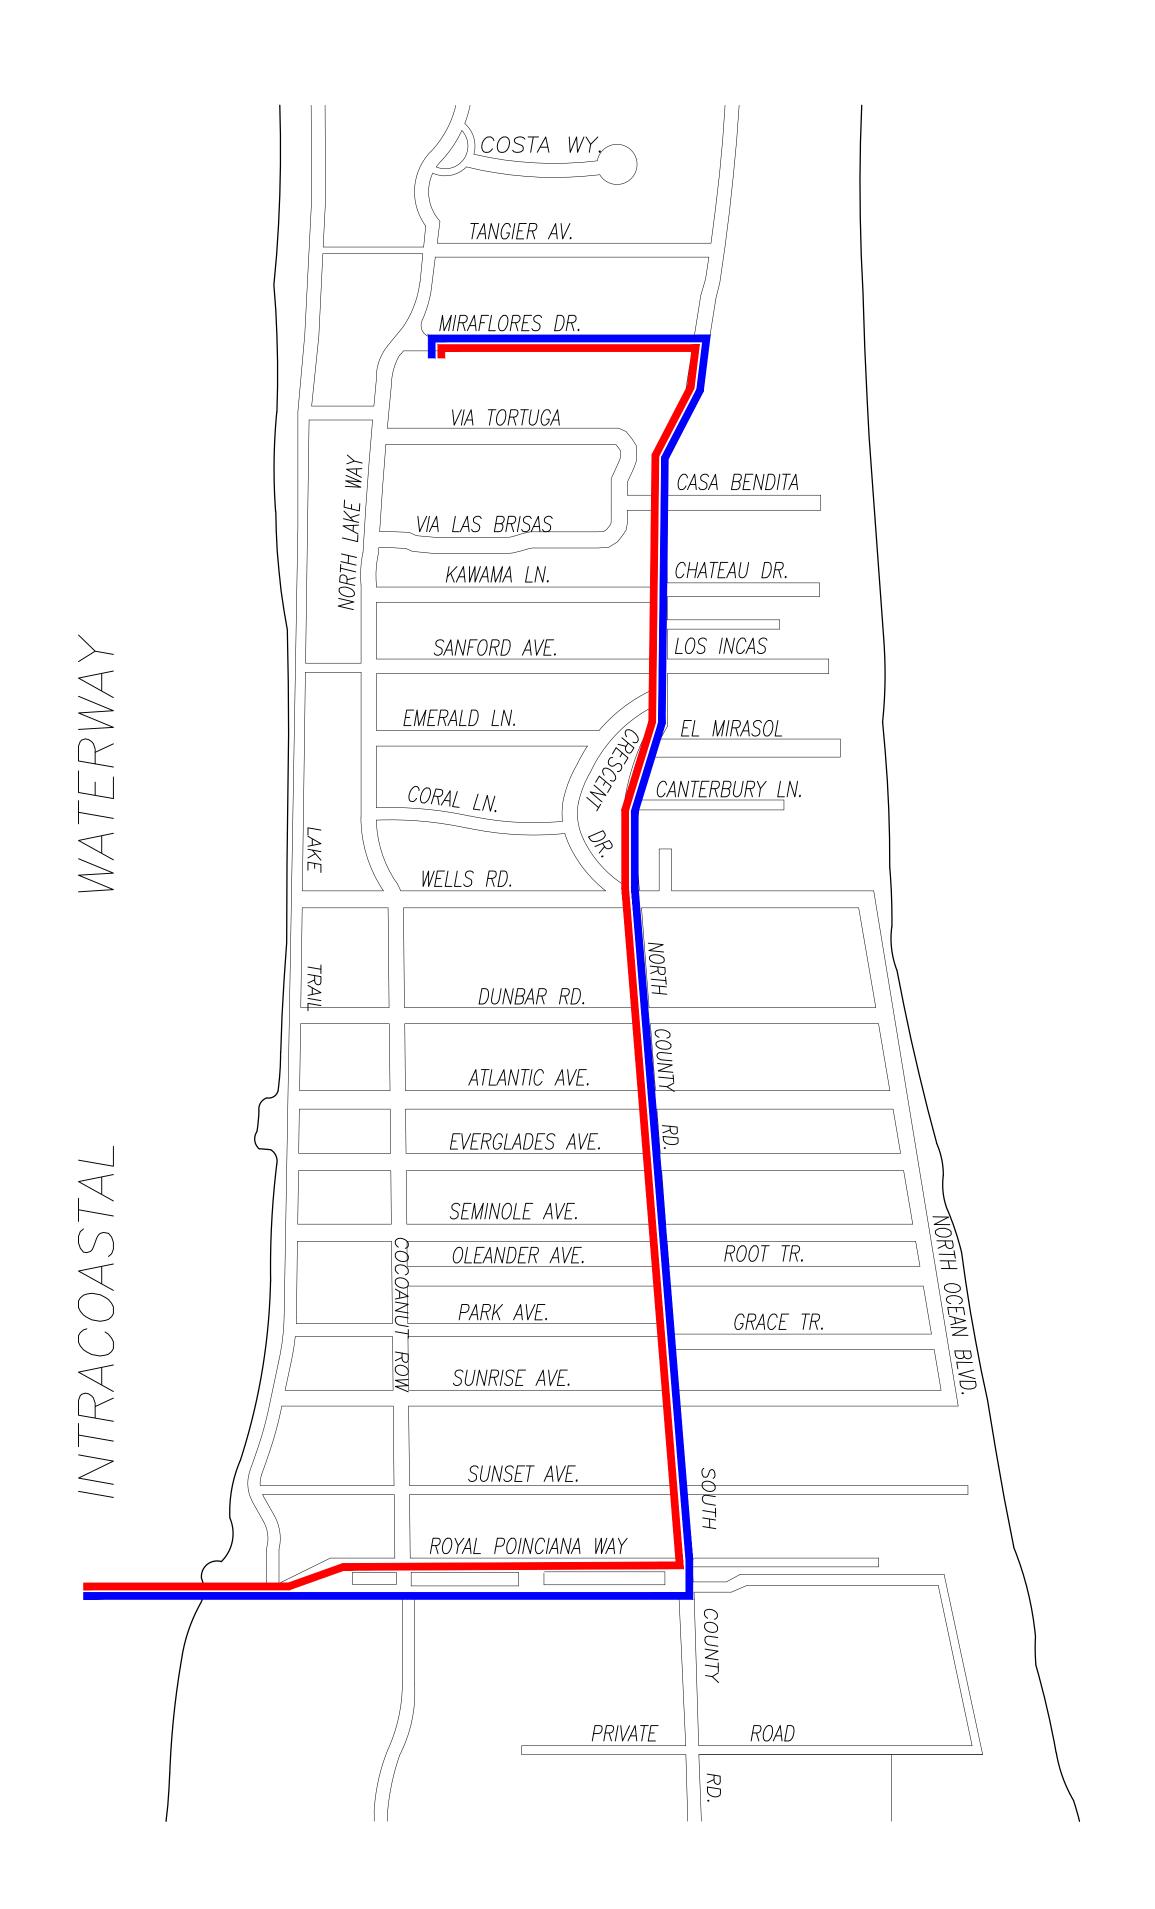







•	MAR 27 2024 - ARG MAR-APR 2024 -	COM MEETING SUBMIT FOR PERMIT
• • • • •	1 MONTH - APR 2024 1-2 MONTHS 4 MONTHS 1-2 MONTHS 2 MONTHS 1-2 MONTHS	<ul> <li>MOBILIZATION &amp; DEMOLITION</li> <li>SITE/BUILDING PREPARATION</li> <li>FRONT FACADE IMPROVEMENT</li> <li>FINISHES</li> <li>LANDSCAPE &amp; HARDSCAPE INSTALLATION</li> <li>FINAL INSPECTIONS</li> </ul>
•	+/-10 MONTHS	- PROPOSED TOTAL CONSTRUC FOLLOWING BUILDING PERMIT

PROPOSED TRUCK INGRESS / EGRESS ROUTES MAP

SCHEDULE:

MONTH 1: DEMOLITION AND CLEANUP (3 - 5 DAYS)

LARGEST TRUCK -> 10-15 DUMP TRUCKS FOR DEBRIS REMOVAL TRAILER FOR EXCAVATOR / DEMOLITION LANDSCAPE TRUCKS -> SOD IRRIGATION

JOB NUMBER: **# 23152.00 LA** DRAWN BY: Nick Pastor NOTE: SEE SEPARATE "CONSTRUCTION STAGING PLAN" SHEET FOR INFORMATION ON LOCATIONS FOR PARKING, MATERIAL STORAGE, DELIVERIES, DUMPSTER, PORTABLE TOILETS, TIRE CLEANING AREA, SILT FENCE, ETC. DATE: PROPOSED INGRESS TRUCK ROUTE

PROPOSED EGRESS TRUCK ROUTE



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