# SHAW RESIDENCE 286 ORANGE GROVE PALM BEACH, FLORIDA 33480



By yfigueroa at 11:23 am, Jul 11, 2023



# FIRST SUBMITTAL 04.13.23 THIRD SUBMITTAL 06.26.23 ARCOM PRESENTATION 08.23.23 ARCOM ARC-23-084

### VARNAVA DESIGN STUDIO 1706 NE 18TH ST. FORT LAUDERDALE, FLORIDA 3330

#### SCOPE OF WORK

- INTERIOR RENOVATION AND FIRST FLOOR EXPANSION OF AN EXISTING TWO-STORY HOUSE.
- THE FIRST FLOOR EXPANSION WILL BE LOCATED AT THE BACK OF THE HOUSE ON THE FIRST FLOOR.
- REPLACE FRONT ENTRY DOOR WITH NEW DESIGN AND REPLACE ALL EXISTING EXTERIOR DOORS AND WINDOWS WITH NEW IMPACT RATED.
- MINOR HARDSCAPE RECONFIGURATION AT REAR YARD.
- EXISTING POOL REMAINS BUT RECONFIGURED.
- NO HARDSCAPE/LANDSCAPE CHANGES AT FRONT YARD.

SHAW	RFSI	DENCE

286 ORANGE GROVE PALM BEACH, FL, 33480

ARC-23-084

ARCHITECT	LANDSCAPE ARCHITECT	MEP ENGINEER
VARNAVA DESIGN STUDIO, LLC	TODD MACLEAN OUTDOORS	CARO DESIGN GROUP  14012 Red Rock Lake Dr.
1706 NE 18th Street	P.O Box 2901	Jacksonville FL 32226
Fort Lauderdale, Florida 33305	Palm Beach, Florida 33480	
PH. 561.302.5853	PH. 561.310.2333	PH. 813.506.0422

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MARK DATE DESCRIPTION		
PROJECT NO: ###		
CAD DWG FILE: 286 ORANGE GROVE - ARCOM PRESENTATION DWG		
DRAWN BY: R.5 Y.V M.C		
CHKID BY: Y.V M.C		
PLOT DATE: 07.10.23		
SHEET TITLE		
COVER PAGE		

CP-001

# LOT INFORMATION OWNER: HARRY & DEE DEE SHAW PROPERTY ADDRESS: 286 ORANGE GROVE PALM BEACH SURVEY BY: WALLACE SURVEYING

#### CUBIC CONTENT CALCULATIONS

CUBIC CONTENT RATIO =  $4.00 + [(10,000-8,156) \div 10,000] = 4.184$ MAXIMUM ALLOWABLE CUBIC CONTENT =  $4.184 \times 8,156$  SQ FT. = 34,124 CU FT.

	MAX ALLOW.	_EXISTING	PROPOSED
CUBIC CONTENT	4.184 CCR	2.94 CCR	3.63 CCR
	34,124 CU FT.	23,970 CU FT.	29,646 CU FT.

#### BUILDING FOOTPRINT

EXISTING: 2,220 SQ. FT (FIRST FLOOR) + 64 SQ. FT. (SHED) + 262 SQ. FT. (AWNING) EXISTING TOTAL: 2,546 SQ. FT

PROPOSED: 2,220 SQ. FT (FIRST FLOOR) + 120 SQ. FT. (ADDITION) + 300 SQ. FT. (AWNING) PROPOSED TOTAL: 2,640 SQ.

TOPB Zo	ning Legend			
Property Address:	286 Orange Grove			
Zoning District:	R-B			
Structure Type:	CMU			
	Required/Allowed	Existing	Proposed	
Lot Size (sq ft)	10,000	8,156	8,156	
Lot Depth	100'	94'	94'	
Lot Width	100'	80'	80'	
Lot Coverage (Sq Ft and %) for two story + 3% Awning exception	30% + 3% 2,447 + 245 sq.ft.	28.0% + 3.2% 2,284 + 262 sq.ft.	28.7% + 3.7% 2,340 + 300 sq.f	
Max total:	33% = 2692 sq. ft.	31.2% = 2546 sq. ft.		
Enclosed Square Footage for two story structure		2,912 sq. ft.	3,032 sq. ft.	
Cubic Content Ratio (CCR) (R-B ONLY)	4.184	2.94	3.63	
*Front Yard Setback (Ft.)	25' N	31.7' N	31.7' N	
* Side Yard Setback (1st Story) (Ft.)	12.5' E,W	5.9' W	5.9' W	
* Side Yard Setback (2nd Story) (Ft.)	15' E,W	24.3' W	24.3' W	
*Rear Yard Setback (Ft.)	10' S	30.1 S	10' S	
Angle of Vision (Deg.)	100 (Deg.)	80 (Deg.)	80 (Deg.)	
Building Height (Ft.)	22'	17'-10"	17'-10"	
Overall Building Height (Ft.)	30'	22'-4"	22'-4"	
Crown of Road (COR) (NAVD)				
19 Max. Amount of Fill Added to Site (Ft.)	0'	n/a	n/a	
Finished Floor Elev. (FFE)(NAVD)	7.0 NAVD	7.0 NAVD	7.0 NAVD	
Zero Datum for point of meas. (NAVD)				
FEMA Flood Zone Designation	AE	AE	AE	
Base Flood Elevation (BFE)(NAVD)	BFE=6 FT NAVD	BFE=6 FT NAVD	BFE=6 FT NAVD	
Landscape Open Space (LOS) (Sq Ft and %)		3050 sq. ft. 37.4%	3712 sq.ft. 45.0%	
Perimeter LOS (Sq Ft and %)		2460 sq.ft. 66%	2775 sq.ft. 74%	
Front Yard LOS (Sq Ft and %)		819 sq. ft. 43%	819 sq. ft. 43%	
Native* Trees %		0%	0%	
Native* Palms %		0%	0%	
Native* Shrubs %		0%	31%	
Native* Vines / ground cover %		0%	0%	

VARNAVA DESIGN
STUDIO

1706 NE 18TH ST.
FORT LAUDERDALE, FLORIDA 33305
TEL. 561302.5853
ARIO1023

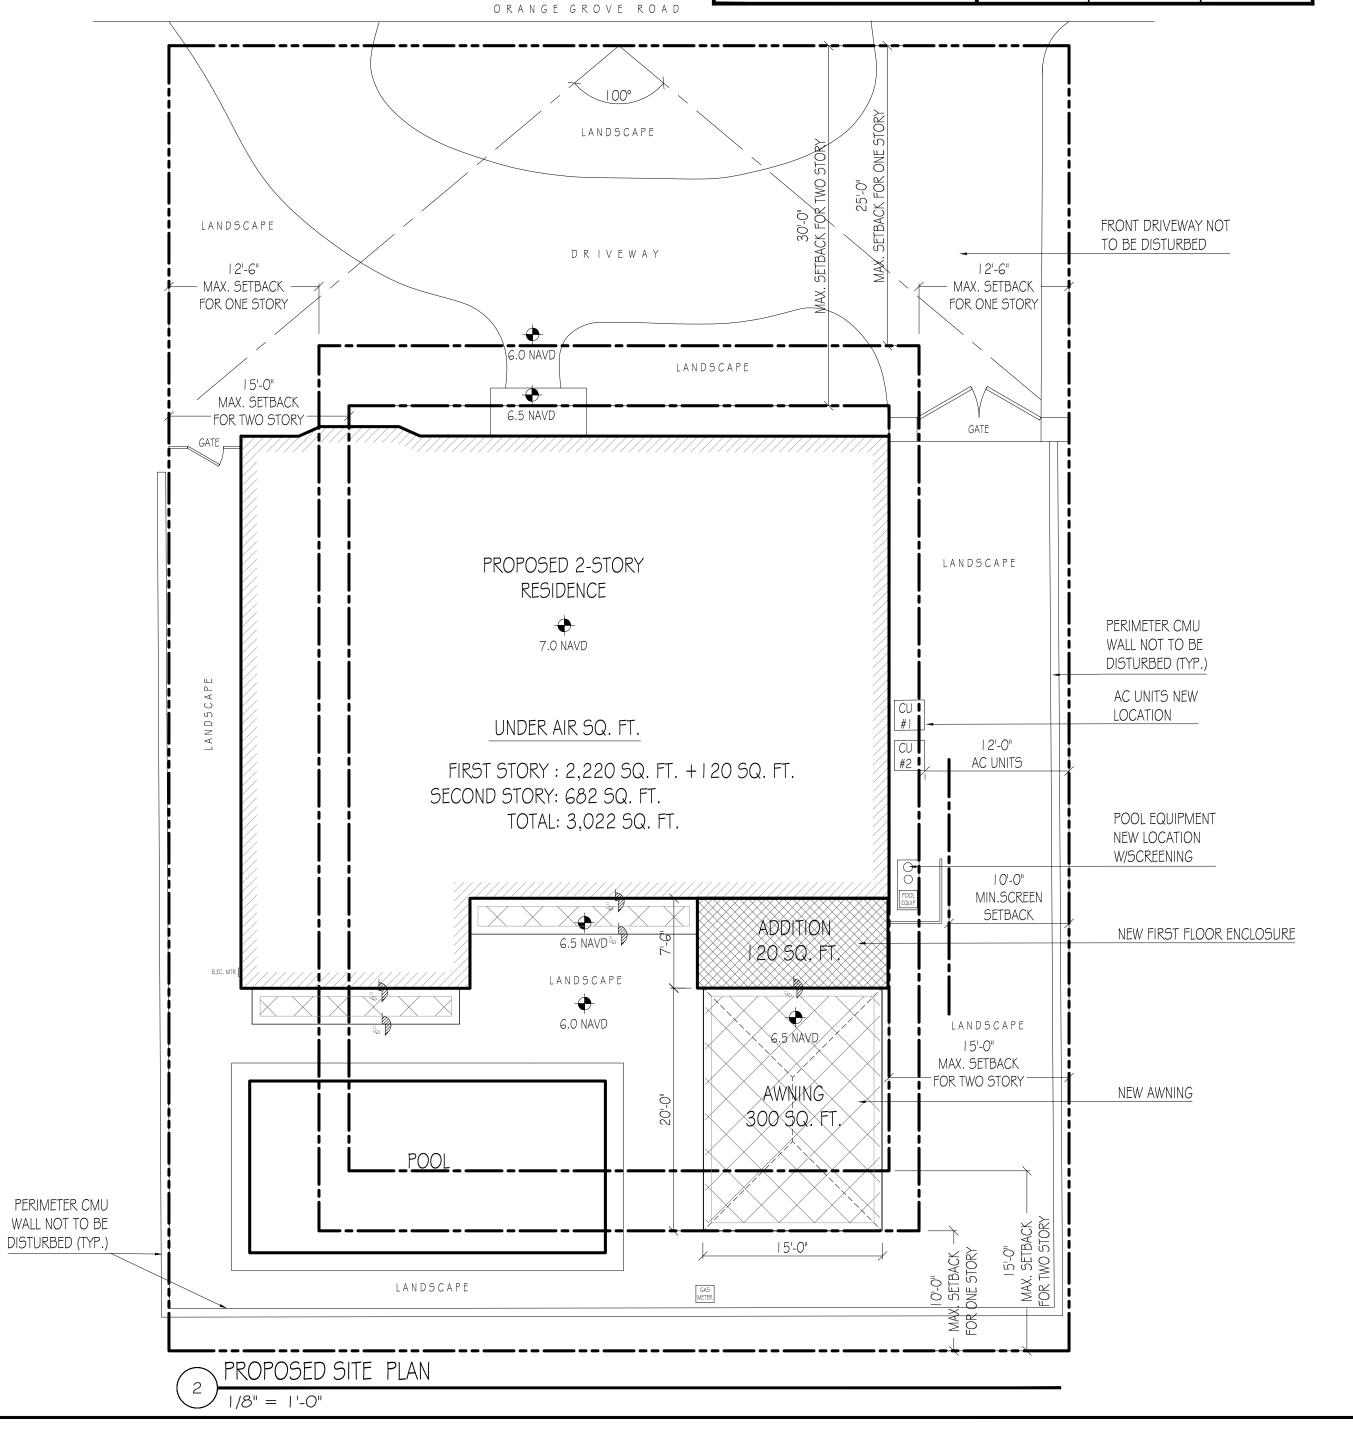
SHAW RESIDENCE

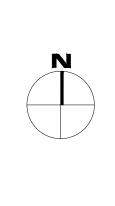
286 ORANGE GROVE PALM BEACH, FL, 33480

ARC-23-084

ORANGE GROVE ROAD FRONT DRIVEWAY NOT TO BE DISTURBED DRIVEWAY AC UNIT TO BE RELOCATED 6.5 NAVD GATE REMOVE PAVERS EXISTING 2-STORY RESIDENCE 6.6 NAVD PERIMETER CMU WALL NOT TO BE 7.0 NAVD DISTURBED (TYP.) AC UNIT TO BE CU RELOCATED UNDER AIR SQ. FT. FIRST STORY: 2,220 SQ. FT. SECOND STORY: 682 SQ. FT. STOR SHED TOTAL: 2,902 SQ. FT. REMOVE SHED REMOVE CONCRETE **PAVERS** REMOVE STEPS REMOVE AWNING POOL EQUIPMENT TO BE RELOCATED POOL DECK 6.0 NAVD REMOVE POOL REMOVE CONCRETE POOL DECK POOL TURF PERIMETER CMU WALL NOT TO BE DISTURBED (TYP.) POOL DECK EXISTING SITE PLAN


1/8" = 1'-0"





MARK	DATE	DESCRIPTION		
PROJEC	T NO:	###		
CAD DW	/G FILE:	286 ORANGE GROVE - ARCOM PRESENTATION.DWG		
DRAWN BY:		R.S Y.V M.C		
CHK'D E	Y:	Y.V M.C		
PLOT DATE:		07.10.23		
SHEET T	SHEET TITLE			
EXISTING & PROPOSED SITE PLAN				

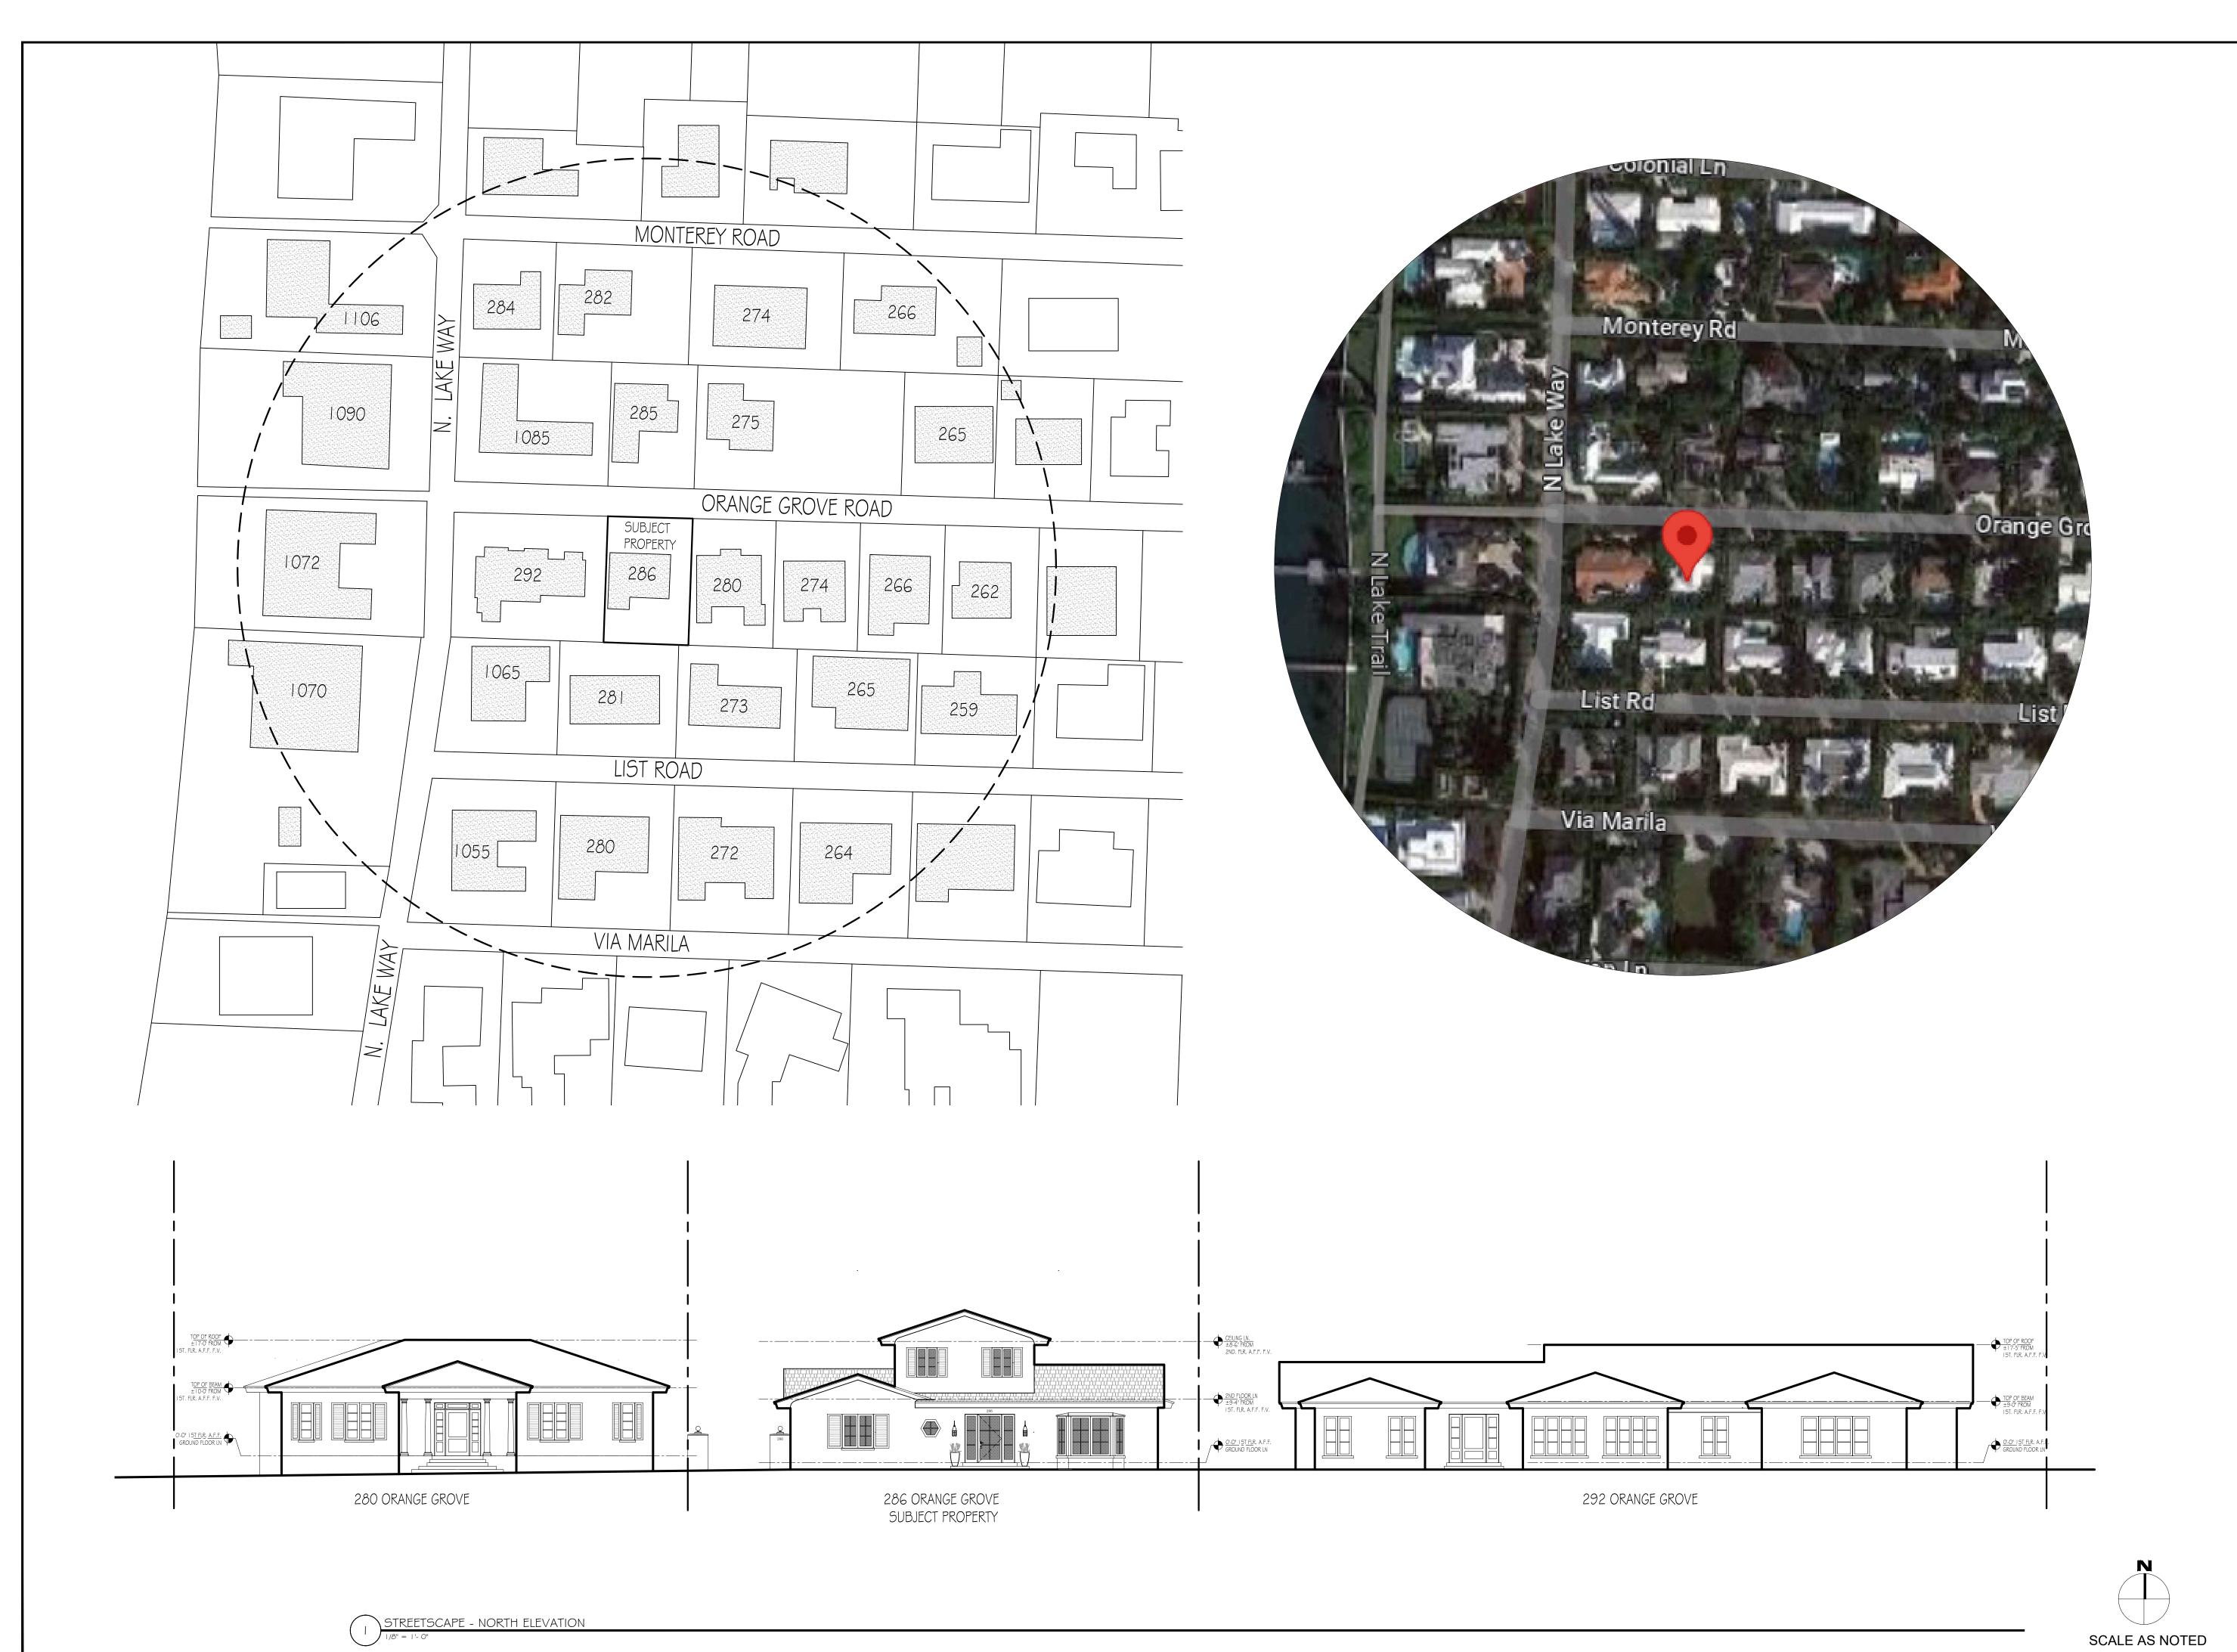SP-001



VARNAVA DESIGN STUDIO

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FORT LAUDERDALE, FLORIDA 33305
TEL. 561.302.5853
ARIO1023

SHAW RESIDENCE

286 ORANGE GROVE PALM BEACH, FL, 33480

ARC-23-084

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DRAWN BY: R.S Y.V M.C

CHKD BY: Y.V M.C

PLOT DATE: 07.10.23

SHEET TITLE

STREETSCAPE

SP-002

#### CUBIC CONTENT CALCULATIONS

CUBIC CONTENT RATIO =  $4.00 + [(10,000-8,156) \div 10,000] = 4.184$ MAXIMUM ALLOWABLE CUBIC CONTENT =  $4.184 \times 8,156 \text{ SQ FT.} = 34,124 \text{ CU FT.}$ 

	MAX ALLOW.	EXISTING	PROPOSED
CUBIC CONTENT	4.184 CCR	2.94 CCR	3.63 CCR
	34,124 CU FT.	23,970 CU FT.	29,646 CU FT.

varnava design STUDIO 1706 NE 18TH ST. Fort Lauderdale, florida 33305 Tel. 561.302.5853

EXISTING FIRST FLOOR 20,066 CU. FT. EXISTING SECOND FLOOR 5,800 CU. FT. FIRST FLOOR ADDITION 1,080 CU. FT.

AWNING ADDITION 2,700 CU. FT.

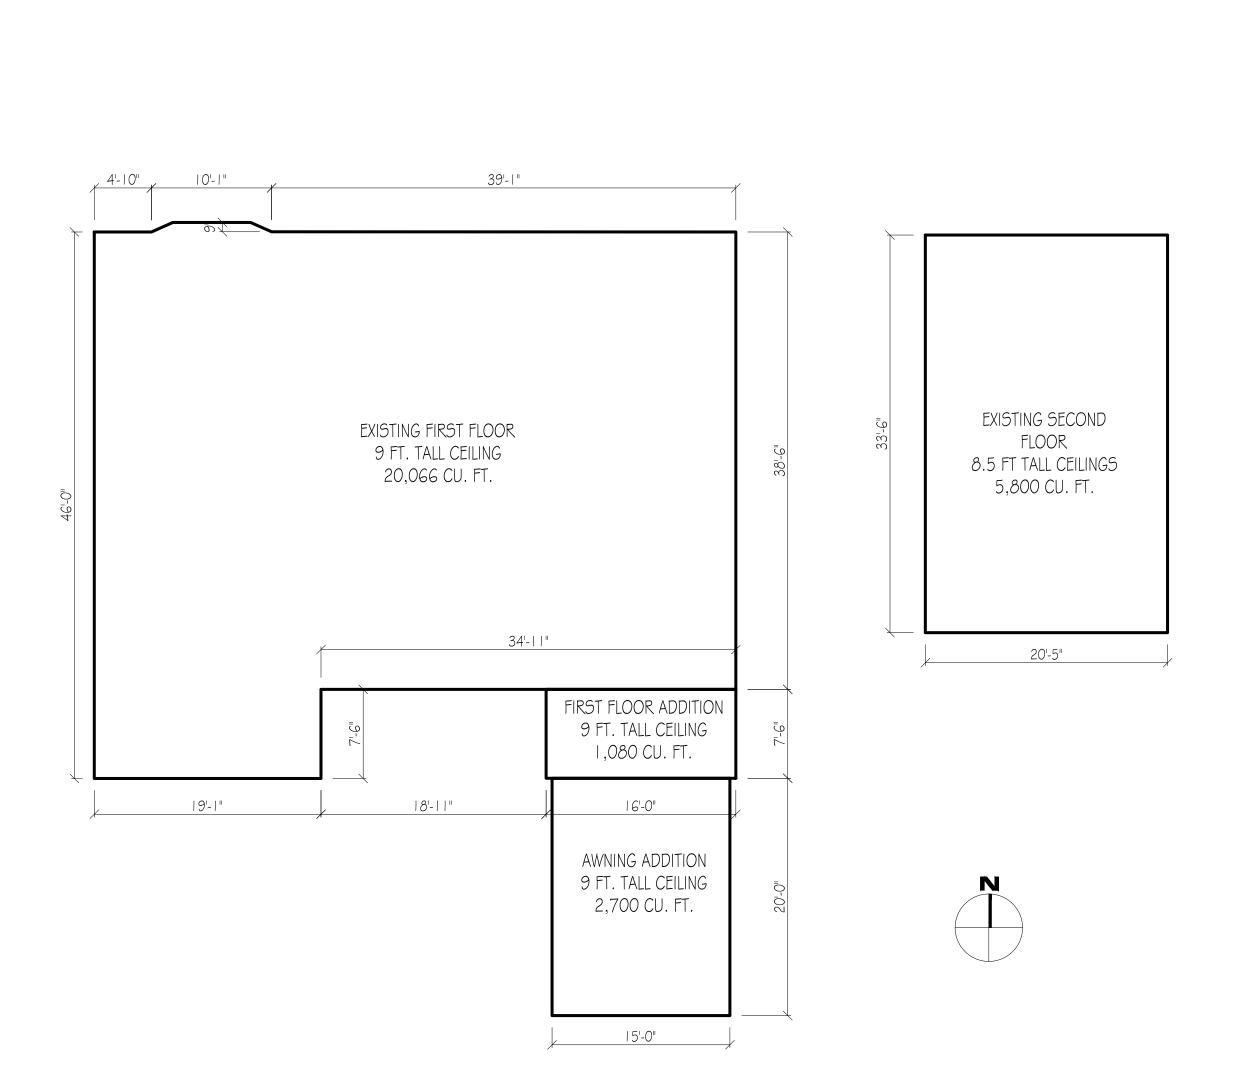
PROPOSED TOTAL: 29,646 CU. FT.

SHAW RESIDENCE


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286 ORANGE GROVE PALM BEACH, FL, 33480

ARC-23-084



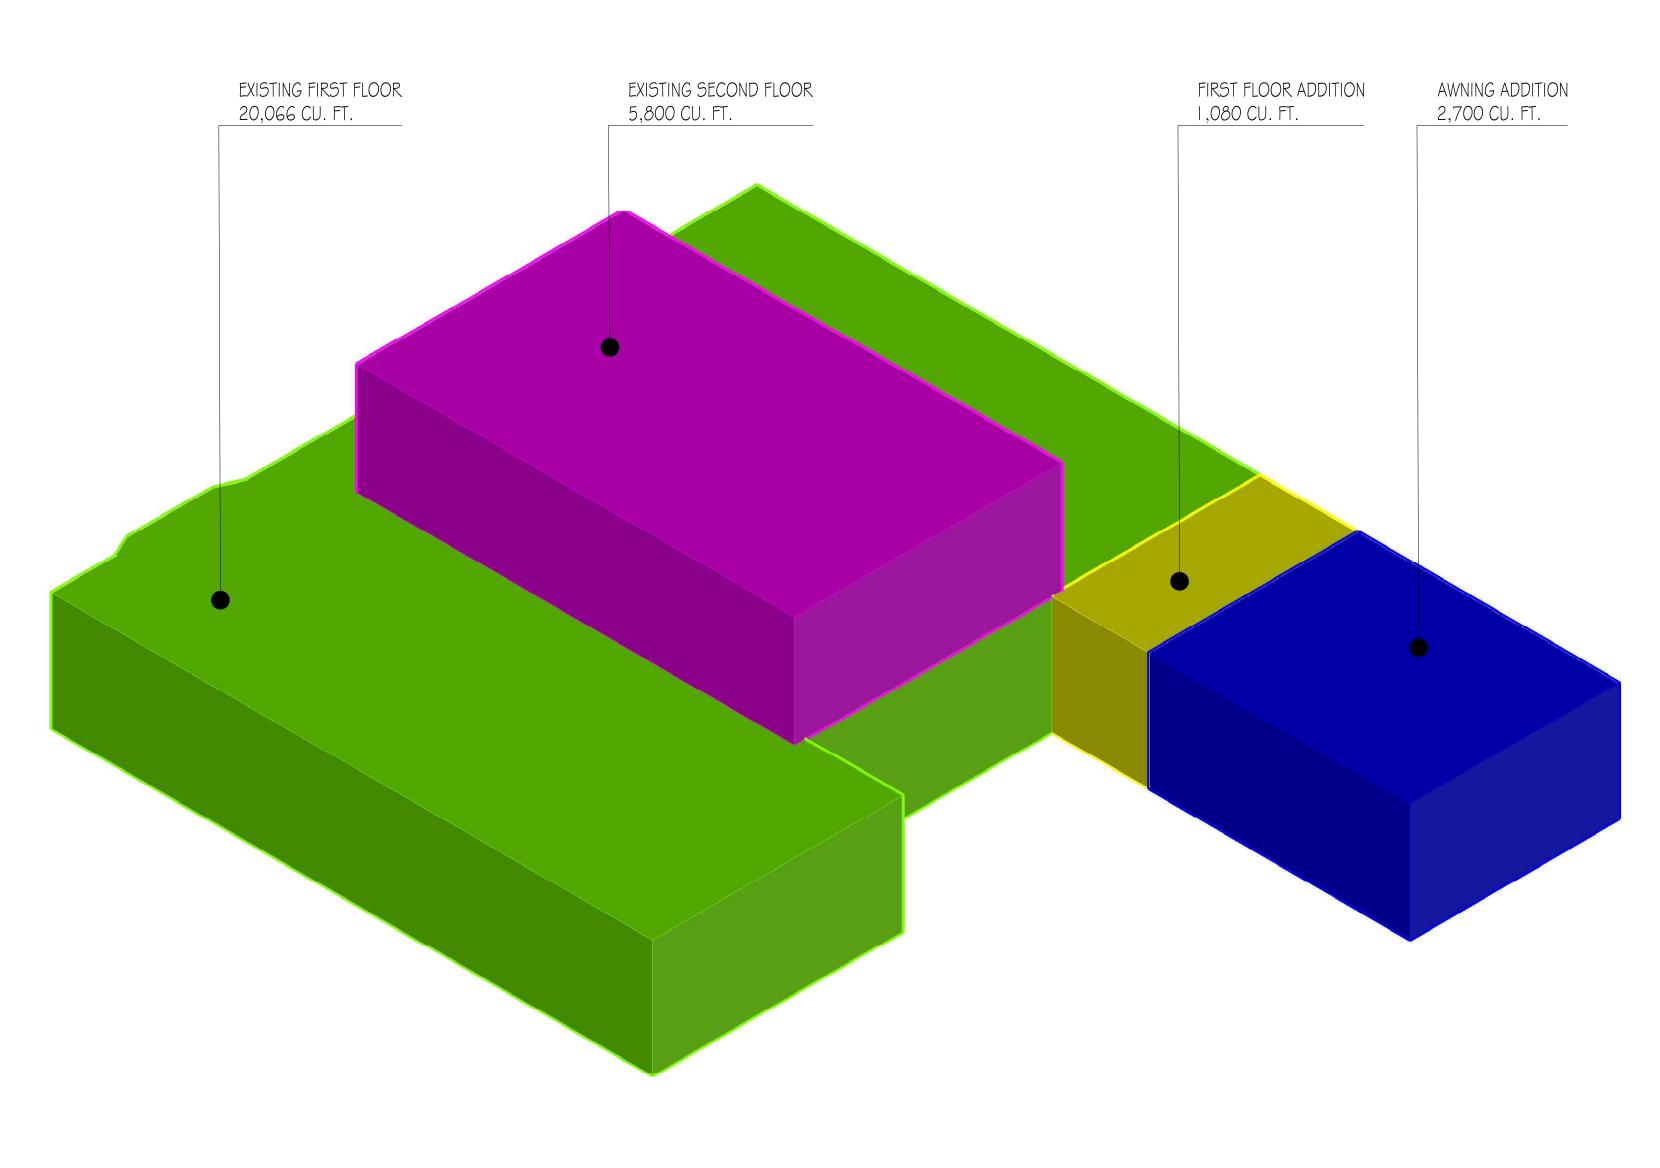FLOOR PLAN OUTLINES AND CUBIC MEASUREMENTS



PROJECT NO: ### CAD DWG FILE: 286 ORANGE GROVE - ARCOM PRESENTATION.DWG R.S Y.V M.C Y.V M.C PLOT DATE: 07.10.23 CUBIC CONTENT CALCULATIONS

SP-003



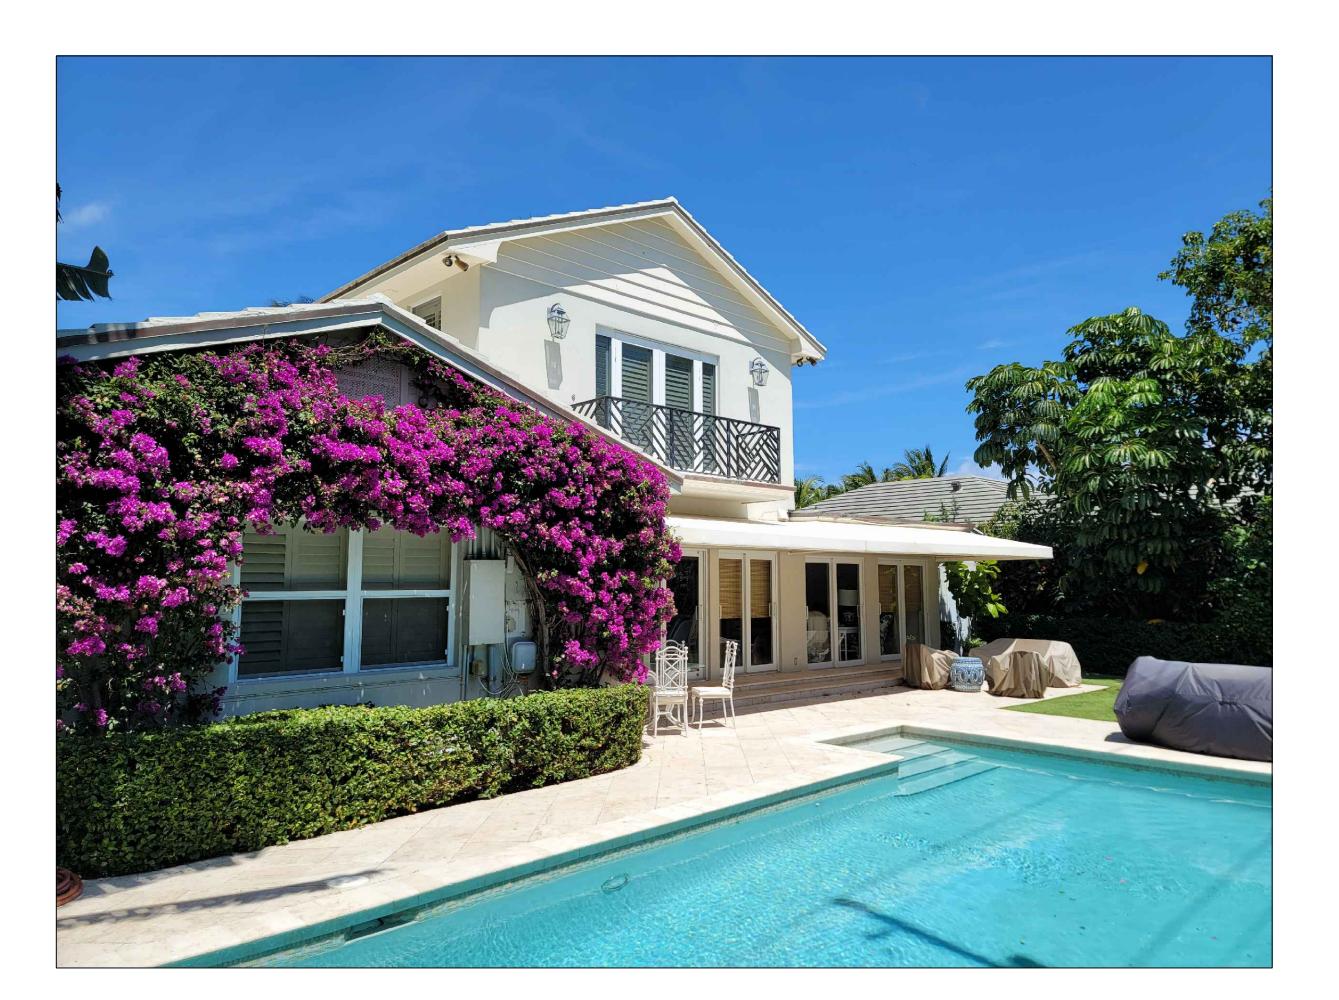








FRONT FACAD







1706 NE 18TH ST. FORT LAUDERDALE, FLORIDA 33305 Tel. 561.302.5853 Ario1023

SHAW RESIDENCE

286 ORANGE GROVE PALM BEACH, FL, 33480

ARC-23-084

K DATE DESCRIPTION

JECT NO: ###

DWG FILE: 285 ORANGE GROVE - ARCOM PRESENTATION DWG


WN BY: R.5 Y.V. M.C.


TO BY: Y.V. M.C.


PHOTOS OF EXISTING HOUSE

LOT DATE: 07.10.23

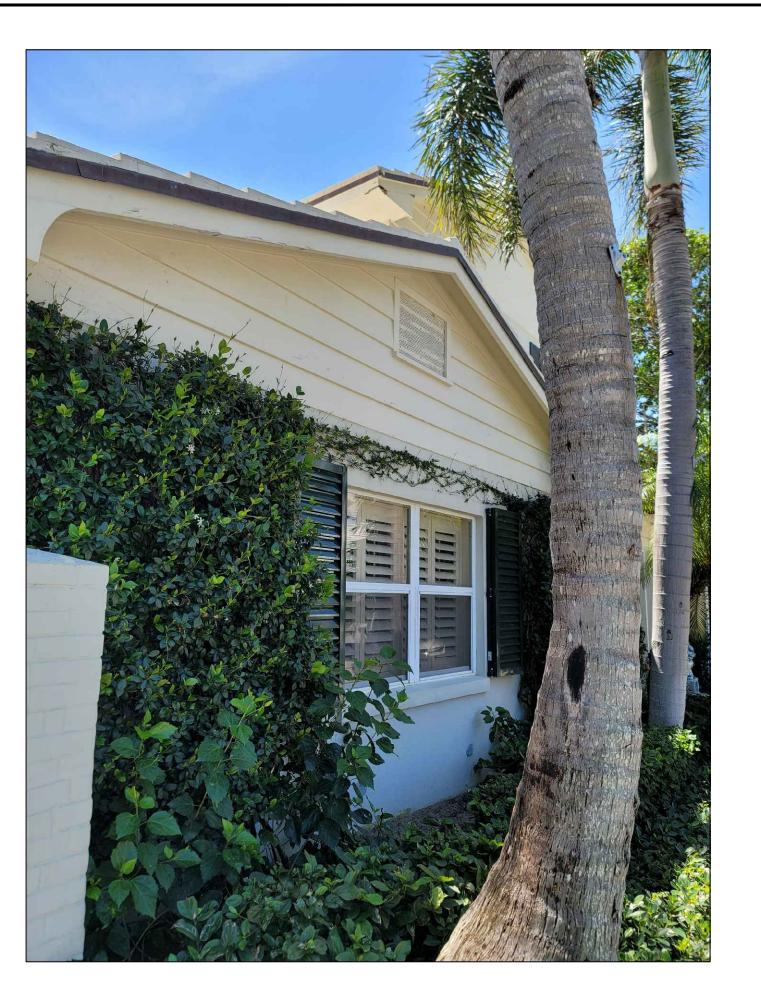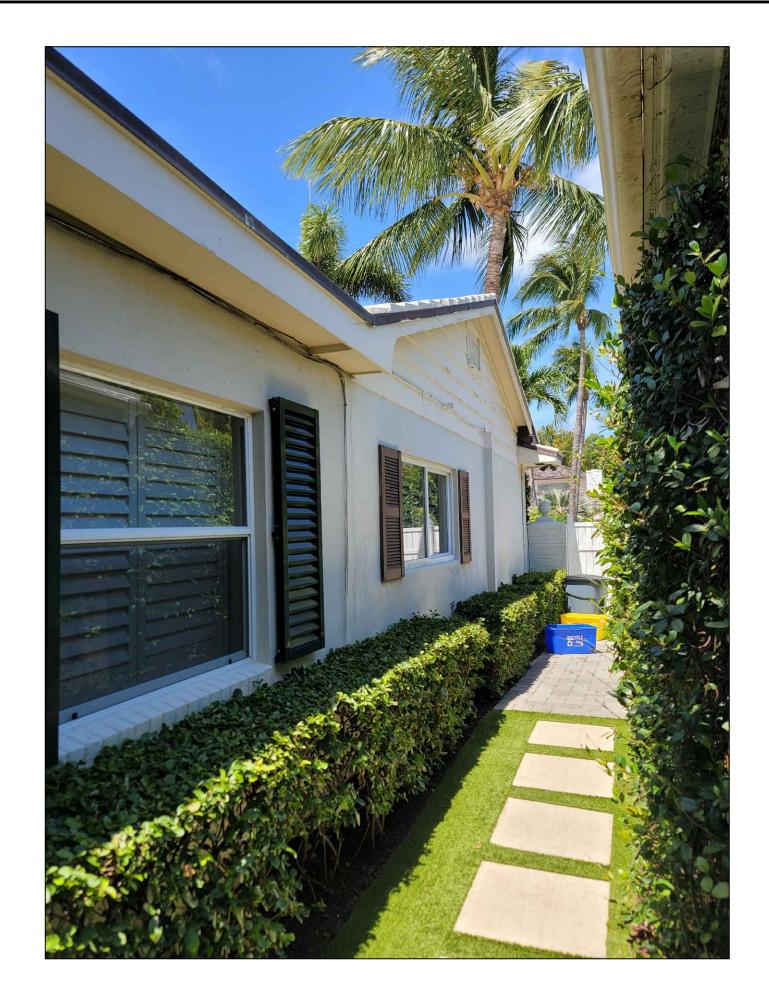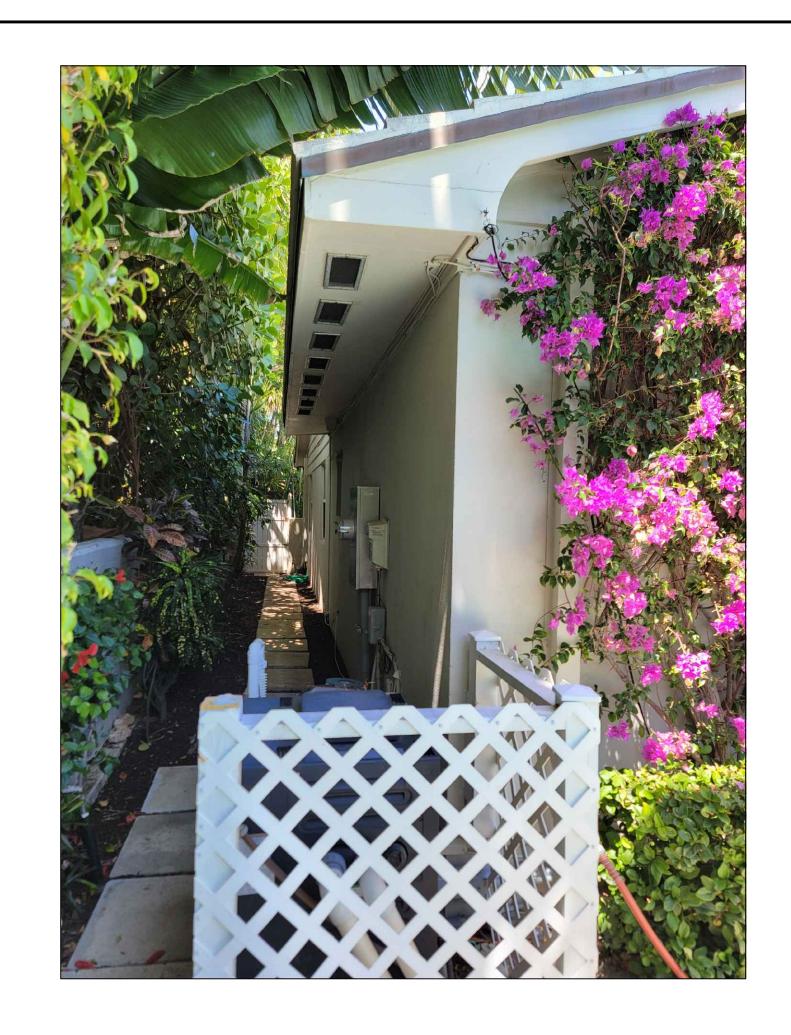PH-001









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SHAW RESIDENCE

286 ORANGE GROVE PALM BEACH, FL, 33480

ARC-23-084













PHOTOS OF EXISTING HOUSE

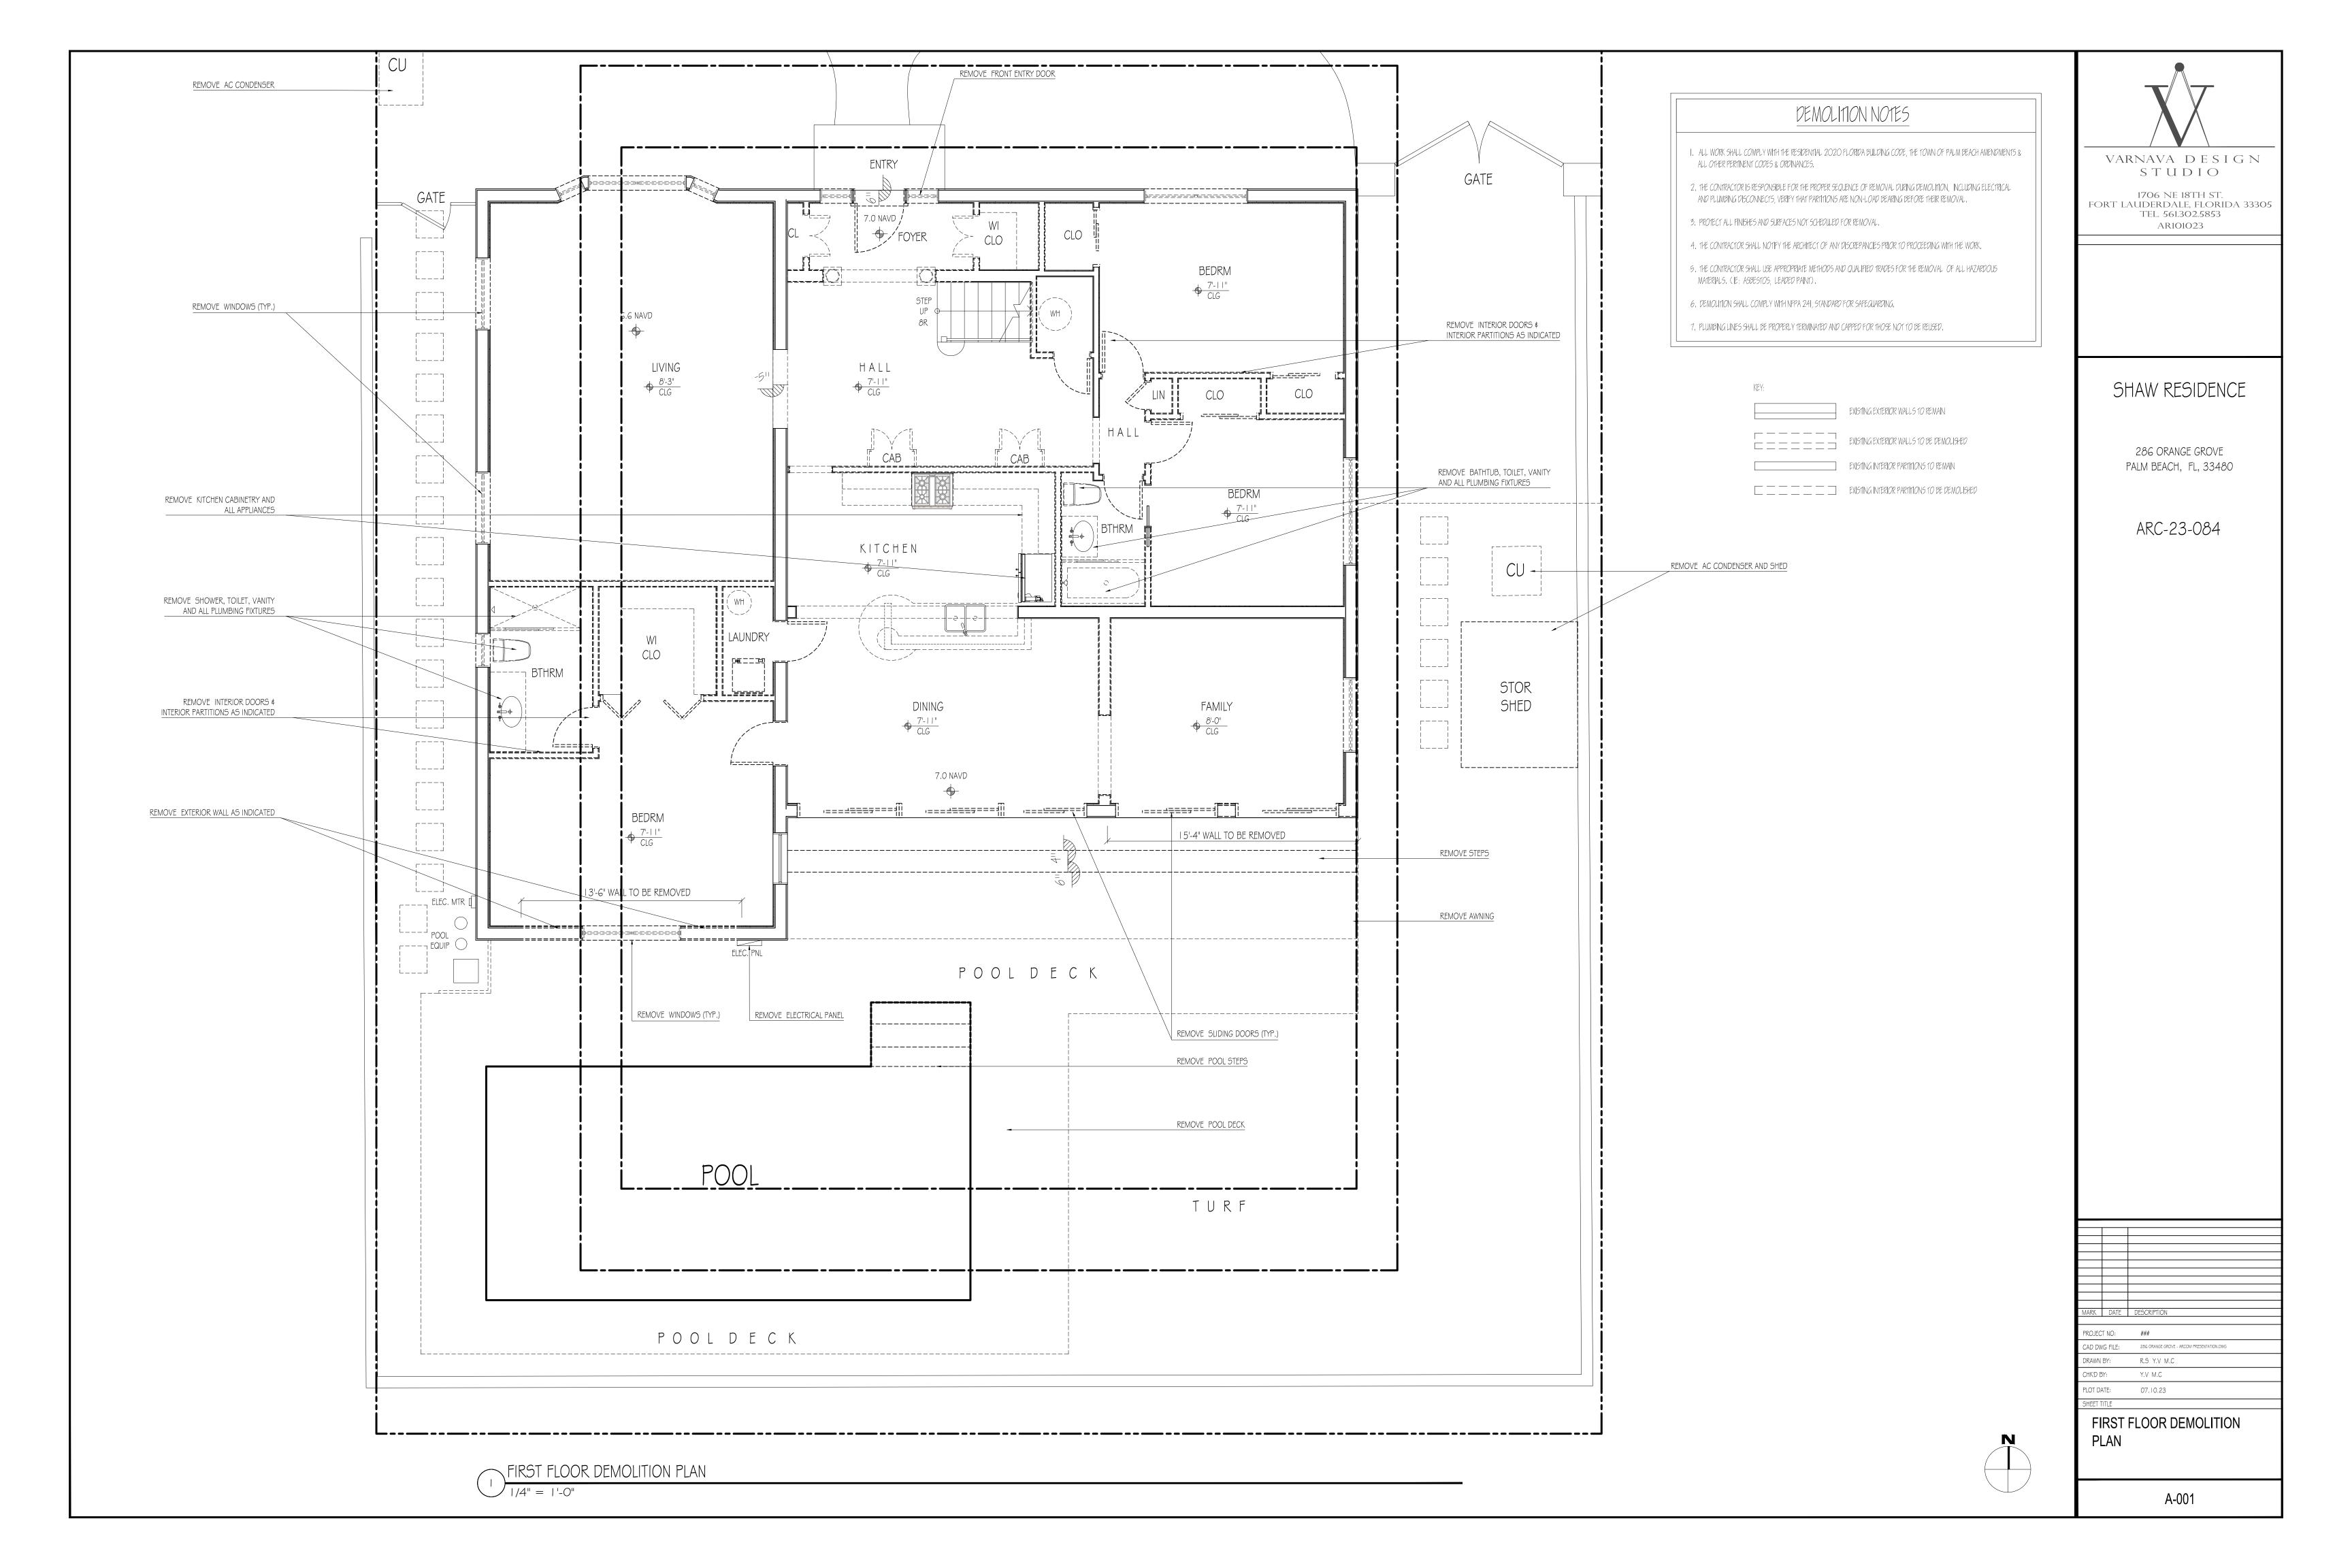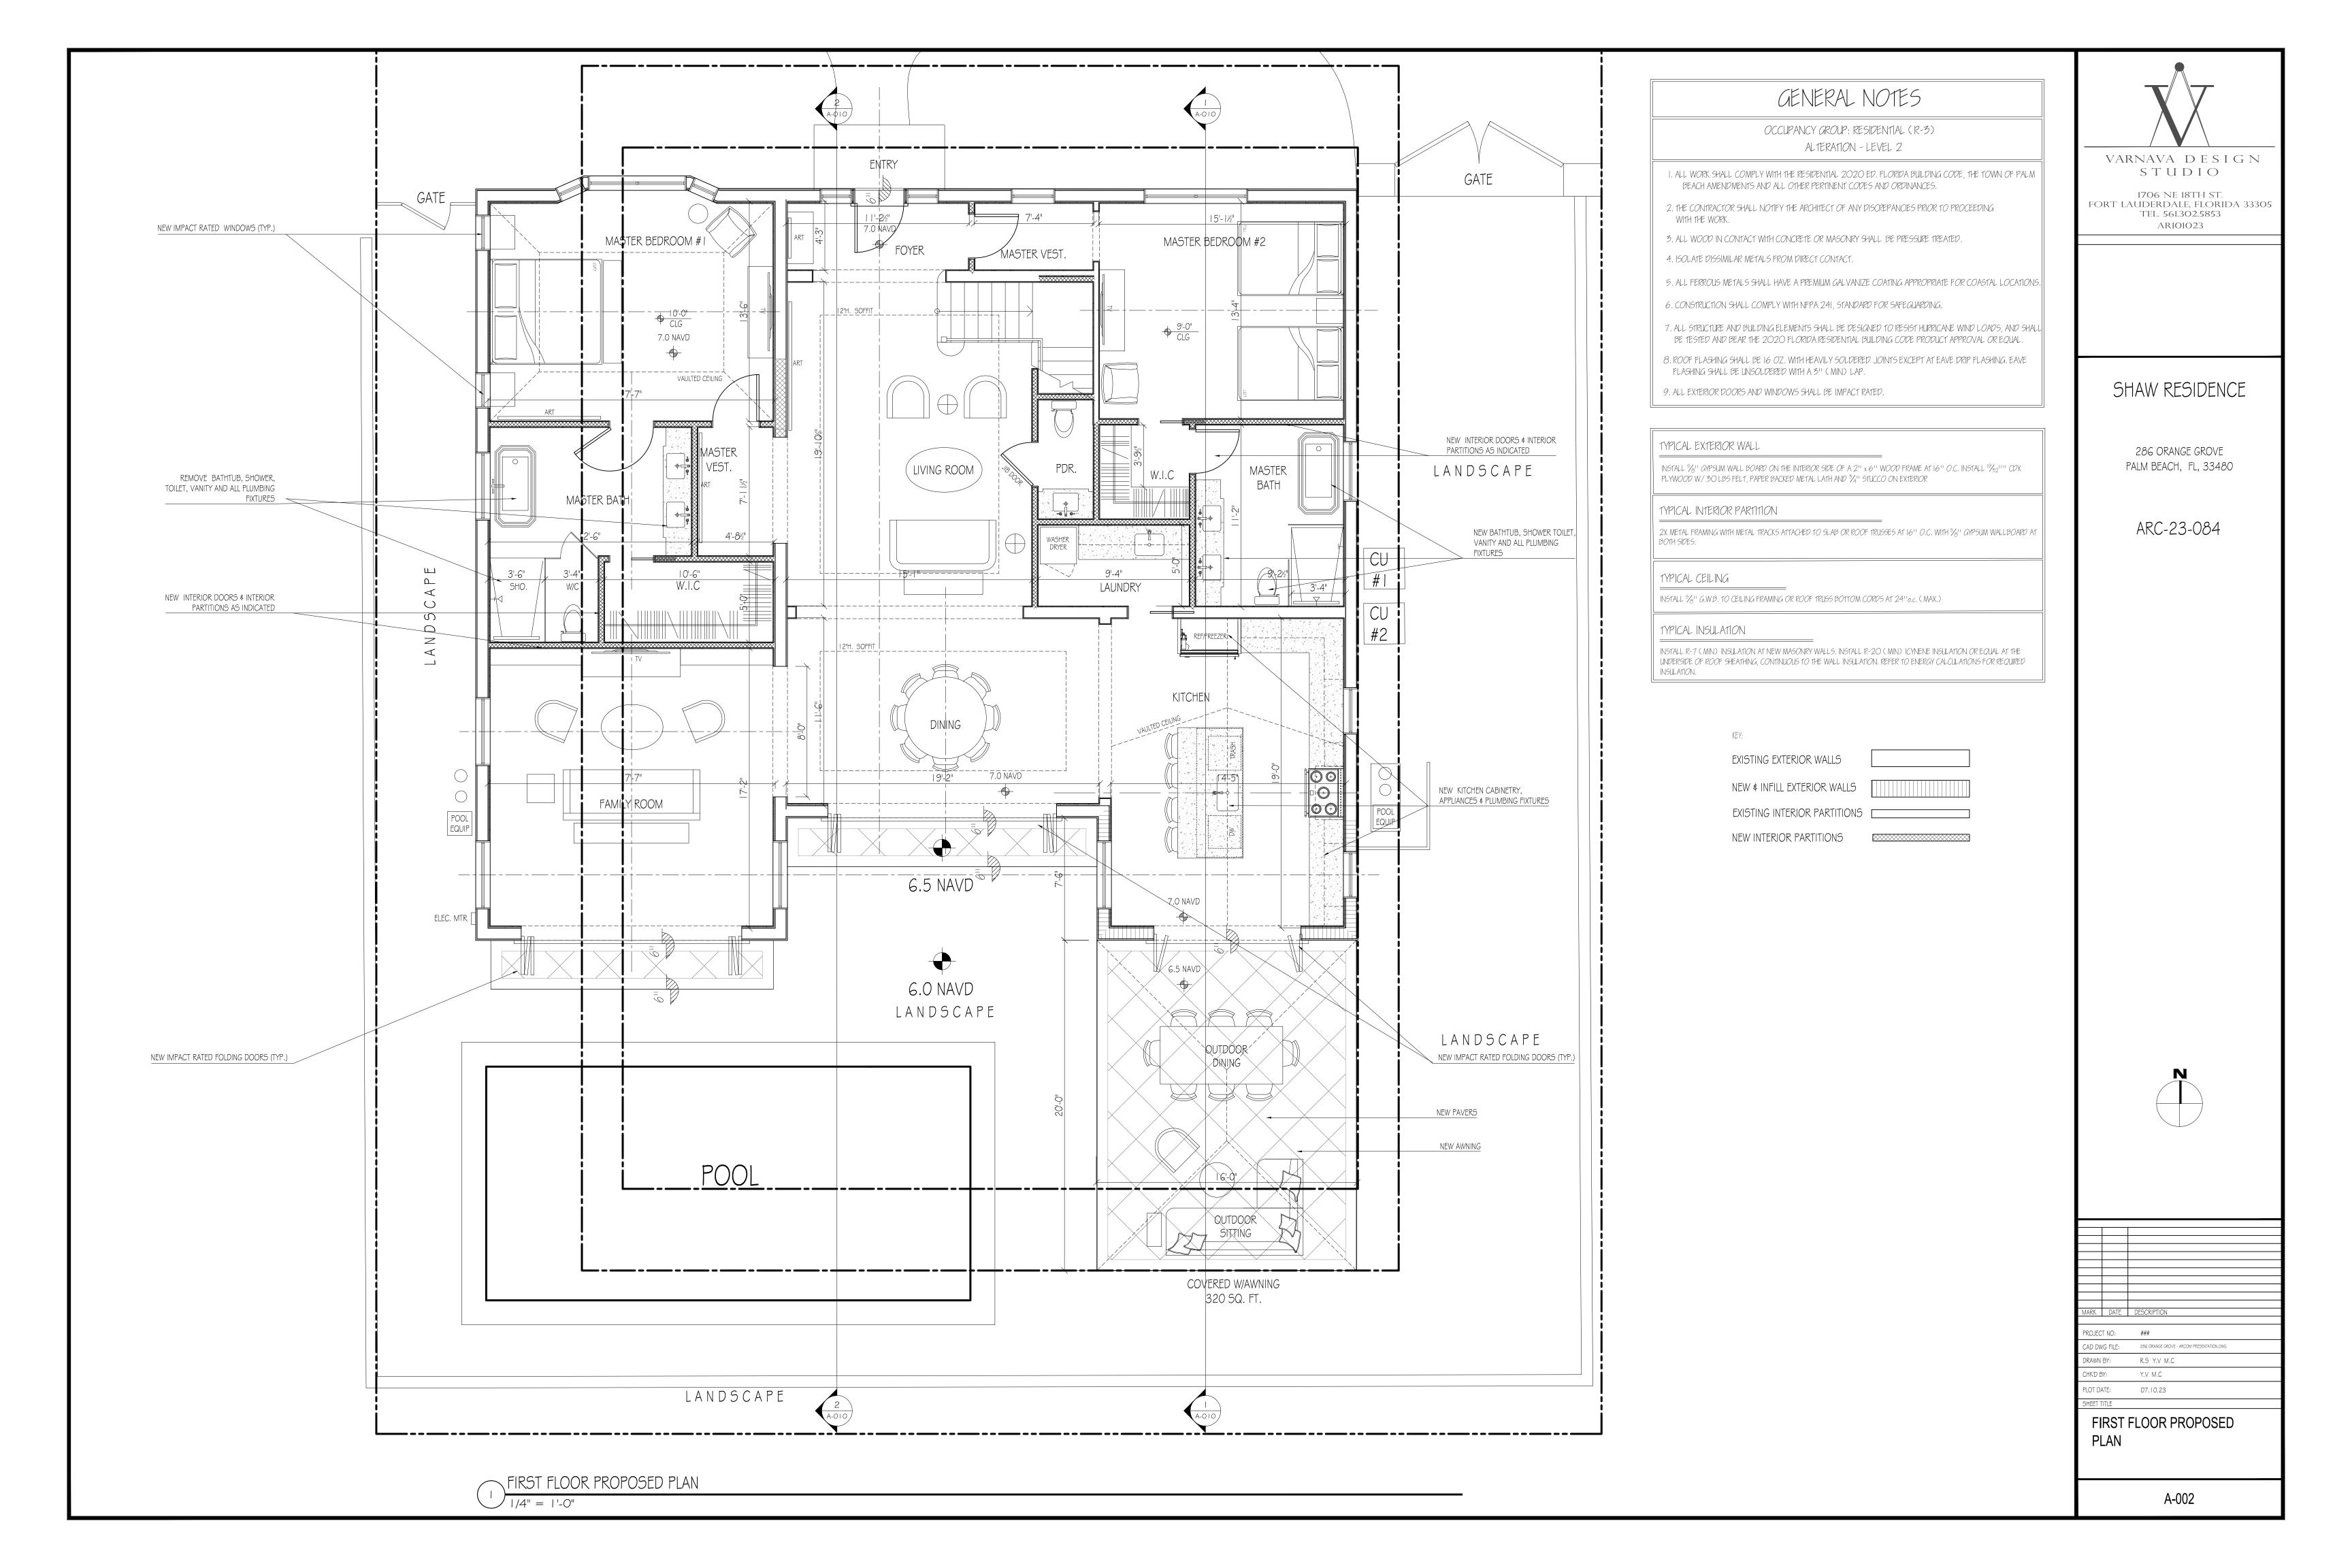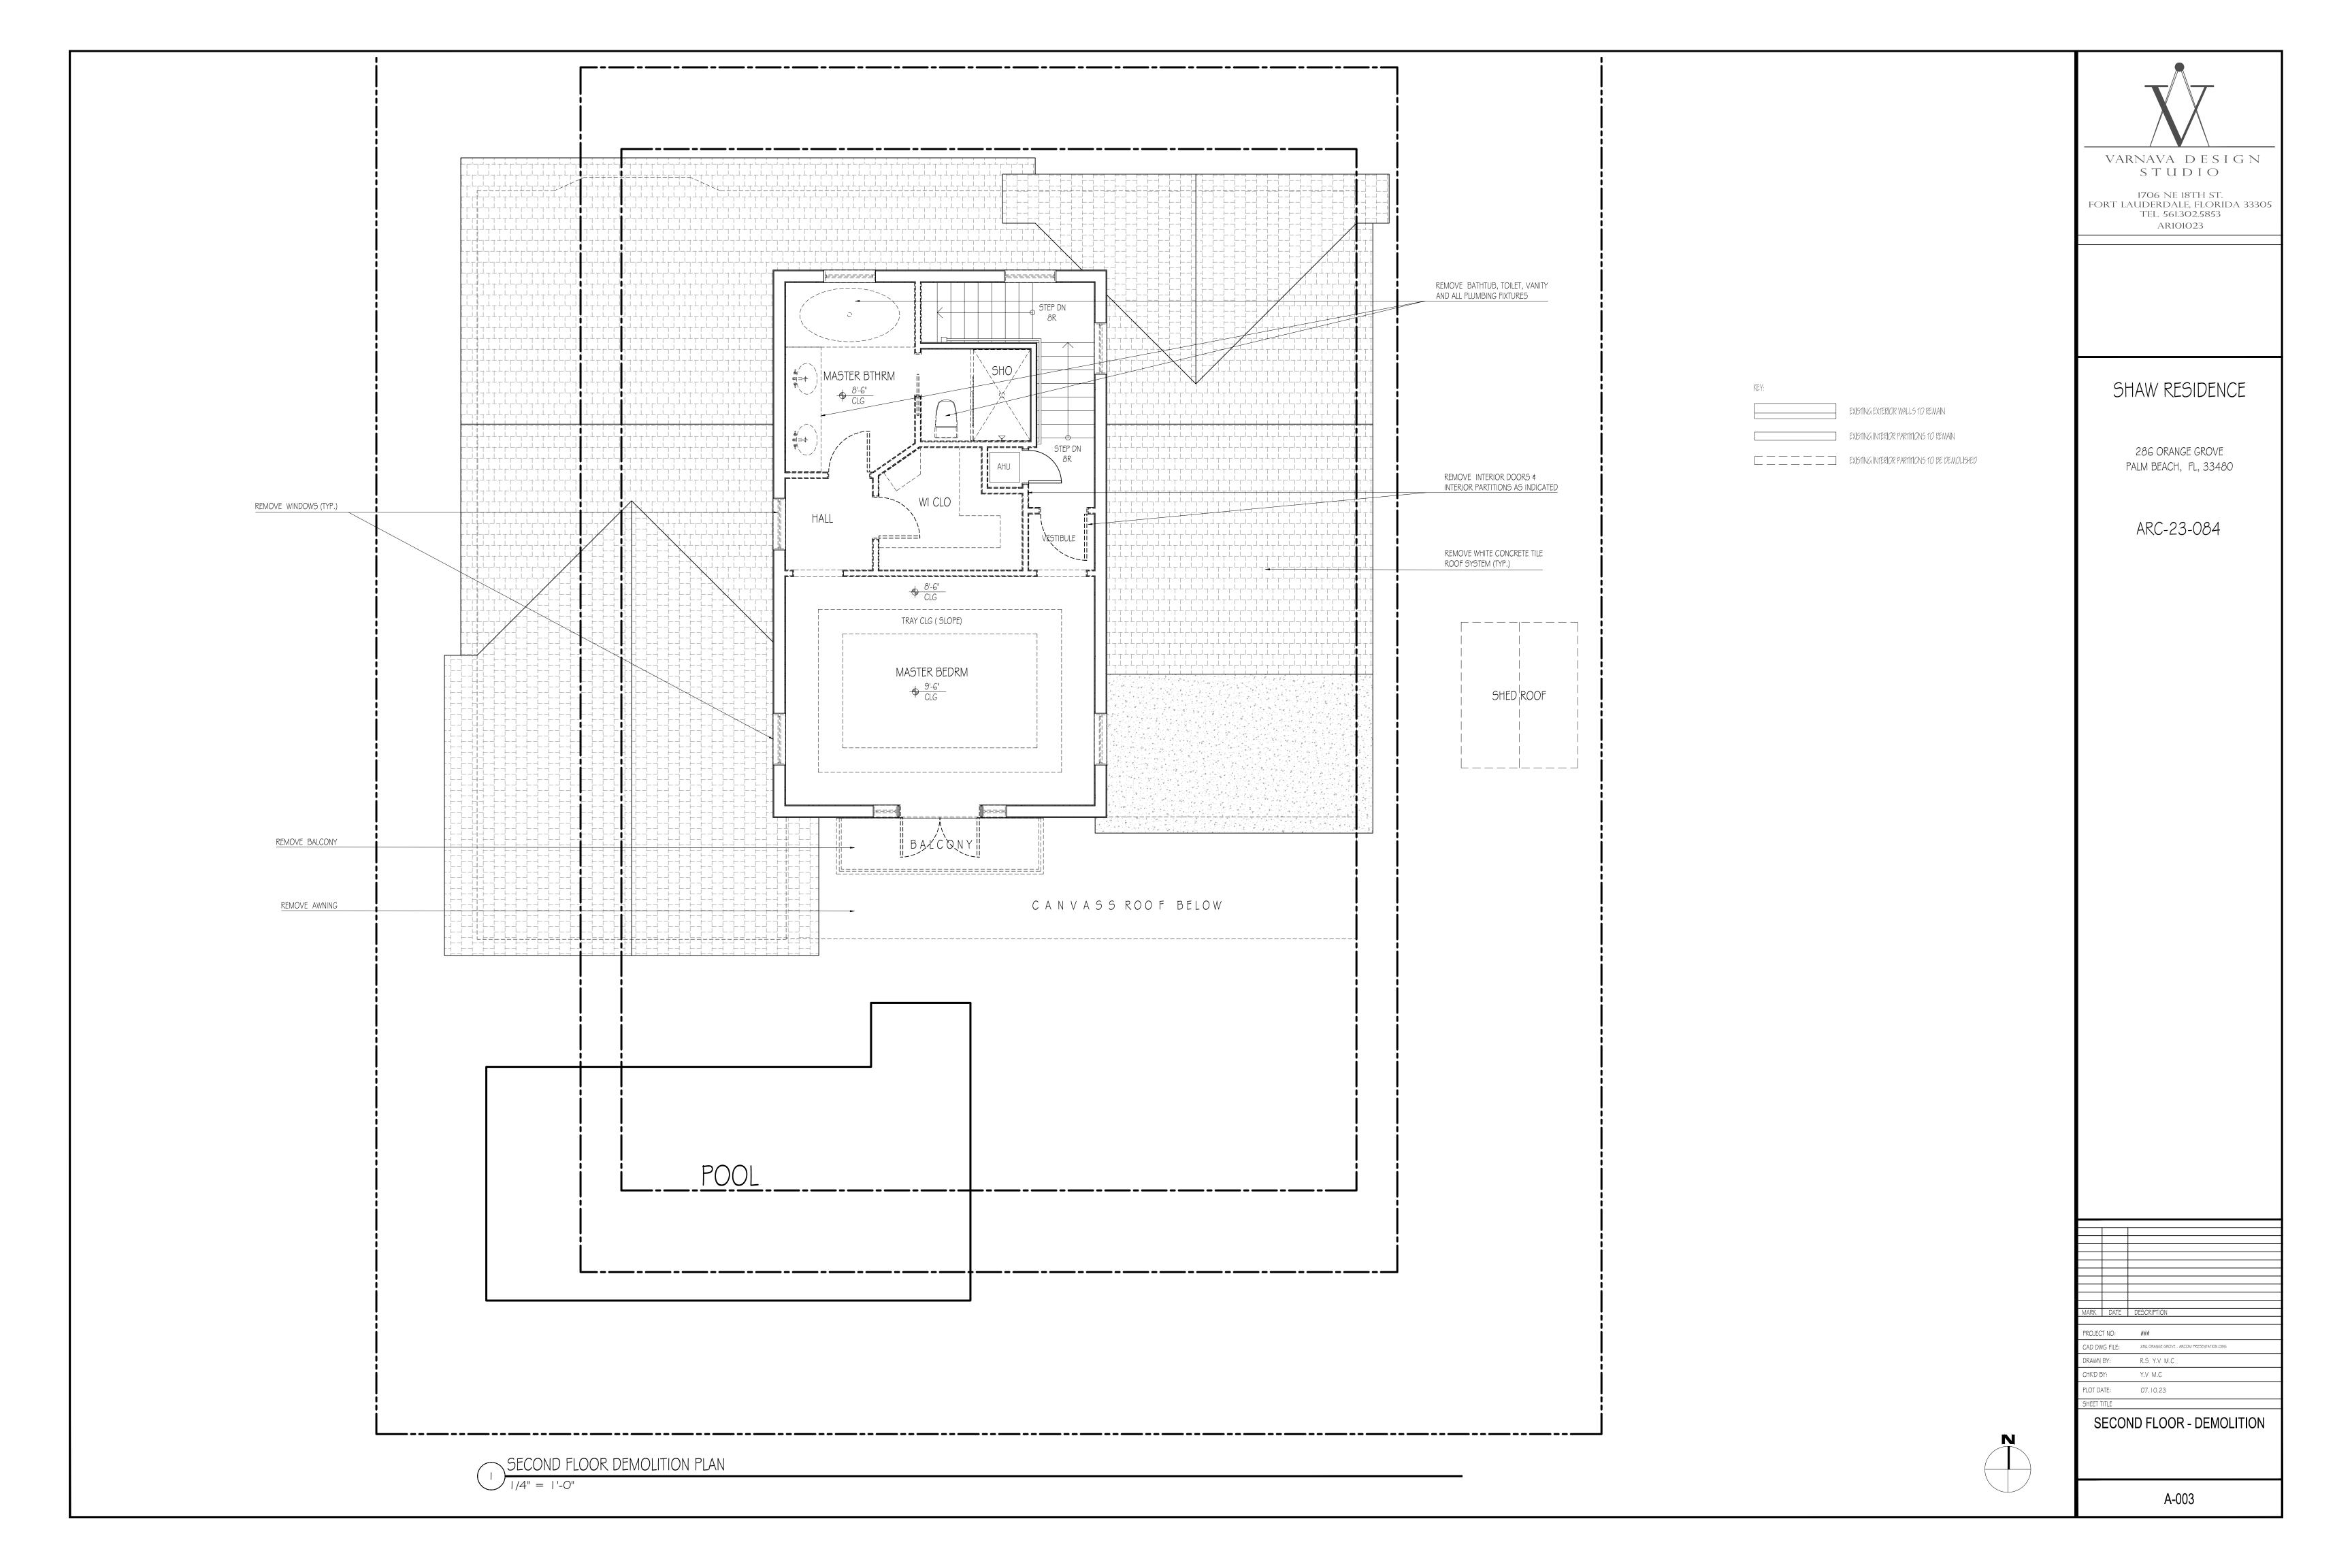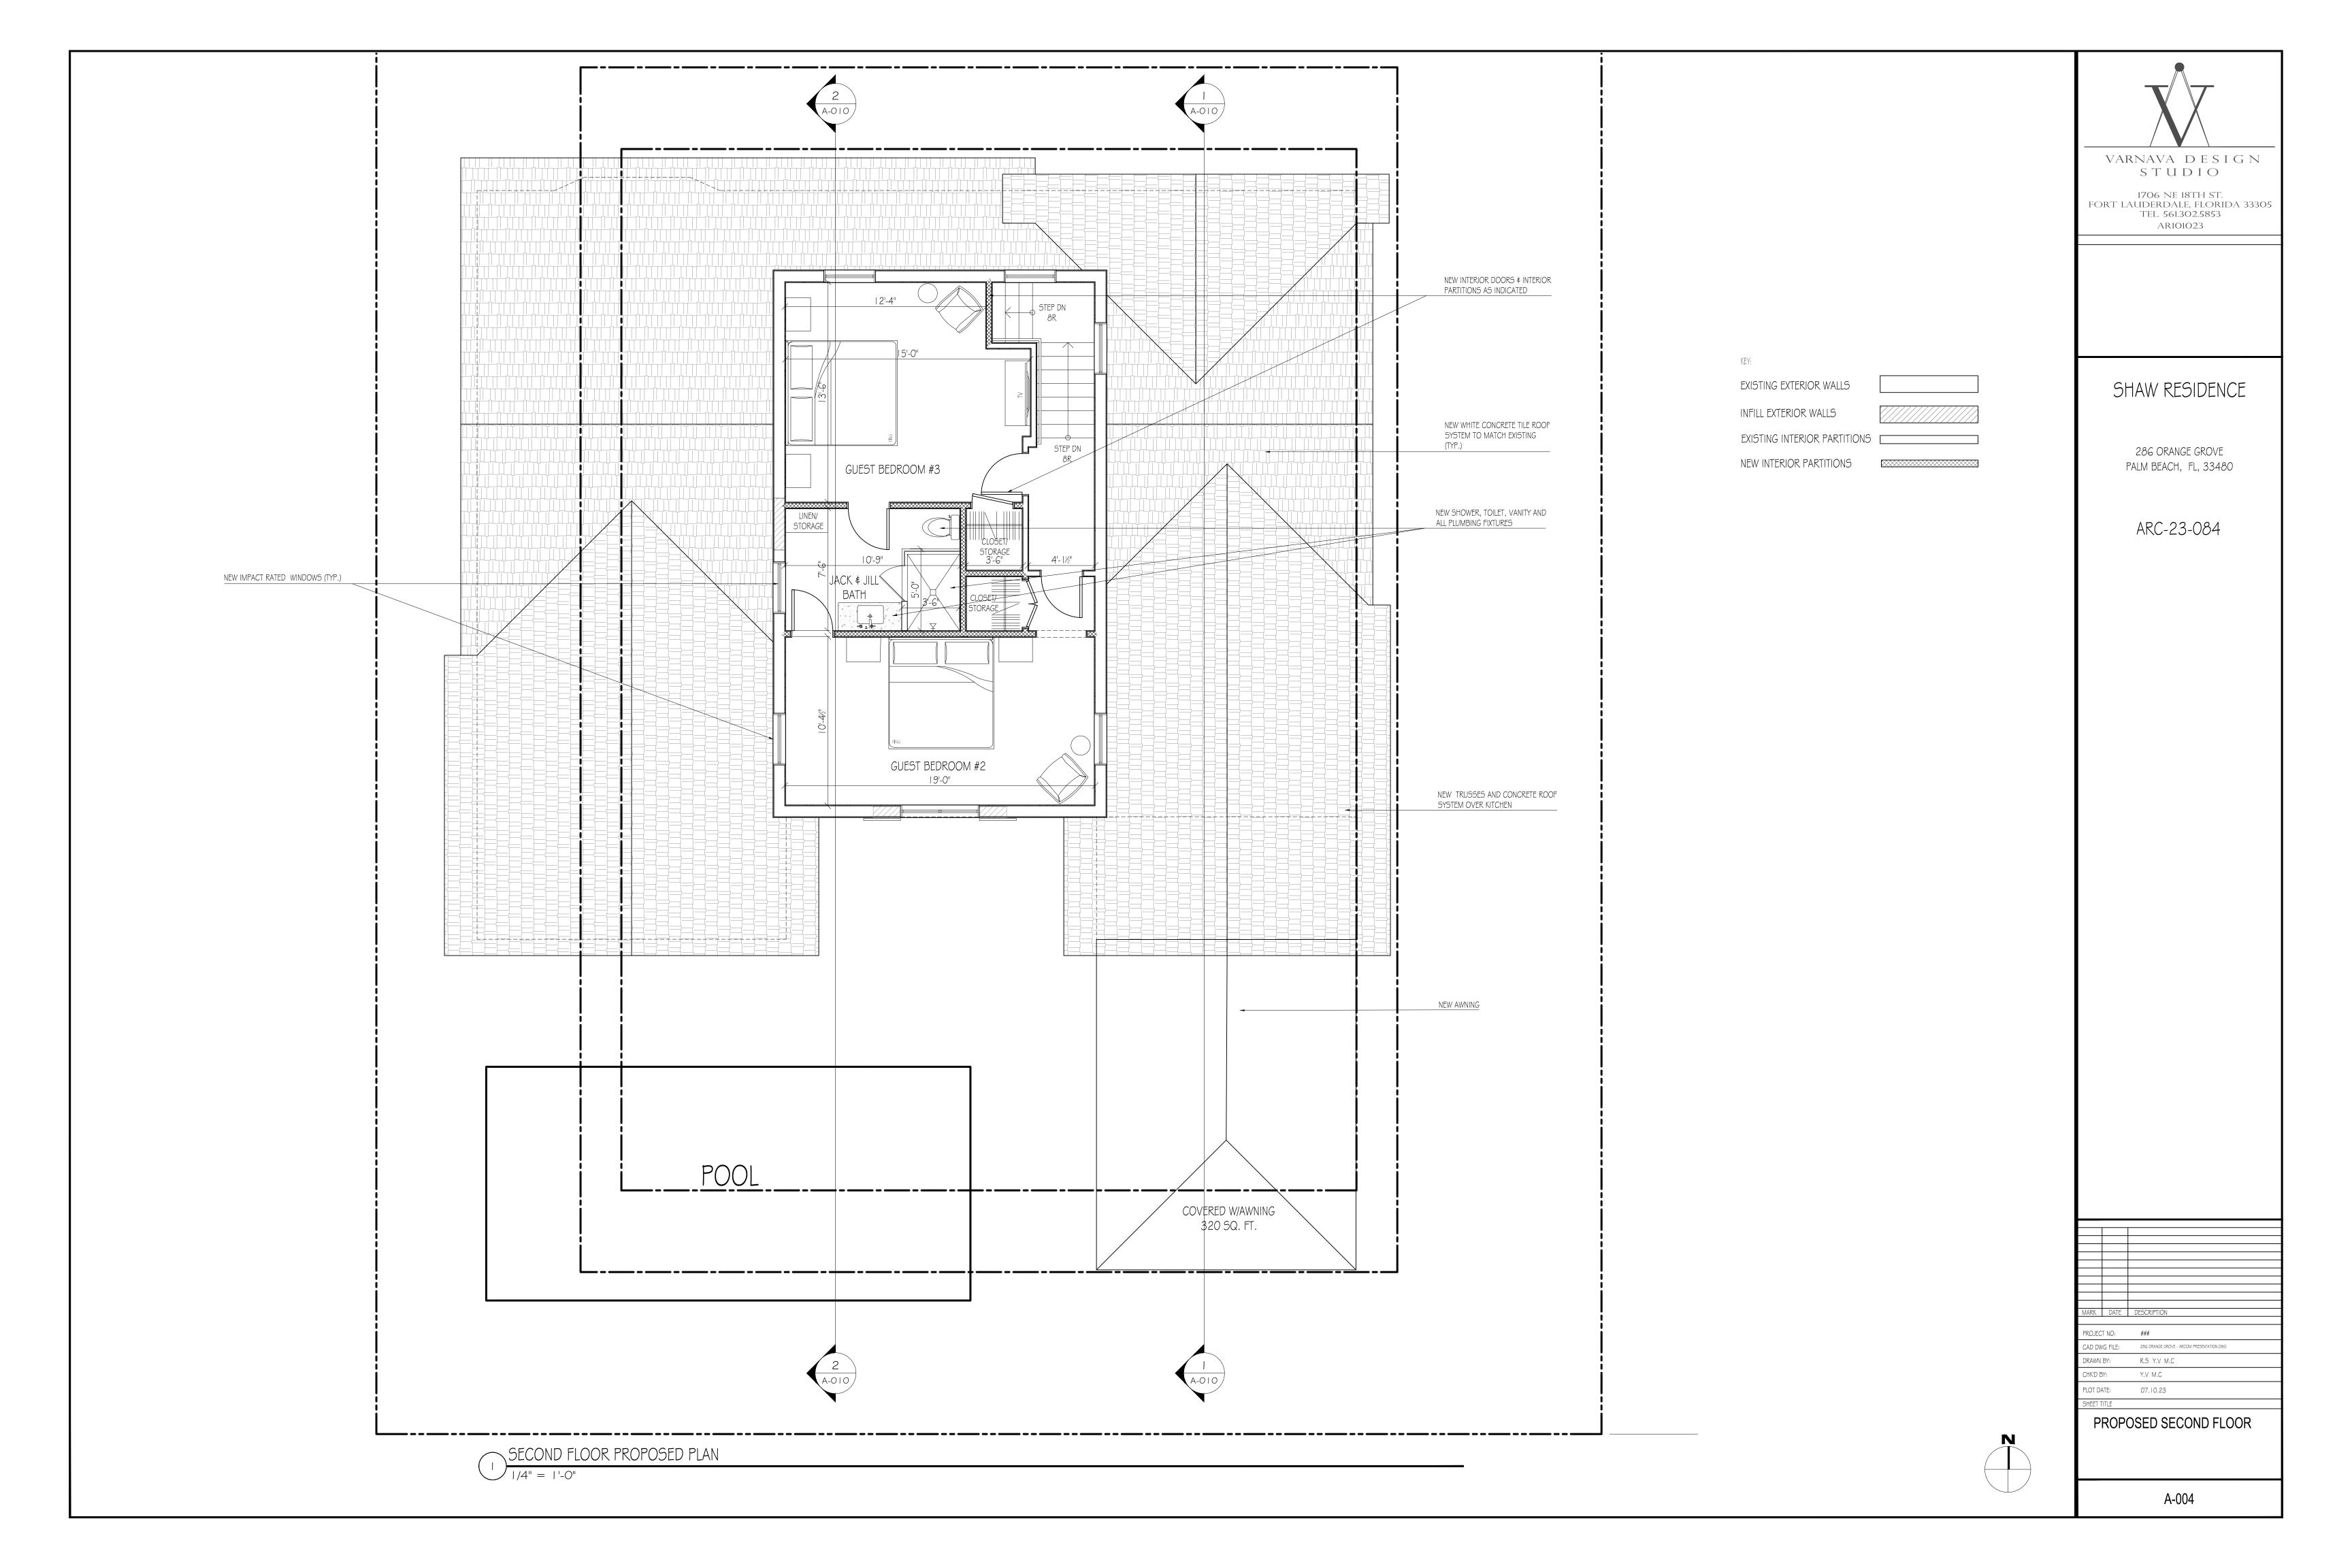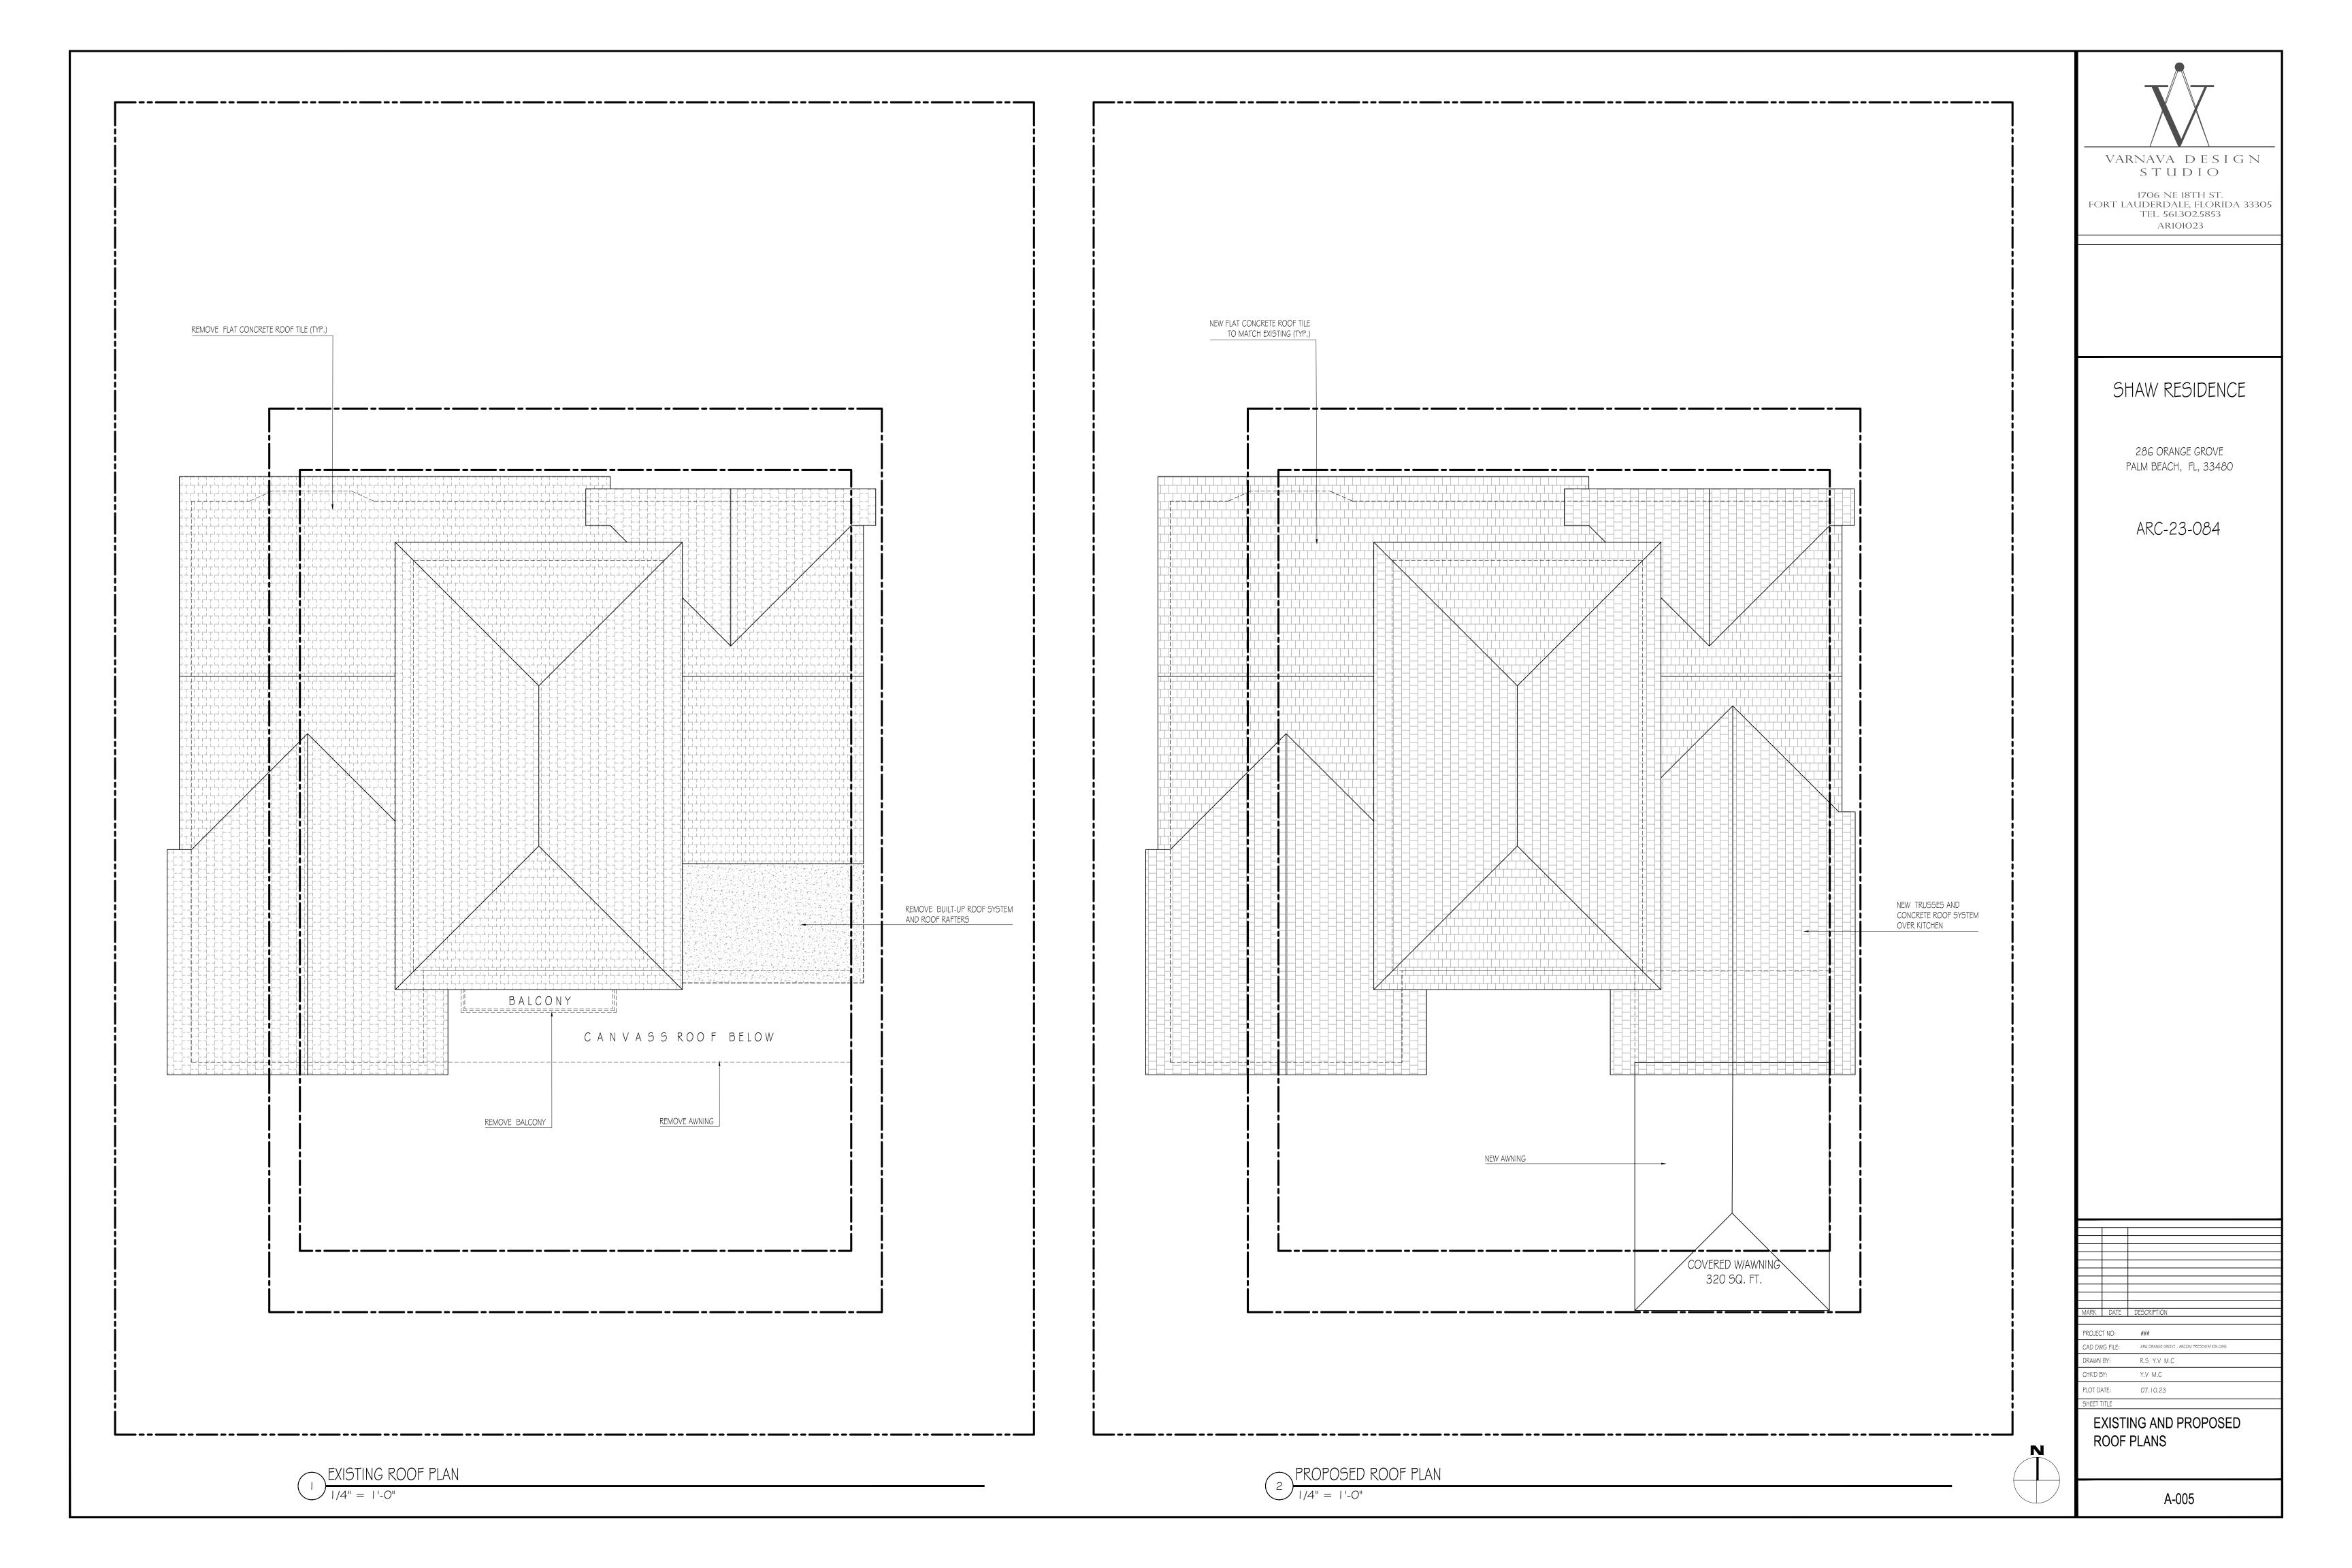
LOT DATE: 07.10.23

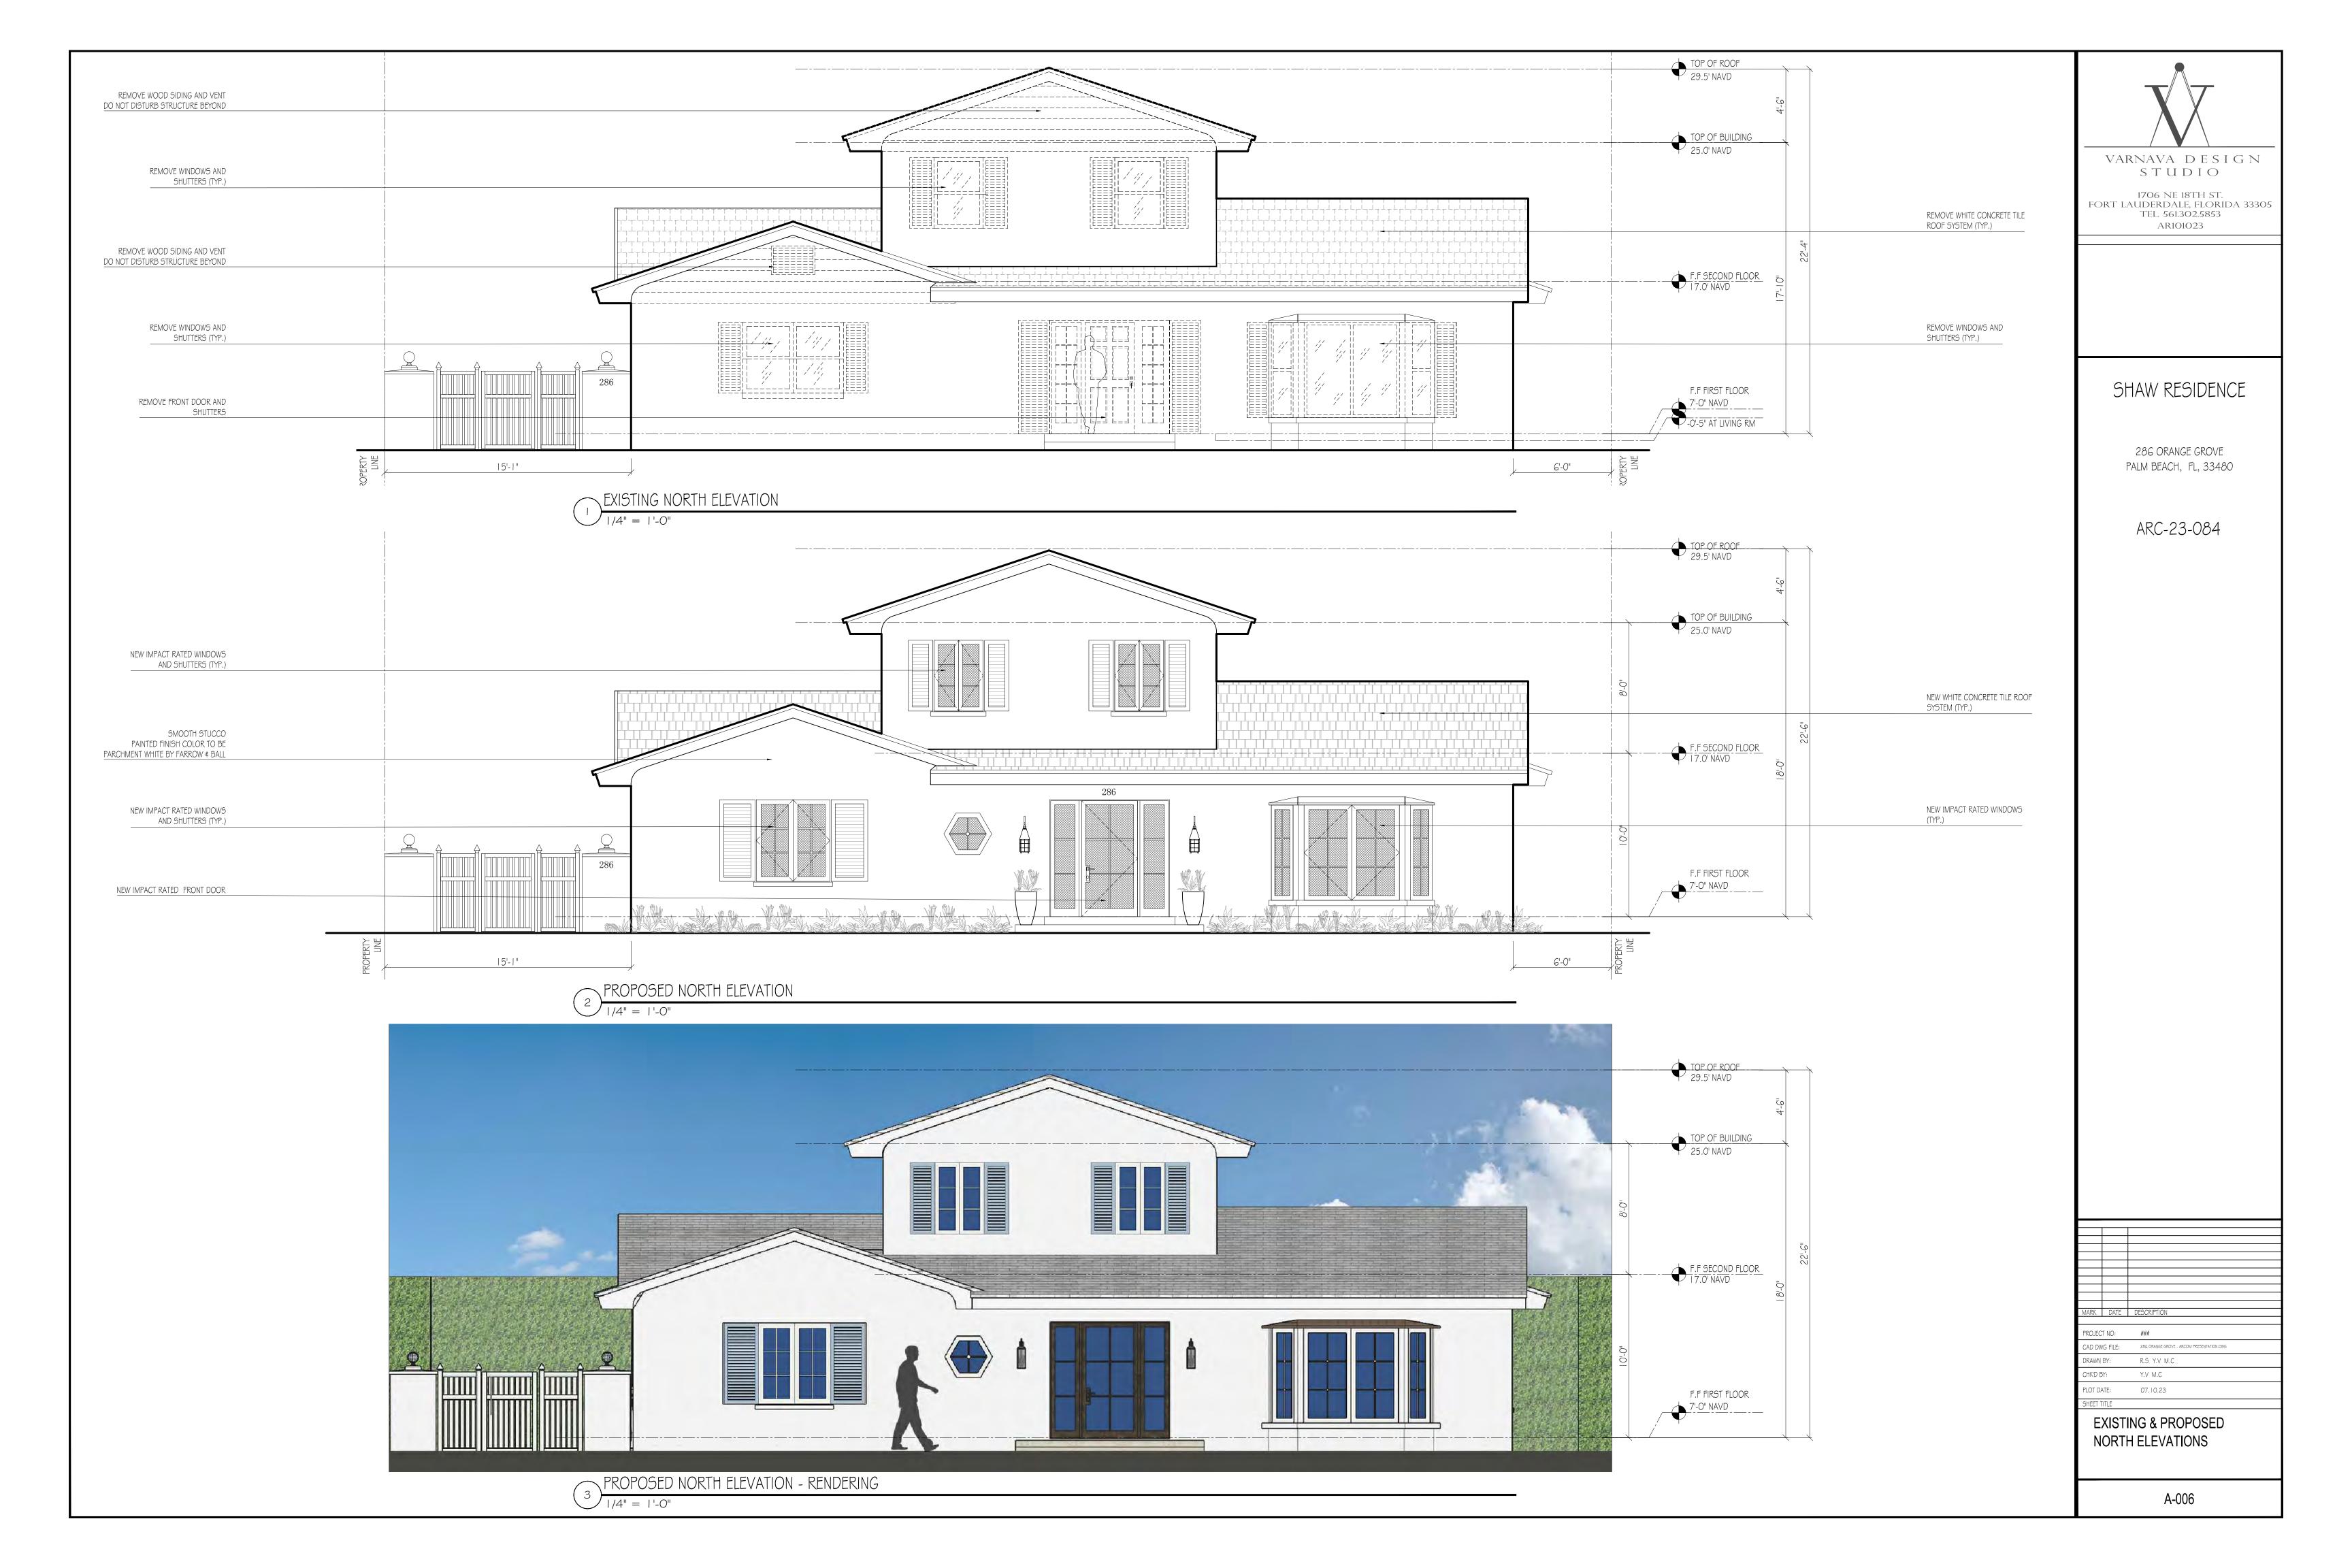


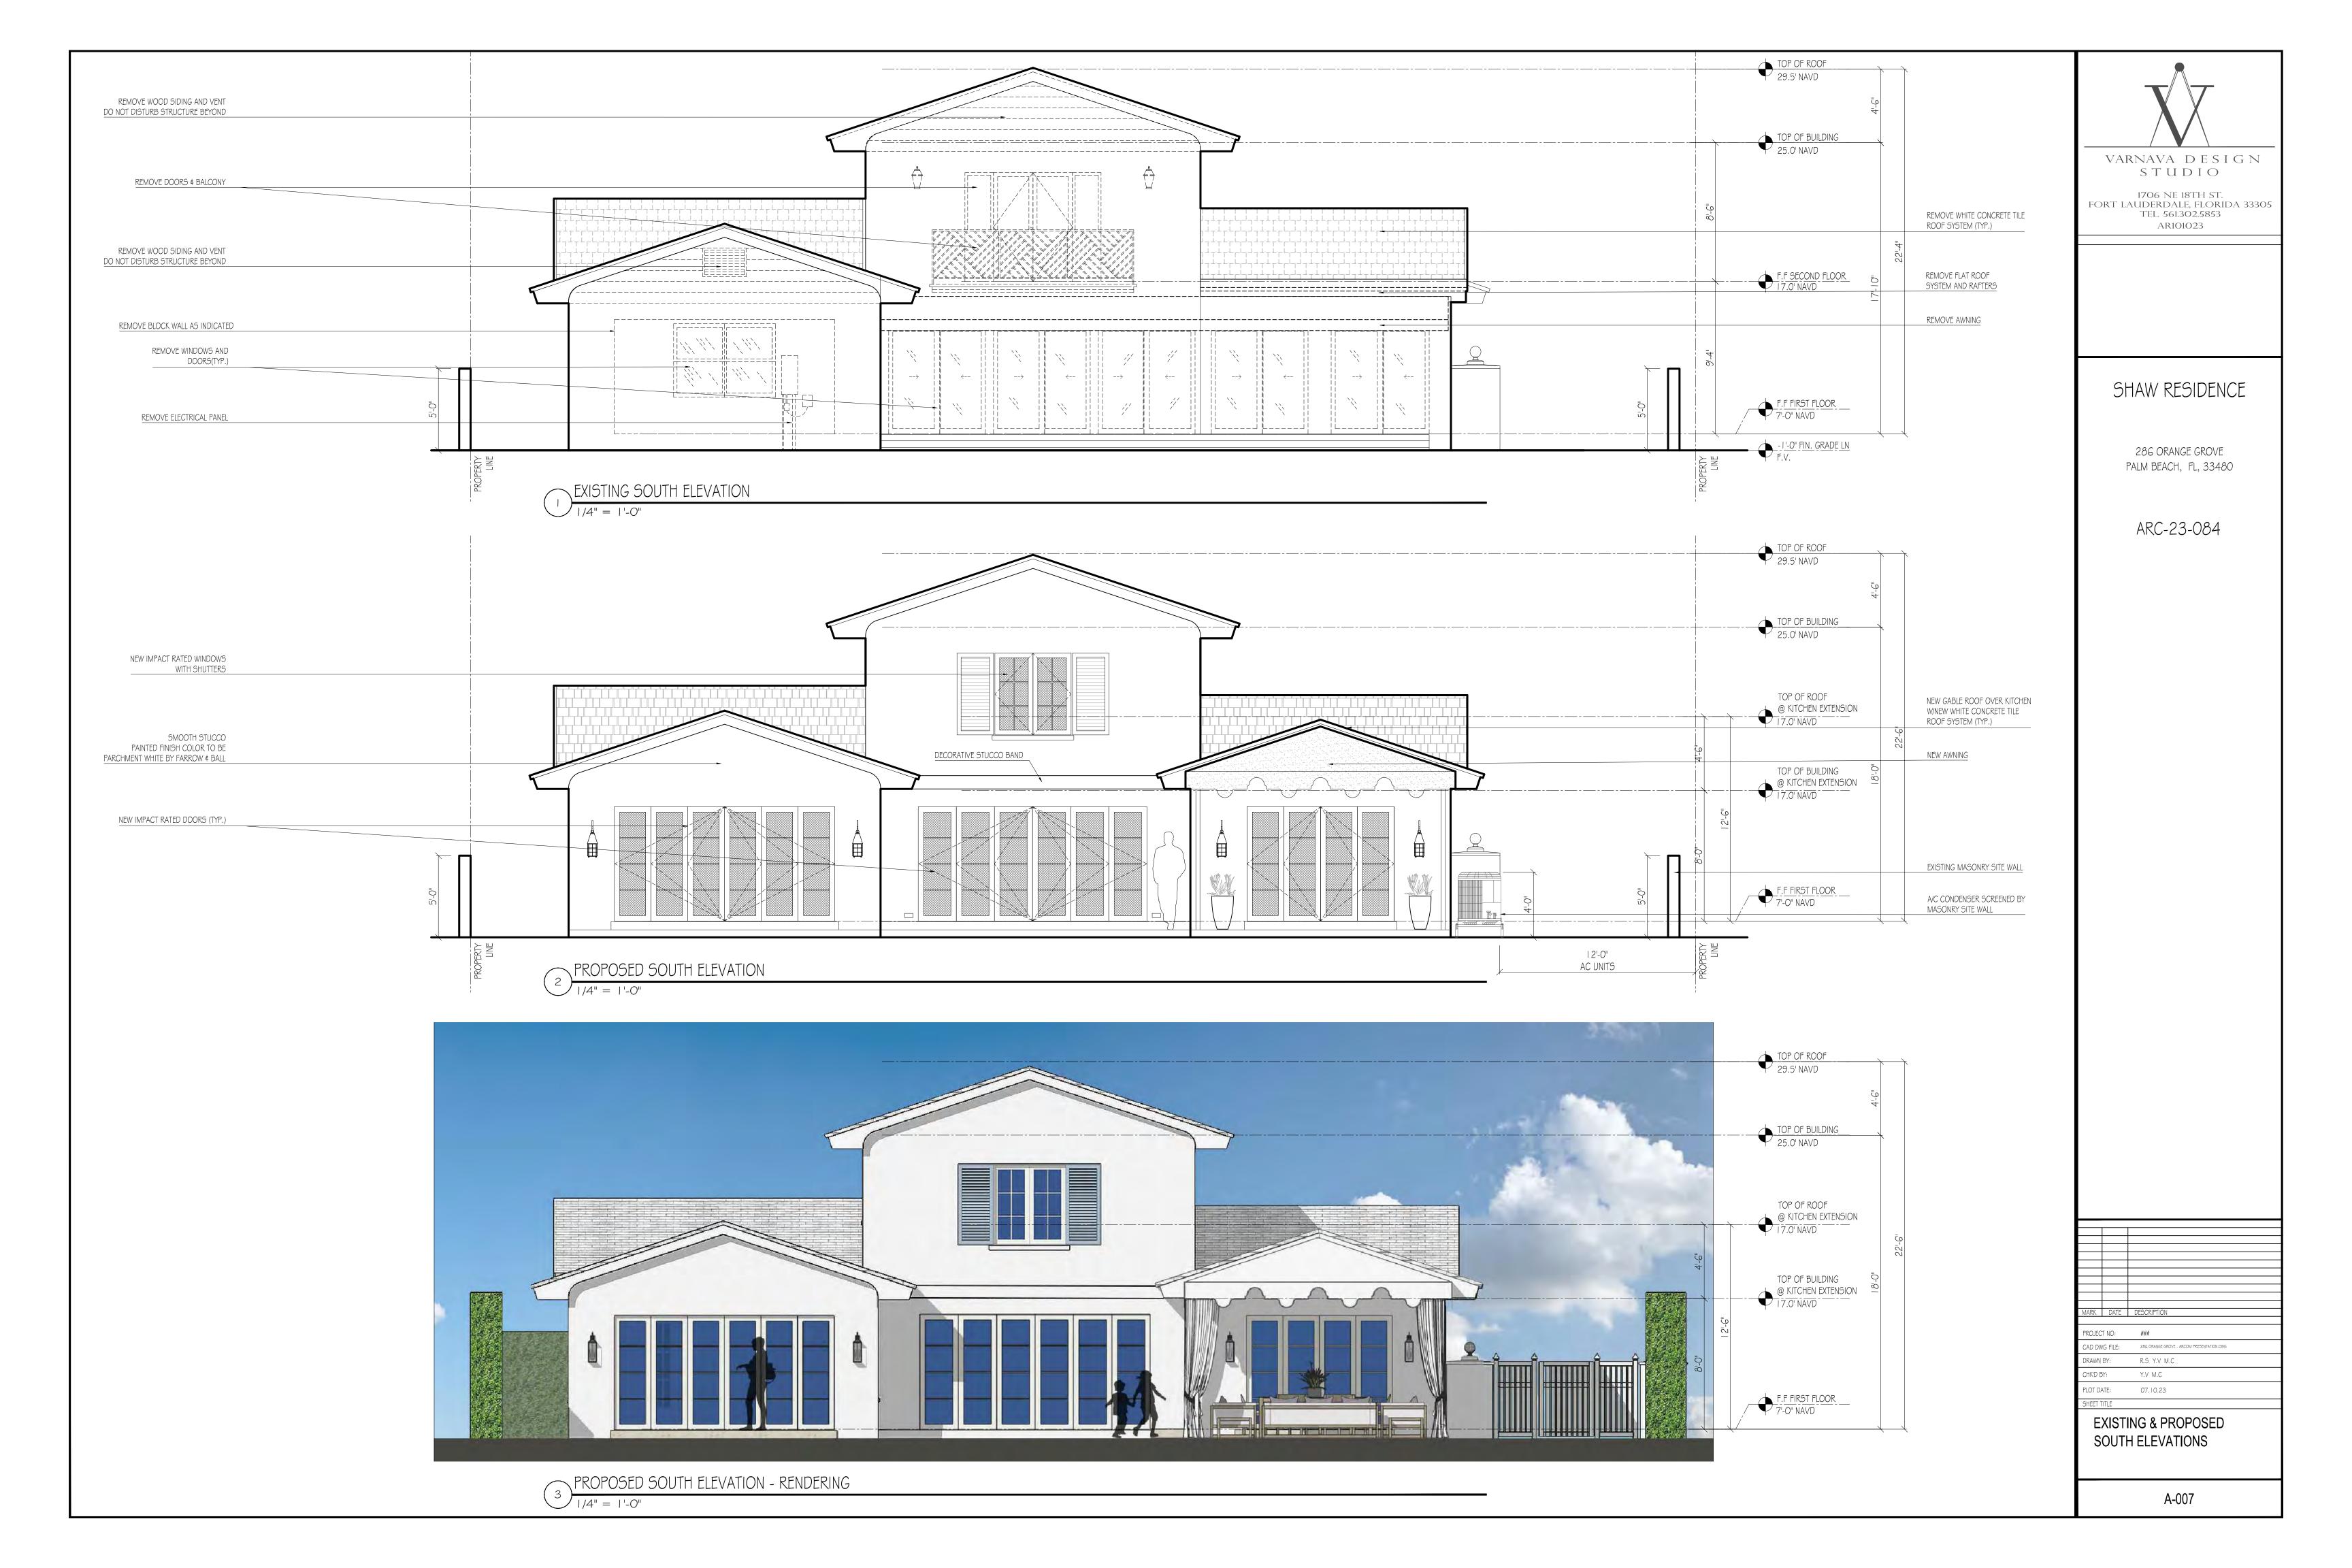


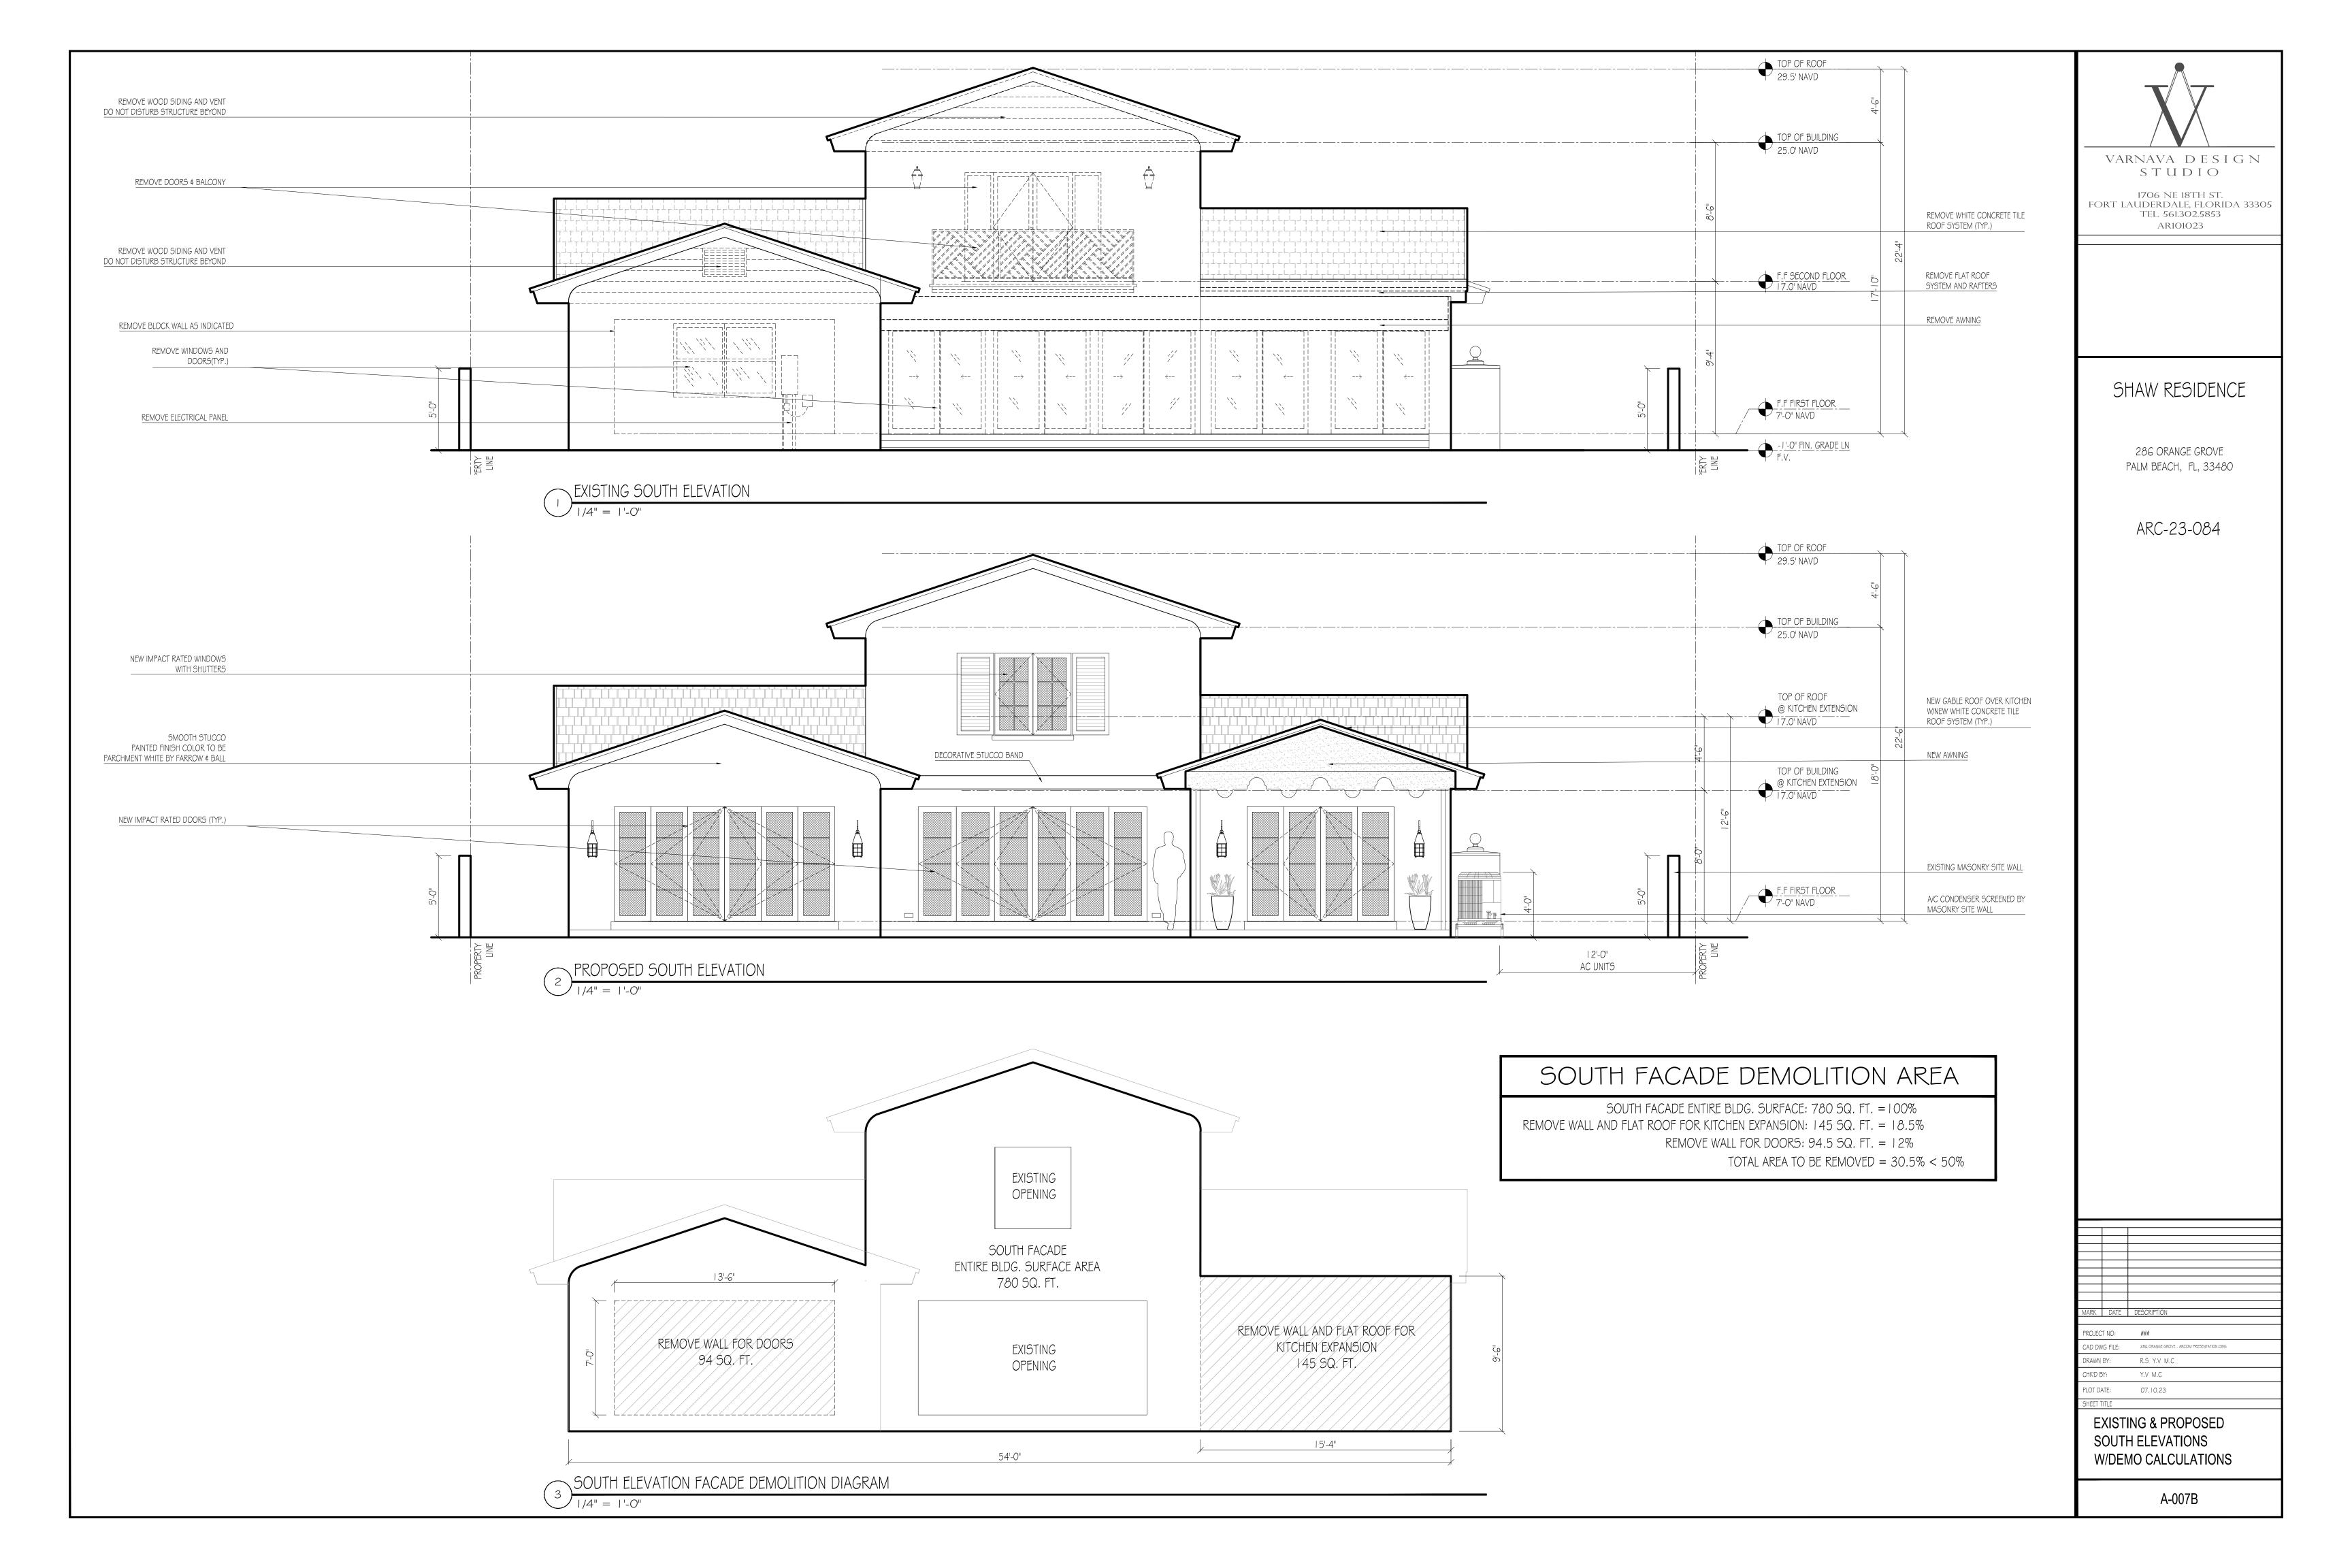


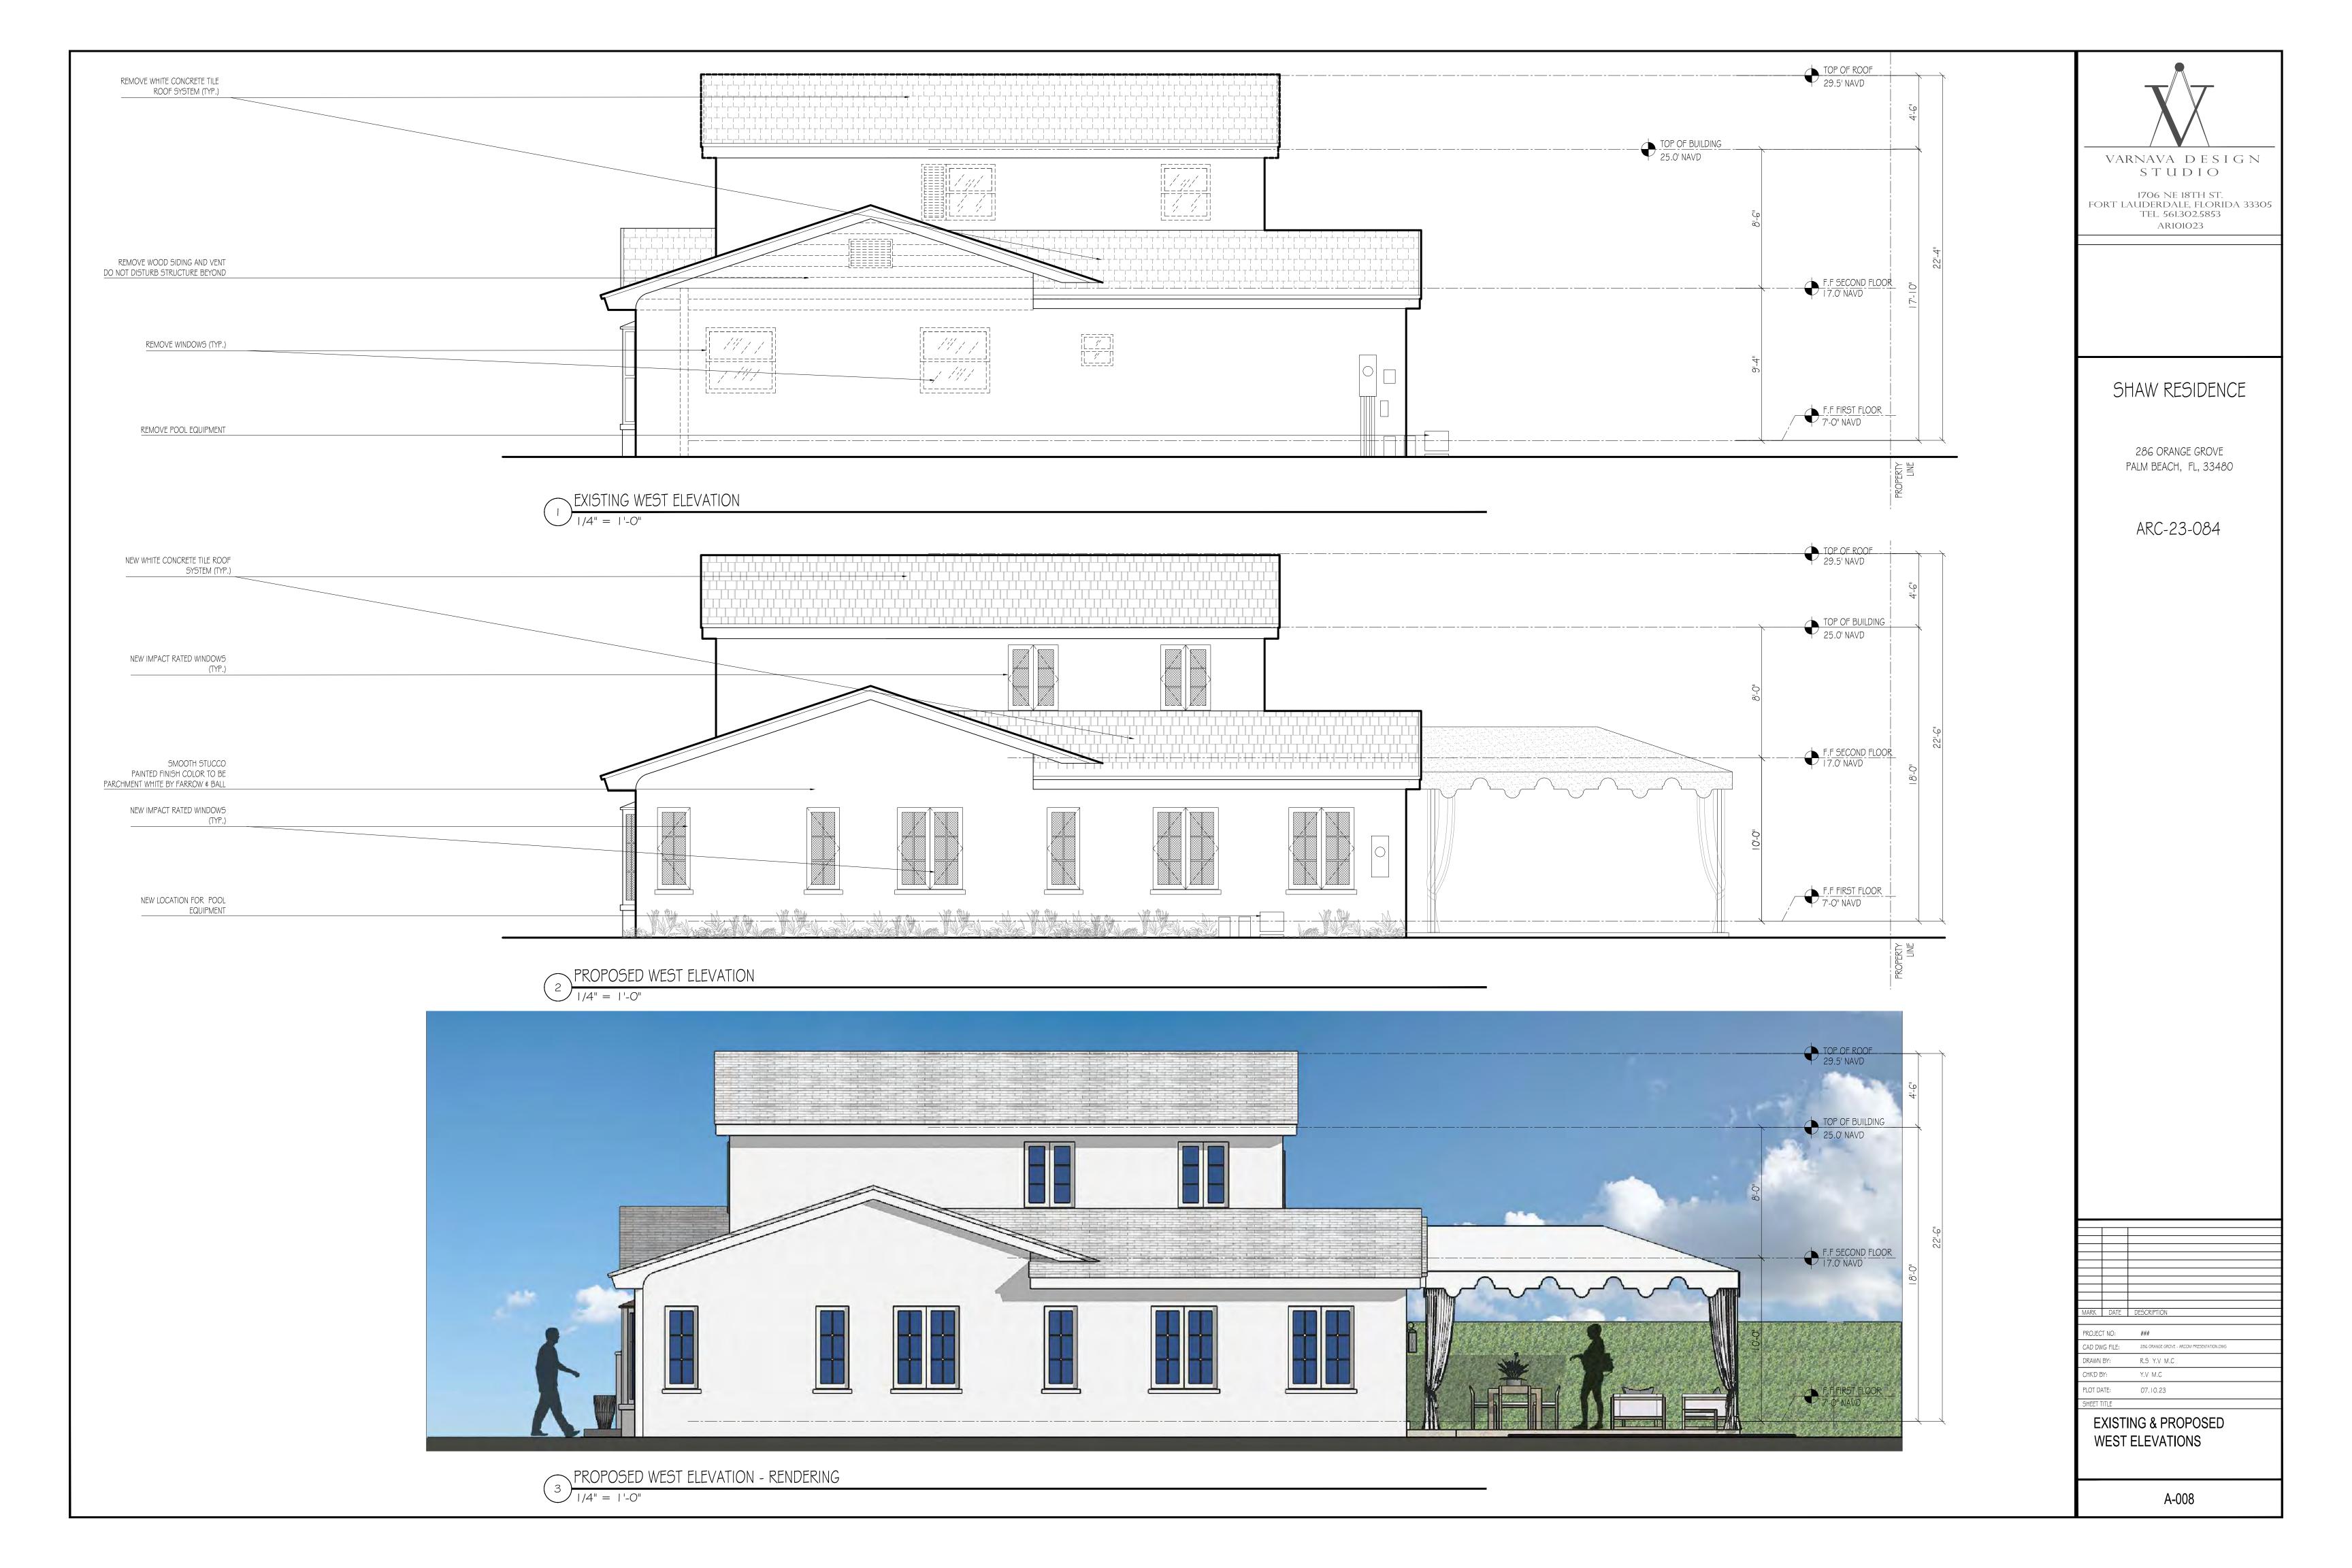


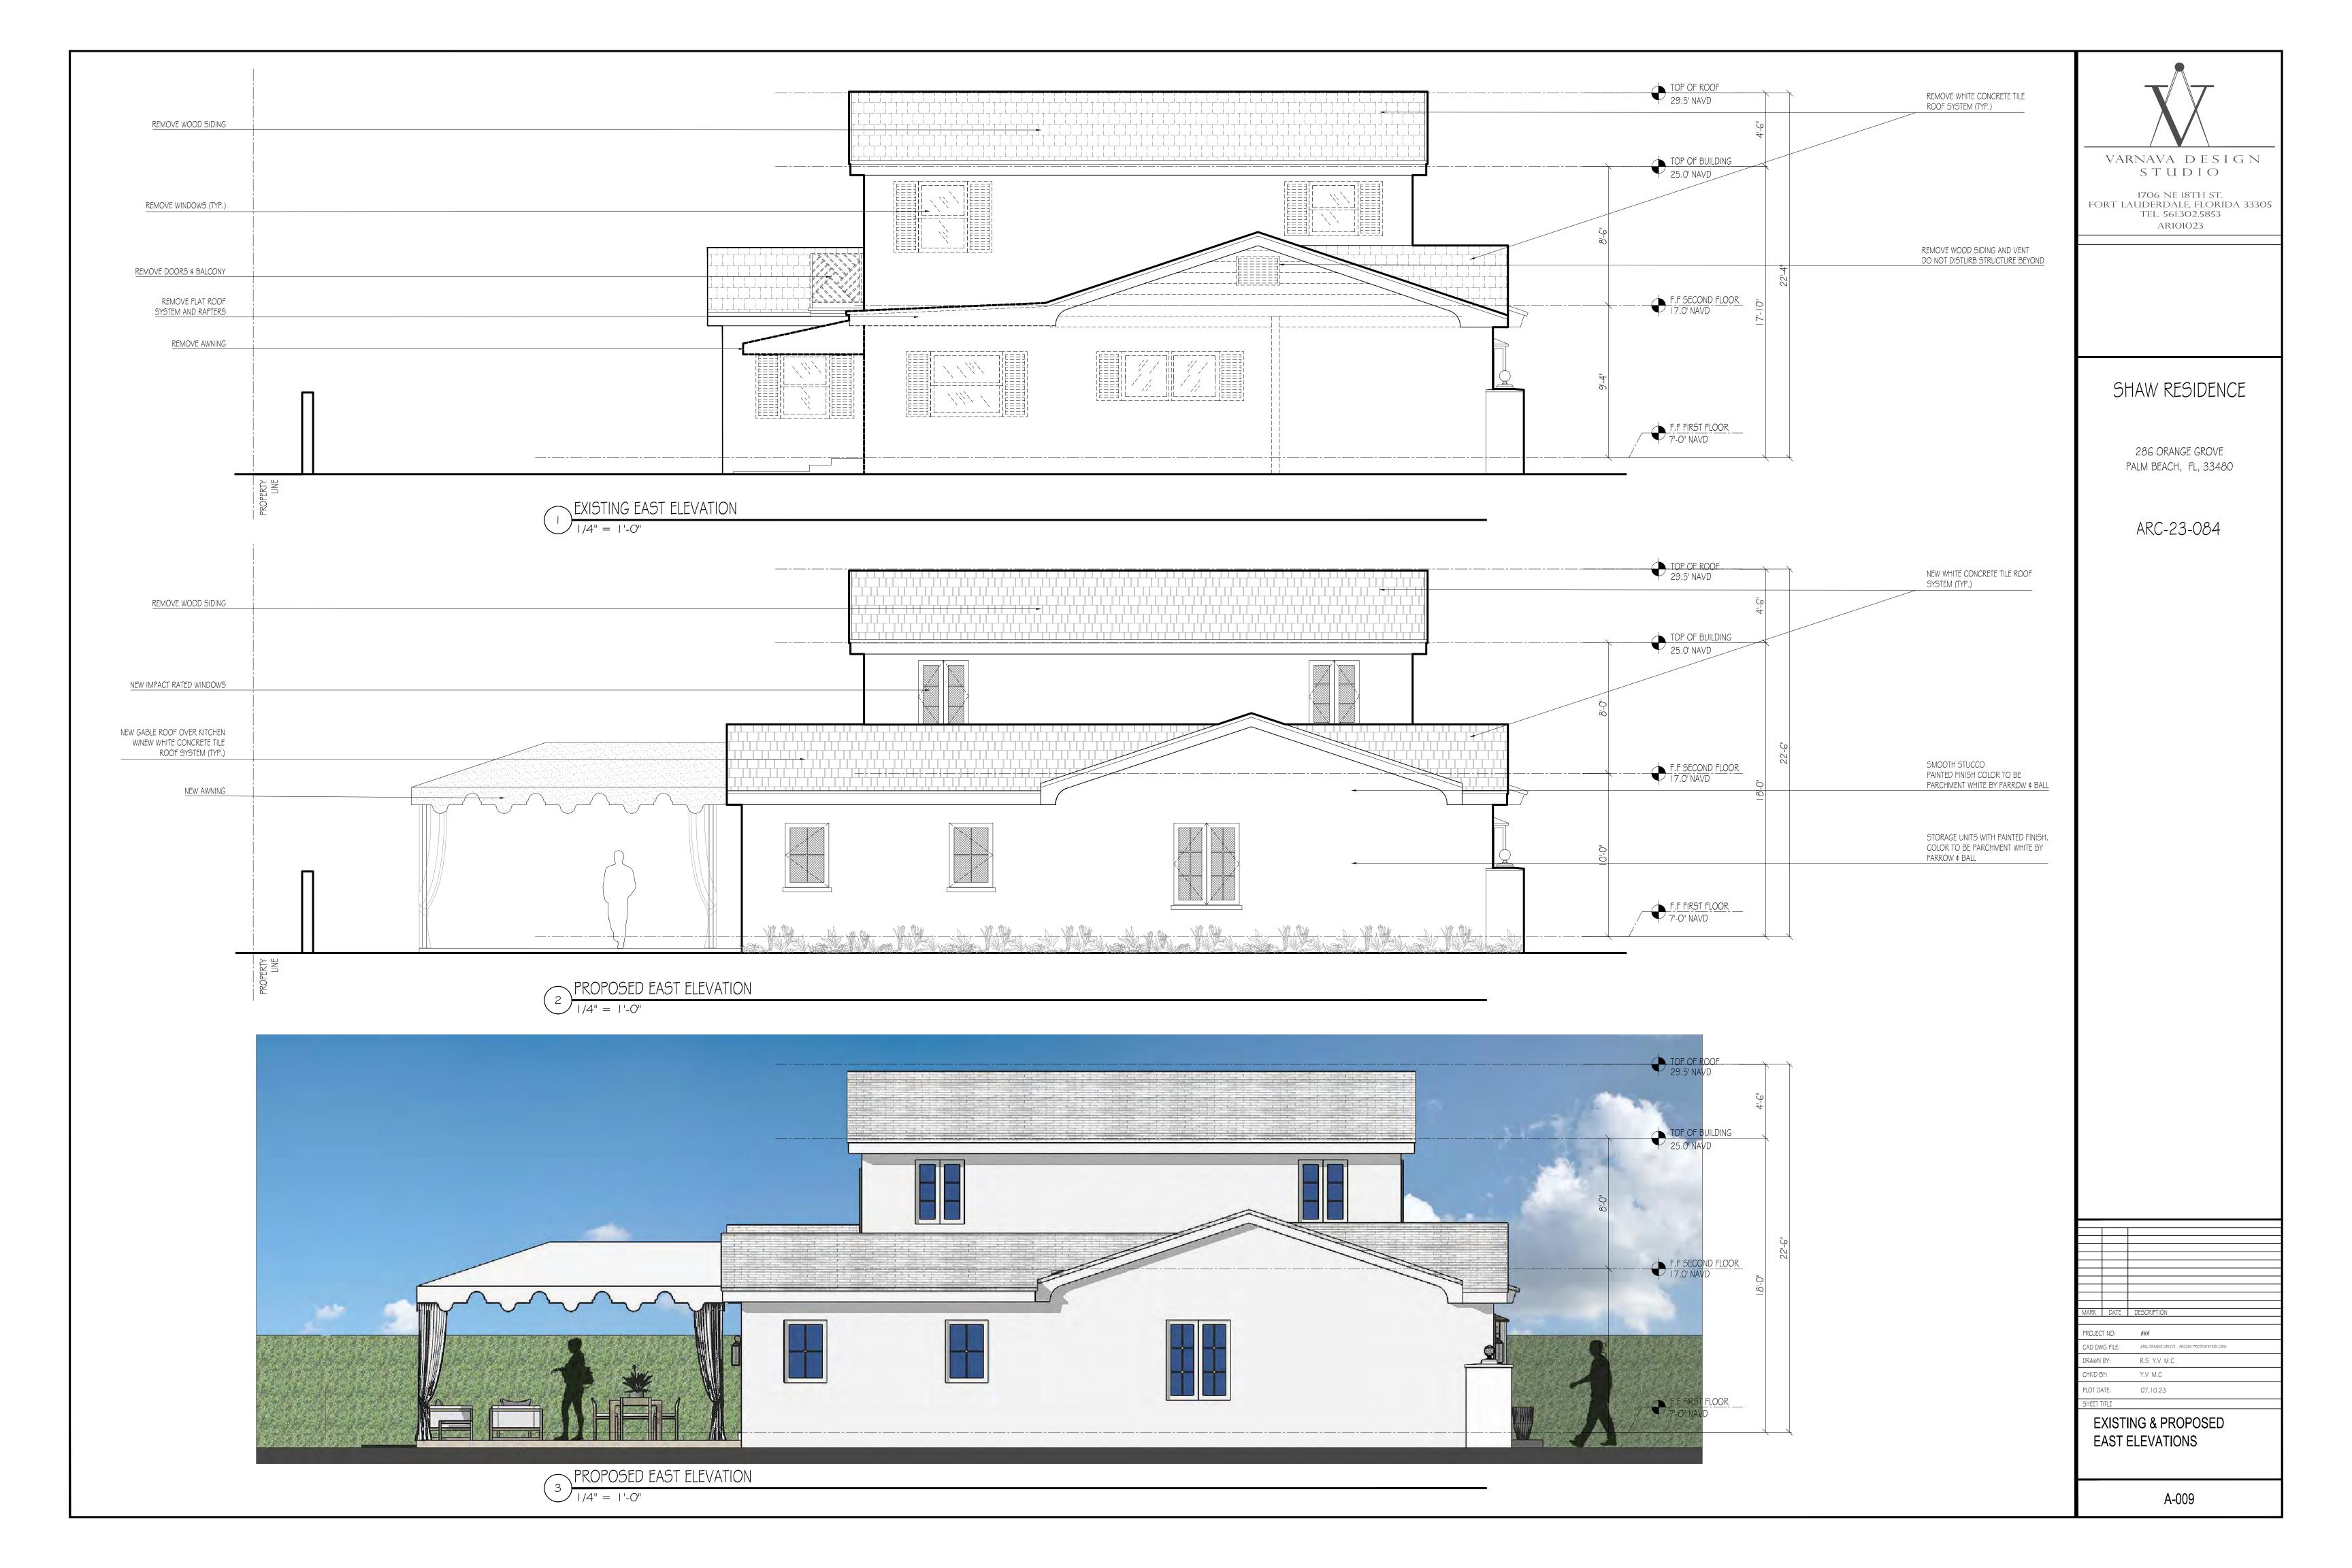


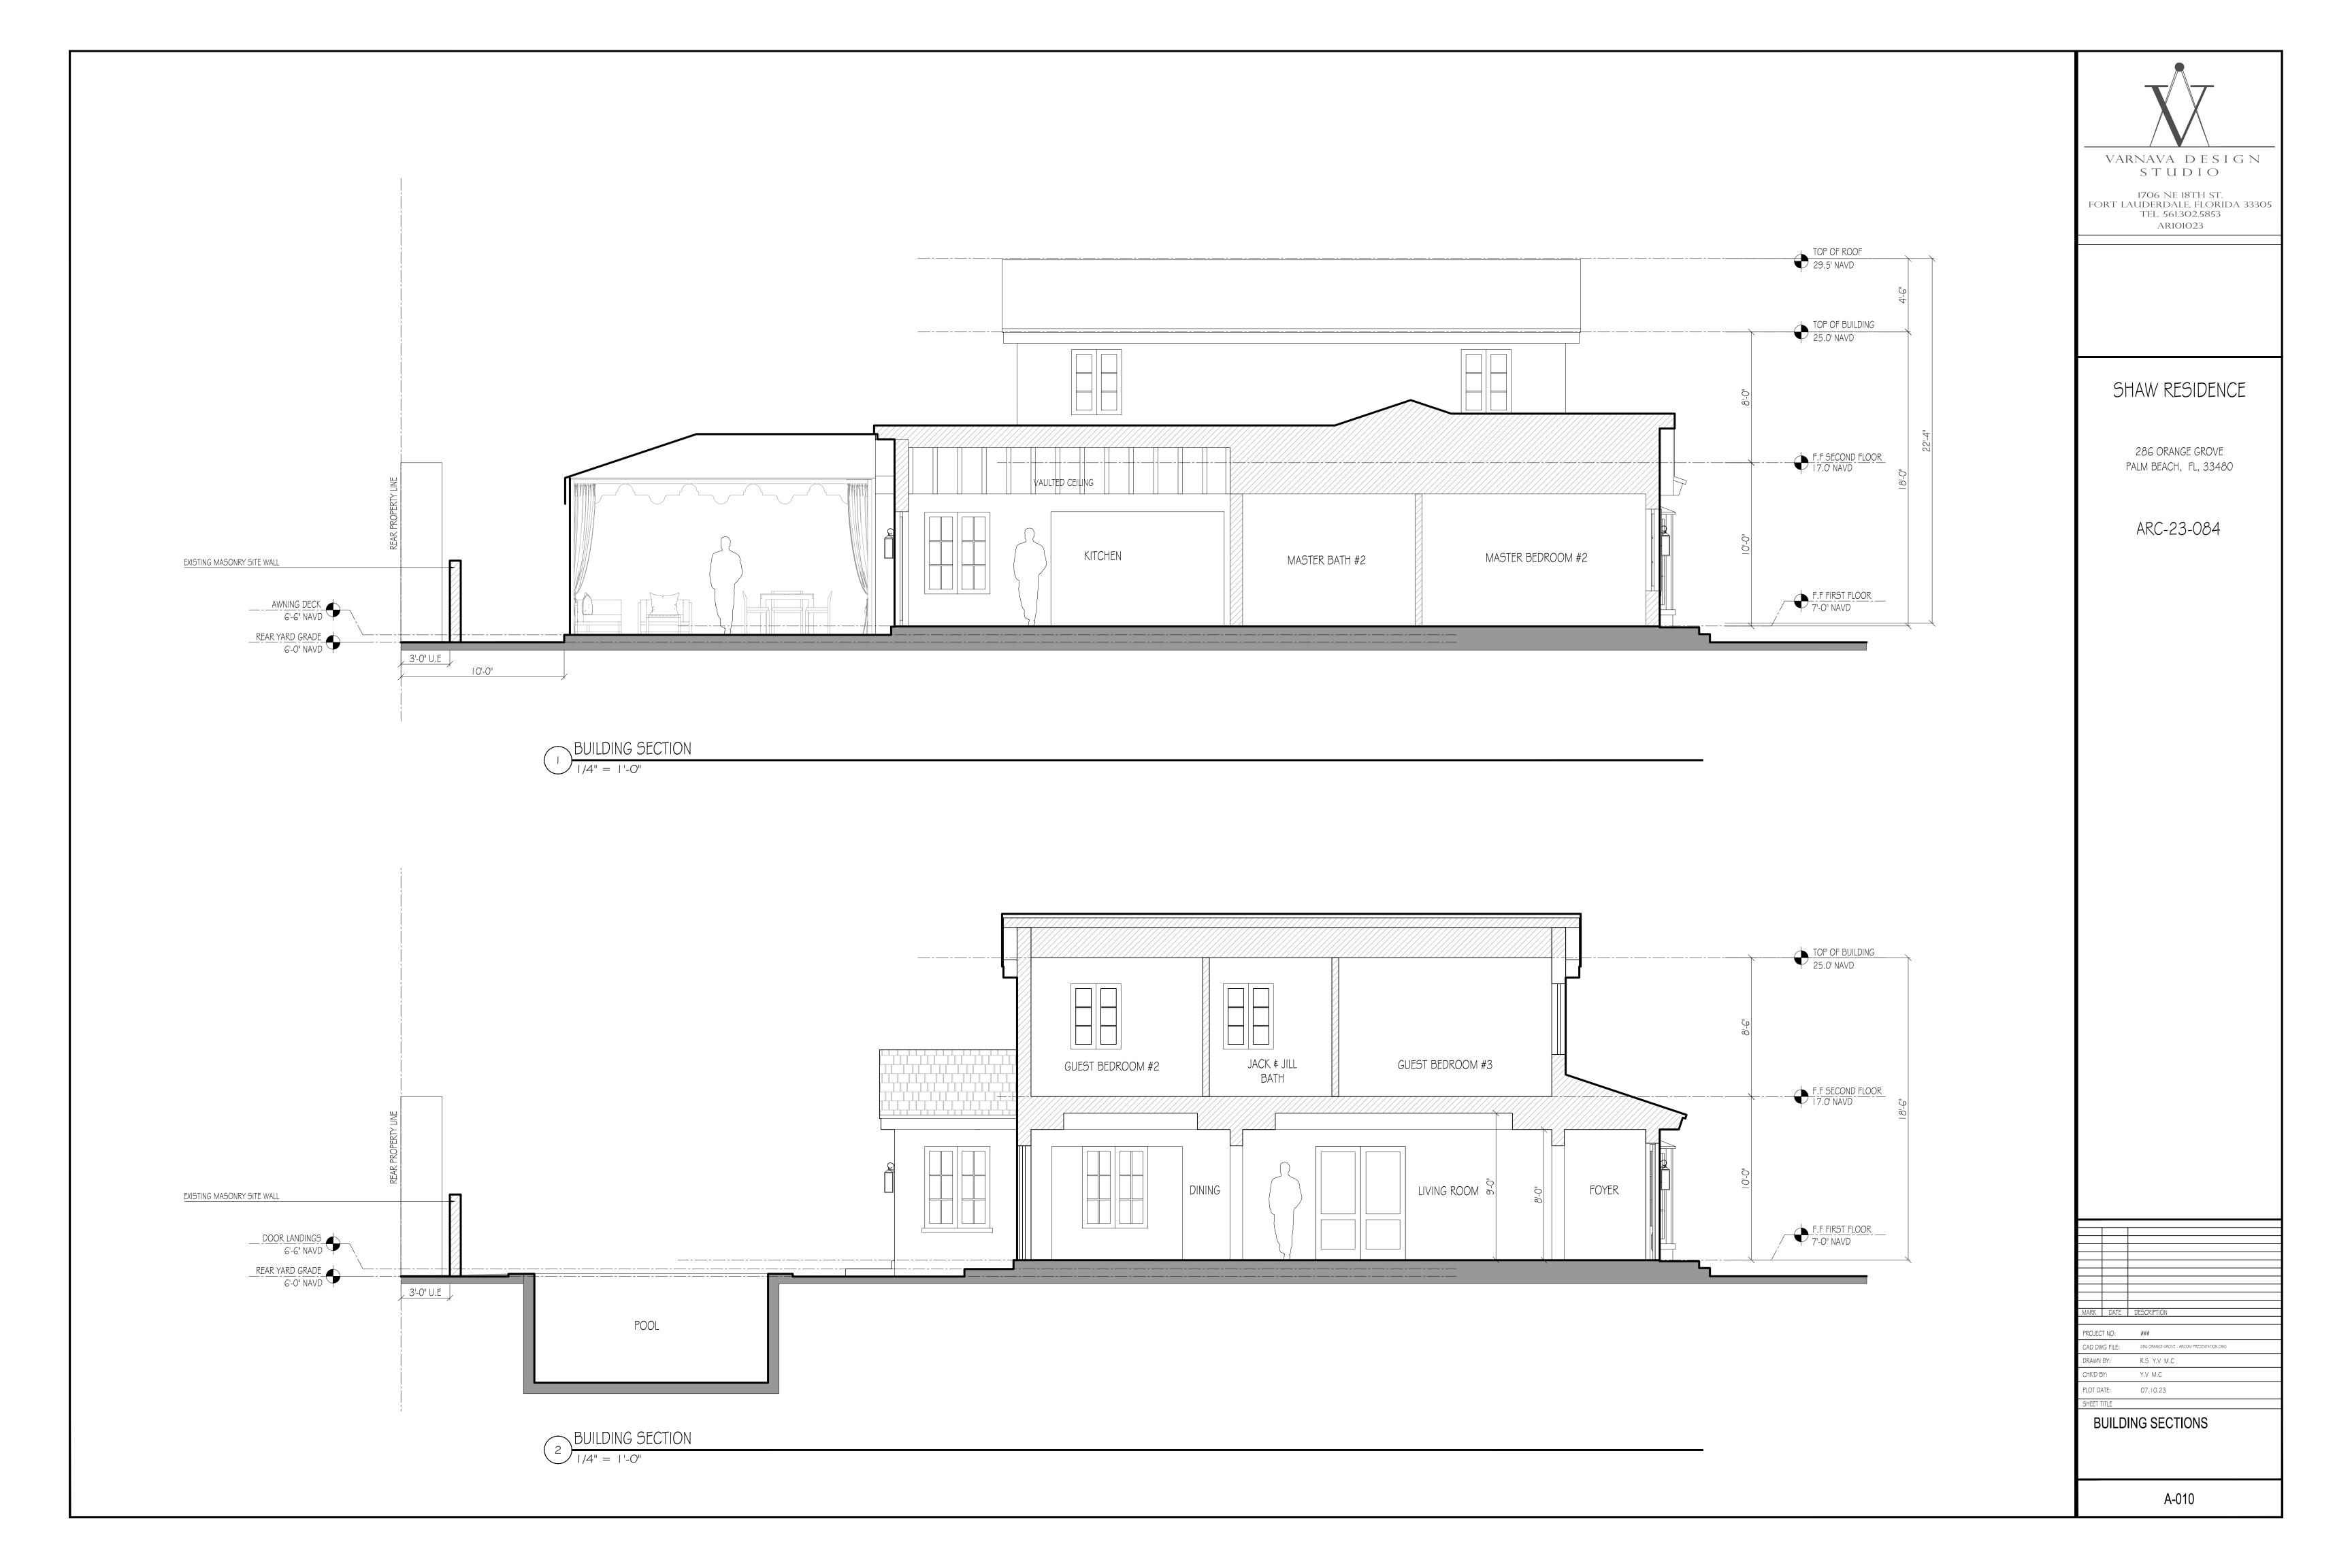


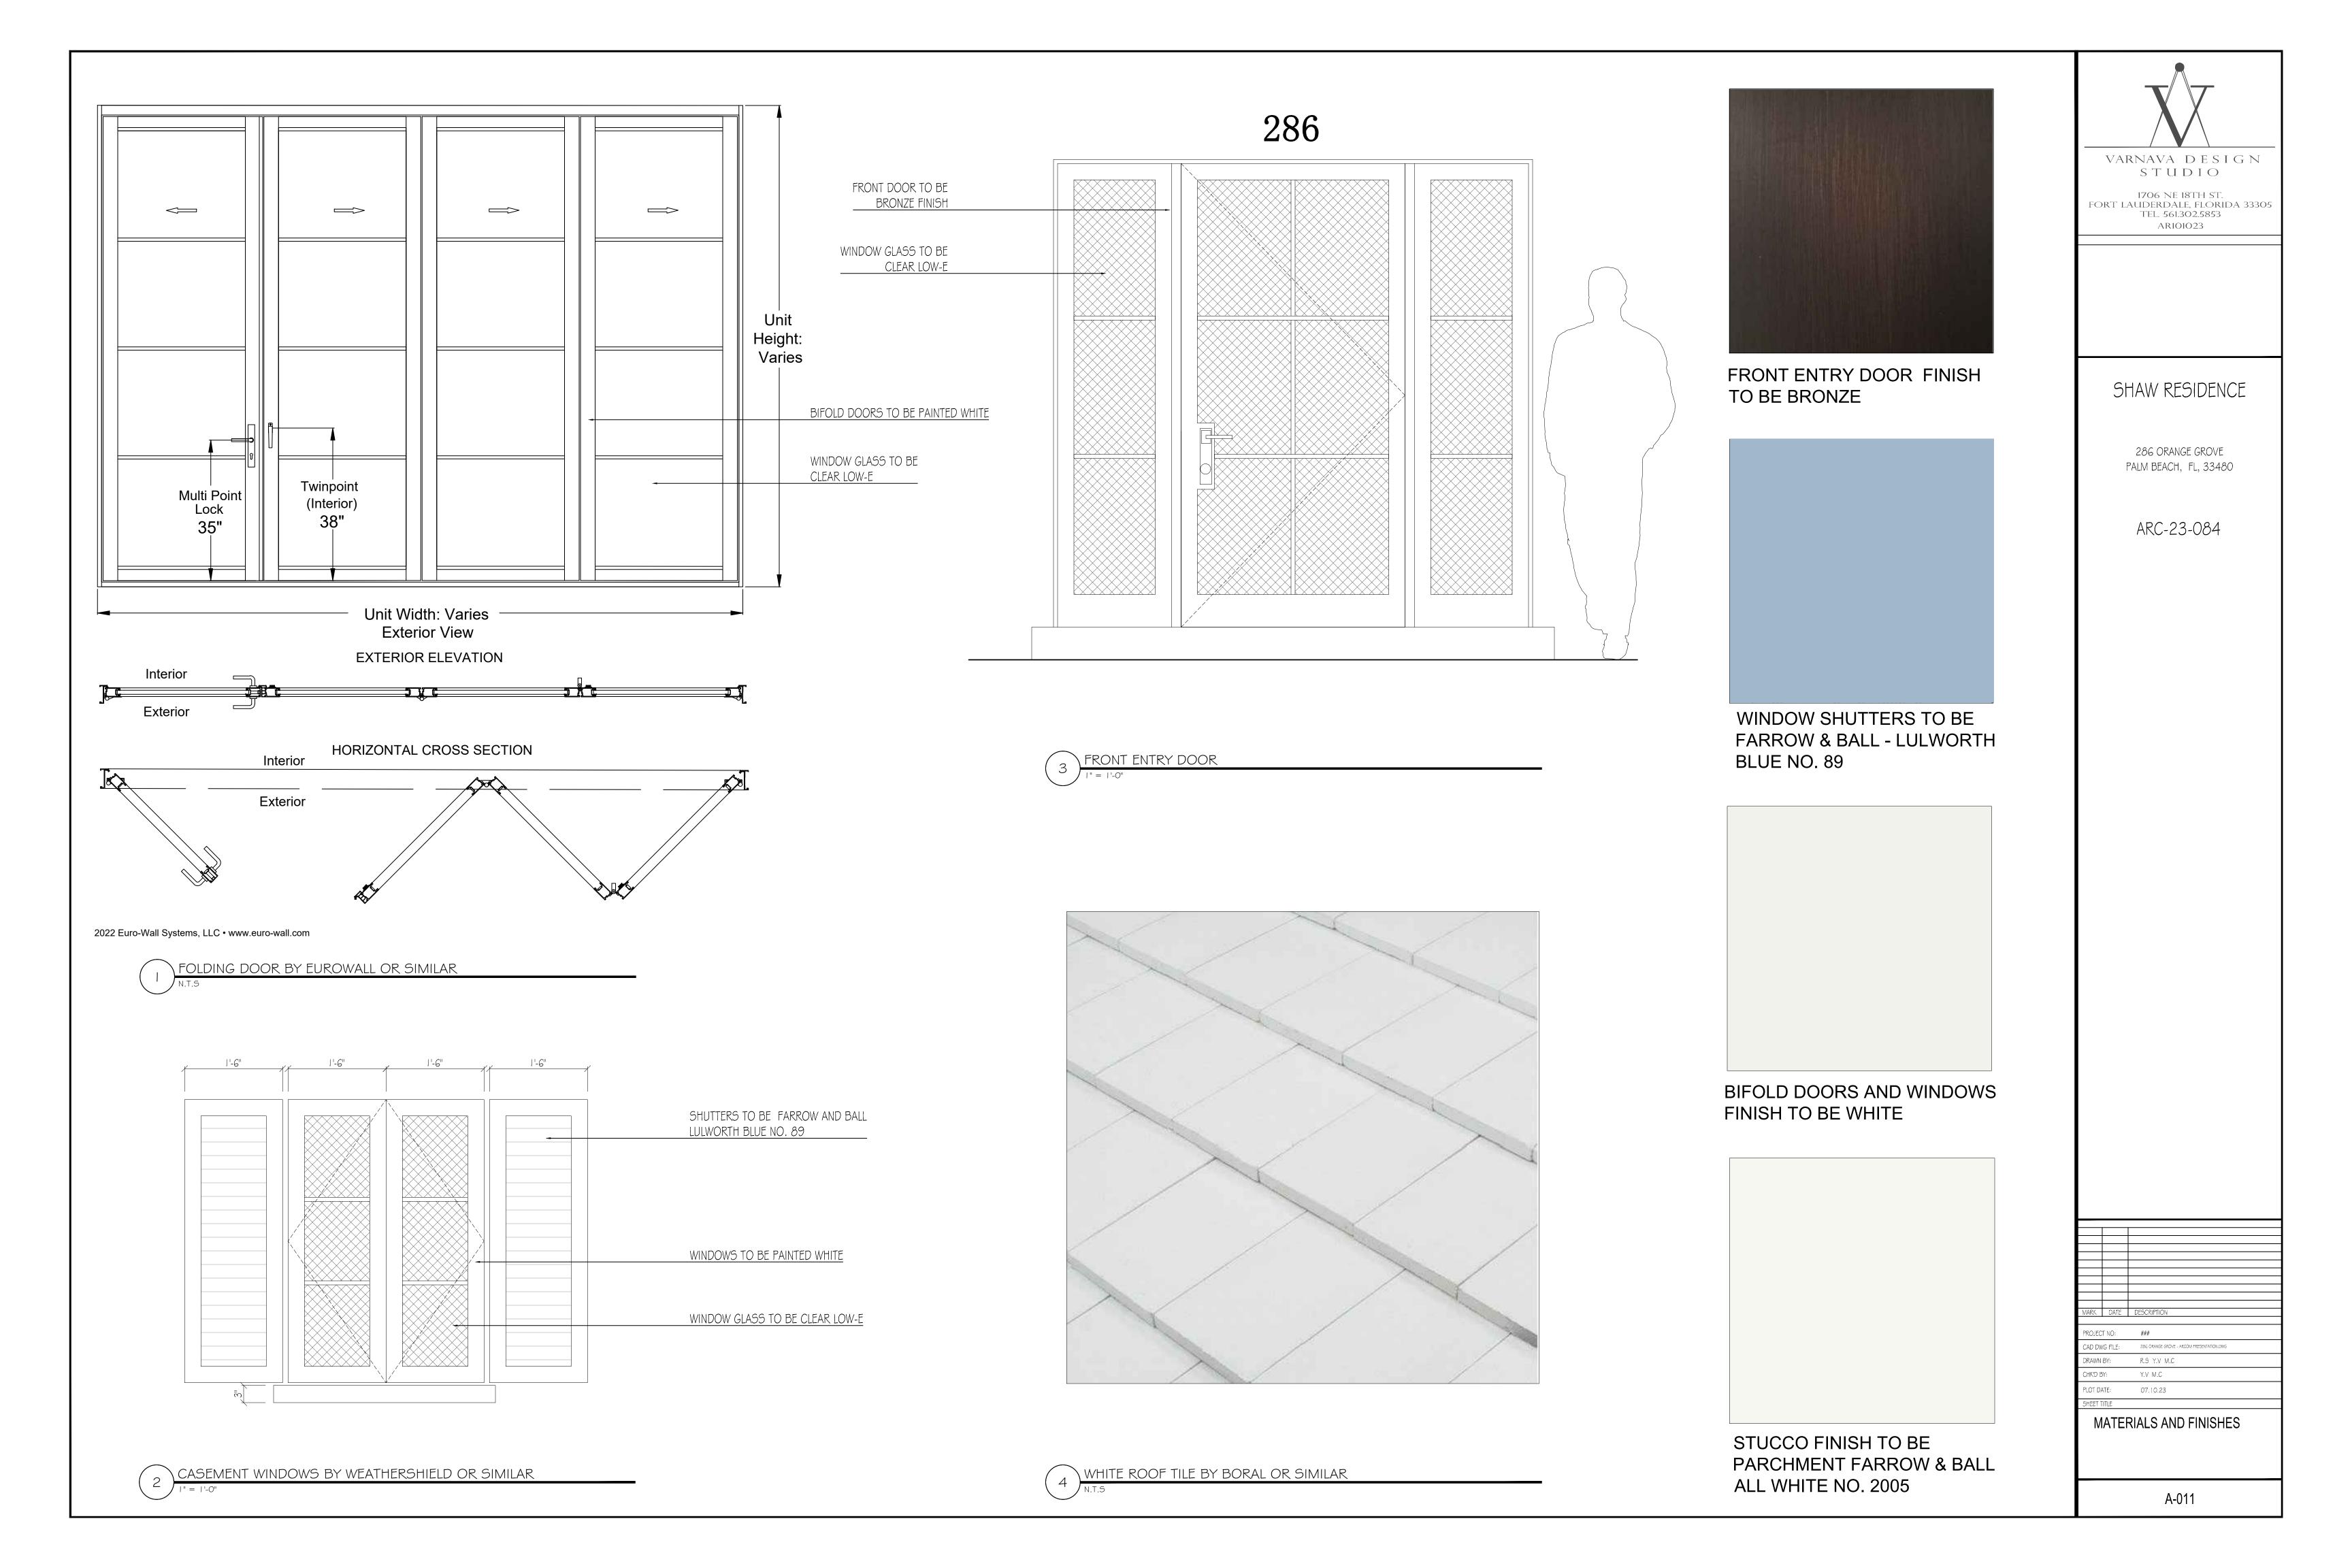














RENDERING OF FRONT FACADE



RENDERING OF FRONT FACADE

N.T.S

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SHAW RESIDENCE

286 ORANGE GROVE PALM BEACH, FL, 33480

ARC-23-084

MARK DATE DESCRIPTION

PROJECT NO: ###

CAD DWG FILE: 285 ORANGE GROVE - ARCOM PREDENTATION DWG

DRAWN BY: R.5 Y.V M.C

CHKD BY: Y.V M.C

PLOT DATE: 07.10.23

SHEET TITLE

RENDERINGS

A-012



RENDERING OF REAR YARD AND AWNING



RENDERING OF REAR YARD AND AWNING
N.T.S

VARNAVA DESIGN STUDIO

1706 NE 18TH ST. FORT LAUDERDALE, FLORIDA 33305 TEL. 561.302.5853 Ario1023

SHAW RESIDENCE

286 ORANGE GROVE PALM BEACH, FL, 33480

ARC-23-084

MARK DATE DESCRIPTION

PROJECT NO: ###

CAD DWG FILE: 285 ORANGE GROVE - ARCOM PRESENTATION DWG

DRAWN BY: R.S. Y.V. M.C.

CHKD BY: Y.V. M.C.

PLOT DATE: 07.10.23

SHEET TITLE

RENDERINGS

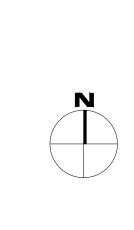
A-013



SHAW RESIDENCE

286 ORANGE GROVE PALM BEACH, FL, 33480


ARC-23-084






A-014


#### ORANGE GROVE

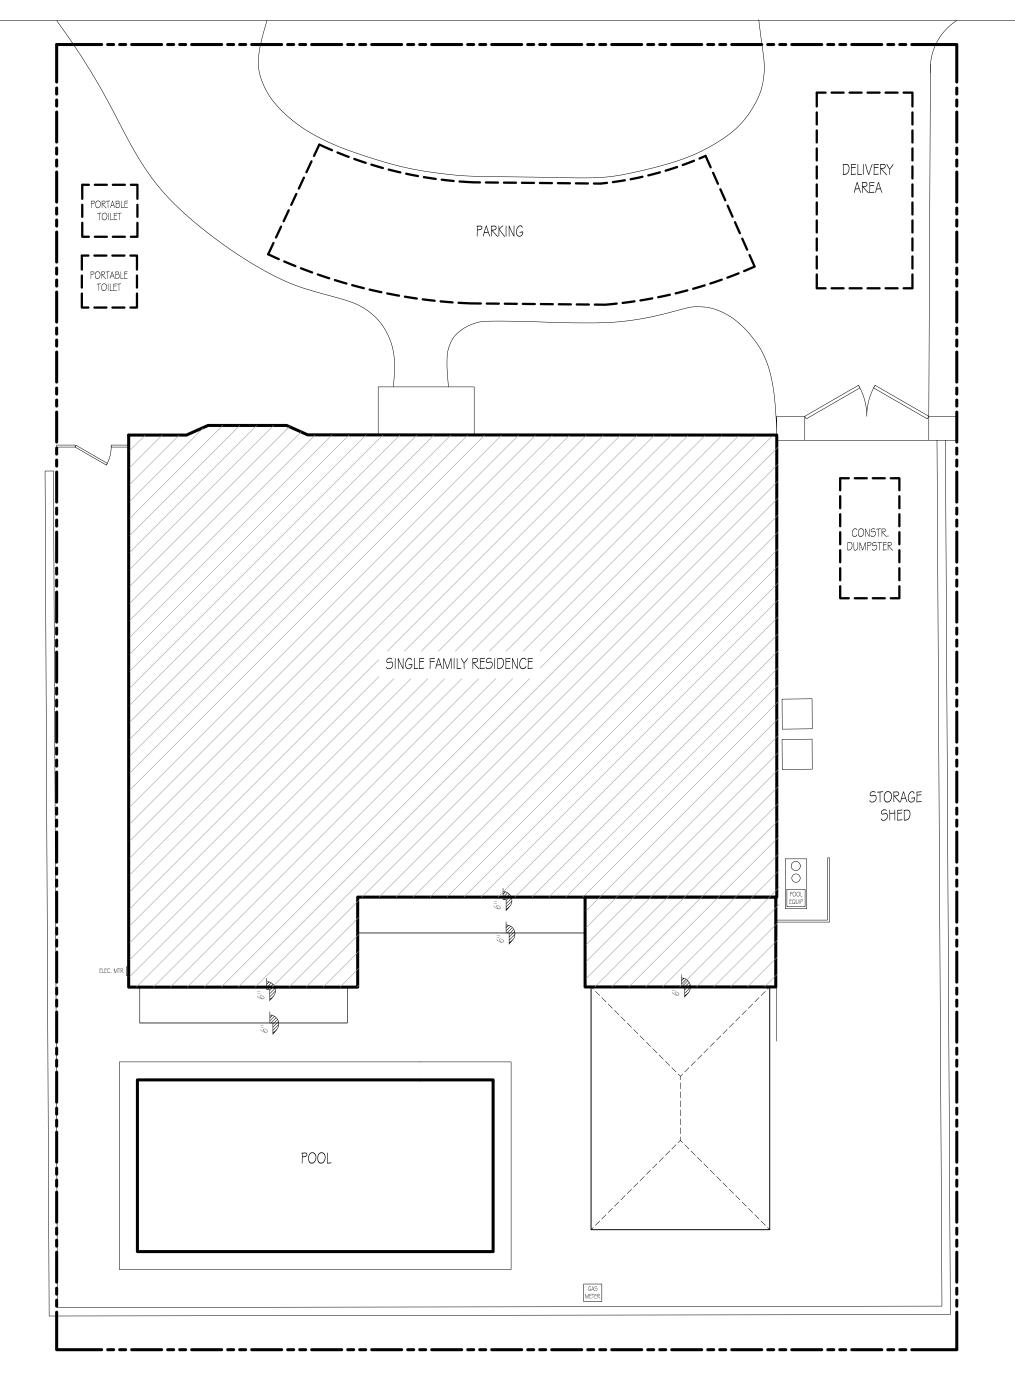

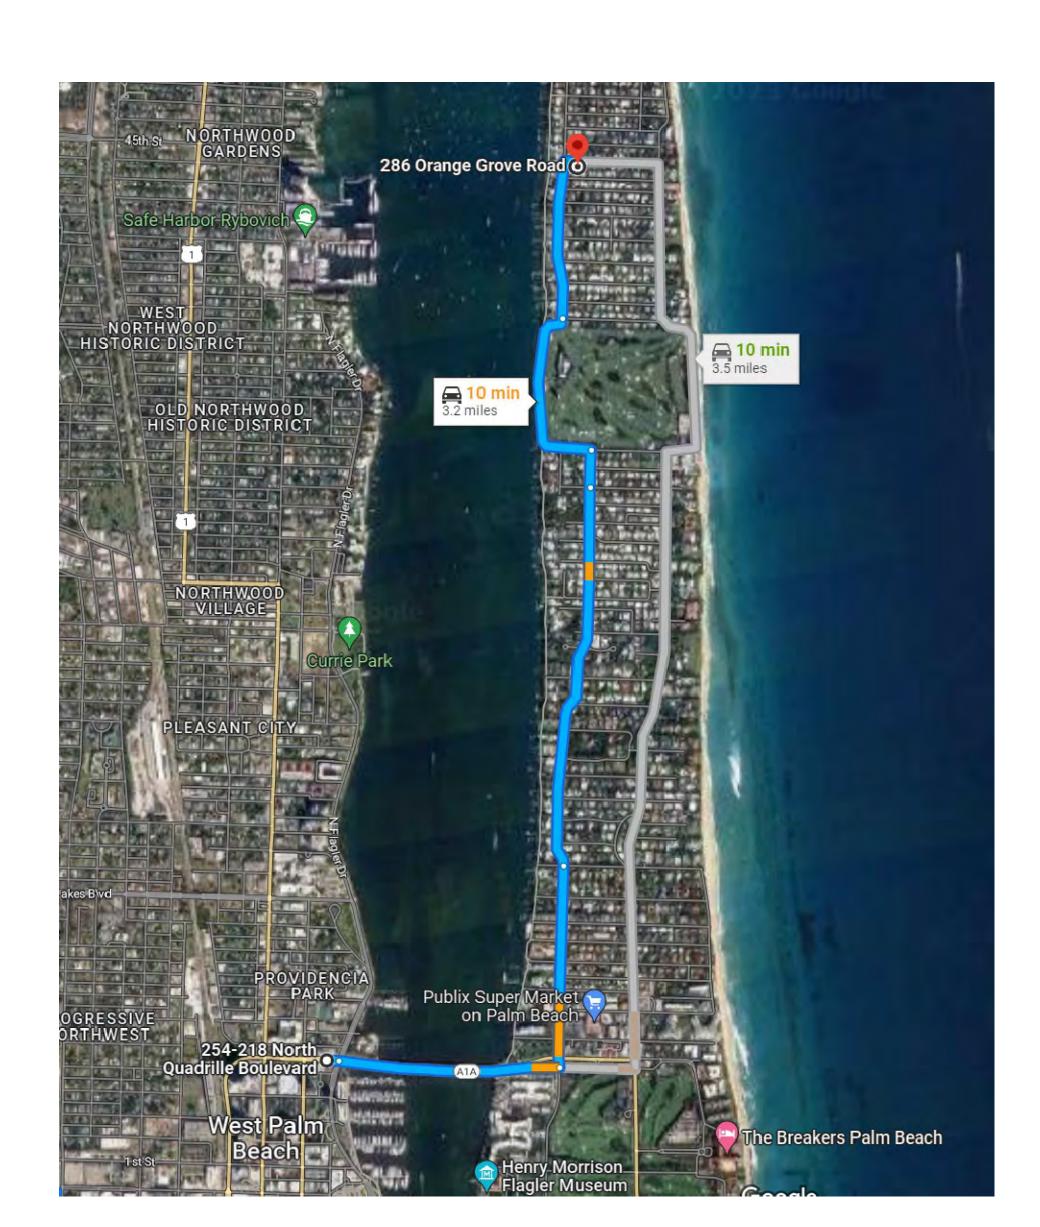

# ORANGE GROVE ------SILT FENCE (SEE DETAIL) (SEE DETAIL) SINGLE FAMILY RESIDENCE SINGLE FAMILY RESIDENCE COVERED PORCH STORAGE SHED SILT FENCE (SEE DETAIL) SILT FENCE (SEE DETAIL) POOL SILT FENCE (SEE DETAIL)

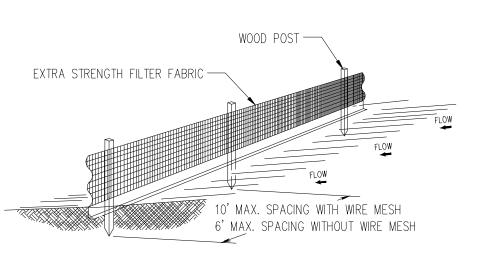CONSTRUCTION SCREENING PLAN



#### Notes

1) The height of a silt fence shall not exceed 36".

Filter fabric shall be purchased in a continuous roll cut to the length of the barrier to avoid the use of joints.

3) Posts shall be spaced a maximum of 10' apart at the barrier location and driven securely into the ground a minimum of 12". When extra strength fabric is used without the wire support fence, post spacing shall not

4) A trench shall be excavated approximately 4" wide and 4" deep along the line of posts and upslope from the barrier.

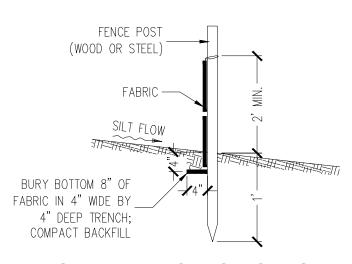
5) When standard strength filter fabric is used, a wire mesh support fence shall be fastened securely to the upslope side of the posts using heavy duty wire staples at least 1" long, tie wires, or hog rings. The wire shall extend into the trench a minimum of 2" and shall not extend more than 36" above the original ground surface.

6) The standard strength filter fabric shall be stapled or wired to the fence, and 8" of the fabric shall be extended into the trench. The fabric shall not extend more than 36" above the original ground surface.


7) The trench shall be backfilled and the soil compacted over the filter

#### SILT FENCE DETAIL

N.T.S.



### SILT FENCE SECTION N.T.S.

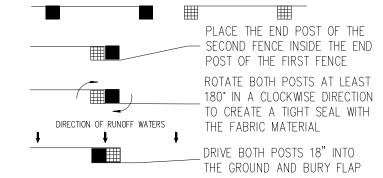

## ATTACHING TWO SILT FENCES N.T.S.

#### Notes:

 Contractor is responsible for installing and maintaining erosion control measures during construction.

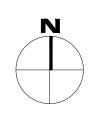
 Contractor to investigate condition of existing sewer service prior to building permit submittal. If existing service is cast iron, or in poor condition, service will be replaced to main per Town of Palm Beach standards.



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CHK'D E	Y:	Y.V M.C	
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SHEET T	TTLE		
CONSTRUCTION SCREENING PLAN			

A-014

SCALE AS NOTED