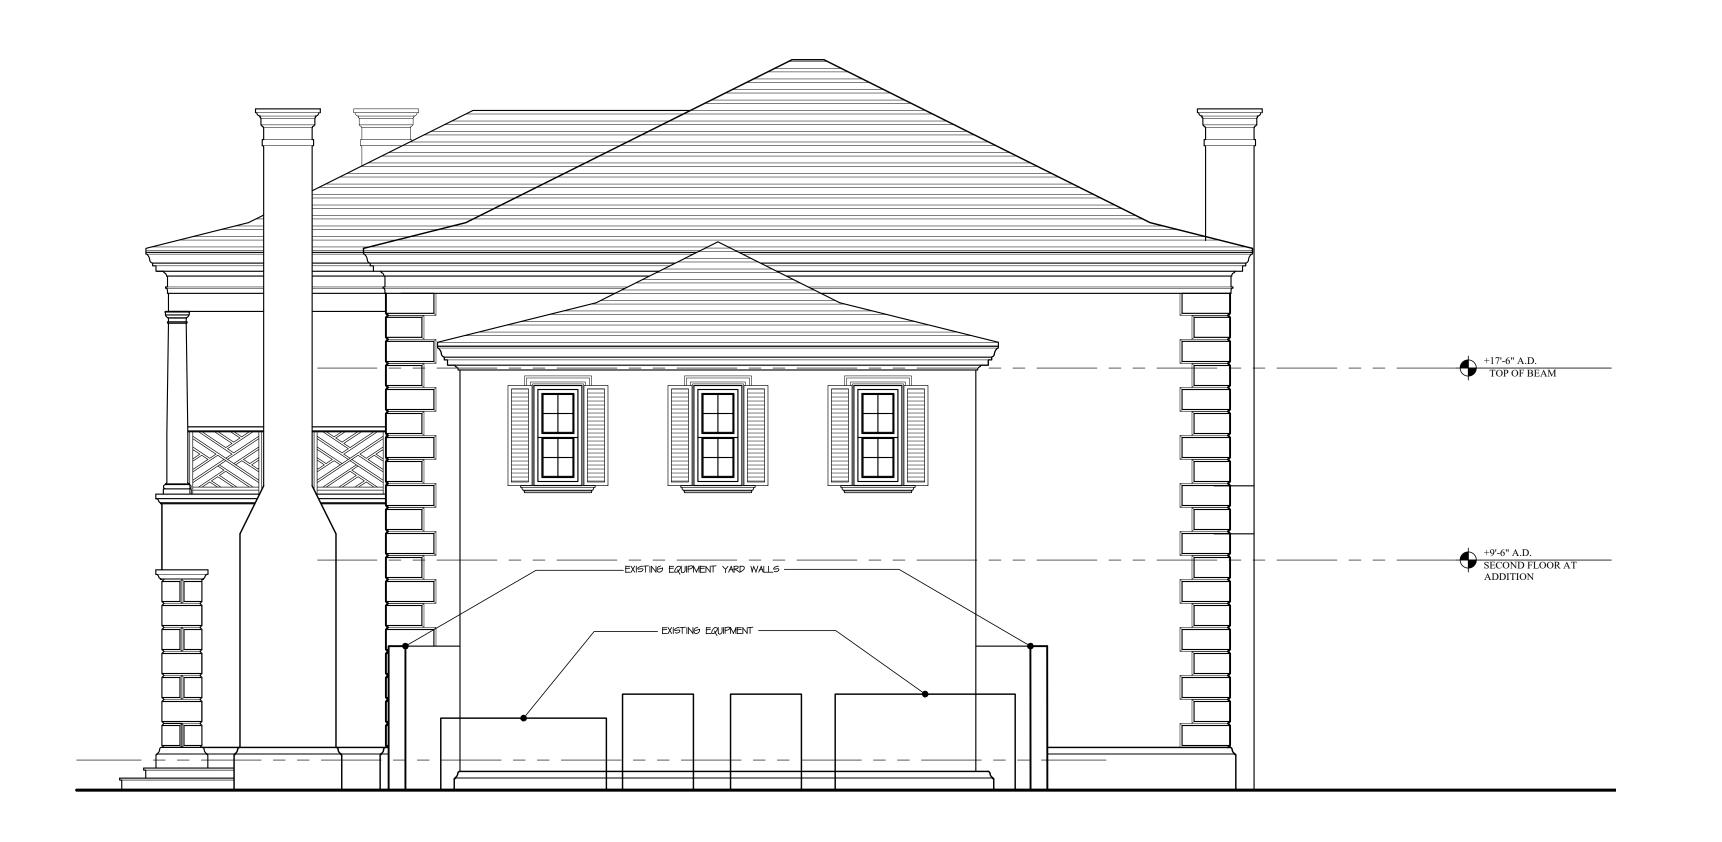


### PREVIOUSLY PROPOSED SOUTH ELEVATION

SCALE: 1/4"=1'-0"



CURRENTLY PROPOSED SOUTH ELEVATION

SCALE: 1/4"=1'-0"



I/6 SEMINOLE AVENUE
PALM BEACH, FLORIDA

D M O D F A D C HITE C T C I N

FLORIDA AAC

S

NO. 001285

HAROLD J. SMITH
REGISTERED ARCHITECT 8742

JONATHAN C. MOORE REGISTERED ARCHITECT 13541

PETER G. PAPADOPOULOS
REGISTERED ARCHITECT 92952

DANIEL KAHAN
REGISTERED ARCHITECT 94757

PRE-APP SUBMITTAL 2022-12-27 FIRST SUBMITTAL 2023-01-05

NO:
DWG. BY: DK
SHEET:

[A-200A



### EXISTING WEST ELEVATION

SCALE: 1/4"=1'-0"



PREVIOUSLY PROPOSED

PROPOSED WEST ELEVATION

SCALE: 1/4"=1'-0"



176 SEMINOLE AVENUE
PALM BEACH, FLORIDA

FLORIDA AAC

S

NO. 001285

HAROLD J. SMITH
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PETER G. PAPADOPOULOS
REGISTERED ARCHITECT 92952

DANIEL KAHAN REGISTERED ARCHITECT 94757

PRE-APP SUBMITTAL 2022-12-27 FIRST SUBMITTAL 2023-01-05

23-041

NO:
DWG. BY: DK
SHEET:

A-20



### PREVIOUSLY PROPOSED WEST ELEVATION

SCALE: 1/4"=1'-0"



CURRENTLY PROPOSED WEST ELEVATION

SCALE: 1/4"=1'-0"



NEW ADDITION
176 SEMINOLE AVENUE
PALM BEACH, FLORIDA
ND MOORE ARCHITECTS, IN C.

FLORIDA AAC

NO. 001285

S

HAROLD J. SMITH REGISTERED ARCHITECT 8742

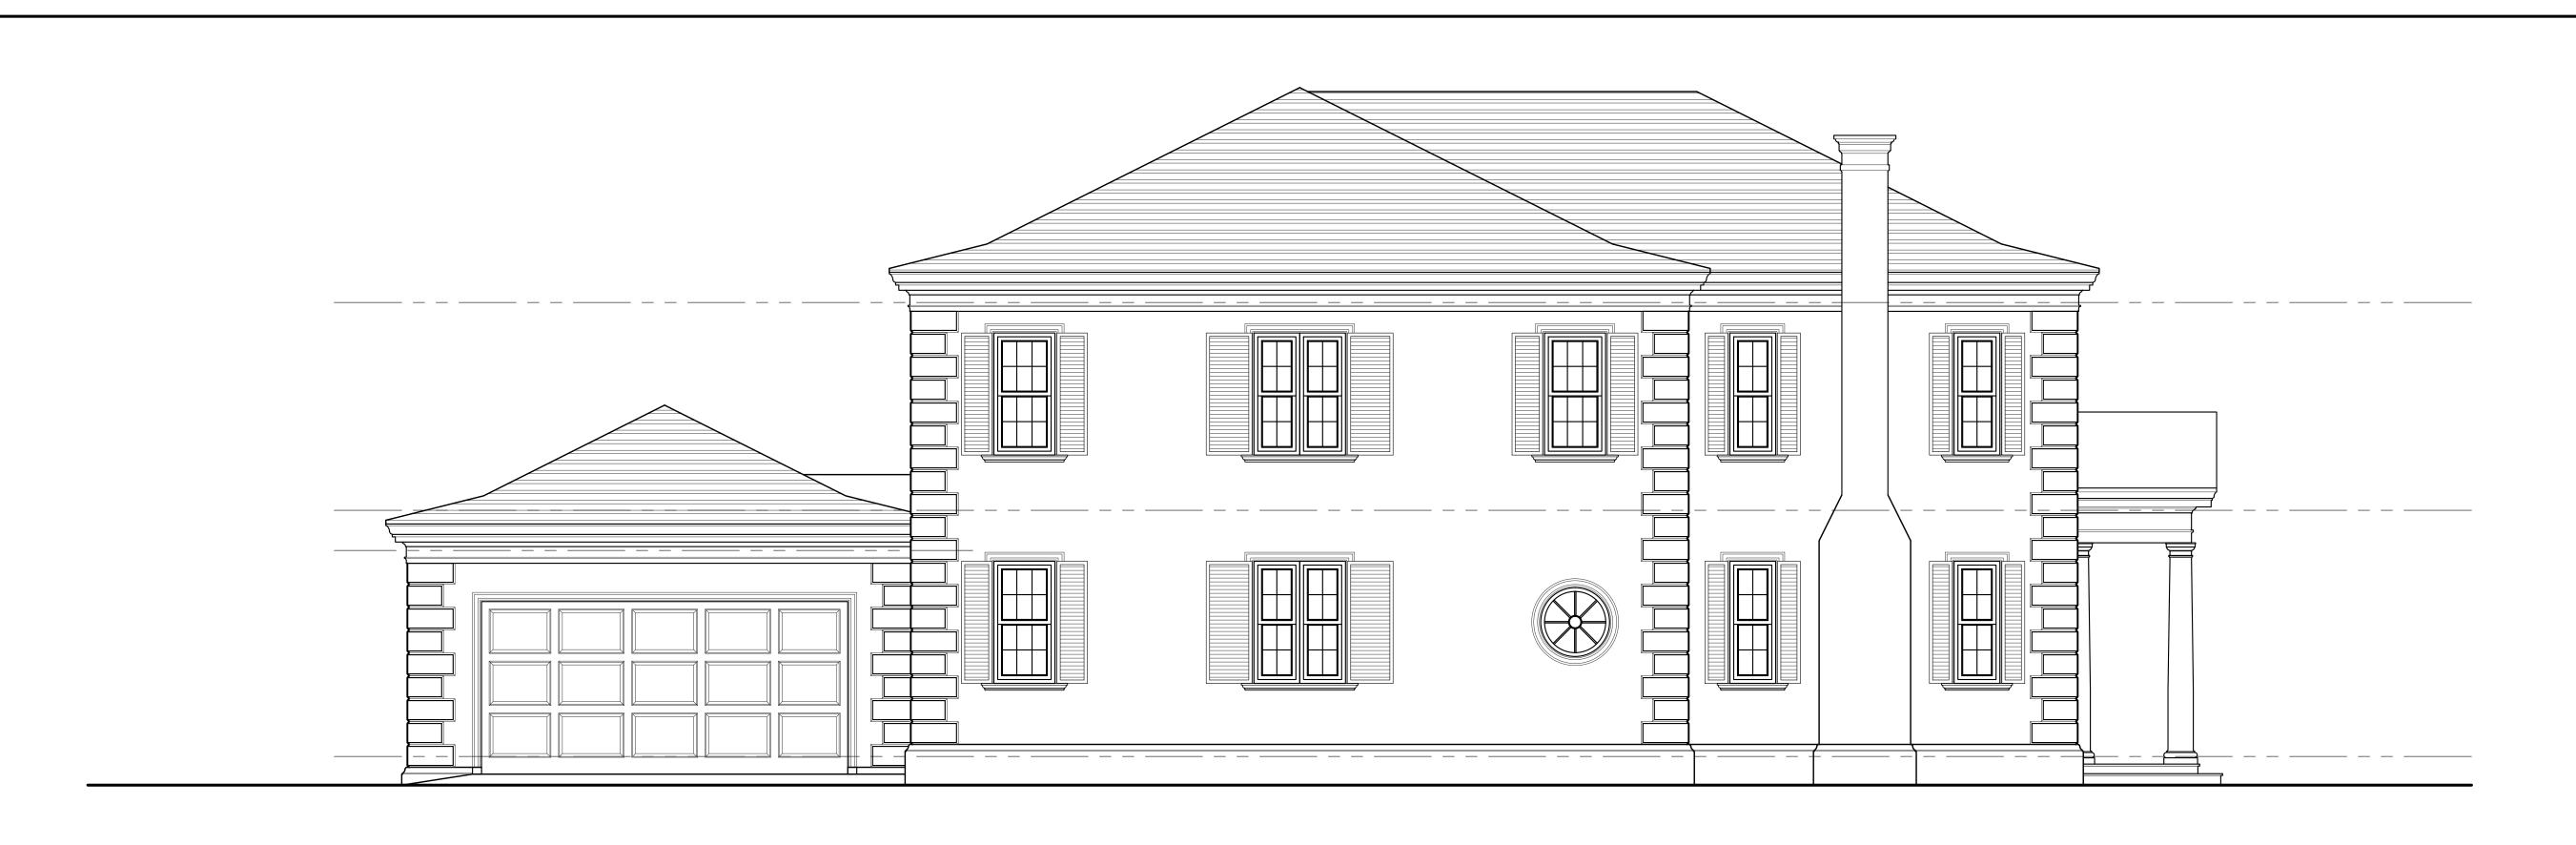
JONATHAN C. MOORE REGISTERED ARCHITECT 13541 PETER G. PAPADOPOULOS REGISTERED ARCHITECT 92952

DANIEL KAHAN REGISTERED ARCHITECT 94757

PRE-APP SUBMITTAL 2022-12-27 FIRST SUBMITTAL 2023-01-05

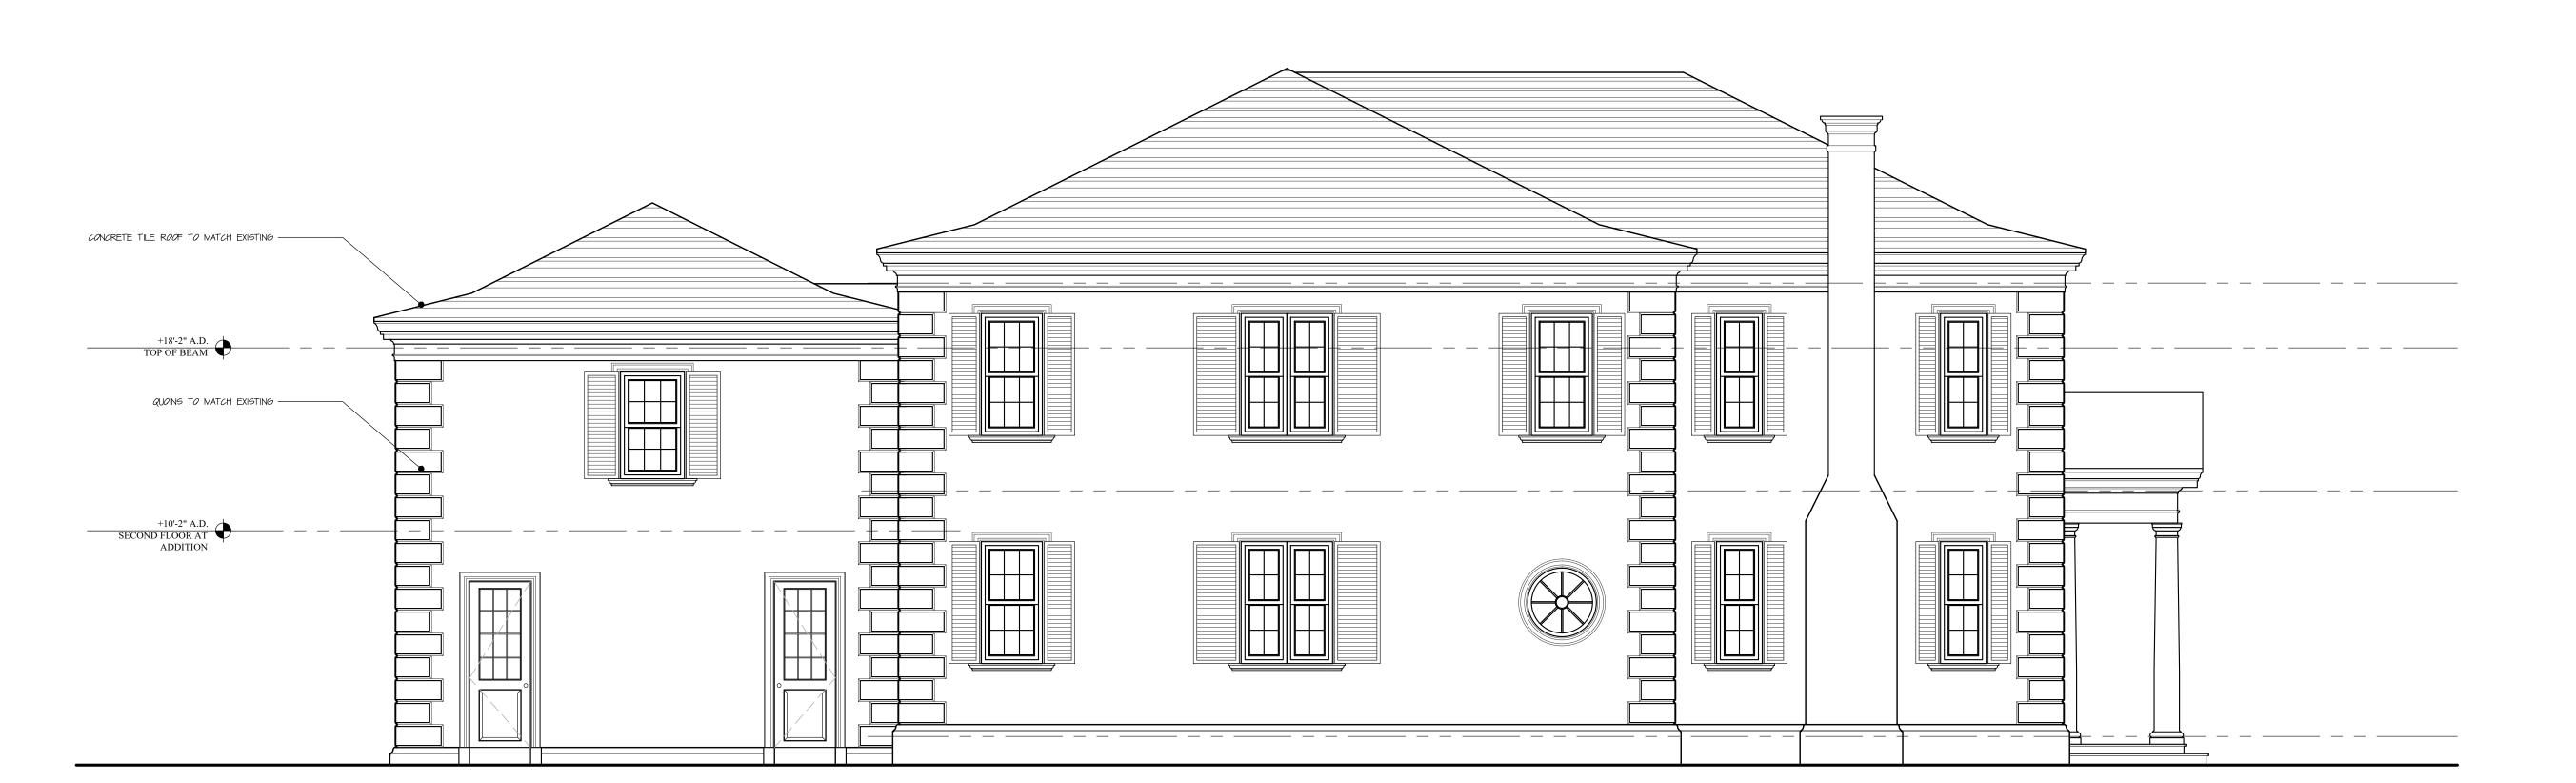
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DWG. BY: DK
SHEET:

| Sel | A-201



### EXISTING EAST ELEVATION

SCALE: 1/4"=1'-0"



PREVIOUSLY PROPOSED

PROPOSED EAST ELEVATION

SCALE: 1/4"=1'-0"

S·M

176 SEMINOLE AVENUE
PALM BEACH, FLORIDA

FLORIDA AAC

S

NO. 001285

HAROLD J. SMITH
REGISTERED ARCHITECT 8742

JONATHAN C. MOORE REGISTERED ARCHITECT 13541

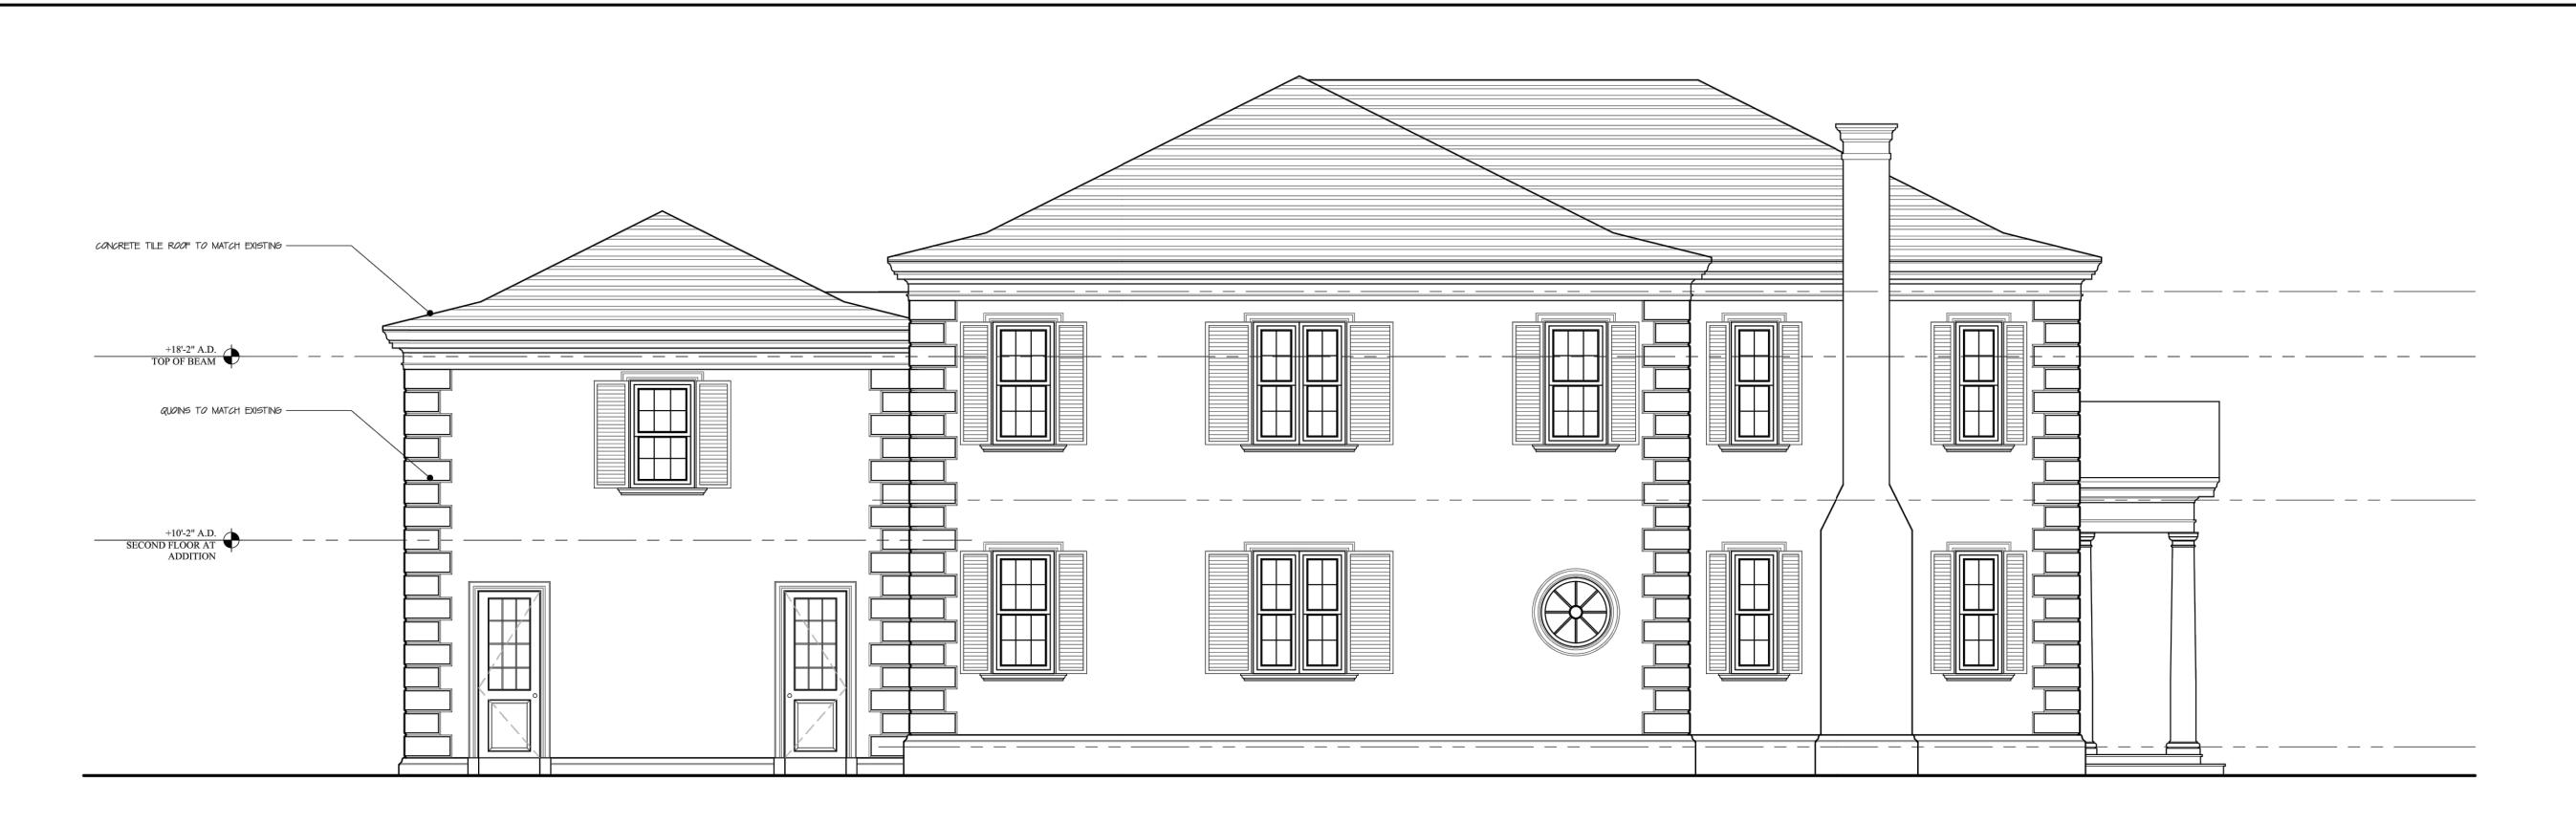
PETER G. PAPADOPOULOS
REGISTERED ARCHITECT 92952

DANIEL KAHAN
REGISTERED ARCHITECT 94757

PRE-APP SUBMITTAL 2022-12-27 FIRST SUBMITTAL 2023-01-05

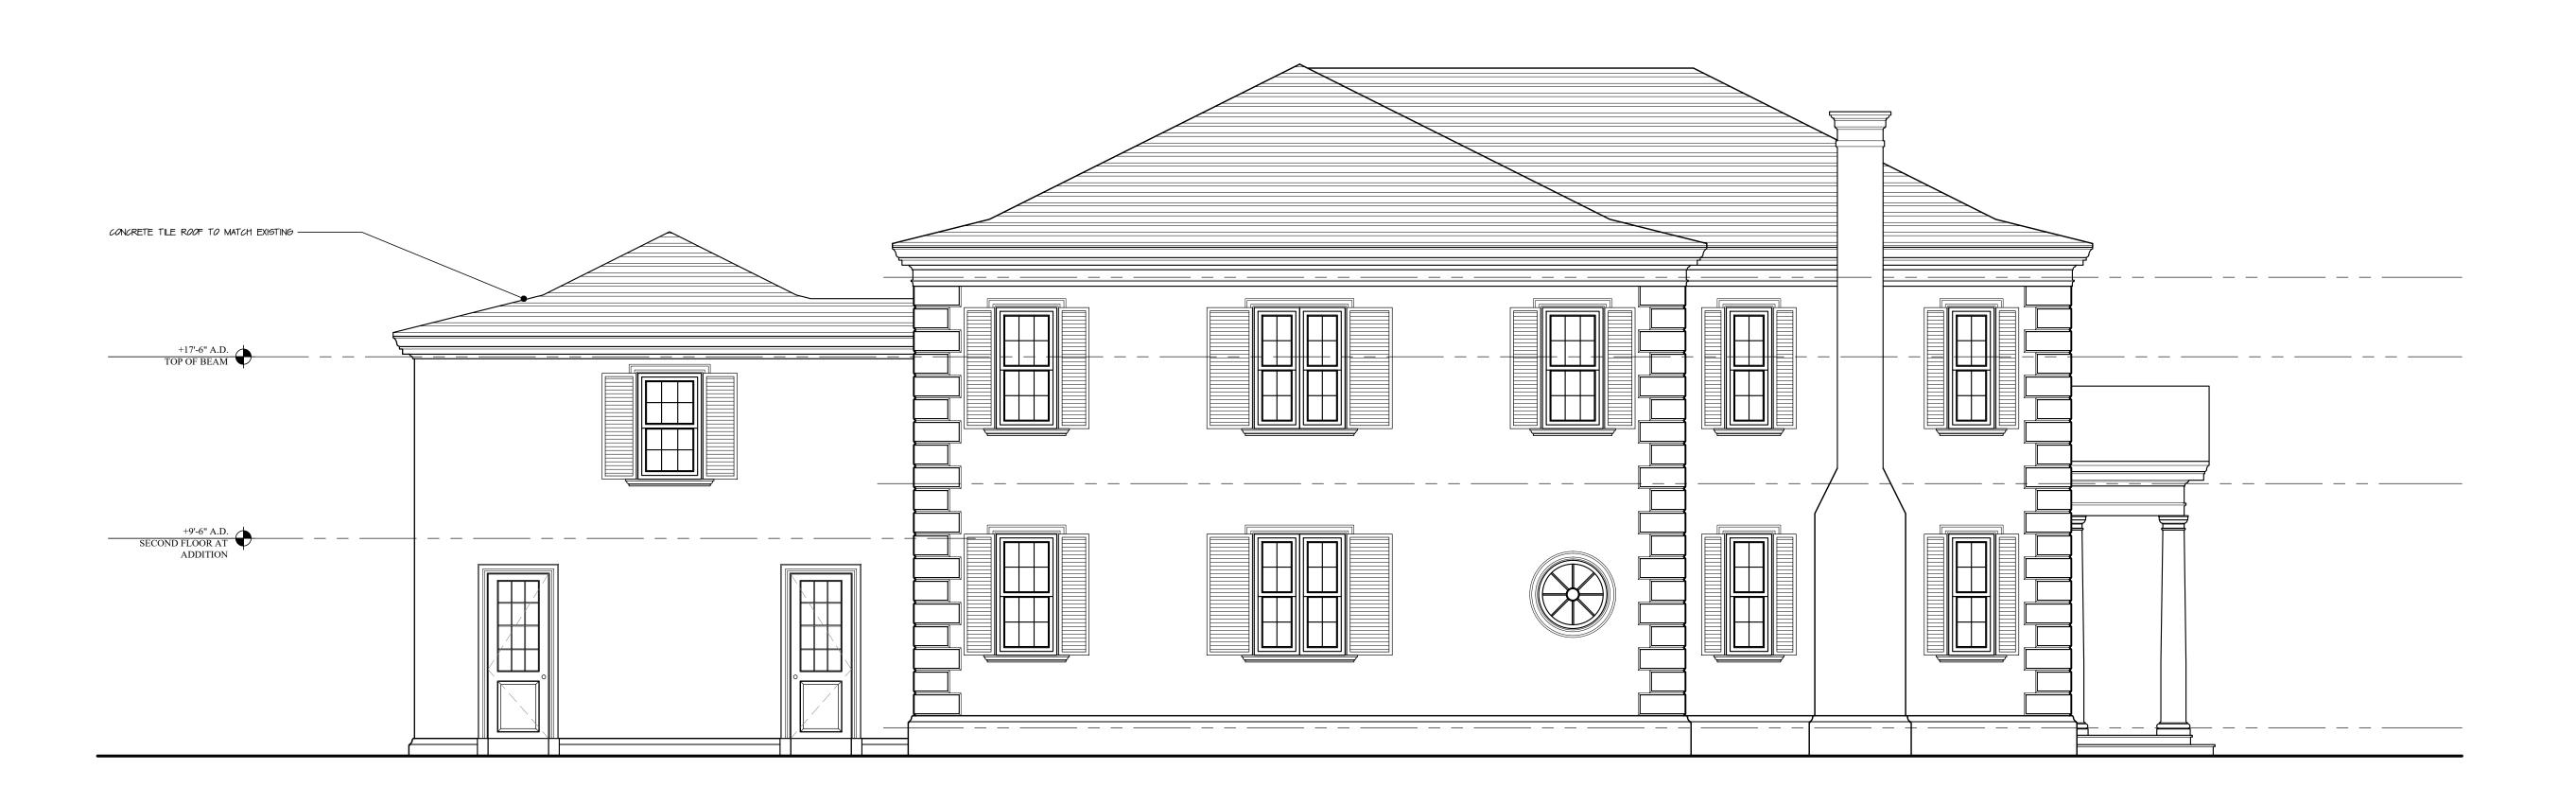
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DWG. BY: DK
SHEET:

A-202



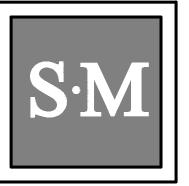
### PREVIOUSLY PROPOSED EAST ELEVATION

SCALE: 1/4"=1'-0"



CURRENTLY PROPOSED EAST ELEVATION

SCALE: 1/4"=1'-0"



NEW ADDITION
176 SEMINOLE AVENUE
PALM BEACH, FLORIDA
1 AND MOORF ARCHITECTS IN

FLORIDA AAC

S

HAROLD J. SMITH REGISTERED ARCHITECT 8742

NO. 001285

JONATHAN C. MOORE REGISTERED ARCHITECT 13541

PETER G. PAPADOPOULOS REGISTERED ARCHITECT 92952

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NO:
DWG. BY: DK
SHEET:



PROPOSED SOUTH SECTION AA

SCALE: 1/4"=1'-0"



176 SEMINOLE AVENUE
PALM BEACH, FLORIDA

FLORIDA AAC

AND

NO. 001285 HAROLD J. SMITH REGISTERED ARCHITECT 8742

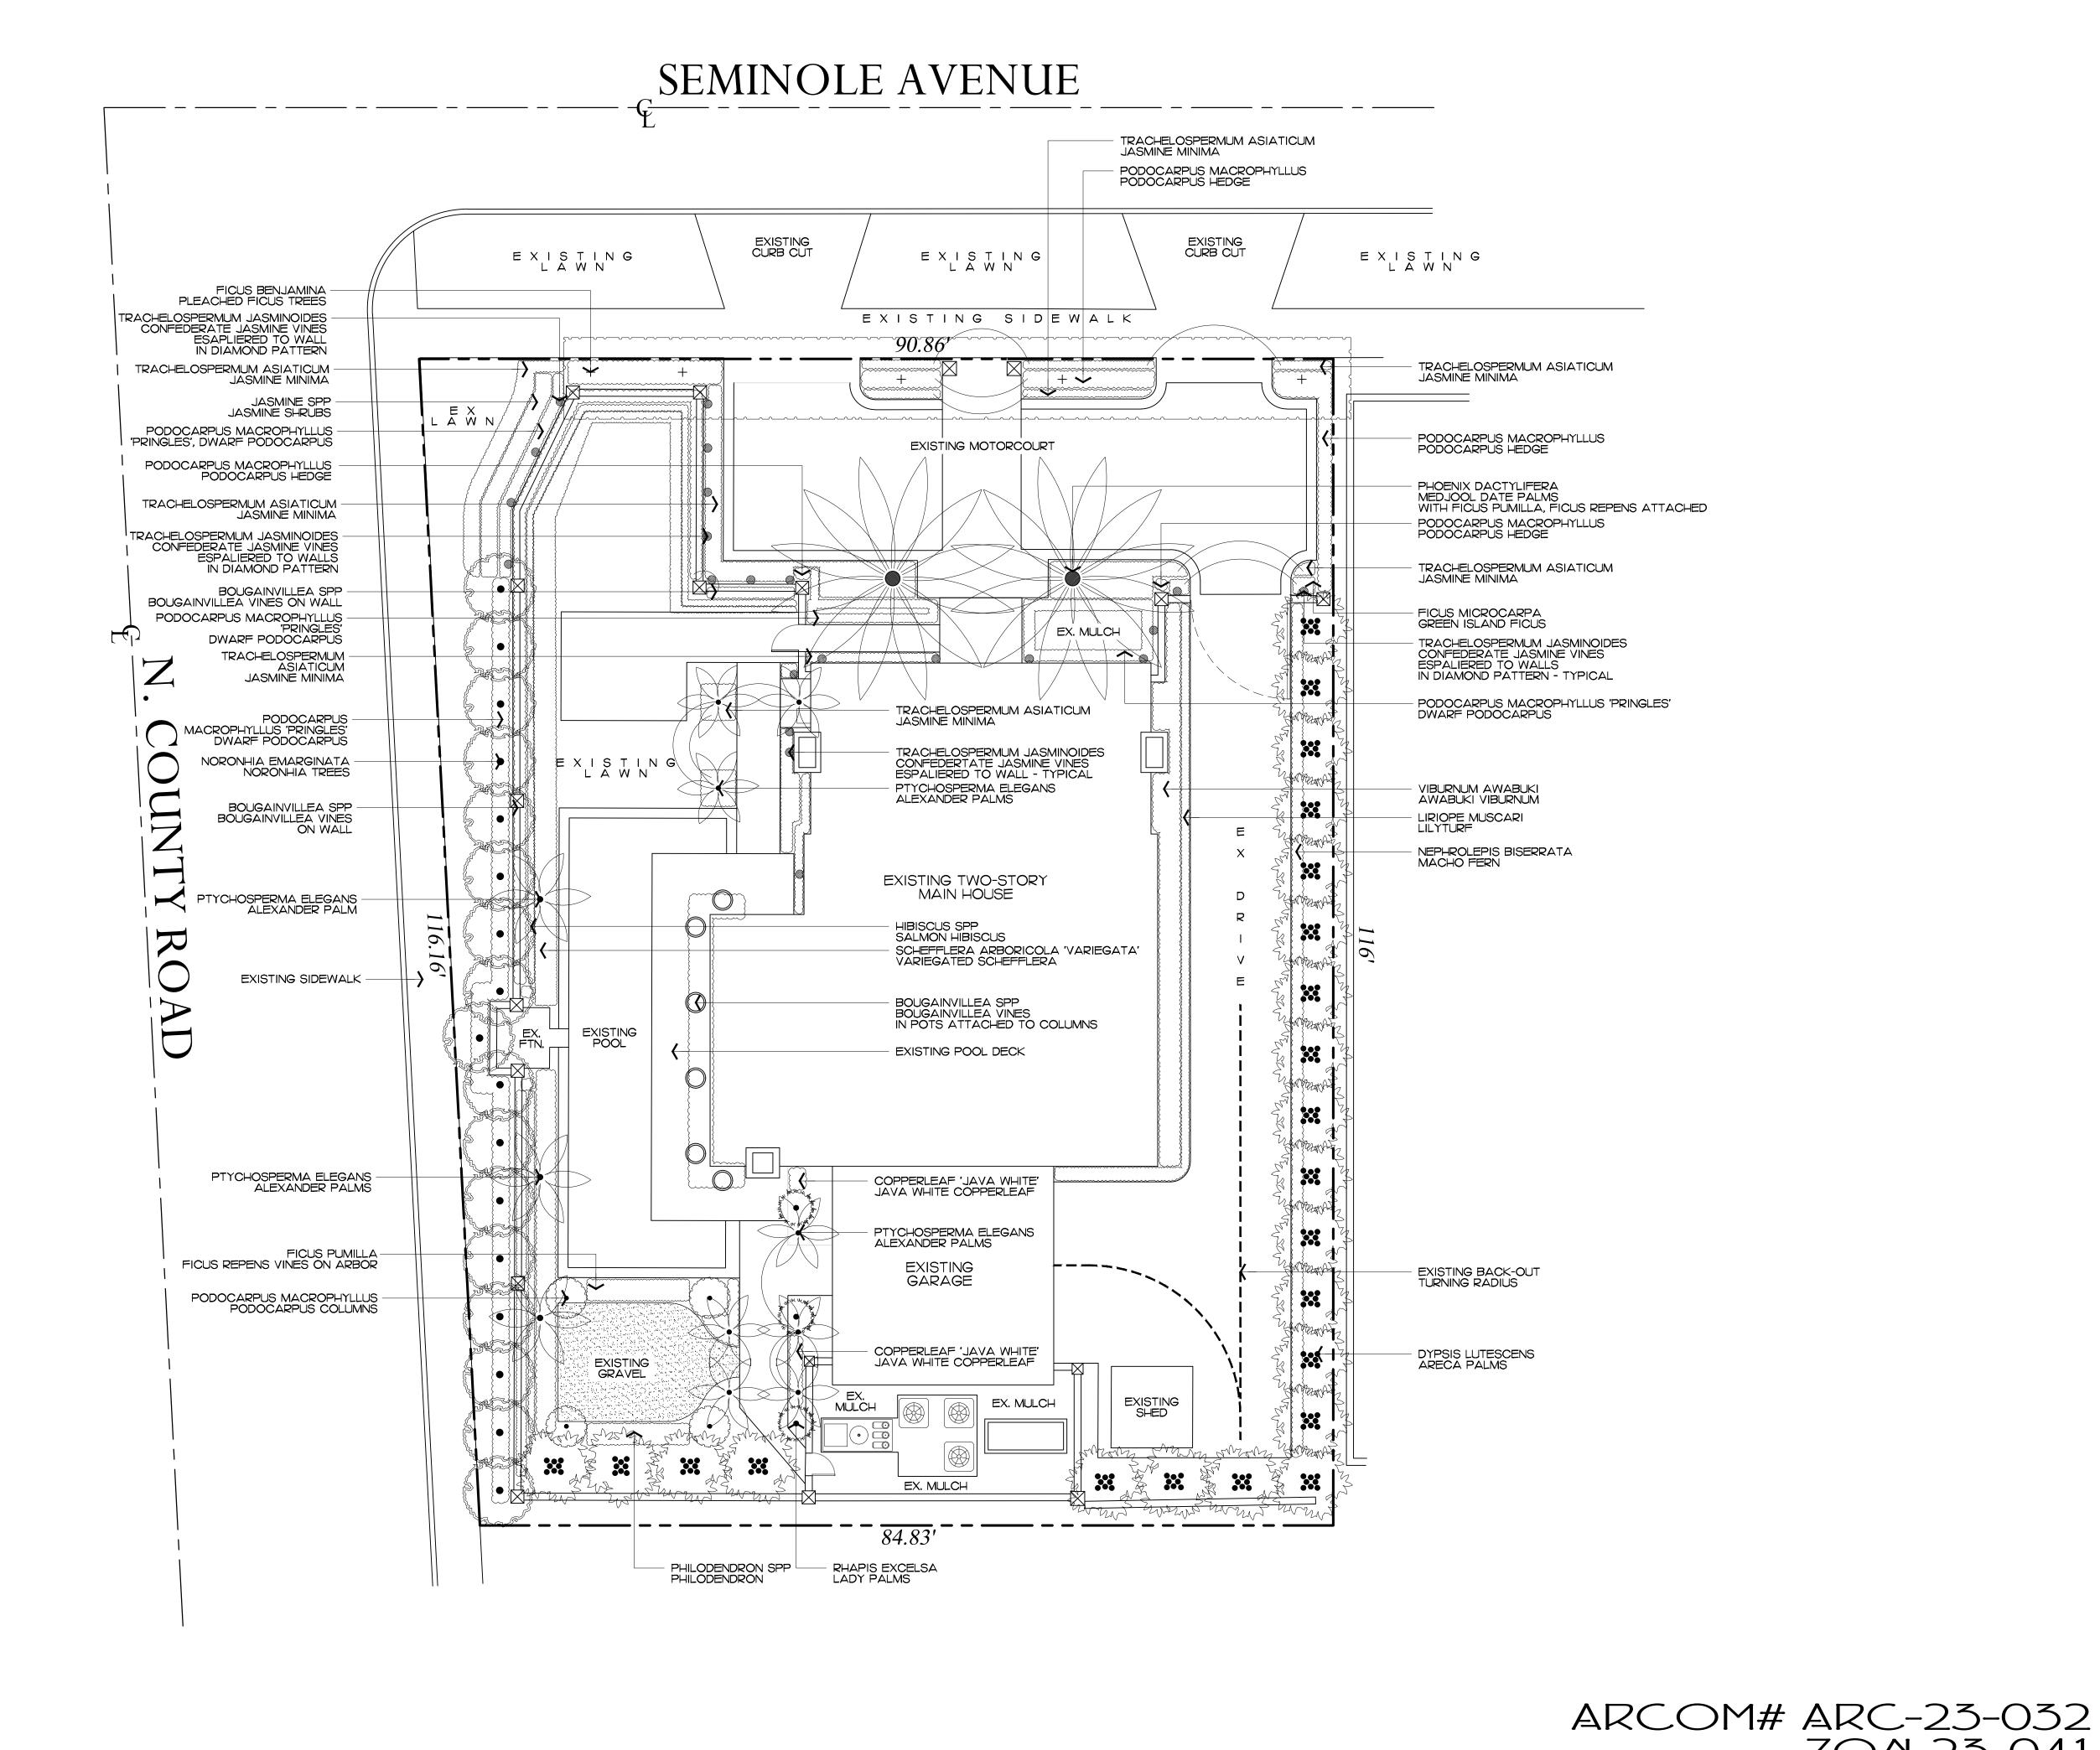
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DANIEL KAHAN REGISTERED ARCHITECT 94757

PRE-APP SUBMITTAL 2022-12-27 FIRST SUBMITTAL 2023-01-05

DWG. BY: DK SHEET:



TOTAL TOTAL

Dustin@environmentdesigngroup.com

ate Residence eminole Avenue

•

JOB NUMBER: # xxxxx.00 LA
DRAWN BY: Lauren Freeman
DATE: 01.05.2023
01.23.2023

/HEET L1.0

Existing Vegetation Inventory & Action Plan

ZON-23-041
Plan
SCALE IN FEET O' 8' 16' 24'

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176 SEMINOLE AVENUE
PALM BEACH, FLORIDA

FLORIDA AAC

S

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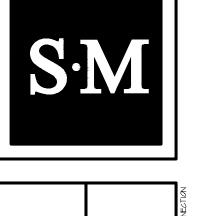
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NO:
DWG. BY: DK
SHEET:

R-1

PREVIOUSLY PROPOSED

EAST GARDEN VIEW



176 SEMINOLE AVENUE
PALM BEACH, FLORIDA

FLORIDA AAC

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NO. 001285

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PRE-APP SUBMITTAL 2022

PRE-APP SUBMITTAL 2022-12-27 FIRST SUBMITTAL 2023-01-05 DEFERRAL SUB. 2023-06-05

V: 23-041

NO:
DWG. BY: DK
SHEET:

R-1

CURRENTLY PROPOSED - EAST GARDEN VIEW



S

NO. 001285

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R-2

DWG. BY: DK SHEET:

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DANIEL KAHAN REGISTERED ARCHITECT 94757

DWG. BY: DK N SHEET:

R-2

PETER G. PAPADOPOULOS REGISTERED ARCHITECT 92952

DANIEL KAHAN REGISTERED ARCHITECT 94757

PRE-APP SUBMITTAL 2022-12-27 FIRST SUBMITTAL 2023-01-05

R-3

DWG. BY: DK SHEET:

WEST FACADE (INSIDE WALL AT ROAD)

PREVIOUSLY PROPOSED





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PETER G. PAPADOPOULOS REGISTERED ARCHITECT 92952

DANIEL KAHAN REGISTERED ARCHITECT 94757

R-3

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DANIEL KAHAN REGISTERED ARCHITECT 94757

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VIEW FROM COUNTY ROAD



S

NO. 001285

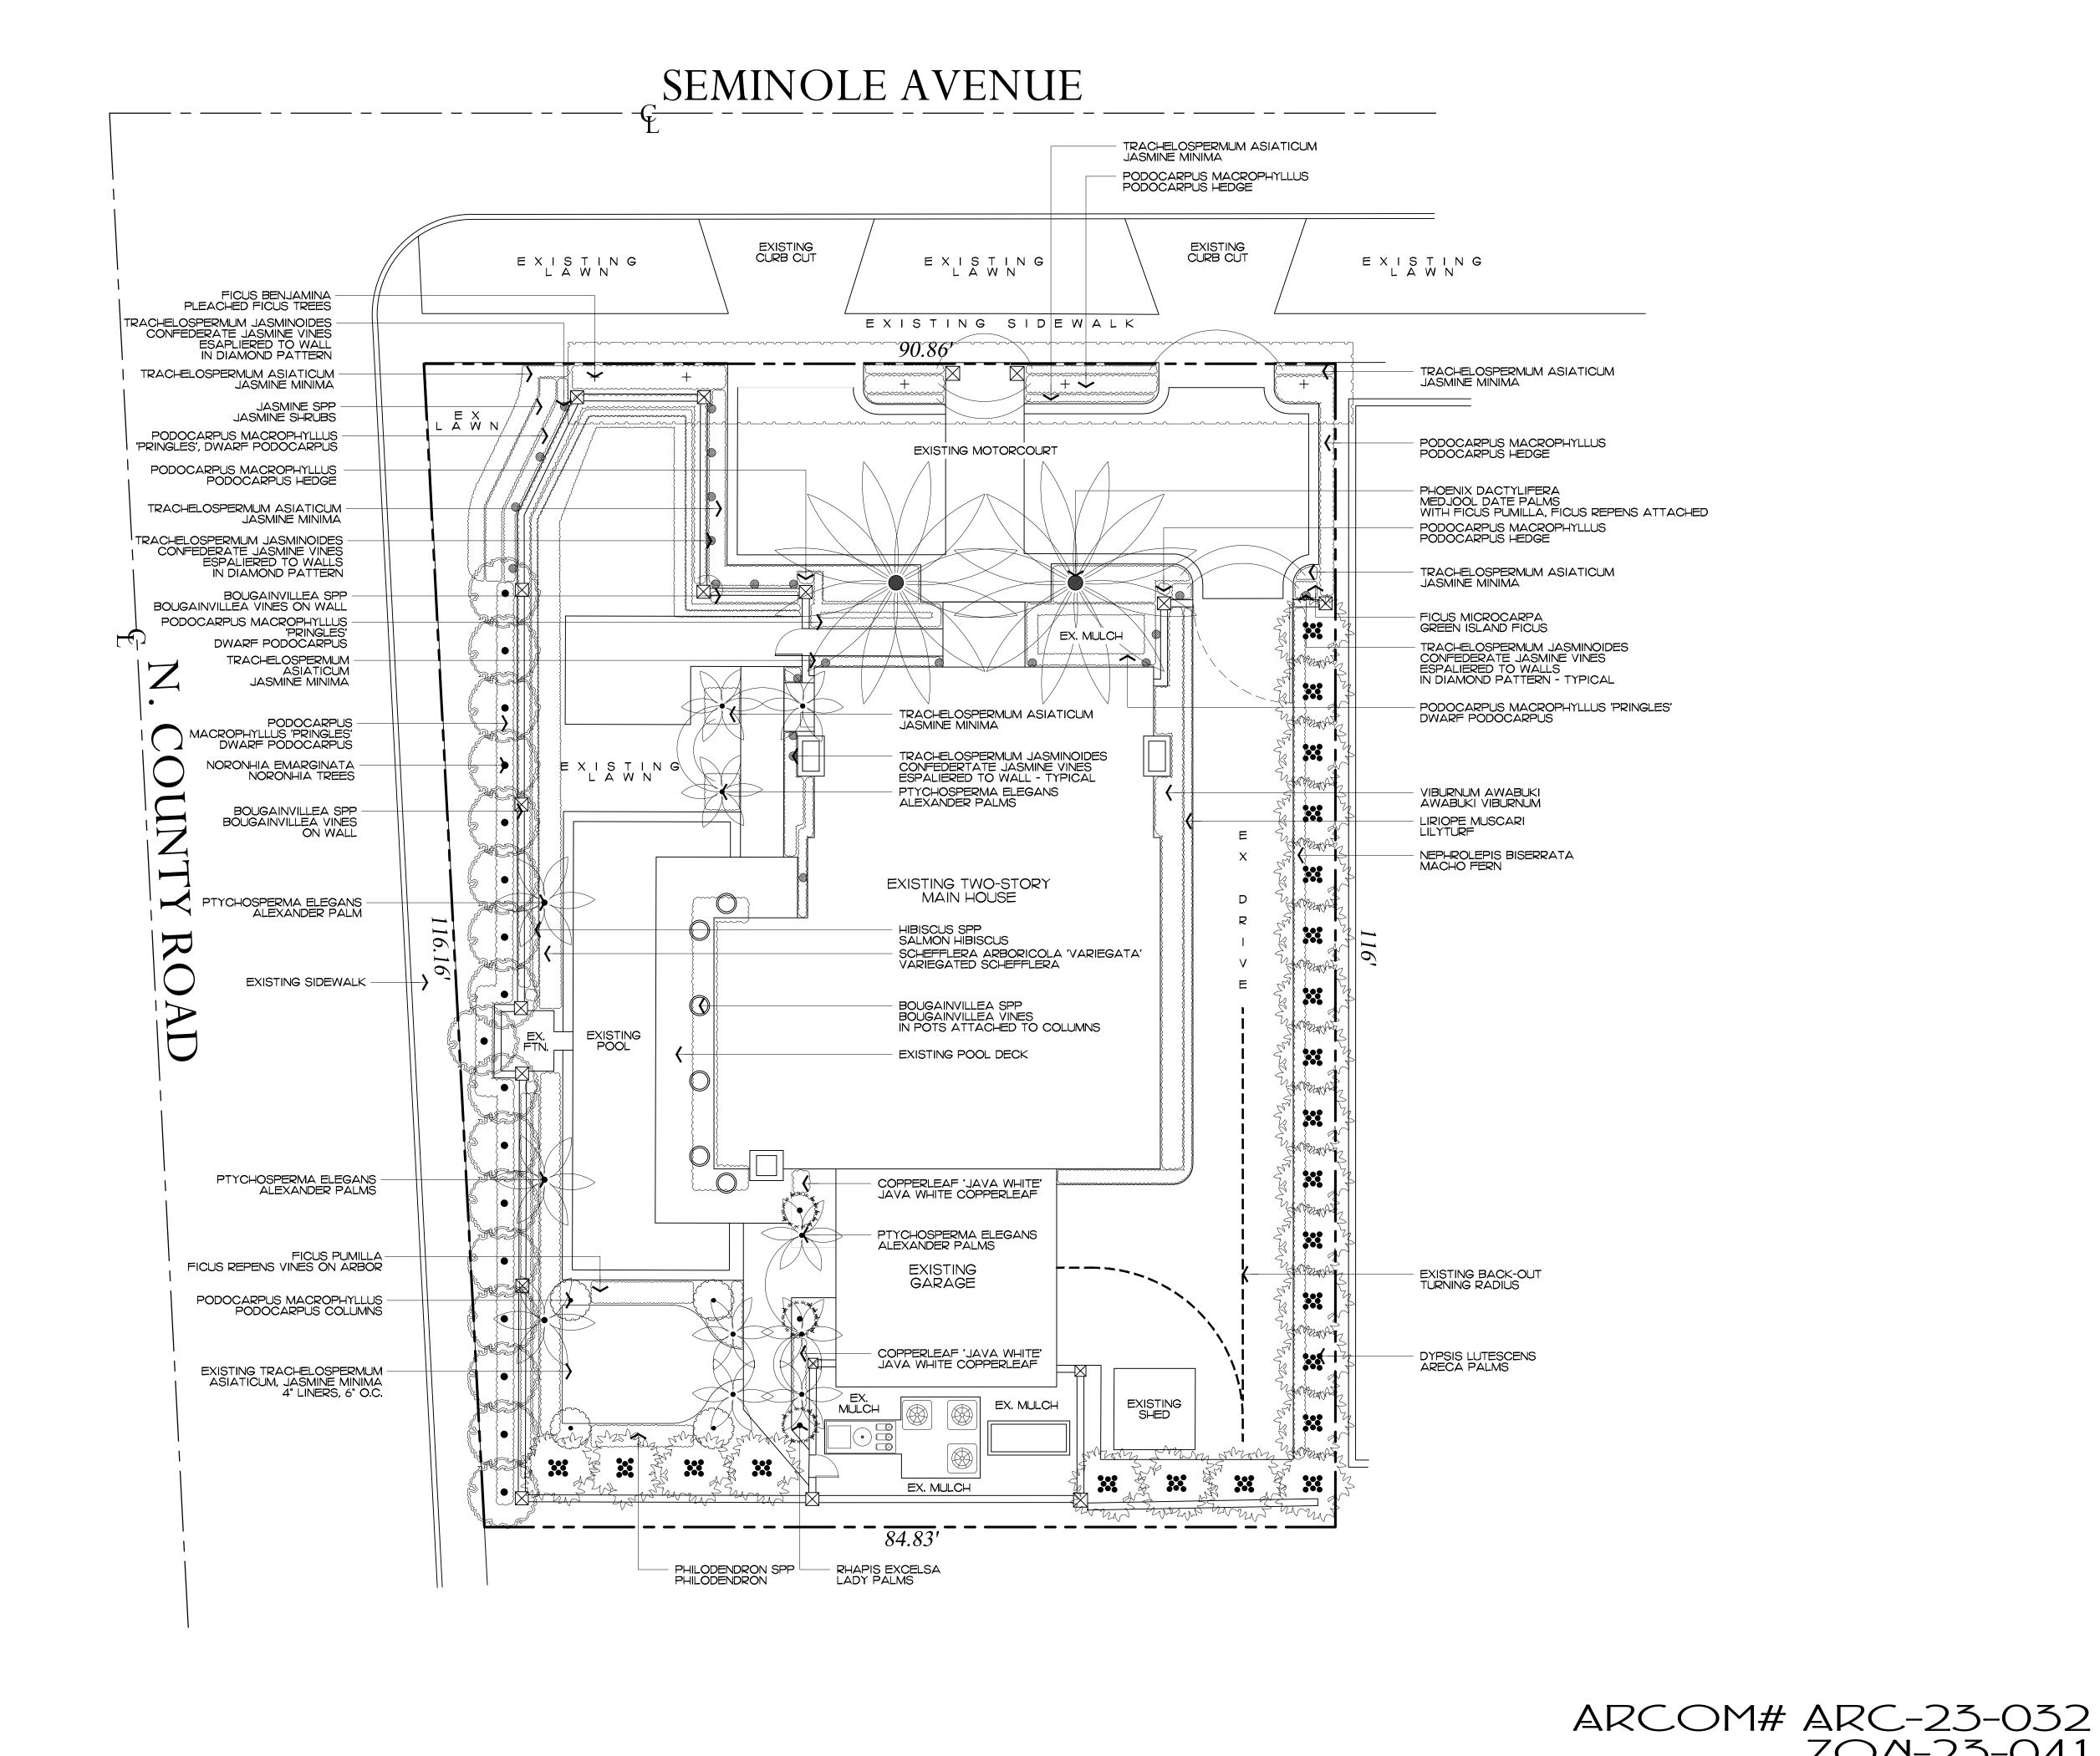
JONATHAN C. MOORE REGISTERED ARCHITECT 13541

HAROLD J. SMITH REGISTERED ARCHITECT 8742

PETER G. PAPADOPOULOS REGISTERED ARCHITECT 92952

DANIEL KAHAN REGISTERED ARCHITECT 94757

DWG. BY: DK SHEET:



DE/IG/I ROUP 139 North County Road S#20-B Palm Beach, Fl 33481 Phone 561.832.4600 " Mobile 561.313.4424 Landscape Architecture Land Planning Landscape Management Dustin M. Mizell, MLA RLA #6666784

Dustin@environmentdesigngroup.com

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JOB NUMBER: # xxxxx.00 LA DRAWN BY: Lauren Freeman
DATE: 01.05.2023

/HEET L1.0

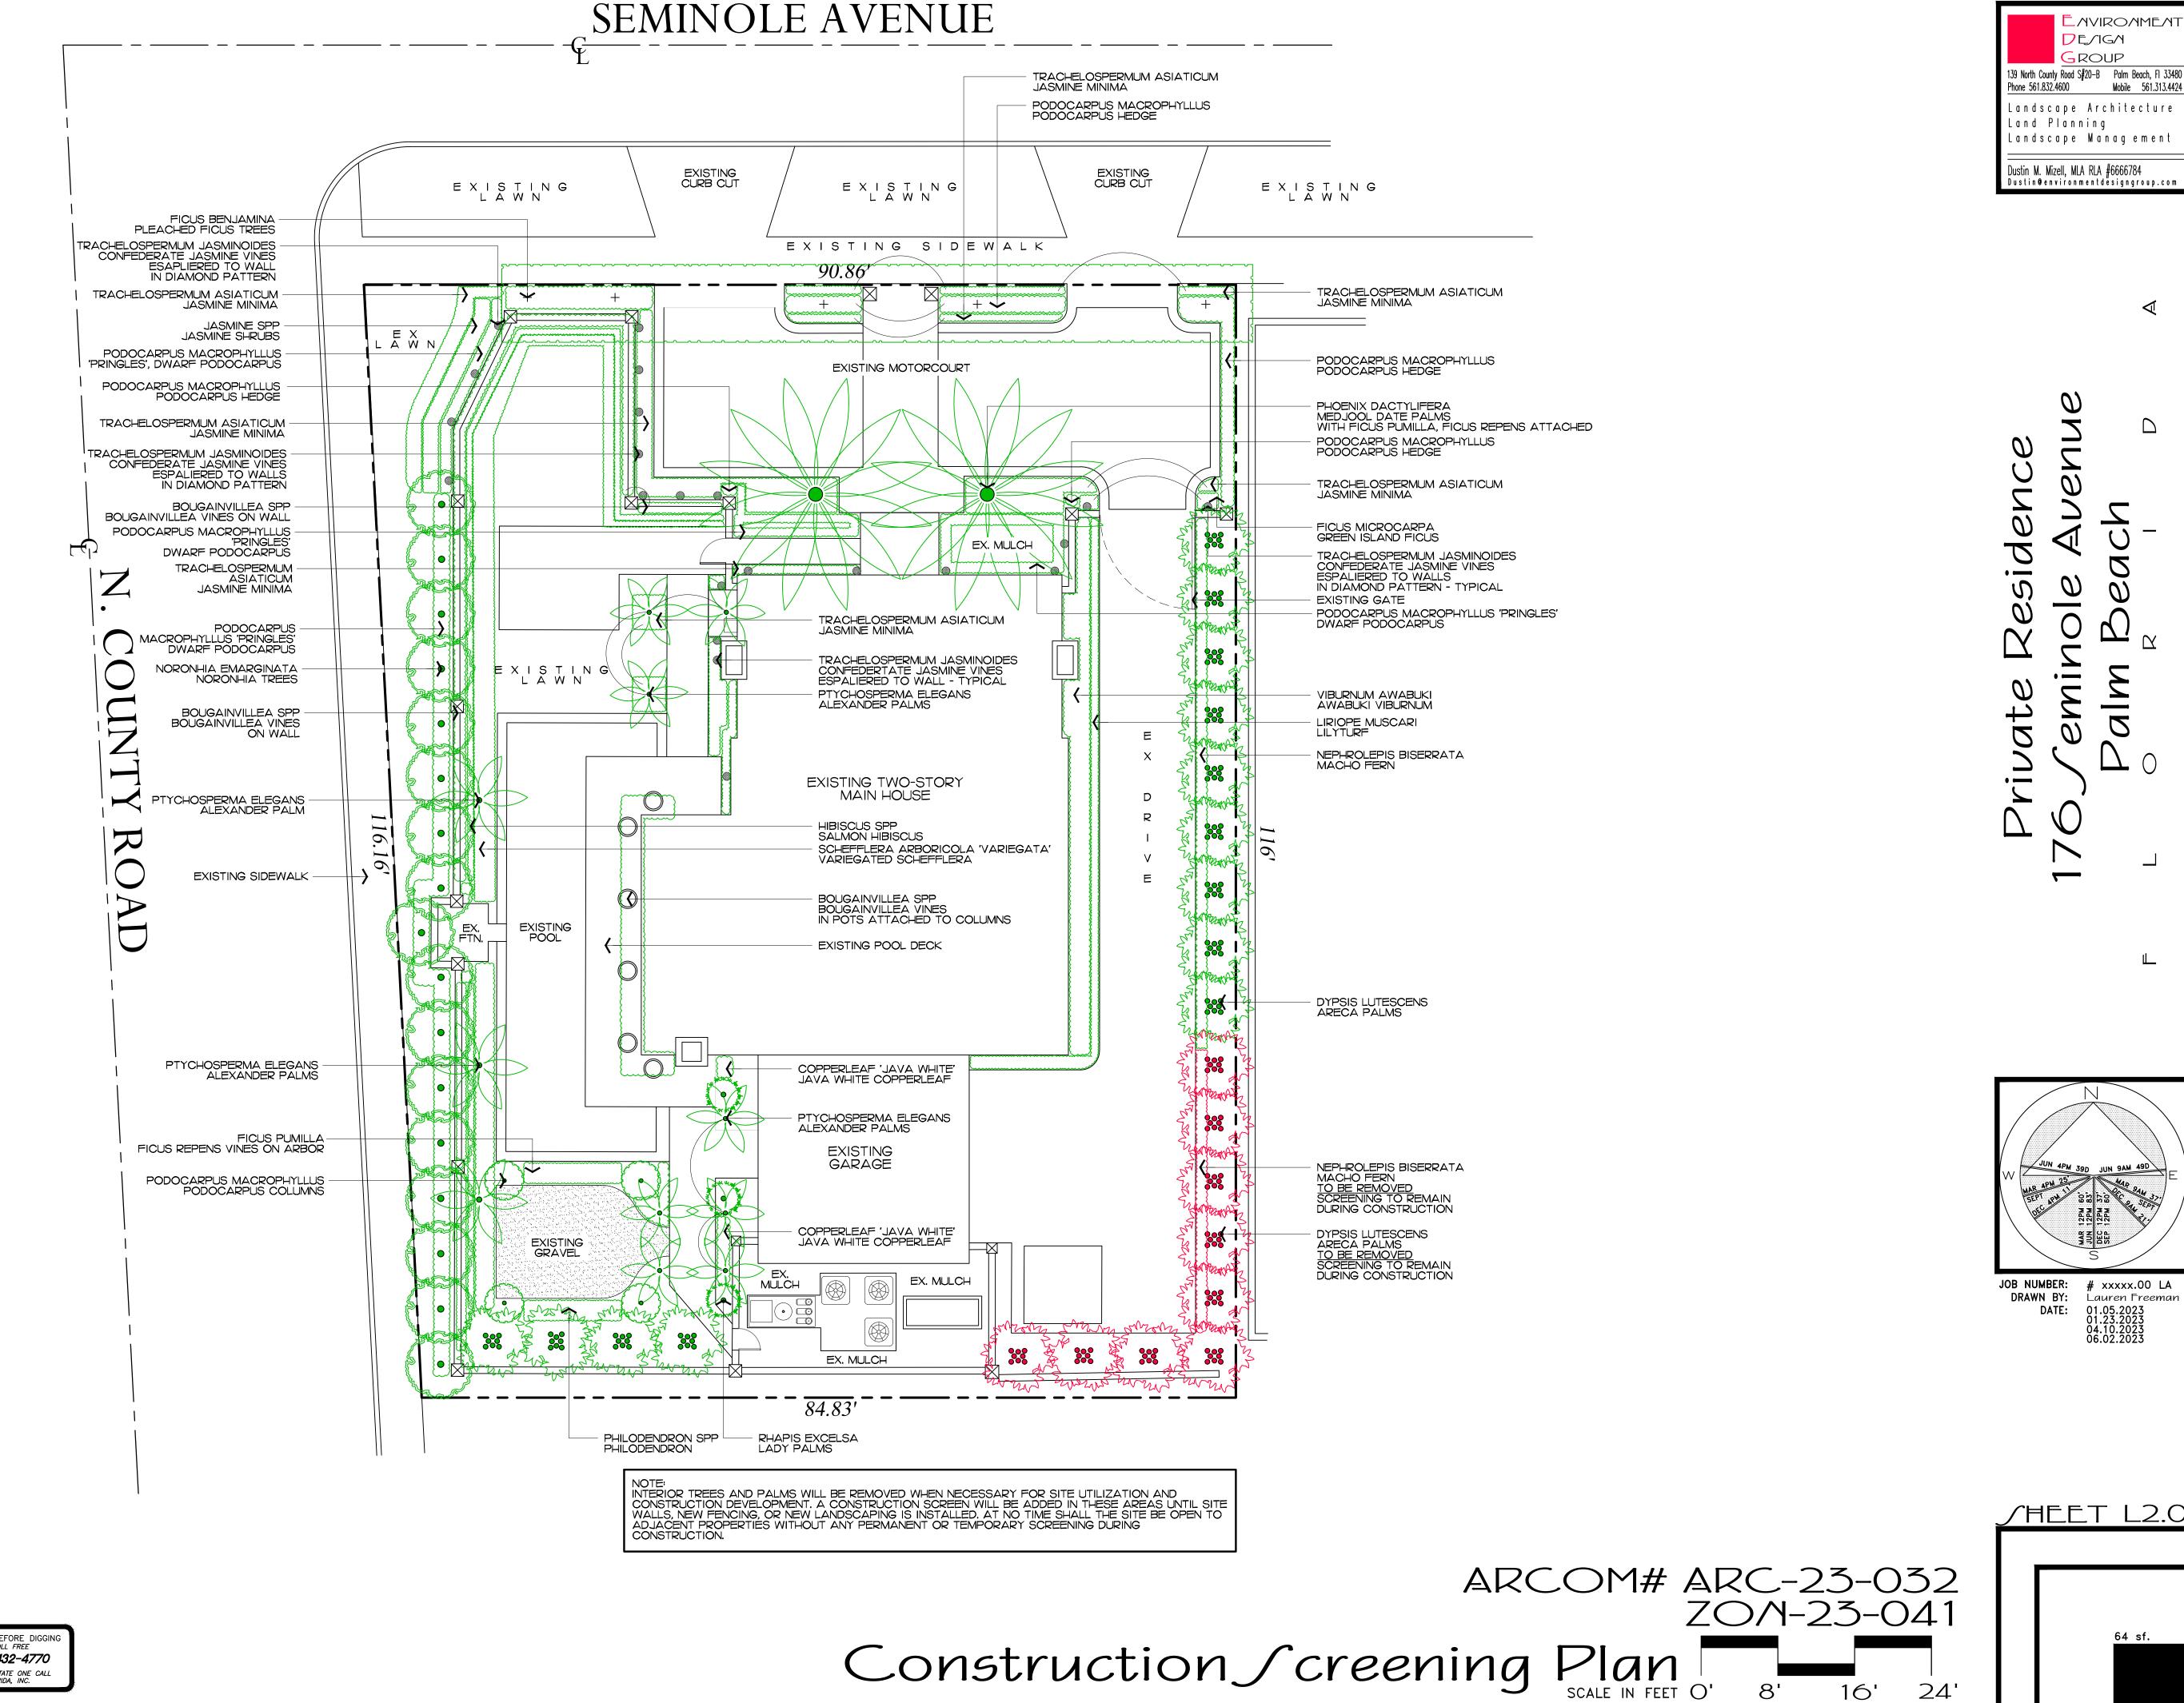
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48 HOURS BEFORE DIGGING
CALL TOLL FREE 1-800-432-4770 SUNSHINE STATE ONE CALL OF FLORIDA, INC.

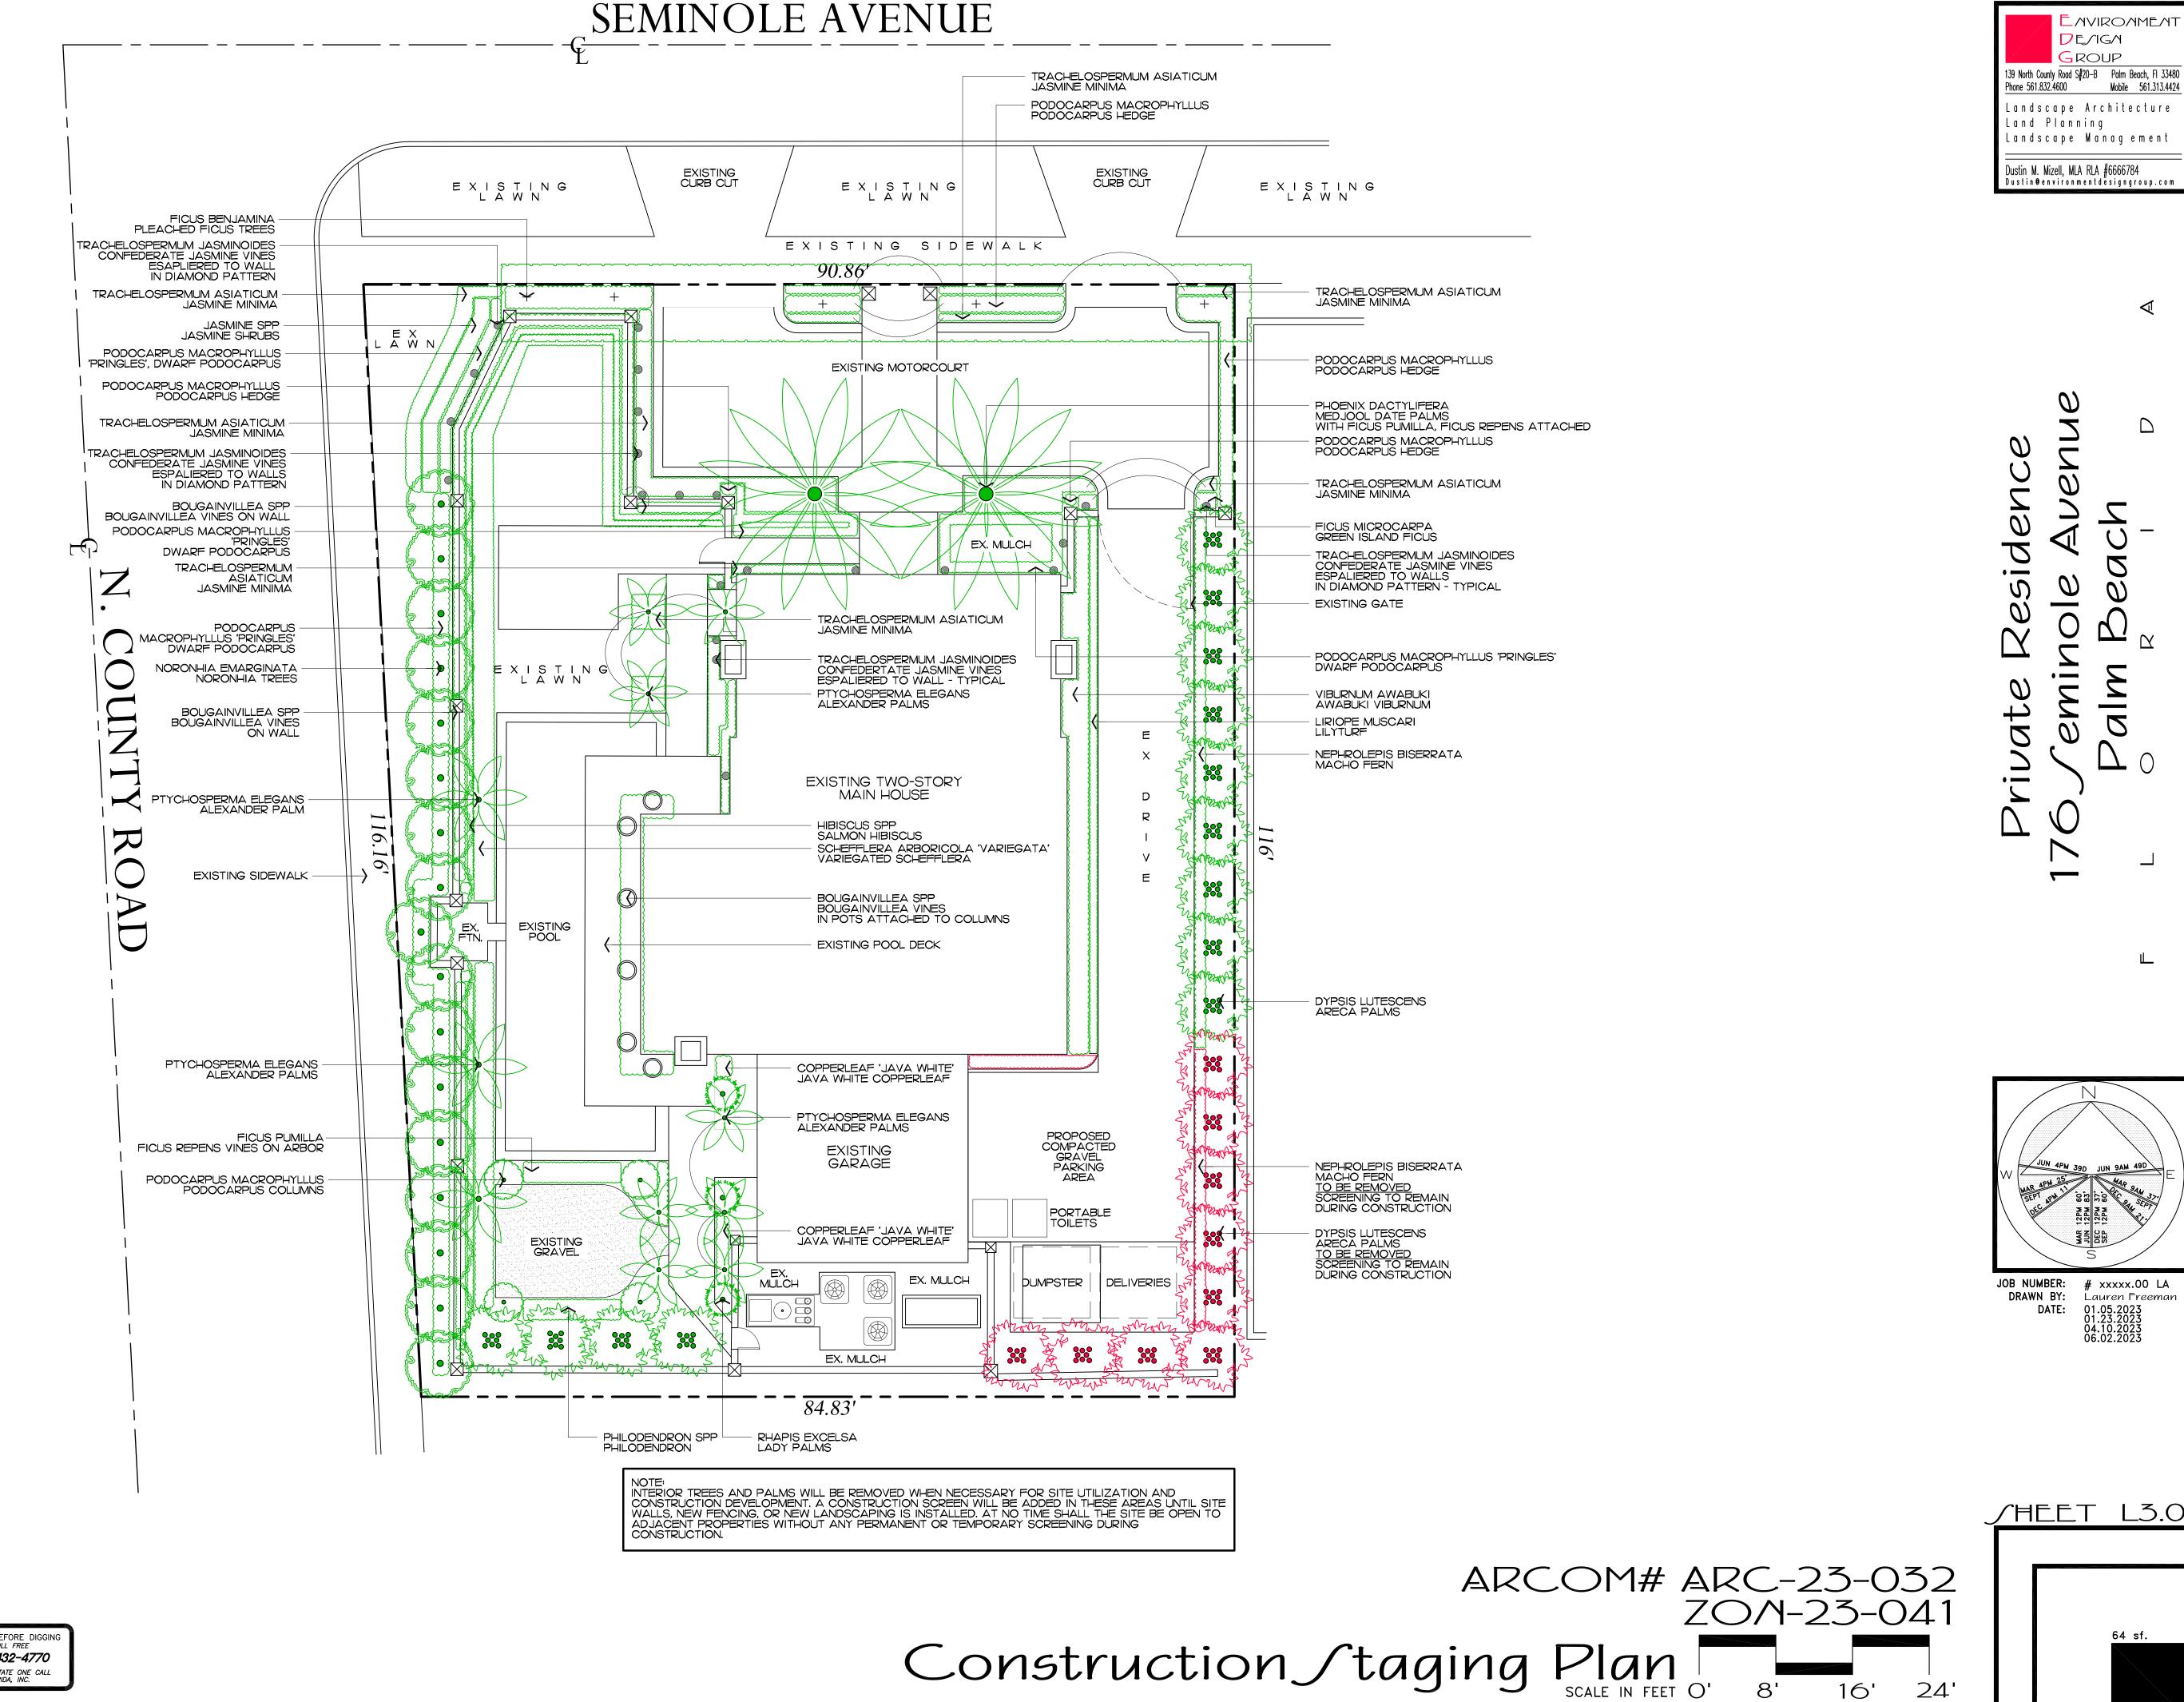
Existing Vegetation Inventory & Action Plan Scale IN FEET O'

ZOM-23-041



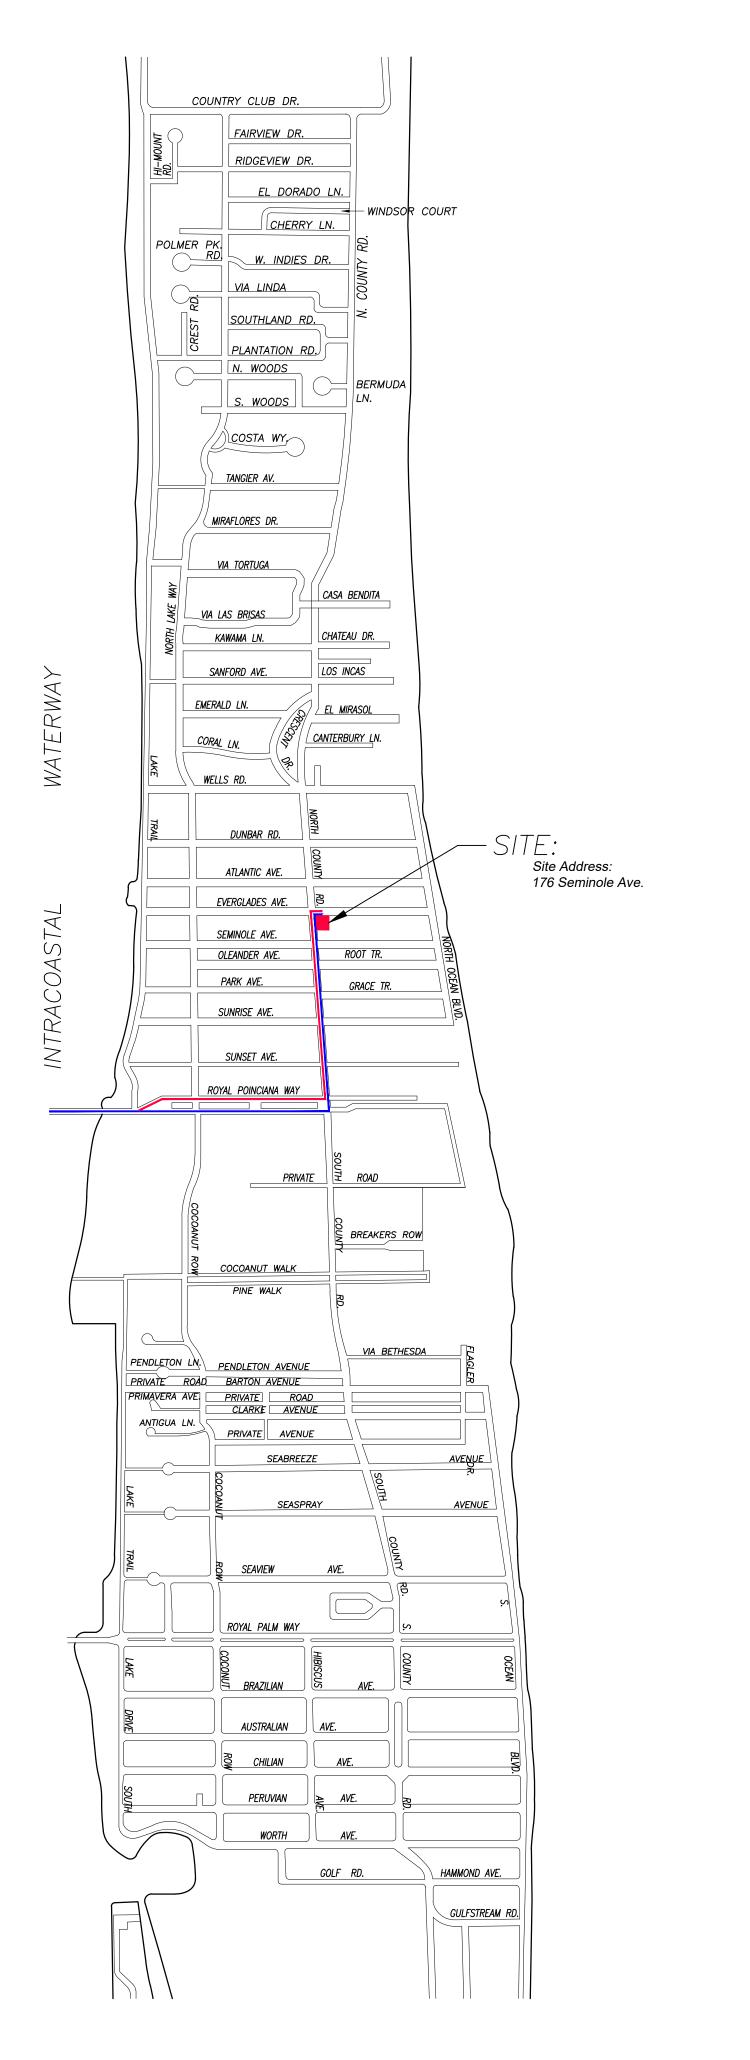
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PROPOSED TRUCK INGRESS / EGRESS ROUTES MAP

SCHEDULE:

MONTH 1: DEMOLITION AND CLEANUP (3 - 5 DAYS)

LARGEST TRUCK ->

10-15 DUMP TRUCKS FOR DEBRIS REMOVAL TRAILER FOR EXCAVATOR / DEMOLITION LANDSCAPE TRUCKS ->

IRRIGATION

NOTE: SEE SEPARATE "CONSTRUCTION STAGING PLAN" SHEET FOR INFORMATION ON LOCATIONS FOR PARKING, MATERIAL STORAGE, DELIVERIES, DUMPSTER, PORTABLE TOILETS, TIRE CLEANING AREA, SILT FENCE, ETC.

PROPOSED INGRESS TRUCK ROUTE

PROPOSED EGRESS TRUCK ROUTE

E AVIROAMEA **D**E/IG/I ROUP 139 North County Road S#20-B Palm Beach, Fl 33481 Phone 561.832.4600 Mobile 561.313.4424 Landscape Architecture Land Planning Landscape Management Dustin M. Mizell, MLA RLA #6666784 Dustin@environmentdesigngroup.com

Residen Private

JOB NUMBER: # xxxxx.00 LA
DRAWN BY: Lauren Freeman
DATE: 01.05.2023

SHEET L4.0

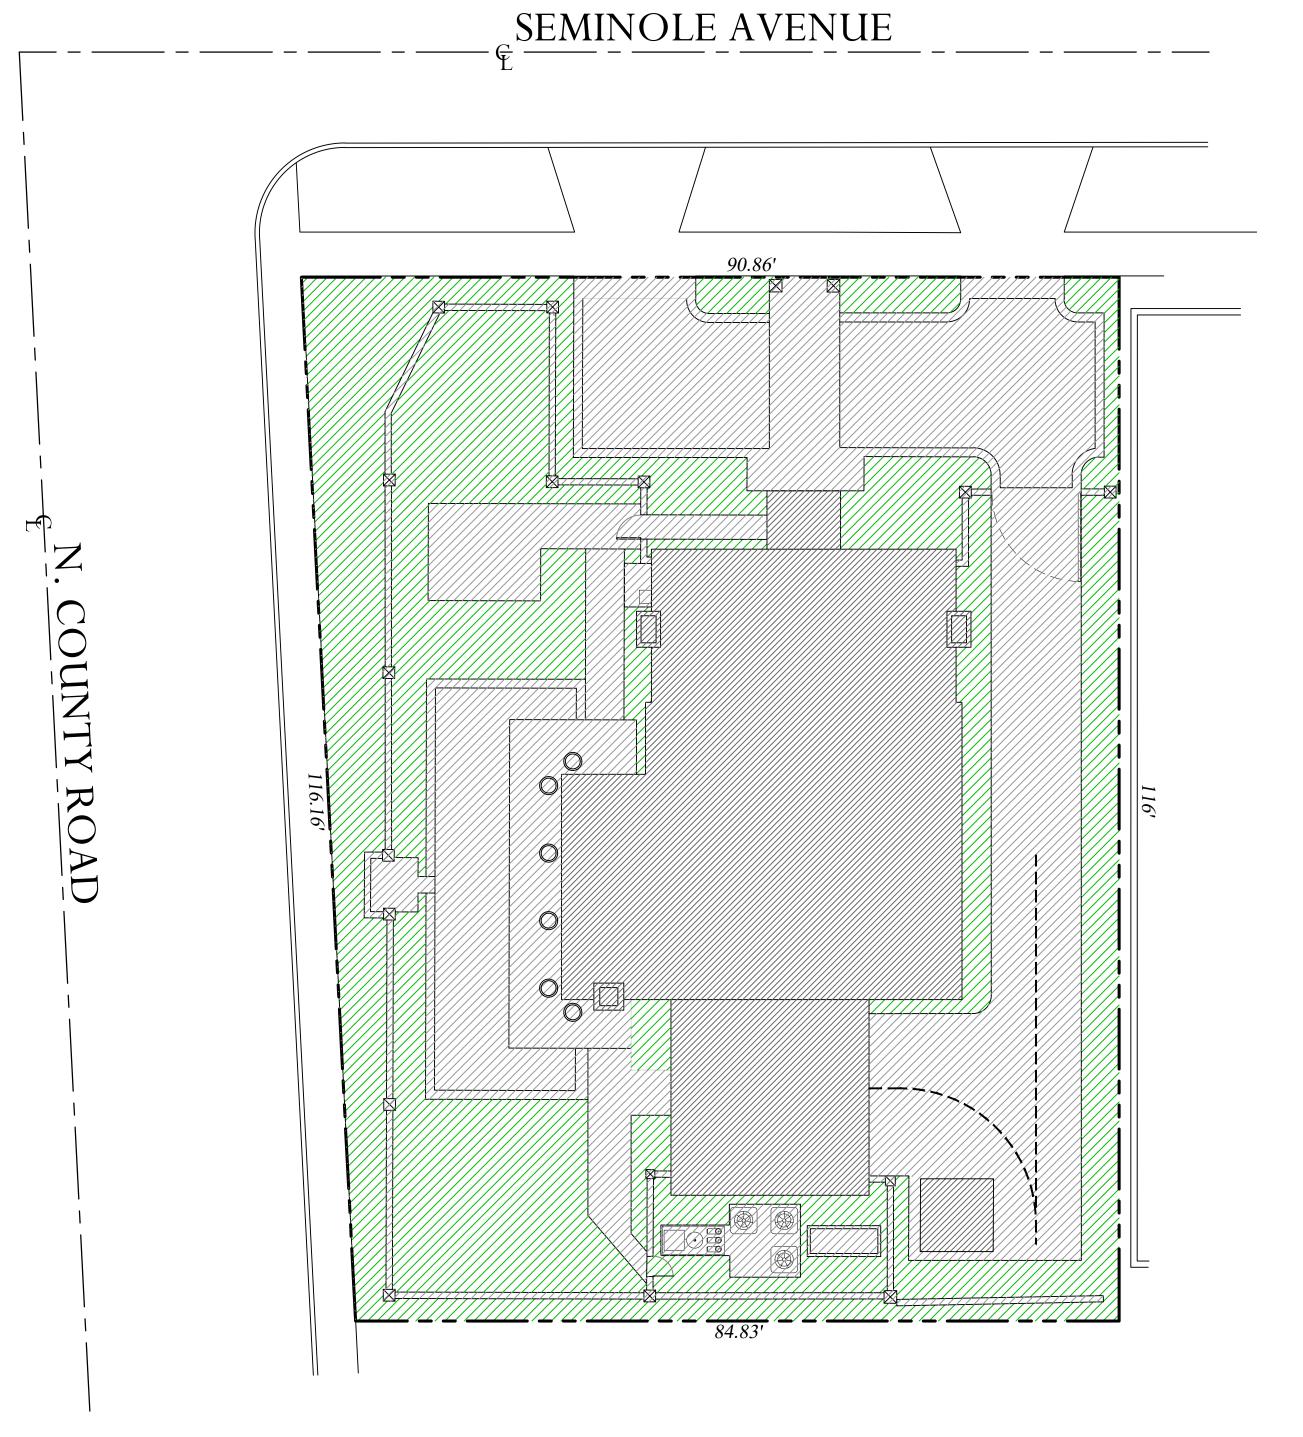
ARCOM# ARC-23-032 ZOM-23-041 Truck Logistics Plan SCALE: NOT TO SCALE

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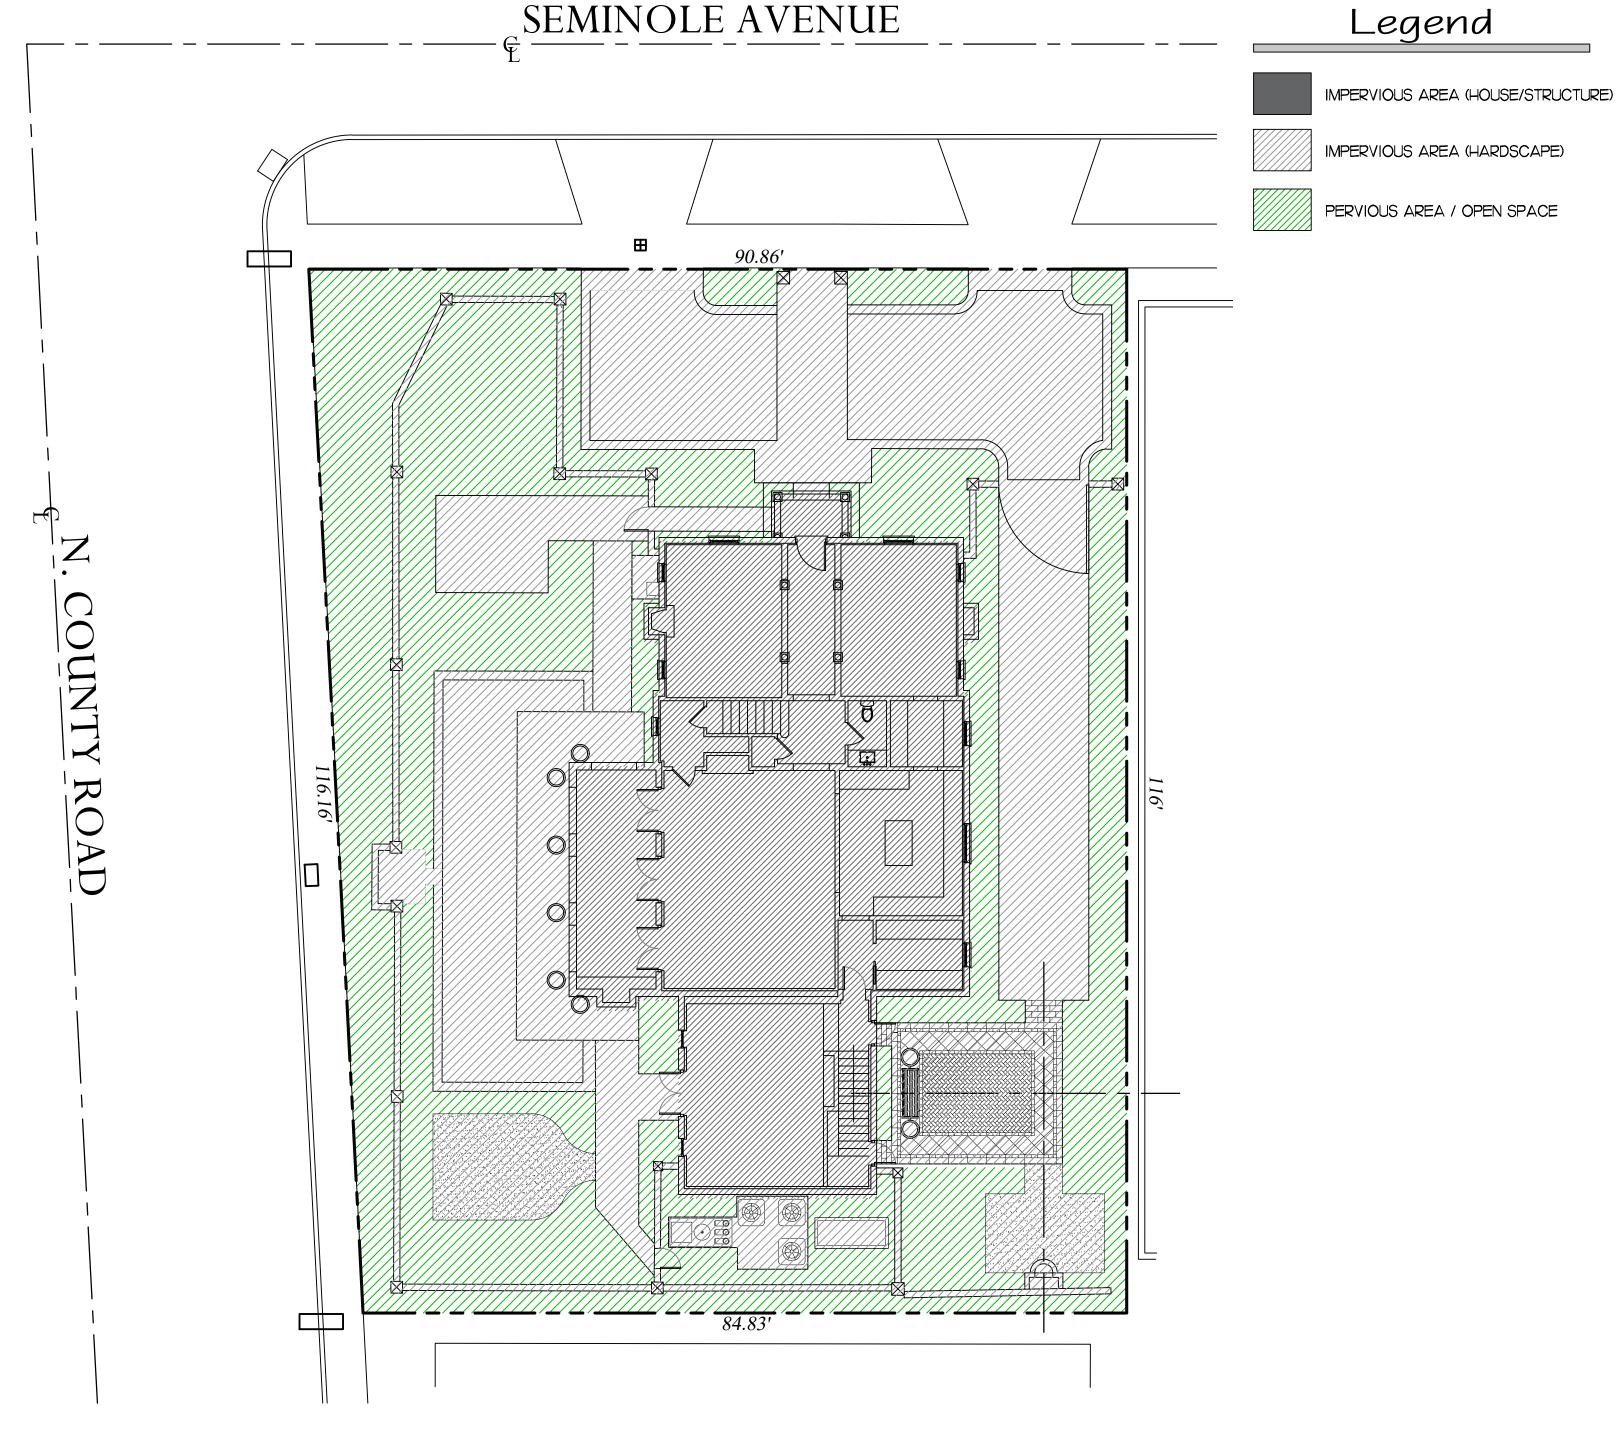
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Existing Open Space Graphic

### Existing Site Data

DESCRIPTION	REQUIRE	ED .	E	KISTING
LOT ZONE			R-B - LOW DE	ENSITY RESIDENTIAL
LOT AREA	10,000 S.F. N	MINIMUM	10,1	90 S.F.
OPEN / PERMEABLE SPACE	MINIMUM 45%	4,585.5 S.F.	35.8%	3,647 S.F.
FRONT YARD LANDSCAPE	MINIMUM 40% OF FRONT YARD	902 S.F.	45.1%	1,016 S.F.
PERIMETER LANDSCAPE WITHIN 10' OF PROPERTY LINE	MINIMUM 50% OF REQ'D OPEN SPACE	2,292.75 S.F.	61%	2,242 S.F.



### Proposed Open Space Graphic

### Proposed Site Data

DESCRIPTION	REQUIRE	ED .	PF	ROPOSED
LOT ZONE			R-B - LOW DE	ENSITY RESIDENTIAL
LOT AREA	10,000 S.F. N	MINIMUM	10,	190 S.F.
OPEN / PERMEABLE SPACE	MINIMUM 45%	4,585.5 S.F.	37.8%	3,847 S.F.
FRONT YARD LANDSCAPE	MINIMUM 40% OF FRONT YARD	902 S.F.	45.1%	1,016 S.F.
PERIMETER LANDSCAPE WITHIN IO' OF PROPERTY LINE	MINIMUM 50% OF REQ'D OPEN SPACE	2,292.75 S.F.	62.3%	2,292 S.F.

ARCOM# ARC-23-032 ZOM-23-041 Site Calculation/OpenSpace Graphics

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**DE/IGN** GROUP

139 North County Road S#20-B Palm Beach, Fl 33480 Phone 561.832.4600 Mobile 561.313.4424

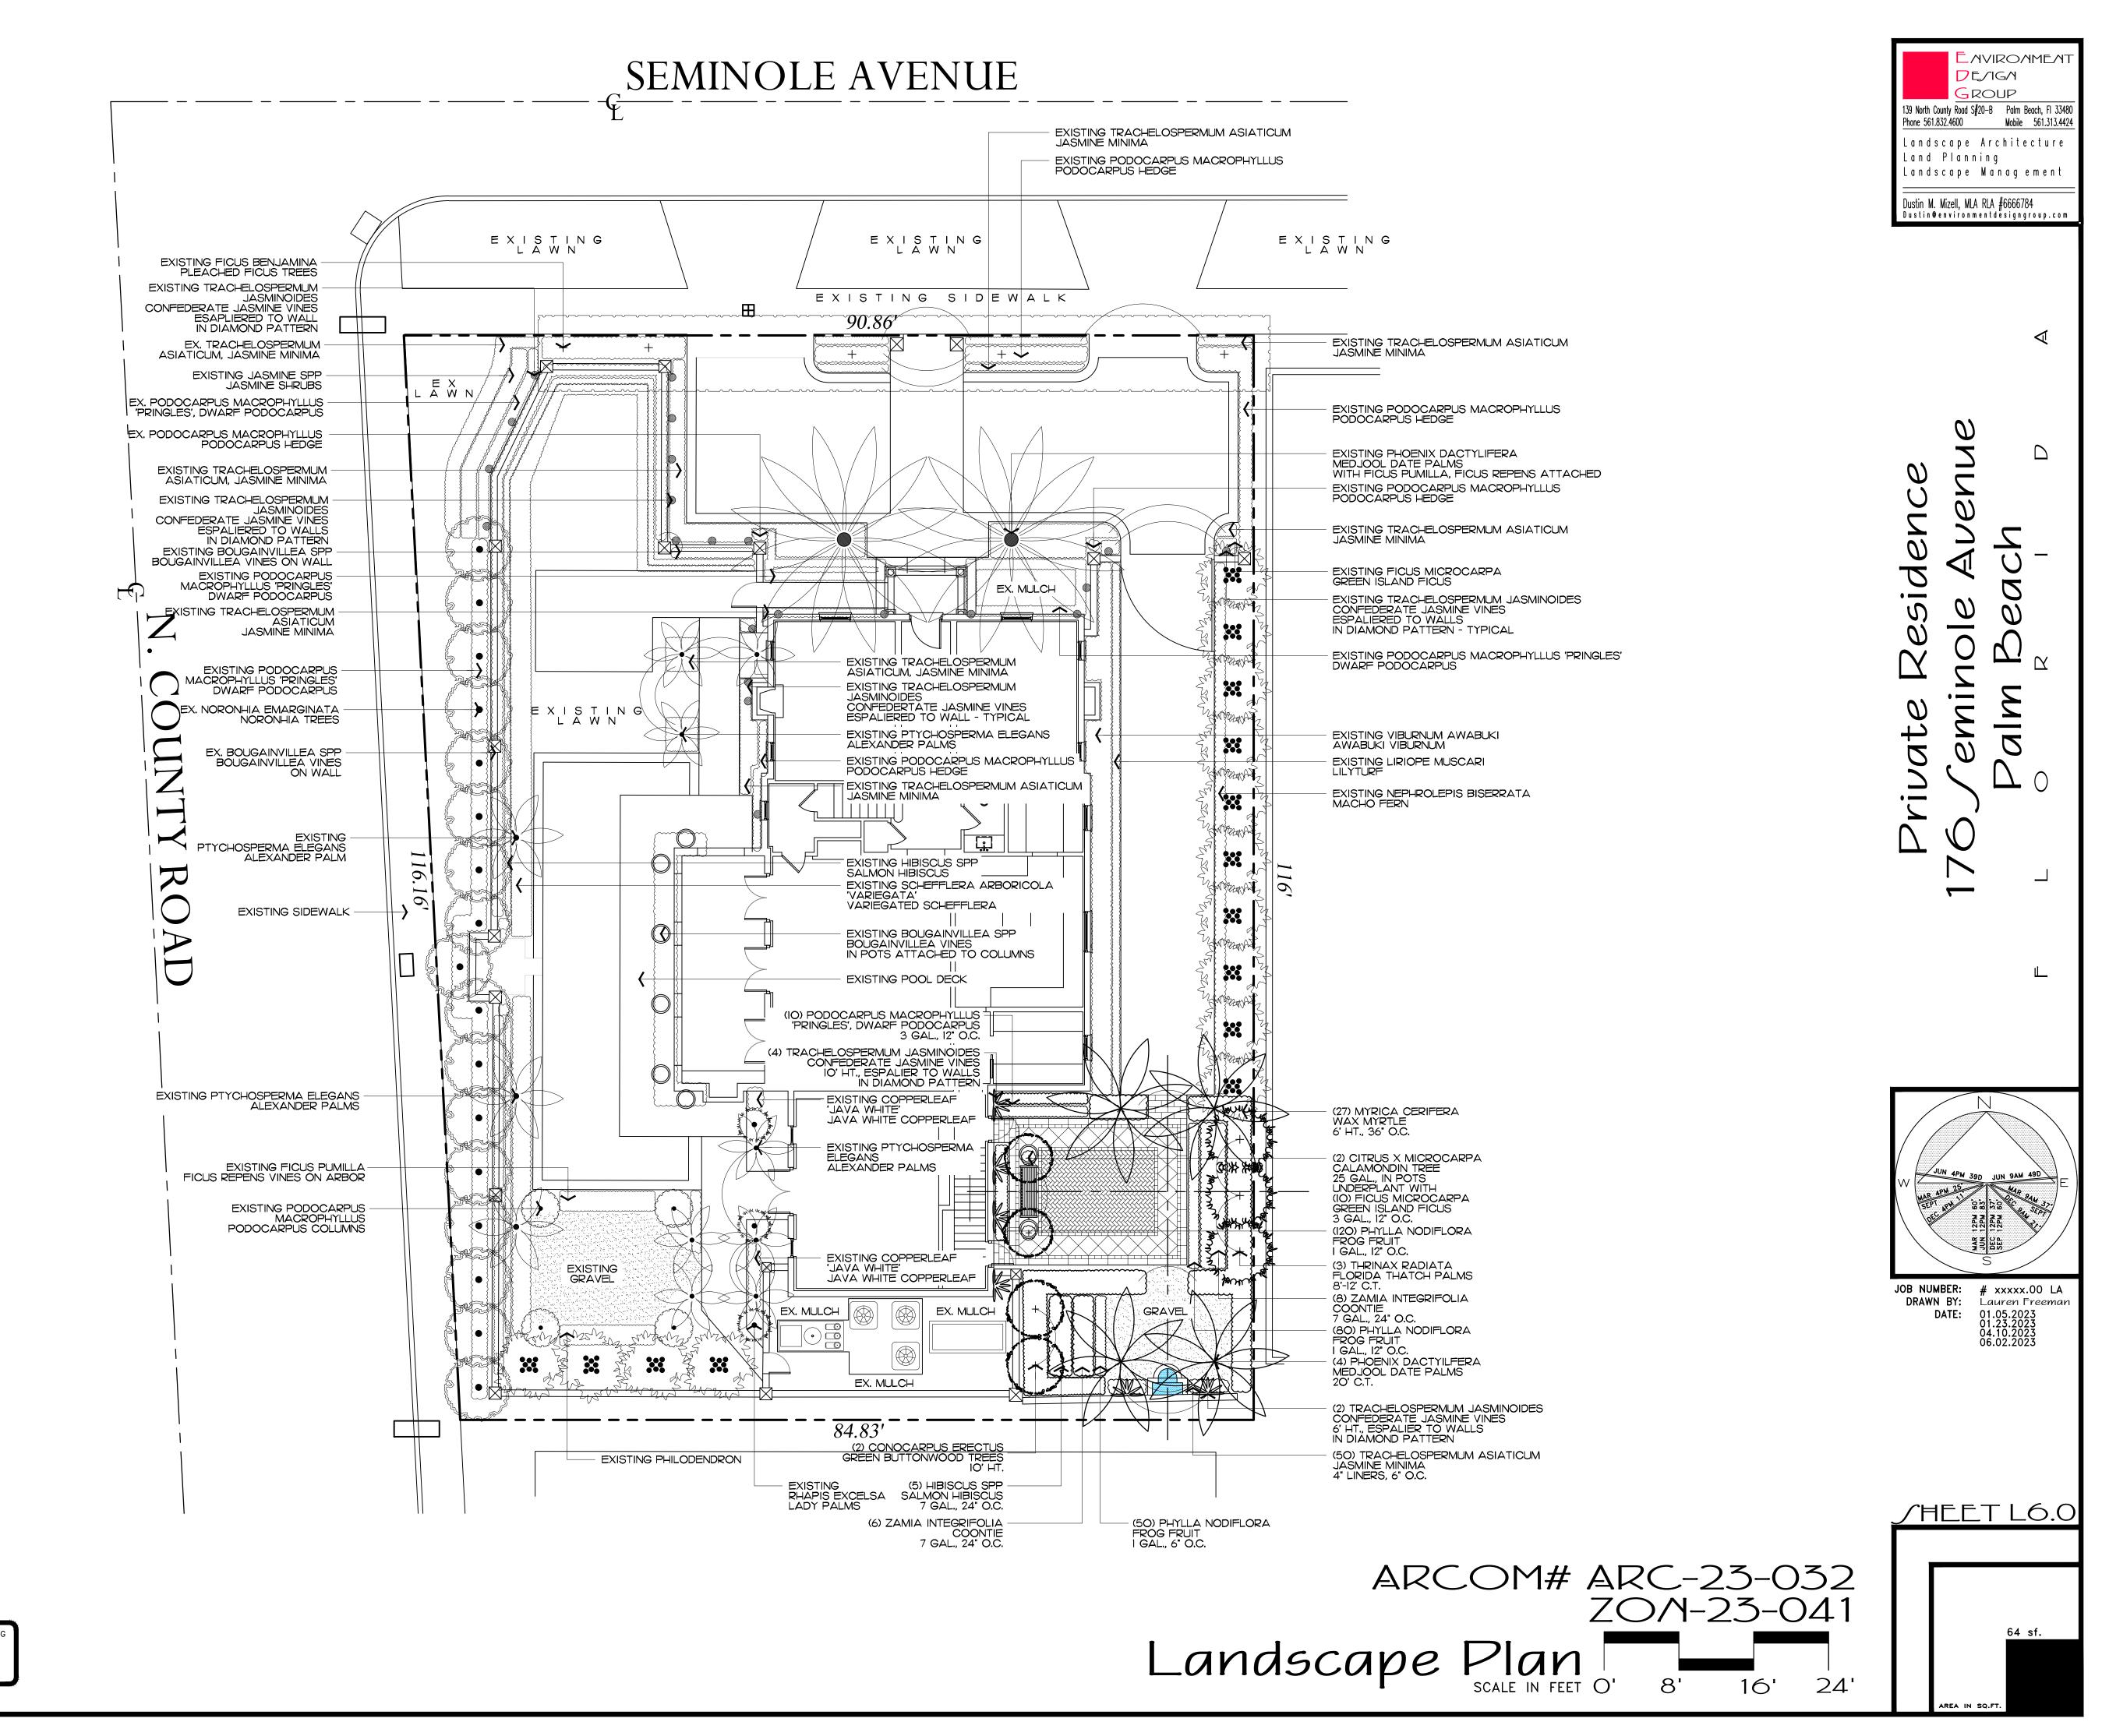
Landscape Architecture Land Planning

Landscape Management

Dustin M. Mizell, MLA RLA #6666784 Dustin@environmentdesigngroup.com

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DRAWN BY: Lauren Freeman
DATE: 01.05.2023

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DRAWN BY: Dustin Mizell
DATE: 01.05.2023
01.23.2023
06.02.2023

JHEET L6.1

ARCOM# ARC-23-032 ZOM-23-041 Rendered Landscape Plan Scale IN FEET O'

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### Trees

SYMBOL	PLANT NA	AME	QTY.	DESCRIPTION	NATIVE
·	CONOCARPU GREEN BUT	S ERECTUS TONWOOD TREES	2	10' HT.	YES
<u> </u>	CITRUS X MIC CALAMONE		2	25 GAL., IN POTS	NO
		TOTAL:	4		

2 (50%) NATIVE SPECIES:

## Palms

SYMBOL	PLANT NA	AME	QTY.	DESCRIPTION	NATIVE
as we wear	PHOENIX DAC MEDJOOL [	DATE PALM	4	20' C.T.	NO VEC
A + A	THRINAX RAD FLORIDA TI	HATCH PALM	3	8'-12' C.T.	YES
		TOTAL	7		

3 (42.9%) NATIVE SPECIES:

# Shrubs

SYMBOL/KEY	PLANT NAME	QTY.	DESCRIPTION	NATIVE
	HIBISCUS SPP SALMON HIBISCUS	5	7 GAL., 24" O.C.	NO
	MYRICA CERIFERA WAX MYRTLE	27	6' HT., 36" O.C.	YES
	ZAMIA INTEGRIFOLIA COONTIE	14	7 GAL., 24" O.C.	YES

41 (89.1%) NATIVE SPECIES:

# Vines, & Groundcovers

SYMBOL/KEY	PLANT NAME	QTY.	DESCRIPTION	NATIVE
	FICUS MICROCARPA GREEN ISLAND FICUS	10	3 GAL., 12" O.C.	NO
	PHYLLA NODIFLORA FROG FRUIT	250	1 GAL., 6" O.C.	YES
	TRACHELOSPERMUM ASIATICUM JASMINE MINIMA	50	4" LINERS, 6" O.C.	NO
	TRACHELOSPERMUM JASMINOIDES CONFEDERATE JASMINE VINES	2	6' HT. ESPALIER TO WALLS IN DIAMOND PATTERN	NO

250 (80.1%) NATIVE SPECIES:

## Lawn & Mulch

PROPERTY ADDRESS:

LOT SIZE (SQ FT)

NATIVE TREES %

NATIVE PALMS %

NATIVE SHRUBS %

LANDSCAPE OPEN SPACE (LOS) (SQ FT AND %)

PERIMTETER LOS (SQ FT AND %)

FRONT YARD LOS (SQ FT AND %)

NATIVE VINES / GROUND COVER %

SYMBOL/KEY	PLANT NAME	QTY.	DESCRIPTION
LAWN	DIAMOND ZOYSIA LAWN	AS NEEDED	SOD PALLETS
PLANTING BED	SHREDDED EUCALYPTUS MULCH	AS NEEDED	MULCH ALL BEDS 3" MIN. DEPTH

176 SEMINOLE AVENUE

PROPOSED

10,190 SF

3,847 SF (37.8%)

2,292 SF (62.3%)

1,016 SF (45.1%)

50%

42.9%

89.1%

80.1%

REQUIRED

10,000 SF

4,585.5 SF (MIN 45%)

2,292.75 SF (MIN 50%)

902 SF (MIN. 40%)

35%

35%

35%

35%

	ENVIRONMENT DE/IGN
	GROUP
139 North County Phone 561.832.	y Road S#20-B Palm Beach, Fl 3348 4600 Mobile 561.313.442
	ape Architecture Ianning
	ape Management

Residence  $\nabla$ Private

JOB NUMBER: # xxxxx.00 LA
DRAWN BY: Dustin Mizell
DATE: 01.03.2023

SHEET L6.2

ARCOM# ARC-23-032 ZOM-23-041 Plant Schedule

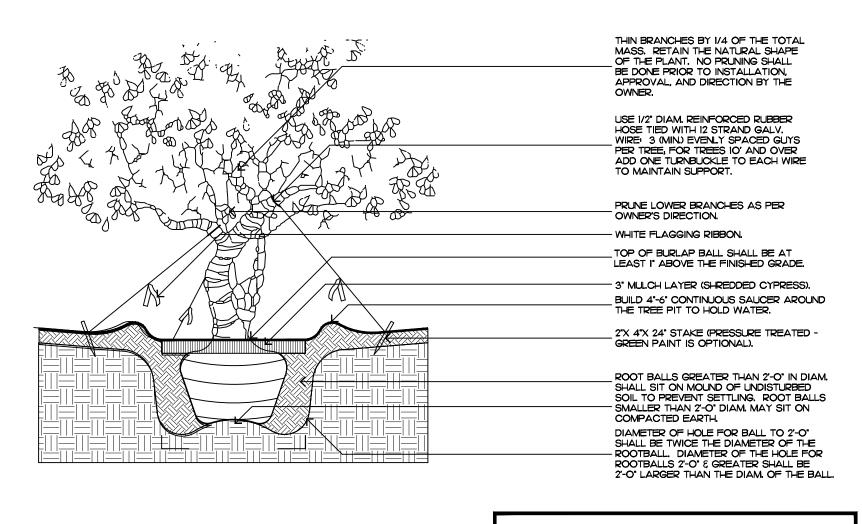
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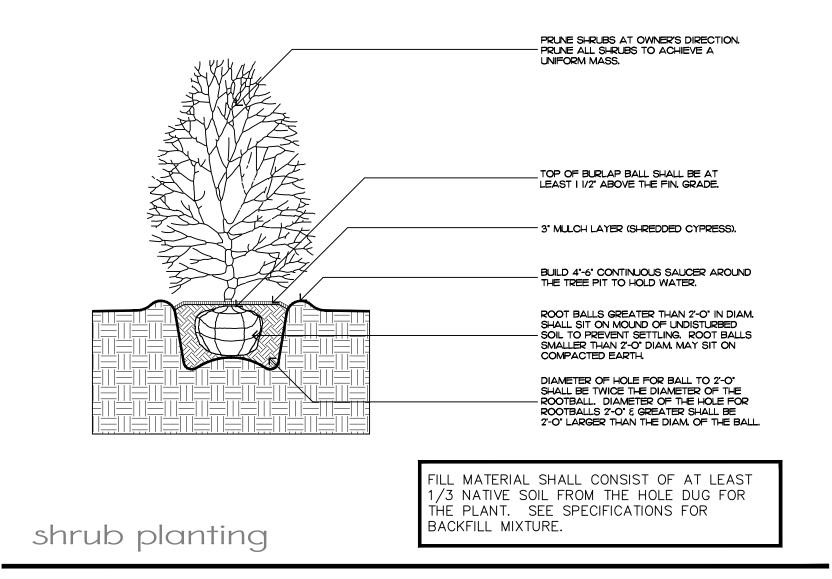
tree planting

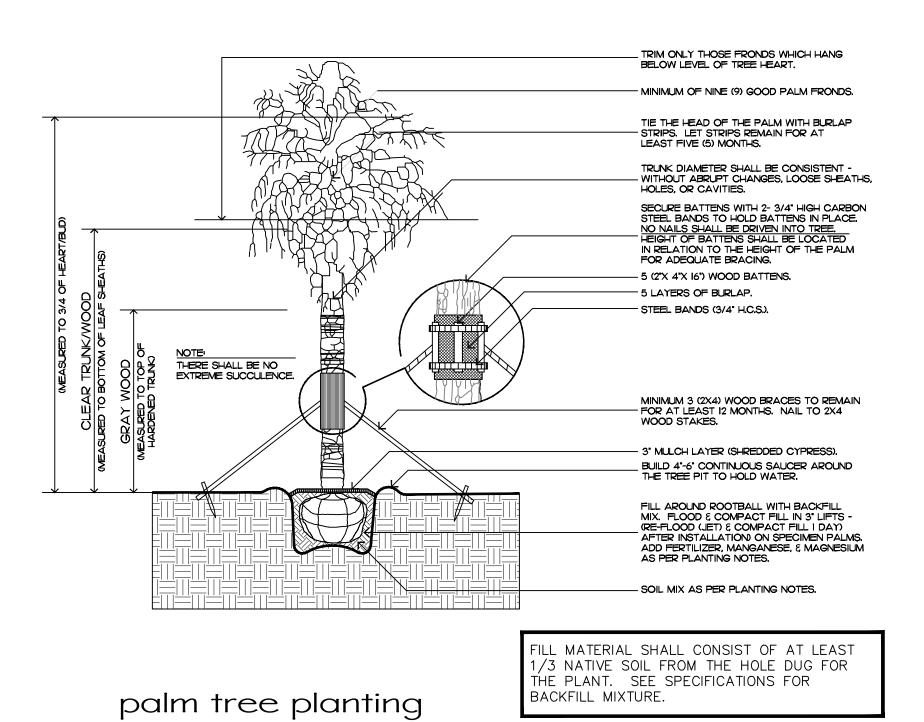
MATERIAL SHALL CONSIST OF AT LEAST /3 NATIVE SOIL FROM THE HOLE DUG FOR THE PLANT. SEE SPECIFICATIONS FOR BACKFILL MIXTURE.

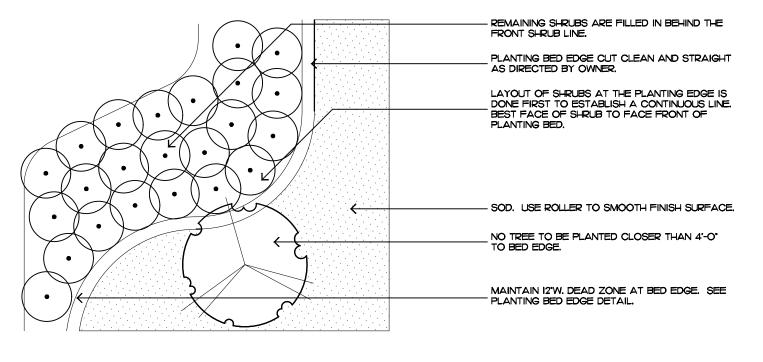


FILL MATERIAL SHALL CONSIST OF AT LEAST 1/3 NATIVE SOIL FROM THE HOLE DUG FOR THE PLANT. SEE SPECIFICATIONS FOR BACKFILL MIXTURE.

irregular and multi-stem tree







shrub & ground cover layout

ARCOM# ARC-23-032 ZOM-23-041

# Planting Details & Specifications

## Planting Motes

COMMERCIAL FERTILIZER:

FERTILIZER SHALL BE COMPLETELY ORGANIC, IT SHALL BE UNIFORM IN COMPOSITION, DRY AND FREE FLOWING. THIS FERTILIZER SHALL BE DELIVERED TO THE SITE IN THE ORIGINAL UNOPENED BAGS, EACH BEARING THE MANUFACTURER'S STATEMENT OF ANALYSIS, AND SHALL MEET THE FOLLOWING REQUIREMENTS:

SIX PERCENT (6%) PHOSPHOROUS SIX PERCENT (6%) POTASSIUM

FERTILIZER SHALL BE APPLIED TO ALL SHRUBS (1/3 LB. PER 3 GAL. POT, 1/4 LB. PER 1 GAL. POT) AND GROUNDCOVER. THE SAME FERTILIZER MIXTURE SHALL BE USED ON SOD AT A RATE OF 15 LBS. PER 1000 SQUARE FEET. A FOURTEEN PERCENT (14%) NITROGEN, FOURTEEN PERCENT (14%) PHOSPHOROUS AND FOURTEEN PERCENT (14%) POTASSIUM IS REQUIRED ON ALL TREES AND SHRUBS OVER 5'-O" IN HEIGHT (1/2 LB. PER 5'-O" OF SPREAD). AGRIFORM TABLETS WITH TWENTY PERCENT (20%) NITROGEN, TEN PERCENT (10%) PHOSPHOROUS, FIVE PERCENT (5%) POTASSIUM IN 21 GRAM SIZES SHALL BE APPLIED ALONG WITH THE FERTILIZER PROCESS (I WITH I GAL. PLANTS, 2 WITH 3 GAL. PLANTS AND 2 TABLETS PER I" OF TREE TRUNK CALIPER). BACK FILL HALFWAY UP THE ROOT BALL, PLACE ABOUT ONE INCH (I") FROM ROOT TIPS. MAGNESIUM SULFATE SHALL BE APPLIED TO ALL PALMS AT INSTALLATION AT A RATE OF 1/2 LB. PER INCH OF TRUNK CALIPER. MANGANESE SHALL BE APPLIED AT THE SAME RATE.

#### MULCH:

MULCH MATERIAL SHALL BE SHREDDED CYPRESS MULCH OR APPROVED EQUAL, MOISTENED AT THE TIME OF APPLICATION TO PREVENT WIND DISPLACEMENT. MULCH SHALL BE APPLIED TO A MINIMUM 3" DEPTH

#### SOD:

THE SOD SHALL BE FREE FROM WEEDS, FUNGUS, INSECTS AND DISEASES OF ANY KIND, CLEAN, STRONGLY ROOTED, UNIFORMLY SIZED STRIPS, MACHINE STRIPPED NOT MORE THAN TWENTY-FOUR (24) HOURS

### JUB/TITUTION/:

NO SUBSTITUTION OF PLANT MATERIAL TYPES OR SIZES WILL BE ALLOWED WITHOUT WRITTEN AUTHORIZATION FROM THE OWNER. CONTAINER GROWN MATERIAL WILL NOT BE ACCEPTED AS SUBSTITUTE FOR BEB MATERIAL UNLESS PREVIOUSLY APPROVED. INTENDED SUBSTITUTIONS SHALL BE SPELLED OUT IN BID.

### MEA/UREMENT/:

HEIGHT SHALL BE MEASURED FROM GROUND TO THE AVERAGE BRANCH HEIGHT OF CANOPY. SPREAD SHALL BE MEASURED TO THE END OF THE BRANCHING EQUALLY AROUND THE CROWN FROM THE CENTER OF THE TRUNK. MEASUREMENTS ARE NOT TO INCLUDE ANY TERMINAL GROWTH. SINGLE TRUNK TREES SHALL BE FREE OF "V" CROTCHES THAT COULD BE POINTS OF WEAK LIMB STRUCTURE OR DISEASE INFESTATION.

HEIGHT SHALL BE MEASURED FROM THE GROUND TO THE AVERAGE POINT WHERE MATURE PLANT GROWTH STOPS. SPREAD SHALL BE MEASURED TO THE END OF

BRANCHING EQUALLY AROUND THE SHRUB MASS. MEASUREMENT AREA NOT TO INCLUDE ANY TERMINAL GROWTH.

CLEAR TRUNK (C.T.) - SHALL BE MEASURED FROM THE GROUND AT TIME OF INSTALLATION

TO THE POINT WHERE THE MATURE AGED TRUNK JOINS THE IMMATURE OR GREEN PORTION

OVERALL HEIGHT (O.A.) - SHALL BE MEASURED FROM THE GROUND AT THE TIME OF INSTALLATION TO THE AVERAGE FROND HEIGHT.

PALMS WITH MARRED OR BURNED TRUNKS WILL NOT BE ACCEPTED.

### PLANTING JOIL AND BACKFILL:

PLANTING SOIL FOR USE IN PREPARING BACKFILL FOR PLANT PITS SHALL BE A FERTILE, FRIABLE AND NATURAL TOPSOIL, WITHOUT MIXTURE OF SUBSOIL MATERIALS, AND SHALL BE FREE FROM HEAVY CLAY STONES, LIME, LUMPS, SHELLS, PLANTS, ROOTS OR OTHER FOREIGN MATERIALS, WEEDS, OR NOXIOUS GRASSES (SUCH AS BERMUDA OR NUT GRASS). IT SHALL NOT CONTAIN TOXIC SUBSTANCES WHICH MAY BE HARMFUL TO THE PLANT GROWTH.

BACKFILL FOR SOD AREAS SHALL BE SUBJECT TO LESSER STANDARDS AT THE DISCRETION AND DECISION OF THE OWNER.

EXISTING TOPSOIL SHALL BE USED IN ALL PLANT MATERIAL PITS EXCEPT SABAL PALMS WHERE THE SOIL SHALL CONSIST OF CLEAN SAND.

PLANTING SOIL FOR USE IN BEDS FOR ANNUALS AND/OR PERENNIALS SHALL CONTAIN ONE-THIRD (1/3) POTTING SOIL OR A BLENDED TOPSOIL, TILL INTO TOP 10" - 12" OF SOIL WITH A TIME-RELEASE FERTILIZER.

#### PLANT MATERIALS:

PALMS, TREES, SHRUBS, GROUNDCOVERS AND VINES

PLANT SPECIES AND SIZE SHALL CONFORM TO THOSE INDICATED ON THE DRAWINGS. NOMENCLATURE SHALL CONFORM TO "STANDARDIZED PLANT NAMES", 1942 EDITION. ALL NURSERY STOCK SHALL BE IN ACCORDANCE WITH "GRADES AND STANDARDS FOR NURSERY PLANTS PARTS I & II", LATEST EDITION PUBLISHED BY THE FLORIDA DEPARTMENT OF AGRICULTURE AND CONSUMER SERVICES. UNLESS SPECIFIED OTHERWISE, ALL PLANTS SHALL BE FLORIDA GRADE NUMBER I OR BETTER AS DETERMINED BY THE FLORIDA DIVISION OF PLANT INDUSTRY. SPECIMEN MEANS AN EXCEPTIONALLY HEAVY, SYMMETRICAL TIGHTLY KNIT PLANT, SO TRAINED OR FAVORED IN ITS DEVELOPMENT THAT FIRST APPEARANCE IS UNQUESTIONABLE AND OUTSTANDINGLY SUPERIOR IN FORM, NUMBER OF BRANCHES, COMPACTNESS AND SYMMETRY. ALL PLANTS SHALL BE FRESHLY DUG, SOUND, HEALTHY, VIGOROUS, WELL BRANCHED AND FREE OF DISEASE AND INSECT EGGS AND LARVAE AND SHALL HAVE ADEQUATE ROOT SYSTEMS. TREES FOR PLANTING ROWS SHALL BE UNIFORM IN SIZE AND SHAPE. ALL MATERIALS SHALL BE SUBJECT TO APPROVAL BY THE OWNER. WHERE REQUIREMENTS ARE OMITTED FROM THE PLANT LIST, THE PLANTS FURNISHED SHALL BE NORMAL FOR THE VARIETY AND FLORIDA NUMBER 1. PLANTS SHALL BE PRUNED PRIOR TO DELIVERY ONLY UPON THE APPROVAL OF THE OWNER.

### CONTAINER GROWN / TOCK:

ALL CONTAINER GROWN MATERIAL SHALL BE HEALTHY, VIGOROUS, WELL-ROOTED PLANTS AND ESTABLISHED IN THE CONTAINER IN WHICH THEY ARE SOLD. THE PLANTS SHALL HAVE TOPS OF GOOD QUALITY AND BE IN A HEALTHY GROWING CONDITION.

AN ESTABLISHED CONTAINER GROWN PLANT SHALL BE TRANSPLANTED INTO A CONTAINER AND GROWN IN THAT CONTAINER SUFFICIENTLY LONG ENOUGH FOR THE NEW FIBROUS ROOTS TO HAVE DEVELOPED SO THAT THE ROOT MASS WILL RETAIN ITS SHAPE AND HOLD TOGETHER WHEN REMOVED FROM THE

### WARRANTY:

WARRANTY PLANTS, SHRUBS AND GROUNDCOVERS FOR A PERIOD OF NINETY (90) DAYS; TREES  $\xi$  PALMS FOR ONE YEAR (I) AGAINST UNHEALTHY CONDITION, EXCEPT AS MAY RESULT FROM NEGLECT BY OWNER, DAMAGE BY OTHERS, AND UNUSUAL PHENOMENA BEYOND INSTALLER'S CONTROL. REPLACE AT TIME REQUESTED BY THE OWNER OR LANDSCAPE ARCHITECT.

#### MAINTENANCE:

MAINTAIN LANDSCAPE WORK UNTIL THE LETTER OF SUBSTANTIAL COMPLETION BY THE GENERAL CONTRACTOR. INCLUDE WATERING, WEEDING, CULTIVATING, RESTORATION OF GRADE, MOWING AND TRIMMING GRASS, PRUNING TREES AND SHRUBS, PROTECTION FROM INSECTS AND DISEASES, FERTILIZATION AND SIMILAR OPERATIONS AS NEEDED TO ENSURE NORMAL GOOD HEALTH FOR LIVE PLANT MATERIAL.

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Landscape Management

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ROUP

JOB NUMBER: # xxxxx.00 LA DRAWN BY: Dustin Mizell

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JOB NUMBER: # xxxxx.00 LA
DRAWN BY: Dustin Mizell
DATE: 01.05.2023
01.23.2023
06.02.2023

✓HEET L7.0

ARCOM# ARC-23-032 ZOM-23-041

Rendered Landscape Elevations
SCALE IN FEET: 3/16"=1'-0"

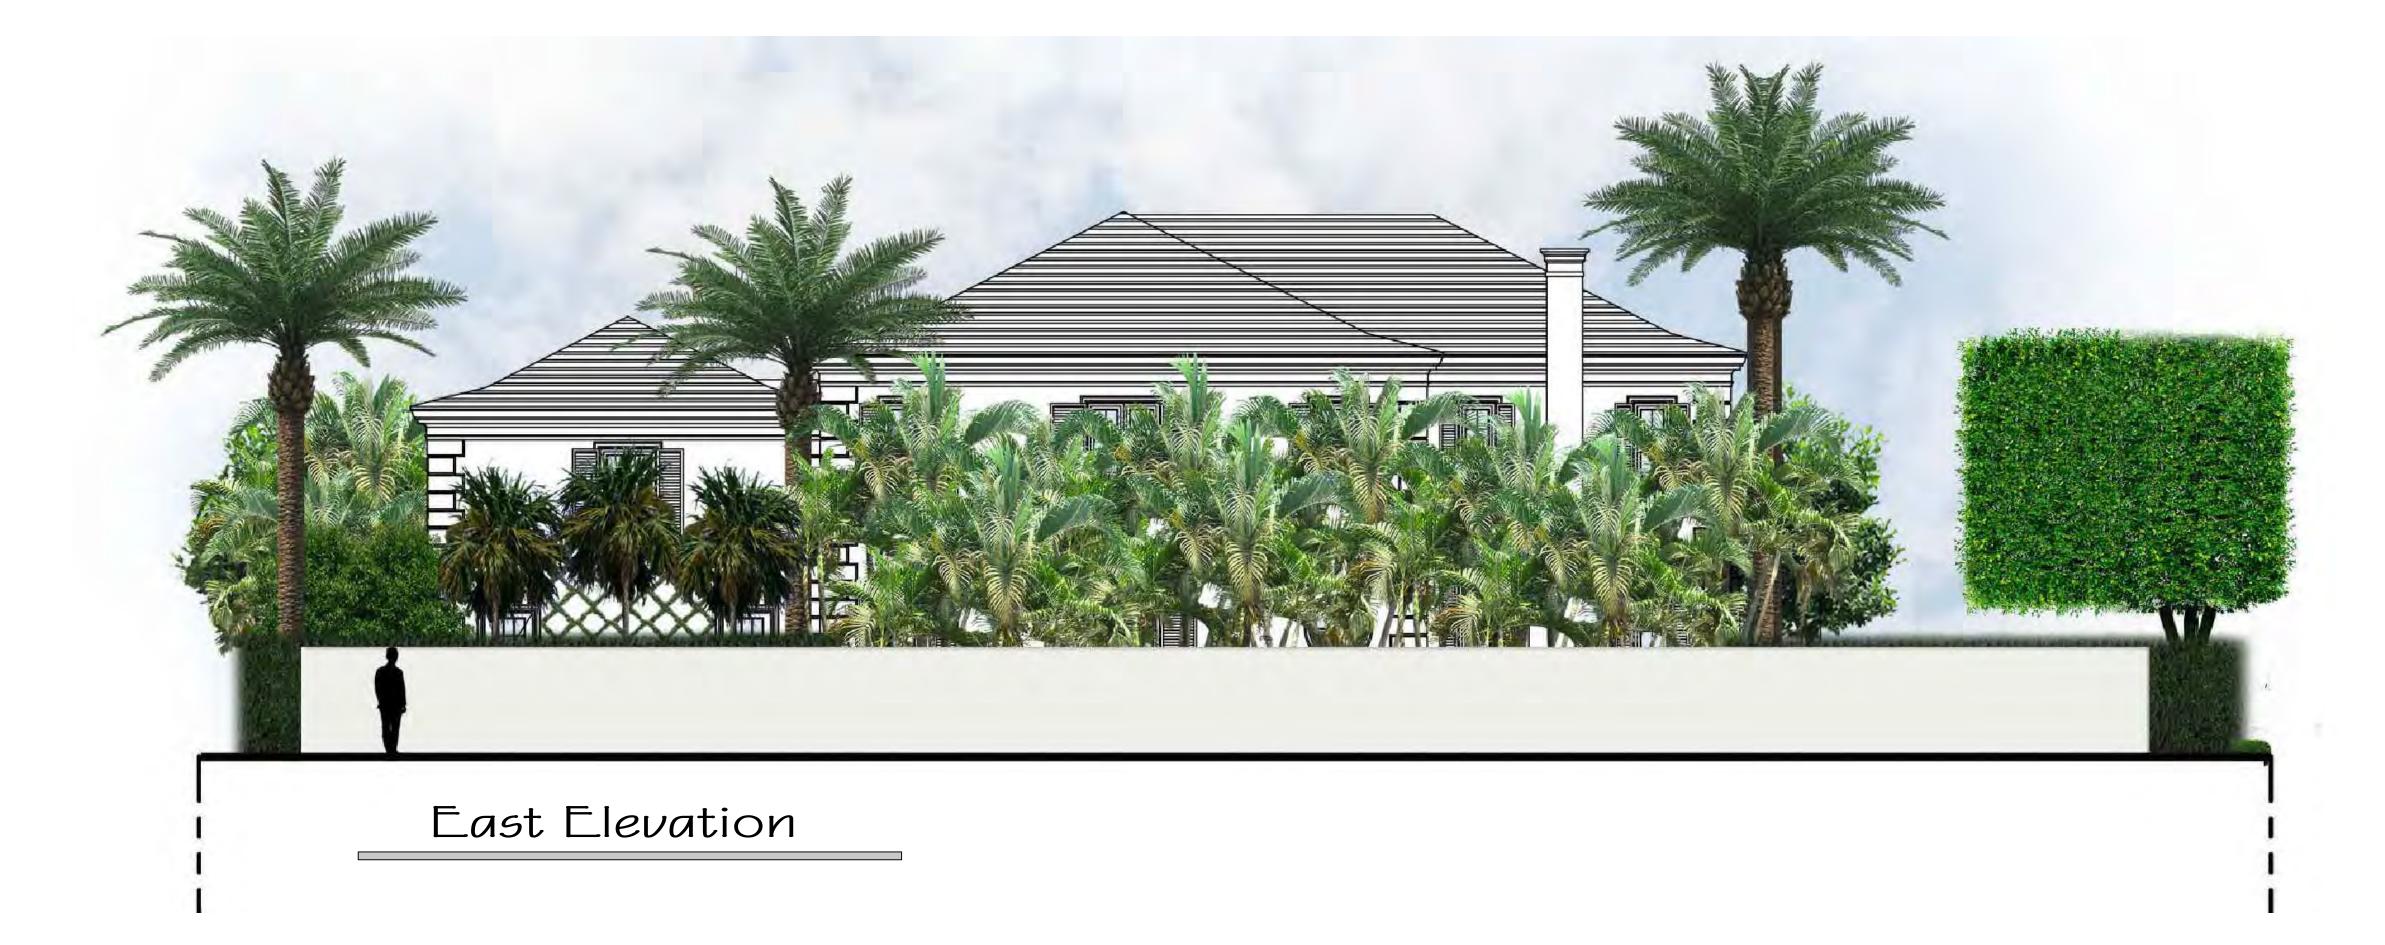
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